A NEW BUILDING FOR ORANGE BEACH TRAIL SHOP / WILDLIFE CENTER

ORANGE BEACH, ALABAMA PHASE I

VICINITY MAP

GENERAL NOTES

- . ALL NEW CONSTRUCTION SHALL COMPLY WITH ALL APPLICABLE BUILDING CODES AND RESTRICTIVE ORDINANCES, AND INDUSTRY STANDARDS FOR CONSTRUCTION, ELECTRICAL, PLUMBING, AND MECHANICAL
- 2. THE INTENT OF THESE DRAWINGS IS TO PROVIDE THE BUILDER WITH GENERAL GUIDELINES FOR THE SOUND CONSTRUCTION OF THE STRUCTURE INDICATED HEREIN. DEVIATIONS FROM THESE DRAWINGS ARE AT THE BUILDERS RISK UNLESS APPROVED IN WRITING OR WITH SUPPLEMENTAL DRAWINGS FROM THE ARCHITECT
- 3. IT IS RECOMMENDED THAT THE SERVICES OF A REGISTERED LAND SURVEYOR BE EMPLOYED FOR THE PROPER PLACEMENT OF THE STRUCTURE IN RELATION TO PROPERTY LINES, SETBACK LINES, EASEMENTS, ETC.
- 4. DIMENSIONS INDICATED ON DRAWINGS ARE TO FACE OF STUD OR MASONRY UNLESS OTHERWISE NOTED.
- 5. THE CONTRACTOR SHALL FIELD VERIFY ALL DIMENSIONS INDICATED WITHIN THESE DOCUMENTS AND SHALL NOTIFY THE ARCHITECT OF ANY VARIATION PRIOR TO THE PURCHASE OF MATERIALS, FABRICATION, OR BEGINNING CONSTRUCTION.
- PROVIDE TEMPORARY SETTLING BASINS, HAY BALES, AND OTHER METHODS AS APPROPRIATE TO FILTER WATER AT ALL AREAS WHERE STORM WATER LEAVES THE PROJECT. CLEAN ALL SOIL WHICH FLOWS OFF-SITE.
- 7. ALL EXISTING SITE CONDITIONS ARE TO BE VERIFIED BY CONTRACTOR PRIOR TO START OF CONSTRUCTION.
- 8. PROVIDE CHEMICAL BARRIER TO BUILDING FROM SUBTERRANEAN TERMITE ATTACK.
- 9. NO QUALIFYING STATEMENTS OR EXCEPTIONS TO PLANS OR NOTES ARE ALLOWED. 10. ALL WORK RELATED DEBRIS SHALL BE REMOVED FROM THE SITE REGULARLY AND PROMPTLY. II. THE CONTRACTOR SHALL LEAVE ALL AREAS AND FINISHED SPACES IN A CLEAN AND ACCEPTABLE CONDITION AT THE PROJECT COMPLETION.
- 12. ALL MECHANICAL, PLUMBING, AND ELECTRICAL SYSTEMS ARE TO BE FULLY COORDINATED WITH THE ARCHITECTURAL DOCUMENTS
- 13. ALL PLUMBING, MECHANICAL, AND ELECTRICAL SYSTEMS SHALL BE DESIGNED AND INSTALLED BY A STATE OF ALABAMA LICENSED AND CERTIFIED CONTRACTOR AND THEIR RESPECTIVE DISCIPLINE. PLUMBING CONTRACTOR SHALL SHOW EVIDENCE OF THEIR ALABAMA PLUMBERS AND GAS FITTERS LICENSE; HEATING AND COOLING CONTRACTOR'S LICENSE; AND ALABAMA ELECTRICAL CONTRACTOR'S LICENSE
- 14. PLUMBING, MECHANICAL, AND ELECTRICAL CONTRACTOR'S SHALL PROVIDE THE OWNER WITH SHOP DRAWINGS AND SPECIFICATIONS PRIOR TO ORDERING AND INSTALLATION. ALL WORK SHALL COMPLY WITH THE 2018 INTERNATIONAL BUILDING CODE. 2018 INTERNATIONAL PLUMBING AND GAS CODES, 2018 INTERNATIONAL MECHANICAL CODE, 2018 INTERNATIONAL FIRE CODE, AND 2017 NATIONAL ELECTRICAL CODE.
- 15. DO NOT SCALE DRAWINGS! DIMENSIONS OR LINEAR MEASUREMENTS TAKE PRECEDENT OVER NOTED DIMENSIONS
- 16. ALL CONTRACTOR'S AND SUB-CONTRACTOR'S SHALL COMPLY WITH OSHA REQUIREMENTS. 17. ALL EXTERIOR DOORS AND WINDOWS SHALL BE DESIGNED AND INSTALLED TO WITHSTAND DESIGN WIND LOADS BASED ON ASCE 7-16 AND 160 MPH WIND RATING.
- 18. ALL PRODUCTS, MATERIALS, AND CONSTRUCTION SHALL BE PROVIDED AND/OR INSTALLED IN STRICT ACCORDANCE WITH THE MANUFACTURER'S SPECIFICATIONS, GUIDELINES, AND/OR INDUSTRY STANDARDS.

CONTACT INFORMATION

ARCHITECT

McCOLLOUGH ARCHITECTURE, INC. CONTACT: STED McCOLLOUGH 4790 MAIN STREET #209 ORANGE BEACH, ALABAMA 36561 PHONE: 251-968-7222

MECHANICAL, PLUMBING, & ELECTRICAL ENGINEERING

STEWART ENGINEERING CONTACT: WADE STEWART 40680 STATE HIGHWAY 59 BAY MINETTE, ALABAMA 36507 PHONE: 251-937-6313

PROJECT SUMMARY PHASE I

IN GENERAL, THE WORK FOR PHASE I OF THIS PROJECT WILL CONSIST OF A 7,316 SQUARE

<u>CONCRETE SLAB</u> - PROVIDE THICKENED SLAB AT ALL LOAD BEARING WALLS AS REQUIRED. REFER TO STRUCTURAL FOUNDATION PLANS FOR REQUIREMENTS. PROVIDE SEALED CONCRETE AT ALL AREAS SCHEDULED. THE MECHANICAL ELECTRICAL AND PLUMBING CONTRACTOR WILL COORDINATE ALL STUB UP LOCATIONS. COORDINATE AS REQUIRED ALL PHASE II CONDITIONS AND PREP AS REQUIRED.

METAL BUILDING - THE METAL BUILDING INTERIOR WILL CONSIST OF A COMPLETE BUILDING SHELL WITH ALL INTERIOR INSULATION, BRACING AND PREP AS REQUIRED FOR PHASE II CONSTRUCTION. PROVIDE SIMPLE SAVER INSULATION @ ENTIRE PERIMETER PURLIN CAVITY AND ROOF PURLINS EXCEPT WHERE OMITTED AT BREEZEWAY AREA. VERIFY AND PROVIDE ALL DOOR AND WINDOW ROUGH OPENINGS AS REQUIRED.

THE METAL BUILDING EXTERIOR WILL CONSIST OF PROVIDING A COMPLETE EXTERIOR METAL BUILDING WITH ALL TRIM, FLASHING, GUTTERS AND DOWNSPOUTS. PROVIDE WEATHER RESISTANT PAINT FOR ALL EXTERIOR EXPOSED STEEL

DOORS AND WINDOWS - PROVIDE ALL UNITS SCHEDULED IN PHASE I WITH PAINTED INTERIOR AND EXTERIOR SURFACES. PROVIDE ALL FINISHED HARDWARE.

MECHANICAL - PROVIDE ALL ITEMS REQUIRED FOR PHASE I (SEE MECHANICAL PHASE I DRAWINGS).

ELECTRICAL - PROVIDE ALL STUB UPS AND IN SLAB CONDUIT AS REQUIRED FOR PHASE I. PROVIDE ELECTRICAL METER PANEL AND SUB PANELS WITH ALL REQUIRED ELECTRICAL WORK FOR PHASE I. (SEE ELECTRICAL PHASE I DRAWINGS).

<u>PLUMBING - PROVIDE ALL UNDERGROUND PIPING, IN SLAB STUB UPS AND ALL PLUMBING WORK AS REQUIRED FOR PHASE I. PROVIDE WATER AND SEWER CONNECTIONS AS REQUIRED</u> (SEE PLUMBING PHASE I DRAWINGS).

PHASE I ADD ALTERNATES

<u>ADD ALTERNATE |</u> - ADD ALTERNATE | CONSISTS OF A 2,368 S.F. COMPLETE INTERIOR FITUP OF THE TRAIL SHOP SPACE. THIS FIT UP INCLUDES INTERIOR WALLS, DOORS, MILLWORK, FIXTURES, MECHANICAL EQUIPMENT, ELECTRICAL, APPLIANCES AND FINISHES THROUGHOUT ALSO A 1,022 S.F. SECOND FLOOR OR "MEZZANINE" WILL BE PART OF THIS ADD ALTERNATE INCLUDING STAIRS AND FINISHES. IN GENERAL, THIS ADD ALTERNATE IS MEANT TO TAKE THE TRAIL SHOP SPACE FROM ITS STATE AT THE END OF THE BASE PHASE I TO A COMPLETE "TURN KEY" SPACE, WITH ALL NECESSARY TRAIL SHOP SYSTEMS IN PLACE AND IN NEW WORKING ORDER. UPON COMPLETION OF THIS ADD ALTERNATE I THE TRAIL SHOP SIDE OF THE BUILDING IS MEANT TO BE MOVE IN READY.

NISHING OF ENTRY ELEMENTS AS DESIGNATED ON THESE CONSTRUCTION DOCUMENTS. IN GENERAL THIS INCLUDES AN ENTRY SIGNAGE ELEMENT. WOOD TRELLIS. WOOD LOW WALL. WOOD BENCH AND A WOOD FRAMED ELEMENT AT THE REAR OF THE BREEZEWAY.

N GENERAL, AT THE COMPLETION OF PHASE I AND ADD ALTERNATE I \$ 2 ALL BUT THE WILDLIFE SPACE IS MEANT TO BE COMPLETE AND ALL SYSTEMS INSTALLED AND IN NEW WORKING ORDER

SHEET INDEX

TITLE

T1.1 - TITLE SHEET AND GENERAL NOTES

CIVIL 01 TITLE SHEET

- 02 NOTES
- 03 EXISTING AND DEMO
- 04 GEOMETRY PLAN 05 GEOMETRY PLAN 2
- 06 GRADING AND DRAINAGE 07A GRADING AND DRAINAGE 2
- 07B GRADING AND DRAINAGE
- 08 UTILITY PLAN
- 09 EROSION CONTROL PLAN 10 EROSION CONTROL DETAILS
- 11 CONSTRUCTION DETAILS
- 12 CONSTRUCTION DETAILS 2
- 13 CONSTRUCTION DETAILS 3 14 WATER DETAILS
- 15 SEWER DETAILS
- STRUCTURAL
- S1.1 FOUNDATION PLAN AND DETAILS

ARCHITECTURAL

BASE PHASE I

- RA1.1 FLOOR PLAN (REFERENCE)
- A1.0 ADA STANDARDS
- A1.1 FLOOR PLAN / PHASE I A2.1 - SCHEDULES AND DETAILS / PHASE I
- A3.1 EXTERIOR ELEVATIONS / PHASE I
- A4.1 BUILDING SECTIONS / PHASE I A4.2 - WALL SECTIONS / PHASE I
- A7.1 ROOF PLAN / PHASE I
- ADD ALTERNATE 1 (TRAIL SHOP FIT UP)
- ALT 1 LS1.1 LIFE SAFETY PLAN / ADD ALT 1
- ALT 1 A1.1 FLOOR PLAN / ADD ALT 1
- ALT 1 A2.1 SCHEDULES AND DETAILS / ADD ALT 1
- ALT 1 A3.1 EXTERIOR ELEVATIONS / ADD ALT 1
- ALT 1 A4.1 BUILDING SECTIONS / ADD ALT 1
- ALT 1 A4.2 WALL SECTIONS / ADD ALT 1
- ALT 1 A5.1 INTERIOR ELEVATIONS / ADD ALT 1
- ALT 1 A6.1 REFLECTED CEILING PLAN / ADD ALT 1
- ADD ALTERNATE 2 (ENTRY ELEMENTS)
- ALT 2 A1.1 FLOOR PLAN / ADD ALT 2 ALT 2 A4.3 - SECTIONS AND DETAILS / ADD ALT 2
- ALT 2 A4.4 SECTIONS AND DETAILS / ADD ALT 2
- ALT 2 A4.5 SECTIONS AND DETAILS / ADD ALT 2

PLUMBING

BASE PHASE I

- P1.0 PLUMBING NOTES, SCHEDULES AND LEGEND
- P1.1 PLUMBING PLAN
- P2.0 SANITARY WASTE RISERS ADD ALTERNATE 1 (TRAIL SHOP FIT UP)
- P1.0 PLUMBING NOTES, SCHEDULES AND LEGEND
- P1.1 PLUMBING PLAN BASE BID P2.0 - SANITARY WASTE RISER
- P2.1 PLUMBING DETAILS

MECHANICAL

- ADD ALTERNATE 1 (TRAIL SHOP FIT UP)
- M1.0 HVAC LEGEND, NOTES AND SCHEDULES
- M1.1 HVAC PLAN FIRST FLOOR M1.2 - HVAC PLAN SECOND FLOOR
- M2.0 HVAC DETAILS

ELECTRICAL

- **BASE PHASE 1** E1.0 - ELECTRICAL NOTES AND LEGEND
- E1.1 POWER & AUX PLAN BASE BID E1.2 - LIGHTING PLAN
- E3.0 ELECTRICAL RISER AND DETAILS
- ADD ALTERNATE 1 (TRAIL SHOP FIT UP)
- E1.0 ELECTRICAL NOTES AND LEGEND
- E1.1 LIGHTING PLAN ALTERNATES
- E1.2 LIGHTING PLAN 2ND FLOOR ALTERNATES
- E2.1 POWER & AUX FIRST FLOOR ALTERNATES
- E2.2 POWER PLAN SECOND FLOOR
- E3.0 ELECTRICAL RISER AND DETAILS





ľ BE

21-05 JOB NO.: CLT DRAWN: CHECKED: 2021.06.01 DATE: **REVISION:**

AS NOTED

SHEET NO.:

SCALE:

TITLE SHEET

PHASE I


CITY OF ORANGE BEACH

TRAIL SHOP / WILDLIFE CENTER

POWERLINE ROAD, ORANGE BEACH, AL CIVIL CONSTRUCTION DRAWINGS

MAY 2021

Sheet List Table	
Sheel Number	Sheet Title
1	TITLE SHEET
2	NOTES
3	EXISTING AND DEMO
4	GEOMETRY PLAN
5	GEOMETRY PLAN 2
6	GRADING AND DRAINAGE
7A	GRADING AND DRAINAGE 2
7B	GRADING AND DRAINAGE
8	UTILTIY PŁAN
9	EROSION CONTROL PLAN
10	ECP DETAILS
11	CONSTRUCTION DETAILS
12	CONSTRUCTION DETAILS 2
13	CONSTRUCTION DETAILS 3
14	WATER DETAILS
15	SEWER DETAILS

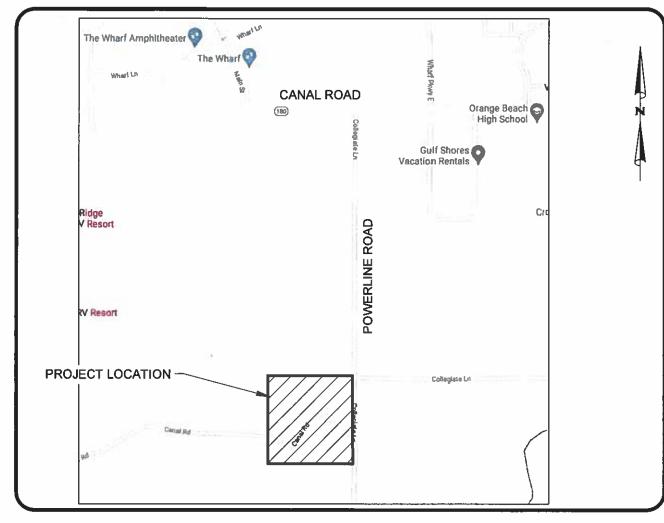

UTILITY PROVIDERS

SANITARY SEWER CITY OF ORANGE BEACH

WATER


ORANGE BEACH WATER AUTHORITY

POWER TELEPHONE BALDWIN EMC CENTURYLINK

VICINITY MAP

PREPARED BY:



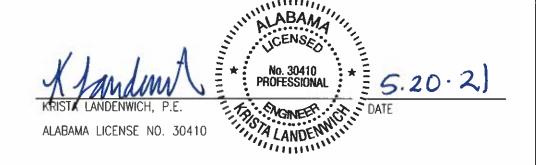

UTILITY PLAN NOTES

- 1. THE CONTRACTOR SHALL NOTIFY SAWGRASS LLC. CONSTRUCTION SURVEILLANCE REPRESENTATIVE AND LOCAL JURISDICTIONAL INSPECTOR 48 HOURS BEFORE THE BEGINNING OF EACH PHASE OF CONSTRUCTION.
- 2. ALL WORK SHALL COMPLY WITH APPLICABLE STATE, FEDERAL, AND LOCAL CODES, AND ALL NECESSARY LICENSES AND PERMITS SHALL BE OBTAINED BY THE CONTRACTOR AT HIS EXPENSE UNLESS PREVIOUSLY OBTAINED BY THE OWNER/DEVELOPER.
- 3. THE CONTRACTOR SHALL IMMEDIATELY INFORM THE ENGINEER OF ANY DISCREPANCIES OR ERRORS HE DISCOVERS IN THE PLAN.
- 4. DEVIATION FROM THESE PLANS AND NOTES WITHOUT THE PRIOR CONSENT OF THE OWNER OR HIS REPRESENTATIVE OR THE ENGINEER MAY BE CAUSE FOR THE WORK TO BE UNACCEPTABLE.
- 5. THE CONTRACTOR IS REQUIRED TO USE THE ONE-CALL CENTER TELEPHONE NUMBER FOR THE PURPOSE OF COORDINATING THE MARKING OF UNDERGROUND
- 6. IT IS THE RESPONSIBILITY OF THE CONTRACTOR TO DETERMINE THE LOCATION OF ALL EXISTING UNDERGROUND UTILITIES AND TO TAKE WHATEVER STEPS ARE NECESSARY TO PROVIDE FOR THEIR PROTECTION. THE ENGINEER HAS DILIGENTLY ATTEMPTED TO LOCATE AND INDICATE ALL EXISTING FACILITIES ON THESE PLANS, HOWEVER, THIS INFORMATION IS SHOWN FOR THE CONTRACTOR'S CONVENIENCE ONLY. THE ENGINEER ASSUMES NO RESPONSIBILITY FOR THE LOCATIONS OF UTILITIES SHOWN OR NOT SHOWN. CONTRACTOR TO CONTACT THE UTILITY COMPANIES FOR EXACT LOCATION OF THEIR UTILITIES PRIOR TO STARTING CONSTRUCTION. ANY AND ALL DAMAGE MADE TO UTILITIES BY THE CONTRACTOR SHALL BE THE SOLE RESPONSIBILITY OF THE CONTRACTOR TO REPAIR AND REPLACE.
- 7. THE CONTRACTOR SHALL COORDINATE LOCATION AND INSTALLATION OF ALL UNDERGROUND UTILITIES AND APPURTENANCES TO MINIMIZE DISTURBING CURBING, PAVING AND COMPACTED SUBGRADE.
- 8. UTILITY COORDINATION SHALL BE INCLUDED IN THE PROJECT SCHEDULE AND IT IS THE EXPLICIT RESPONSIBILITY OF THE CONTRACTOR TO ASSURE THAT THE PROJECT SCHEDULE INCLUDES THE NECESSARY RELOCATION. THE CONTRACTOR SHOULD SEEK ASSISTANCE FROM ALL UTILITY COMPANIES TO LOCATE AND PROTECT THEIR FACILITIES.
- 9. FIRE HYDRANT AND WATER MAINS TO BE INSTALLED AND UNDER PRESSURE BEFORE ANY COMBUSTIBLE CONSTRUCTION IS STARTED.
- 10. THE CONTRACTOR SHALL BE RESPONSIBLE FOR ANY DAMAGE DONE BY HIS EQUIPMENT TO EXISTING UTILITIES, CROSS-DRAIN PIPES AND HEADWALLS.
- 11. ALL WATER AND SANITARY SEWER CONSTRUCTION METHODS AND MATERIALS SHALL CONFORM TO THE LOCAL UTILITY COMPANIES STANDARD SPECIFICATIONS.
- 12. UNLESS DUCTILE IRON PIPE IS USED, MINIMUM COVER FOR SANITARY SEWER SHALL BE THREE(3) FEET.
- 13. ALL MANHOLES WITHIN THE 100-YEAR FLOOD PLAIN SHALL BE CONSTRUCTED THREE(3) FEET ABOVE GRADE.
- 14. NEOPRENE COUPLINGS WITH STAINLESS STEEL BAND AND SHEAR RINGS ARE REQUIRED FOR JOINING DIFFERENT TYPES OF SANITARY SEWER PIPES.
- 15. THE CONTRACTOR SHALL EXCAVATE FOR NEW SEWER TO ELEVATIONS SHOWN ON PLANS. THE CONTRACTOR SHALL TAKE EVERY NECESSARY PRECAUTION TO PROTECT EXISTING SEWER DURING CONSTRUCTION OPERATIONS. ALL EXCAVATION, SHORING AND BRACING SHALL BE THE RESPONSIBILITY OF THE CONTRACTOR.
- 16. THE CONTRACTOR SHALL EXPLORE AHEAD 200 FEET SO ADJUSTMENTS CAN BE MADE IN THE ALIGNMENT OF THE PIPE IN CASE OF CONFLICTS WITH EXISTING STRUCTURES, UTILITIES AND PIPING.
- 17. ALL EXCESS MATERIAL FROM EXCAVATION SHALL BE DISPOSED OF BY THE CONTRACTOR. COST FOR THIS WORK SHALL BE INCLUDED IN OTHER ITEMS OF
- 18. THE CONTRACTOR SHALL BE RESPONSIBLE FOR PREVENTING PIPE FROM FLOATING. IF PIPE FLOATS DURING CONSTRUCTION, THE CONTRACTOR SHALL RELAY PIPE TO GRADE AT HIS EXPENSE.
- 19. THE CONTRACTOR SHALL FIELD VERIFY LOCATION AND INVERT OF SANITARY SEWER FOR CONNECTION TO EXISTING OR PROPOSED SEWER SYSTEM.
- 20. THE WATER SYSTEM IN THE PUBLIC RIGHT-OF-WAY WILL BECOME THE PROPERTY OF THE LOCAL UTILITIES BOARD UPON COMPLETION.
- 21. BEDDING REQUIREMENTS SPECIFIED HEREIN ARE TO BE CONSIDERED AS MINIMUMS FOR RELATIVELY DRY, STABLE EARTH CONDITIONS. ADDITIONAL BEDDING SHALL BE REQUIRED FOR ROCK TRENCHED AND WET AREAS. THE CONTRACTOR SHALL HAVE THE RESPONSIBILITY TO PROVIDE SUCH ADDITIONAL BEDDING AS MAY BE REQUIRED TO PROPERLY CONSTRUCT THE WORK.
- 22. NATURAL GAS REQUIREMENTS SHALL BE PROVIDED TO THE UTILITIES DEPARTMENT ONE(1) MONTH PRIOR TO SERVICE REQUEST.
- 23. ALL PROPERTY LINE MARKERS (IRON PINS, CONCRETE MONUMENTS, ETC.) DESTROYED DURING CONSTRUCTION SHALL BE REPLACED IN KIND BY THE CONTRACTOR. THE CONTRACTOR SHALL EMPLOY A LAND SURVEYOR REGISTERED IN THE STATE OF ALABAMA TO RESET PROPERTY MARKERS. THE COST FOR THIS WORK SHALL BE INCLUDED IN OTHER ITEMS OF WORK.

GRADING AND DRAINAGE NOTES

- 1. THE CONTRACTOR SHALL FURNISH AND MAINTAIN ALL NECESSARY BARRICADES AROUND WORK AND SHALL PROVIDE PROTECTION AGAINST WATER DAMAGE AND SOIL EROSION.
- 2. ALL SILT BARRIERS MUST BE PLACED AS ACCESS IS OBTAINED DURING CLEARING. NO GRADING SHALL BE DONE UNTIL SILT BARRIER AND DETENTION FACILITIES ARE CONSTRUCTED.
- 3. ALL SEDIMENT CONTROL DEVICES ARE TO BE CONSTRUCTED AND FULLY OPERATIONAL PRIOR TO ANY OTHER CONSTRUCTION OR GRADING.
- 4. ALL SLOPES SHALL BE STABILIZED AS SOON AS POSSIBLE.
- 5. COMPACTION OF THE BACKFILL OF ALL TRENCHES SHALL BE COMPACTED TO THE DENSITY OF 95% OF THEORETICAL MAXIMUM DRY DENSITY (ASTM D698). BACKFILL MATERIAL SHALL BE FREE FROM ROOTS, STUMPS OR OTHER FOREÍGN DEBRIS AND SHALL BE PLACED AT OR NEAR OPTIMUM MOISTURE. CORRECTION OF ANY TRENCH SETTLEMENT WITHIN A YEAR FROM THE DATE OF APPROVAL WILL BE THE RESPONSIBILITY OF THE CONTRACTOR.
- 6. ALL FILL MATERIAL TO BE UTILIZED ON THE PROJECT SHALL BE FREE OF ORGANIC OR OTHERWISE DELETERIOUS MATERIALS AND COMPACTED TO MINIMUM DRY DENSITIES CORRESPONDING TO 95% OF MAXIMUM DRY DENSITY AS OBTAINED BY STANDARD PROCTOR, ASTM D698 AND AT LEAST 100% DENSITY WITHIN 1 FOOT BELOW PAVEMENT SUBGRADE. FILL SHALL BE PLACED IN LIFTS NOT TO EXCEED 6 INCHES IN COMPACTED FILL THICKNESS. A REPORT FROM A GEOTECHNICAL ENGINEER WILL BE REQUIRED BY THE LOCAL JURISDICTIONAL INSPECTOR.
- 7. MAXIMUM SLOPE OF EMBANKMENT SHALL BE 3.0 FEET HORIZONTAL TO 1.0 FOOT VERTICAL.
- 8. PROPOSED CONTOUR INTERVALS ARE AS LABELED. ALL PROPOSED CONTOURS ARE FINISHED GRADES.
- 9. THE CONTRACTOR WILL INSURE THAT POSITIVE AND ADEQUATE DRAINAGE IS MAINTAINED AT ALL TIMES WITHIN THE PROJECT LIMITS. THIS MAY INCLUDE, BUT NOT LIMITED TO, REPLACEMENT OR RECONSTRUCTION OF EXISTING DRAINAGE STRUCTURES THAT HAVE BEEN DAMAGED OR REMOVED OR REGRADING AS REQUIRED BY THE ENGINEER, EXCEPT FOR THOSE DRAINAGE ITEMS SHOWN AT SPECIFIC LOCATIONS IN AND HAVING SPECIFIC PAY ITEMS IN THE DETAILED ESTIMATE. NO SEPARATE PAYMENT WILL BE MADE FOR ANY COSTS INCURRED TO COMPLY WITH THIS REQUIREMENT.
- 10. EXCESS EARTH CUT MATERIAL, IF ANY, SHALL BECOME THE RESPONSIBILITY OF THE CONTRACTOR AND SHALL BE REMOVED FROM THE SITE UNLESS OTHERWISE APPROVED TO BE PLACED ON SITE BY THE OWNER.
- 11. ALL STORM DRAINAGE PIPE SHALL BE LAID ON SMOOTH CONTINUOUS GRADES WITH NO VISIBLE BENDS AT JOINTS.
- 12. ALL STORM DRAINAGE INLET STRUCTURES SHALL HAVE METAL FRAME AND COVER FOR ACCESS.
- 13. THE CONTRACTOR SHALL PROVIDE ANY EXCAVATION AND MATERIAL SAMPLES NECESSARY TO CONDUCT REQUIRED SOIL TESTS. ALL ARRANGEMENTS AND SCHEDULING FOR THE TESTING SHALL BE THE CONTRACTOR'S RESPONSIBILITY.
- 14. SOILS TESTING AND ON-SITE INSPECTION SHALL BE PERFORMED BY AN INDEPENDENT GEOTECHNICAL ENGINEER. THE SOILS ENGINEER SHALL PROVIDE COPIES OF TEST REPORTS TO THE CONTRACTOR, THE OWNER AND THE OWNER'S REPRESENTATIVE AND SHALL PROMPTLY NOTIFY THE OWNER. HIS REPRESENTATIVE AND THE CONTRACTOR SHOULD WORK PERFORMED BY THE CONTRACTOR FAIL TO MEET THESE SPECIFICATIONS.
- 15. CONTRACTOR SHALL REMOVE ALL UNSUITABLE MATERIAL FROM LIMITS OF ROADWAY CONSTRUCTION AS DIRECTED BY AN INDEPENDENT GEOTECHNICAL ENGINEER. UNSUITABLE MATERIAL SHALL BE REMOVED FROM THE SITE UNLESS OTHERWISE DIRECTED.

SOIL EROSION AND SEDIMENT CONTROL NOTES

- 1. ALL DRAINAGE SWALES MUST BE GRASSED AND RIP-RAP MUST BE PLACED AS SHOWN TO CONTROL EROSION.
- 2. SILT FENCE MUST MEET THE REQUIREMENTS OF LOCAL JURISDICTIONAL AGENCY, SAID REQUIREMENTS AS SHOWN BY THESE PLANS.
- 3. DISTURBED AREAS SHALL BE VEGETATED AFTER CONSTRUCTION.
- 4. ADDITIONAL EROSION CONTROL MEASURES OR SILT BARRIERS TO BE PLACED AS SHOWN AND/OR DIRECTED BY THE PROJECT ENGINEER AND/OR LOCAL JURISDICTIONAL INSPECTOR.
- 5. WHEN ANY CONSTRUCTION BORDERS A DRAINAGE COURSE:
- A. THE CONTRACTOR IS RESPONSIBLE FOR REMOVING ANY BUILDING OR OTHER EXCAVATION SPOIL DIRT, CONSTRUCTION TRASH OR DEBRIS, ETC., FROM THE DRAINAGE AREA SHOWN HEREON IN AN EXPEDITIOUS MANNER AS CONSTRUCTION PROGRESSES.
- B. THE CONTRACTOR HEREBY AGREES TO STOP ALL WORK AND RESTORE THESE AREAS IMMEDIATELY UPON NOTIFICATION BY THE LOCAL JURISDICTIONAL INSPECTOR AND/OR PROFESSIONAL ENGINEER.
- 6. FOR ALL CONSTRUCTION ALONG AND/OR ACROSS WATERWAYS, BANK PROTECTION AND STABILIZATION SHALL BE REQUIRED AS PER LOCAL JURISDICTIONAL EROSION LAWS,
- 7. ALL EROSION CONTROL MEASURES SHALL BE IN PLACE PRIOR TO COMMENCING CONSTRUCTION AND SHALL BE MAINTAINED IN PROPER WORKING ORDER UNTIL ALL DISTURBED AREAS ARE STABILIZED. CONSTRUCTION ENTRANCE PADS SHALL BE INSTALLED BY THE CONTRACTOR AT CONSTRUCTION ACCESS POINTS PRIOR TO LAND DISTURBANCE.
- 8. A COPY OF THE APPROVED LAND DISTURBANCE PLAN SHALL BE PRESENT ON THE SITE WHENEVER LAND DISTURBING ACTIVITY IS IN PROGRESS.
- 9. CONSTRUCT SILT FENCE ALONG THE DOWNSTREAM SIDE OF ALL PROPOSED FILL CONSTRUCTION.
- 10. EROSION CONTROL DEVICES SHALL BE INSTALLED IMMEDIATELY AFTER GROUND DISTURBANCE OCCURS. THE LOCATION OF SOME OF THE EROSION CONTROL DEVICES MAY HAVE TO BE ALTERED FROM THAT SHOWN ON THE APPROVED PLANS IF DRAINAGE PATTERNS DURING CONSTRUCTION ARE DIFFERENT FROM THE FINAL PROPOSED DRAINAGE PATTERNS. IT IS THE CONTRACTOR'S RESPONSIBILITY TO ACCOMPLISH EROSION CONTROL FOR ALL DRAINAGE PATTERNS CREATED AT VARIOUS STAGES DURING CONSTRUCTION. ANY DIFFICULTY IN CONTROLLING EROSION DURING ANY PHASE OF CONSTRUCTION SHALL BE REPORTED TO THE ENGINEER IMMEDIATELY.
- 11. CONTRACTOR SHALL MAINTAIN ALL EROSION CONTROL MEASURES UNTIL PERMANENT VEGETATION HAS BEEN ESTABLISHED. CONTRACTOR SHALL CLEAN OUT ALL SEDIMENT PONDS WHEN REQUIRED BY THE ENGINEER OR LOCAL JURISDICTIONAL INSPECTOR, CONTRACTOR SHALL INSPECT EROSION CONTROL MEASURES AT THE END OF EACH WORKING DAY TO ENSURE MEASURES ARE FUNCTIONING PROPERLY.
- 12. THE CONTRACTOR SHALL REMOVE ACCUMULATED SILT WHEN THE SILT IS WITHIN 12" OF THE TOP OF THE SILT FENCE UTILIZED FOR EROSION CONTROL. IN THE DETENTION POND, SILT SHALL BE REMOVED WHEN A DEPTH OF 18" HAS ACCUMULATED AT THE WEIR.
- 13. ALL EASEMENTS DISTURBED MUST BE DRESSED AND GRASSED TO CONTROL EROSION IN ACCORDANCE WITH EASEMENT PLATS PRIOR ACCEPTANCE.
- 14. SILT BARRIERS TO BE PLACED AT DOWNSTREAM TOE OF ALL CUT AND FILL SLOPES.

- 15. THE CONTRACTOR SHALL FURNISH AND MAINTAIN ALL NECESSARY BARRICADES AROUND THE WORK AND SHALL PROVIDE PROTECTION AGAINST WATER DAMAGE AND SOIL EROSION.
- 16. TREE PROTECTION AND EROSION CONTROL MEASURES ARE TO BE ACCOMPLISHED PRIOR TO ANY OTHER CONSTRUCTION ON THE SITE AND MAINTAINED UNTIL PERMANENT GROUND COVER IS ESTABLISHED.
- 17. ALL SILT BARRIERS MUST BE PLACED AS ACCESS IS OBTAINED DURING CLEARING. NO GRADING SHALL BE DONE UNTIL SILT BARRIER AND DETENTION FACILITIES ARE CONSTRUCTED.
- 18. ALL SEDIMENT CONTROL DEVICES ARE TO BE CONSTRUCTED AND FULLY OPERATIONAL PRIOR TO ANY OTHER CONSTRUCTION OR GRADING.
- 19. ALL DISTURBED AREAS TO BE GRASSED AS SOON AS POSSIBLE.
- 20. ALL SLOPES SHALL BE STABILIZED AS SOON AS POSSIBLE.
- 21. GRASS AREAS DISTURBED DURING CONSTRUCTION SHALL BE REPLACED WITH GRASS IN KIND. IN AREAS OF INDECIPHERABLE GRASSES-USE FESCUE.
- 22. IT IS THE CONTRACTOR'S RESPONSIBILITY TO PERFORM REQUIRED MAINTENANCE OF ALL EROSION AND SEDIMENT CONTROL DEVICES TO ENSURE THEIR FUNCTION AT ALL TIMES.
- 23. LENGTH OF RIP RAP AREA SHALL BE 6(SIX) TIMES THE DIAMETER OF THE STORM DRAIN PIPE. WIDTH OF RIP RAP AREA SHALL BE THREE(3) TIMES THE DIAMETER AT THE MOUTH OF THE PIPE AND TWO(2) TIMES THE DIAMETER AT THE DOWNSTREAM END.

SITE NOTES

- 1. ALL CONCRETE SHALL BE CLASS A, 3,000 PSI AT 28 DAYS COMPRESSIVE STRENGTH WITH A MAXIMUM SLUMP OF 4" UNLESS NOTED OTHERWISE. ALL EXPOSED CONCRETE TO HAVE A FINE BROOM FINISH.
- 2. ALL MATERIALS SHALL BE NEW UNLESS USED OR SALVAGED MATERIALS ARE AUTHORIZED BY THE OWNER OR TENANT.
- 3. ALL DIMENSIONS ARE FACE OF CURB AND FACE OF BUILDING OR AS NOTED.
- 4. NECESSARY BARRICADES, SUFFICIENT LIGHTS, SIGNS AND OTHER TRAFFIC CONTROL METHODS AS MAY BE NECESSARY PER MANUAL ON UNIFORM TRAFFIC CONTROL DEVICES, PART VI, SHALL BE PROVIDED AND MAINTAINED THROUGHOUT CONSTRUCTION
- 5. ALL SIDEWALK ENTRANCES AND EXITS SHALL HAVE TRUNCATED DOMES AS SPECIFIED IN SPECIAL DRAWING NO. SW-618, INDEX NO. 734 OF THE ALABAMA DEPARTMENT OF TRANSPORTATION (ALDOT) SPECIAL AND STANDARD HIGHWAY DRAWING MANUAL.
- 6. THE CONTRACTOR IS RESPONSIBLE FOR SECURING A LAY DOWN YARD.
- 7. CONTRACTOR SHALL NOT OVERLAY BRICK AND/OR CONCRETE DRIVEWAYS WITHOUT APPROVAL FROM THE PROJECT ENGINEER.

ENGINEER: SAWGRASS CONSULTING, LLC. (251) 544-7900 (OFFICE) (251) 544-7918 (FAX)

NUMBER:	REVISION:	DATE:




PROJECT NOTES


WILDERNESS CENTER AND TRAIL SHOP


CITY OF ORANGE BEACH




munn,	SCALE:		NTS		
CENSEO	DATE:		MAY 20	21	
No. 30410 *	DRAWN B	Y:	KL		
A LANDENHICK	CHECKED	BY:	JR		
annin.	SHEET:	2	OF	15	

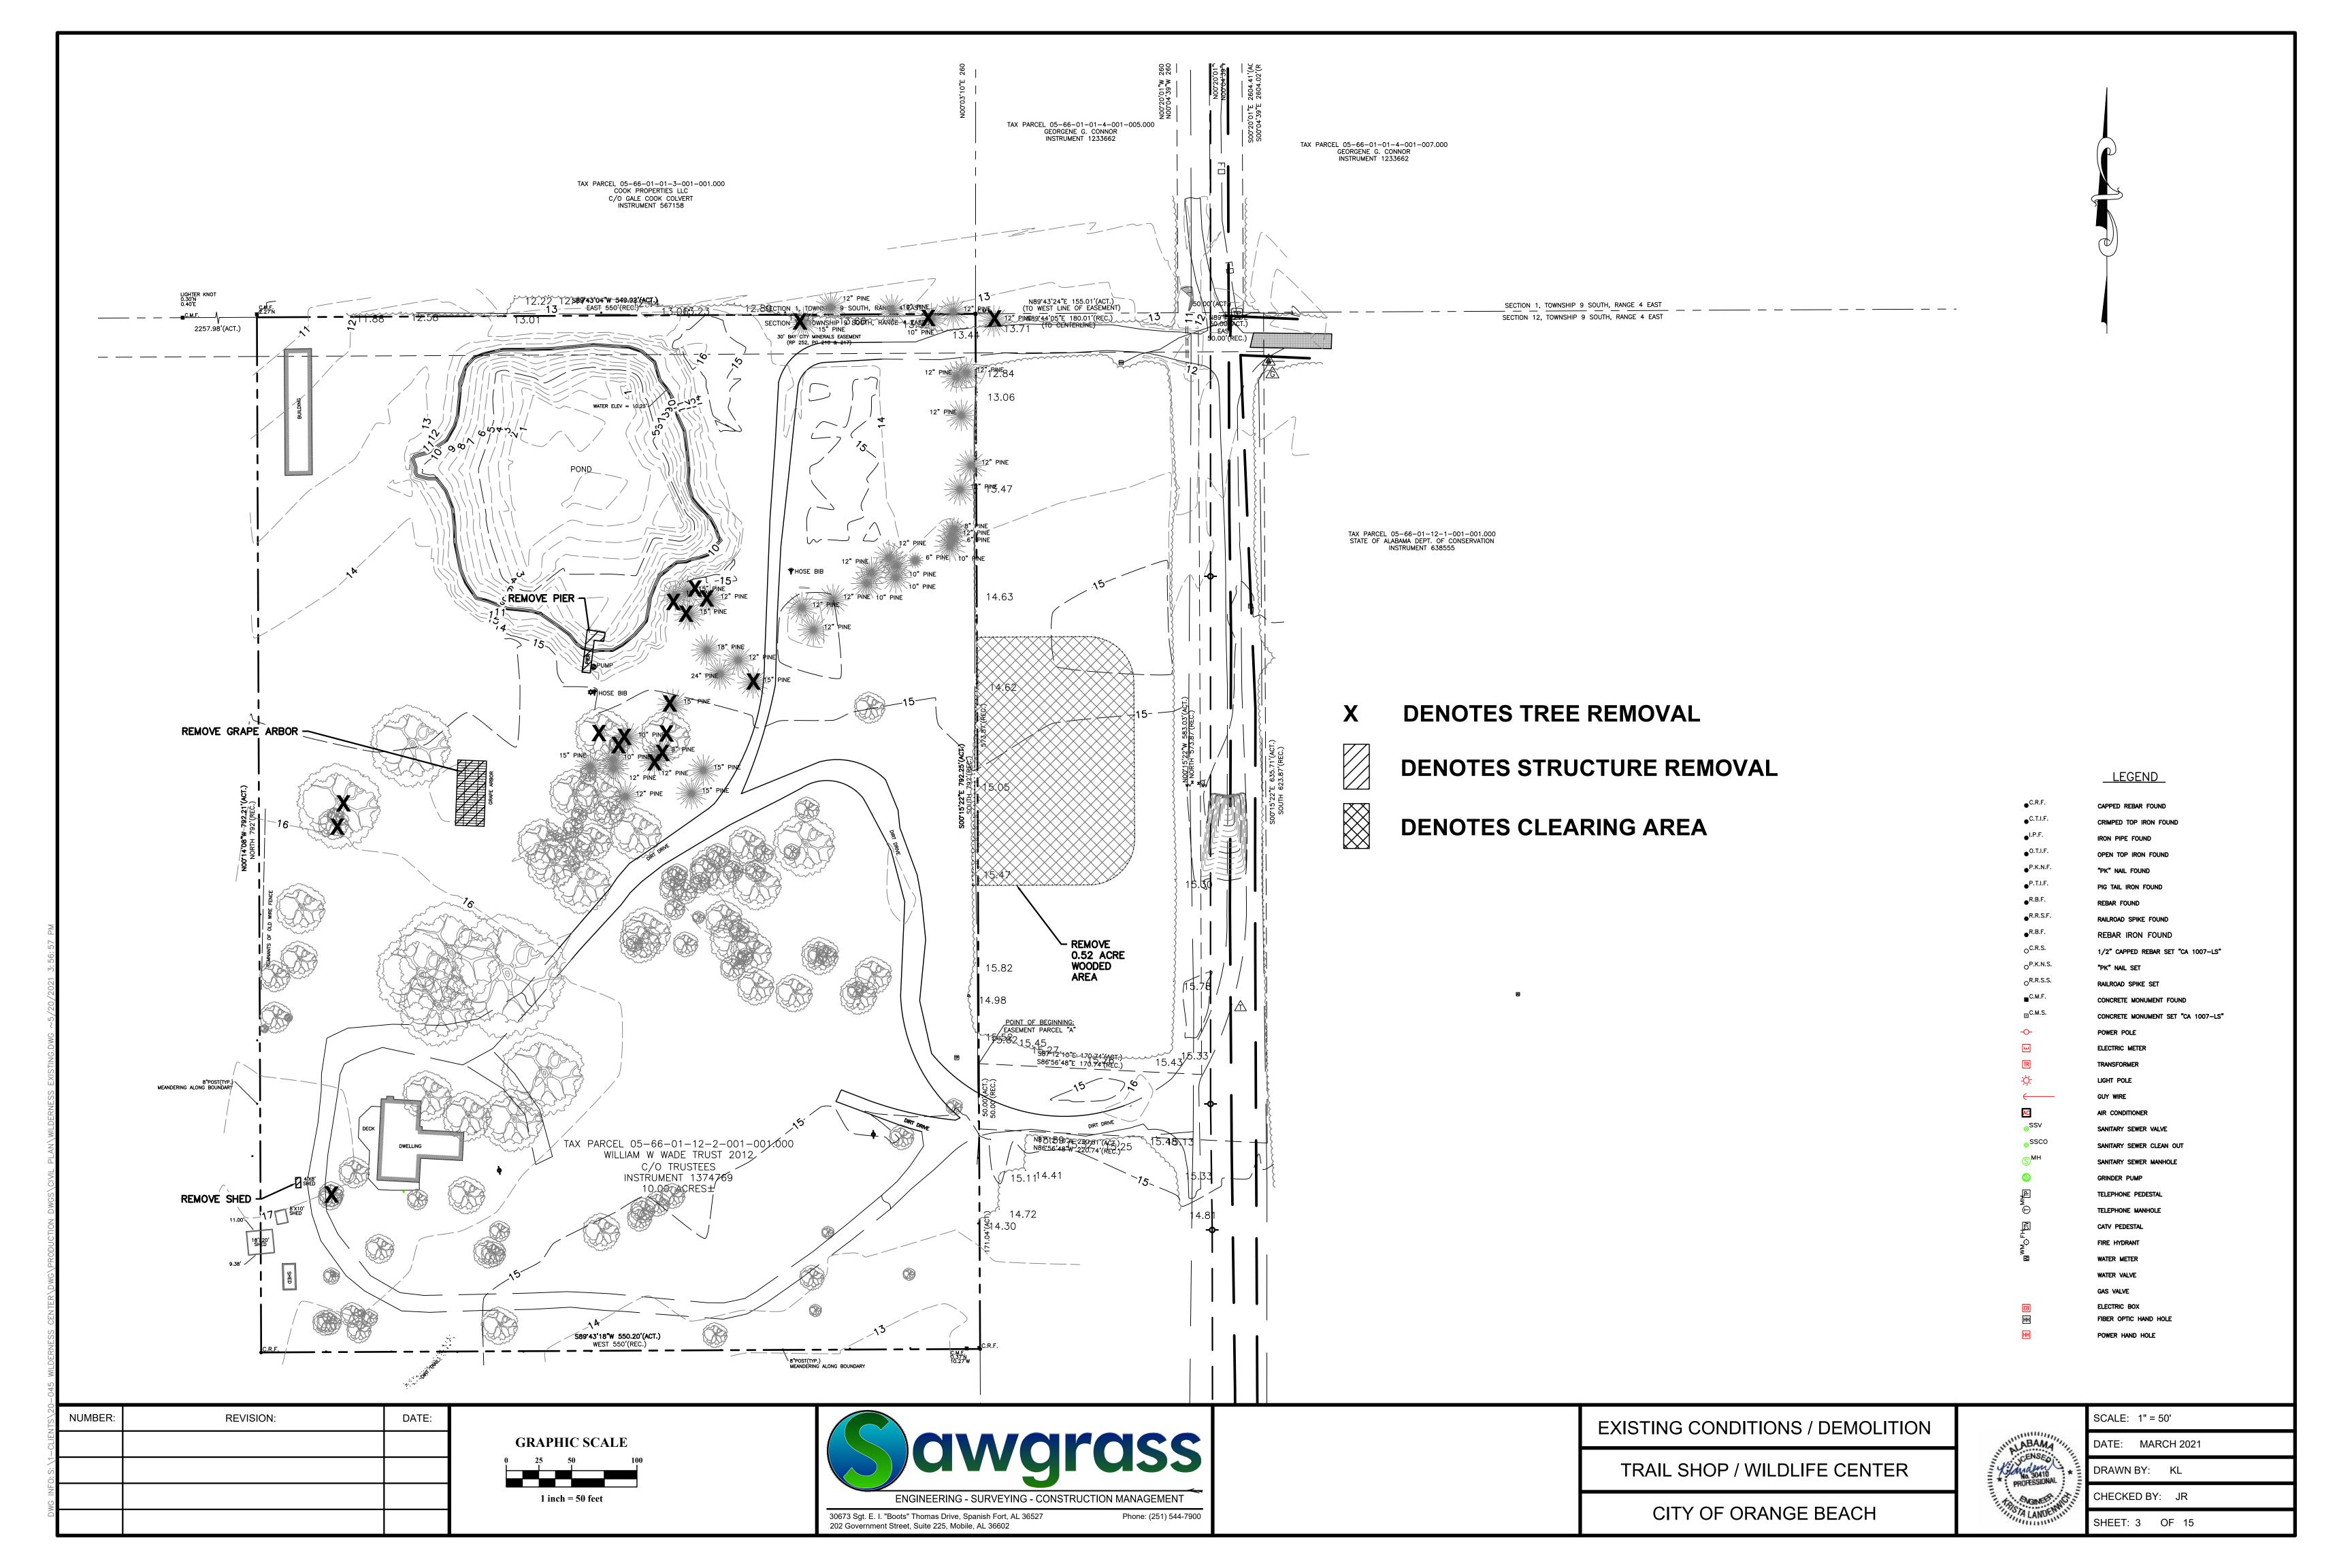

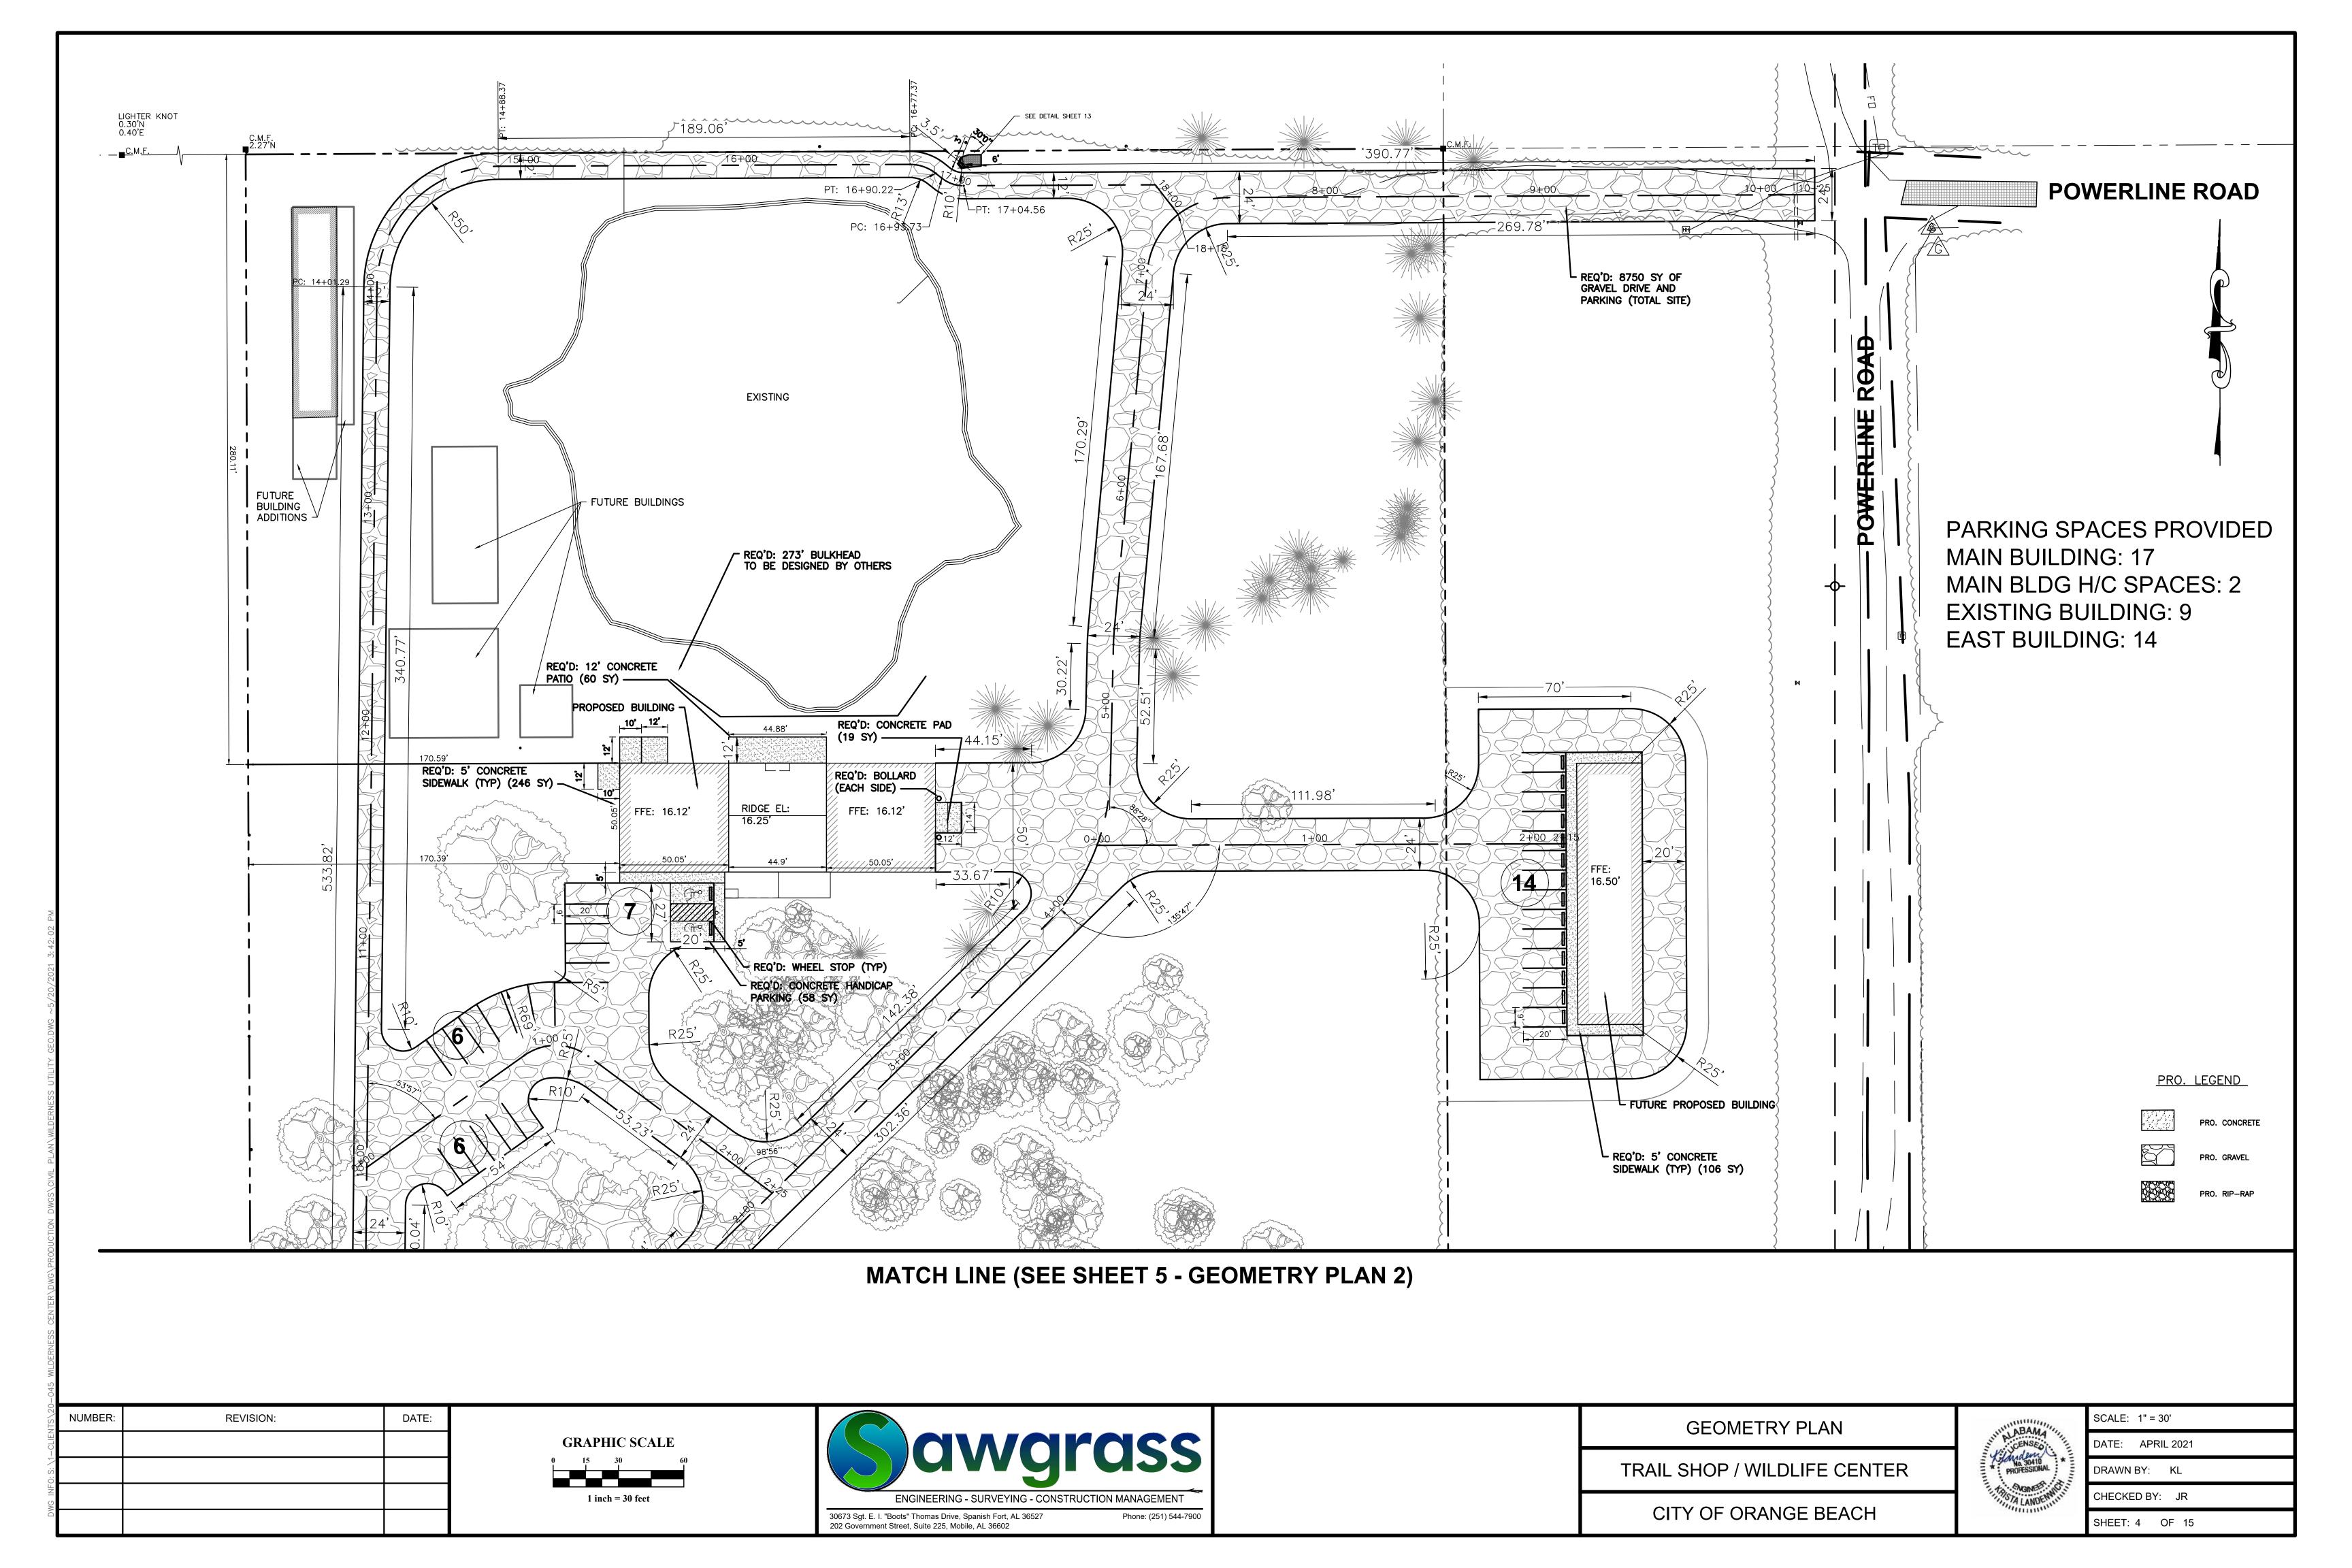


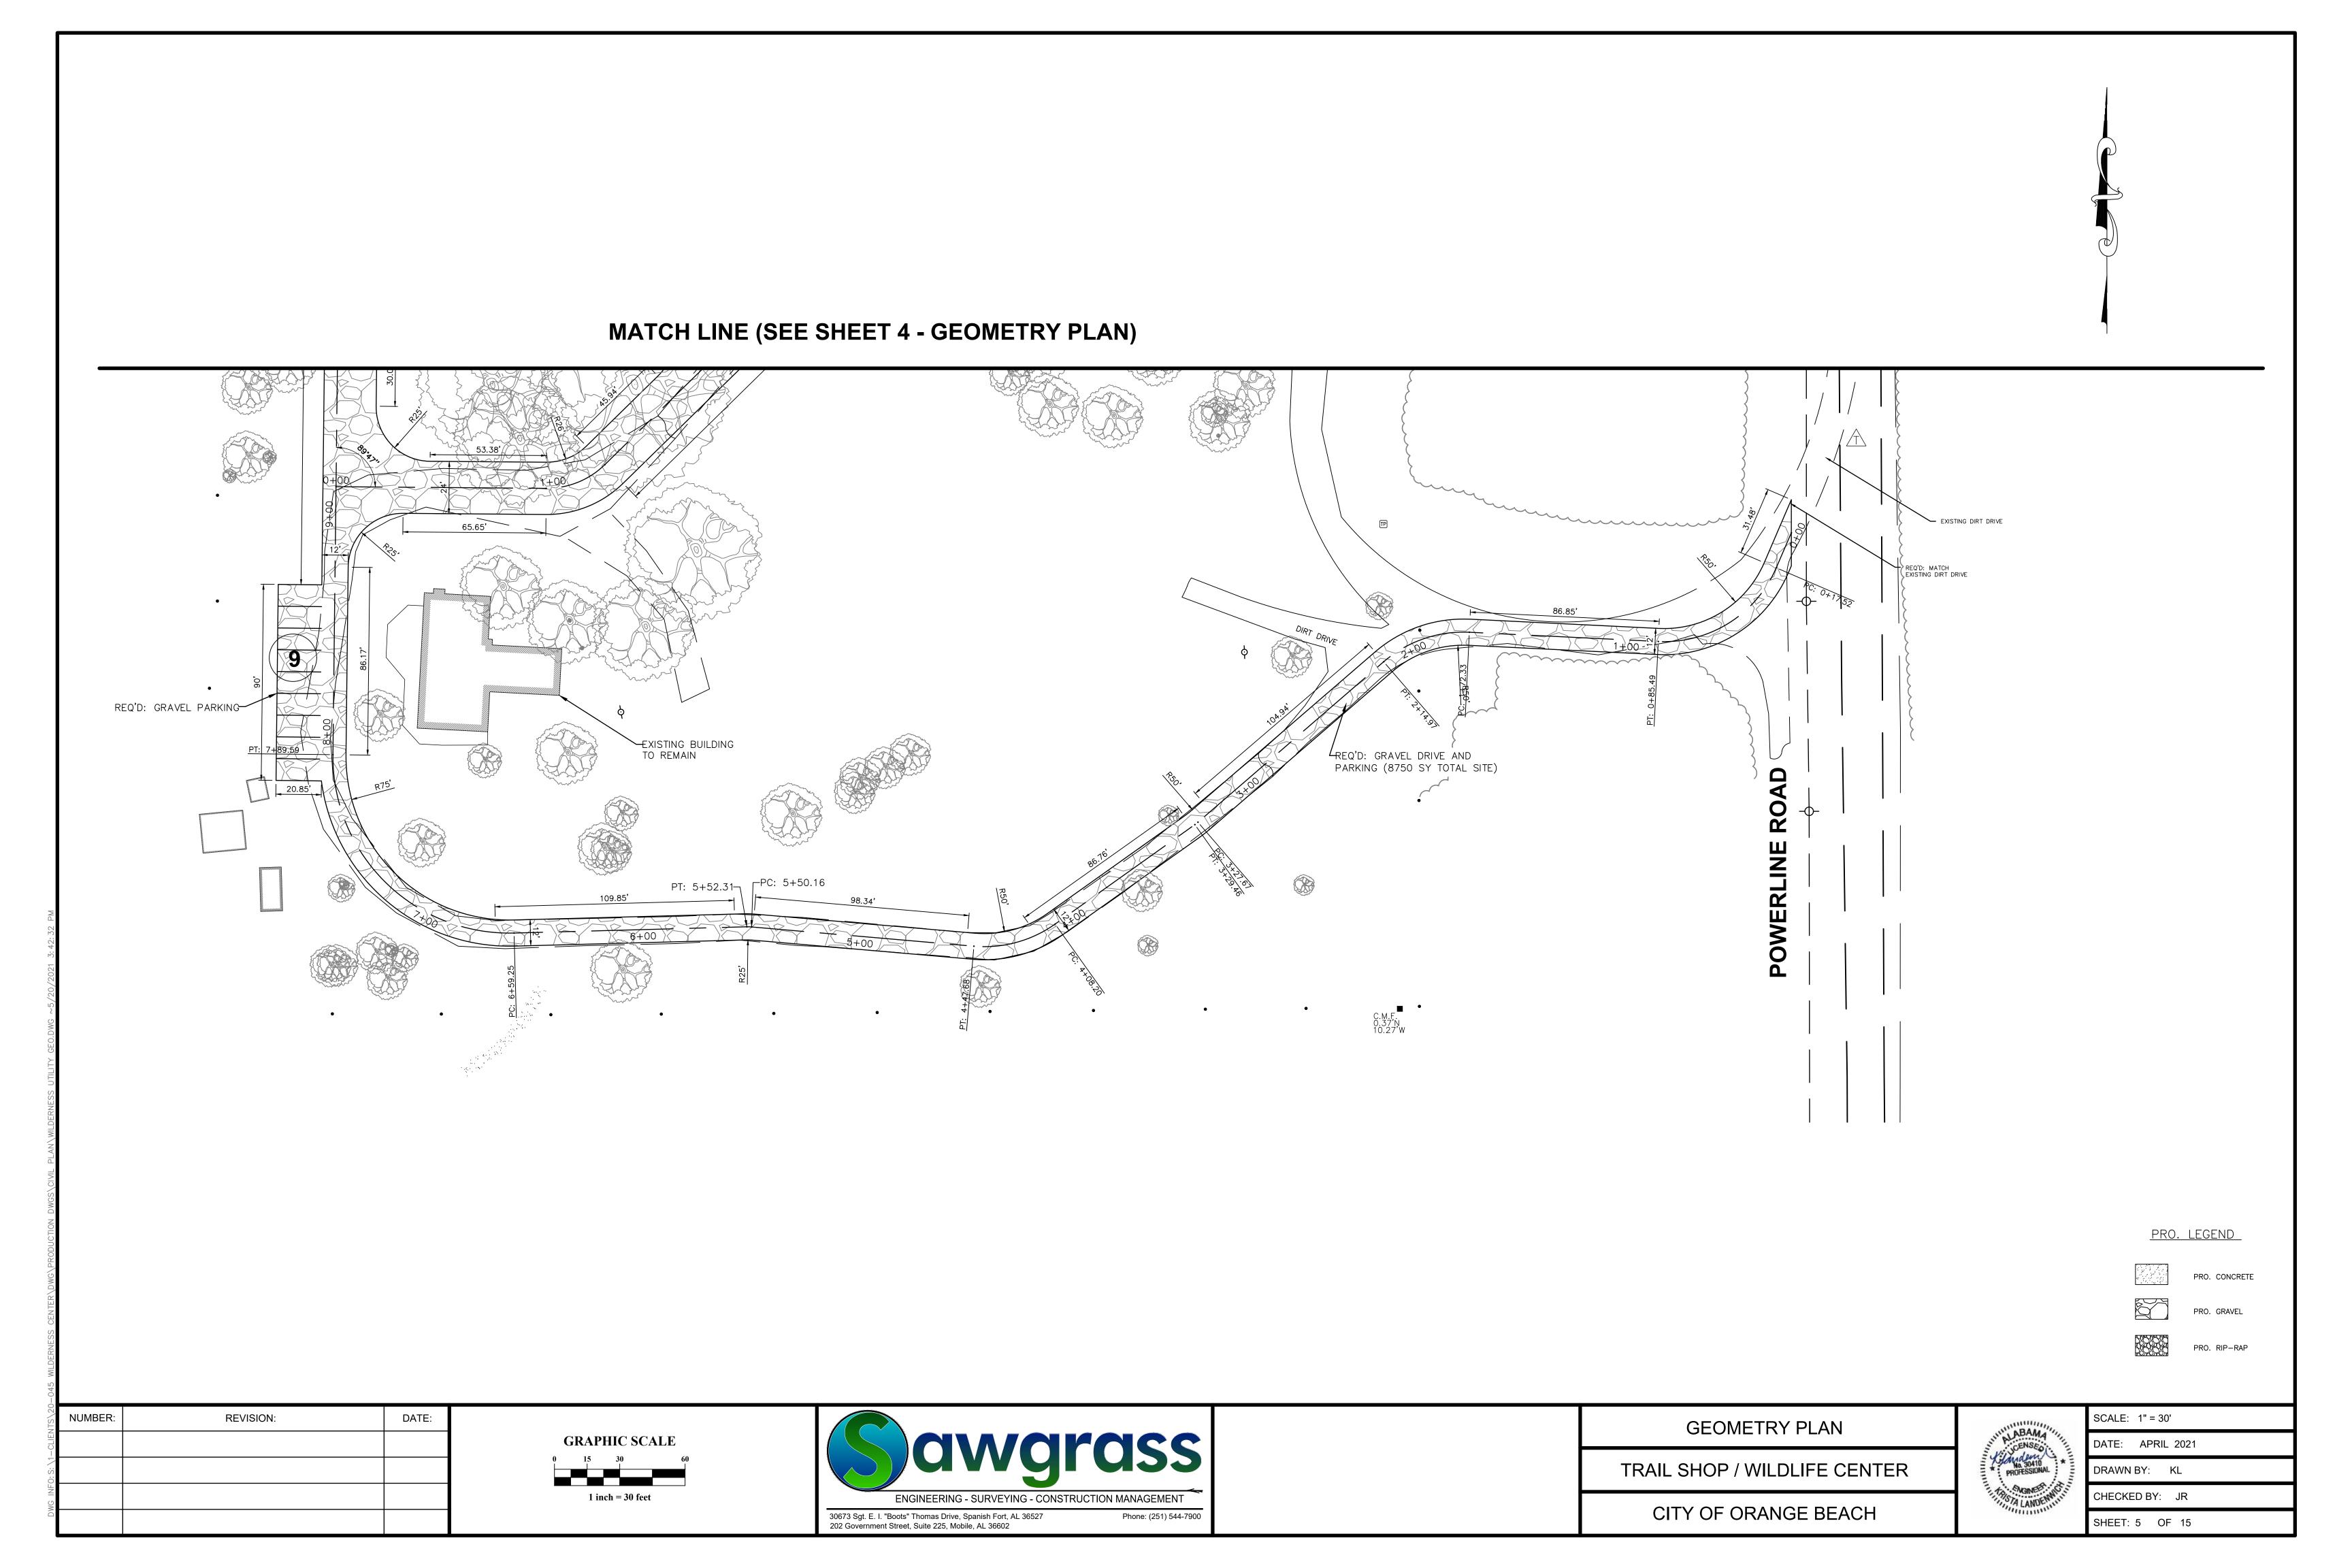

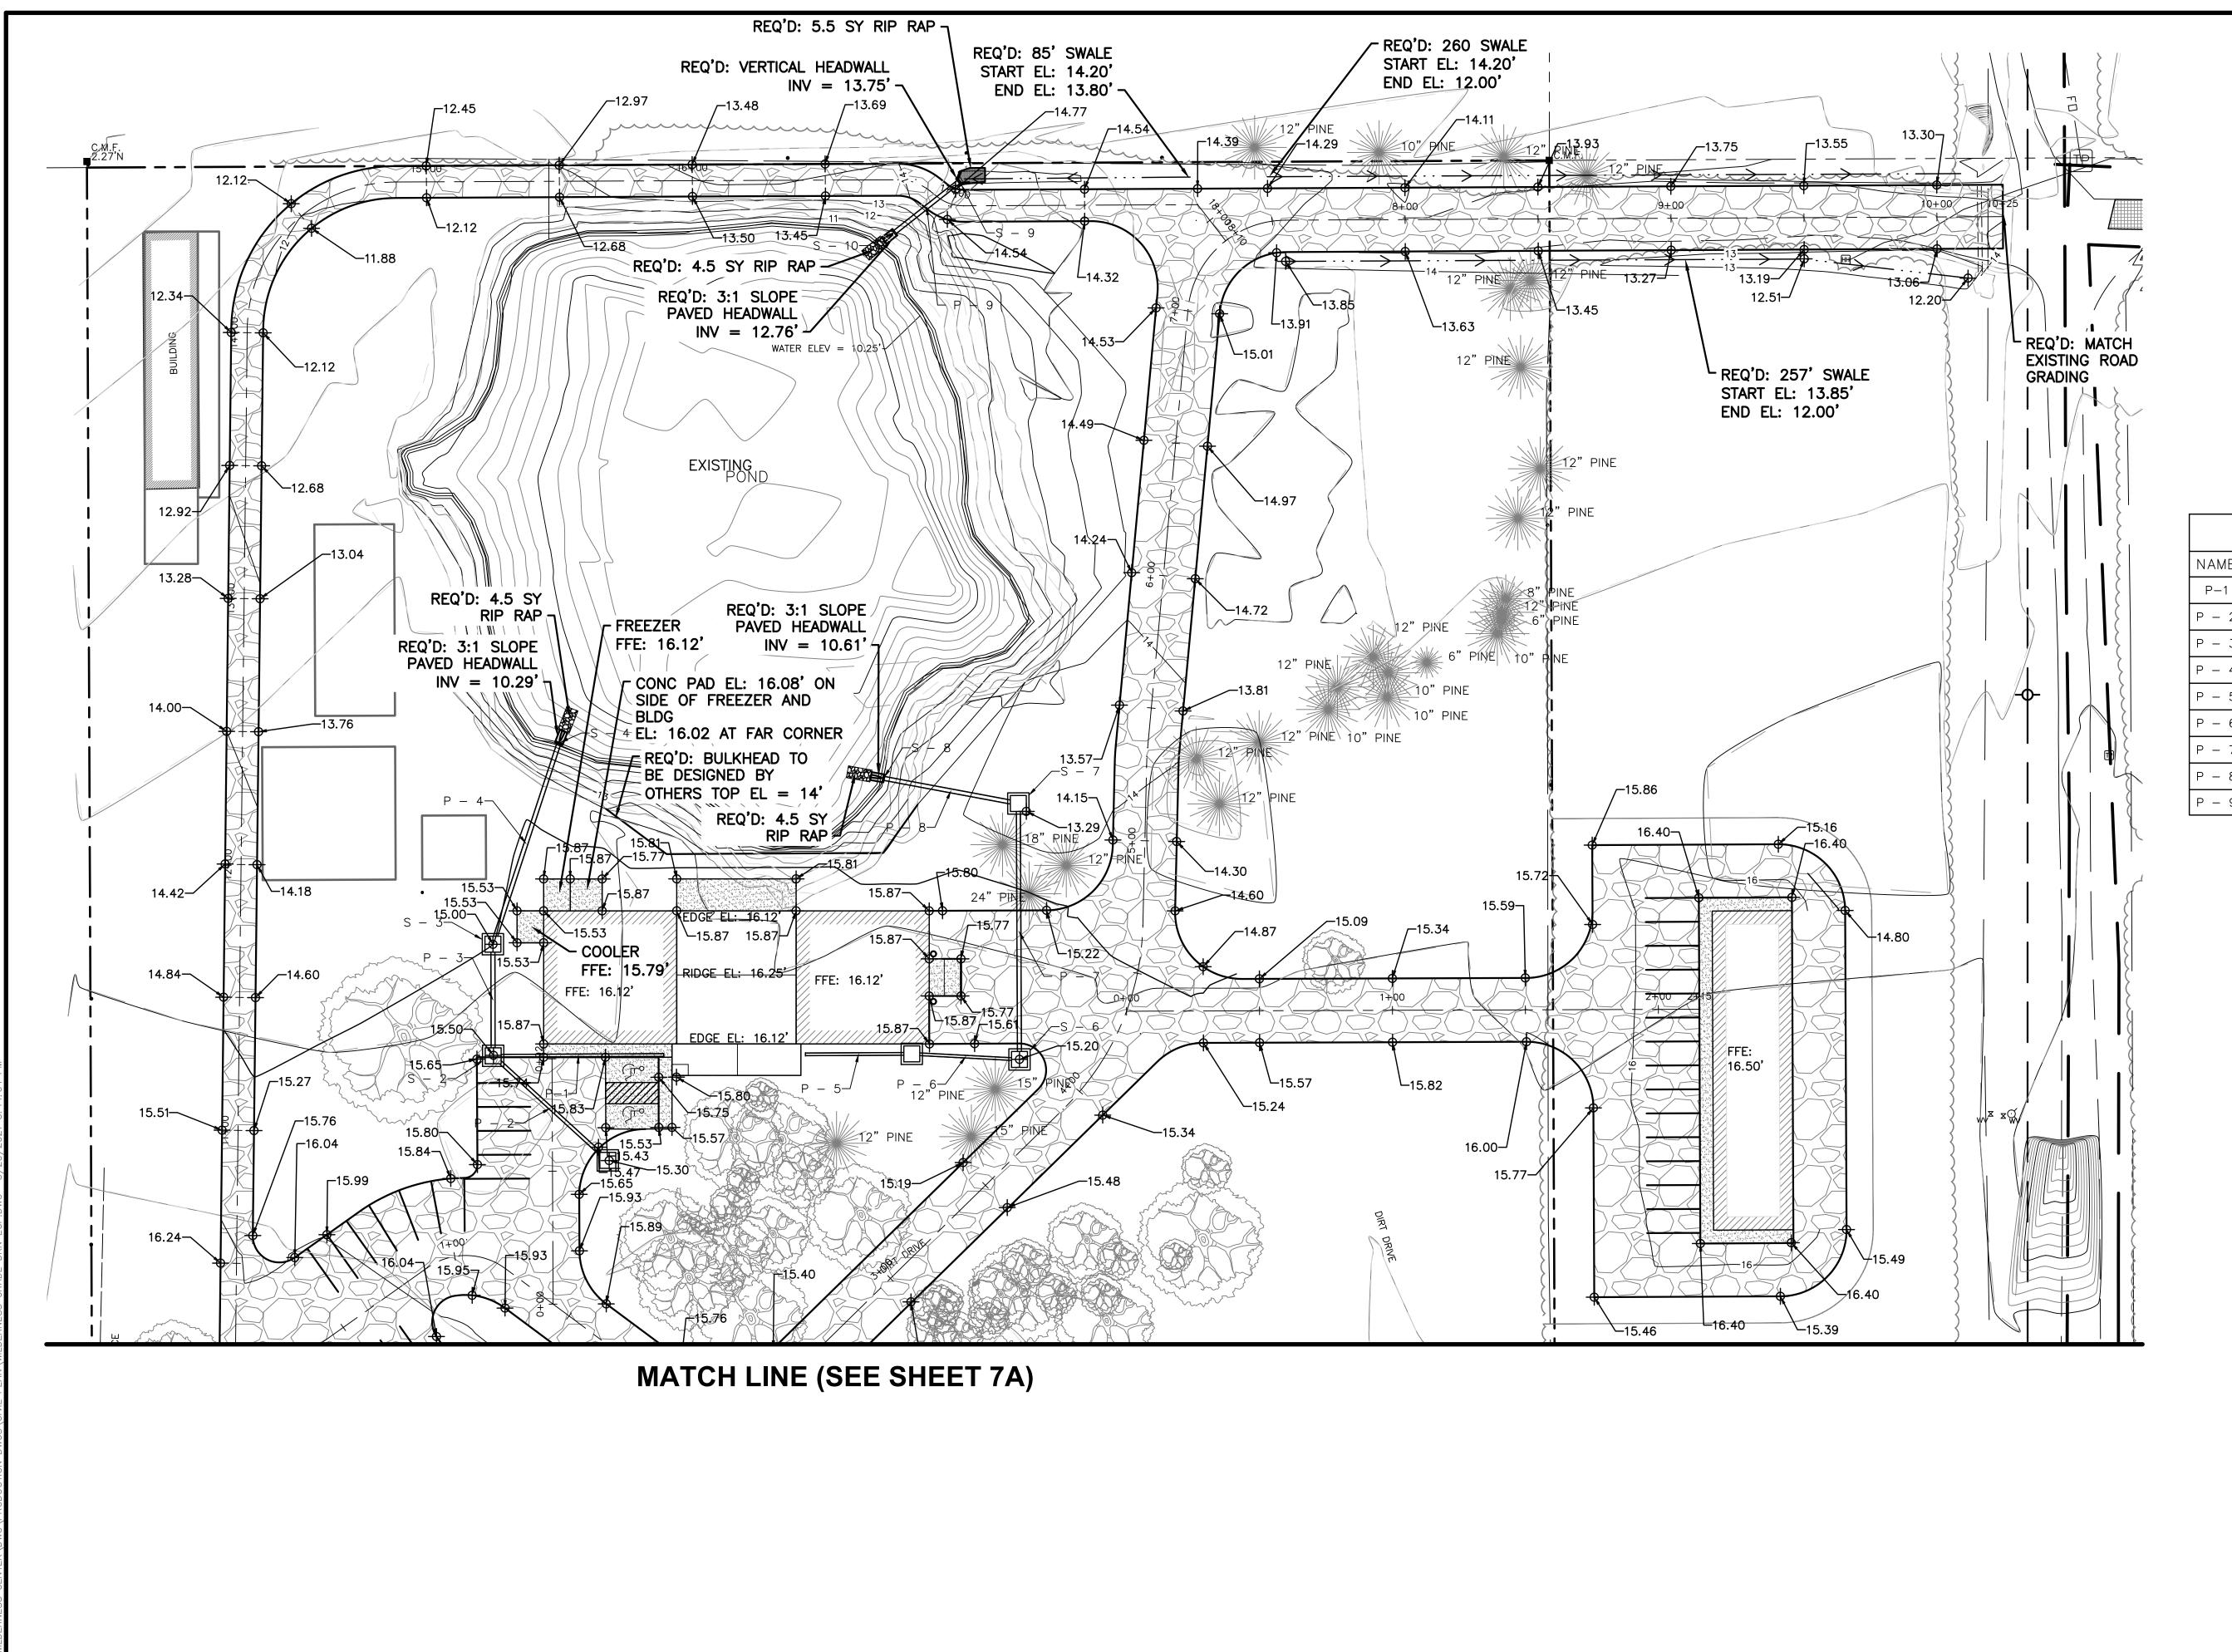

	STRUCTURE SCHEDULE			
NAME	RIM EL	INV IN	INV OUT	
S - 1	16.49		12.30 (P - 2)	
S - 2	16.19	11.59 (P-1) 11.72 (P - 2)	11.72 (P - 3)	
S - 3	15.56	11.09 (P - 3)	11.09 (P - 4)	
S - 4	12.43	10.29 (P - 4)		
S - 5	15.85	11.76 (P - 5)	11.76 (P - 6)	
S - 6	15.82	11.35 (P - 6)	11.35 (P - 7)	
S - 7	15.34	10.87 (P - 7)	10.87 (P - 8)	
S - 8	12.75	10.61 (P - 8)		
S - 9	15.88		13.75 (P - 9)	
S - 10	14.90	12.76 (P - 9)		

	Pipe Table					
NAME	SIZE	LENGTH	SLOPE	MATERIAL	INVERT	INVERT
P-1	12"	64.17'	0.50%	Corrugated HDPE Pipe	11.91	11.59
P - 2	15"	58.35'	1.00%	Corrugated HDPE Pipe	12.30	11.72
P - 3	18"	41.96'	1.50%	Corrugated HDPE Pipe	11.72	11.09
P - 4	18"	79.69'	1.00%	Corrugated HDPE Pipe	11.09	10.29
P - 5	12"	40.00'	1.48%	Corrugated HDPE Pipe	12.35	11.76
P - 6	12"	40.55	1.00%	Corrugated HDPE Pipe	11.76	11.35
P - 7	18"	96.26'	0.50%	Corrugated HDPE Pipe	11.35	10.87
P - 8	18"	51.60'	0.50%	Corrugated HDPE Pipe	10.87	10.61
P - 9	18"	30.89'	3.20%	REINFORCED CONCRETE PIPE	13.75	12.76

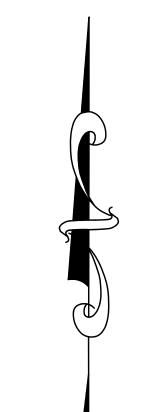


PRO. LEGEND

PRO. CONCRETE

PRO. GRAVEL

REVISION: NUMBER:

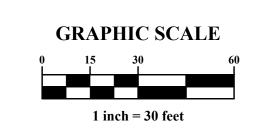




GRADING AND DRAINAGE

CITY OF ORANGE BEACH

TRAIL SHOP/WILDERNESS CENTER



Thursday	SCALE: 1" = 30'
	DATE: MAY 2021
	DRAWN BY: KL
	CHECKED BY: JR
	SHEET: 6 OF 15

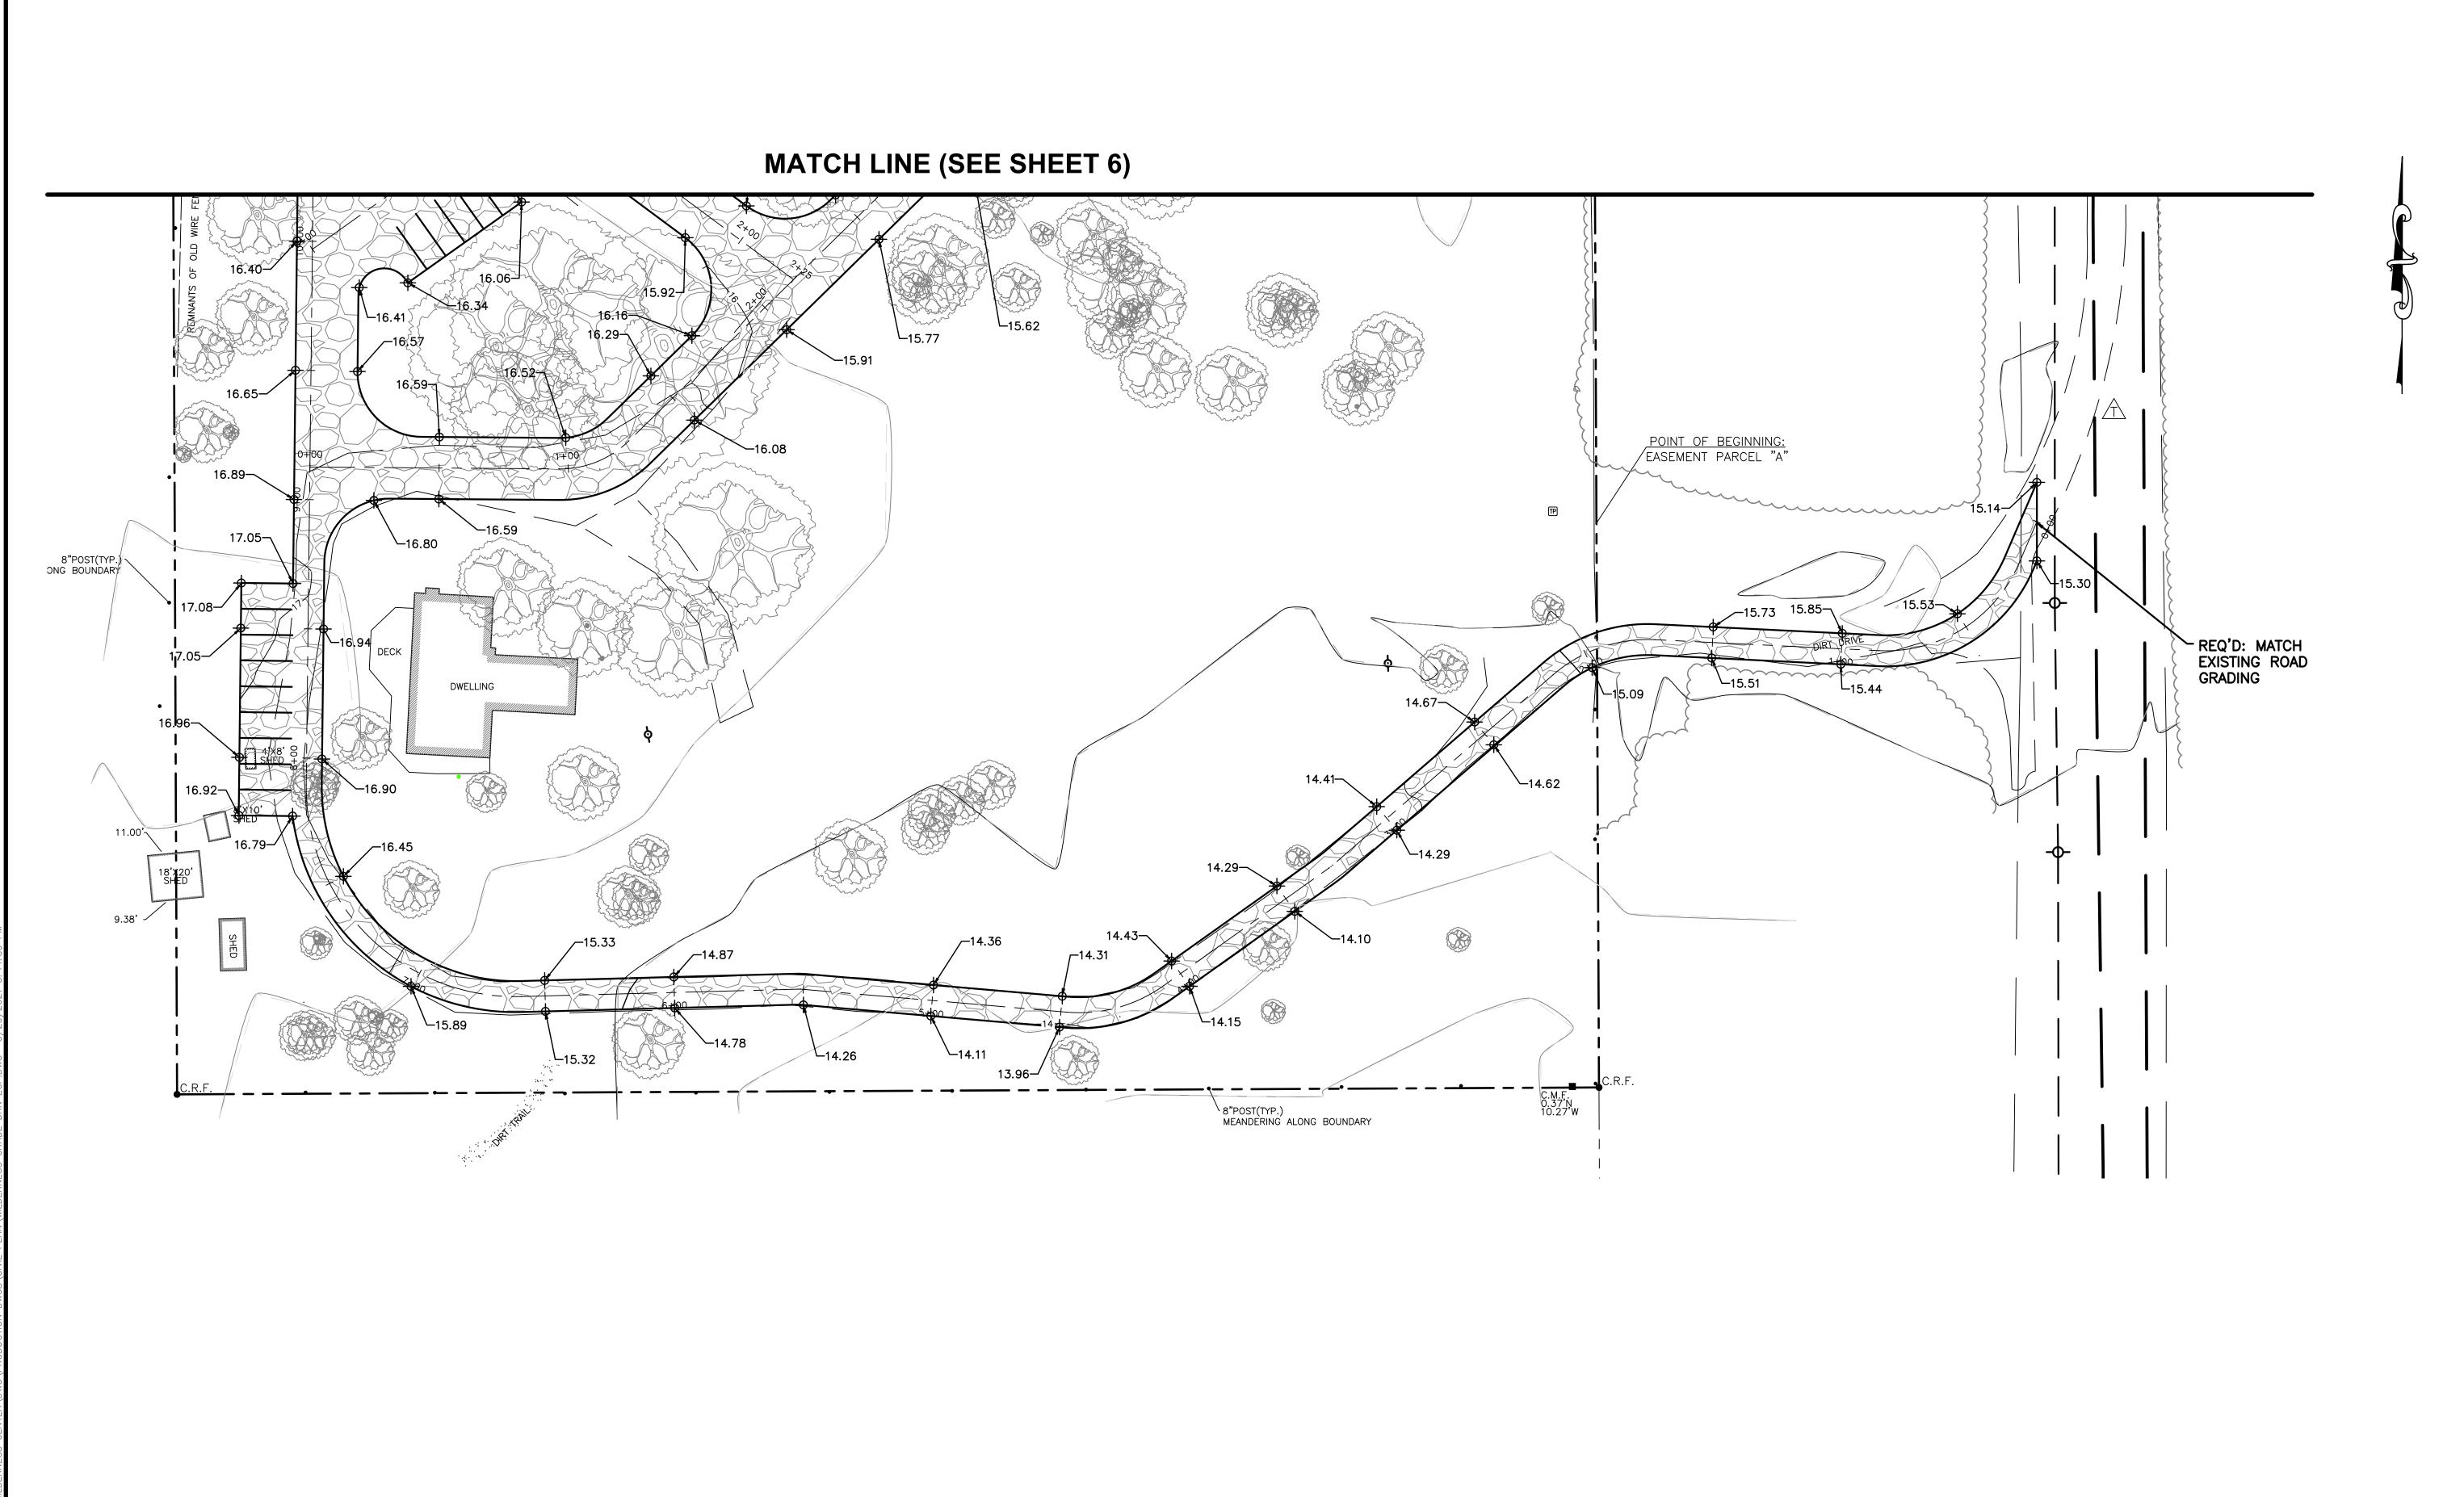

PRO. LEGEND

PRO. CONCRETE

PRO. RIP-RAP

NUMBER: REVISION: DATE:

GRAPHIC SCALE

0 15 30 60

1 inch = 30 feet




GRADING AND DRAINAGE 2	
TRAIL SHOP/WILDERNESS CENTER	


CITY OF ORANGE BEACH


, si	ALABAMA"	,
111111111	Jandens Ma 30410	M. * !!
THE STATE OF	PROFESSIONEE NO	THE STATE OF
~	A LANDEN	


4.	SCALE: 1" = 30'
Maria	DATE: MAY 2021
,,,,,,,,	DRAWN BY: KL
W. T. T.	CHECKED BY: JR

SHEET: 7A OF 15

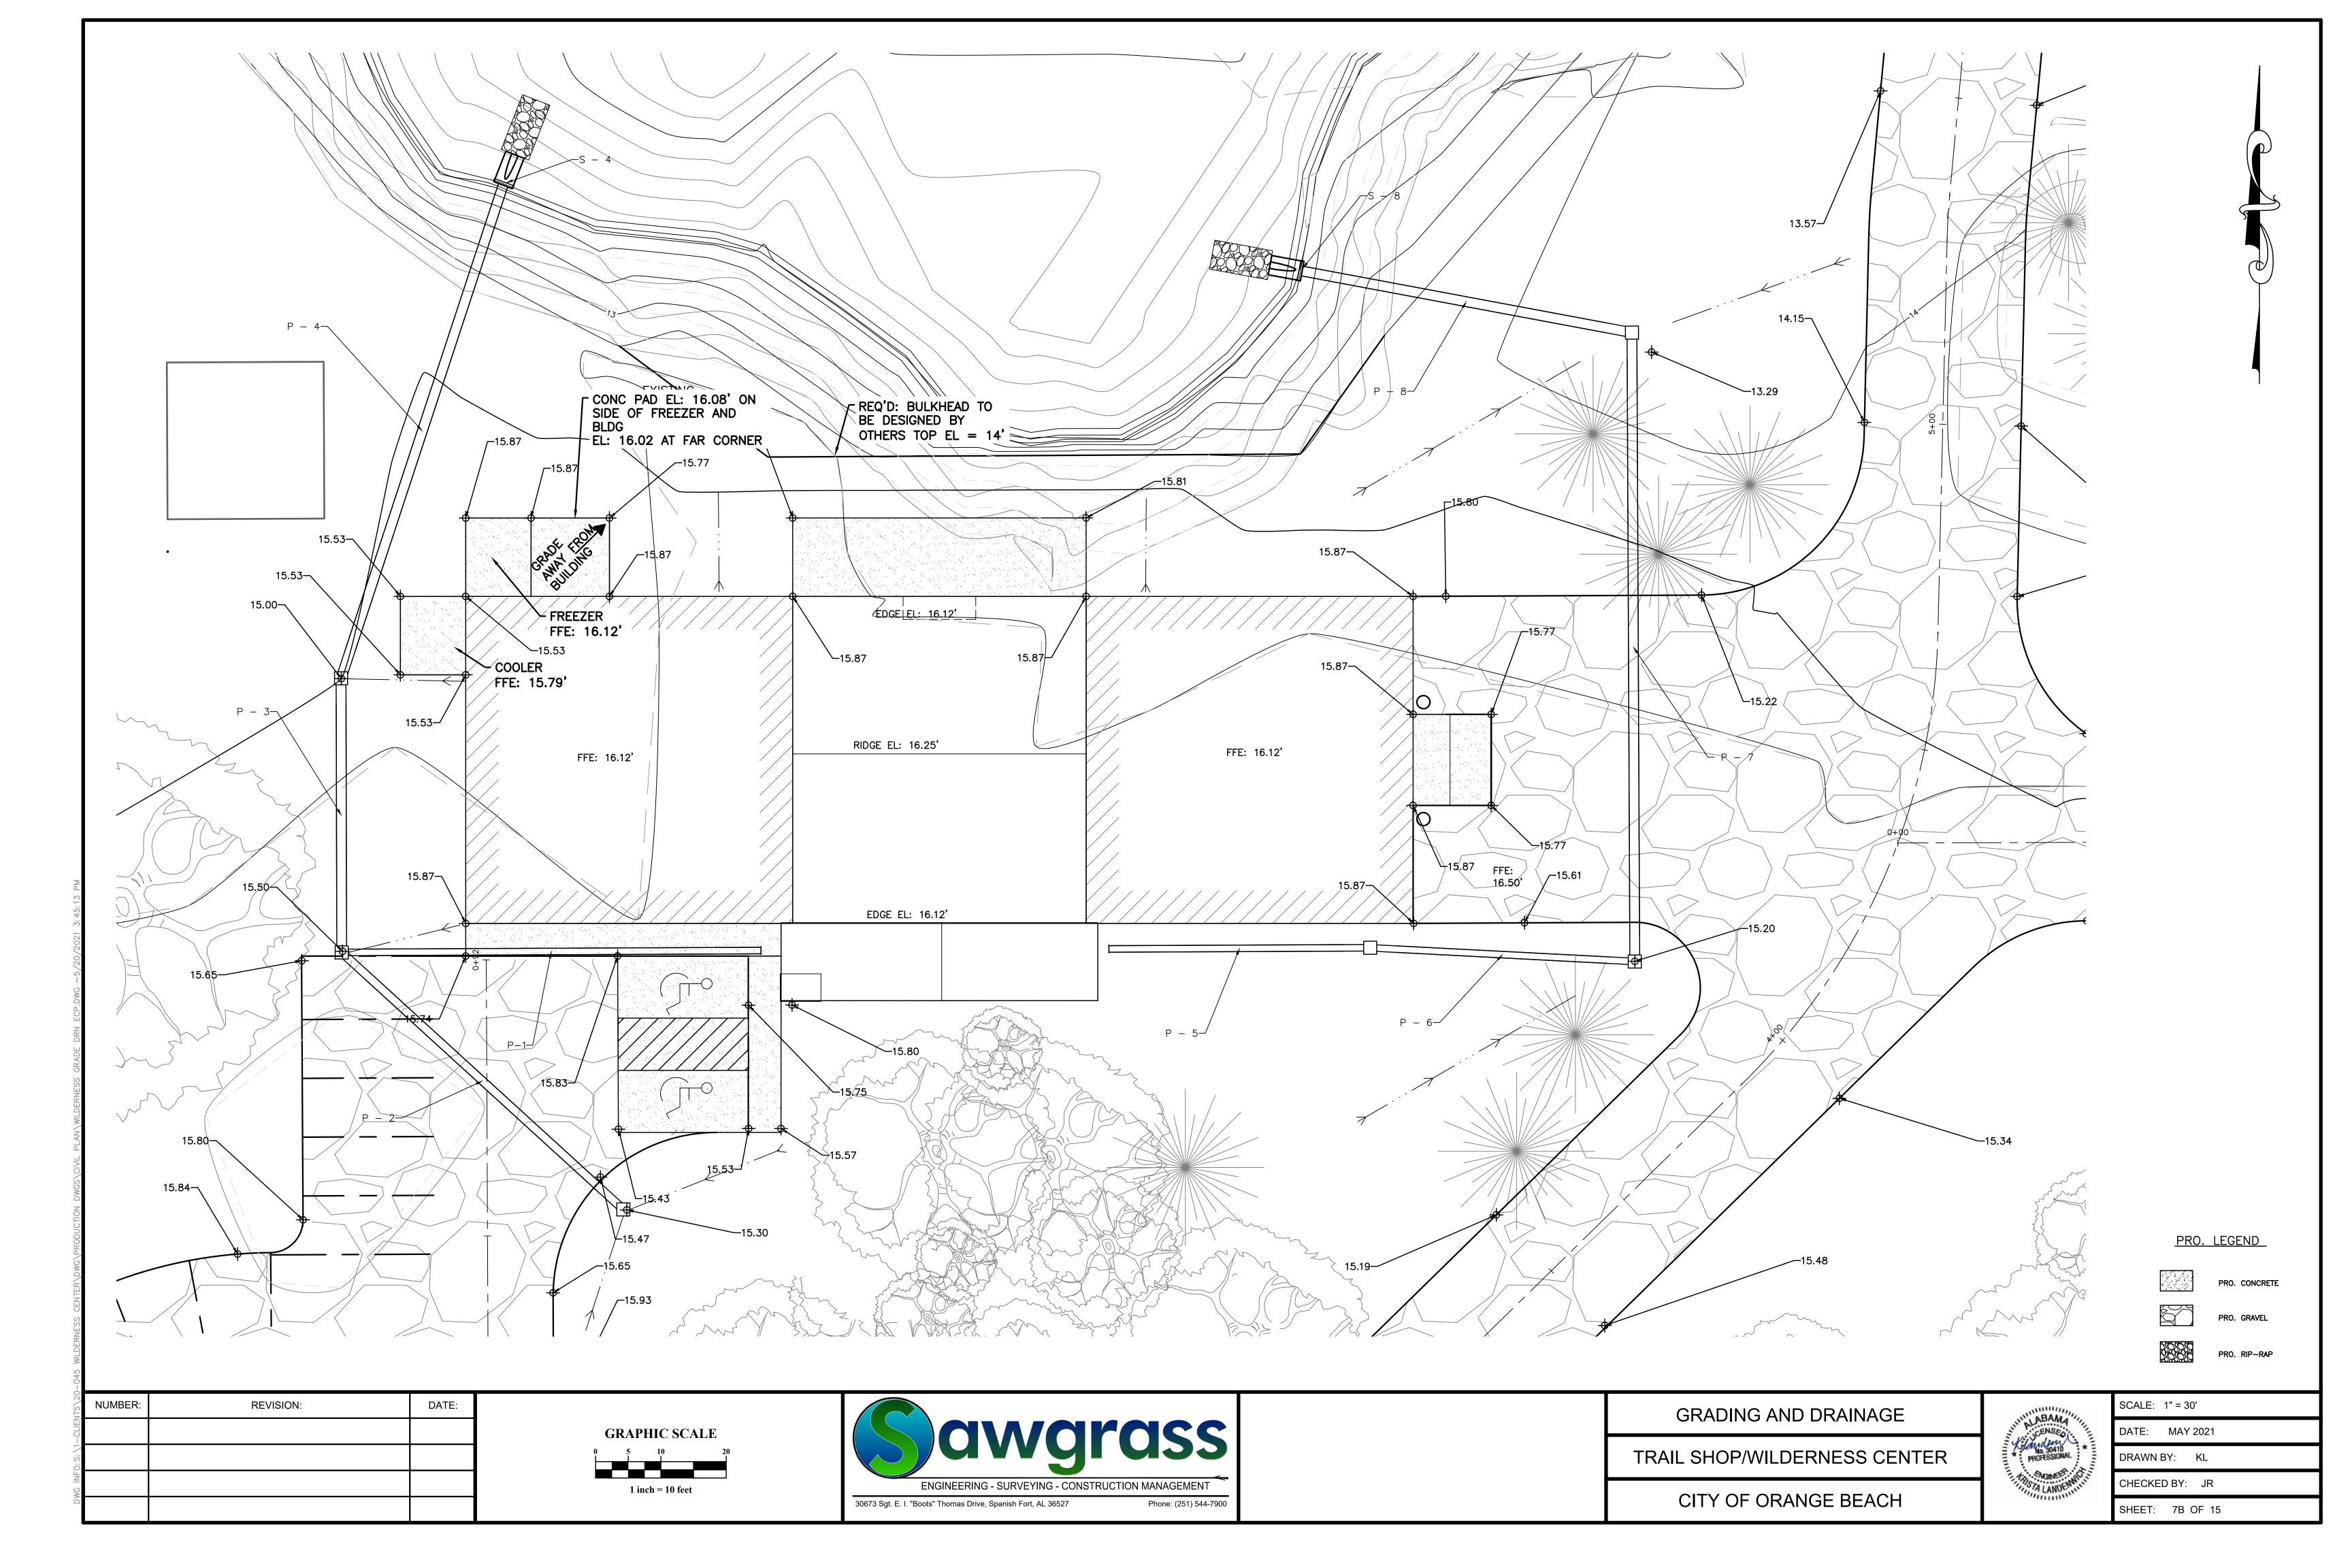

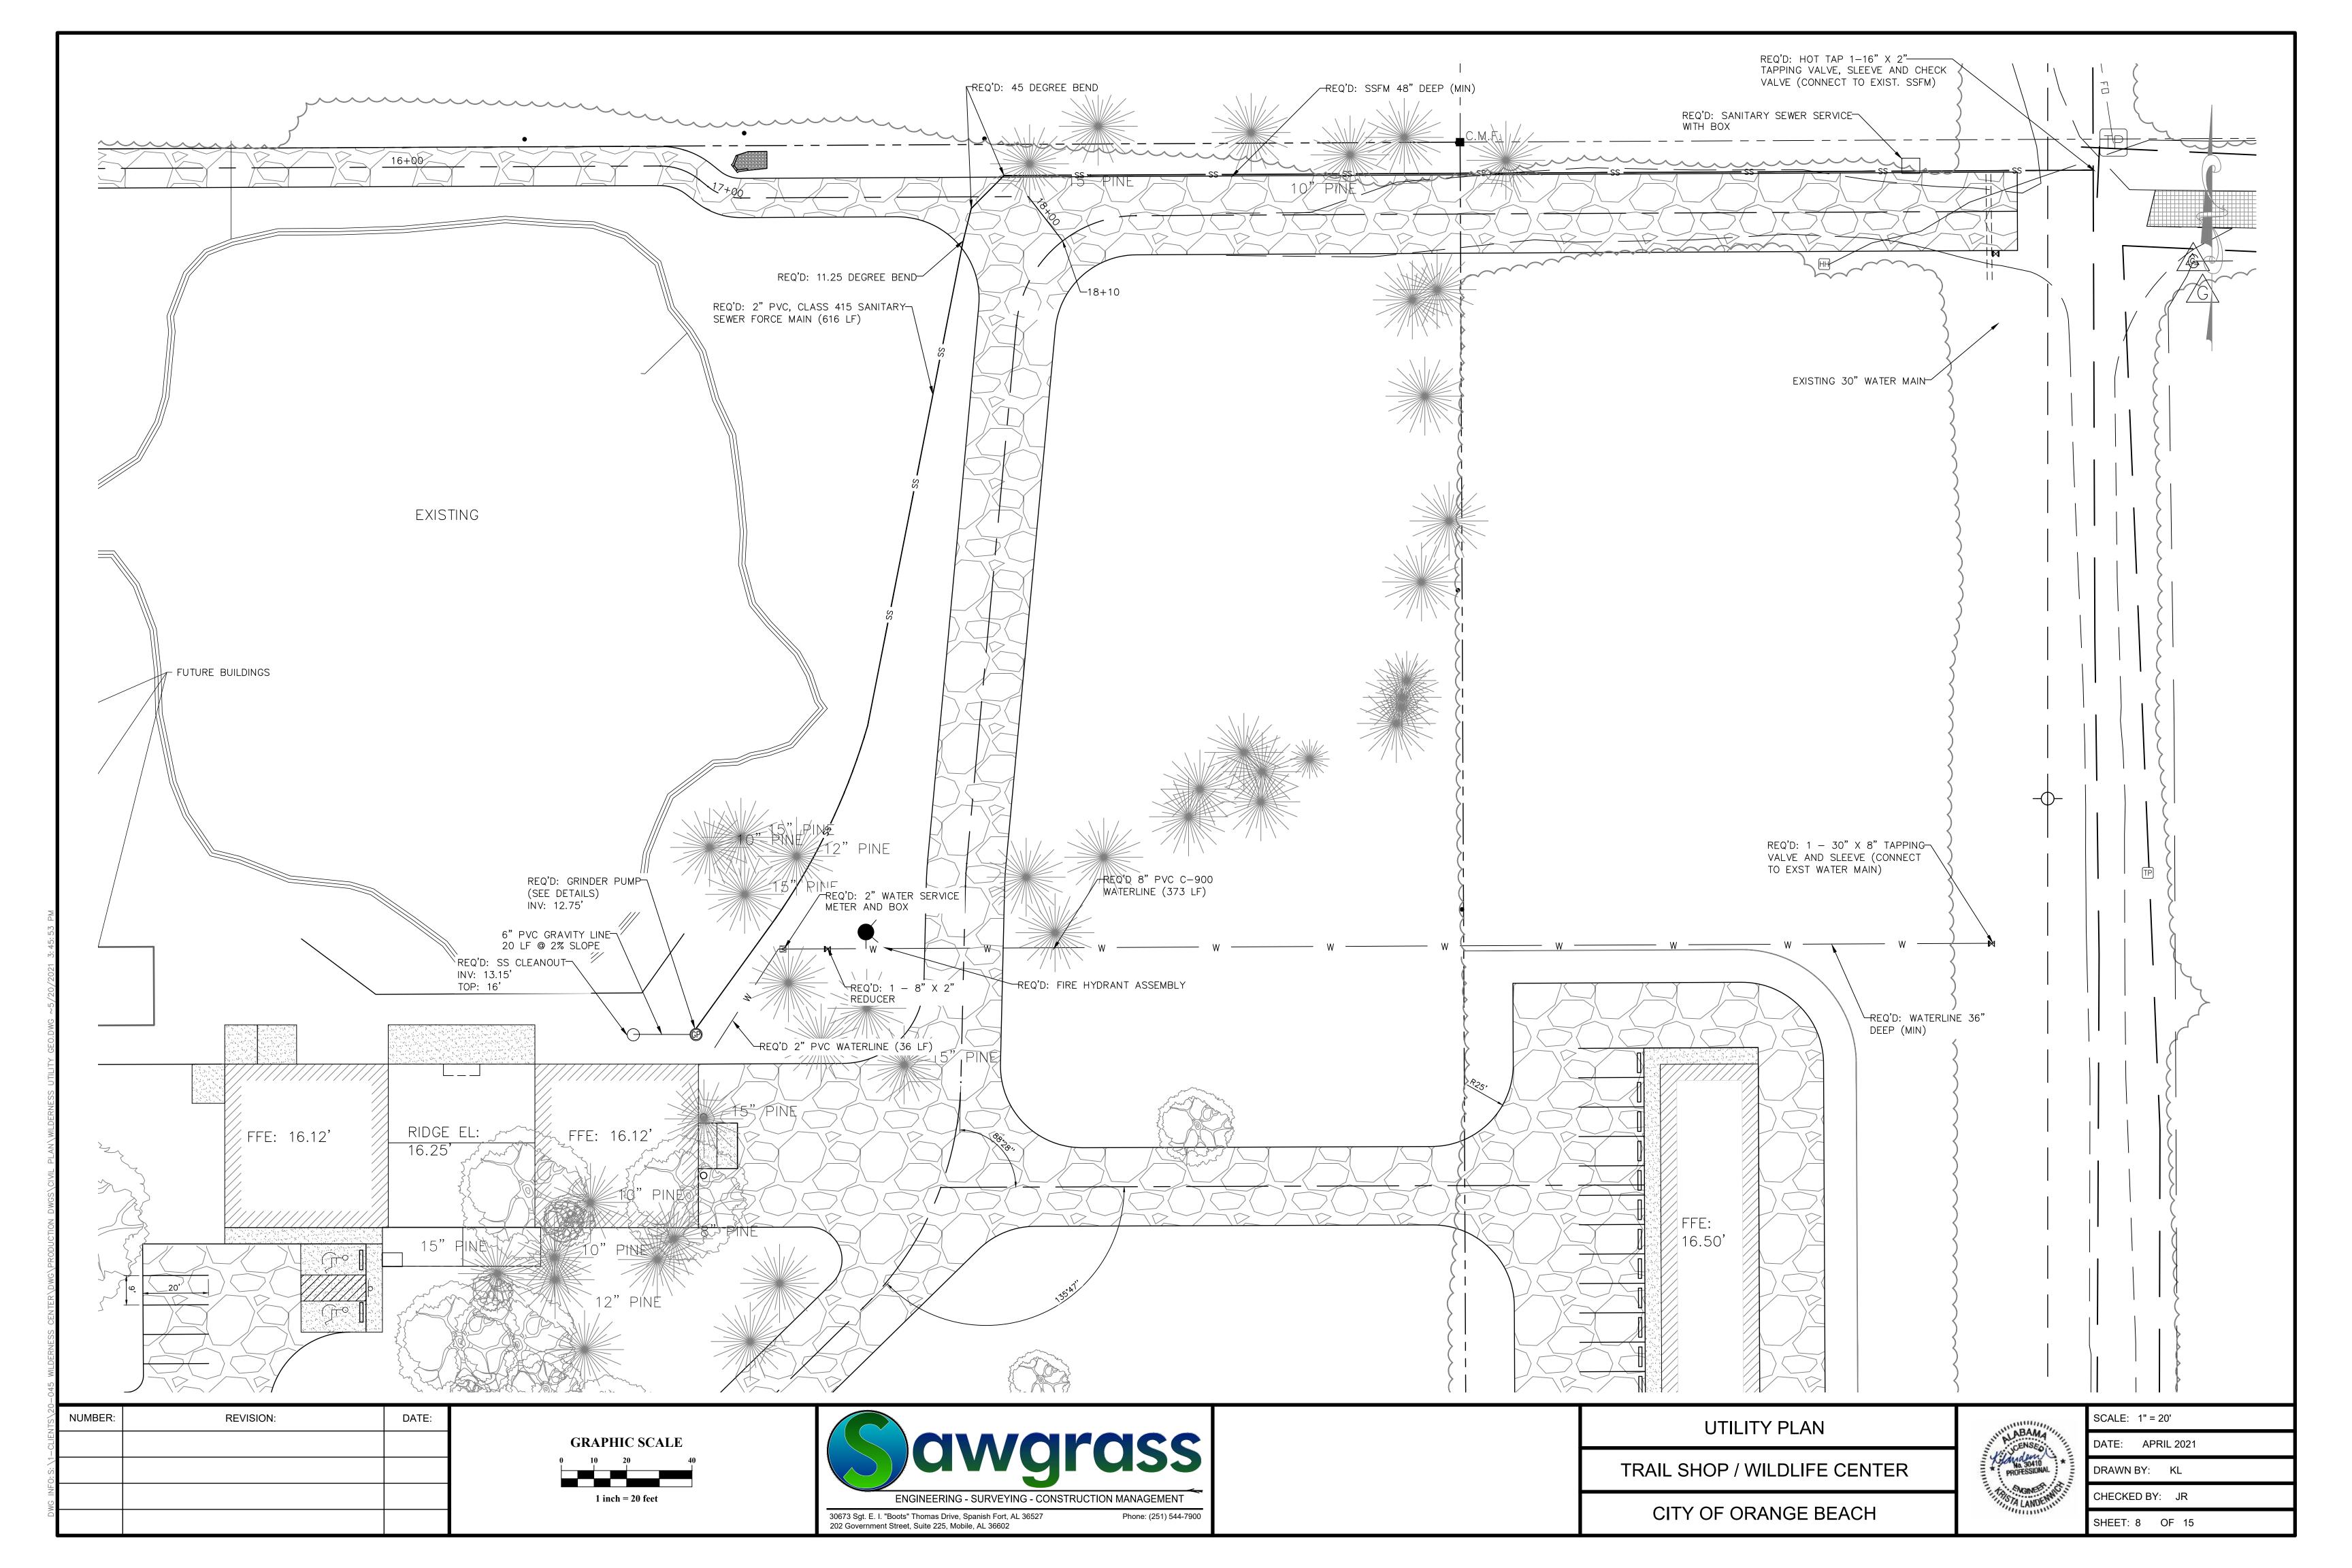

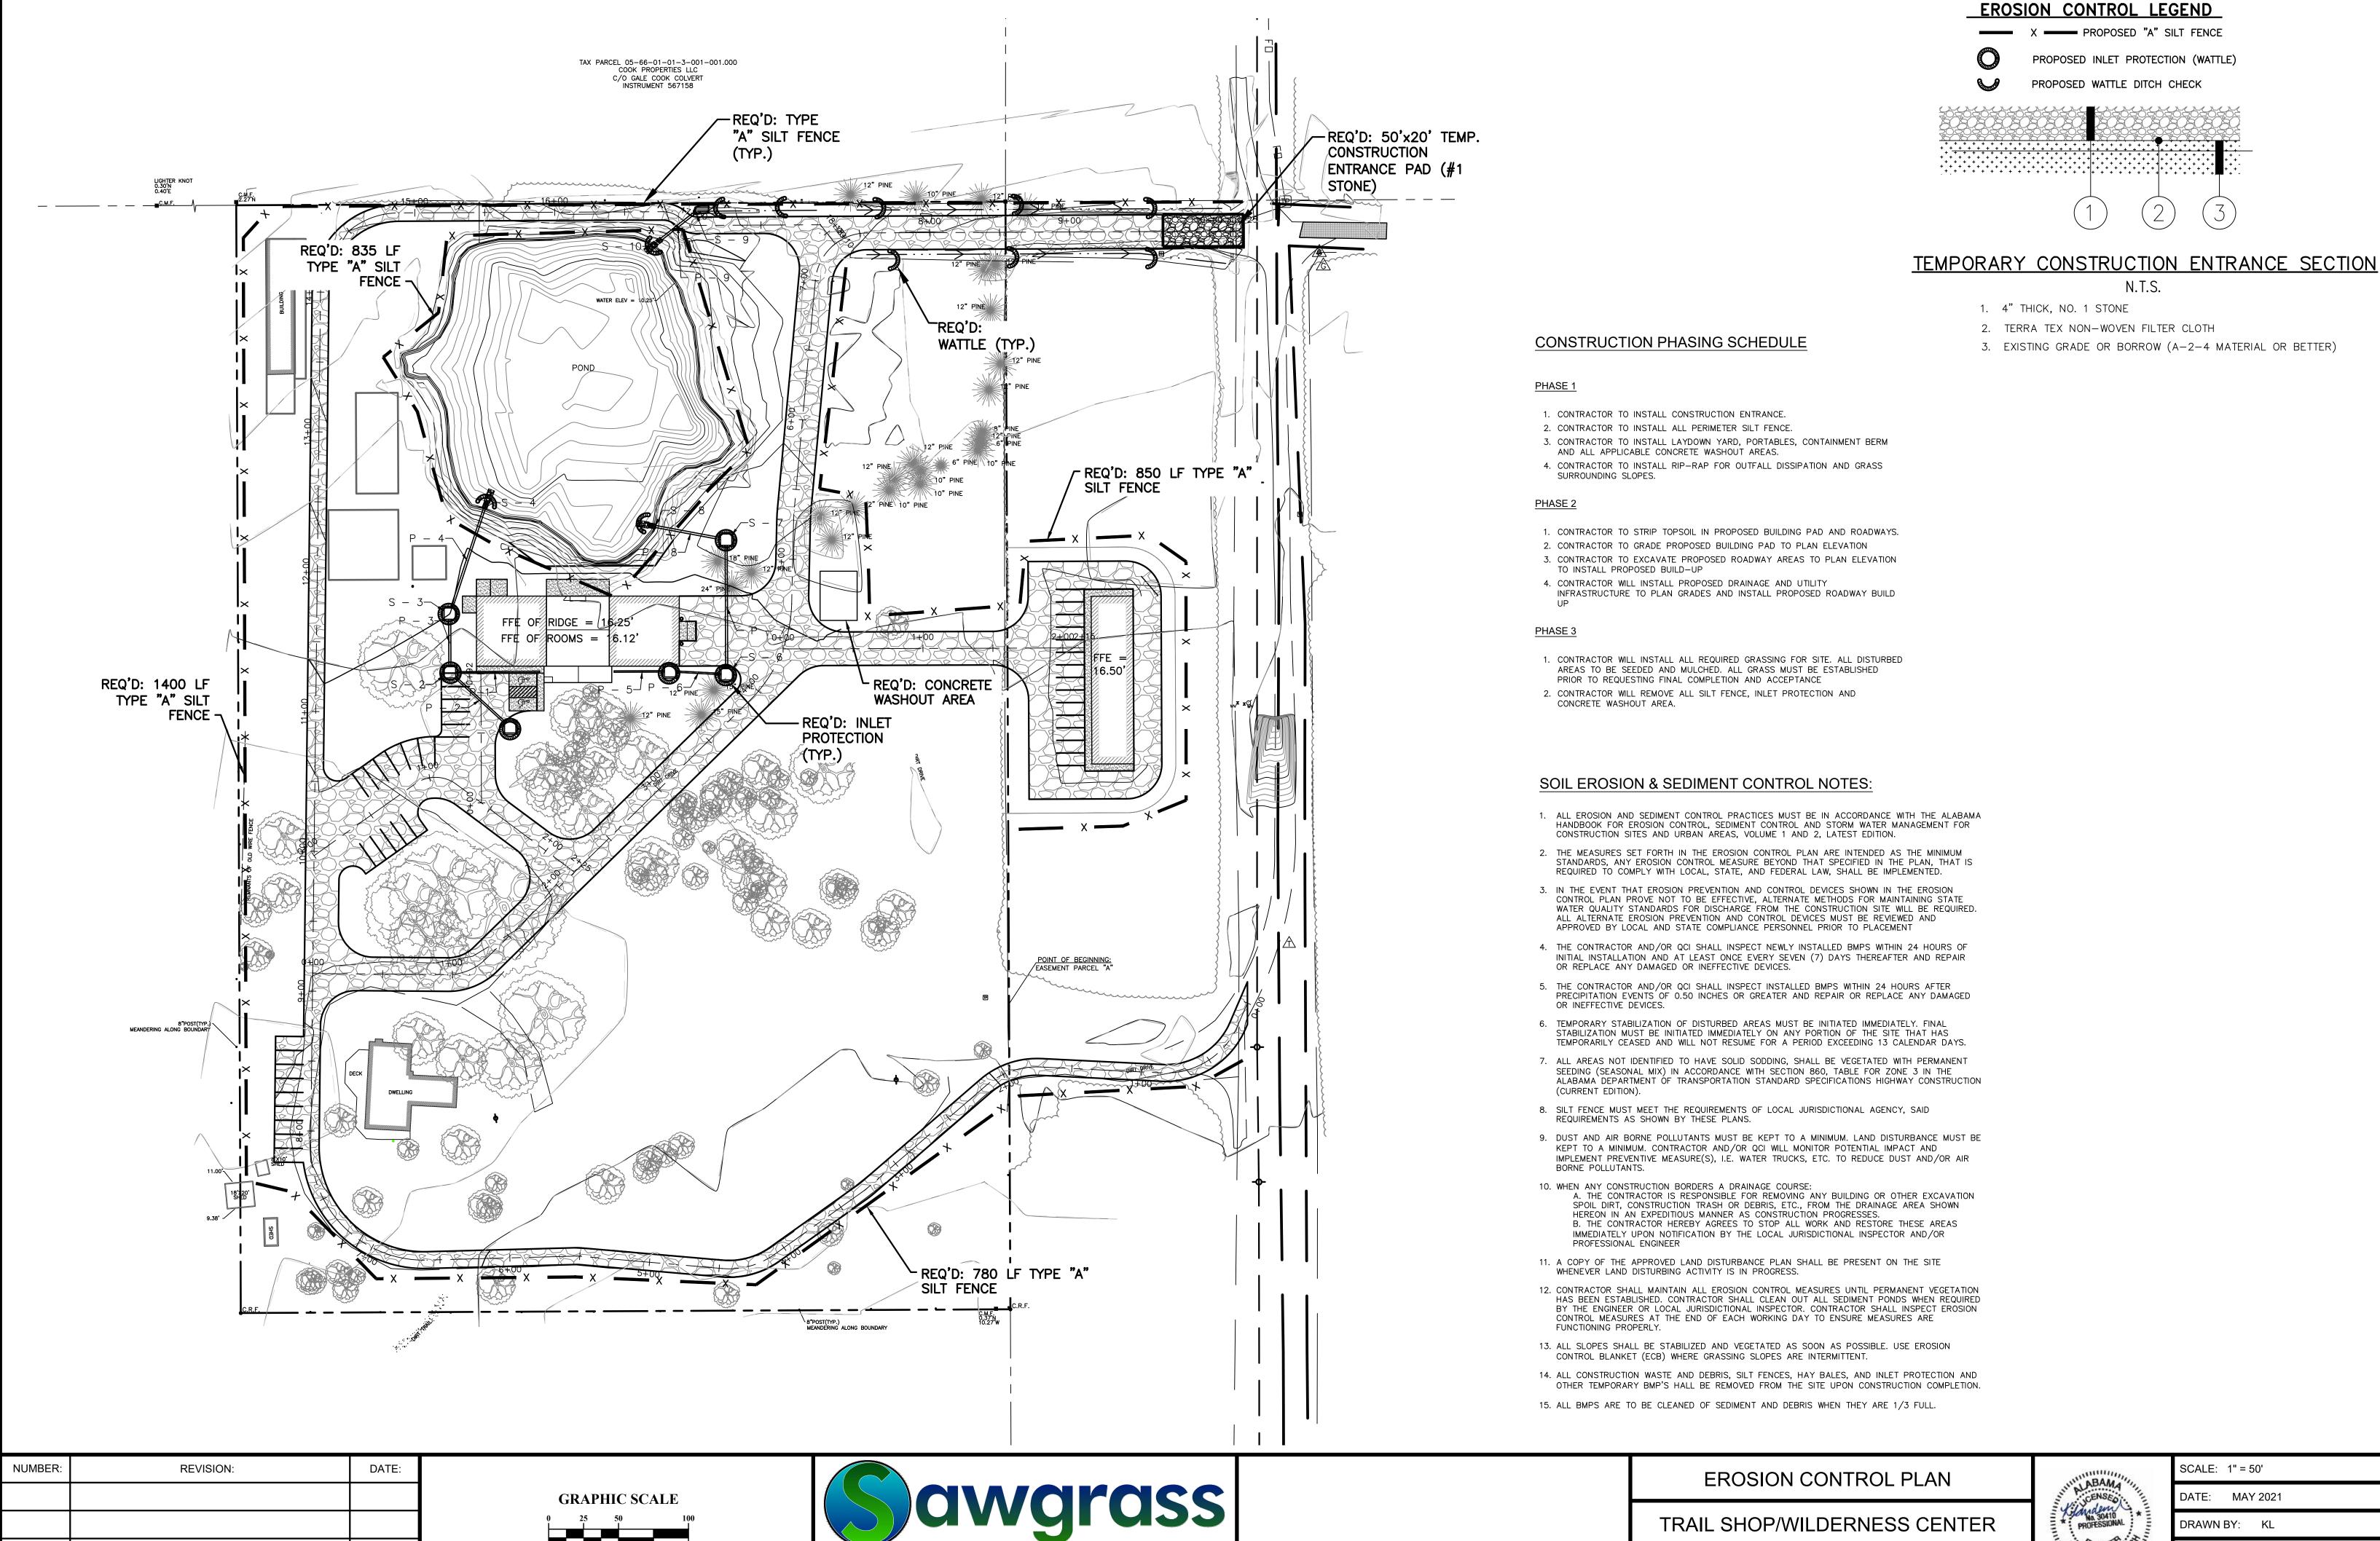

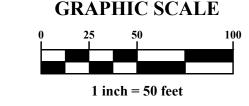






CITY OF ORANGE BEACH





CHECKED BY: JR SHEET: 9 OF 15

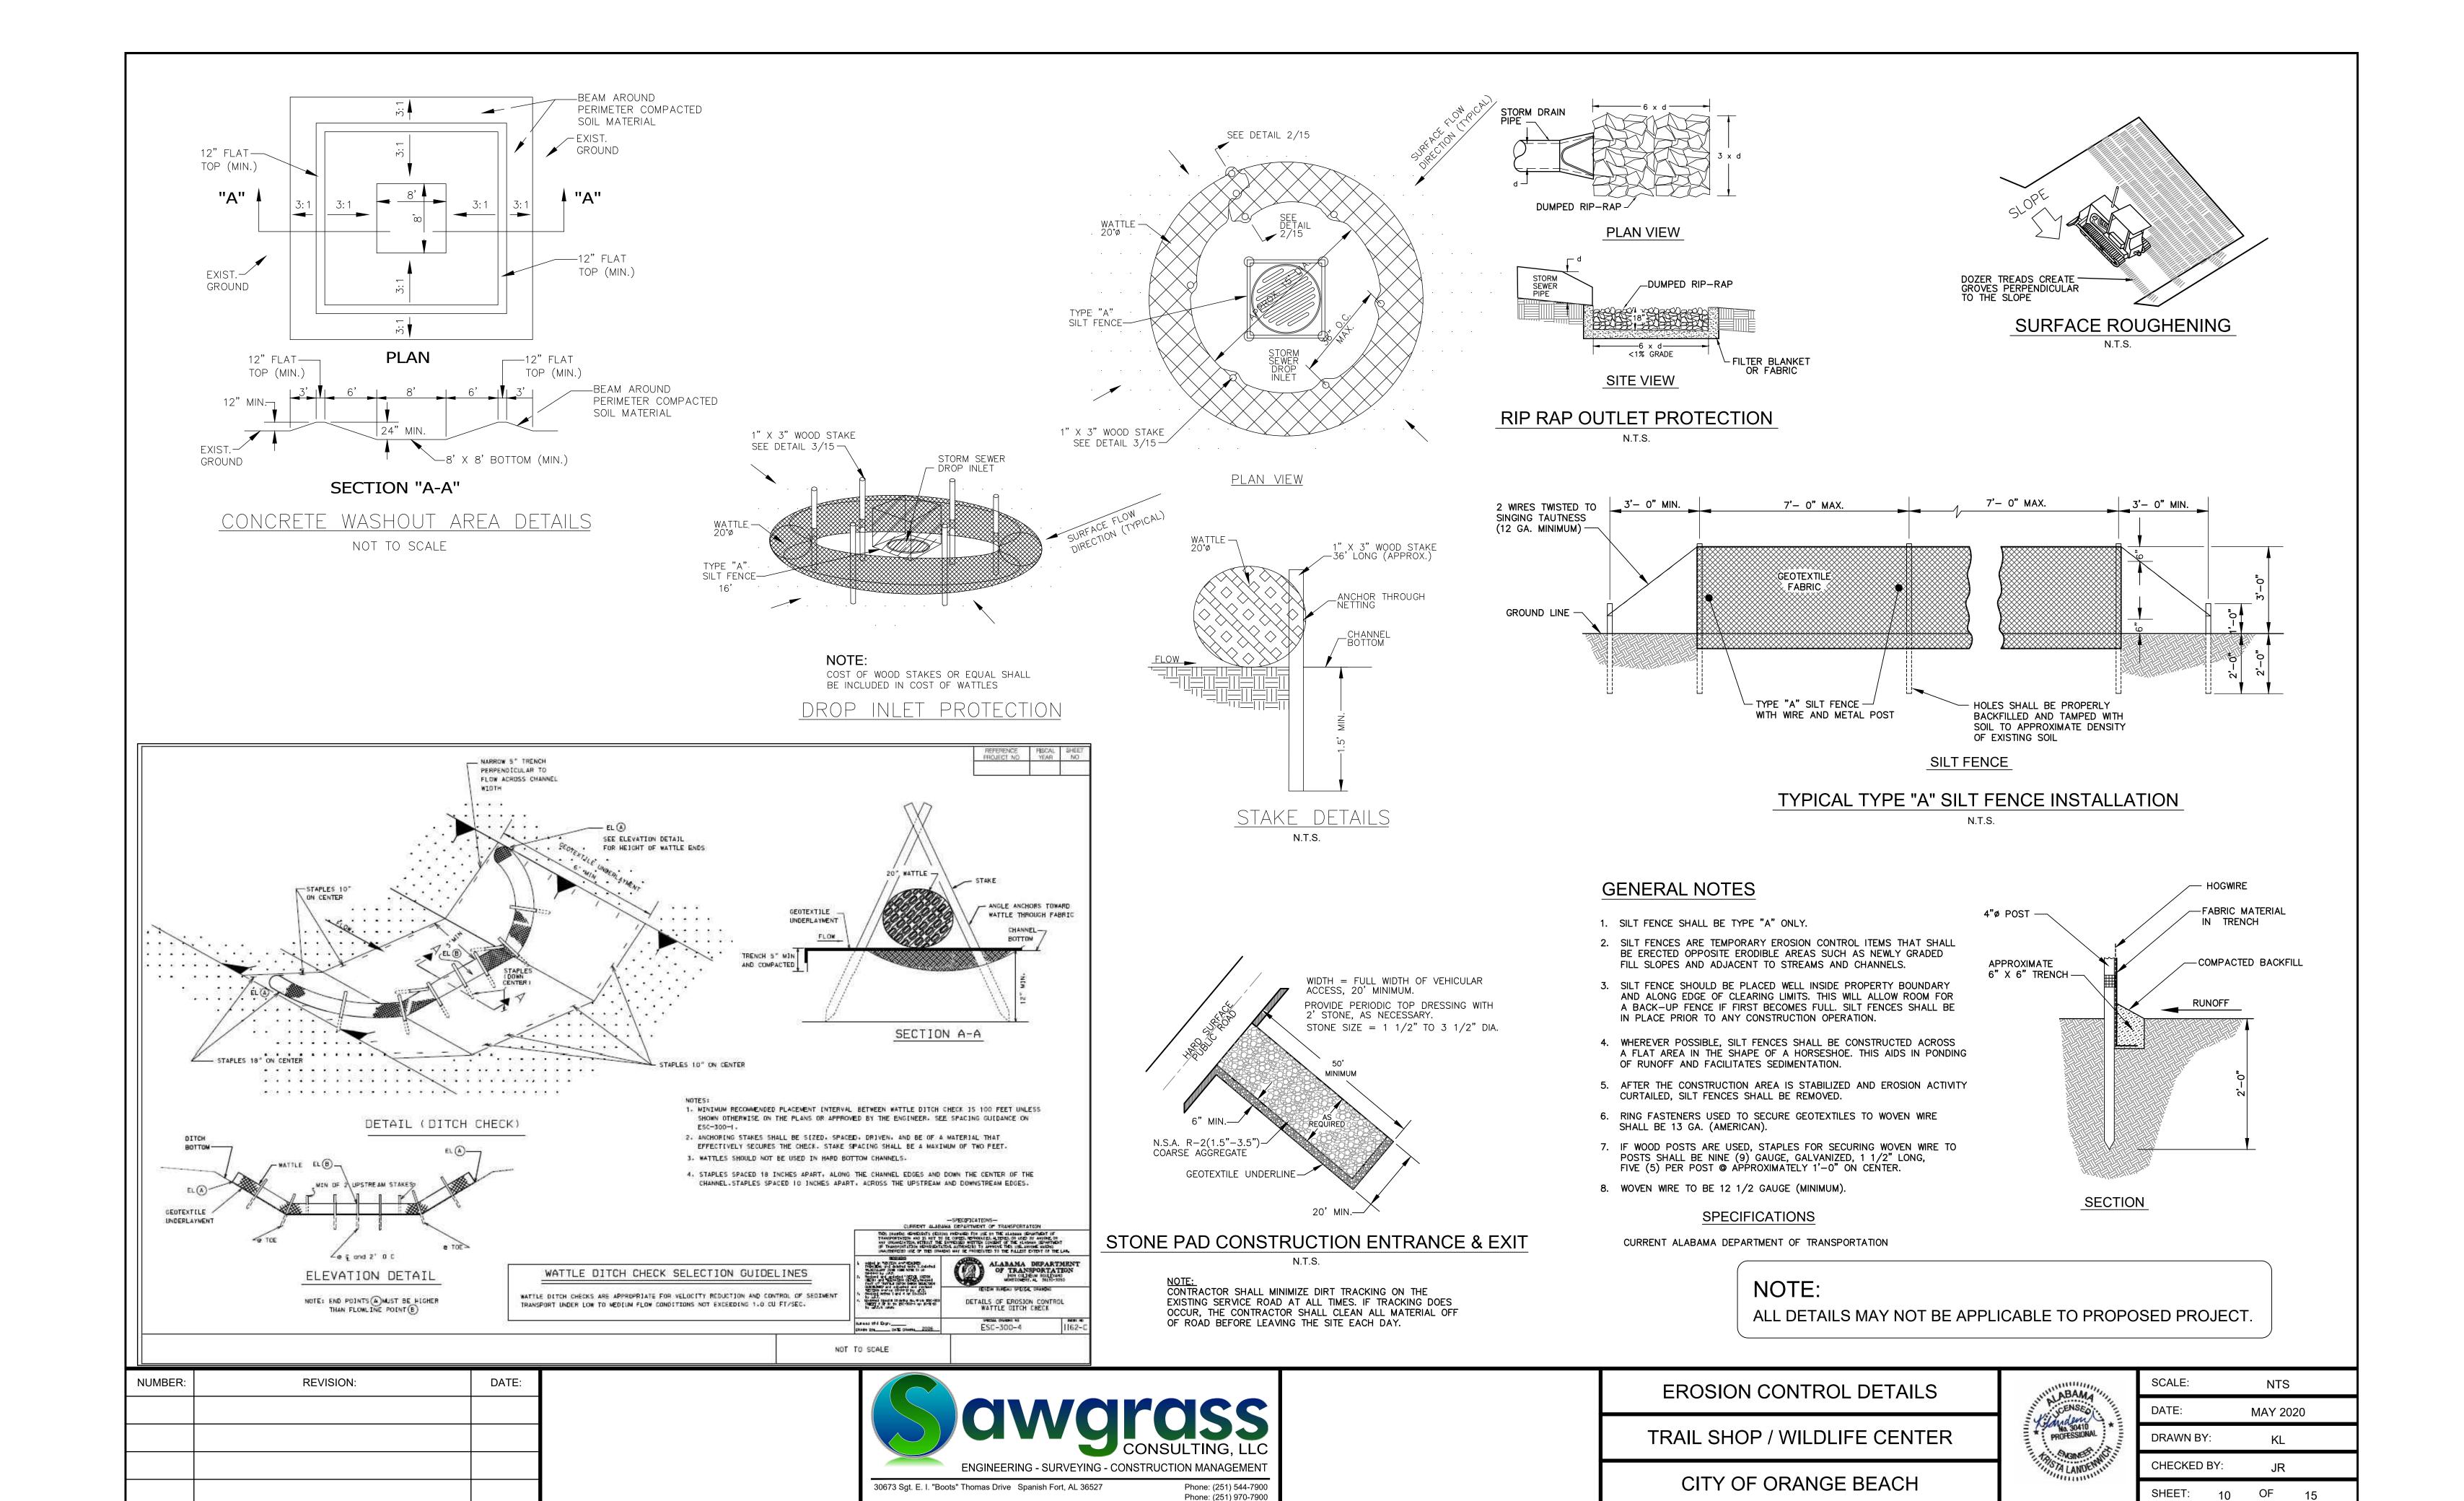


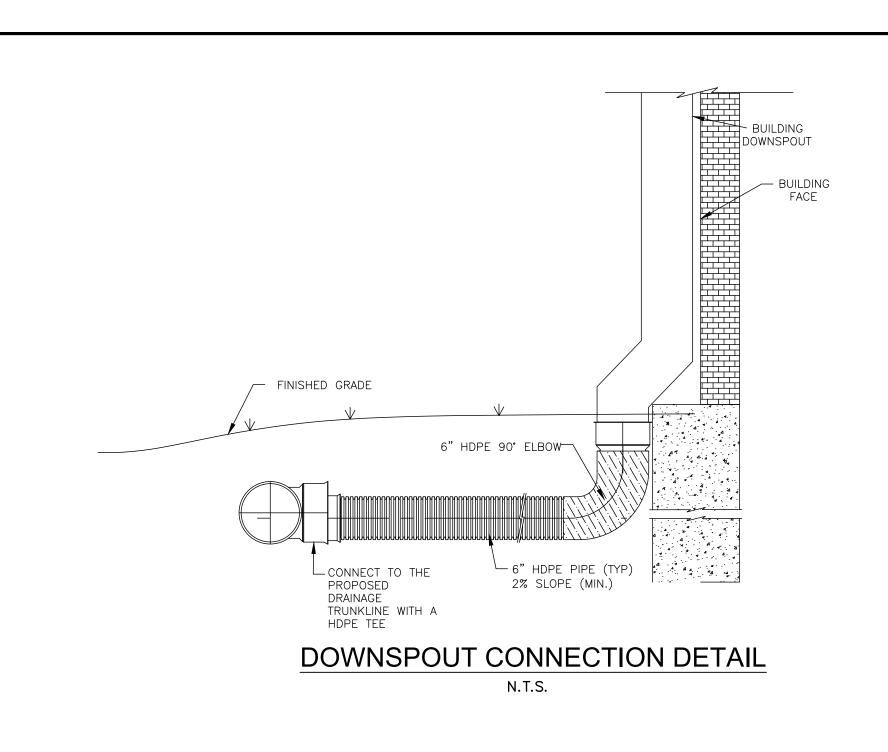


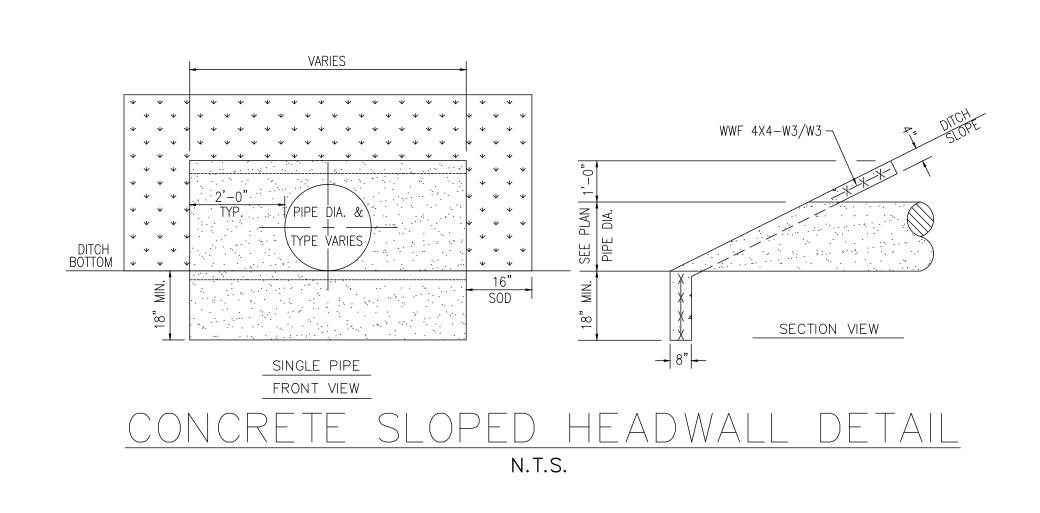

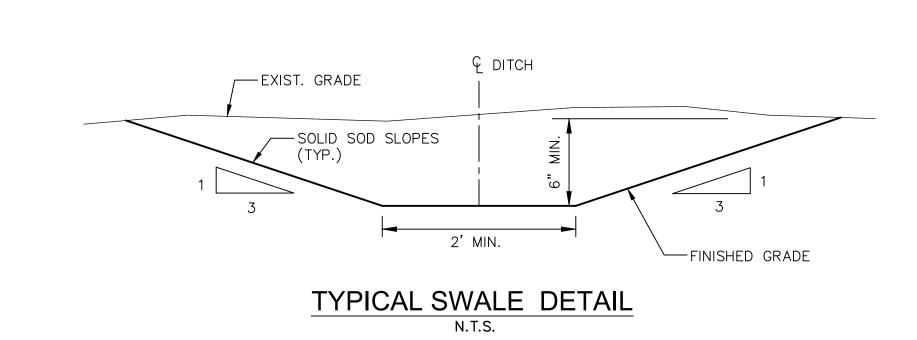

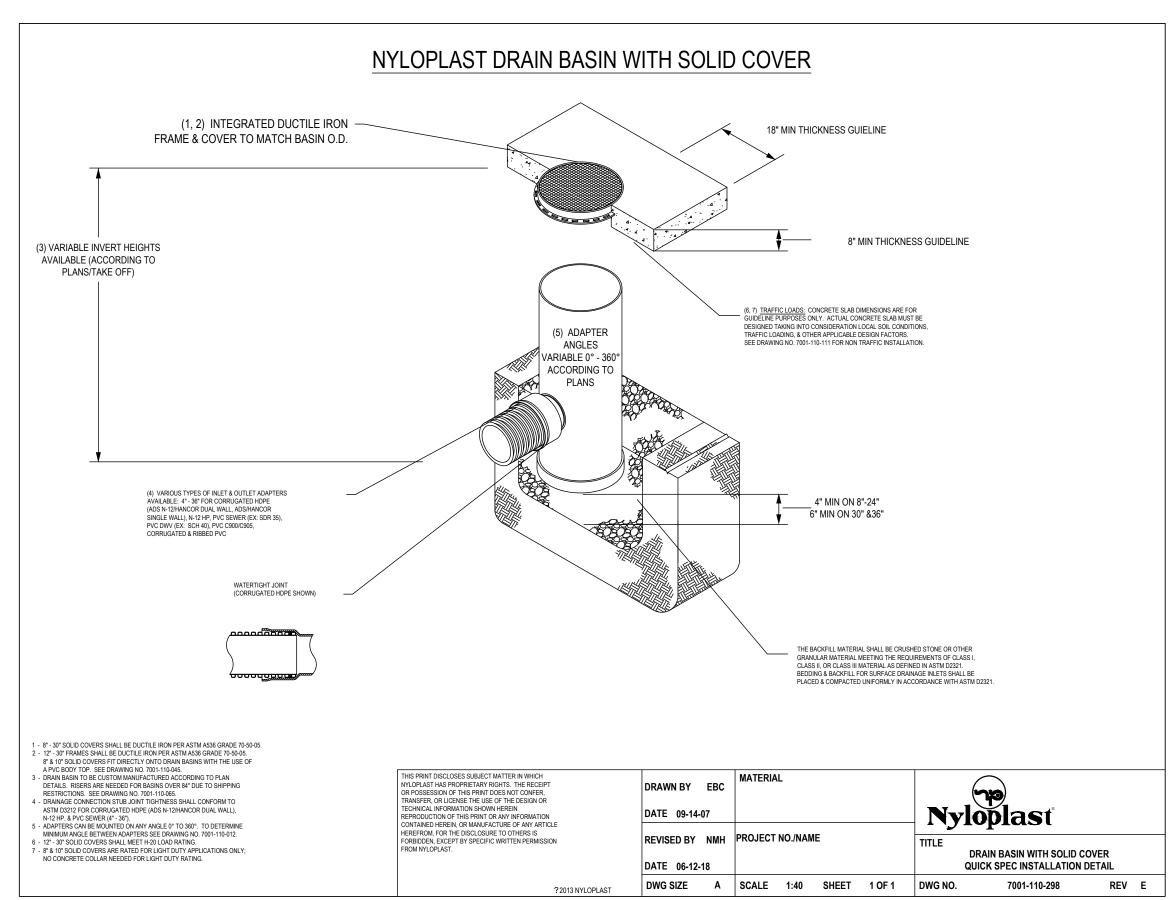

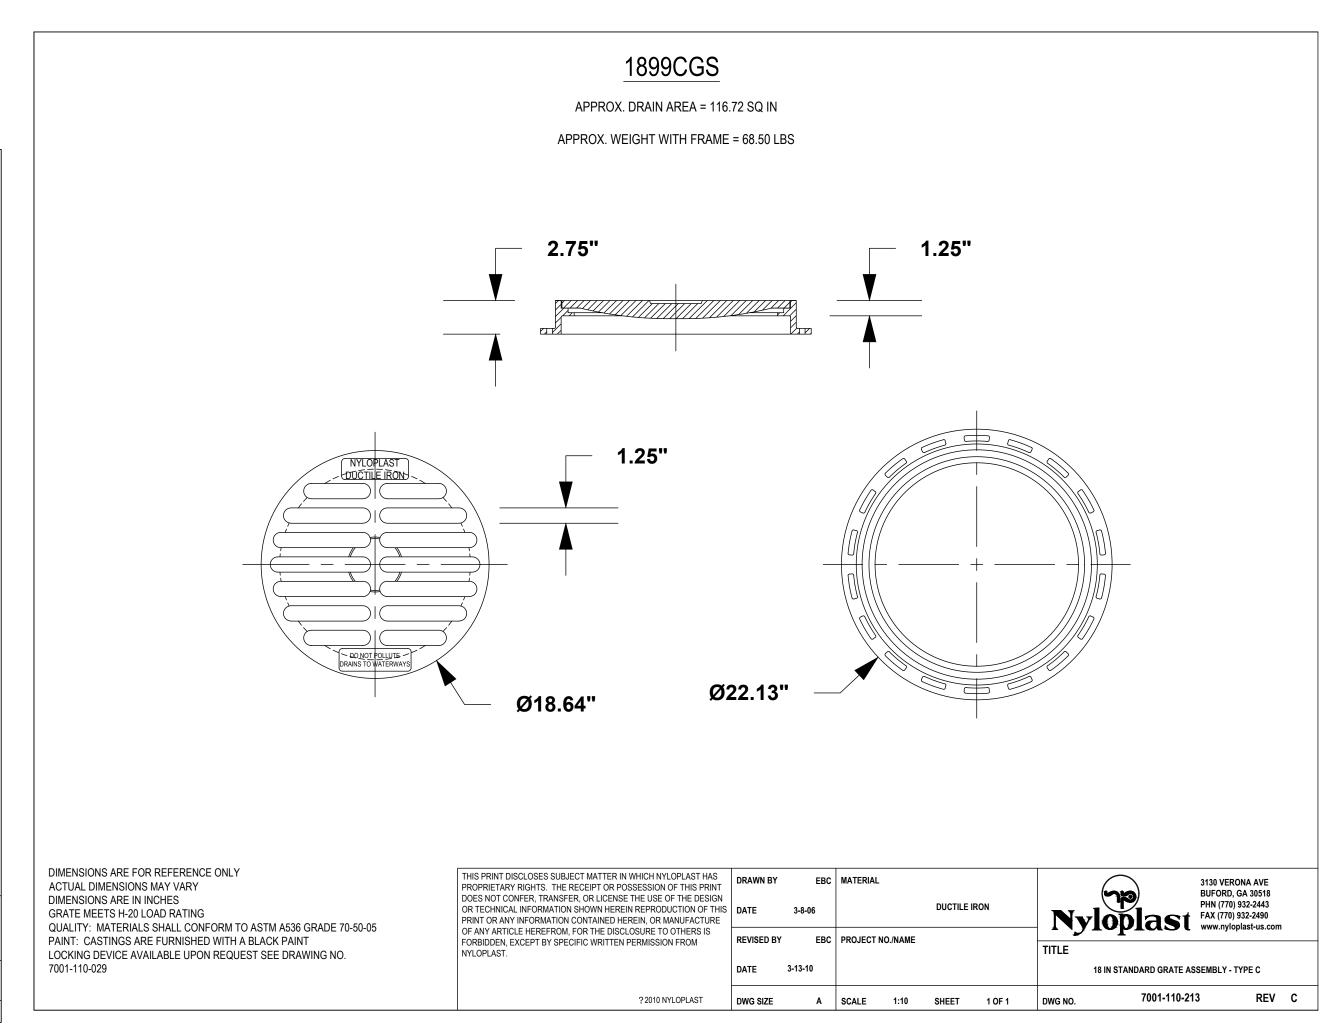

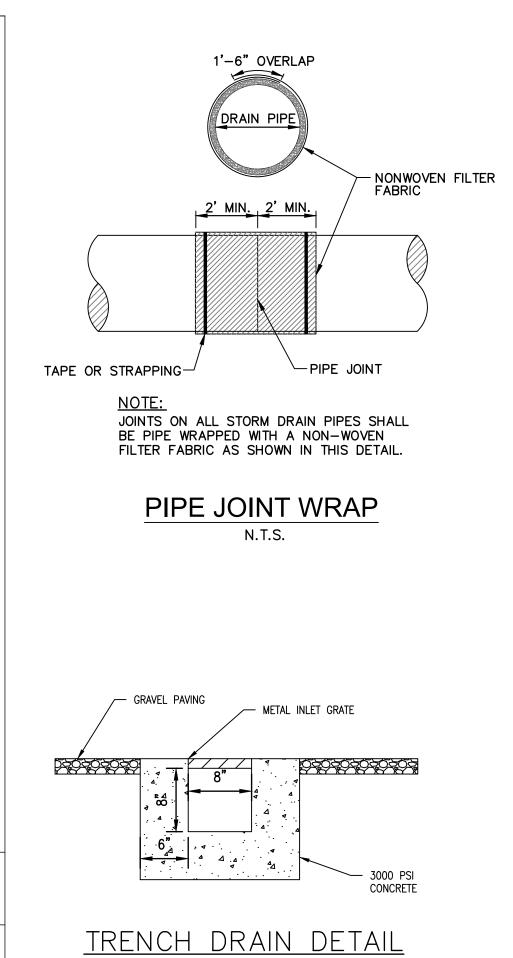

18 INCH STANDARD GRATE INLET TOP

NUMBER:	REVISION:	DATE:	


CIVYGIGSS CONSULTING, LLC ENGINEERING - SURVEYING - CONSTRUCTION MANAGEMENT
30673 Sgt. E. I. "Boots" Thomas Drive Spanish Fort, AL 36527 Phone: (251) 544-7900 Phone: (251) 970-7900

CIVIL CONSTRUCTION DETAILS	TITLE
WILDERNESS CENTER	Y Y
CITY OF ORANGE BEACH	17/1



N.T.S.

SCALE:		NTS		
DATE:		MAY 20	21	
DRAWN BY:		KL		
CHECKED BY:		JR		
SHEET:	11	OF	15	

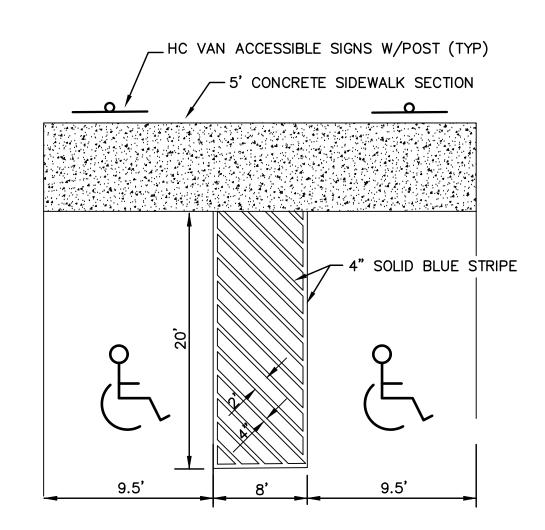

HANDICAPPED PARKING STRIPING DETAIL

N.T.S.


NOTE:

PARKING STRIPING SHALL BE DONE PER THE REQUIREMENTS OF ALDOT ITEM 701—A SOLID WHITE CLASS 1, TYPE A, 5" WIDE STRIPES. MATERIALS AND CONSTRUCTION REQUIREMENTS OF 701—A, SHALL BE ADHERED TO. HANDICAPPED PARKING SPACES SHALL BE STRIPED IN SOLID BLUE, WITH ACCESS AISLES STRIPED AT TWO FEET ON CENTER AND STANDARD HANDICAPPED SYMBOLS.

CONCRETE NOTE:


JOINTS SHOULD BE INSTALLED IN THE PCC PAVEMENTS TO LIMIT STRESSES RESULTING FROM EXPANSION AND CONTRACTION. CONTRACTION JOINTS SHOULD BE FORMED BY SAWING AS SOON AS THE CONCRETE HAS HARDENED ENOUGH TO PREVENT RAVELING. THESE JOINTS SHOULD EXTEND TO A DEPTH OF AT LEAST 1/4 OF THE PAVEMENT THICKNESS AND BE PLACED ON A 12 TO 15 FOOT SPACING. THE DESIGN AND LOCATION OF ALL PAVEMENT JOINTS SHOULD BE IN ACCORDANCE WITH RECOMMENDATIONS OF THE PORTLAND CEMENT ASSOCIATION (PCA) AND ACI 330.

ISOLATION JOINT MATERIAL SHOULD COMPLY WITH ACI STANDARDS. THE UPPER ONE INCH OF THE JOINT MATERIAL SHOULD BE REMOVED AND THE JOINT SEALED WITH A SELF—LEVELING ELASTOMERIC JOINT SEALANT IMMEDIATELY AFTER THE CURING PERIOD AND PRIOR TO OPENING TO TRAFFIC. CONSTRUCTION JOINTS SHOULD BE PROPERLY CLEANED AND SEALED WITH THE SAME TYPE OF JOINT SEALANT. DOWEL SIZING AND SPACING FOR CONSTRUCTION JOINTS SHOULD CONFORM TO THE RECOMMENDATIONS OF ACI 330.

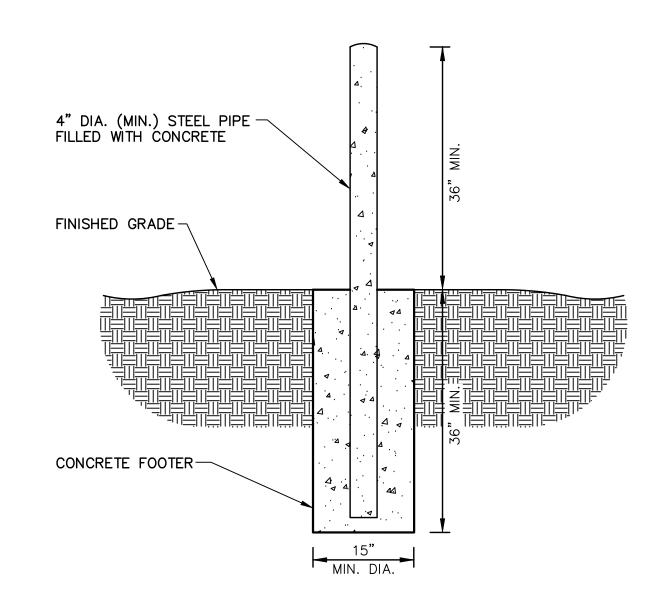



BOLLARDS SHALL BE LOCATED 2' FROM BUILDING AND 1' FROM DRIVE


BOLLARD PROTECTION DETAIL N.T.S.

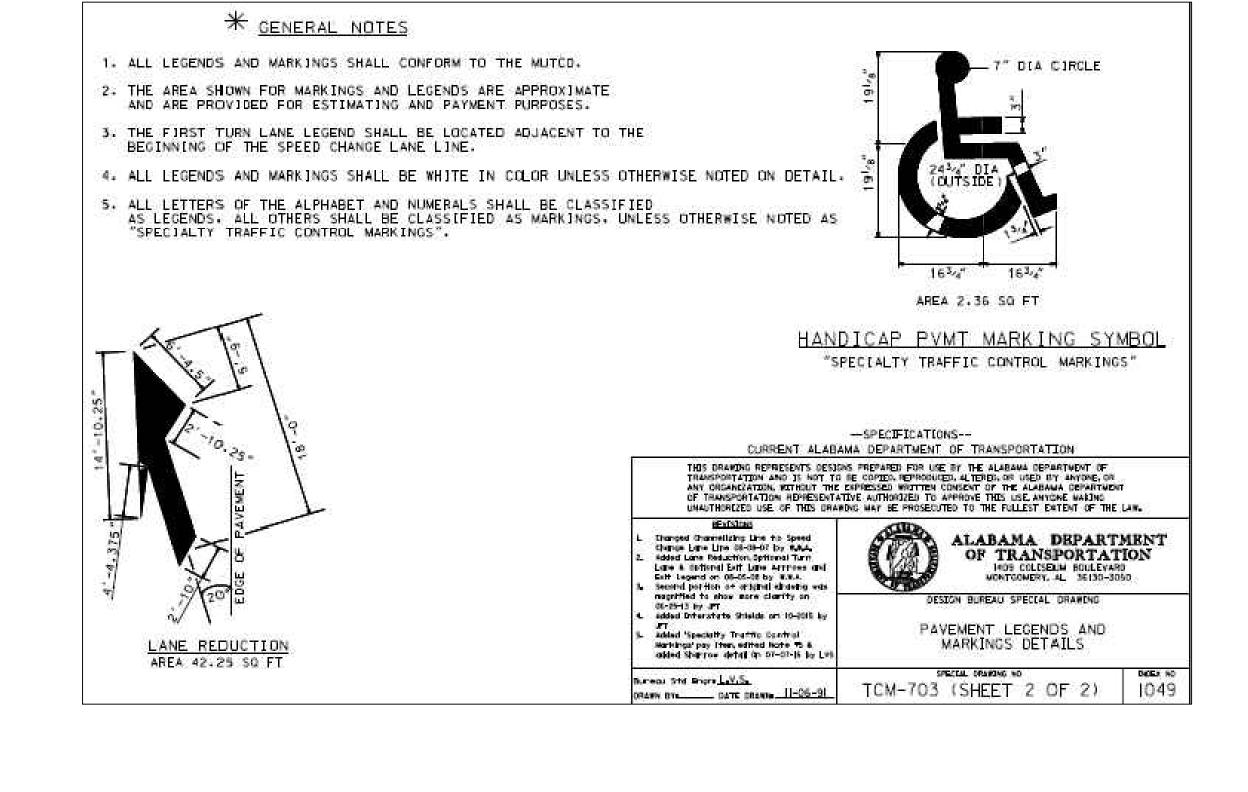


5'-6 1/2"

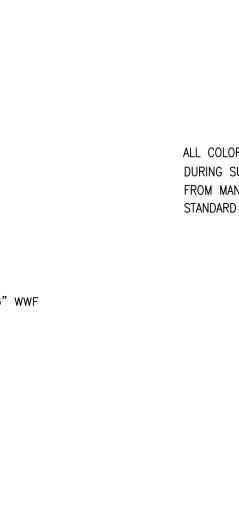


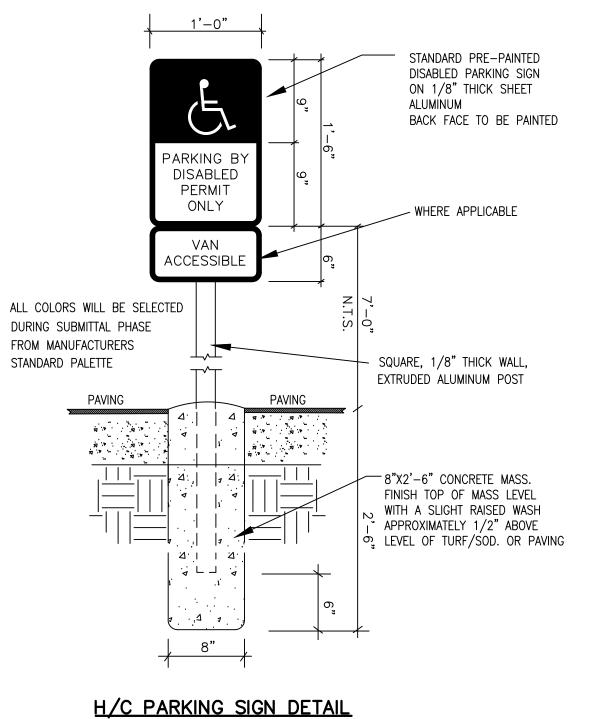

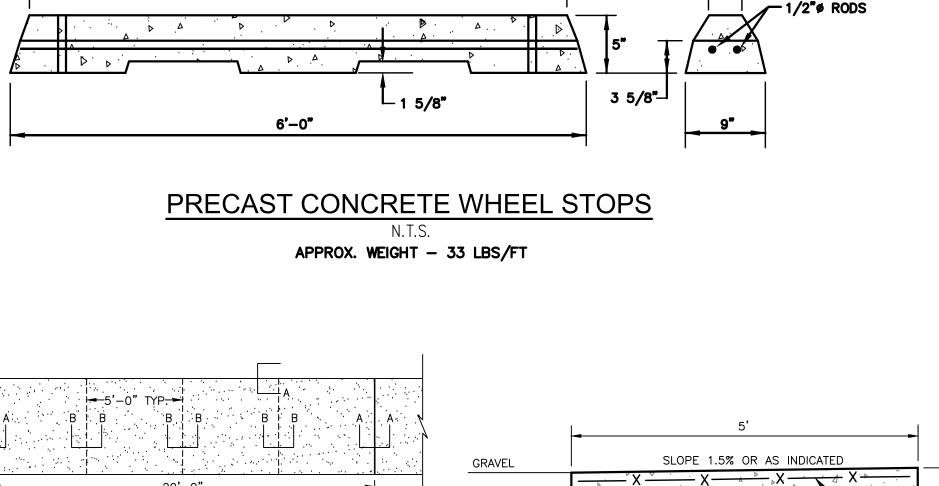

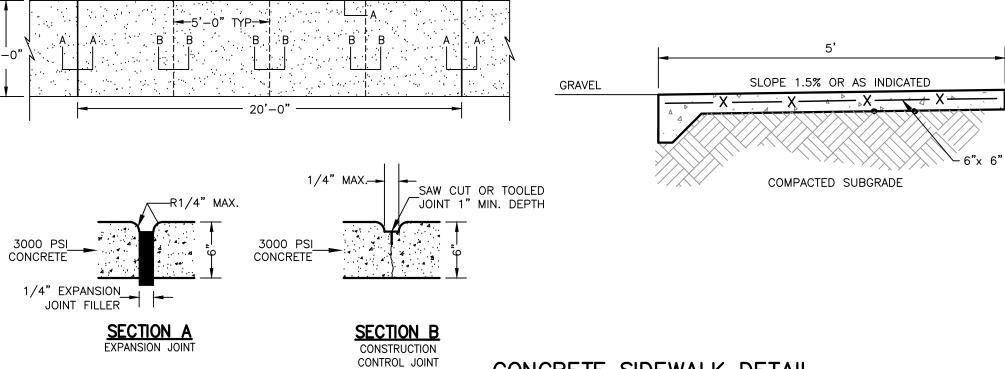


<u>CONCRETE</u>	SIDEWALK	DETAIL
	N.T.S.	

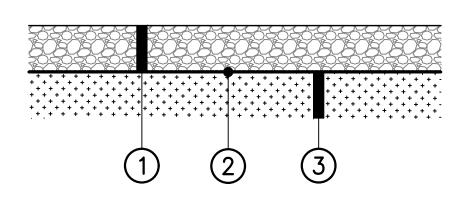

GRAVEL PARKING DRIVE SECTION

- 1. #57 CRUSHED LIMESTONE, 4" THICK
- 2. SEPARATION FABRIC (MARIFI 500X OR APPROVED EQUAL)
- 3. IN-SITU MATERIAL OR BORROW (A-2-4 MATERIAL OR BETTER) (TOP 6" COMPACTED TO 100% STANDARD DENSITY)

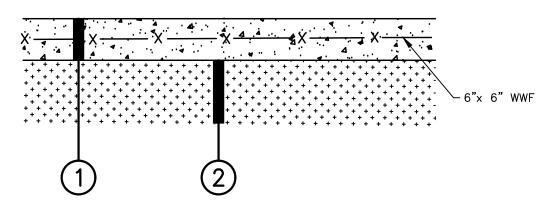

1. 6" CONCRETE PAVEMENT (4,000 PSI COMPRESSIVE STRENGTH, 450 PSI FLEXURAL STRENGTH)

CONCRETE PARKING/PAD SECTION

2. COMPACT NATIVE SUBGRADE OR STRUCTUAL FILL (TOP 12" COMPACTED TO 100% STANDARD DENSITY)

NUMBER:	REVISION:	DATE:	




CIVIL CONSTRUCTION DETAILS - 2

TRAIL SHOP / WILDLIFE CENTER

CITY OF ORANGE BEACH



uuu,	SCALE:		NTS		
BAMA MARINA	DATE:		MAY 2021		
30410 *	DRAWN BY:		KL		
ANDENHICK	CHECKED	BY:	JR		
mun.	SHEET:	12	OF	15	

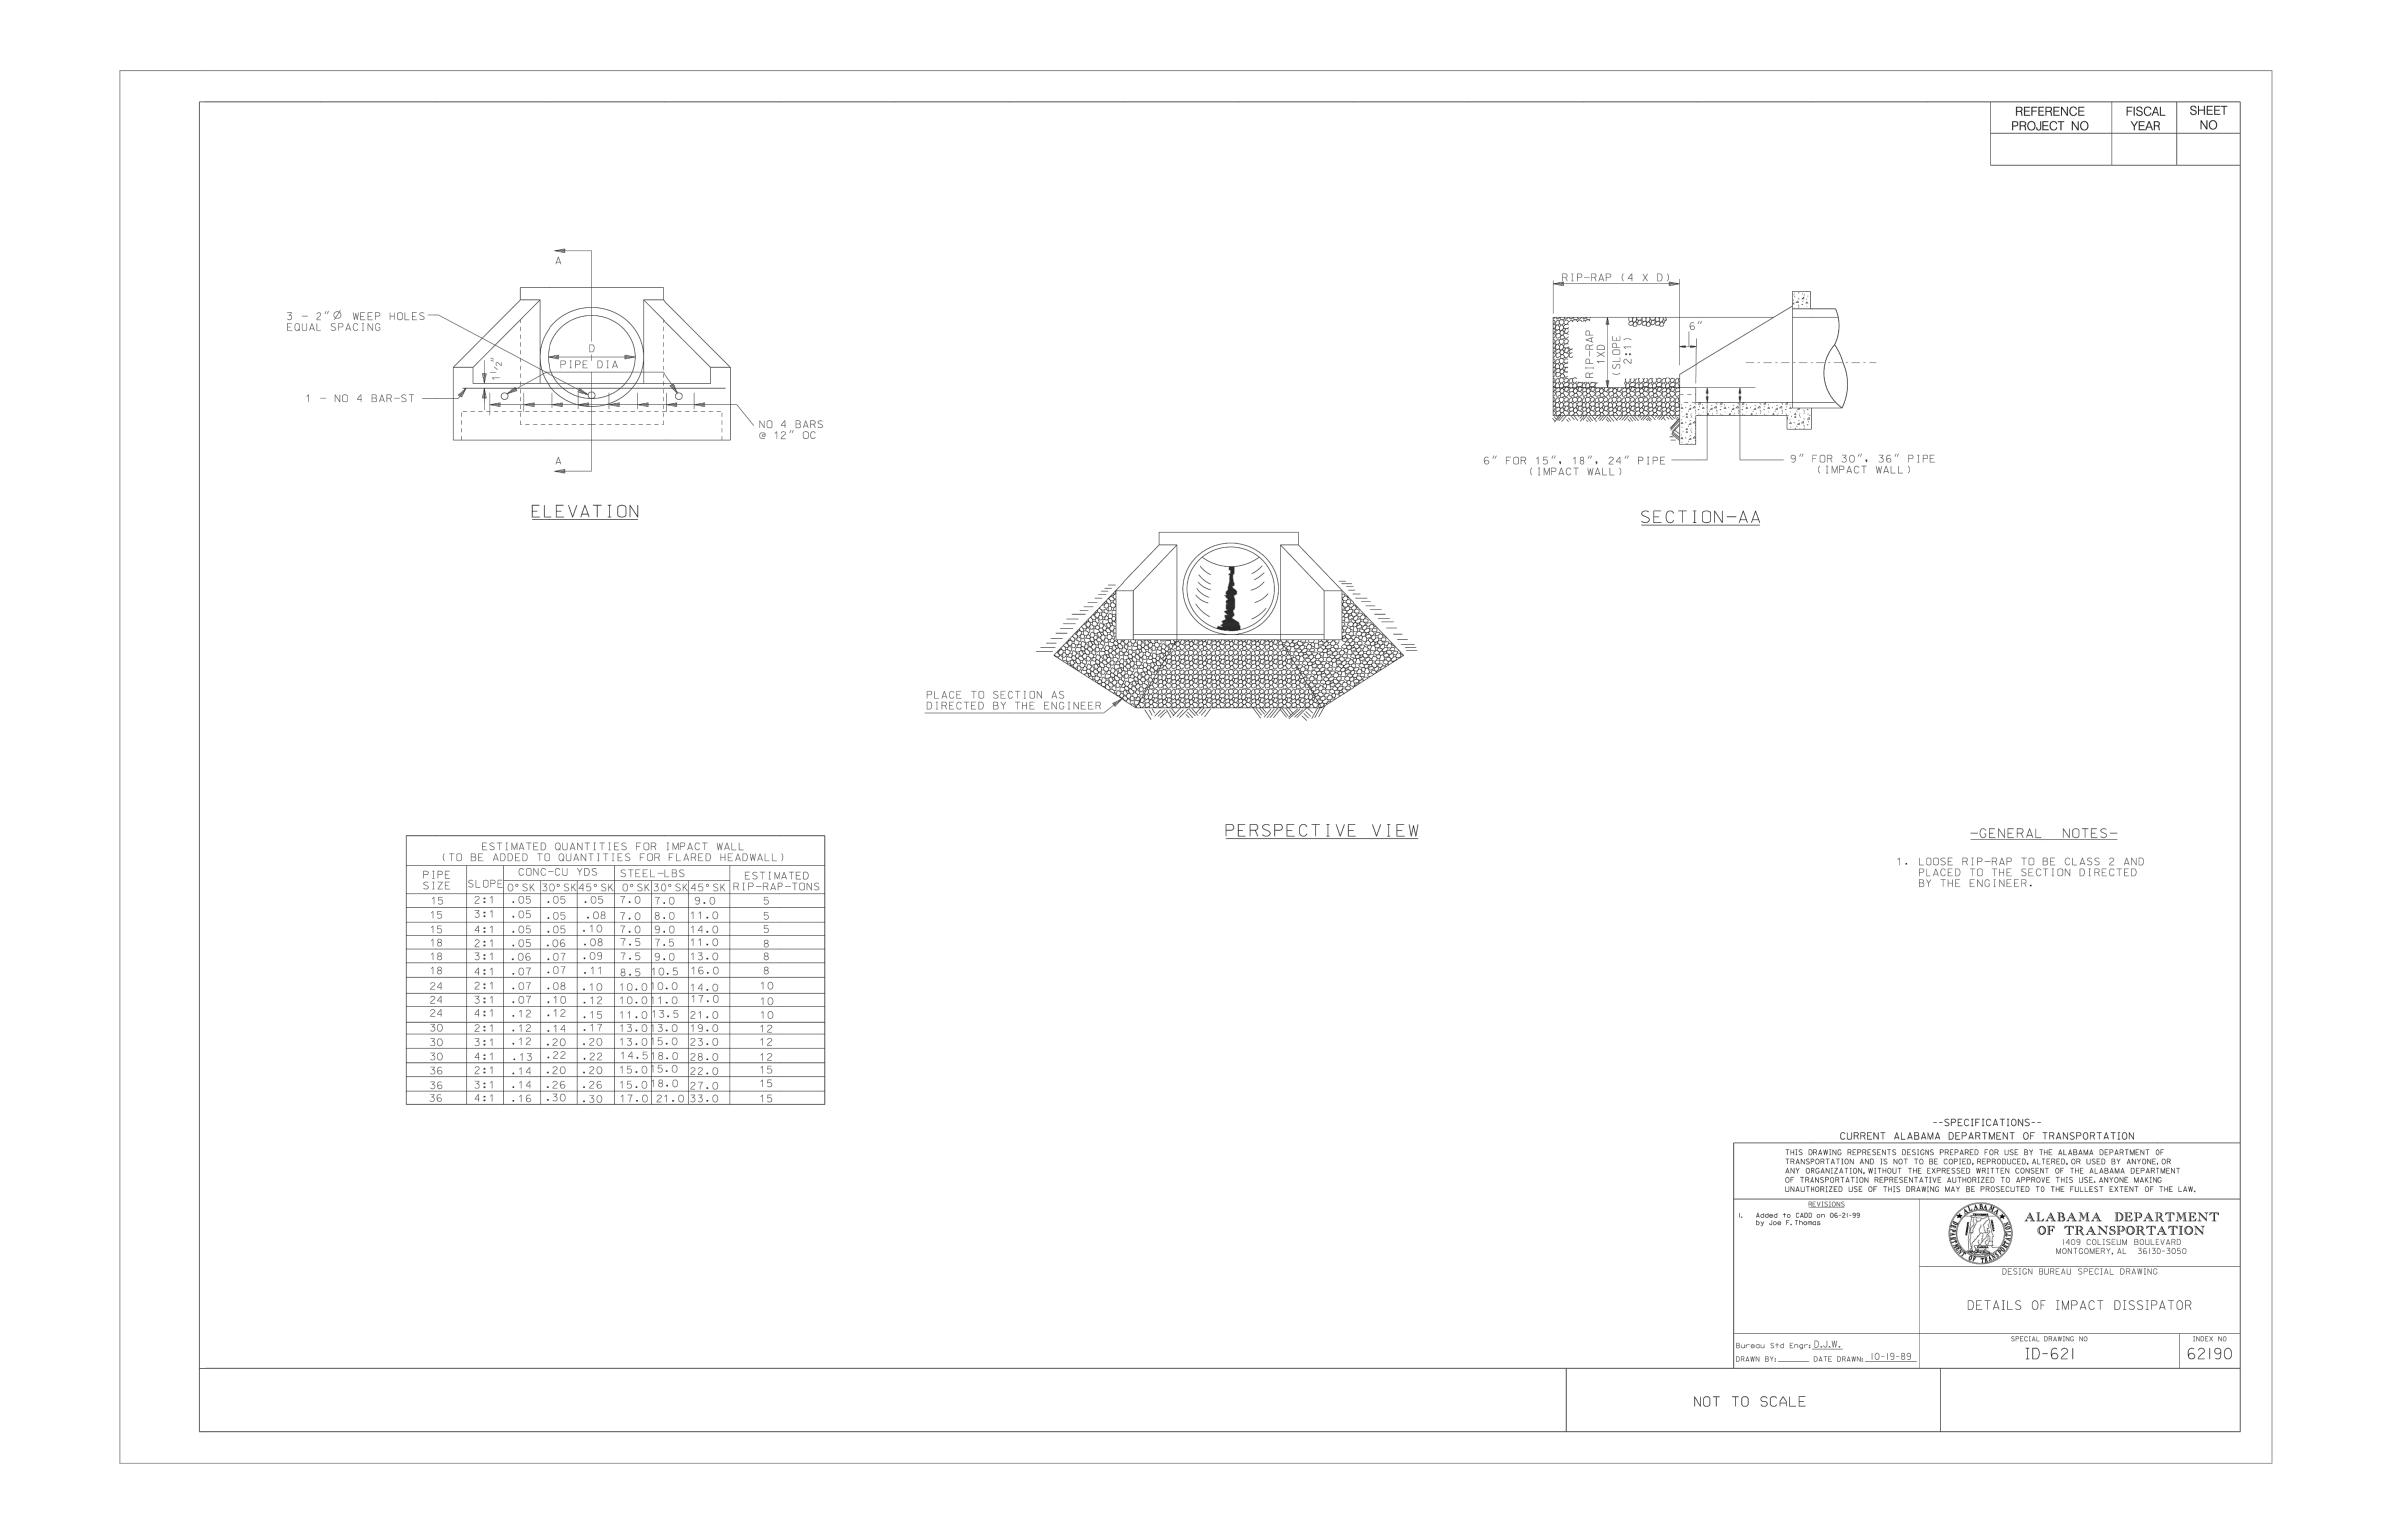

NUMBER:	REVISION:	DATE:




CIVIL CONSTRUCTION DETAILS - 3	
	-

TRAIL SHOP / WILDLIFE CENTER

CITY OF ORANGE BEACH

, u	ABAMA	11,
Marin	Landen Ha. 30410	*
1111111111	PROPESSIONER N	7
7	STA LANDEN	ditt

	SCALE:		NTS		
1111111	DATE:	MAY 2021			
***************************************	DRAWN BY	KL			
No.	CHECKED	BY:	JR		
	SHEET:	13	OF	15	

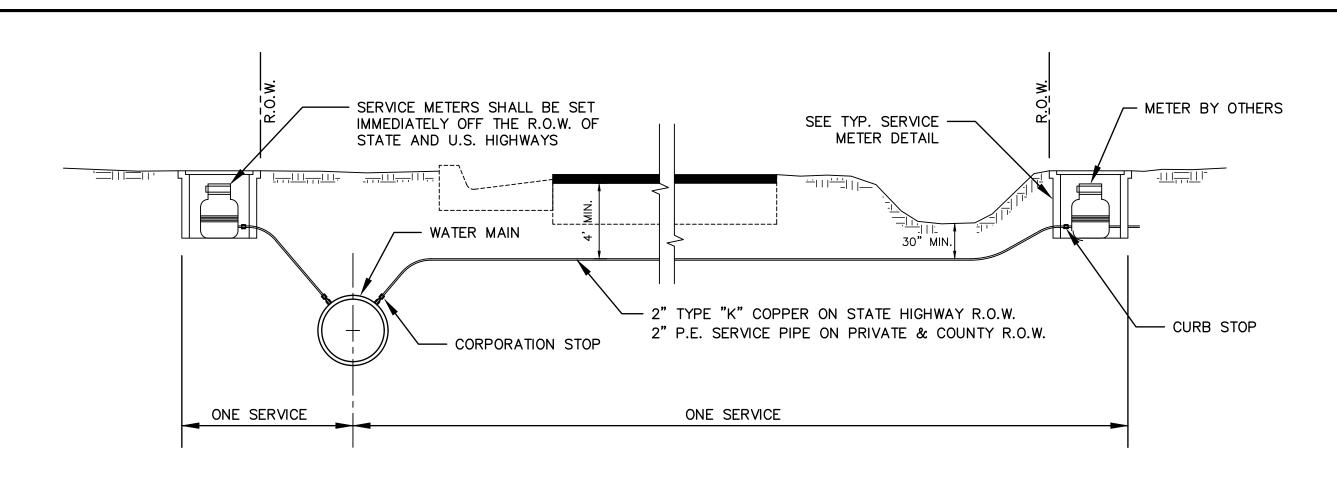


TYPICAL SERVICE CONNECTION

CONCRETE THRUST BLOCK ——— SEE SCHEDULE VERT. THRUST BLOCK DETAIL

THRUST BLOCK BEARING AREAS (SQ.FT.)						VER I BLO	· - · · - · · · · -	HOR <u>MES</u>
SIZE	PLUGGED END OR TEE	90° BEND	45° BEND	22-1/2° BEND	11-1/4° BEND	45° VERT. BEND	22-1/2° VERT. BEND	GATE VALVE
2" DIA. PIPE LINE	1.0	1.0	1.0	1.0	1.0	9.3 CU. FT.	4 CU. FT.	0.5 CU. FT.
4" DIA. PIPE LINE	1.9	2.6	1.4	1.0	1.0	21.1 CU. FT.	9.8 CU. FT.	0.8 CU. FT.
6" DIA. PIPE LINE	3.6	5.0	2.7	1.4	1.0	50 CU. FT.	16 CU. FT.	1.0 CU. FT.
8" DIA. PIPE LINE	5.8	8.2	4.4	2.25	1.2			1.5 CU. FT.




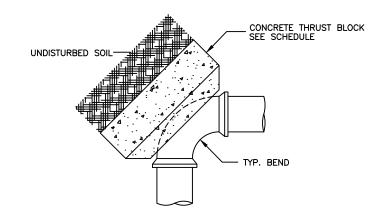


VERTICAL ANCHOR

TEE THRUST BLOCK DETAIL

HORIZ. THRUST BLOCK DETAIL

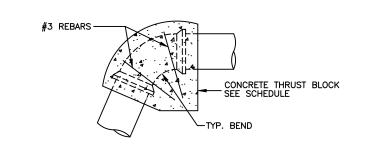

VERT. THRUST BLOCK DETAIL

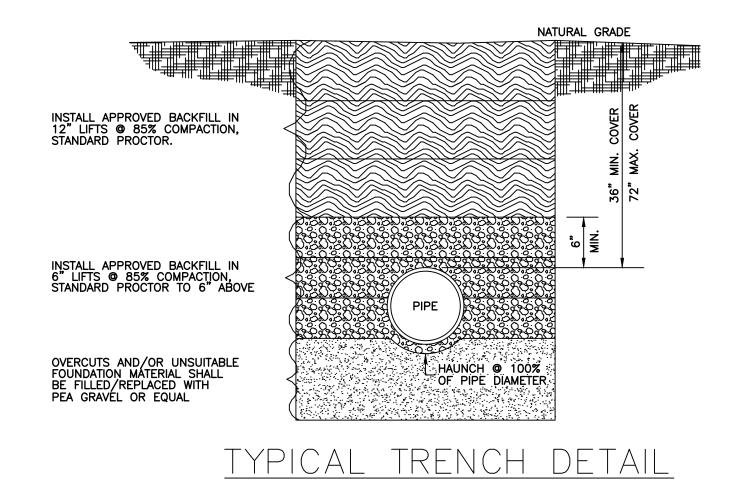


N.T.S.


NUMBER:	REVISION:	DATE:




ALL COMPONENTS SHALL BE PER REQUIRED BY ORANGE BEACH WATER **AUTHORITY**

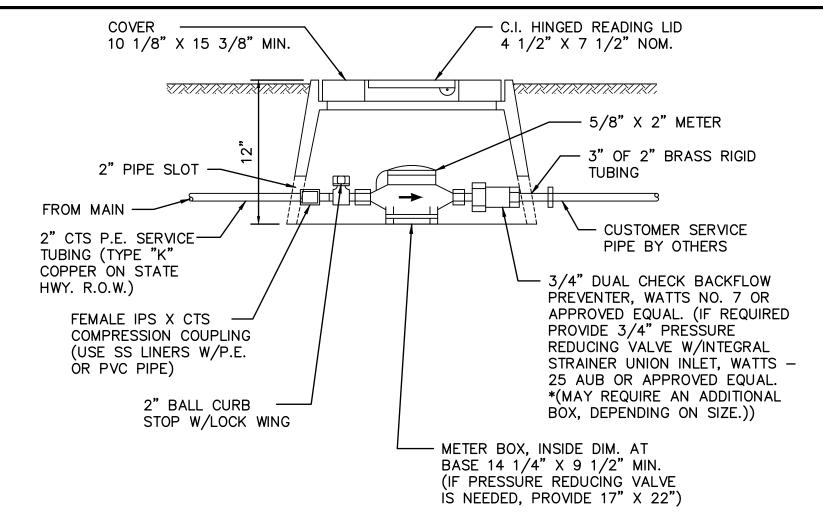

TYPICAL SERVICE METER / (PRESSURE REGULATOR)

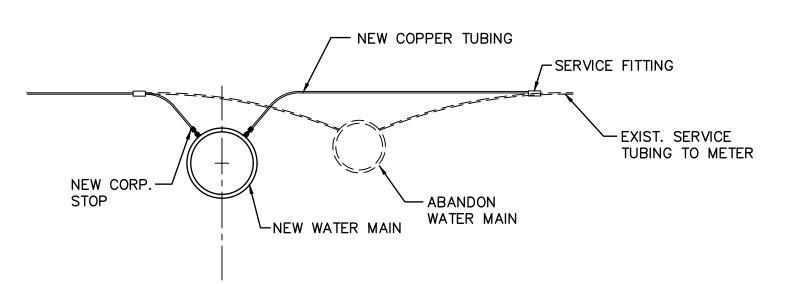

CONNECTION OF EXISTING SERVICES

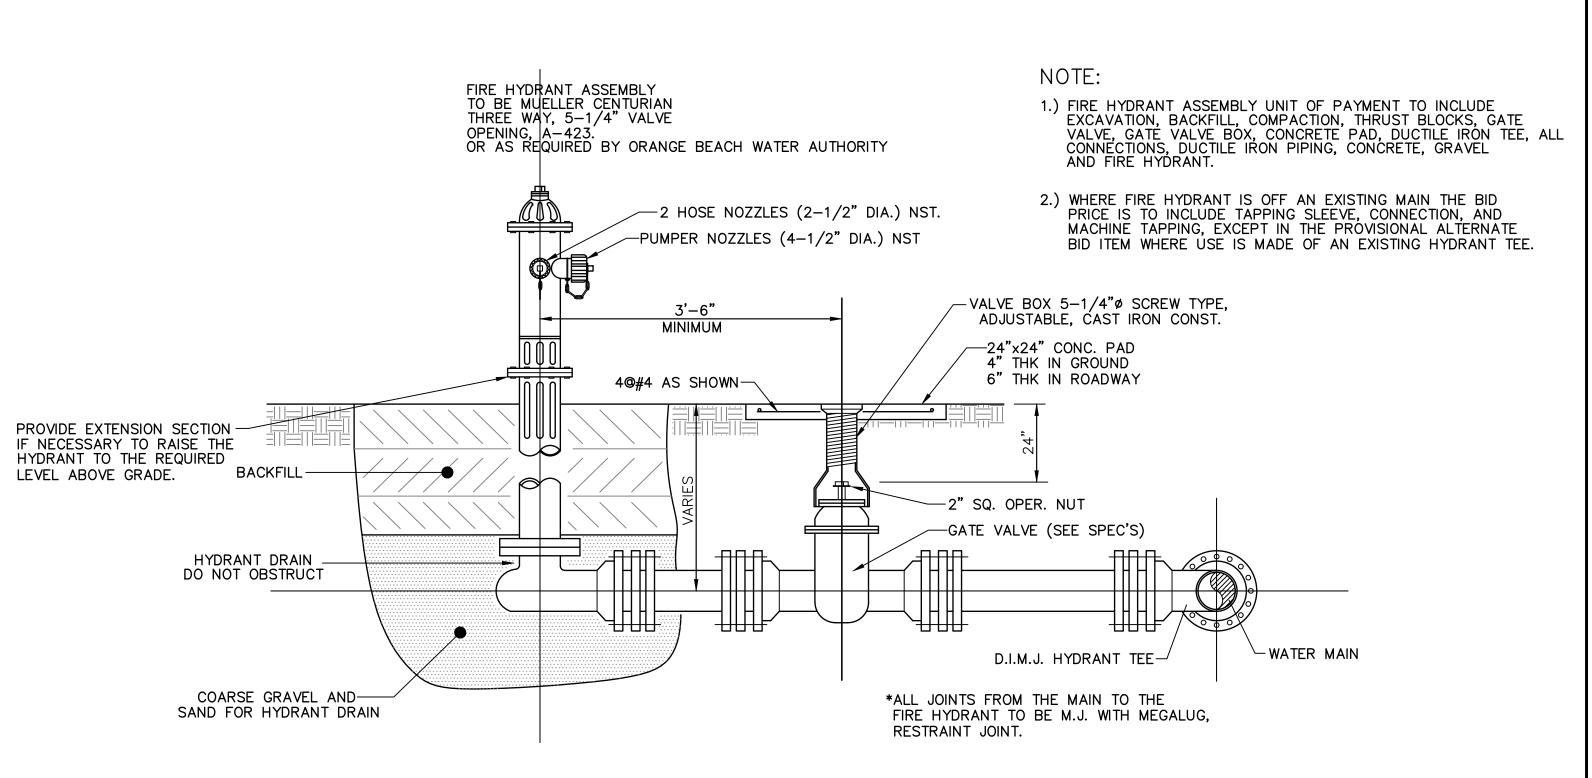

FIRE HYDRANT ASSEMBLY

UTILITY DETAILS


CITY OF ORANGE BEACH

TRAIL SHOP / WILDLIFE CENTER



SCALE:	NTS
DATE:	MAY 2021
DRAWN BY:	KL
CHECKED BY:	JR
SHEET: 14	OF 15


*NOT ALL DETAILS MAY BE APPLICABLE TO THIS PROJECT

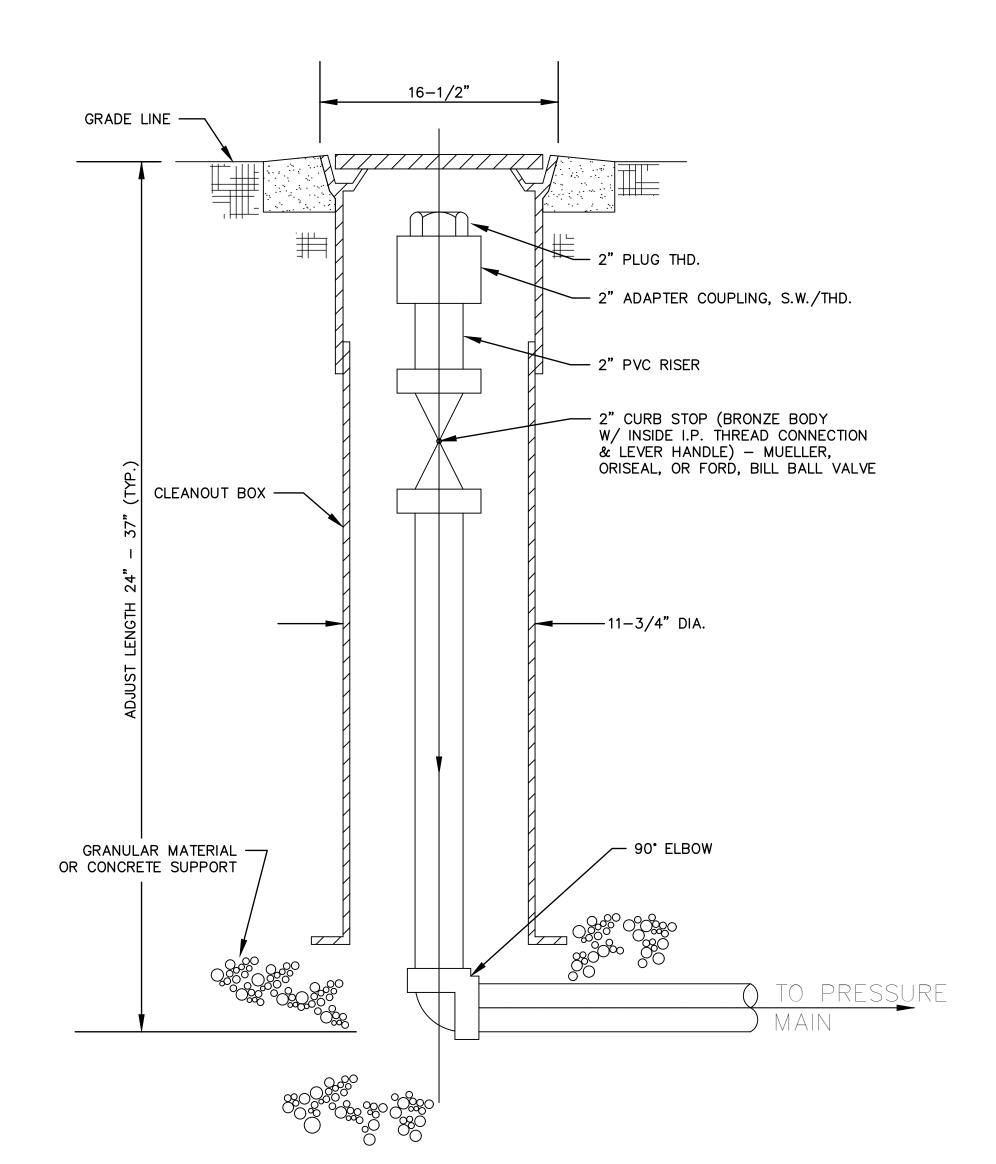



CLEANOUT BOX NOTES

- 1. CLEANOUT BOX SHALL BE CAST IRON, 12" ROUND SHAFT SCREW TYPE, ADJUSTABLE TWO PIECE CONSTRUCTION WITH 22" BOTTOM FLANGE AND COVER LETTERED "SEWER".
- 2. CLEANOUT BOX MAY BE ADJUSTABLE ALONG € OF PIPE TO PROVIDE MAXIMUM ACCESSIBILITY TO THE CLEANOUT VALVE OPERATOR.
- 3. CONCRETE COLLAR TO BE INCLUDED IN UNIT PRICE BID FOR CLEANOUT ASSEMBLY, JUNCTION ASSEMBLY, OR GATE VALVES.

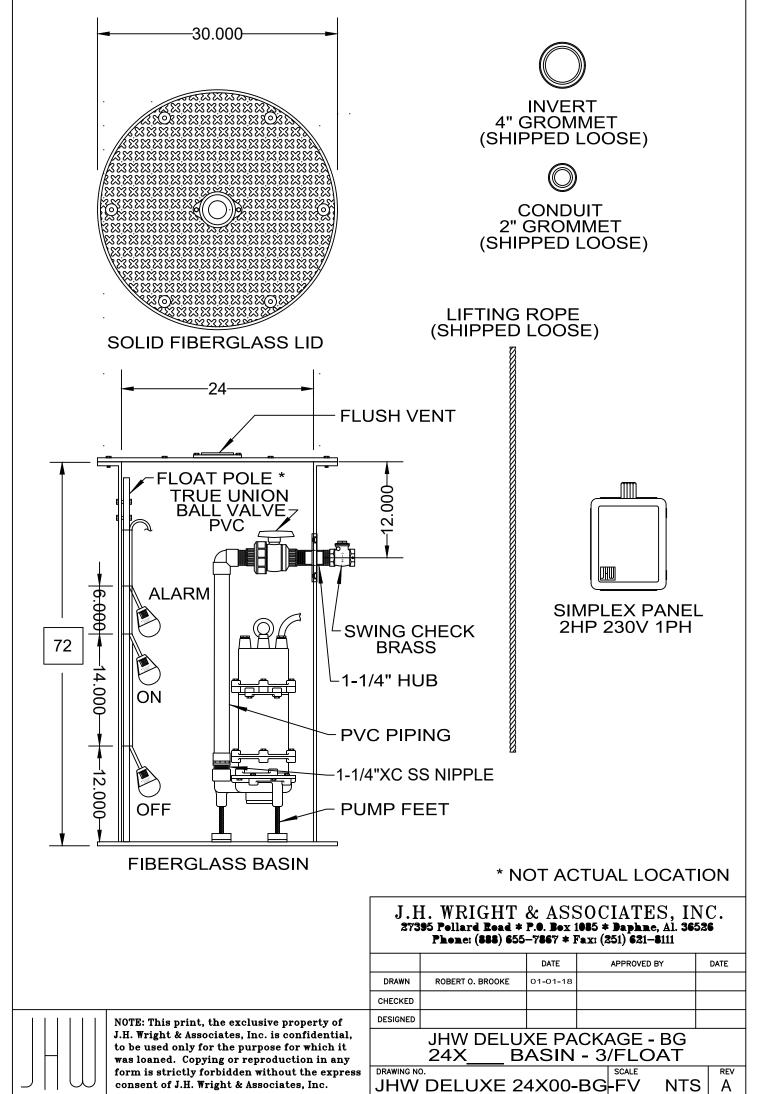

TYPICAL PRESSURE PIPE INSTALLATION DETA	.IL

WIDTH VARIES SEE SPECIFICATIONS

GATE VALVE

CONC. COLLAR (TYP.) TO BE — INCLUDED IN UNIT PRICE BID FOR VALVES AND CONNECTIONS. SLOPE

GRADE LINE _____ C.I. VALVE BOX __

GRANULAR MATERIAL -OR CONCRETE SUPPORT TOP OF CONC. AS SHOWN.

3'-6"

TYPICAL IN-LINE CLEANOUT ASSEMBLY DETAIL

PLAN

N.T.S.

12 GAUGE COPPER WIRE TO

NON-METALLIC PIPES. WIRE SHALL BE NO DEEPER THAN

18" BELOW FINISHED GRADE

BE BURIED ABOVE ALL

EXCAVATE FOR BELLS

BOTTOM QUADRANT OF

PIPE BEDDED FULL

LENGTH OF BARREL

- 2" PLUG THD.

CLEANOUT

∠ 2" RISER PIPE

- CLEANOUT BOX

— CLEANOUT BOX

2" ADAPTER COUPLING, S.W./THD.

 2" CURB STOP (BRONZE BODY W/ INSIDE THREAD CONNECTION & LEVER HANDLE) - MUELLER,

ORISEAL, OR FORD, BILL BALL VALVE

) PRESSURE MAIN

) PRESSURE MAIN

ON PLAN

6" COLLAR W/CAP——

ON PLAN

SIZE AS SHOWN



SLOPE @ 1% MIN.

--- 6" PVC TEE WYE

6" PVC SEWER LATERAL

SEWER CLEAN-OUT

N.T.S.


SEWER DETAILS

TRAIL SHOP / WILDLIFE CENTER

CITY OF ORANGE BEACH



SCALE:		NTS		
DATE:		MAY 20	021	
DRAWN BY	′ :	KL		
CHECKED	ECKED BY:			
SHEET:	15	OF	15	
	DATE: DRAWN BY CHECKED	DATE: DRAWN BY: CHECKED BY:	DATE: MAY 20 DRAWN BY: KL CHECKED BY: JR	DATE: MAY 2021 DRAWN BY: KL CHECKED BY: JR

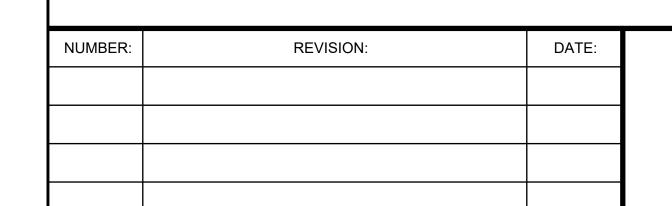


APPROVED BACKFILL TAMPED

APPROVED BACKFILL TAMPED

6" LAYERS TO 95% OF MODIFIED

PROCTOR TO 1'-0" ABOVE PIPE

12" LAYERS TO 90% — OF MODIFIED PROCTOR

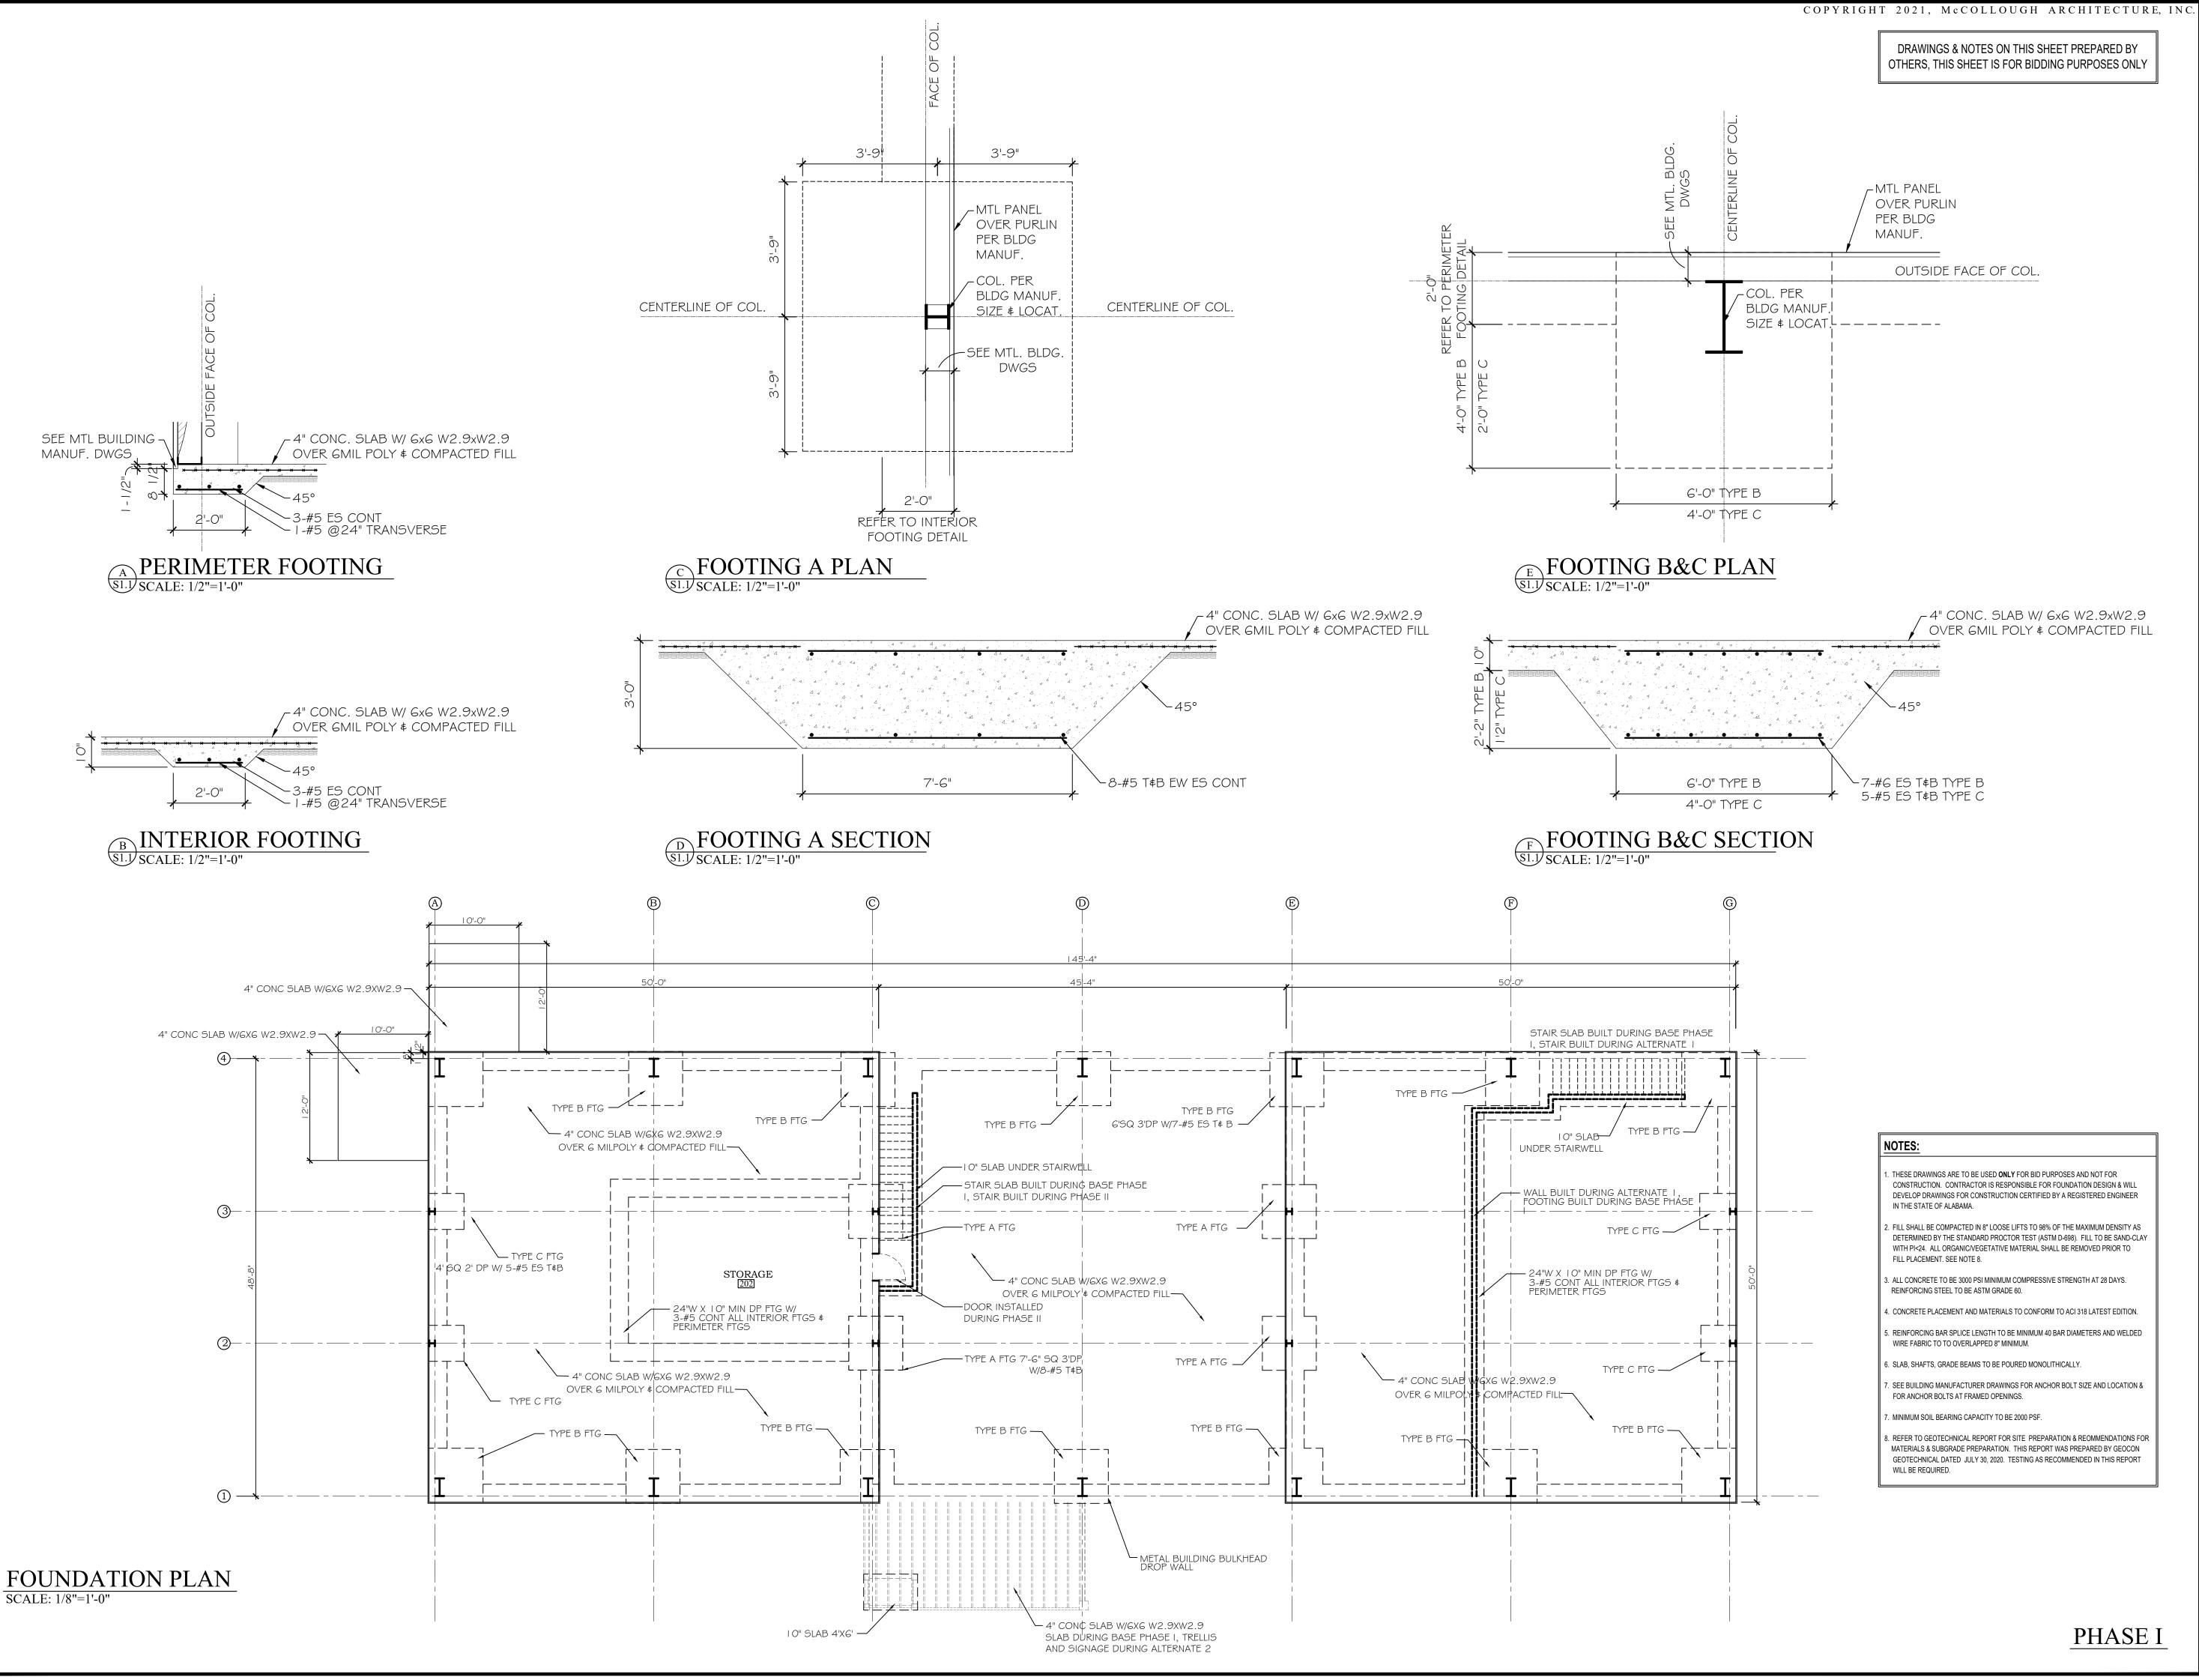



FOR BIDDING TO SES ONLY

NEW BUILDING CONCEPTS FOR ORANGE BEACH SHOP / WILDLIFE CENTE

JOB NO.:

DRAWN: CLT

CHECKED: SBM

DATE: 2021.06.01


REVISION:

SCALE: 1/8" = 1'-0"


SHEET NO.:

S1.1

FOUNDATION PLAN & DETAILS

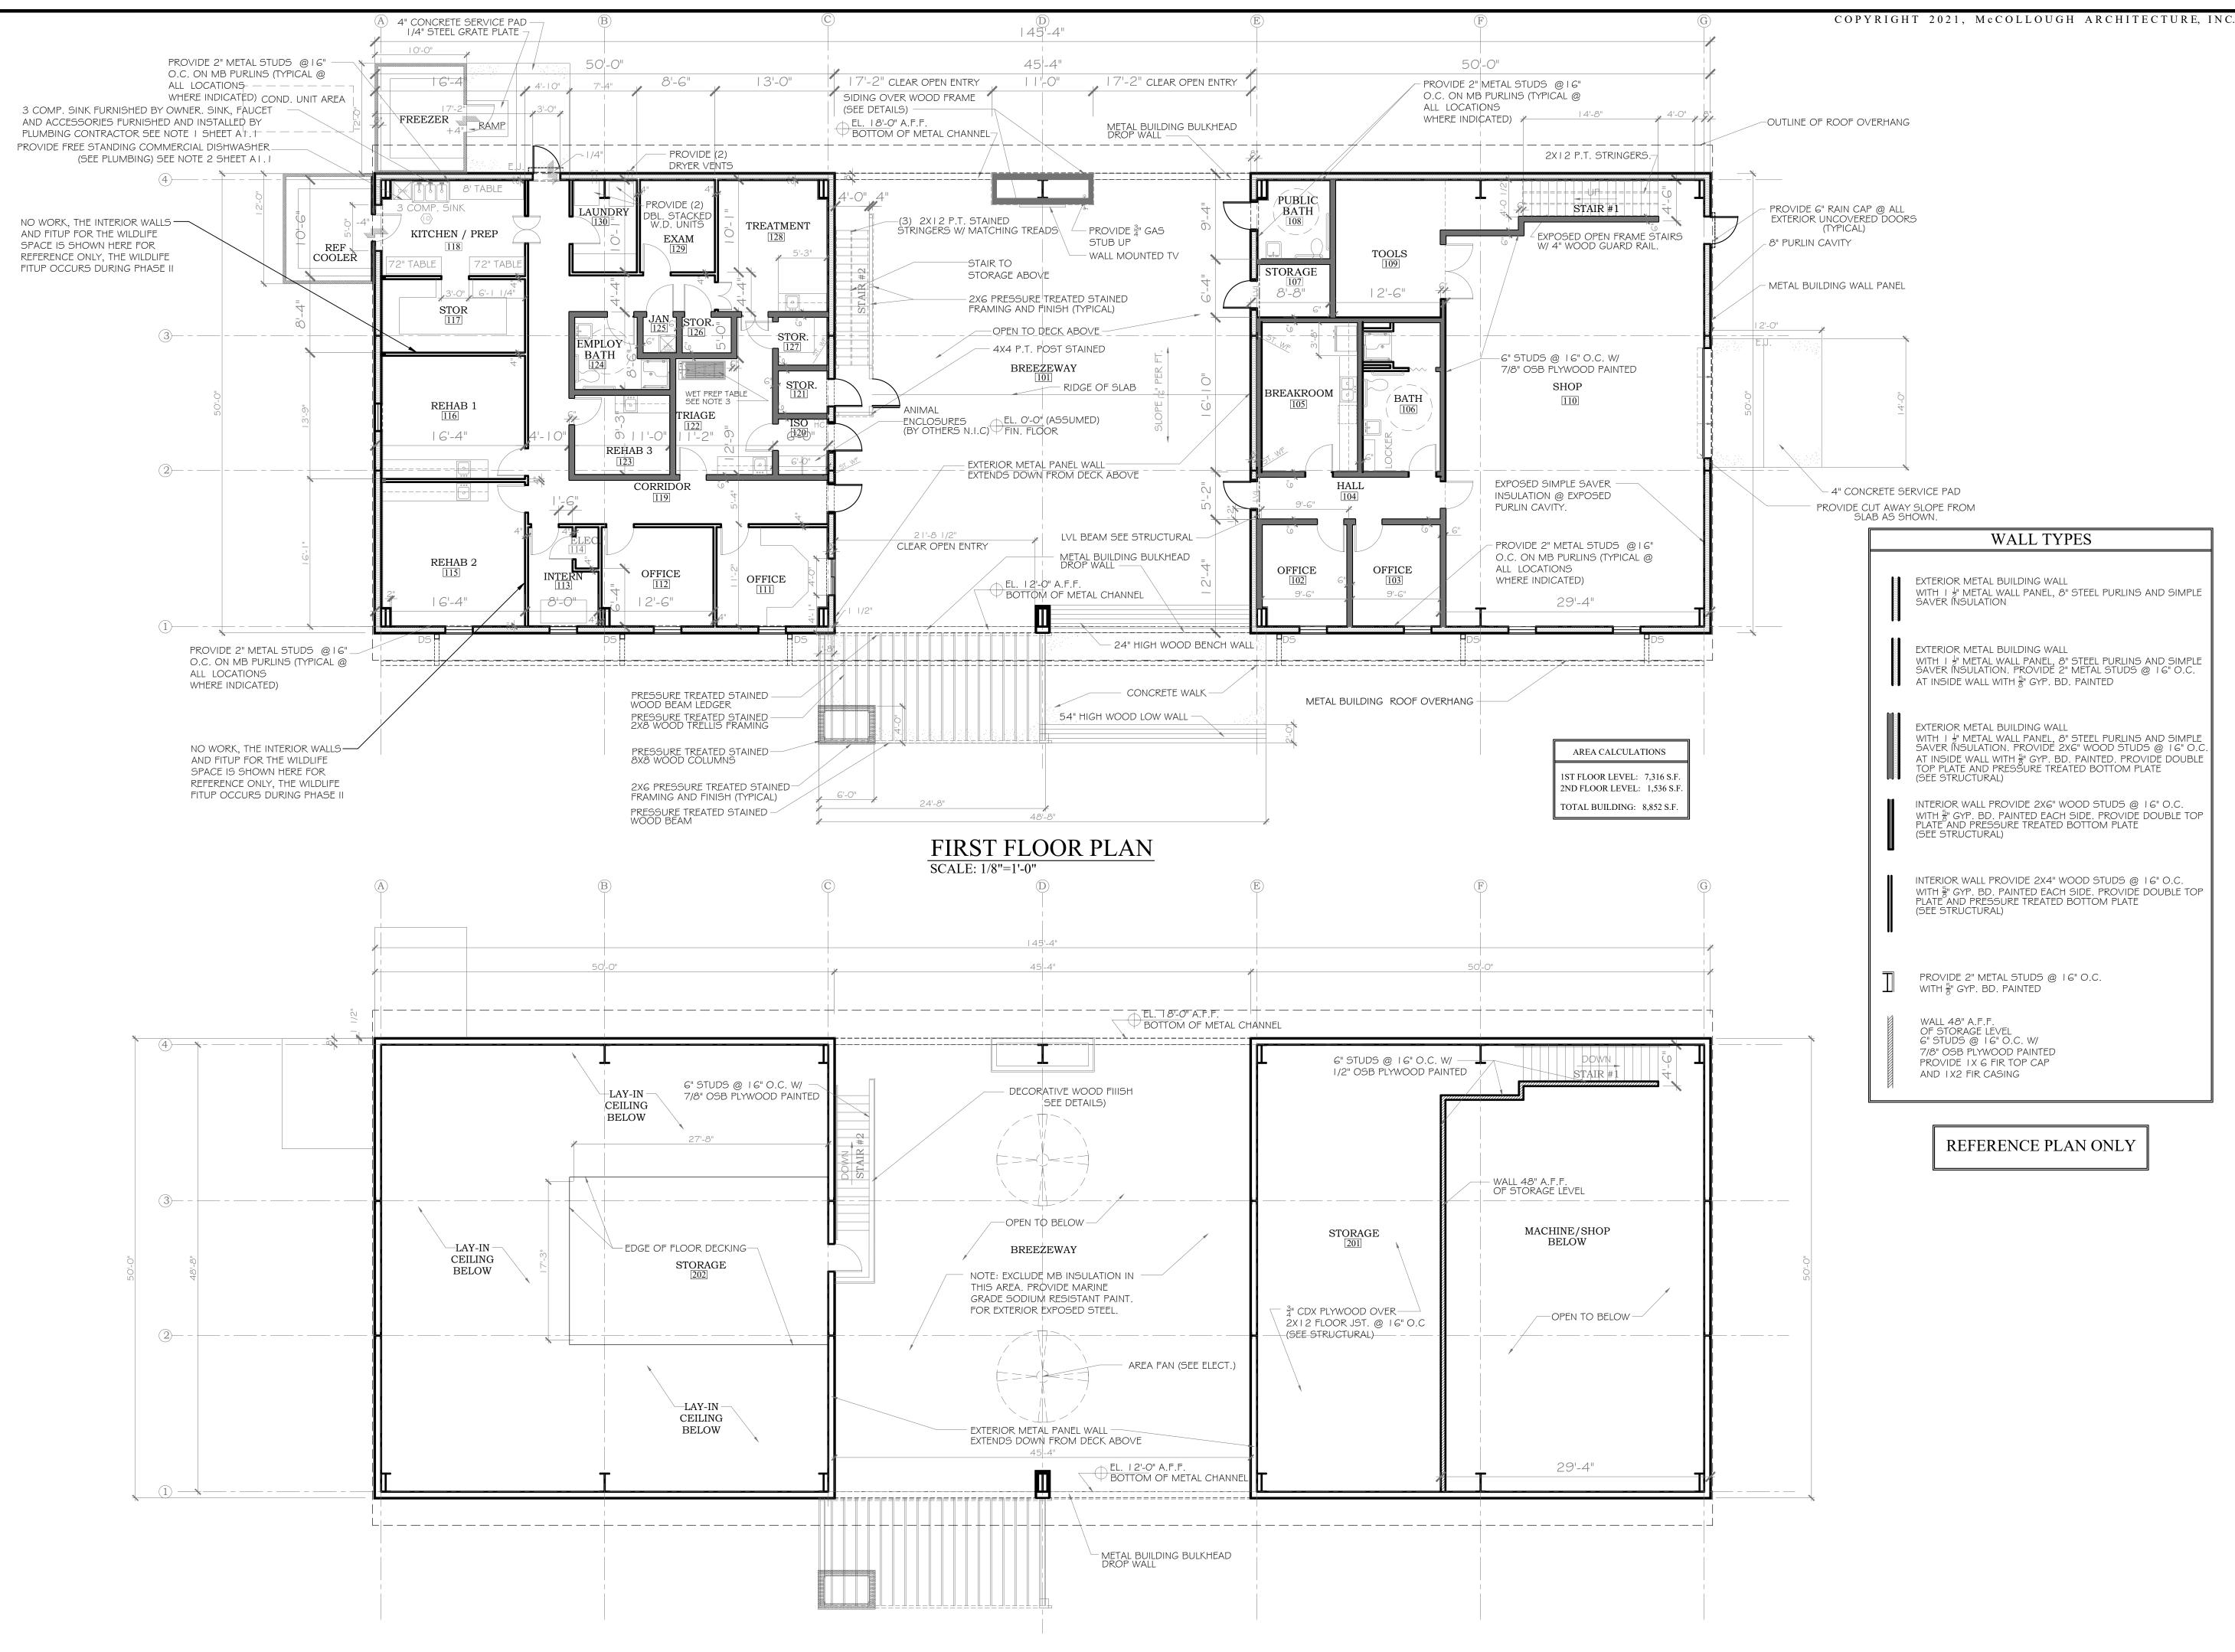



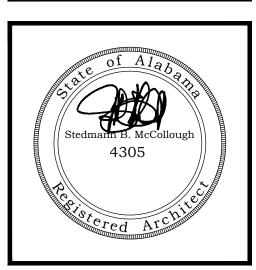

NEW BUILDING CONCEPTS FOR ORANGE BEACH 'RAIL SHOP / WILDLIFE CENTE

JOB NO.: 21-05
DRAWN: CLT
CHECKED: SBM
DATE: 2021.06.01
REVISION:


SCALE: 1/8" = 1'-0"

SHEET NO.:

PHASE I

RA1.1

COMPLETED PROJECT
REFERENCE FOR PHASE I

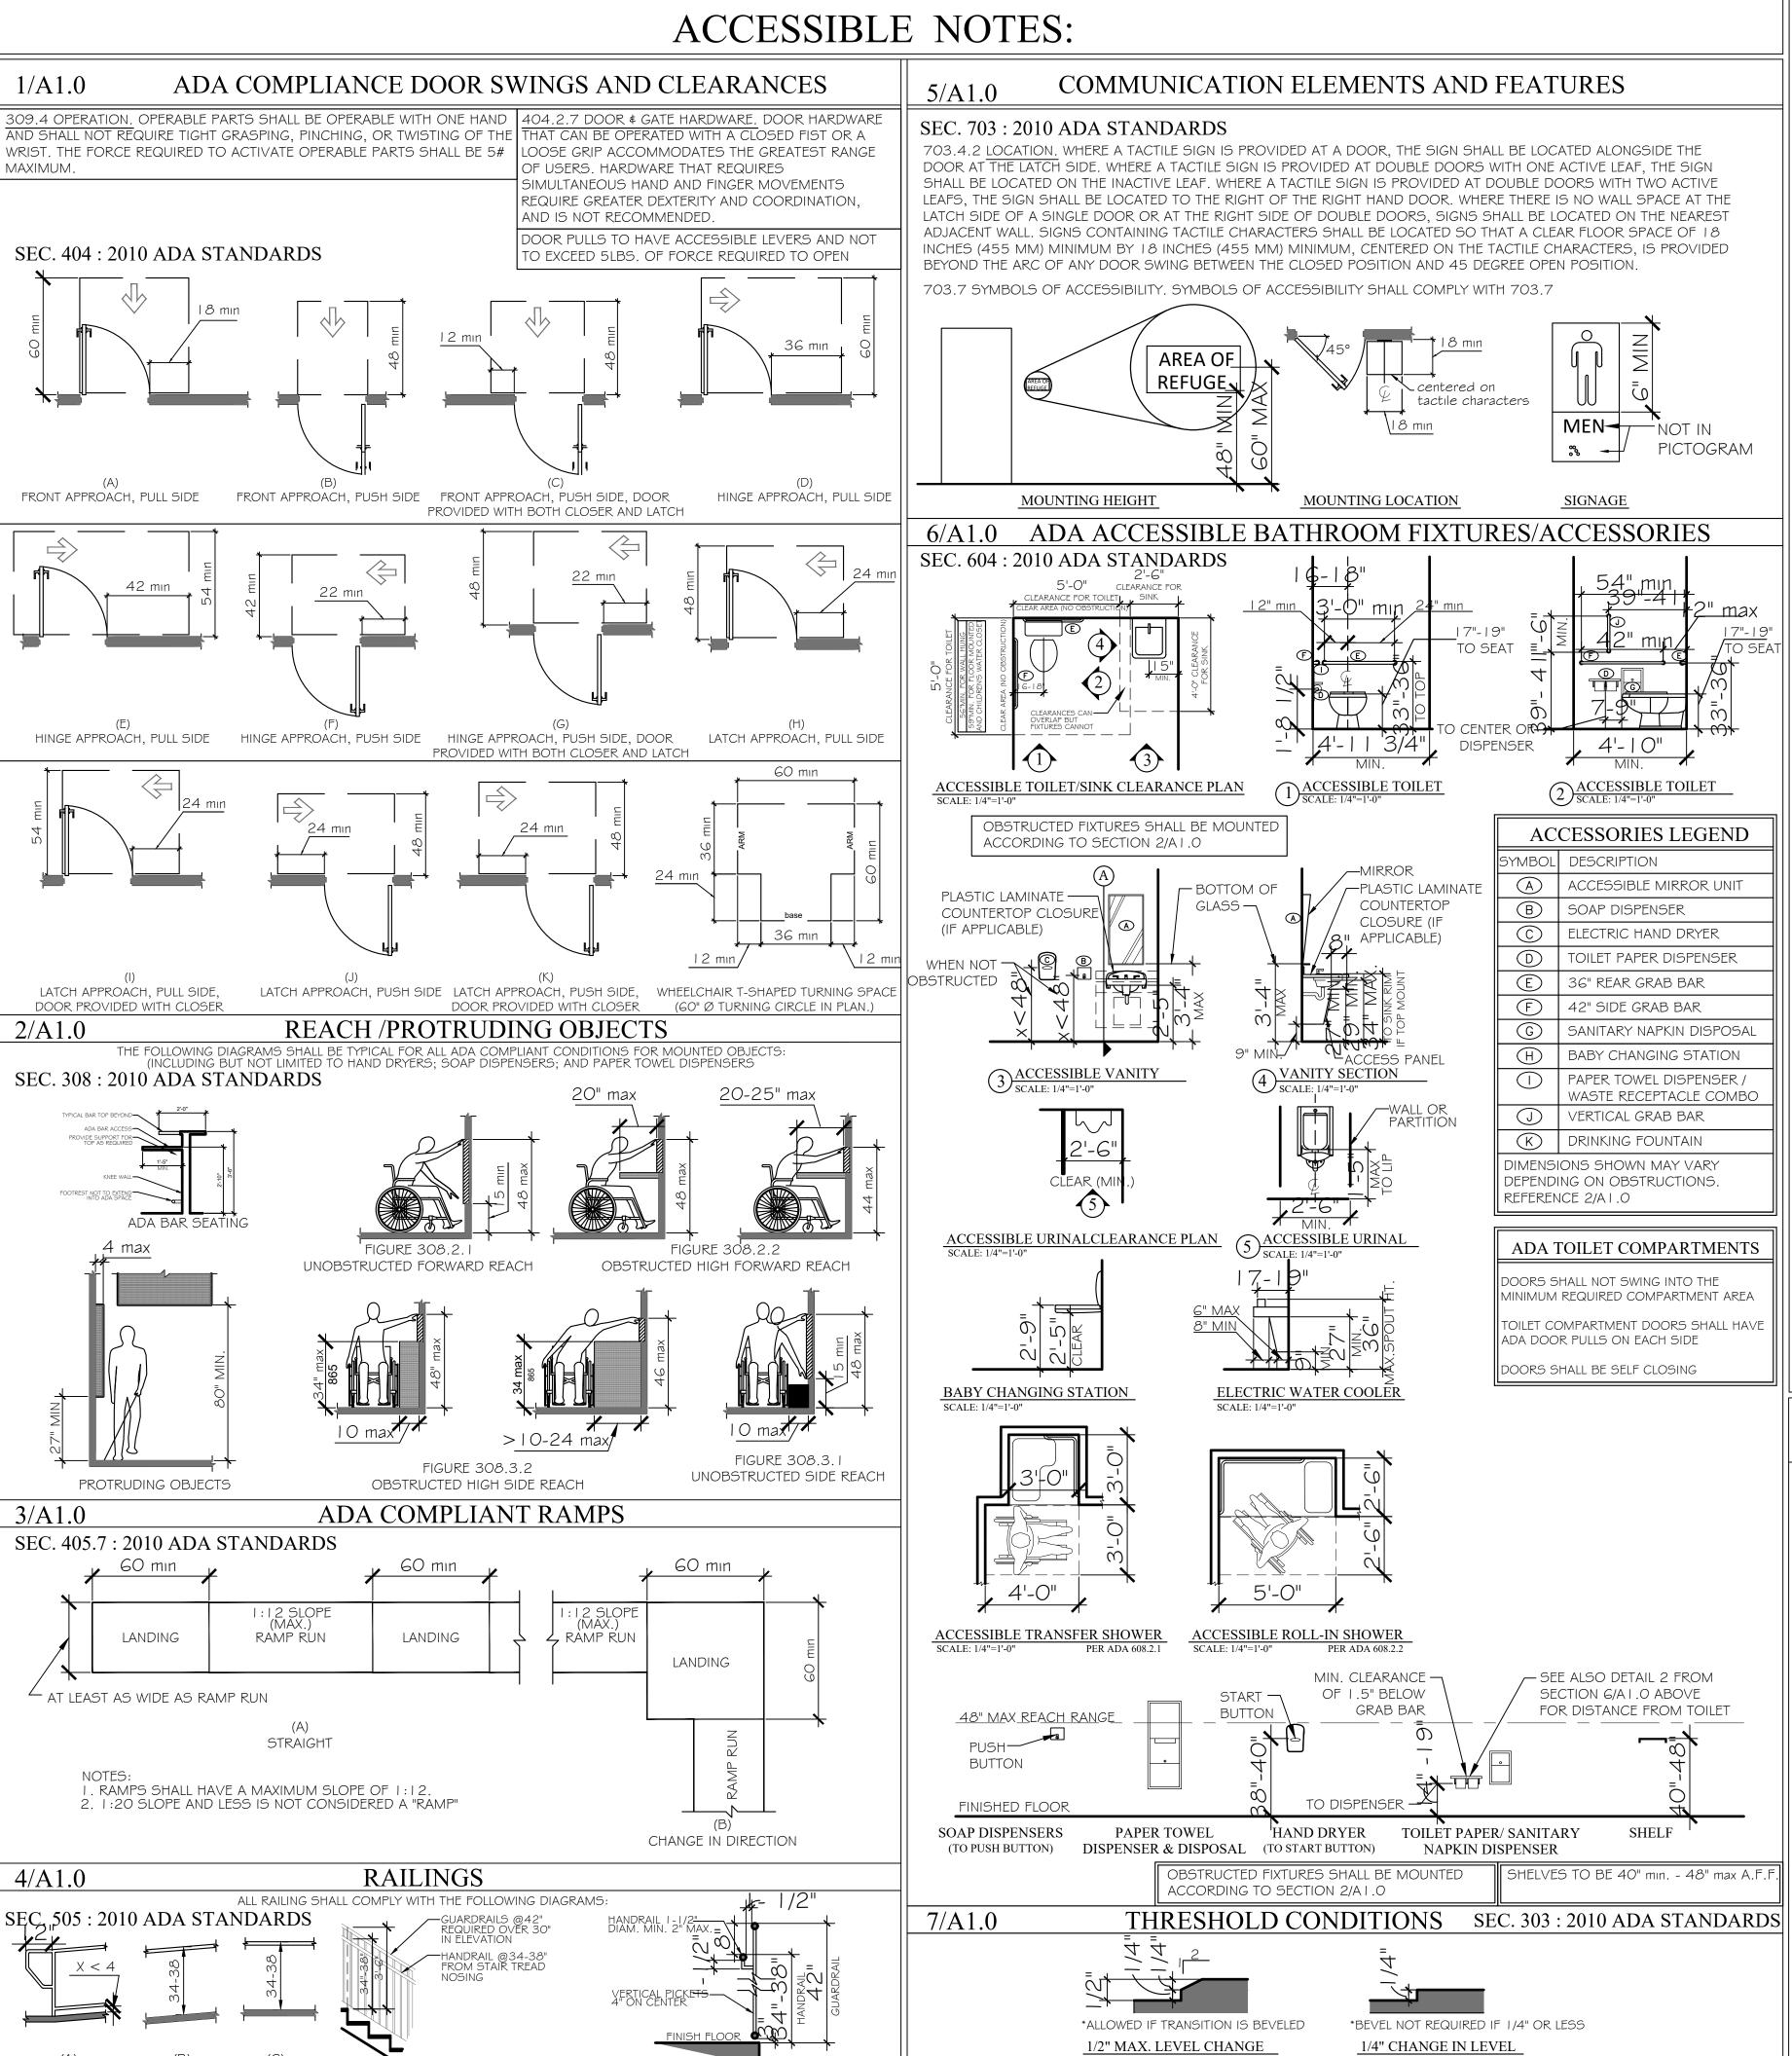

A CHANGE IN LEVEL OF 1/2 INCH IS PERMITTED TO BE 1/4" VERTICAL, PLUS 1/4" BEVELED.

HOWEVER, IN NO CASE MAY THE COMBINED CHANGE IN LEVEL EXCEED 1/2".

1/A1.0

MAXIMUM.

2/A1.0

3/A1.0

4/A1.0

HANDRAIL EXTENSION RAMP

(BOTH ENDS)

FIGURE 405.9.2

LANDING STAIR SECTION

HANDRAIL/GUARDRAIL

	EVIATION LEGEND
ABBREV.	TERM
ACC.	ACCESSIBLE
ACT	ACOUSTICAL CEILING TILE
ADA	AMERICANS WITH DISABILITIES ACT
A.F.F.	ABOVE FINISHED FLOOR
ALUM.	ALUMINUM
ASSEM.	ASSEMBLY
B.B.	BEAD BOARD
CONC.	CONCRETE
CONT.	CONTINUOUS
CPT.	CARPET
DIM	DIMINSION(S)
D/W	DISHWASHER
ELEC.	ELECTRIC / ELECTRICAL
ELEV.	ELEVATOR
EQUIP. E.P.	EQUIPMENT EPOXY PAINT
EXT.	EXTERIOR
EWC	ELECTRIC WATER COOLER
FEC	FIRE EXTINGUISHER CABINET
FG.	FIBERGLASS
FIN.	FINISH / FINISHED
FLR.	FLOOR
FRP	FIBER-REINFORCED PLASTIC
FT.	FOOT / FEET
GFI	GROUND FAULT INTERRUPTOR
GYP.BD.	GYPSUM BOARD
H.B.	HOSE BIBB
H.C.	HOLLOW CORE
H.M.	HOLLOW METAL
HORIZ.	HORIZONTAL
HR	HOUR
INT.	INTERIOR
JAN.	JANITOR
MAX MECH.	MAXIMUM
MT.	MECHANICAL METAL
MICRO.	MICROWAVE
MIN.	MINIMUM
M.R.	MOISTURE RESISTANT
N.T.S.	NOT TO SCALE
O.C.	ON CENTER
PRE-FAB	PRE FABRICATED
PT.	PAINT / PAINTED
P.T.	PRESSURE TREATED
Q.T.	QUARRY TILE
REF.	REFRIGERATOR
REINF.	REINFORCED
REQ.	REQUIRED
SC.	SOLID CORE
S.F.	SQUARE FOOT / FEET
SHWR.	SHOWER CTAINED
5.5. S/S	SCORED \$ STAINED STAINLESS STEEL
5/5 ST.	STAINLESS STEEL STAINED
STOR.	STORAGE
TYP.	TYPICAL
U/C	UNDER COUNTER
VEND.	VENDING MACHINE
V.W.P.	VINYL WOOD PLANK
WD	WOOD
W/	WITH
W/D	WASHER DRYER
W/O	WITH OUT
•	

[30]	ROOM NUMBER
[24]	DOOR NUMBER
DETAIL NUMBER AG. I SHEET NUMBER	INTERIOR ELEVATI
SECTION IDENTIFICATION BB SECTION LOCATION A4.2 SHEET NUMBER	SECTION CUT LOCATION MARKE
DRAWING DESIGNATION A A2.5 SHEET NUMBER	DETAIL MARKER
WALL TYPE NUMBER INTERSECTS WALL REFERENCED	WALL TYPE MARKI
STOREFRONT	STOREFRONT TYP
HEIGHT OF CEILING A.F.F.	ELEVATION MARK
REVISION NUMBER	REVISION MARKER

GENERAL NOTES


- ALL PRODUCTS, MATERIALS, AND CONSTRUCTION SHALL BE PROVIDED AND/OR INSTALLED IN STRICT ACCORDANCE WITH THE MANUFACTURERS SPECIFICATIONS, GUIDELINES, AND/OR INDUSTRY STANDARDS.
- . THE INTENT OF THESE DRAWINGS IS TO PROVIDE THE BUILDER WITH GENERAL GUIDELINES FOR THE SOUND CONSTRUCTION OF THE STRUCTURE INDICATED WITHIN. DEVIATIONS FROM THESE DRAWINGS ARE THE BUILDERS RISK UNLESS APPROVED IN WRITING OR WITH SUPPLEMENTAL DRAWINGS FROM THE ARCHITECT.
- . IT IS RECOMMENDED THAT THE SERVICES OF A REGISTERED LAND SURVEYOR BE EMPLOYED FOR THE PROPER PLACEMENT OF THE STRUCTURE IN RELATION TO PROPERTY LINES, SETBACK LINES, EASEMENTS, ETC.
- . CONTRACTOR TO SECURE AND PAY FOR ALL NECESSARY FEES AND PERMITS FOR CONSTRUCTION, ELECTRICAL, AND PLUMBING INSPECTORS,
- DO NOT SCALE DRAWINGS!!! DIMENSIONS OR LINEAR MEASUREMENTS TAKE PRECEDENCE OVER NOTED DIMENSIONS.
- S. DIMENSIONS INDICATED ON DRAWINGS ARE TO FACE OF STUDS.
- THE CONTRACTOR SHALL FIELD VERIFY ALL DIMENSIONS INDICATED WITHIN THESE DOCUMENTS AND SHALL NOTIFY THE ARCHITECT OF ANY VARIATION PRIOR TO THE PURCHASING OF ANY MATERIALS, STARTING FABRICATION, OR BEGINNING CONSTRUCTION

- 8. PROVIDE TEMPORARY SETTLING BASINS, HAY BALES, AND OTHER METHODS AS APPROPRIATE TO FILTER WATER AT ALL AREAS WHERE STORM WATER LEAVES THE PROJECT. CLEAN UP ALL SOIL WHICH FLOWS OFF SITE AT THE END OF THE DAY.
- 9. ALL EXISTING SITE CONDITIONS ARE TO BE VERIFIED BY CONTRACTOR BEFORE START OF CONSTRUCTION.
- 10. PROVIDE CHEMICAL BARRIER TO BUILDING FROM SUBTERRANEAN TERMITE ATTACK.
- I I . NO QUALIFYING STATEMENTS OR EXCEPTIONS TO PLANS OR NOTES TO BE ALLOWED.
- 12. ALL WORK RELATED DEBRIS SHALL BE REMOVED FROM THE SITE REGULARLY AND PROPERLY.
- 13. THE CONTRACTOR SHALL LEAVE ALL AREAS AND FINISHED SPACES IN
- A CLEAN AND ACCEPTABLE CONDITION AT THE PROJECT COMPLETION. 14. ALL CONTRACTORS AND SUBCONTRACTORS SHALL COMPLY W/ OSHA
- 15. ALL NEW CONSTRUCTION SHALL COMPLY WITH ALL APPLICABLE BUILDING

REQUIREMENTS.

CODES AND RESTRICTIVE ORDINANCES FOR CONSTRUCTION, ELECTRICAL PLUMBING, AND MECHANICAL.



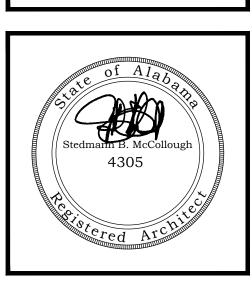


BE

JOB NO.: 21-05 CLT DRAWN: **SBM** CHECKED: 2021.06.01 DATE: **REVISION:**

1/4"-1'-0" SCALE:

SHEET NO.:

ADA STADARDS

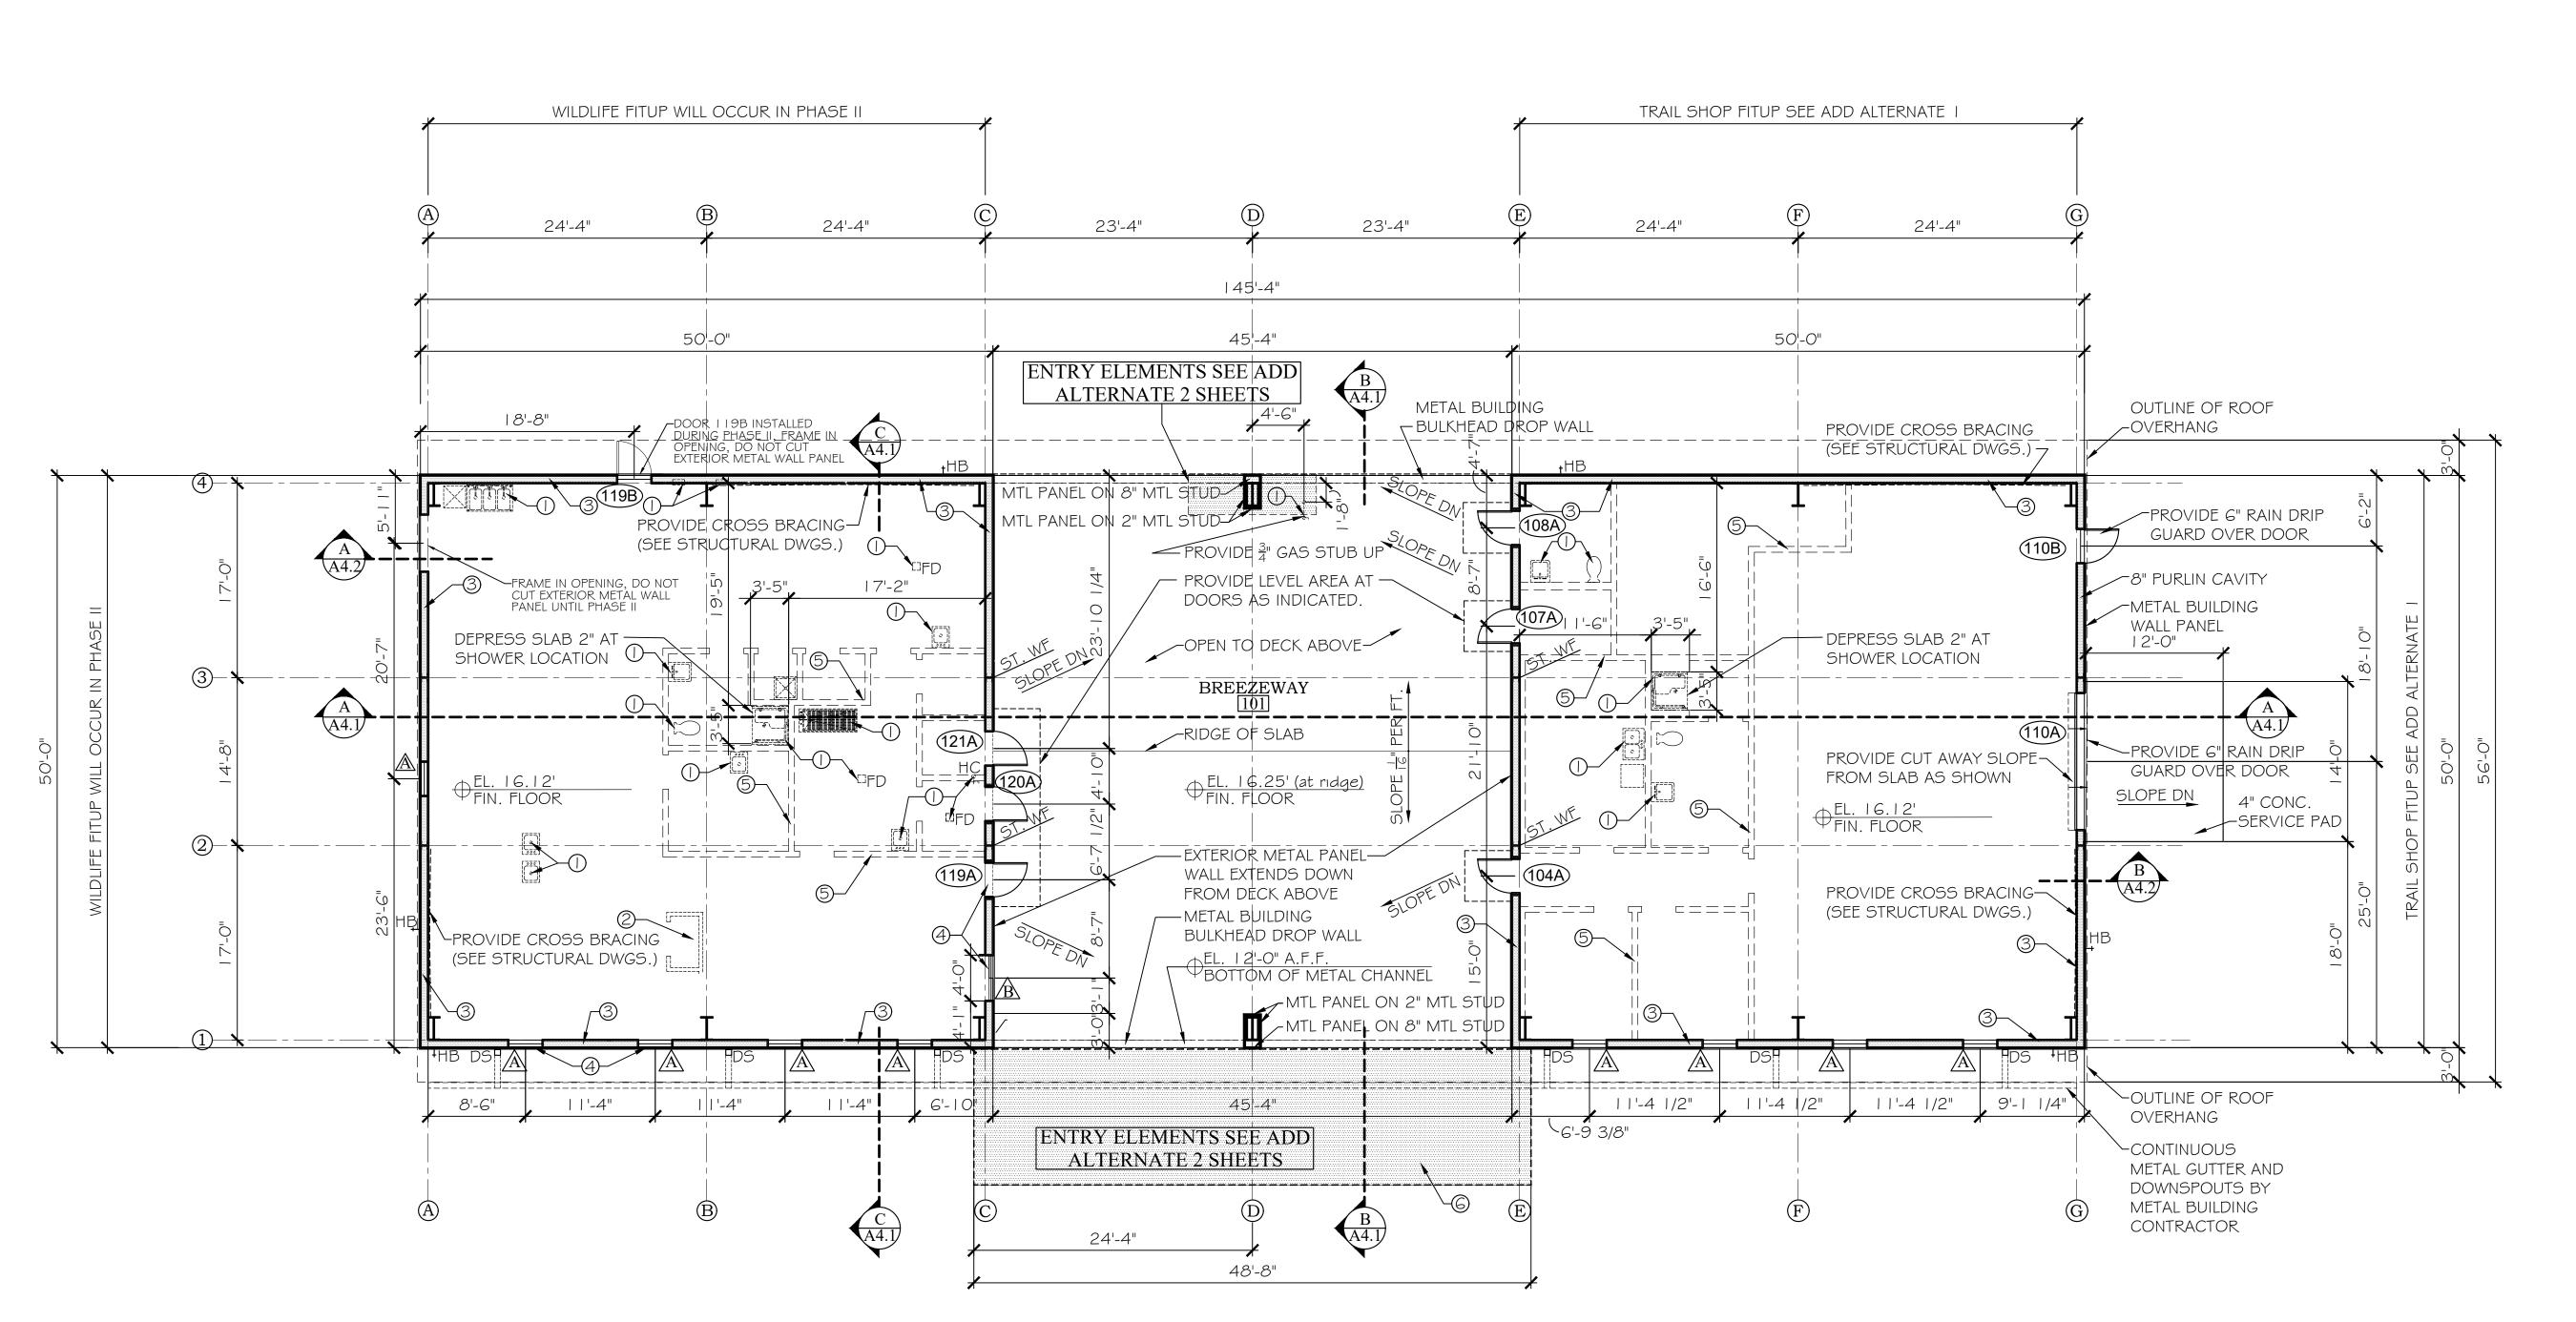

PHASE I FLOOR PLAN

SCALE: 1/8"=1'-0"

(SECOND FLOOR PHASE I CONSISTS OF METAL BUILDING SHELL ONLY)

AREA CALCULATIONS

1ST FLOOR LEVEL: 7,316 S.F.

ADD ALTERNATE 1
TRAIL SHOP FIT UP REFER TO ADD ALTERNATE 1
SHEETS

ADD ALTERNATE 2
FRONT ENTRY TREATMENT REFER TO ADD
ALTERNATE 2 SHEETS

LEGEND

ALTERNATE 2 WORK

======== FUTURE WALLS

WALL TYPES

EXTERIOR METAL BUILDING WALL WITH I ½"
METAL WALL PANEL 8" STEEL PURLINS AND
SIMPLE SAVER INSULATION
WHERE SCHEDULED

PHASE I NOTES

- PLUMBING CONTRACTOR WILL COORDINATE ALL STUB UP LOCATIONS AS REQUIRED.
- ELECTRICAL CONTRACTOR WILL COORDINATE ALL CONDUIT STUB UP LOCATIONS AS REQUIRED.
- METAL BUILDING CONTRACTOR WILL PROVIDE SIMPLE SAVER INSULATION @ ENTIRE PERIMETER PURLIN CAVITY AND ROOF PURLINS EXCEPT WHERE OMITTED AT BREEZEWAY AREA.
- METAL BUILDING CONTRACTOR SHALL VERIFY AND PROVIDE ALL DOOR AND WINDOW ROUGH OPENINGS AS REQUIRED.
- PROVIDE THICKENED SLAB AT ALL LOAD BEARING WALLS AS REQUIRED. REFER TO STRUCTURAL FOUNDATION PLAN FOR REQUIREMENTS.
- COORDINATE AS REQUIRED ALL PHASE I CONDITIONS AND PREP AS REQUIRED.
- REFER TO SHEET A I .O FOR THRESHOLD CONDITIONS. DO NOT EXCEED 1/2" VERTICAL RISE.

McCollough Architecture, Inc. P.O. Box 6310 GULF SHORES, ALABAMA 36547-6310 PHONE: 251-968-7222



PHASE 1 DRAWINGS FOR ORANGE BEACH TRAIL SHOP / WILDLIFE CENTE

JOB NO.: 21-05
DRAWN: CLT
CHECKED: SBM
DATE: 2021.06.01
REVISION:

SCALE: 1/8" = 1'-0"


SHEET NO.:

A1.1


PHASE I FLOOR PLANS

PHASE I

				DOC	R SCH	EDU	LE				
DOOR NO.	DOOR SIZE	DOOR	DOOR	DOOR	DOOR FINISH	FRAME	FRAME FINISH	RATING	PANIC HDWE	DOOR CLOSURE	REMARKS
		1	1	T	·						
104A	3'-0" X 7'-0"	G	METAL	EXTERIOR	PAINT	METAL		-	<u> </u>	-	
107A	3'-0" X 7'-0"	В	METAL	EXTERIOR	PAINT	METAL	PAINT	-	-	-	
108A	3'-0" X 7'-0"	В	METAL	EXTERIOR	PAINT	METAL	PAINT	-	-	-	CLOSER BY DOOR MANUF.
LLOA	12'-0"X14'-0"	E	METAL	EXTERIOR	-	-	-	-	-	-	COILING ROLL UP DOOR/ FINISHES BY MANF.
I I OB	3'-0" X 7'-0"	В	METAL	EXTERIOR	PAINT	METAL	PAINT	-	-	-	
119A	3'-0" X 7'-0"	G	METAL	EXTERIOR	PAINT	METAL	PAINT	-	-	-	HOLLOW METAL DOOR W/ HALF LITE
119B	3'-0" X 7'-0"	В	METAL	EXTERIOR	PAINT	METAL	PAINT	-	-	-	FRAME IN ONLY, DOOR INSTALL DURING PHASE LEAVE EXTERIOR METAL WALL PANEL INTACT
120A	3'-0" X 7'-0"	В	METAL	EXTERIOR	PAINT	METAL	PAINT	-	_	-	
121A	3'-0" X 7'-0"	В	METAL	EXTERIOR	PAINT	METAL	PAINT	-	-	-	
202A	3'-0" X 7'-0"	В	METAL	EXTERIOR	PAINT	METAL	PAINT	-	-	-	FRAME IN ONLY, DOOR INSTALL DURING PHASE LEAVE EXTERIOR METAL WALL PANEL INTACT

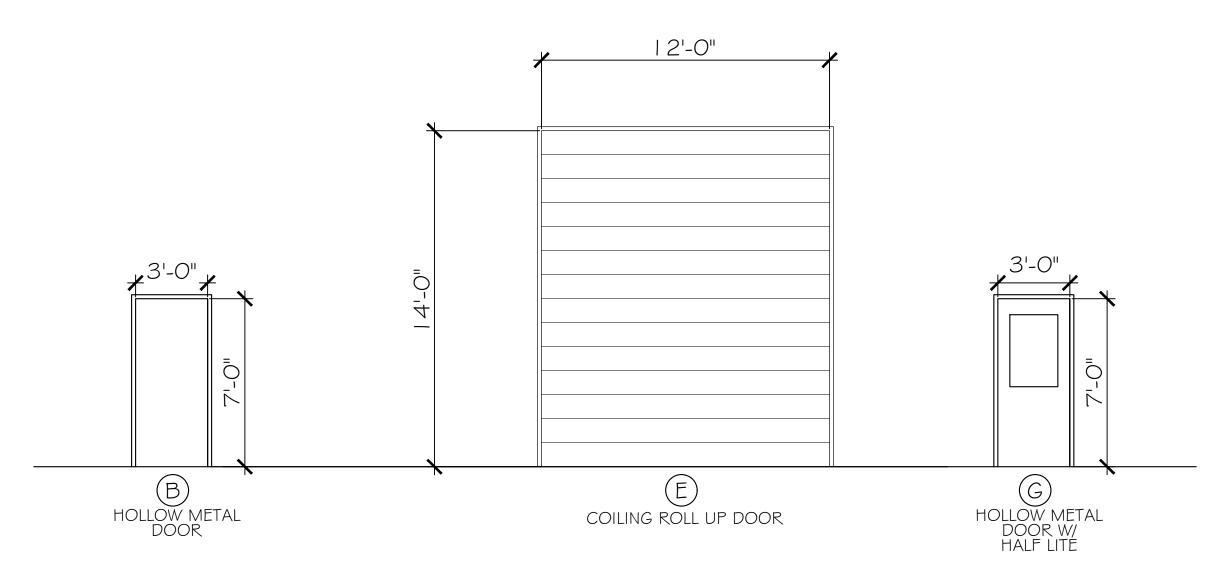

DOOR FRAME / TYPES SCALE: 1/4"=1'-0"

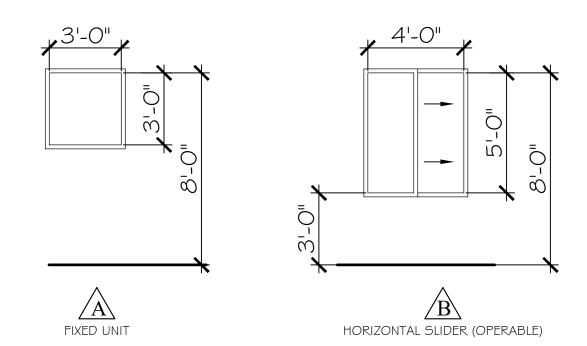


ALL WINDOW UNITS SHALL BE ALUMINUM STOREFRONT AND LARGE MISSILE IMPACT RESISTANT

WINDOW/ TYPES

SCALE: 1/4"=1'-0"

					ROOM FI	NISH SC	HEDUL	E			
ROOM NAME	FLOOR			WALLS					CEILING		REMARKS
	FLOORS	BA	SE	MATERIALS		FINISH		MATERIAL		FINISH	
101 BREEZEWAY	SEALED CONCRETE	EXPOSED META	AL BUILDING EXE	POSED METAL BUILDIN	IG.	EXPOSED META	AL BUILDING	EXPOSED MET	AL BUILDING	EXPOSED METAL BUILDING	
102 OFFICE	1	EXT OSES IVIETY	LE DOILDING LAN	I		LXI OOLD WILIT	(L DOTEDING	EXT COLD TVIET	THE BUILDING	I	
103 OFFICE											
104 HALL											
105 BREAKROOM											
106 BATH											
107 STORAGE											
108 BATH											
109 TOOLS											
IIO SHOP											
III OFFICE											
112 OFFICE											
113 INTERN											
14 ELECTRICAL											
15 REHAB #2											
II6 REHAB#I											
17 STORAGE											
18 KITCHEN / PREP.											
19 CORRIDOR											
20 ISOLATION											
121 STORAGE											
22 TRIAGE											
123 REHAB #3											
124 EMPLOYEE BATH											
125 JANITOR											
126 STORAGE											
127 STORAGE											
28 TREATMENT											
129 LAB											
130 LAUNDRY	+	 		*		+		 		 	
201 STORAGE	NONE										
102 STORAGE	NONE —										



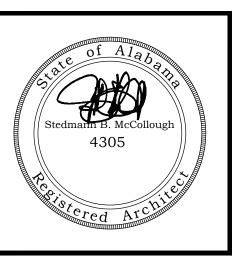


PHASE 1 DRAWINGS FOR ORANGE BEACH RAIL SHOP / WILDLIFE CEN

JOB NO.: 21-05
DRAWN: CLT
CHECKED: SBM
DATE: 2021.06.01
REVISION:

SCALE: 1/4"=1'-0"


SHEET NO.:


A2.1
SCHEDULES AND DETAILS PHASE I

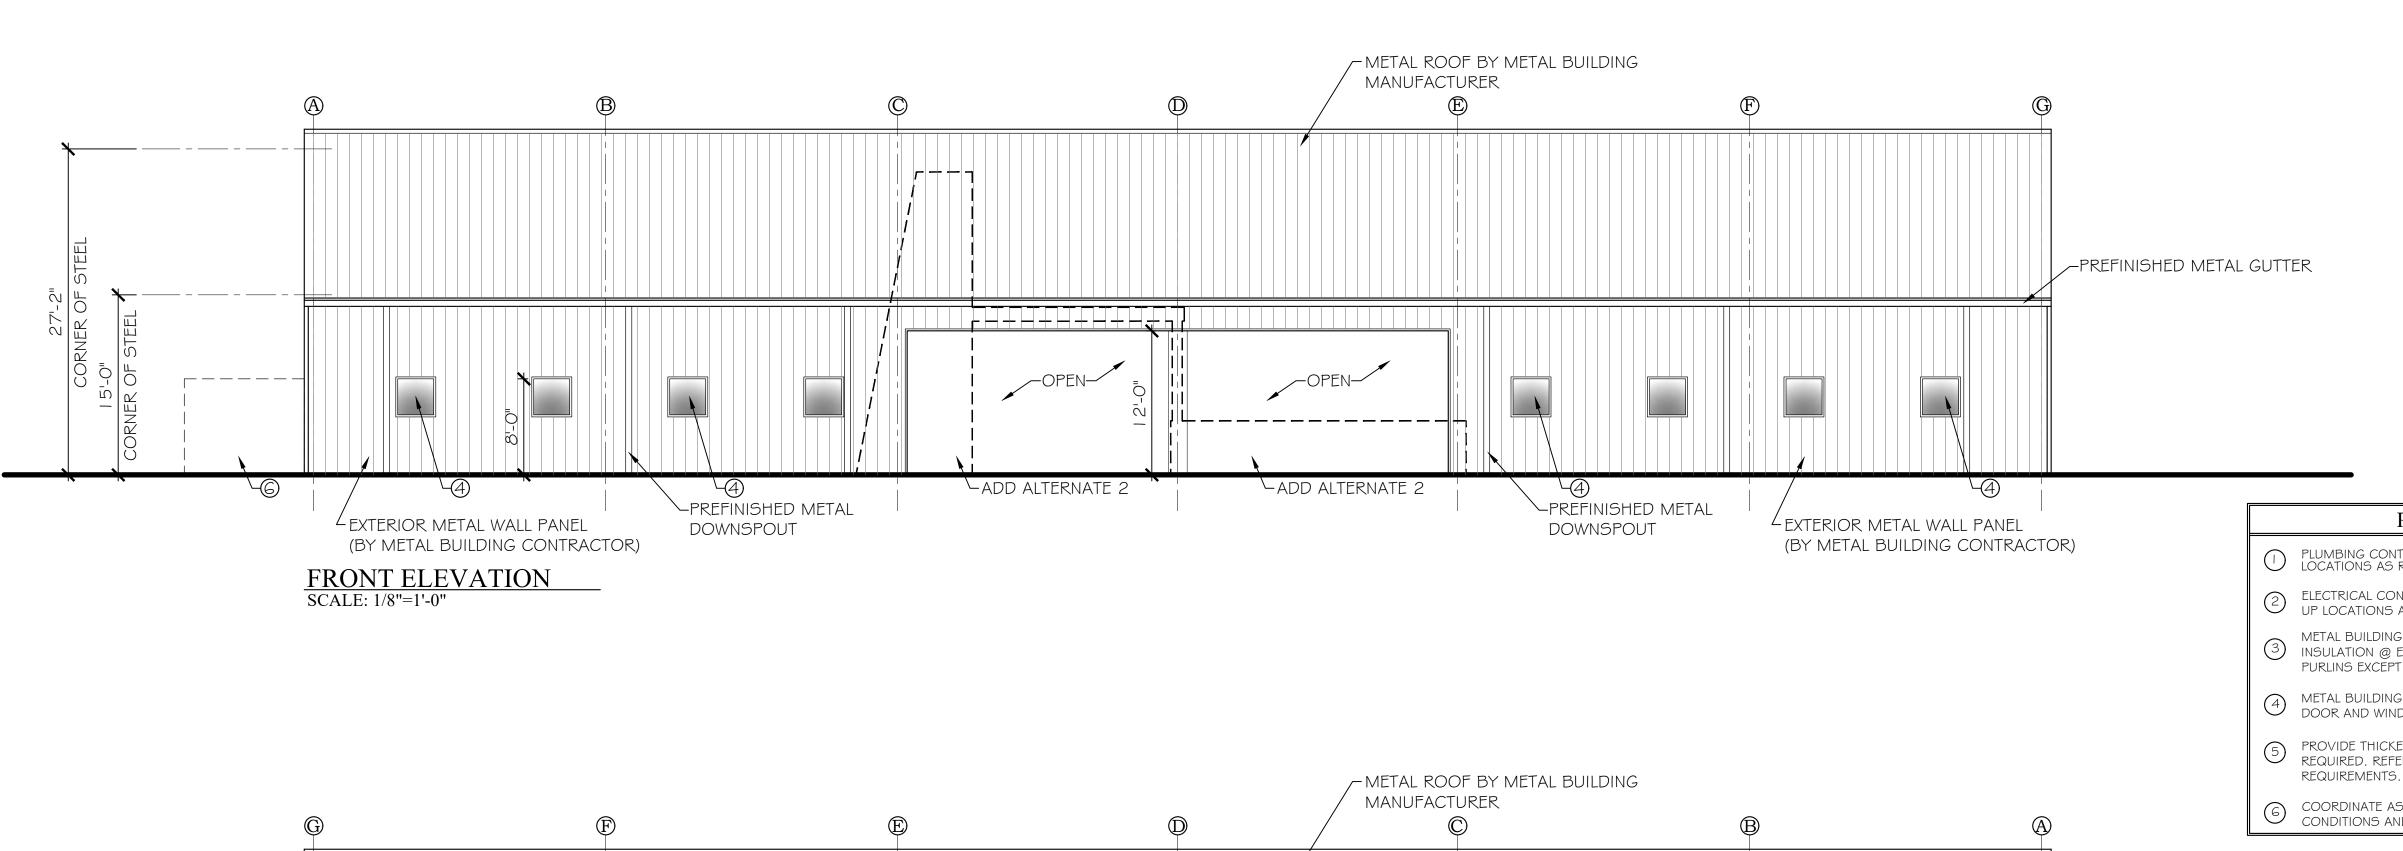



- PLUMBING CONTRACTOR WILL COORDINATE ALL STUB UP LOCATIONS AS REQUIRED.
- ELECTRICAL CONTRACTOR WILL COORDINATE ALL CONDUIT STUB UP LOCATIONS AS REQUIRED.
- METAL BUILDING CONTRACTOR WILL PROVIDE SIMPLE SAVER INSULATION @ ENTIRE PERIMETER PURLIN CAVITY AND ROOF PURLINS EXCEPT WHERE OMITTED AT BREEZEWAY AREA.
- METAL BUILDING CONTRACTOR SHALL VERIFY AND PROVIDE ALL DOOR AND WINDOW ROUGH OPENINGS AS REQUIRED.
- 5 PROVIDE THICKENED SLAB AT ALL LOAD BEARING WALLS AS REQUIRED. REFER TO STRUCTURAL FOUNDATION PLAN FOR REQUIREMENTS.
- 6 COORDINATE AS REQUIRED ALL PHASE I ADD ALT. AND PHASE II CONDITIONS AND PREP AS REQUIRED.

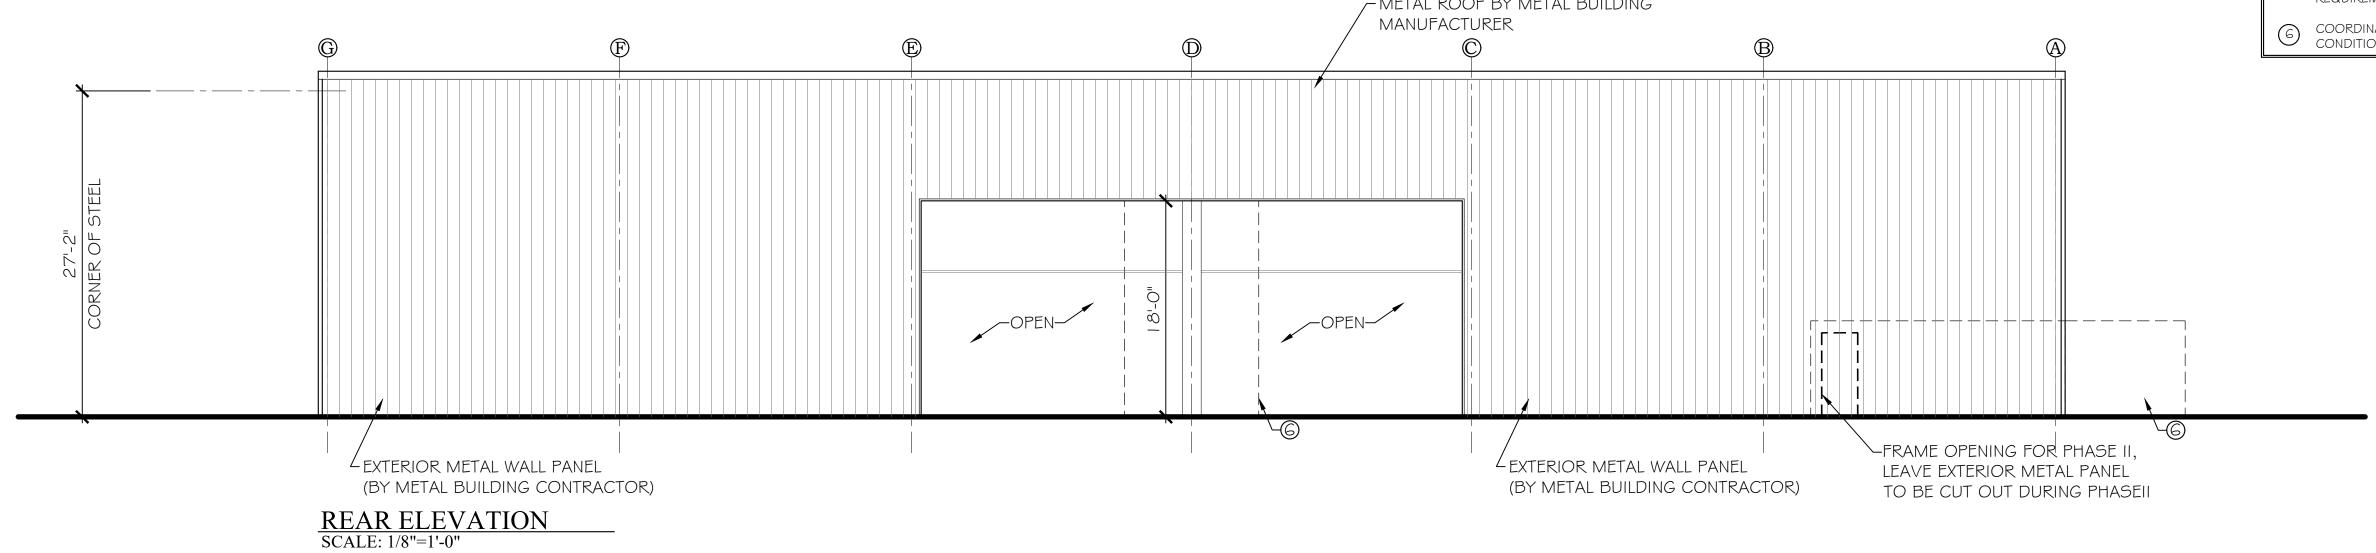

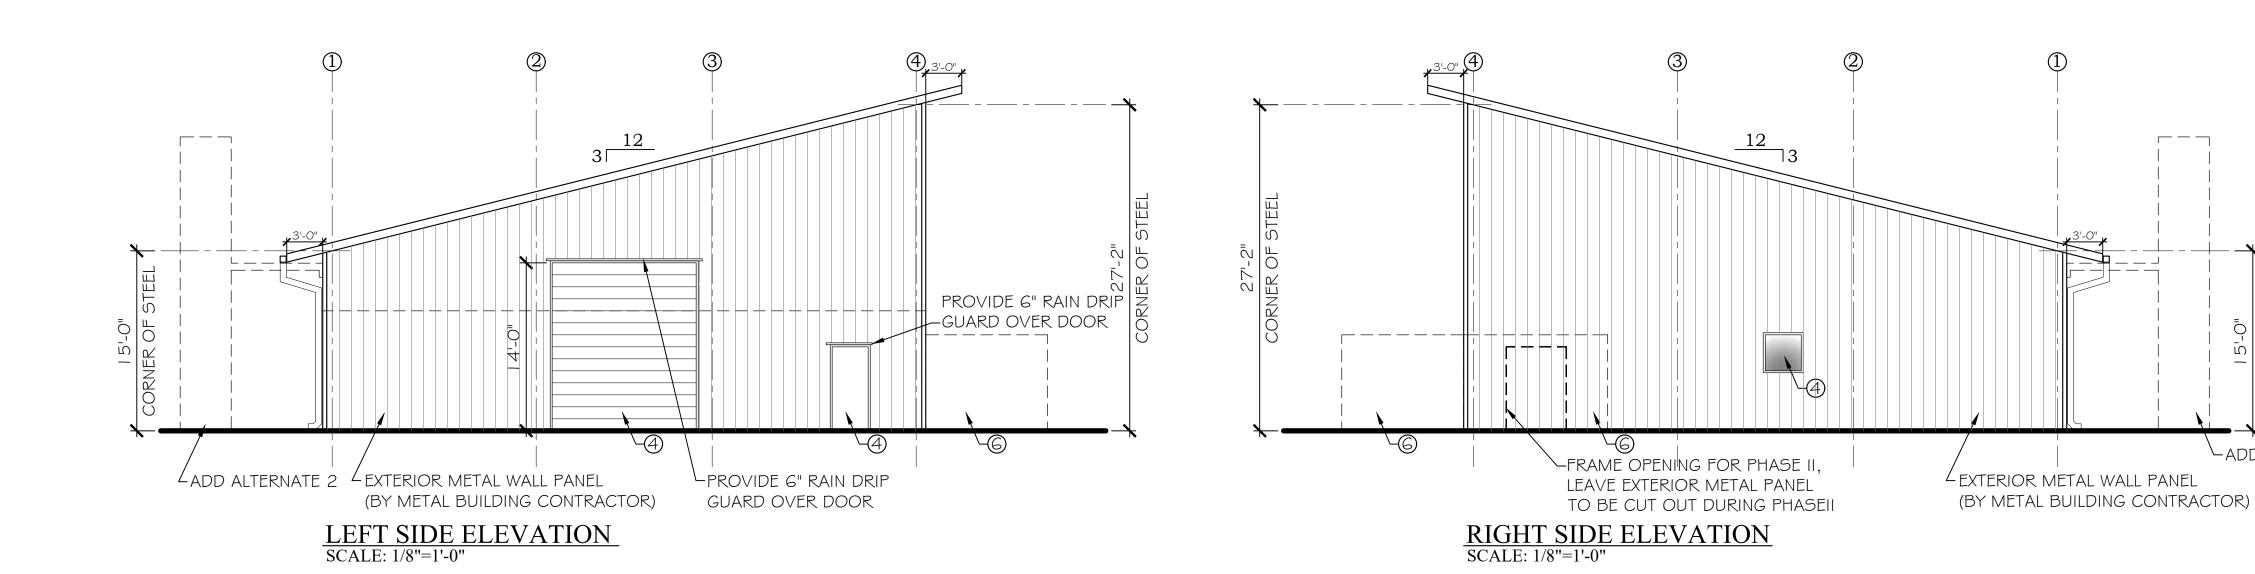

NTE 田 BE **PHASE**

McCollough Architecture, Inc.

P.O. BOX 6310 GULF SHORES, ALABAMA 36547-6310

PHONE: 251-968-7222

21-05 JOB NO.: DRAWN: CLT SBM CHECKED: 2021.06.01 DATE: REVISION:

1/8" = 1'-0" SCALE:

SHEET NO.:

PHASE I EXTERIOR ELEVATIONS

PHASE I

ADD ALTERNATE 2

PHASE I NOTES


METAL BUILDING CONTRACTOR WILL PROVIDE SIMPLE SAVER METAL BUILDING CONTRACTOR WILL PROVIDE SIMPLE SAVER INSULATION @ ENTIRE PERIMETER PURLIN CAVITY AND ROOF PURLINS EXCEPT WHERE OMITTED AT BREEZEWAY AREA.

METAL BUILDING CONTRACTOR SHALL VERIFY AND PROVIDE ALL DOOR AND WINDOW ROUGH OPENINGS AS REQUIRED.

PROVIDE THICKENED SLAB AT ALL LOAD BEARING WALLS AS REQUIRED. REFER TO STRUCTURAL FOUNDATION PLAN FOR

REQUIREMENTS.



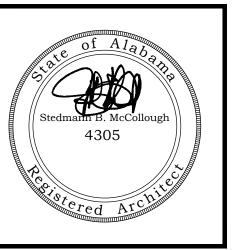

ENTE FOR ACH OLIF BE

NGE I WII DRA **PHASE**

JOB NO.: 21-05 CLT DRAWN: SBM CHECKED: 2021.06.01 DATE:


SHEET NO.:

SCALE:


REVISION:


PHASE I **BUILDING SECTIONS**

1/8" = 1'-0"

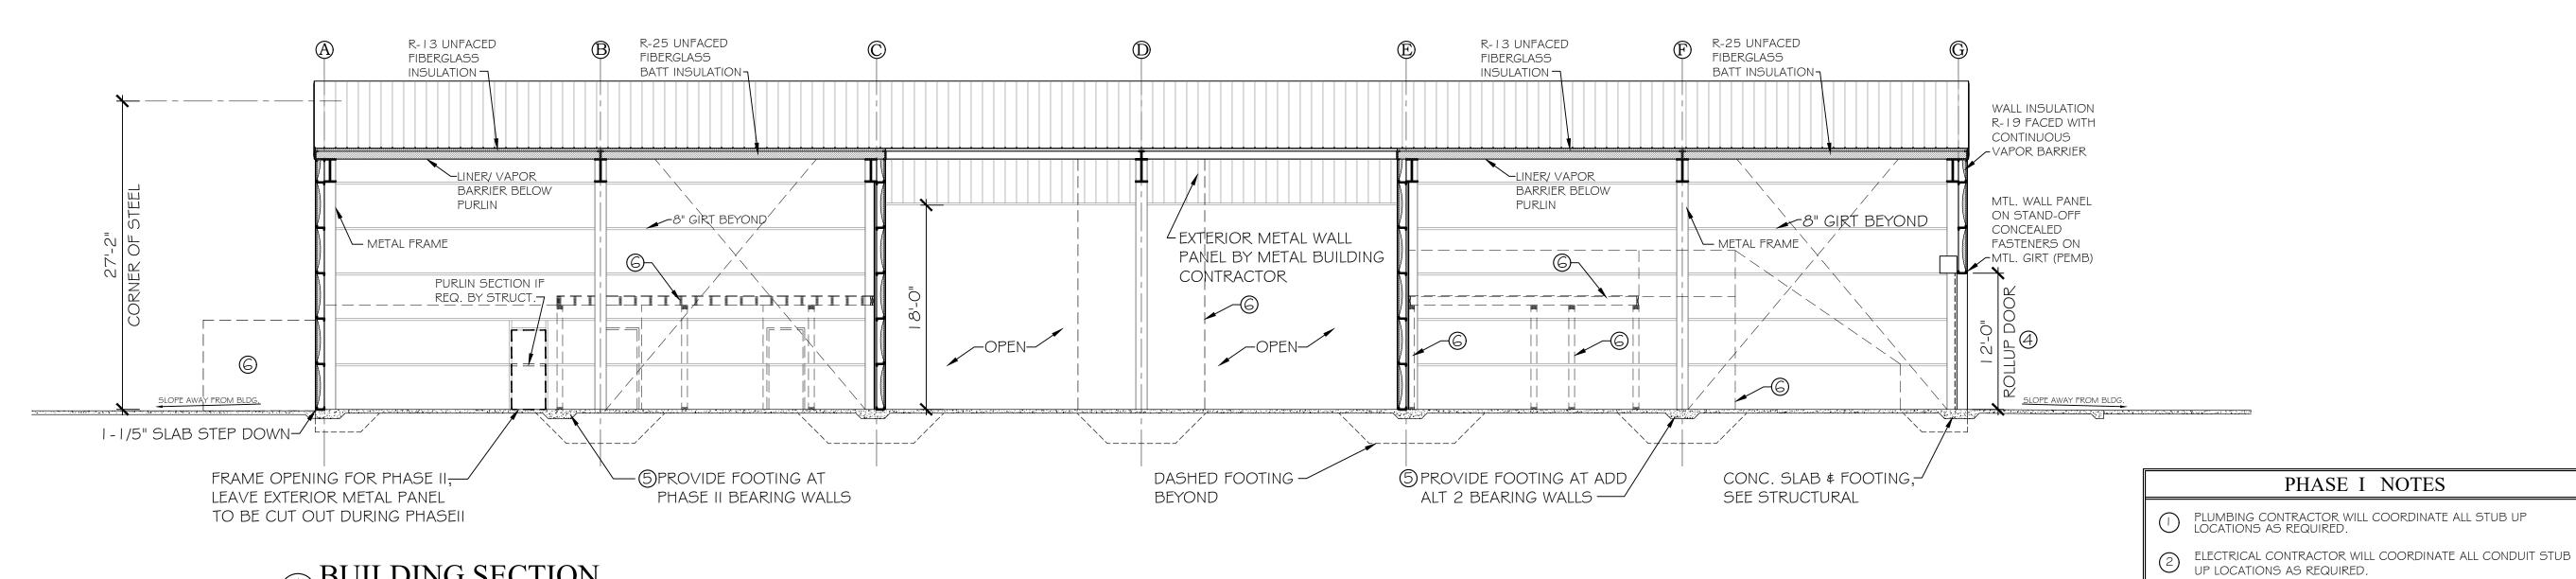


A BUILDING SECTION SCALE: 1/8"=1'-0"

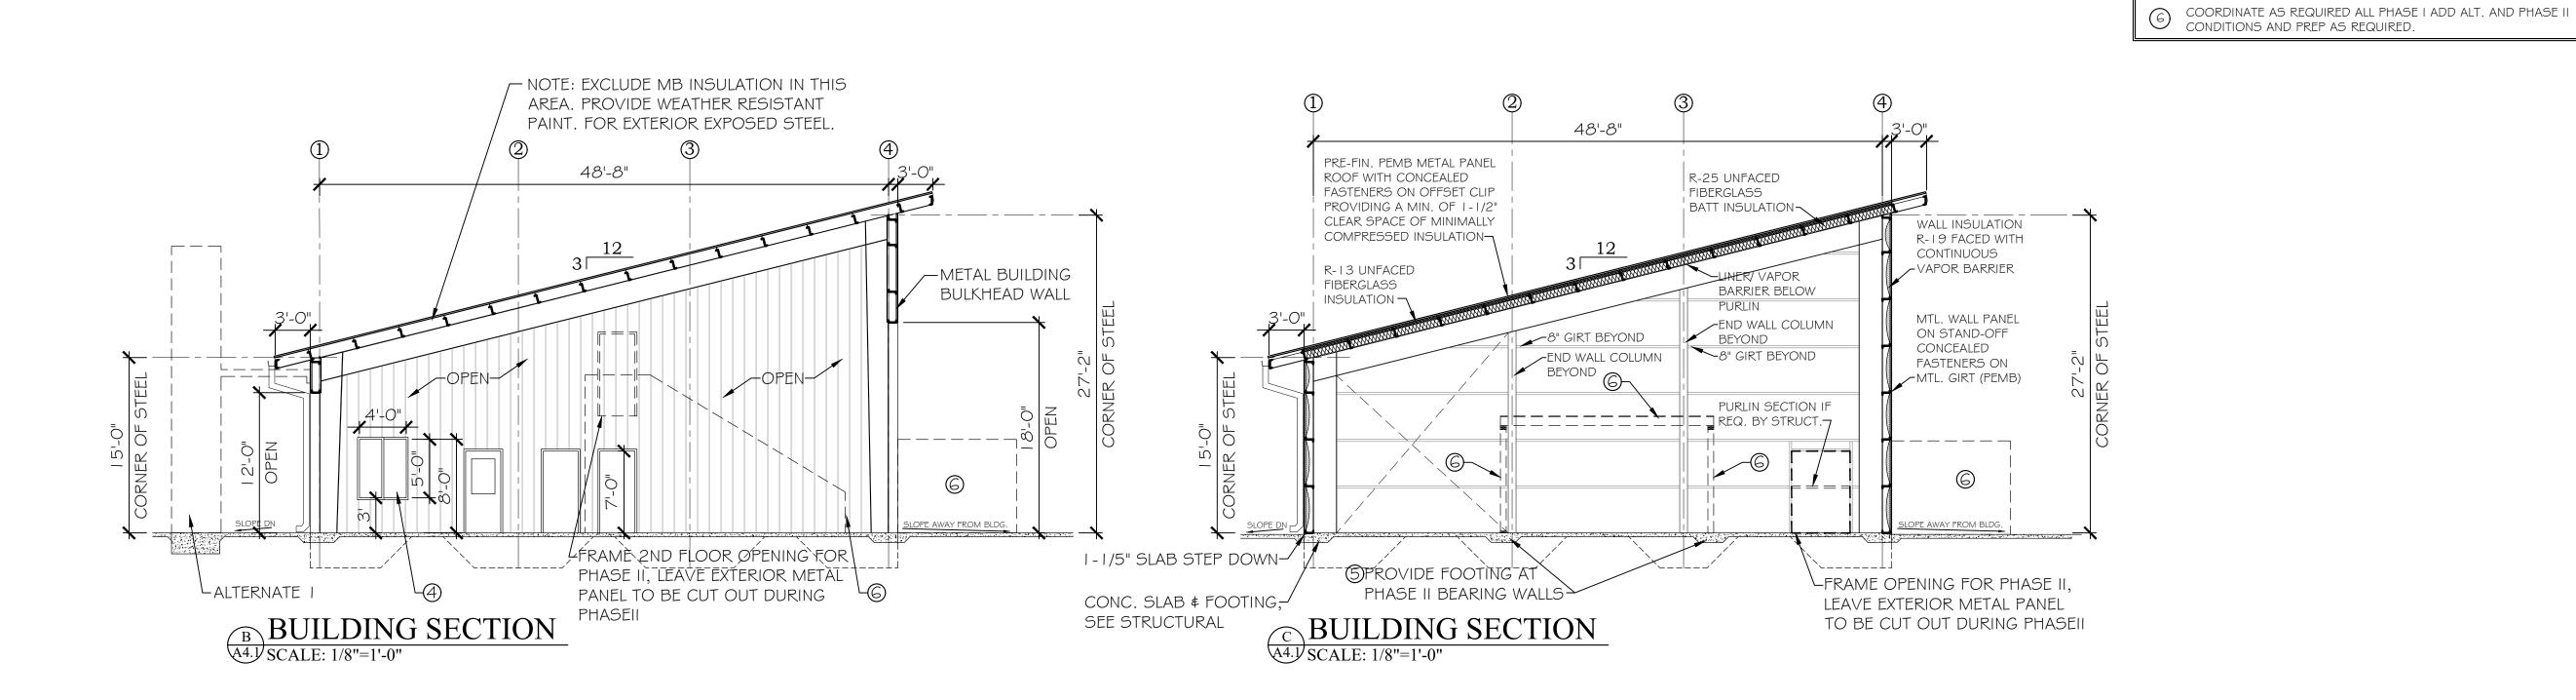

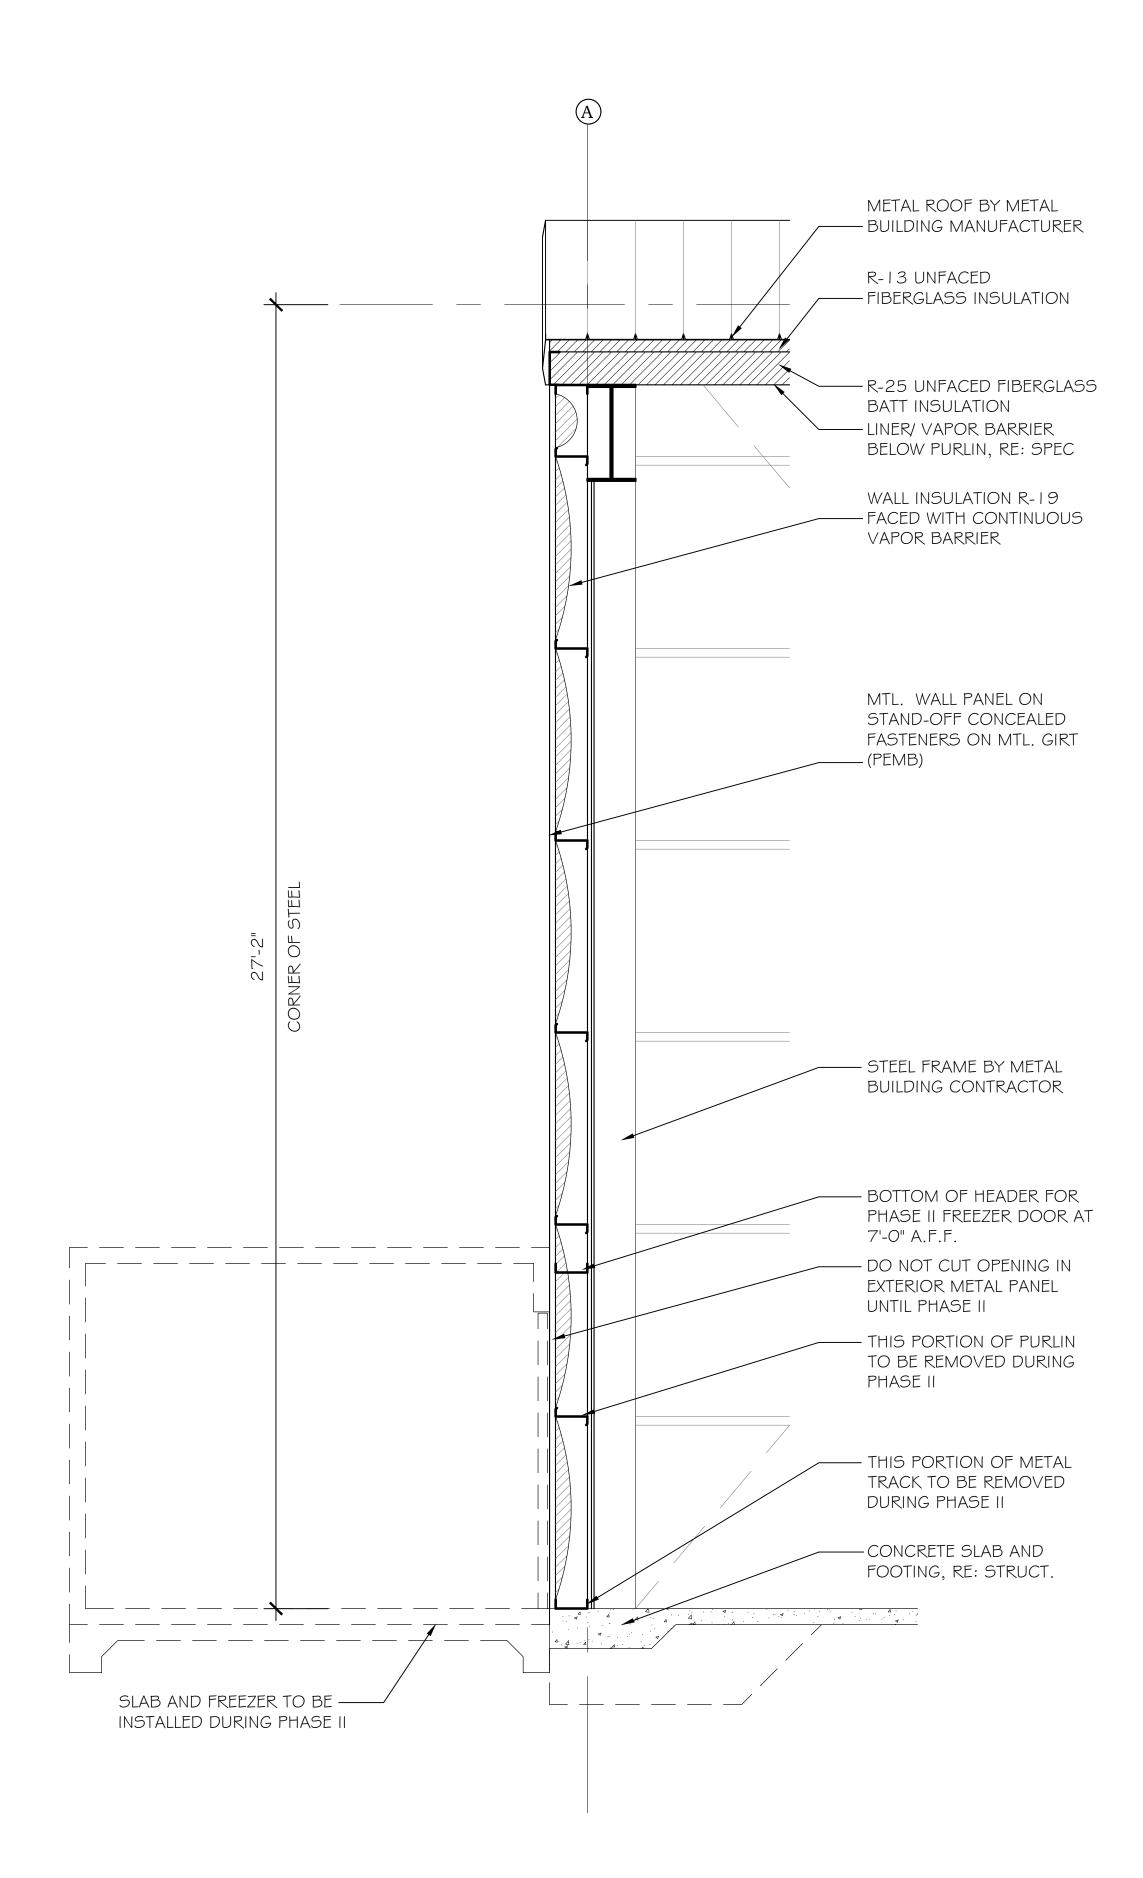





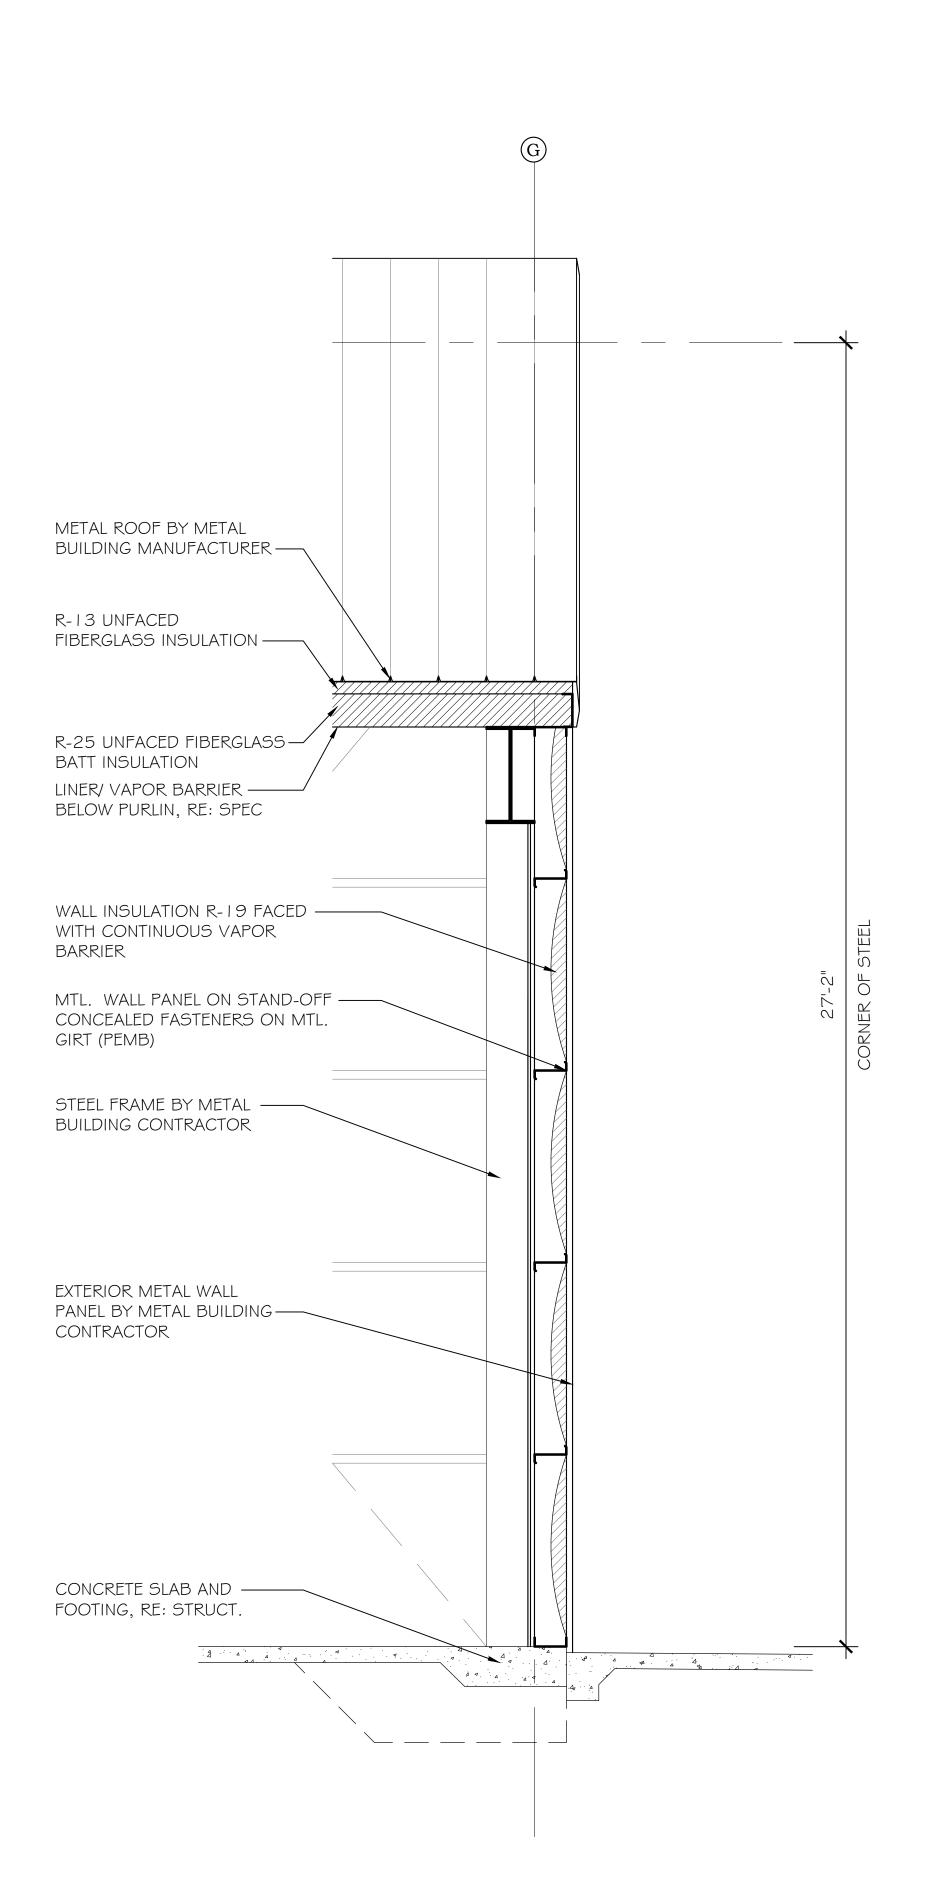

BUILDING SECTION

A4.2 SCALE 1/2"=1'-0"

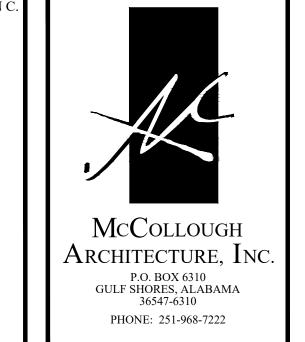

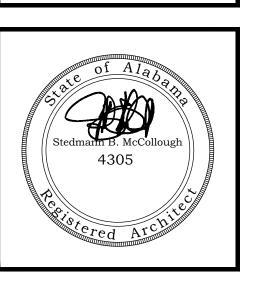

ORANGE BEACH TRAIL SHOP / WILDLIFE CENTE

JOB NO.: 21-05
DRAWN: CLT
CHECKED: SBM
DATE: 2021.06.01
REVISION:

SCALE:

SHEET NO.:


A4.2

1/2" = 1'-0"

SECTIONS AND DETAILS

PHASE I



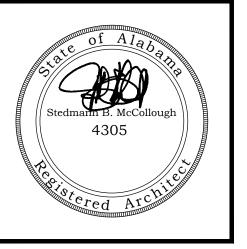

PHASE OR

SHOP

JOB NO.: DRAWN: CHECKED:

2021.06.01 DATE: REVISION:

21-05


CLT

SBM


1/8" = 1'-0"

SCALE: SHEET NO.:


ROOF PLAN PHASE I

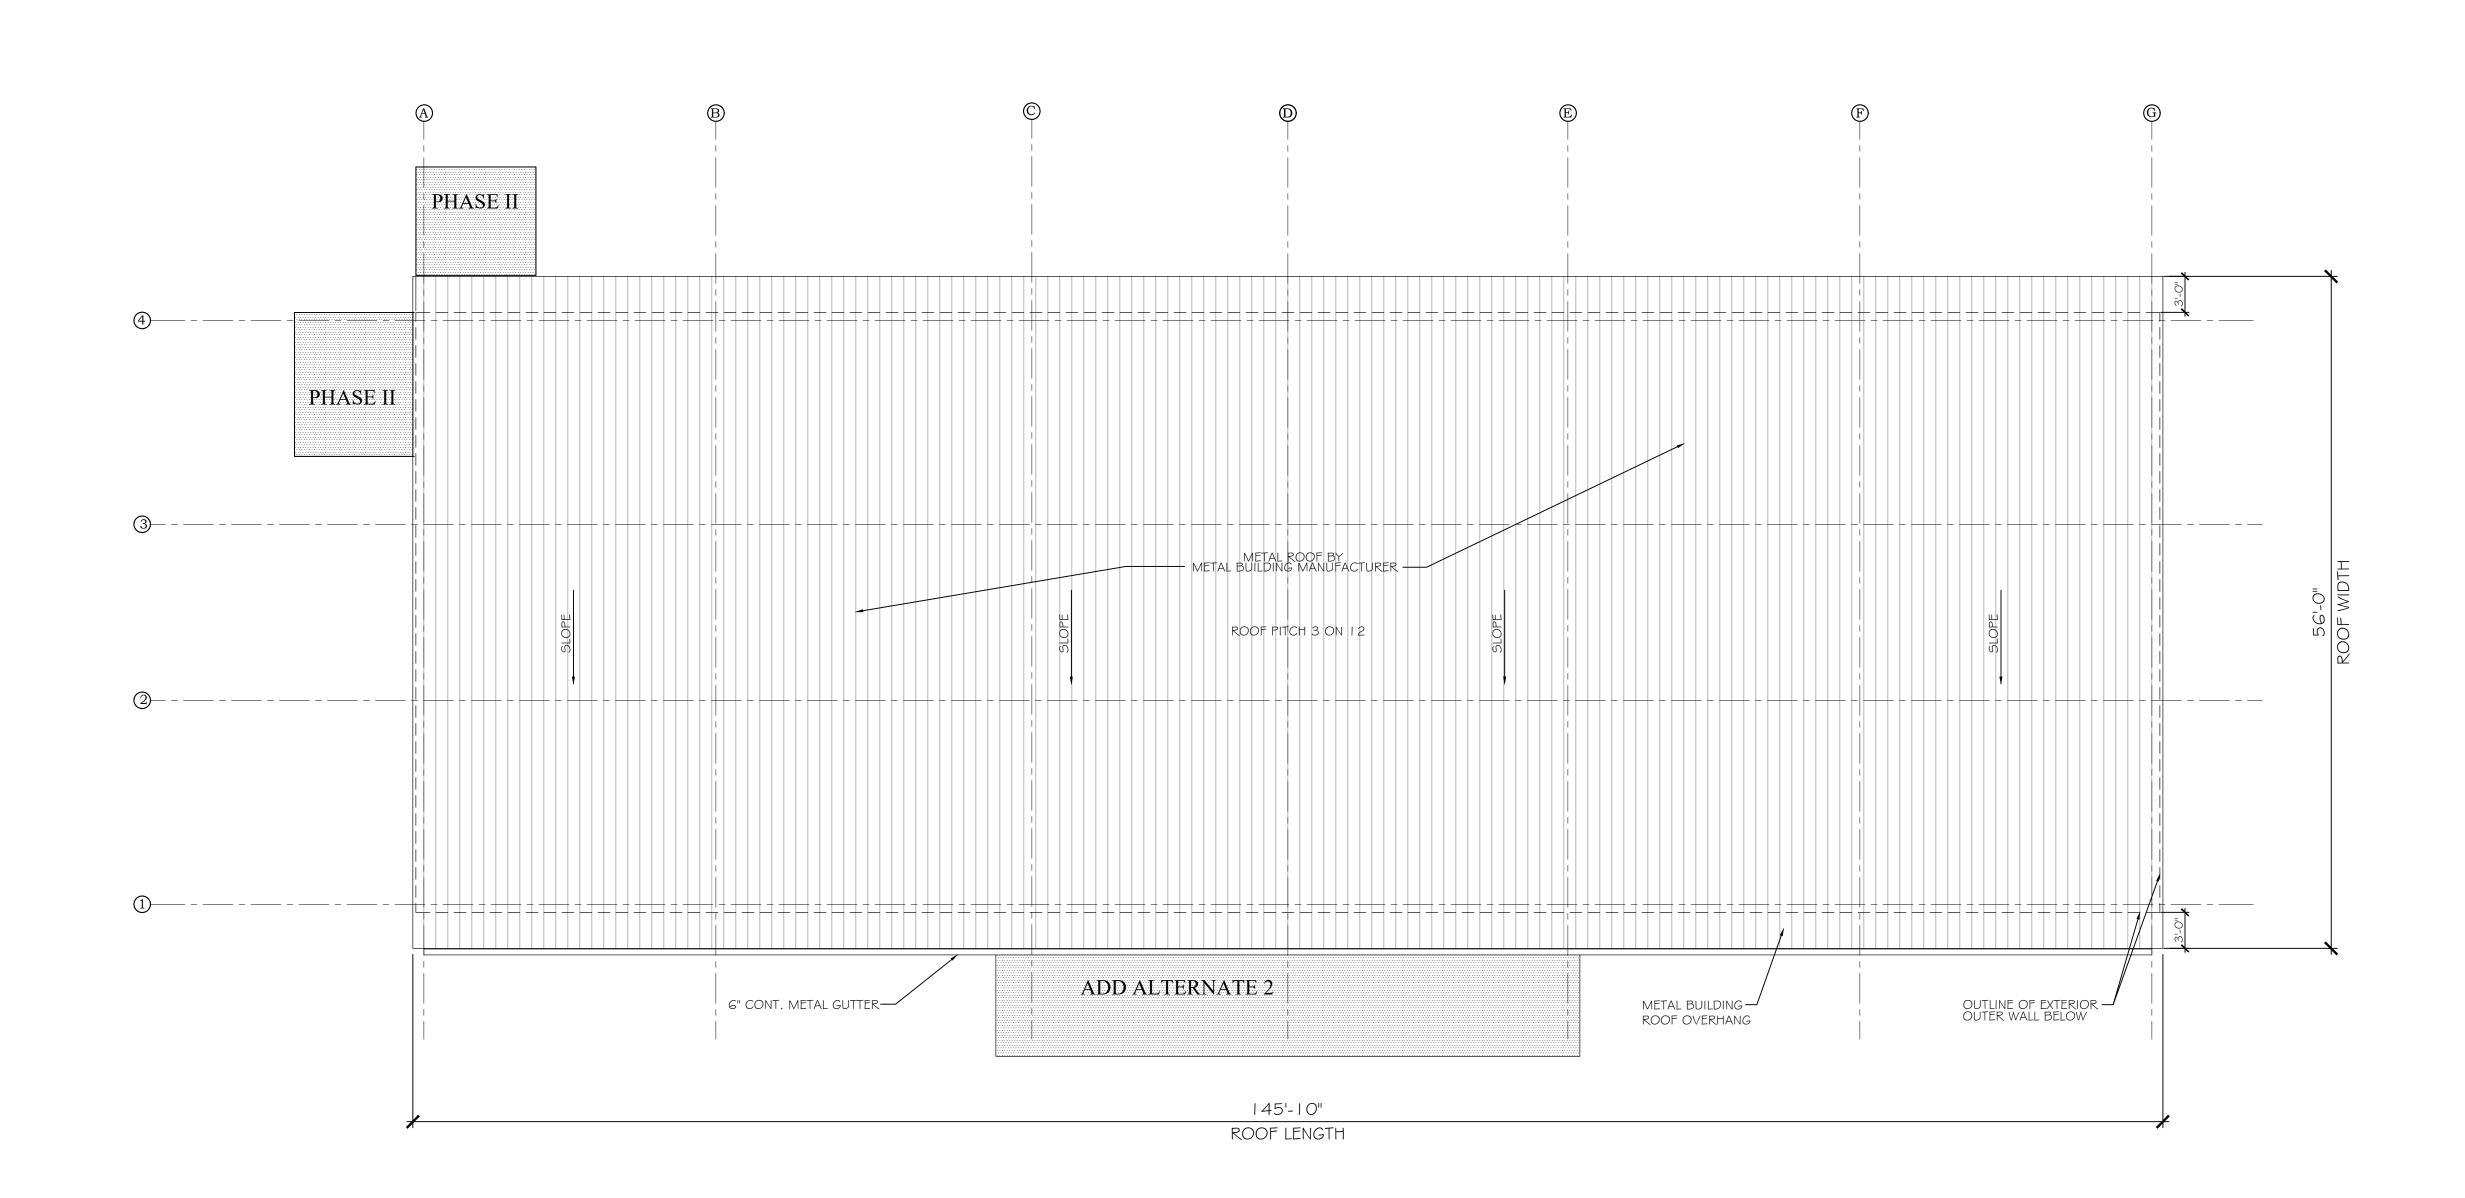


ROOF PLAN
SCALE: 1/16"=1'-0"

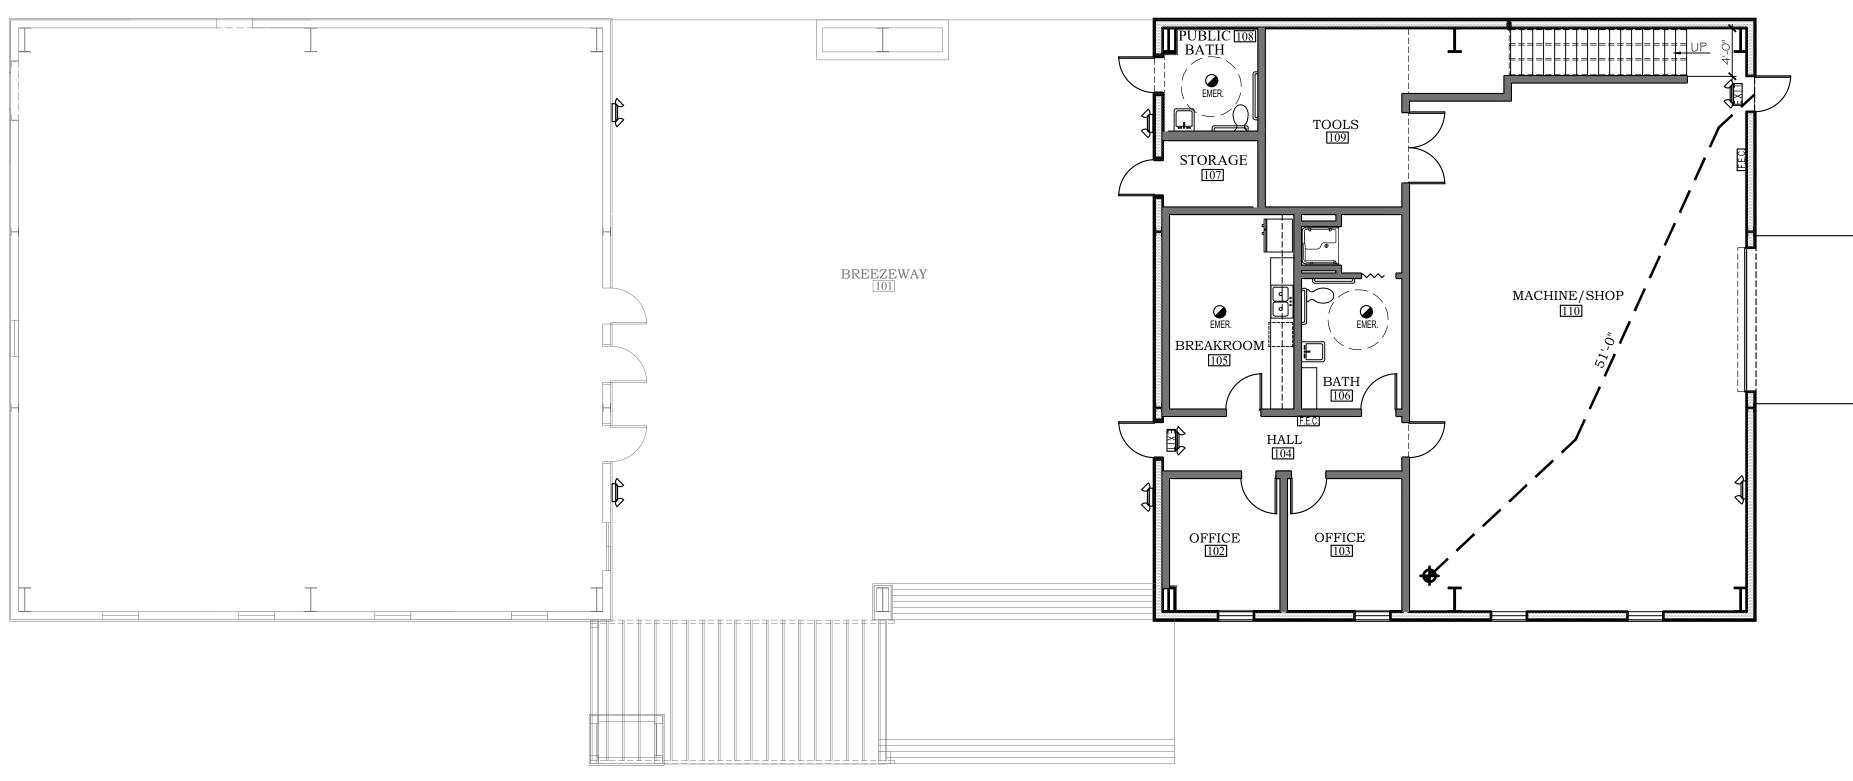


FIRST FLOOR PLAN SCALE: 1/8"=1'-0" FLOORED AREA: 2,368 S.F.

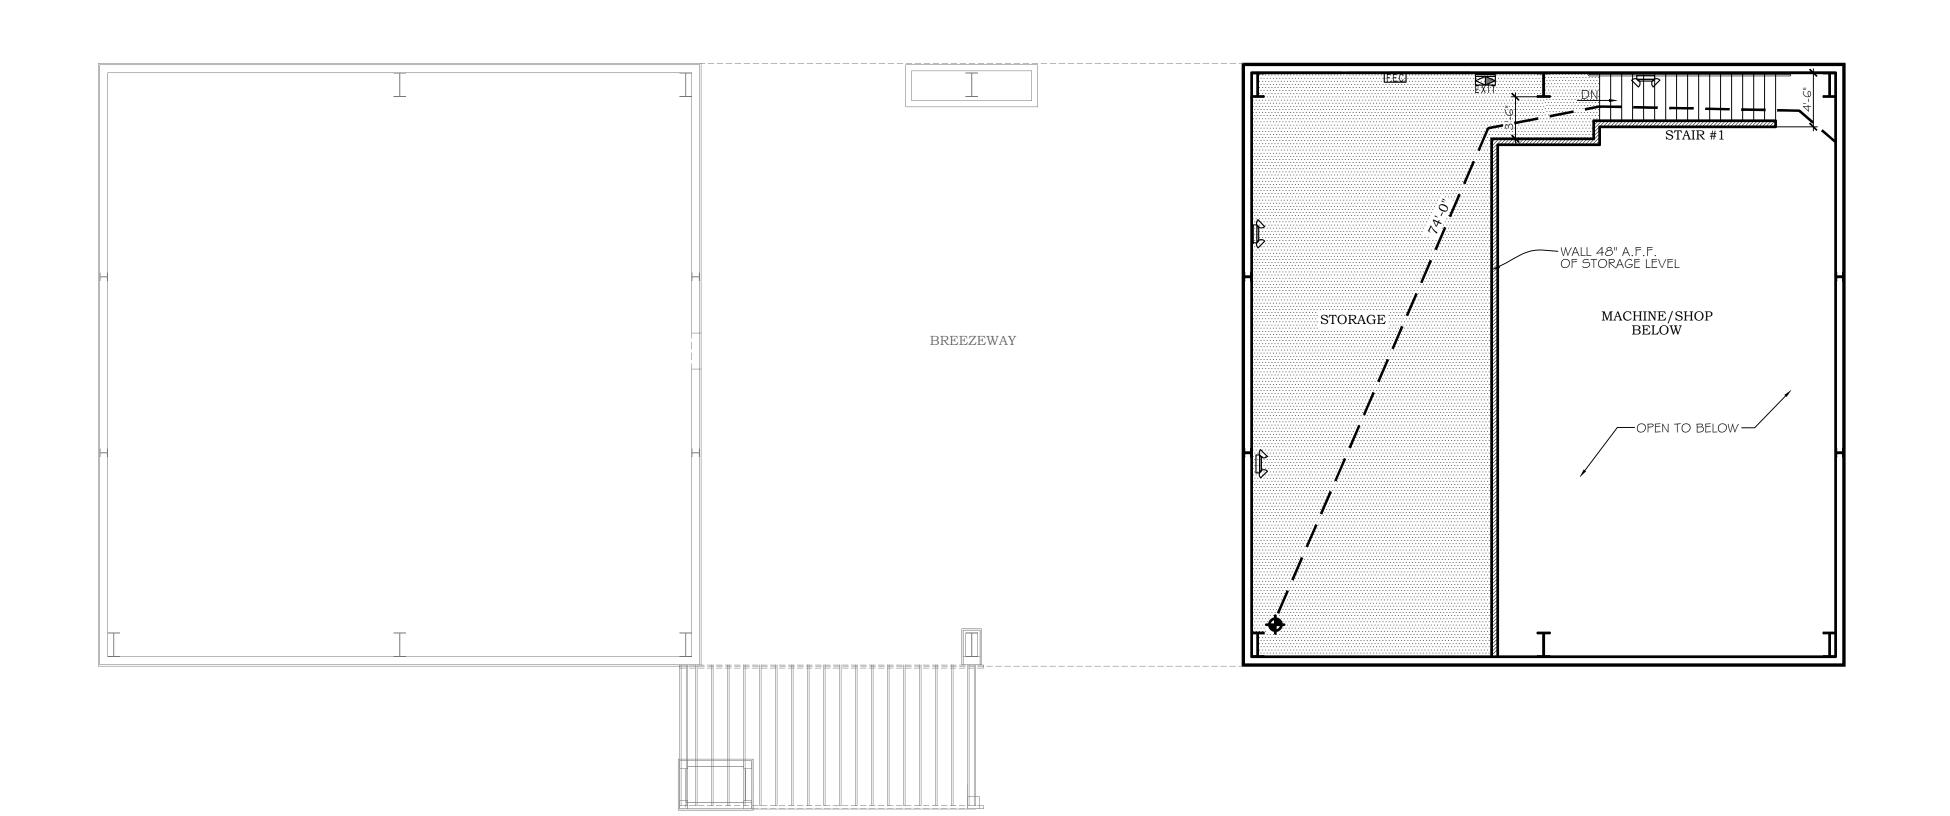

SECOND FLOOR PLAN SCALE: 1/8"=1'-0" FLOORED AREA: 1,022 S.F.

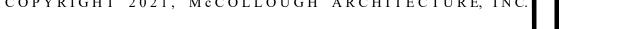



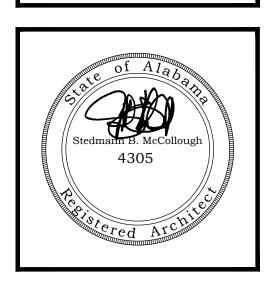

CENTER

BE

PHASE

GENERAL NOTES

ALL GREYED OUT ITEMS ARE PART OF BASE PHASE I OR ADD ALTERNATE 2, NOT THIS ADD ALTERNATE I ALL DOOR THRESHOLDS TO HAVE MAXIMUM $\frac{1}{2}$ " TRANSITION, RE: A I .O

	LEGEND
_ 47'-	— DISTANCE IN FEET EXIT TRAVEL DISTANCE
EXII	EXIT SIGN WITH EMERGENCY LIGHTING
EXIT	—HATCH INDICATES DIRECTION DIRECTIONAL ARROW EXIT SIGN
4	BATTERY PACK EMERGENCY LIGHTS
[F.E.C.]	FIRE EXTINGUISHER CABINET (SEMI-RECESSED)
	2ND FLOOR - FLOORED AREA (FOR CLARITY)

PROJECT SUMMARY

THIS PROJECT PROVIDES FOR A NEW BUILD OUT (APPROXIMATELY 3,390 SQUARE FEET UNDER ROOF) FOR ORANGE BEACH COASTAL RESOURCES TRAIL SHOP. THE TRAIL SHOP PROVIDES FOR A SHOP AREA; ADMINISTRATION; AND RELATED SUPPORT SPACES.

THE OVERALL STRUCTURE IS A PRE-ENGINEERED METAL BUILDING STRUCTURE
BUILT DURING BASE PHASE I. THIS ADD ALTERNATE I BUILD OUT INCLUDES
WOOD-FRAMED INTERIOR WALL CONSTRUCTION.

APPLICABLE BUILDING CODES

-2018 INTERNATIONAL BUILDING CODE -2018 INTERNATIONAL PLUMBING CODE -2018 INTERNATIONAL MECHANICAL CODE -2018 INTERNATIONAL FIRE CODE -2017 NATIONAL ELECTRICAL CODE -AMERICANS WITH DISABILITIES ACT (ADA)

CONSTRUCTION TYPE	IIB, UNSPRINKLERED
OCCUPANCY PHASE I-S1 (MAINTENANCE SHOP) - 3,390 @100 S.F./PERSON= PHASE I-BUSINESS (BREEZEWAY)-2,265 @150 S.F/PERSON= 1 PHASE II-BUSINESS (WILDLIFE CENTER)-2,882 @150 S.F/PERS	6 PEOPLE
OCCUPANT LOAD	70 PEOPLE
TOTAL AREA UNDER ROOF	8,852 S.F.
FIRE RATED WALLS	NONE ²
REQUIRED EXIT TRAVEL DISTANCE	<200'
REQUIRED FIRE EXTINGUISHER/PROVIDED	3,000 S.F/75FT. TRAVEL

PROJECT CODE DATA

¹ UNSEPARATED MIXED OCCUPANCY (B) BUSINESS; (S1) STORAGE ² CORRIDOR FOR WILDLIFE CENTER SERVES LESS THAN 30 PEOPLE (NO RATING)

JOB NO.: 21-05 DRAWN: CLT SBM CHECKED: 2021.06.01 DATE: REVISION:

SCALE: 1/8" = 1'-0"

SHEET NO.:


LIFE SAFETY PLAN

PHASE I ADD ALTERNATE 1

SECOND FLOOR PLAN

SCALE: 1/8"=1'-0"



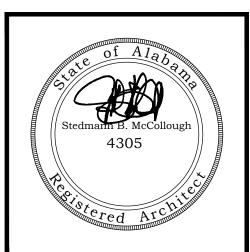

PHASE I DRAWINGS FOR ORANGE BEACH [L SHOP / WILDLIFE CENTEF

JOB NO.: 21-05
DRAWN: CLT
CHECKED: SBM
DATE: 2021.06.01
REVISION:

SCALE: 1/8" = 1'-0"

SHEET NO.:

ALT 1

A1.1

FLOOR PLANS


PHASE I ADD ALTERNATE 1


DOOR NO.	DOOR SIZE	DOOR	DOOR	DOOR	DOOR FINISH	FRAME	FRAME FINISH	RATING	PANIC HDWE	DOOR CLOSURE	REMARKS
IA	3'-0" X 7'-0"	F	WOOD	EXTERIOR	STAIN	WOOD	STAIN		T _		INSTALLED DURING A LATER PHASE
)2A	3'-0" X 7'-0"	С	WOOD	INTERIOR	PAINT	METAL	PAINT	_	 -	 -	INSTALLED DURING A LATER THASE
)3A	3'-0" X 7'-0"	С	WOOD	INTERIOR	PAINT	METAL	PAINT	-	+	+-	
)4A	3'-0" X 7'-0"	G	METAL	EXTERIOR	PAINT	METAL	PAINT	-	+-	+-	INSTALLED DURING BASE PHASE I
)48)4B	3'-0" X 7'-0"	В	METAL	INTERIOR	PAINT	METAL	PAINT	-	 -	+-	INSTALLED DURING DAJETHAJET
		С	WOOD		PAINT	METAL	PAINT	-	+-	+-	
)5A	3'-0" X 7'-0"	ł	WOOD	INTERIOR		+	PAINT	 -	+	+-	CLOSED BY DOOD MANIE
D6A	3'-0" X 7'-0"	С		INTERIOR	PAINT	METAL		 -	 -	+-	** CLOSER BY DOOR MANF. INSTALLED DURING BASE PHASE I
07A	3'-0" X 7'-0"	В	METAL	EXTERIOR	PAINT	METAL	PAINT	-	-	-	
08A	3'-0" X 7'-0"	В	METAL	EXTERIOR	PAINT	METAL	PAINT	-	-	-	INSTALLED DURING BASE PHASE I
09A	PR 3'-0" X 7'-0"	D	METAL	INTERIOR	PAINT	METAL	PAINT	-	-	-	INICTALLED DUDING DACE DUACE I
IOA	12'-0"X 14'-0"	E	METAL	EXTERIOR	- DAINIT	- -	- DAINIT	-	-	-	INSTALLED DURING BASE PHASE I
IOB	3'-0" X 7'-0"	В	METAL	EXTERIOR	PAINT	METAL	PAINT	-	-	-	INSTALLED DURING BASE PHASE I
IIA	3'-0" X 7'-0"	С	WOOD	INTERIOR	PAINT	METAL	PAINT	-	-	-	INSTALLED DURING A LATER PHASE
12A	3'-0" X 7'-0"	С	WOOD	INTERIOR	PAINT	METAL	PAINT	-	-	-	INSTALLED DURING A LATER PHASE
13A	3'-0" X 7'-0"	С	WOOD	INTERIOR	PAINT	METAL	PAINT	-	-	-	INSTALLED DURING A LATER PHASE
14A	3'-0" X 7'-0"	С	WOOD	INTERIOR	PAINT	METAL	PAINT	-	-	-	INSTALLED DURING A LATER PHASE
15A	3'-0" X 7'-0"	С	WOOD	INTERIOR	PAINT	METAL	PAINT	-	-	-	INSTALLED DURING A LATER PHASE
16A	3'-0" X 7'-0"	С	WOOD	INTERIOR	PAINT	METAL	PAINT	-	-	-	INSTALLED DURING A LATER PHASE
18A	PR 1'-6" X 7'-0"	Α	WD. W/ LAM.		_	METAL	1	-	-	-	INSTALLED DURING A LATER PHASE
19A	3'-0" X 7'-0"	G	METAL	EXTERIOR	PAINT	METAL	PAINT	-	-	-	INSTALLED DURING BASE PHASE I
19B	3'-0" X 7'-0"	В	METAL	EXTERIOR	PAINT	METAL	PAINT	-	-	-	INSTALLED DURING BASE PHASE I
20A	3'-0" X 7'-0"	В	METAL	EXTERIOR	PAINT	METAL	PAINT	-	-	-	INSTALLED DURING BASE PHASE I
20B	3'-0" X 7'-0"	С	WOOD	INTERIOR	PAINT	METAL	PAINT	-	-	-	INSTALLED DURING A LATER PHASE
21A	3'-0" X 7'-0"	В	METAL	EXTERIOR	PAINT	METAL	PAINT	-	-	-	INSTALLED DURING BASE PHASE I
22A	3'-0" X 7'-0"	С	WOOD	INTERIOR	PAINT	METAL	PAINT	-	-	-	INSTALLED DURING A LATER PHASE
23A	3'-0" X 7'-0"	С	WOOD	INTERIOR	PAINT	METAL	PAINT	-	-	-	INSTALLED DURING A LATER PHASE
24A	3'-0" X 7'-0"	С	WOOD	INTERIOR	PAINT	METAL	PAINT	-	-	-	INSTALLED DURING A LATER PHASE
25A	3'-0" X 7'-0"	С	WOOD	INTERIOR	PAINT	METAL	PAINT	-	-	-	INSTALLED DURING A LATER PHASE
26A	3'-0" X 7'-0"	С	WOOD	INTERIOR	PAINT	METAL	PAINT	-	-	-	INSTALLED DURING A LATER PHASE
27A	3'-0" X 7'-0"	С	WOOD	INTERIOR	PAINT	METAL	PAINT	-	-	-	INSTALLED DURING A LATER PHASE
28A	PR 1'-6" X 7'-0"	А	WD. W/ LAM.	INTERIOR	-	METAL	PAINT	-	-	-	INSTALLED DURING A LATER PHASE
28B	PR 1'-6" X 7'-0"	А	WD. W/ LAM.	INTERIOR	-	METAL	PAINT	-	-	-	INSTALLED DURING A LATER PHASE
29A	3'-0" X 7'-0"	С	WOOD	INTERIOR	PAINT	METAL	PAINT		_	_	INSTALLED DURING A LATER PHASE
30A	3'-0" X 7'-0"	С	WOOD	INTERIOR	PAINT	METAL	PAINT	-	-	-	INSTALLED DURING A LATER PHASE
											WOTALLED DUDING A LITTLE TO THE
)2A	3'-0" X 7'-0"	В	METAL	EXTERIOR	PAINT	METAL	PAINT	-	-	-	INSTALLED DURING A LATER PHASE
										1	

DOOM NAME		FLOOR	WALLS		CEILING		REMARKS
ROOM NAME	-		WALLS		CEILING		
	FLOORS	BASE	MATERIALS	FINISH	MATERIAL	FINISH	
OI BREEZEWAY	SEALED CONCRETE	EXPOSED METAL BUILDING	METAL PANEL SIDING	-	EXPOSED METAL BUILDING	EXPOSED METAL BUILDING	COMPLETED DURING BASE PHASE I
02 OFFICE	VCT	6" VINYL	GYP. BD	PAINT	GYP. BD.	_	1
03 OFFICE	VCT	6" VINYL	GYP. BD	PAINT	GYP. BD.	_	1
O4 HALL	VCT	6" VINYL	GYP. BD	PAINT	GYP. BD.	_	1
05 BREAKROOM	VCT	6" VINYL	GYP. BD	PAINT	GYP. BD.	_	1
O6 BATH	VCT	6" VINYL	MOISTURE RESISTANT GYP. BD	PAINT	GYP. BD.	_	1
07 STORAGE	VCT	6" VINYL	GYP. BD	PAINT	GYP. BD.	_	
108 BATH	VCT	6" VINYL	MOISTURE RESISTANT GYP. BD	PAINT	GYP. BD.	_	
109 TOOLS	SEALED CONCRETE	EXPOSED METAL BUILDING	EXPOSED FRAMING / METAL BUILDING	EXPOSED METAL BUILDING	GYP. BD.	-	
10 SHOP	SEALED CONCRETE	EXPOSED METAL BUILDING	PLYWOOD AT MEZZ. WALL / METAL BUILDING	EXPOSED METAL BUILDING	EXPOSED METAL BUILDING	-	†
I I OFFICE	VCT	6" VINYL	GYP. BD	PAINT	LAY IN CEILING	_	COMPLETED DURING A LATER PHASE
12 OFFICE	VCT	6" VINYL	GYP. BD	PAINT	LAY IN CEILING	_	COMPLETED DURING A LATER PHASE
13 INTERN	VCT	6" VINYL	GYP. BD	PAINT	LAY IN CEILING	_	COMPLETED DURING A LATER PHASE
14 ELECTRICAL	SEALED CONCRETE	6" VINYL	GYP. BD	PAINT	LAY IN CEILING	_	COMPLETED DURING A LATER PHASE
15 REHAB #2	VCT	6" VINYL	MOISTURE RESISTANT GYP. BD	FRP	LAY IN CEILING	_	COMPLETED DURING A LATER PHASE
IG REHAB #I	VCT	6" VINYL	MOISTURE RESISTANT GYP. BD	FRP	LAY IN CEILING	_	COMPLETED DURING A LATER PHASE
17 STORAGE	VCT	6" VINYL	GYP. BD	PAINT	LAY IN CEILING	_	COMPLETED DURING A LATER PHASE
18 KITCHEN / PREP.	VCT	6" VINYL	MOISTURE RESISTANT GYP. BD	FRP	* LAY IN CEILING	_	COMPLETED DURING A LATER PHASE
19 CORRIDOR	VCT	6" VINYL	GYP. BD	PAINT	LAY IN CEILING	_	COMPLETED DURING A LATER PHASE
20 ISOLATION	VCT	6" VINYL	MOISTURE RESISTANT GYP. BD	FRP	GYP. BD.	PAINT	COMPLETED DURING A LATER PHASE
21 STORAGE	VCT	6" VINYL	GYP. BD	PAINT	GYP. BD.	PAINT	COMPLETED DURING A LATER PHASE
22 TRIAGE	VCT	6" VINYL	MOISTURE RESISTANT GYP. BD	FRP	GYP. BD.	PAINT	COMPLETED DURING A LATER PHASE
23 REHAB #3	VCT	6" VINYL	MOISTURE RESISTANT GYP. BD	FRP	GYP. BD.	PAINT	COMPLETED DURING A LATER PHASE
24 EMPLOYEE BATH	VCT	6" VINYL	GYP. BD	PAINT	GYP. BD.	PAINT	COMPLETED DURING A LATER PHASE
25 JANITOR	SEALED CONCRETE	6" VINYL	MOISTURE RESISTANT GYP. BD	FRP	GYP. BD.	PAINT	COMPLETED DURING A LATER PHASE
26 STORAGE	VCT	6" VINYL	GYP. BD	PAINT	GYP. BD.	PAINT	COMPLETED DURING A LATER PHASE
27 STORAGE	VCT	6" VINYL	GYP. BD	PAINT	GYP. BD.	PAINT	COMPLETED DURING A LATER PHASE
28 TREATMENT	VCT	6" VINYL	MOISTURE RESISTANT GYP. BD	FRP	LAY IN CEILING	_	COMPLETED DURING A LATER PHASE
29 EXAM	VCT	6" VINYL	MOISTURE RESISTANT GYP. BD	FRP	LAY IN CEILING	_	COMPLETED DURING A LATER PHASE
30 LAUNDRY	VCT	6" VINYL	MOISTURE RESISTANT GYP. BD	FRP	LAY IN CEILING	-	COMPLETED DURING A LATER PHASE
201 0700405	5,70055 50,44005						
201 STORAGE	EXPOSED PLYWOOD	EXPOSED METAL BUILDING	EXPOSED FRAMING / METAL BUILDING				
202 STORAGE	EXPOSED PLYWOOD	EXPOSED METAL BUILDING	EXPOSED FRAMING / METAL BUILDING				COMPLETED DURING A LATER PHASE

NOTES: * ALL FRP PANELS INSTALLED TO 9'-0" A,F,F,

VCT - | 2"X | 2" | /8" STANDARD VINYL COMPOSITION TILE

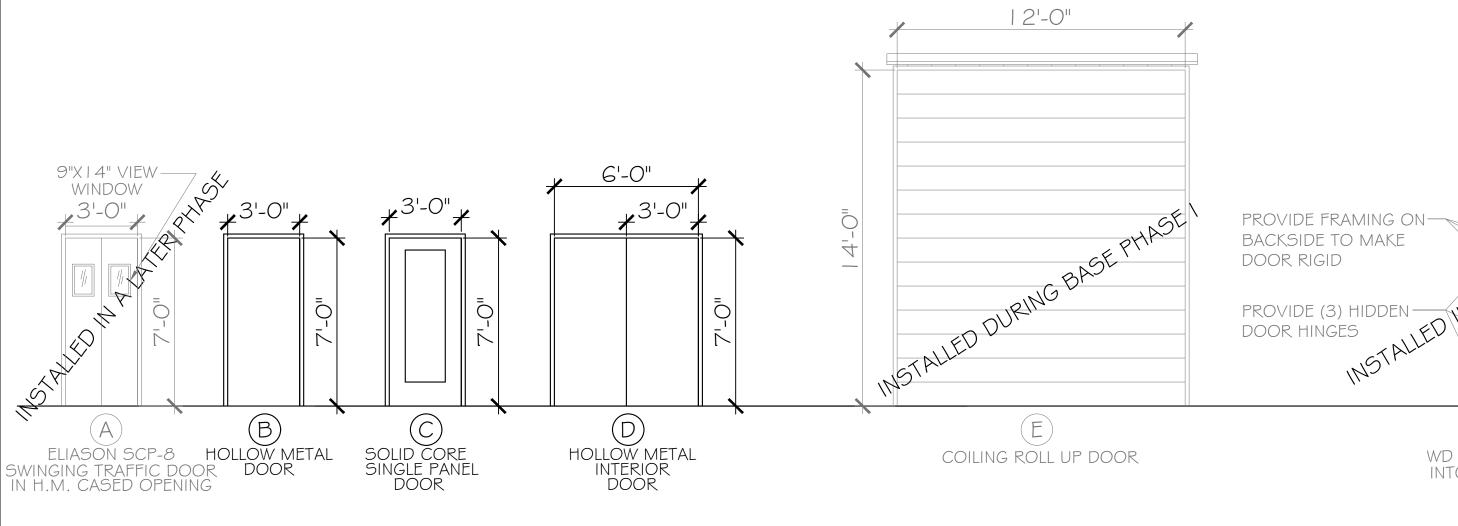

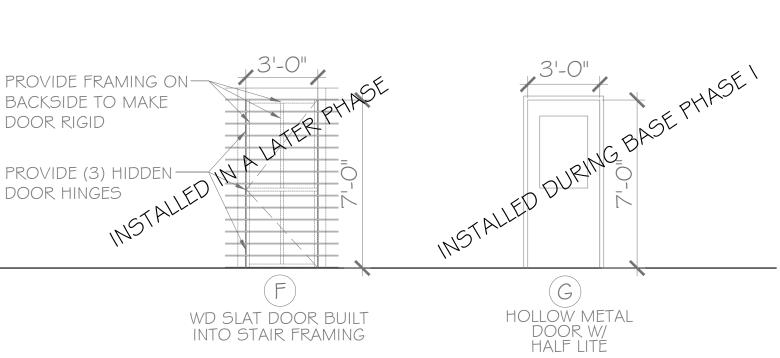

GENERAL NOTES

ALL GREYED OUT ITEMS WERE CONSTRUCTED DURING BASE PHASE I OR ARE TO BE CONSTRUCTED DURING PHASE II





PHASE I DRAWINGS FOR ORANGE BEACH ORANGE BEACH ORANGE BEACH ALABAMA


JOB NO.: 21-05
DRAWN: CLT
CHECKED: SBM
DATE: 2021.06.01
REVISION:

SCALE: 1/4"=1'-0"


SHEET NO.:

ALT 1
A2.1


DOOR, WINDOW &
FINISH SCHEDULE

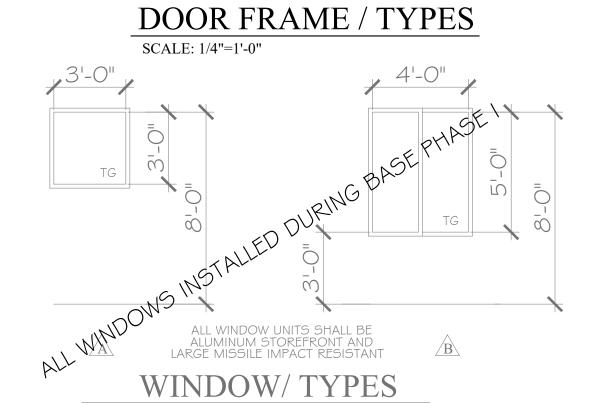


SCALE: 1/4"=1'-0"

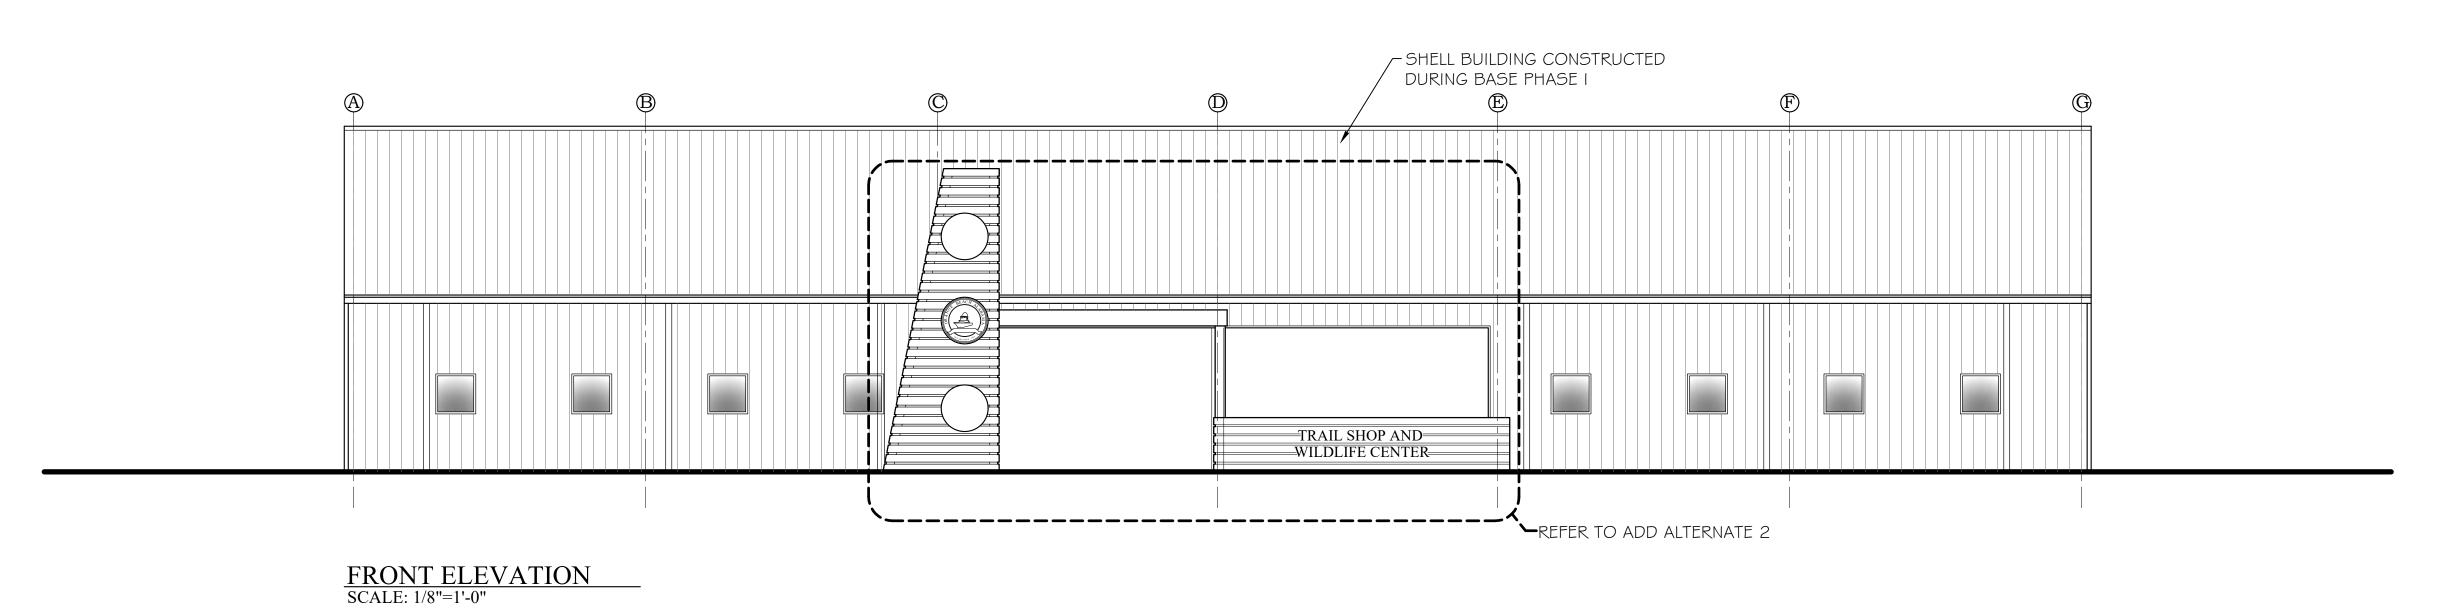





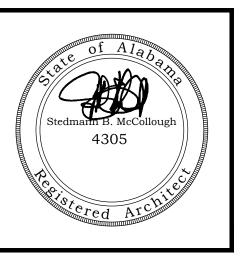

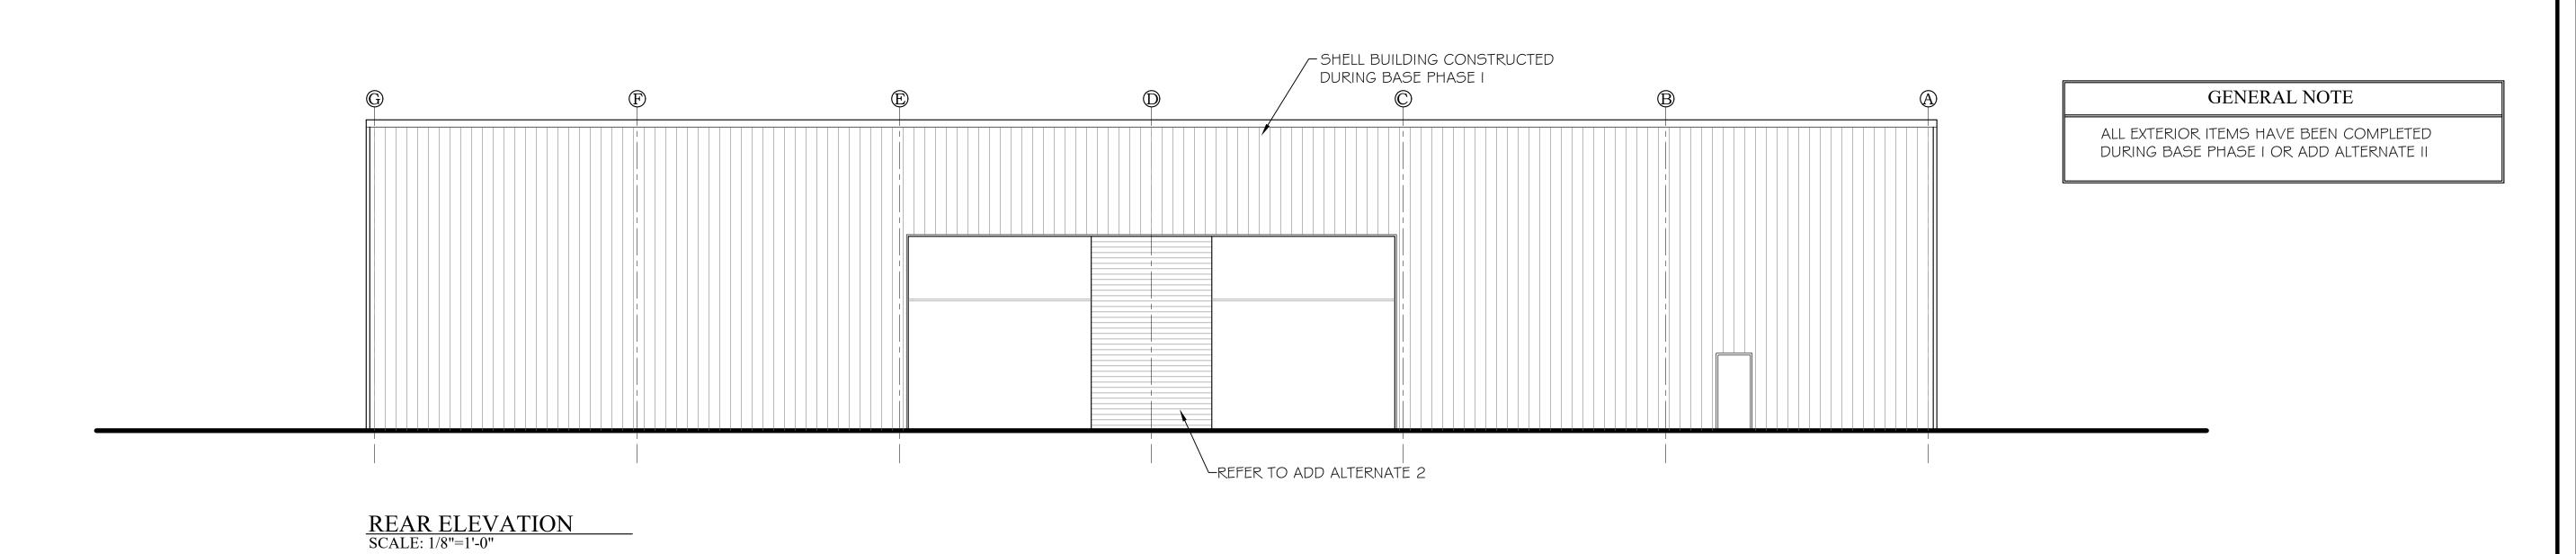

CENTE

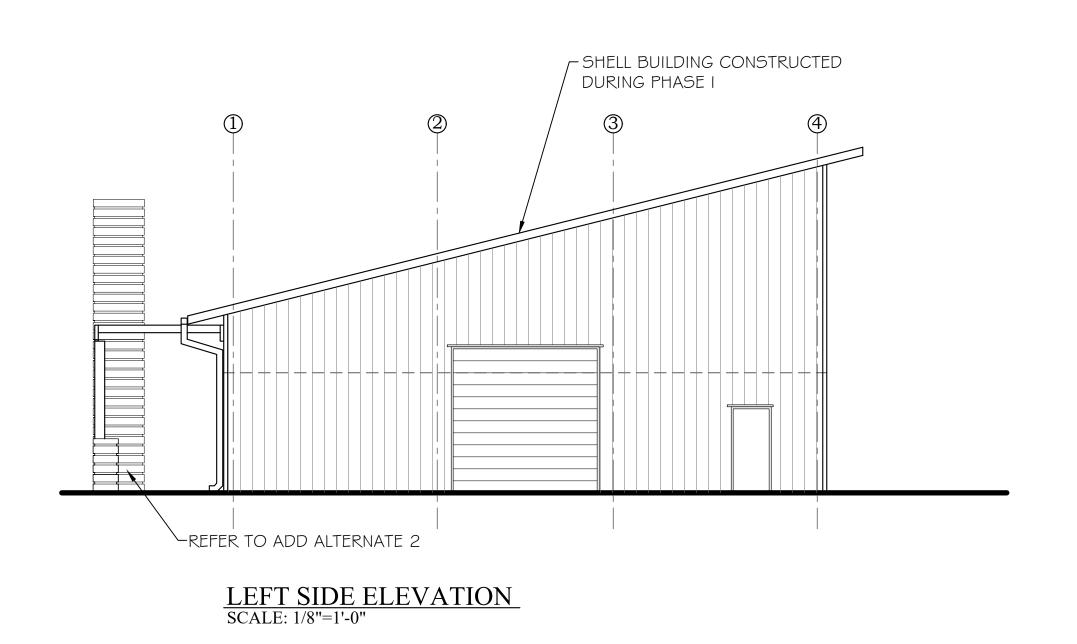

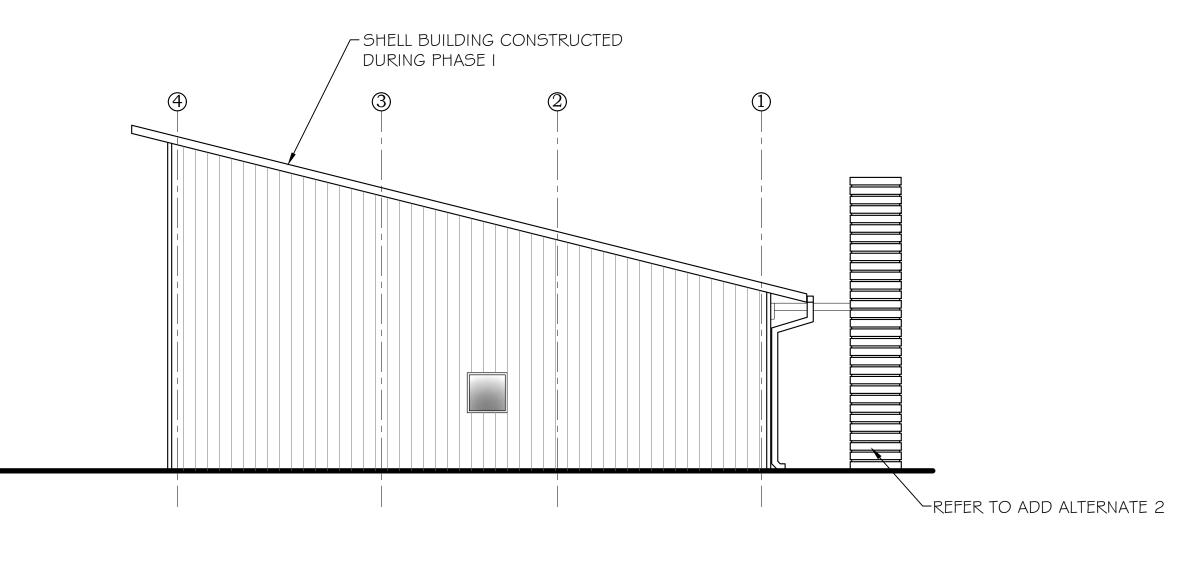

RIGHT SIDE ELEVATION
SCALE: 1/8"=1'-0"


PHASE I ADD ALTERNATE 1

21-05 JOB NO.: DRAWN: CLT SBM CHECKED: 2021.06.01 DATE: REVISION:


1/8" = 1'-0" SCALE:

SHEET NO.: ALT 1


PHASE I EXTERIOR ELEVATIONS

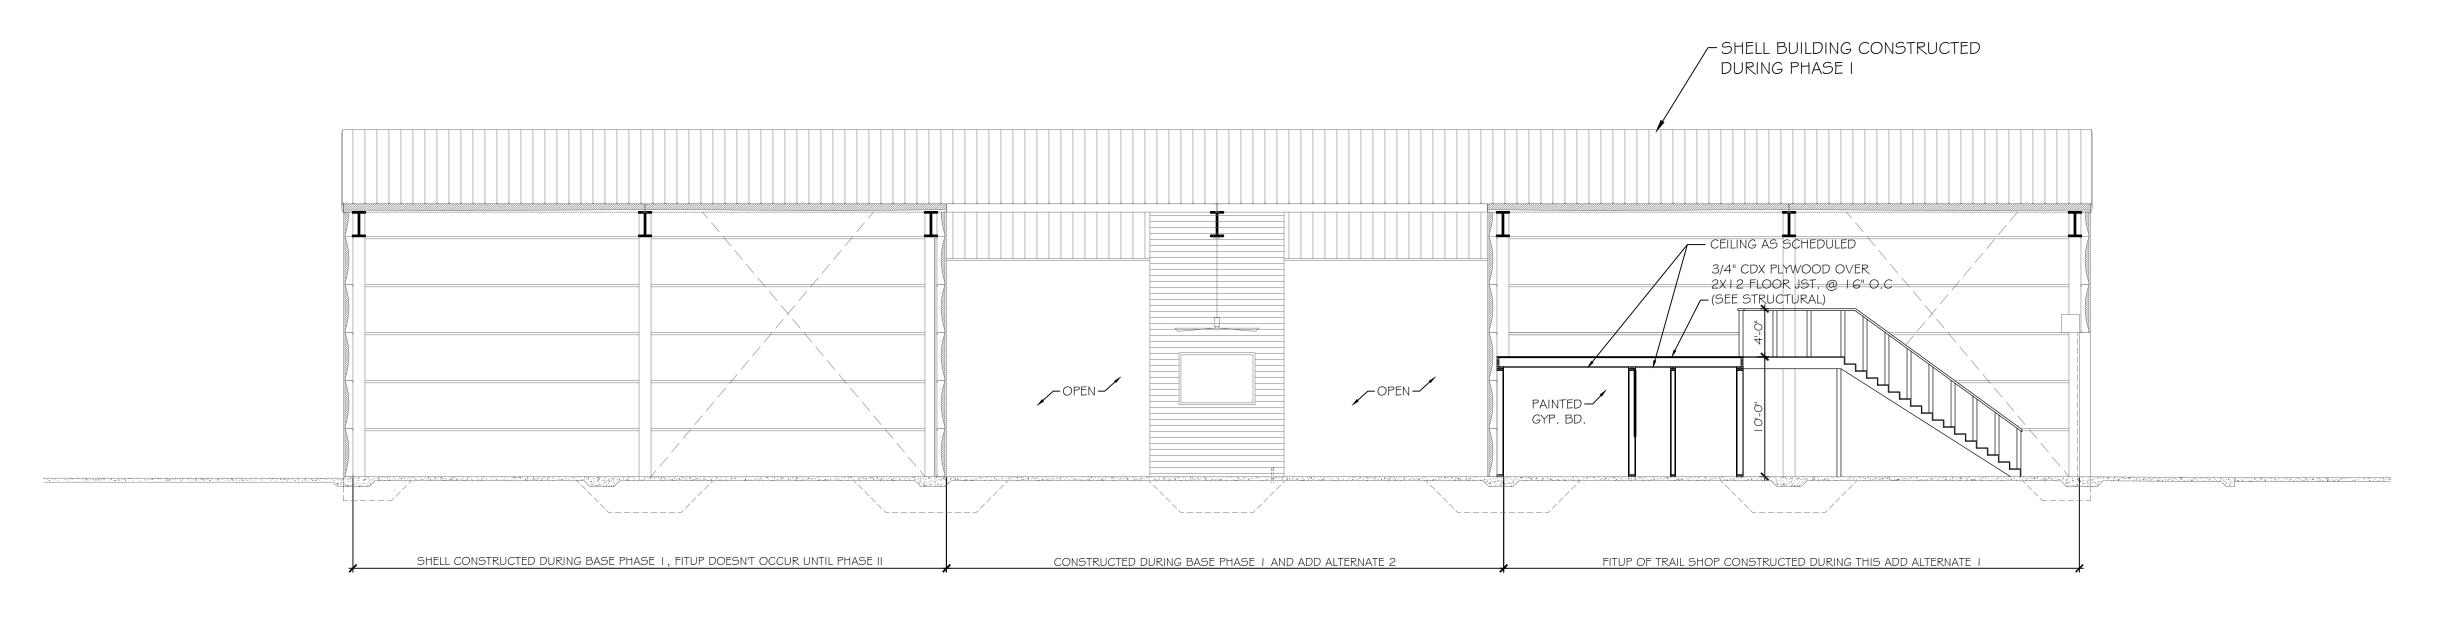

A BUILDING SECTION SCALE: 1/8"=1'-0"

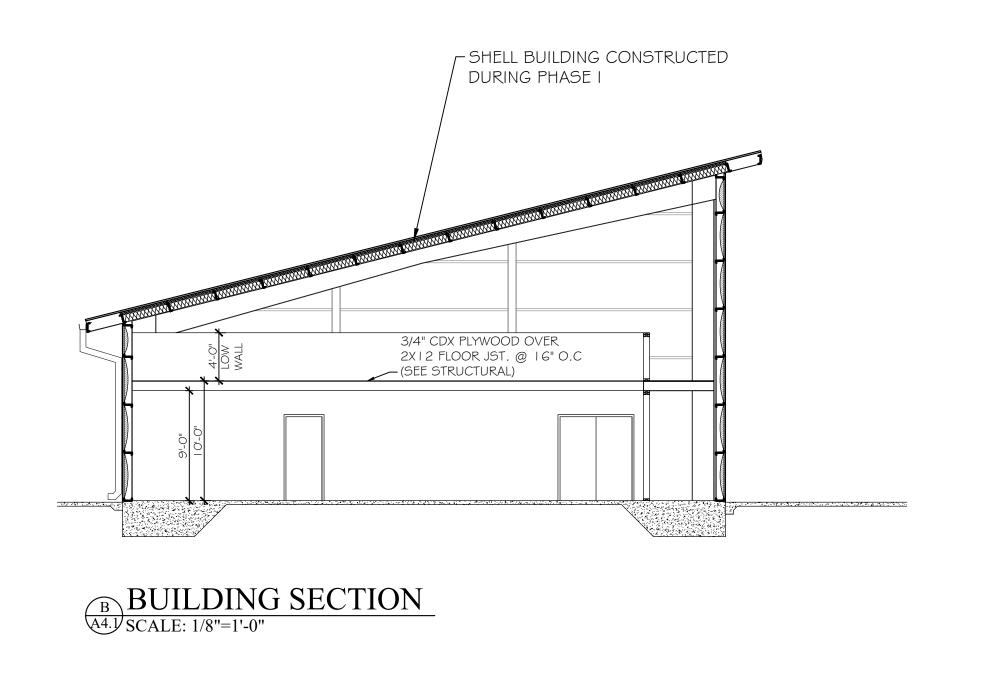

McCollough Architecture, Inc.
P.O. BOX 6310
GULF SHORES, ALABAMA
36547-6310
PHONE: 251-968-7222

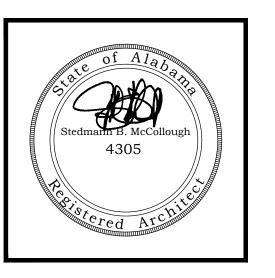

ORANGE BEACH VIL SHOP / WILDLIFE CENTE ORANGE BEACH

JOB NO.: 21-05
DRAWN: CLT
CHECKED: SBM
DATE: 2021.06.01

REVISION:


SCALE: 1/8" = 1'-0"

SHEET NO.:


ALT 1

A

PHASE I BUILDING SECTIONS

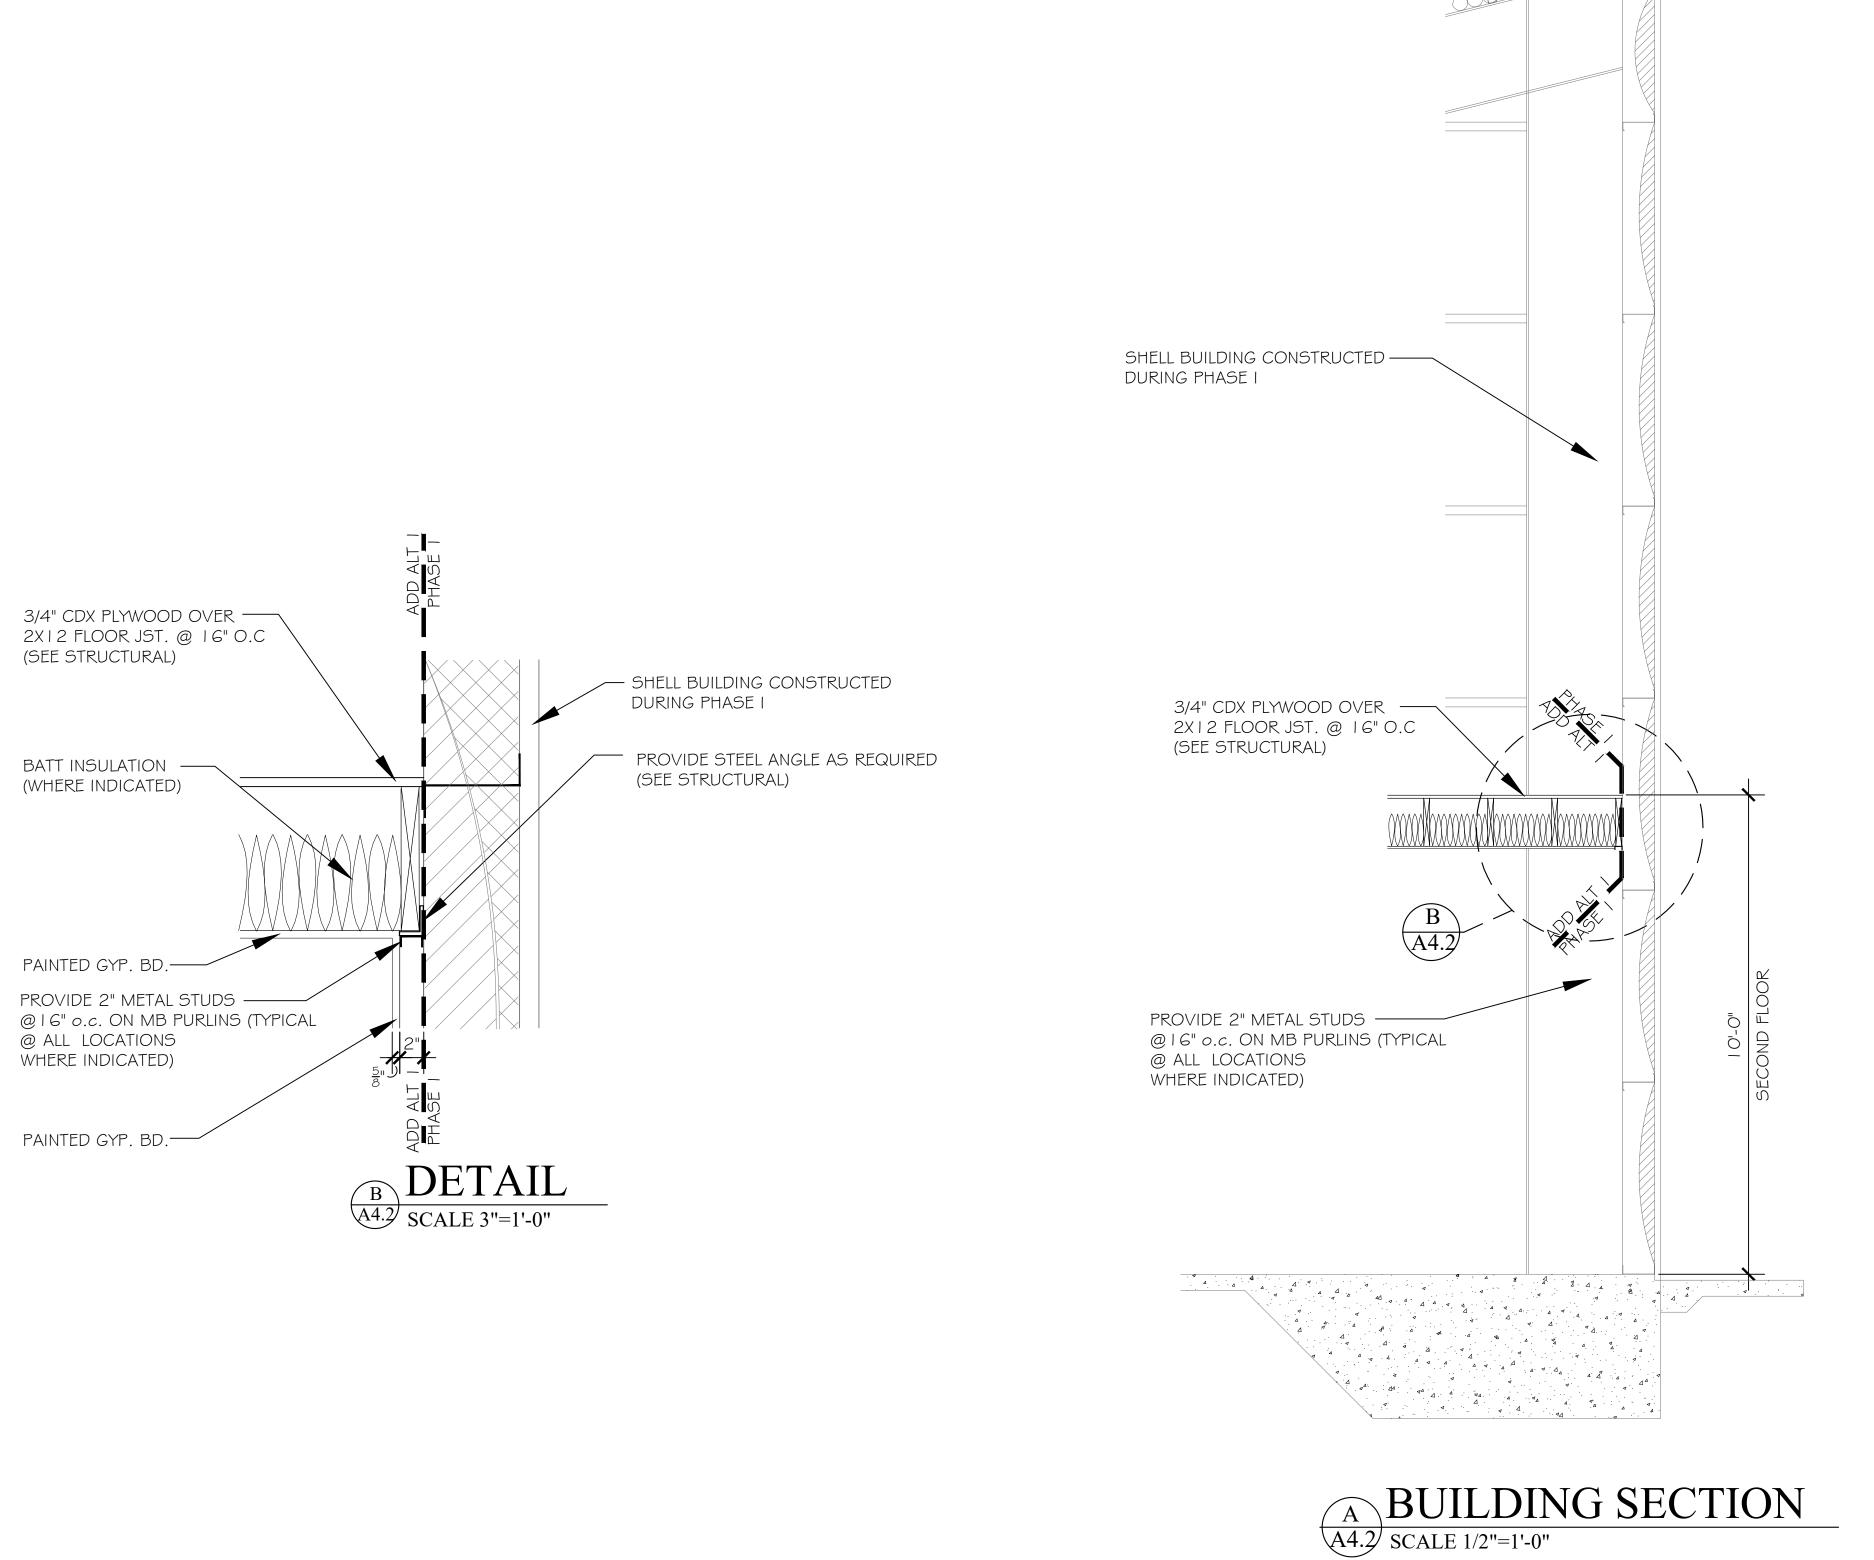



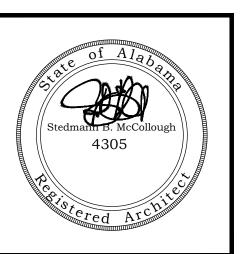

PHASE I DRAWINGS FOR ORANGE BEACH ORANGE BEACH ORANGE BEACH

JOB NO.: 21-05
DRAWN: CLT
CHECKED: SBM
DATE: 2021.06.01
REVISION:

SCALE: 1/2" = 1'-0"

SHEET NO.:


ALT 1 A4.2

SECTIONS AND DETAILS

PHASE I ADD ALTERNATE 1





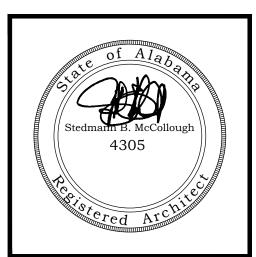

ENTE ACH OLIF WINGS BE OR

JOB NO.: 21-05 DRAWN: CLT CHECKED: 2021.06.01 DATE: REVISION:

SCALE: 1/2" = 1'-0" SHEET NO.:

ALT


ENLARGED PLANS & INTERIOR ELEVATIONS


ALL GREYED OUT ITEMS WERE CONSTRUCTED

DURING BASE PHASE I AND ADD ALTERNATE 2

GENERAL NOTES

COND. UNIT AREA

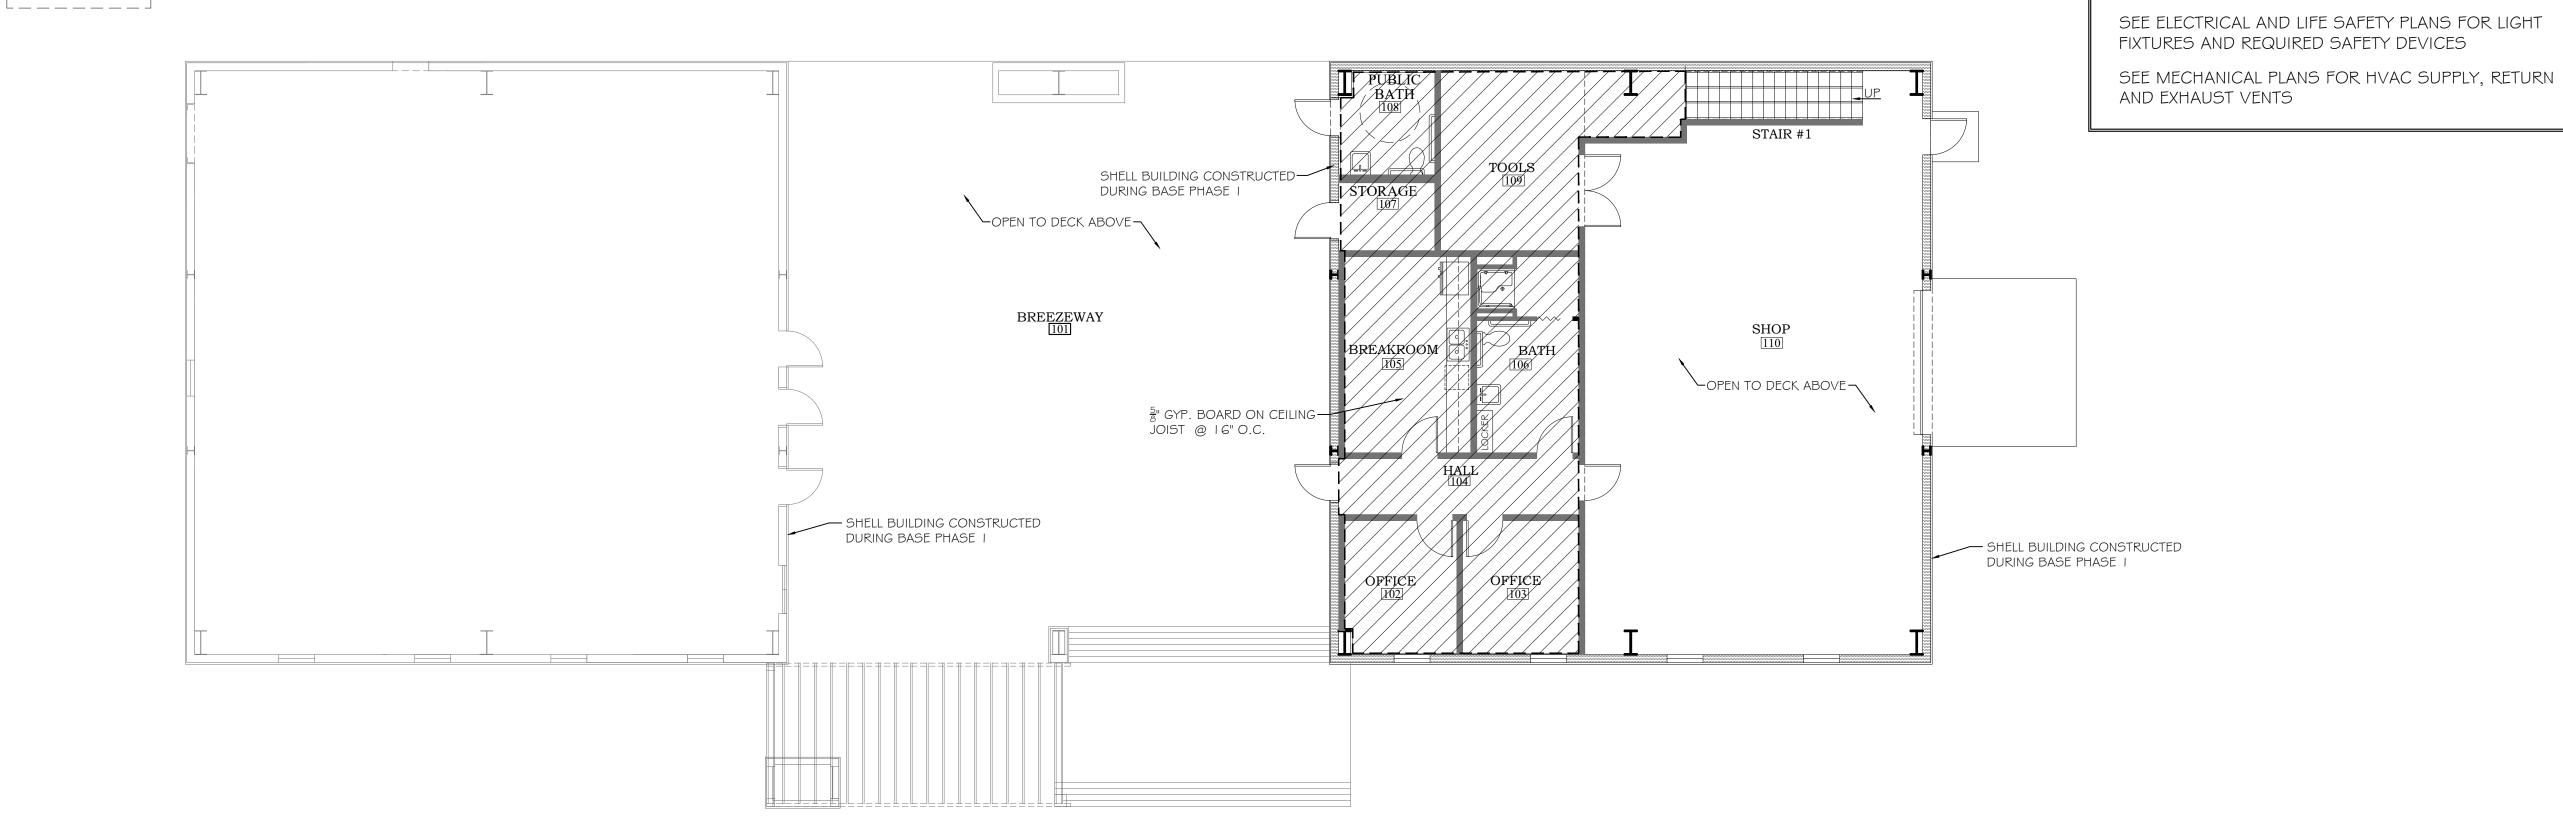

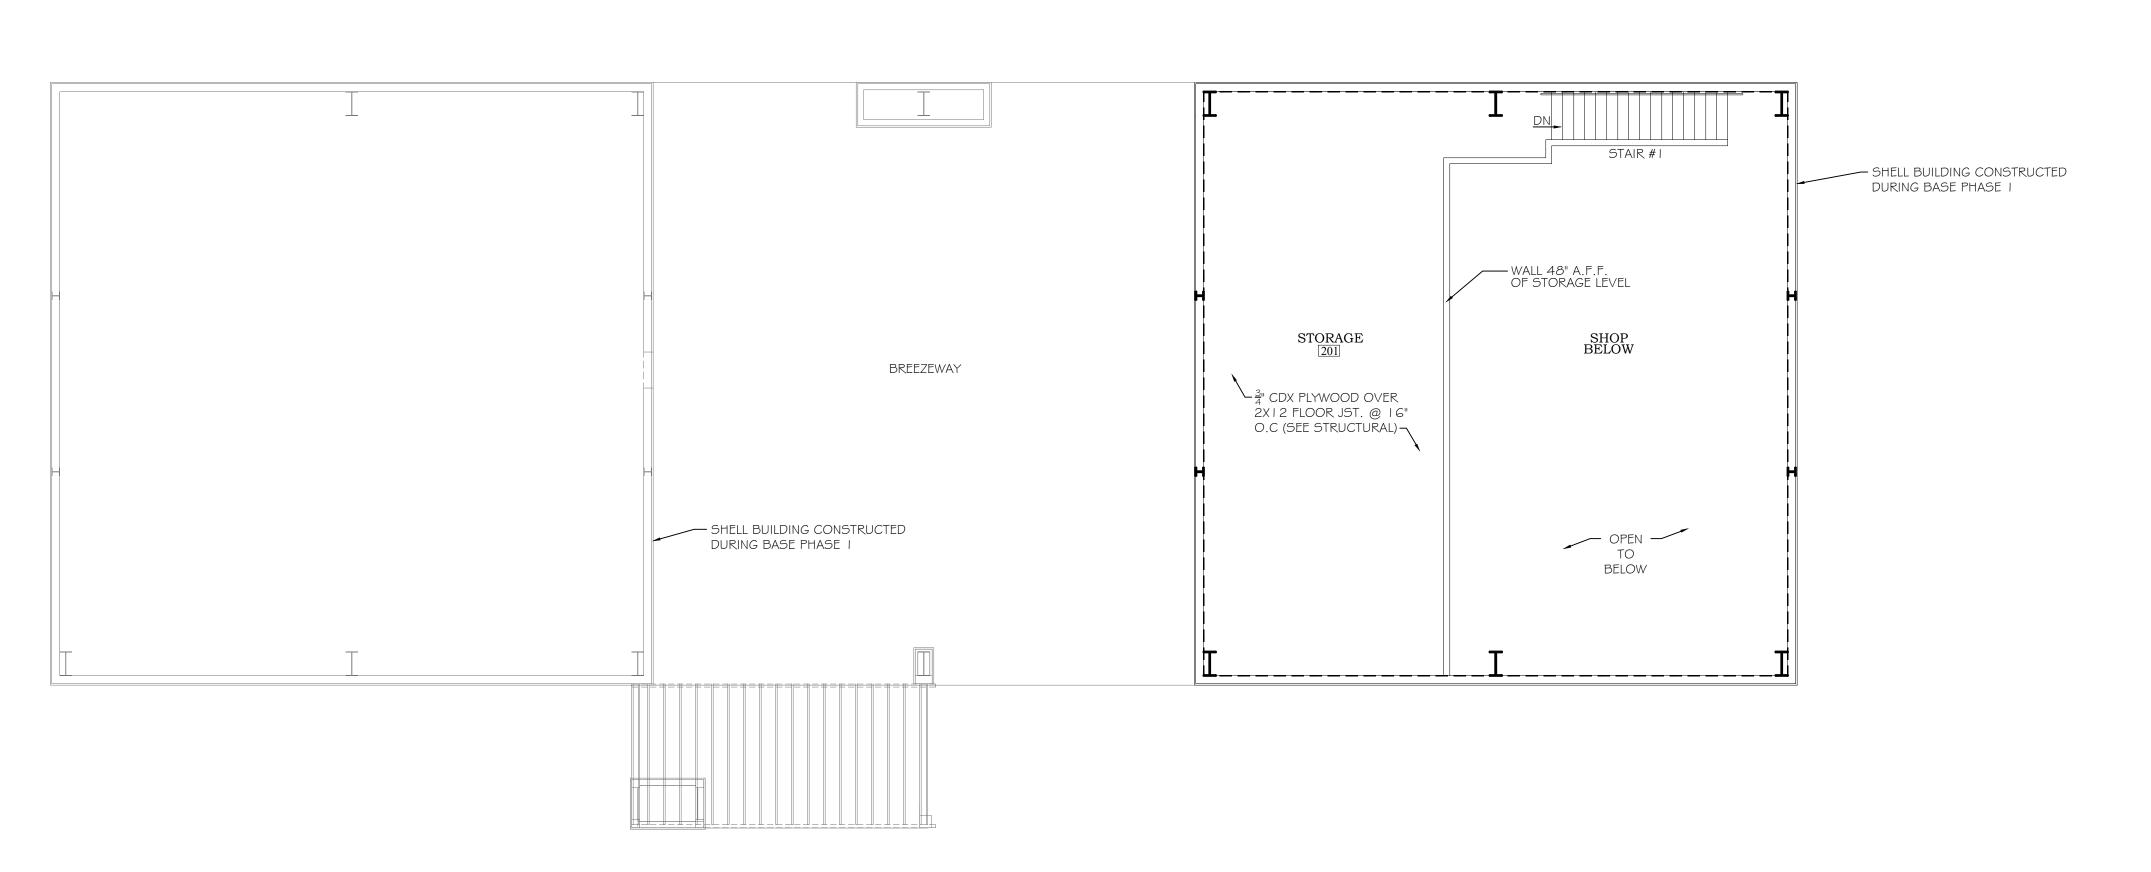



SECOND FLOOR REFLECTED CEILING PLAN
SCALE: 1/8"=1'-0"

FIRST FLOOR REFLECTED CEILING PLAN

SCALE: 1/8"=1'-0"

PHASE I ADD ALTERNATE 1

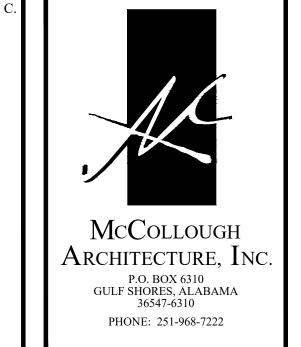

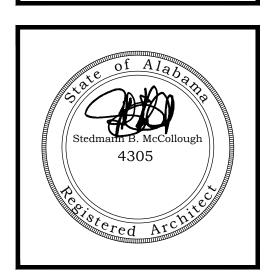

ORANGE BEACH IL SHOP / WILDLIFE CENTE ORANGE BEACH


JOB NO.: 21-05
DRAWN: CLT
CHECKED: SBM
DATE: 2021.06.01
REVISION:

SCALE: 1/8" = 1'-0"

SHEET NO.:

ALT 1 A6.1

REFLECTED CEILING PLAN

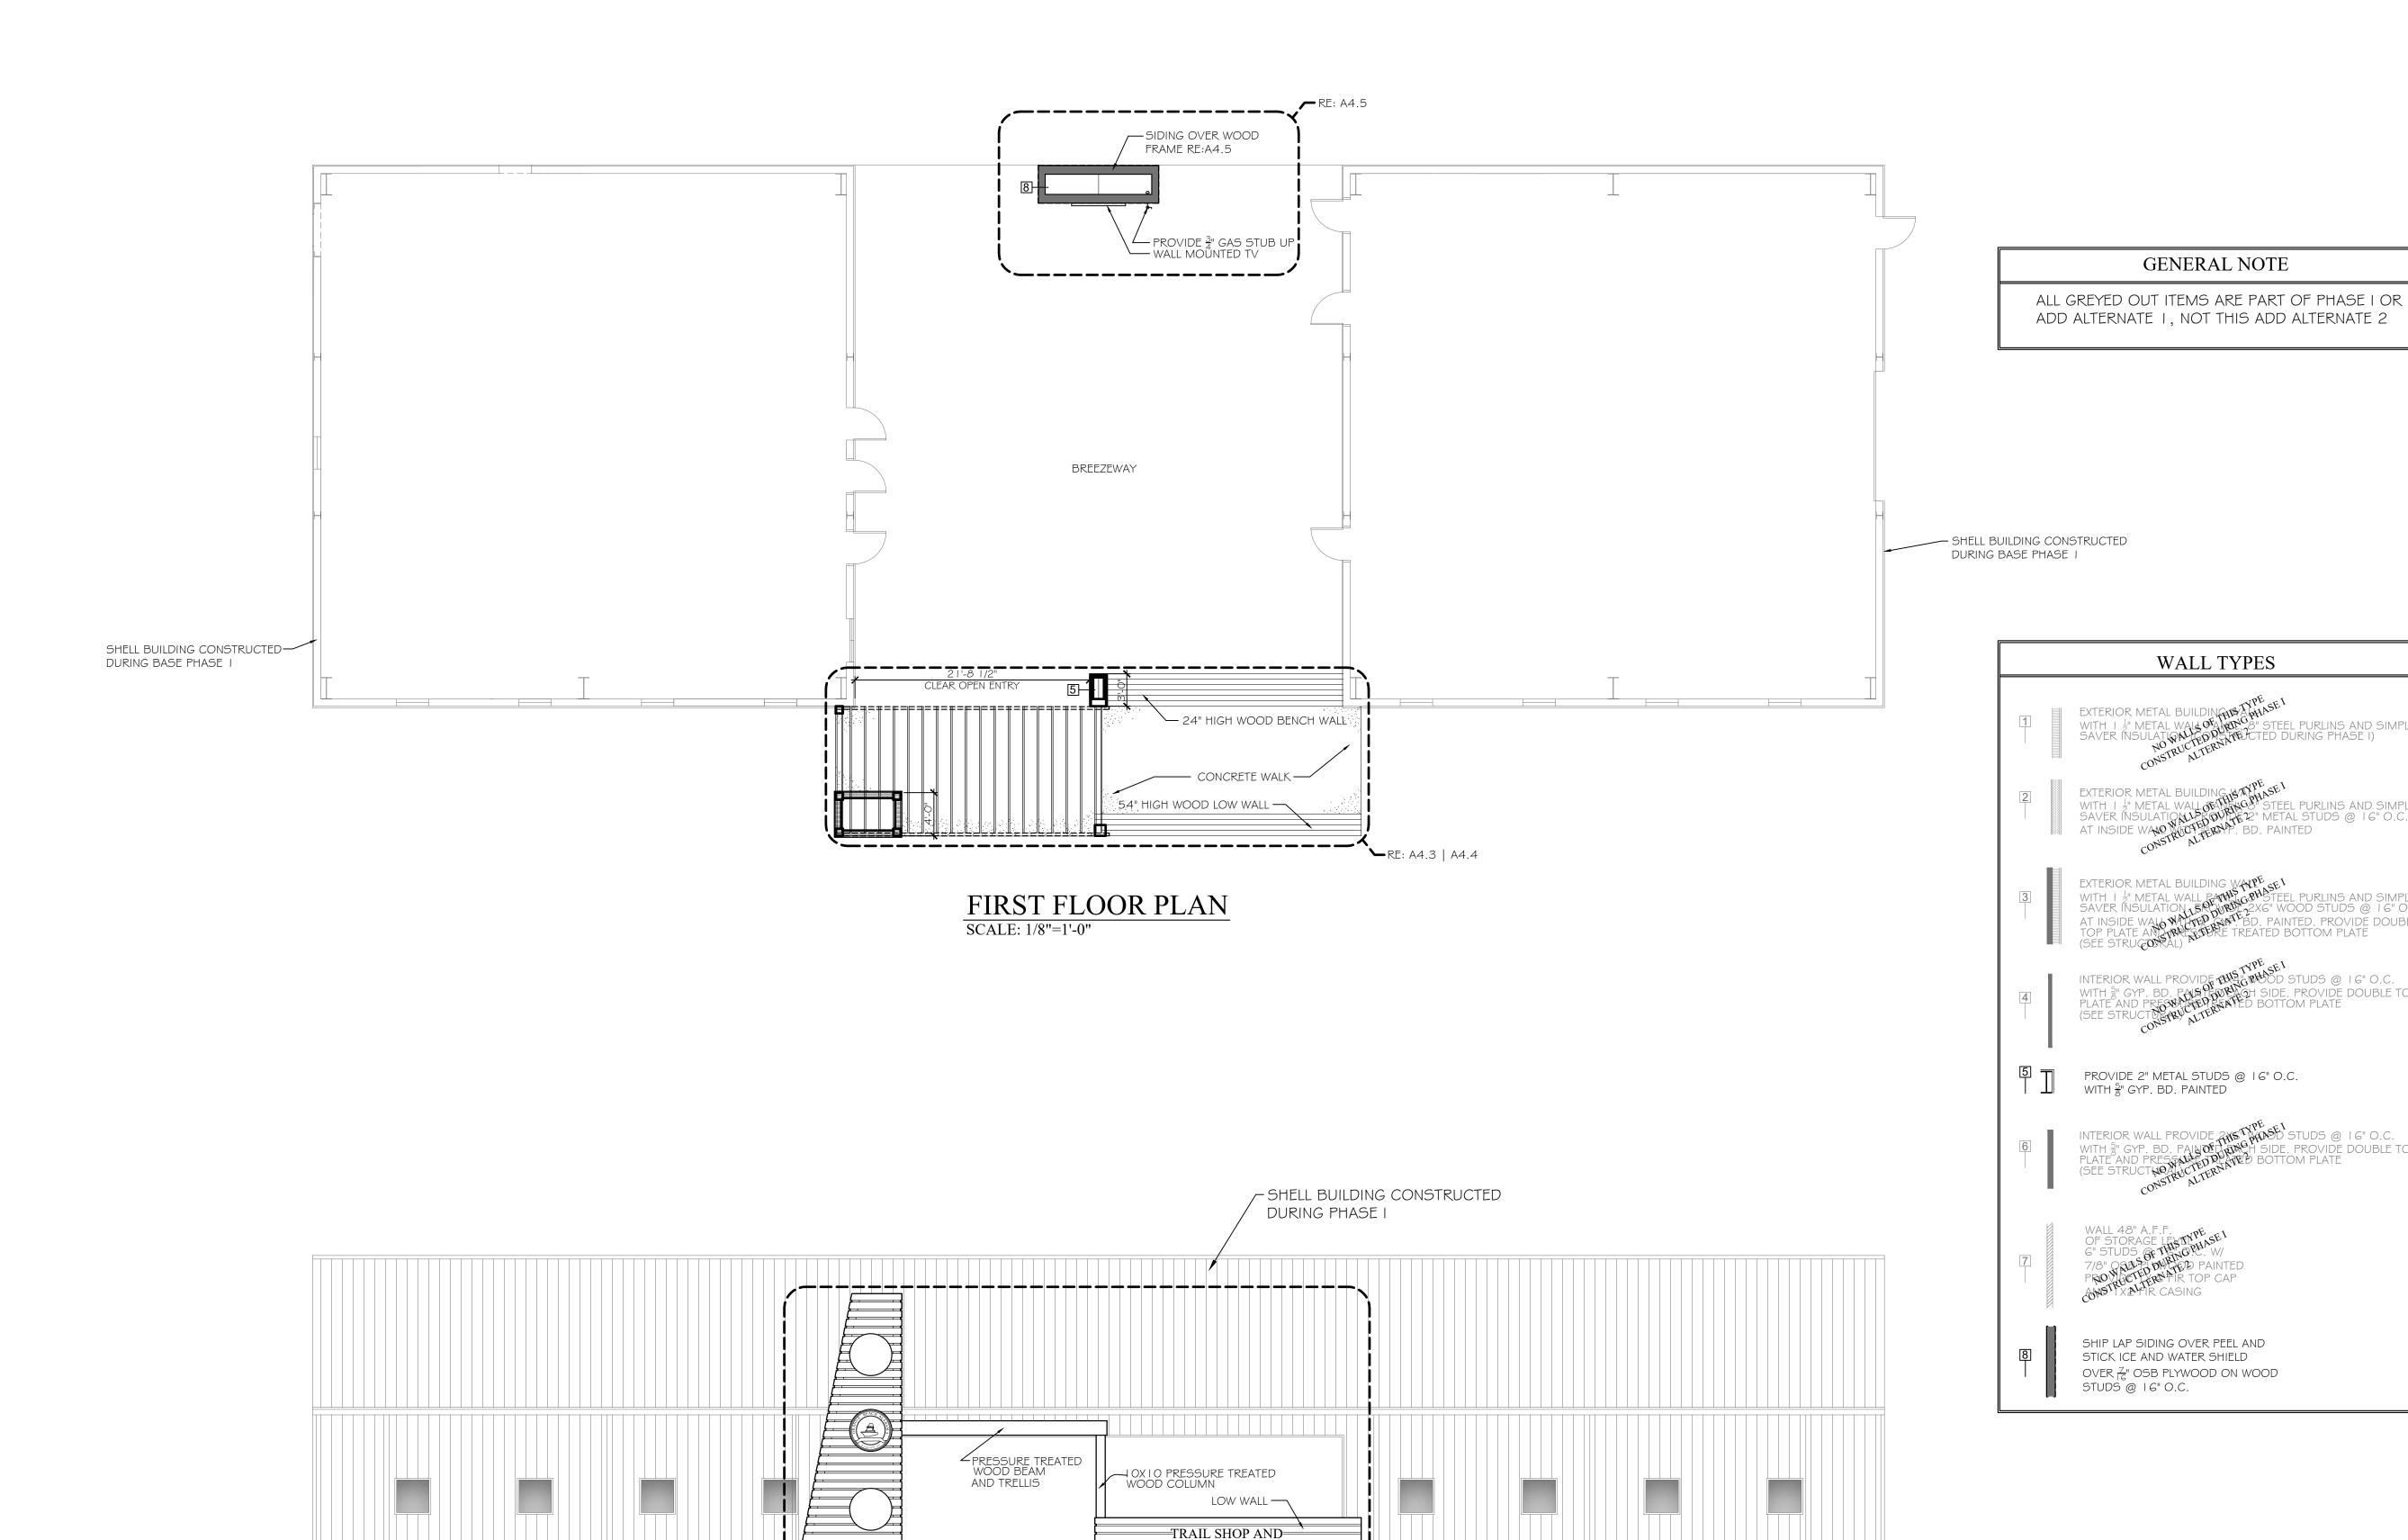


-WILDLIFE CENTER-

FRONT ELEVATION
SCALE: 1/8"=1'-0"

ADD ALTERNATE 2 - ENTRY ELEMENTS

McCollough Architecture, Inc. P.O. BOX 6310 GULF SHORES, ALABAMA 36547-6310 PHONE: 251-968-7222

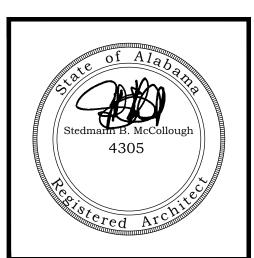

I DRAWINGS I VANGE BEACH
/ WILDLI **PHASE**

21-05 JOB NO.: DRAWN: CHECKED: 2021.06.01 DATE: REVISION:

CLT


SBM

1/8" = 1'-0"SCALE:

SHEET NO.: ALT 2

FLOOR PLANS

PHASE I ADD ALTERNATE 2

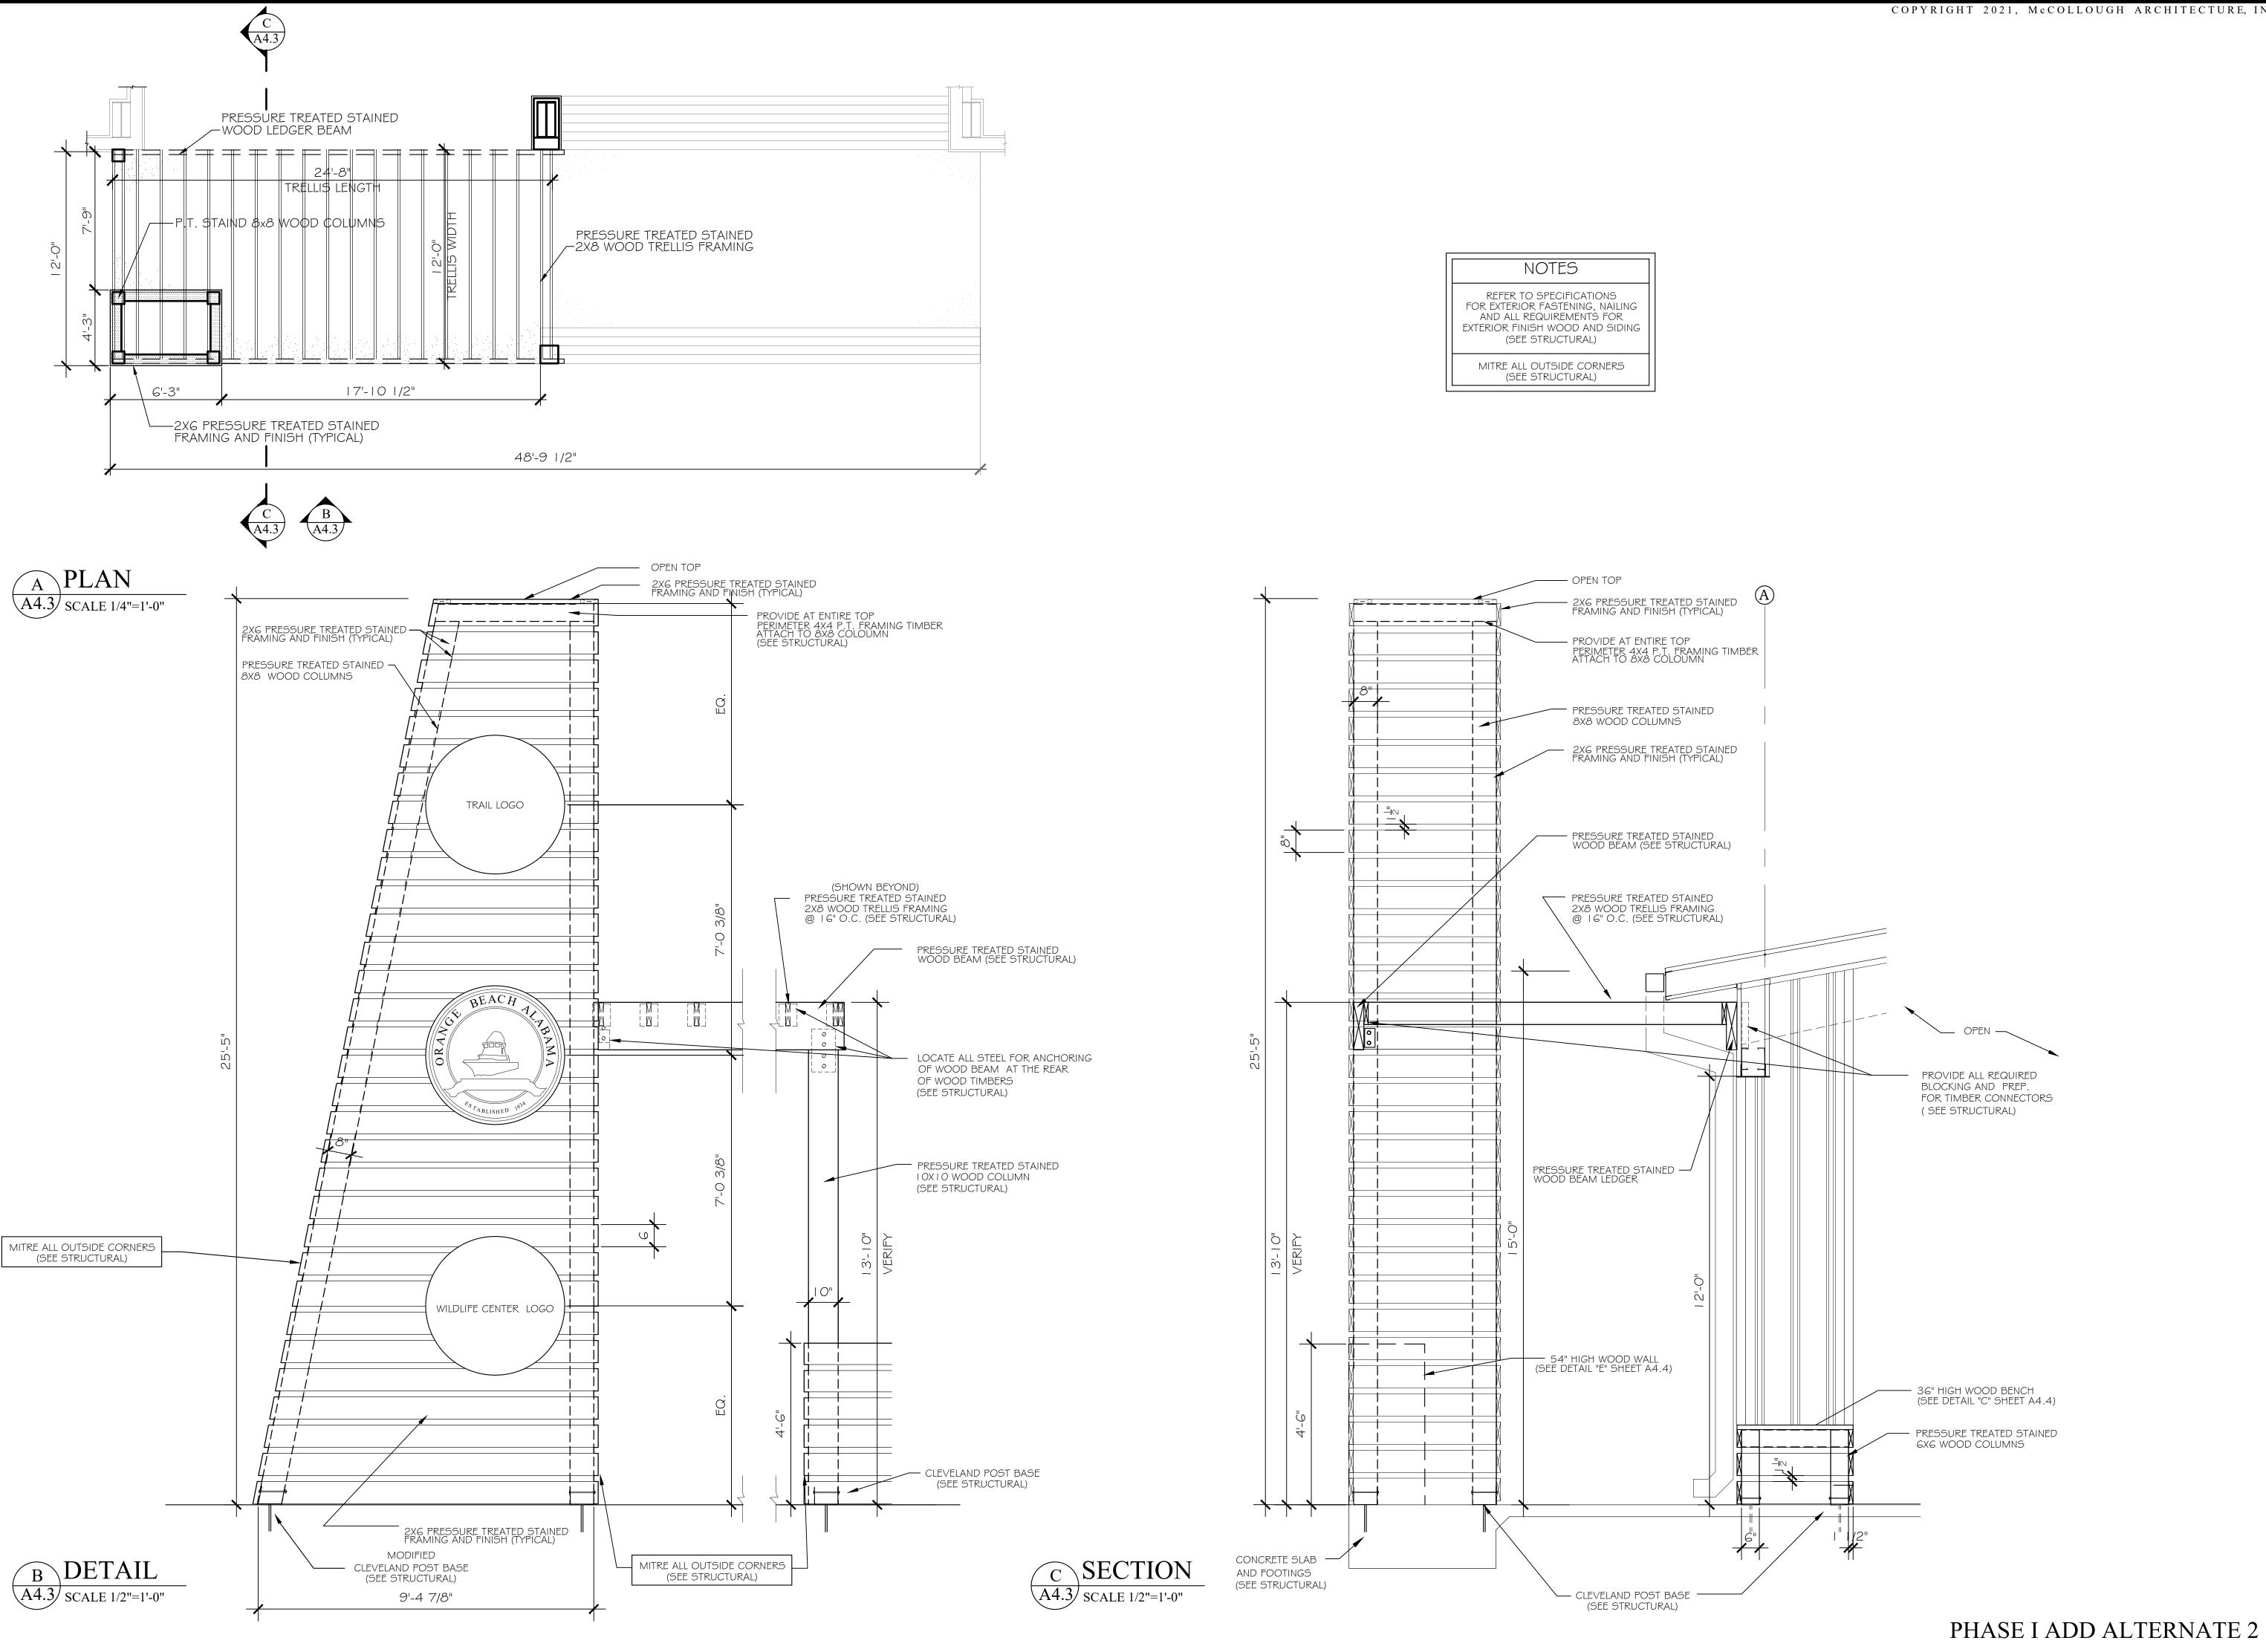






ENTE ACH OLIF BE I DRAW ANGE E ORANGE B ALABAN **PHASE**

JOB NO.: 21-05 DRAWN: CLT SBM CHECKED: 2021.06.01 DATE: REVISION:

1/2" = 1'-0" SCALE:

SHEET NO.: ALT 2

SECTIONS AND DETAILS

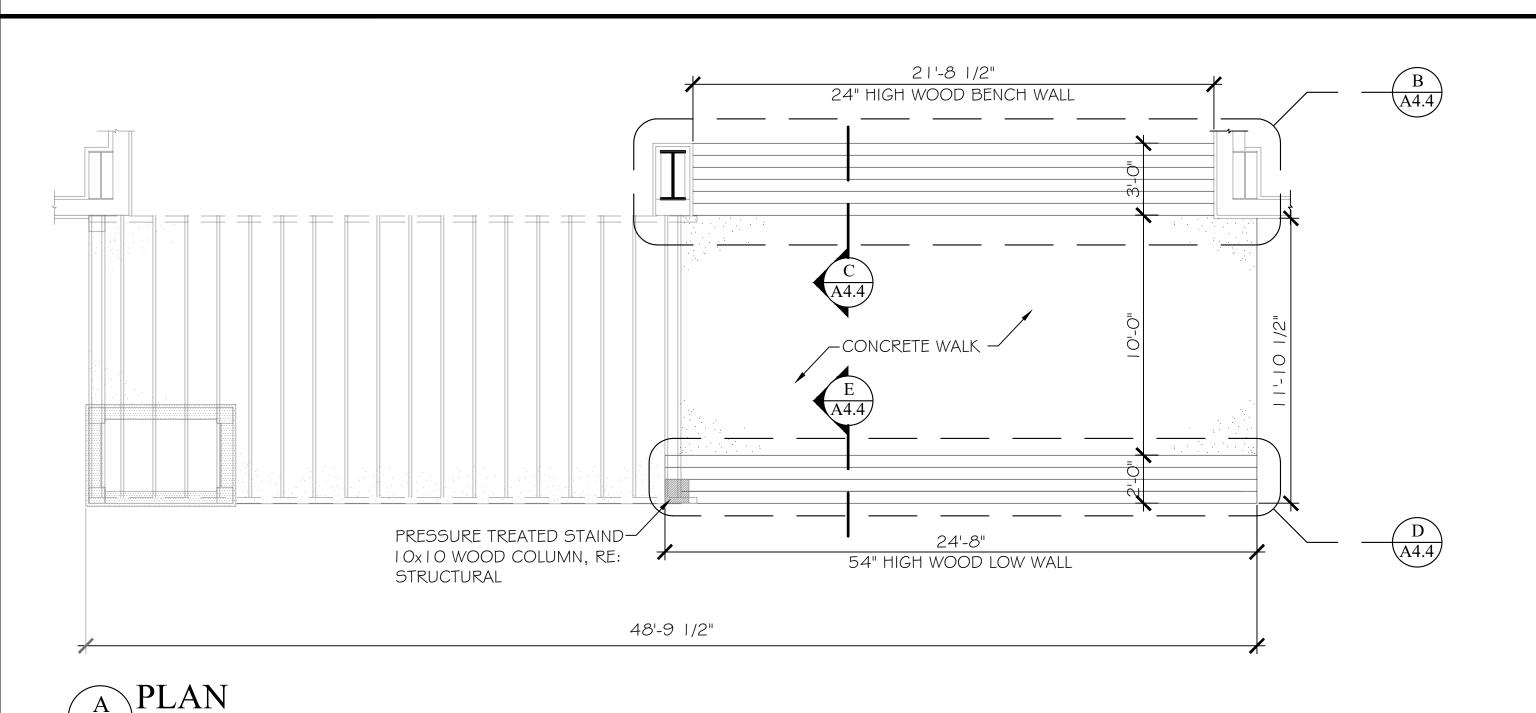



NOTES


REFER TO SPECIFICATIONS
FOR EXTERIOR FASTENING, NAILING
AND ALL REQUIREMENTS FOR
EXTERIOR FINISH WOOD AND SIDING


(SEE STRUCTURAL)

MITRE ALL OUTSIDE CORNERS (SEE STRUCTURAL)

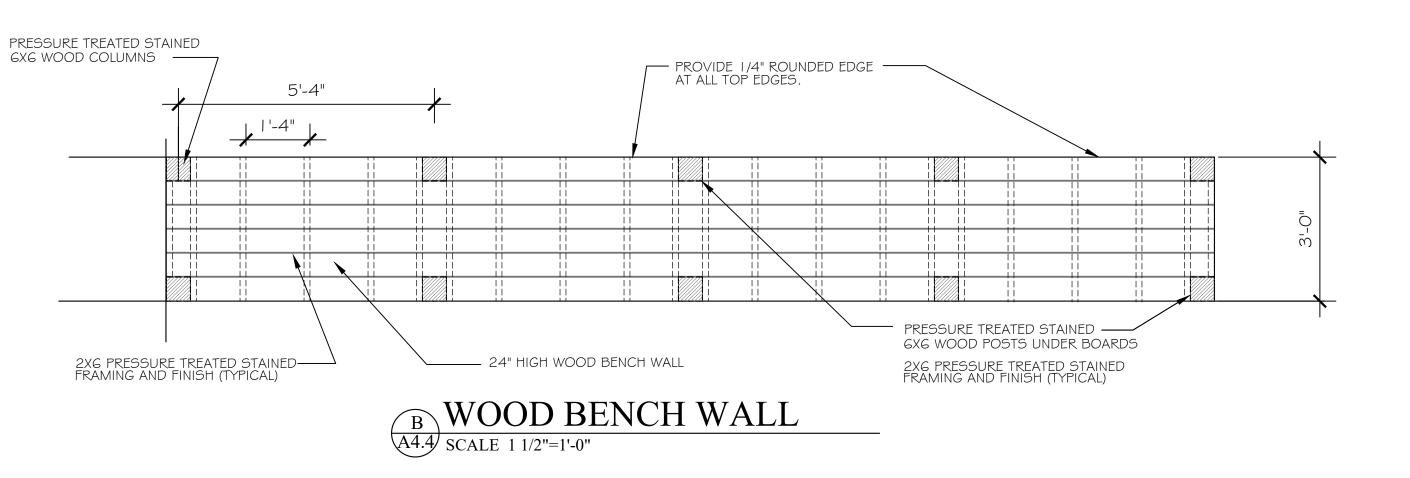


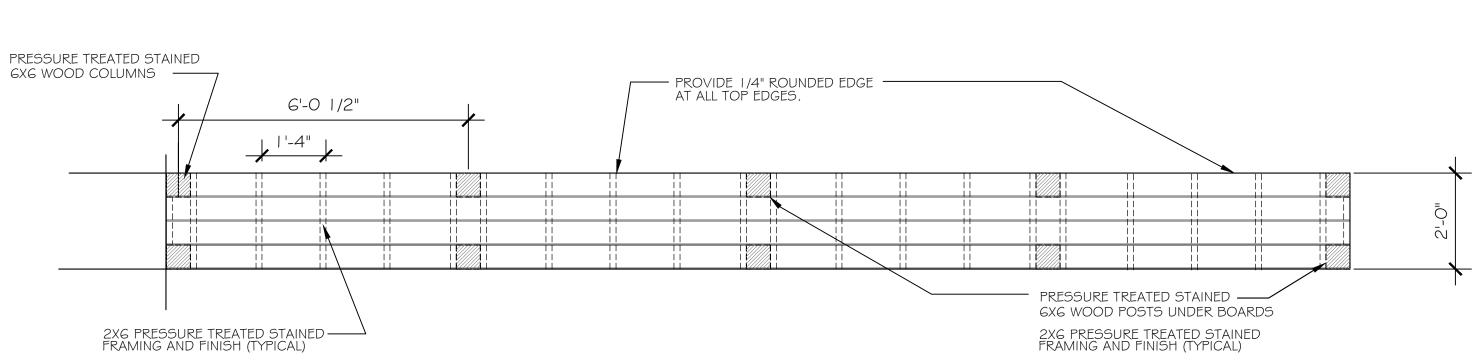

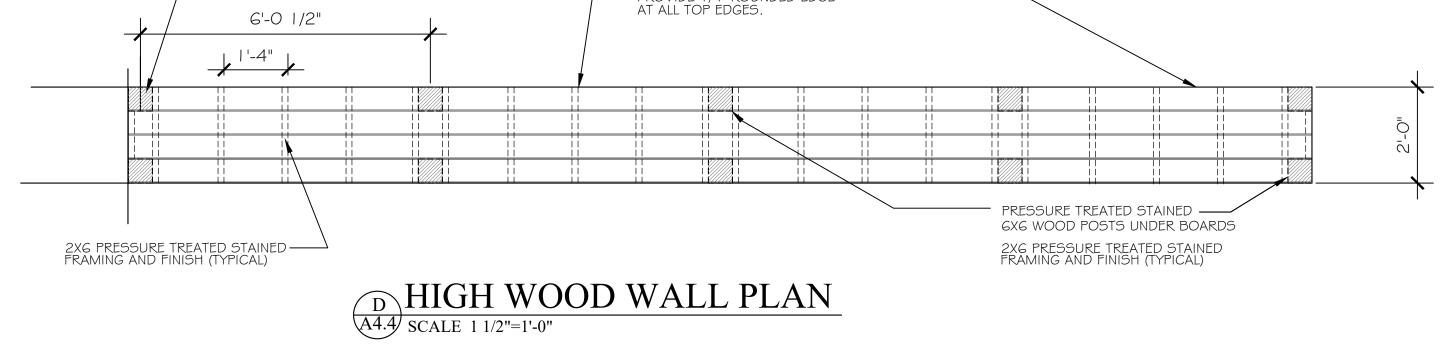


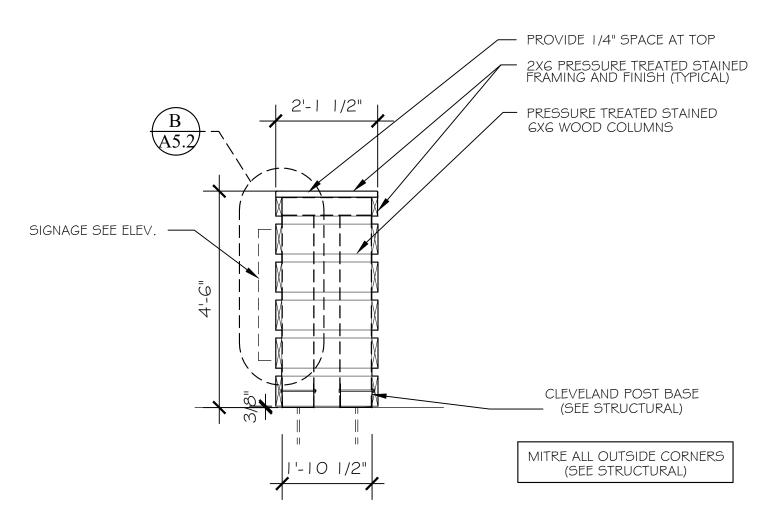

HIGH WOOD WALL SECTION A4.4 SCALE 1 1/2"=1'-0"

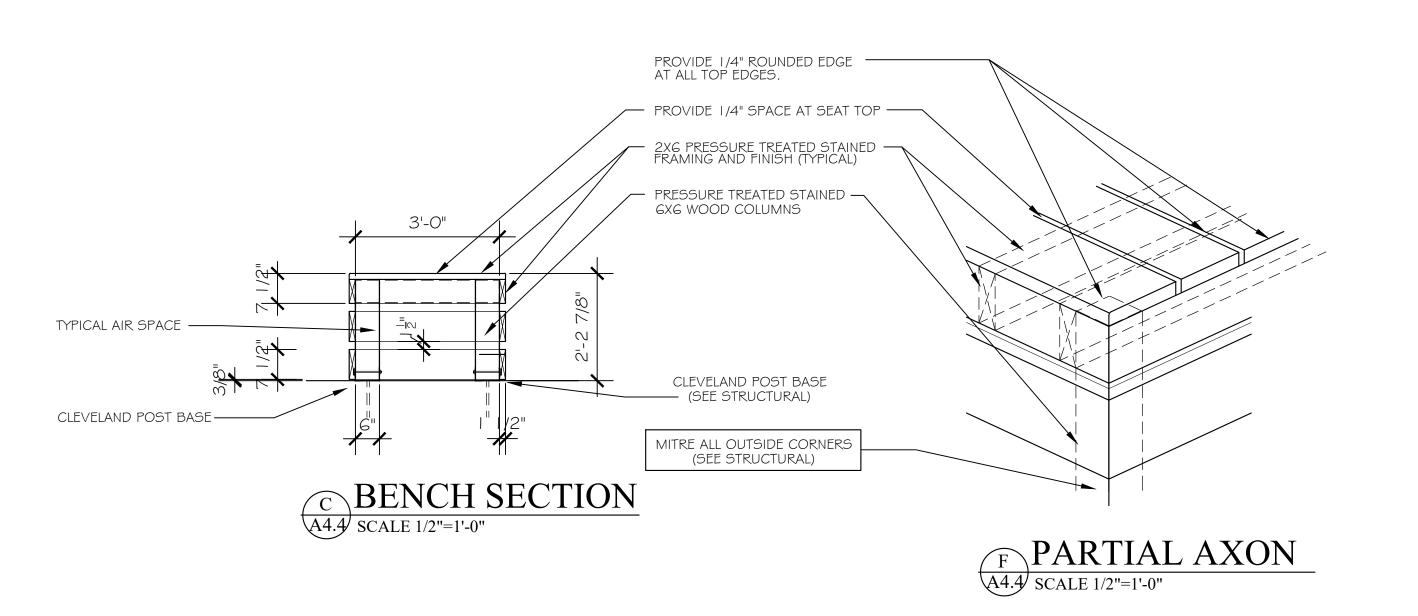

McCollough Architecture, Inc. P.O. BOX 6310 GULF SHORES, ALABAMA 36547-6310 PHONE: 251-968-7222

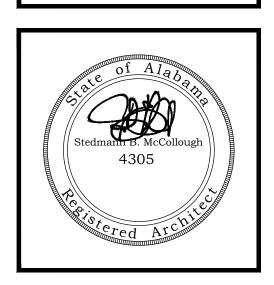


CENTE BEACH LDLIFE BE,

JOB NO.: 21-05 DRAWN: CLT CHECKED: SBM 2021.06.01 DATE: REVISION:


1/2" = 1'-0" SCALE:

SHEET NO.: ALT 2

SECTIONS AND DETAILS

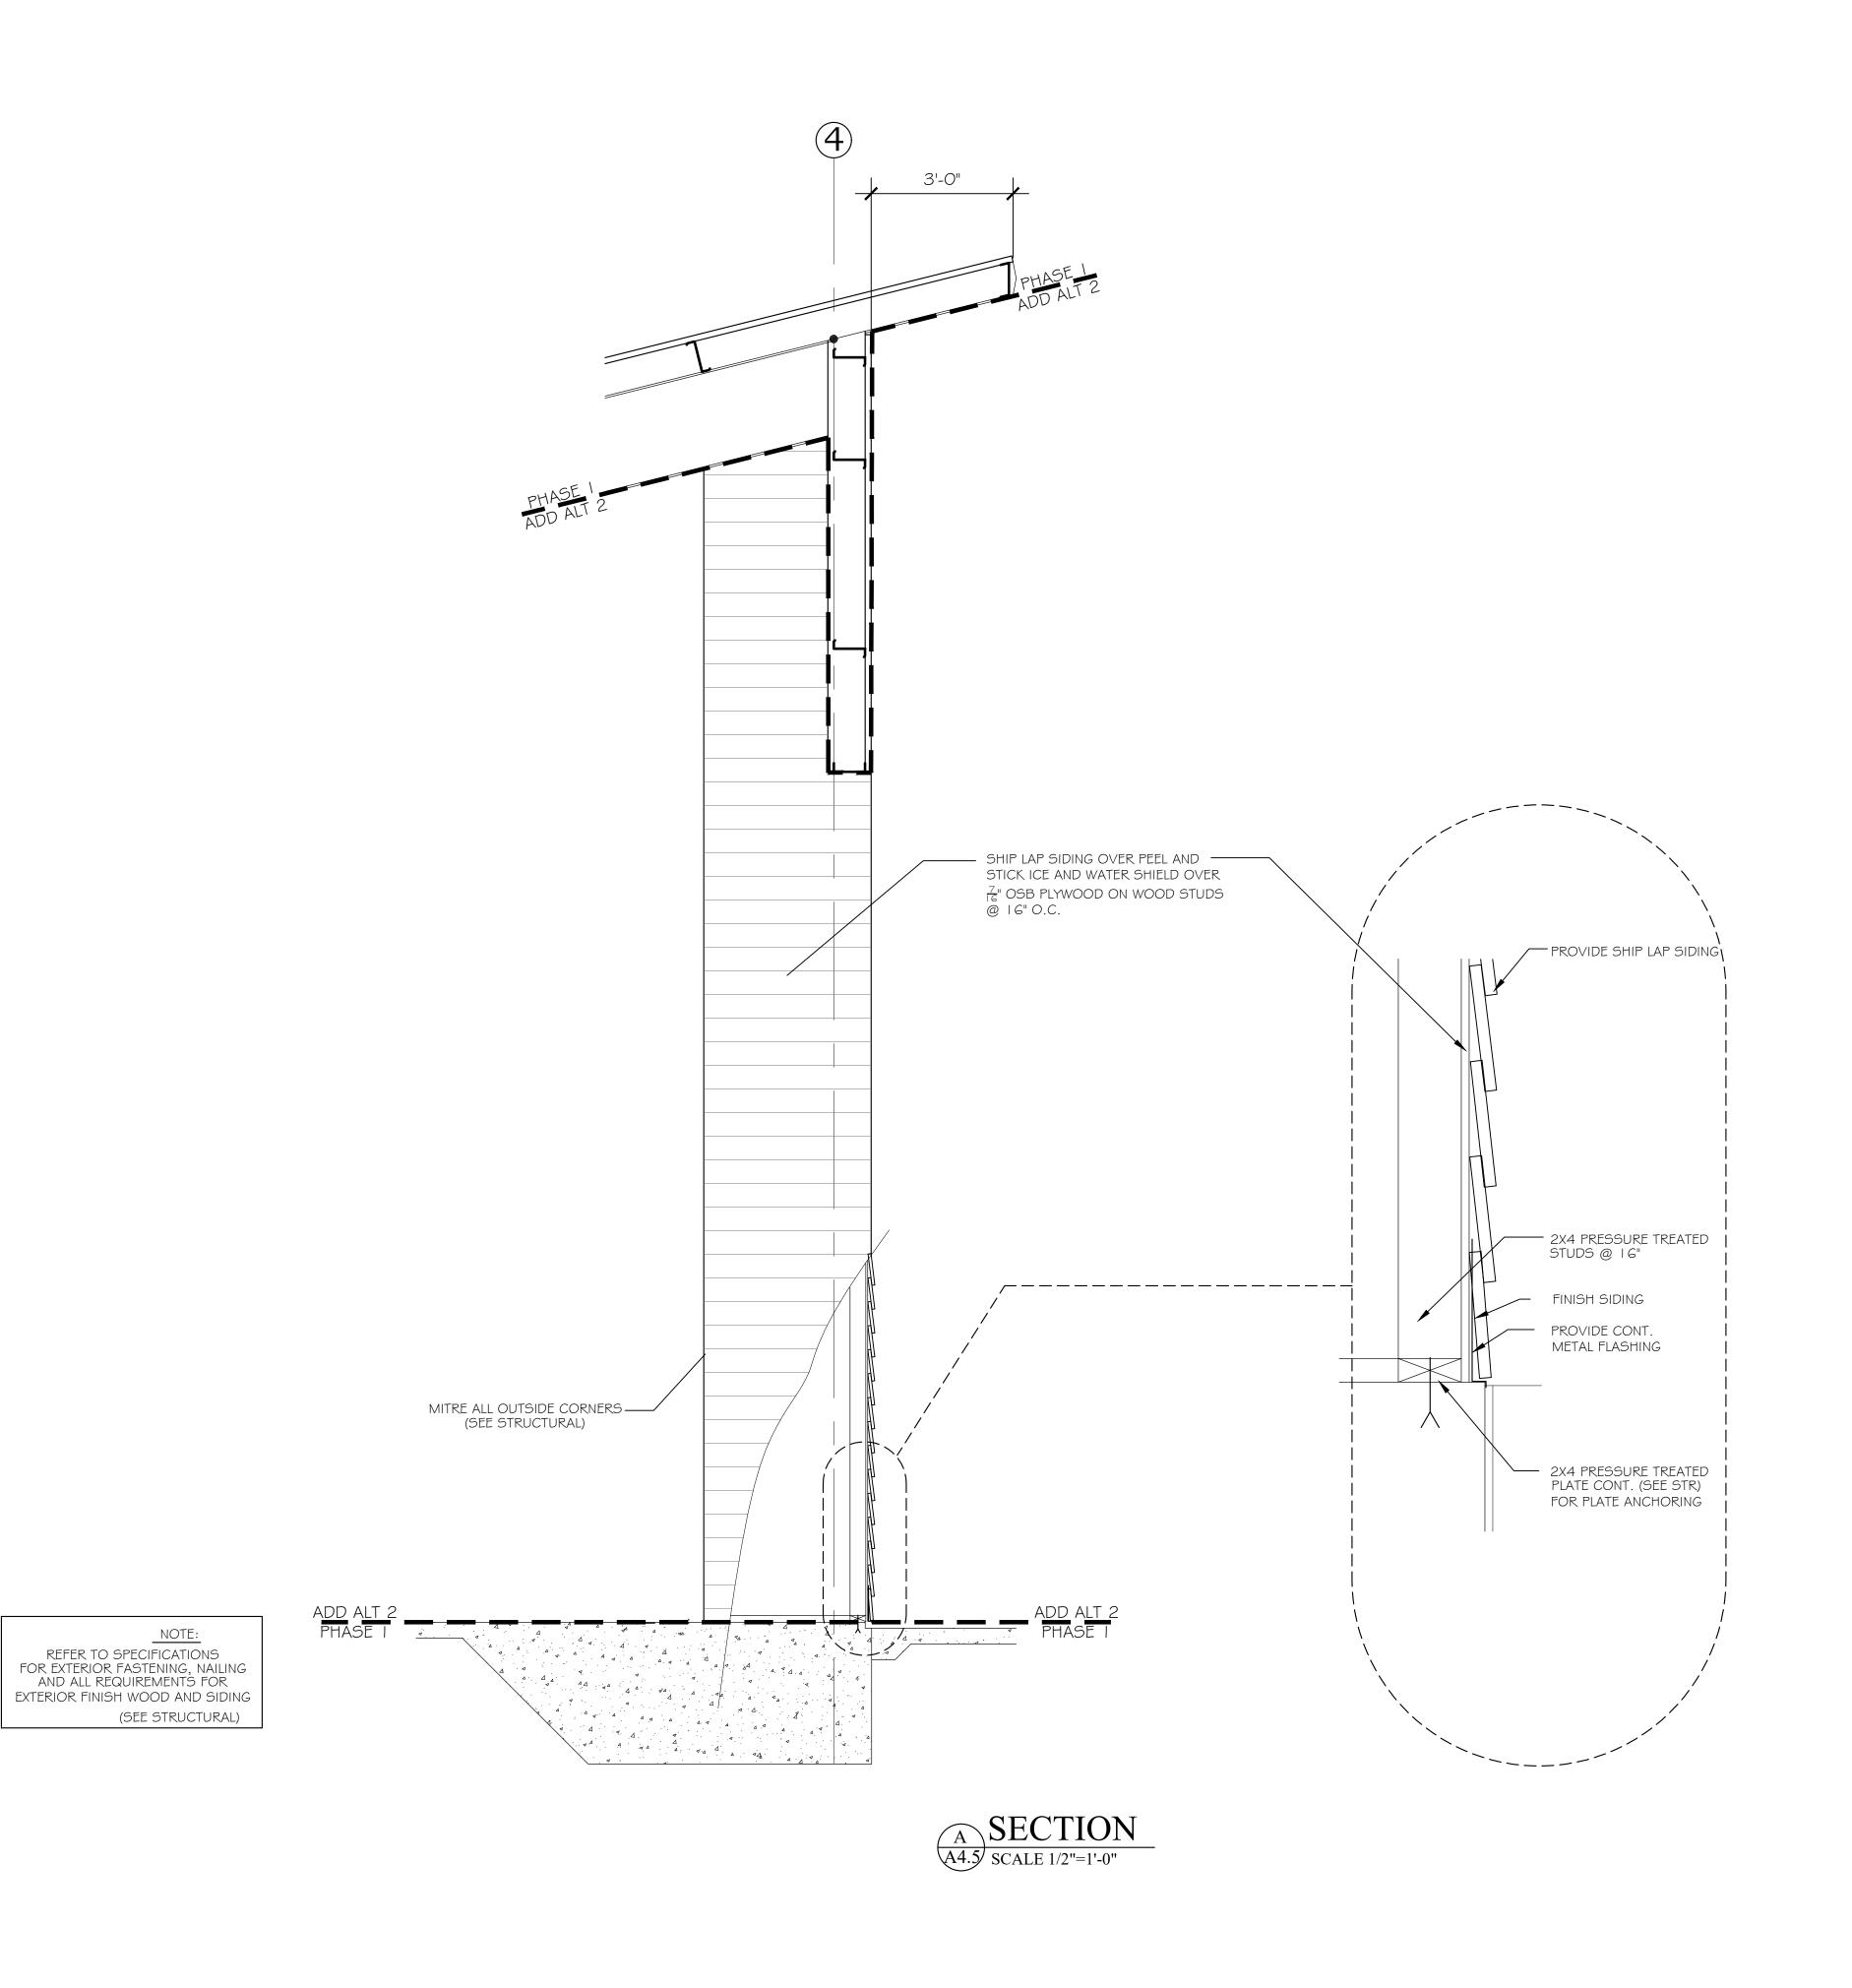



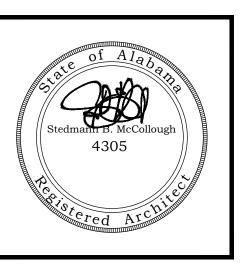

BE, **PHASE**

21-05 JOB NO.: DRAWN: CHECKED: 2021.06.01 DATE: REVISION:

CLT

SBM

1/2" = 1'-0" SCALE:

SHEET NO.:
ALT 2

SECTIONS AND DETAILS





PHONE: 251-968-7222 PROFESSIONAL 7/6/2021

P.O. BOX 6310 GULF SHORES, ALABAMA 36547-6310

$\mathbf{\Omega}$ NGE WI

JOB NO. DRAWN: GWS **GWS** CHECKED: 2021.04.22 DATE: **REVISION:**

SHEET NO.:

SCALE:

ELECTRICAL NOTES

AND LEGEND

AS SHOWN

ELECTRICAL ABBREVIATIONS POWER & LIGHTING LEGEND AUXILIARY LEGEND ALL ABBREVIATIONS SHOWN MAY NOT APPEAR IN DRAWINGS. ALL ABBREVIATIONS SHOWN MAY NOT APPEAR IN DRAWINGS. ALL SYMBOLS SHOWN MAY NOT APPEAR IN DRAWINGS. MAXIMUM MAIN CIRCUIT BREAKER FIXTURE STRIP, OVERHEAD / WALL MOUNTED. AMPERE MOTOR CONTROL CENTER 1000 CIRCULAR MILS FIXTURE STRIP, OVERHEAD / WALL MOUNTED, EMERGENCY. ALTERNATING CURRENT MECH MECHANICAL AIR CONDITIONING MANHOLE \square/\square FIXTURE, 2X2, 1X4, 2X4. ABOVE FINISH CEILING MINIMUM ABOVE FINISH FLOOR MISCELLANEOUS FIXTURE, 2X2, 1X4, 2X4. W/ BATTERY BACKUP. MAIN LUGS ONLY ABOVE FINISH GRADE AMPERE INTERRUPTING CAPACITY MANUFACTURER ALUMINUM MOUNTED EMERGENCY BATTERY PACK FIXTURE, WALL / CEILING MOUNTED. APPROXIMATE(L) MOUNTING ARCHITECT(URAL MANUAL TRANSFER SWITCH $\phi/\emptyset/Q$ FIXTURE, SURFACE MTD. / RECESSED / WALL MOUNTED. NEUTRAL NOT APPLICABLE AUTOMATIC TRANSFER SWITCH AMERICAN WIRE GAGE NORMALLY CLOSED ♦/﴿ FIXTURE, SURFACE MTD. / RECESSED / WALL MOUNTED. W/ BATTERY BACKUP. NATIONAL ELECTRICAL CODE NATIONAL ELECTRICAL MANUFACTURER'S ASSO. BACKBOARD FIRE ALARM AUXILIARY RELAY. EXIT SIGN, CEILING/WALL MOUNTED W/BATTERY. PROVIDE ARROWS AS INDICATED NFPA N.I.C. NATIONAL FIRE PROTECTION ASSOCIATION NOT IN CONTRACT BUILDING CONDUIT NIGHT LIGHT SINGLE POLE TOGGLE SWITCH, 120/277V, 20A. 3'-10" AFF NORMALLY OPEN NO. OR # NUMBFR THREE-WAY TOGGLE SWITCH/FOUR-WAY TOGGLE SWITCH, 120/277V, 20A. 3'-10" AFF CONTROL OUTSIDE DIAMETER CURRENT TRANSFORMER CABLE TELEVISION MOTOR RATED SWITCH, VERIFY REQUIREMENT AND # OF POLES W/ EQUIPMENT POWER FACTOR COLD WATER PIPE PAD MOUNTED SWITCH FIRE ALARM CONTROL PANEL. SINGLE POLE, THREE POSITION MOMENTARY CONTACT, 120/277 V, 20A. 3'-10" AFF PAD_MOUNTED TRANSFORMER DIRECT BURIAL DIRECT CURRENT FIRE ALARM REMOTE PANEL DIMMER SWITCH. 120/277V, FLUOR/INC AND AMPERAGE AS REQUIRED. 3'-10" AFF DUAL ELEMENT TIME DELAY PROVIDE FURNISH AND INSTALL TELEPHONE/DATA OUTLET AND COVER PLATE. 18" AFF WITH 3/4" C. AAC/UNO POTENTIAL TRANSFORMER KEYED SWITCH. 120/277V, AMPERAGE AS REQUIRED. 3'-10" AFF DISCONNECT SWITCH POLYVINYL CHLORIDE PART WINDING LOW VOLTAGE SWITCH. 3'-10" AFF GARBAGE DISPOSAL REFERENCE - DOUBLE THROW RATED LOAD AMPERES OCCUPANCY SENSOR, 3'-10" AFF WALL/CEILING MTD. 3/4"C TO ACC/UNO JISHWASHER RIGID NONMETALLIC CONDUIT ELECTRICAL RANGE OCCUPANCY SENSOR, 3'-10" AFF DUAL RELAY FOR LIGHTING/EXHAUST FAN REFERIGERATOR RAIN TIGHT OCCUPANCY SENSOR, RELAY/POWER PACK, CONCEALED, ACCESSIBLE. LECTRICAL METALLIC TUBING SCCR SHORT CIRCUIT CURRENT RATING XPLOSION PROOF SCHEDULE EQUIPMENT SOFT DRAWN XISTING, REMOVE. SERVICE ENTRANCE ELECTRIC WATER COOLER SECONDARY PANEL, LIGHTING OR POWER AS SPECIFIED IN PANEL SCHEDULE. EXISTING, REPLACE WITH NEW INTERNATIONAL SYSTEM OF UNITS FUSED DISCONNECT SPECIFY AMP/POLE SINGLE LINE DIAGRAM FIRE ALARM SURFACE METALLIC RACEWAY FINISHED SOLID NEUTRAL NON-FUSED DISCONNECT SPECIFY AMP/POLE 46" AFF WITH 3/4"C TO AAF WITH DATA BUSHING. **SPECIFICATIONS** FULL LOAD AMPERES SINGLE POLE — DOUBLE THROW SINGLE POLE — SINGLE THROW MOTOR STARTER. NUMBER NEXT TO SYMBOL INDICATES SIZE, SEE SPECIFICATIONS FOR DESCRIPTION FLEXIBLE METAL CONDUIT WHEN SHOWN WITHIN BOUNDARY OF EQUIPMENT PROVIDED AS PART OF THE EQUIPMENT. STATIC TRANSFER SWITCH GAI VANIZED GROUND FAULT INTERRUPTER SWITCH BOARD COMBINATION NONFUSIBLE DISCONNECT SWITCH/MAGNETIC MOTOR STARTER IN NEMA 1 ENCLOSURE, GALVANIZED RIGID METAL CONDUIT SWITCHGEAR NUMBER NEXT TO SYMBOL INDICATES SIZE, SEE SPECIFICATIONS FOR DESCRIPTION GROUND FERMINAL BACKBOARD **ELECTRICAL DESIGNATIONS** HEAVY DUTY TELEPHONE EXHAUST FAN FURNISHED AND INSTALLED BY HVAC. REFER TO HANDHOLE TEMPERATURE MECHANICAL DWG'S FOR EXACT LOCATION AND ELECTRICAL REQUIREMENTS. HORSEPOWER TRANSIENT VOLTAGE SURGE SUPPRESSORS FIXTURE NOTE HIGH VOLTAGE SINGLE RECEPTACLE 120/277V, AMPERAGE AS REQUIRED. 1'-6" AFF HEATING/VENTILATION/AIR COND. UNDERWRITER'S LABORATORY HERTZ (CYCLES PER' SECOND) DUPLEX/QUAD RECEPTACLE OUTLET, 120/277V, 20A. 1'-6" AFF INSIDE DIAMETER VOLTS ALTERNATING CURRENT FIXTURE NOTE ISOLATED GROUND VOLTS DIRECT CURRENT INTERMEDIATE METAL CONDUIT VENTILATION ♠ /

B

DUPLEX/QUAD RECEPTACLE OUTLET, 120/277V, 20A. 6" ABOVE COUNTER U.N.O.

Outlier

ABOVE COUNTER U.N.O.

DUPLEX/QUAD RECEPTACLE OUTLET, 120/277V, 20A. 6" ABOVE COUNTER U.N.O.

DUPLEX/QUAD RECEPTACLE OUTLET, 120/277V, 20A. 6" ABOVE COUNTER U.N.O.

DUPLEX/QUAD RECEPTACLE OUTLET, 120/27V, 20A. 6" ABOVE COUNTER U.N.O.

DUPLEX/QUAD RECEPTACLE OUTLET, 120/27V, 20A. 6" ABOVE COUNTER U.N.O.

DUPLEX/QUAD REC JUNCTION BOX RECPT NOTE KILO (1000) ↑ ★ DUPLEX/QUAD RECEPTACLE OUTLET, ISOLATED GROUND, 120/277V, 20A. 1'-6" KILO ČIRCUĹAR MILS **WEATHERPROOF** WATERTIGHT KILO VOLT - AMPERES HOME RUN ● / 🖾 / 🖶 RECEPTACLE, FLOOR / CEILING FLUSH MOUNTED. 120/277V, 20A. PPA-5.6.7 LIQUIDTIGHT FLEXIBLE CONDUIT INCHES TWO GANG FLOOR BOX WITH ONE RECEPT AND PROVISION FOR DUAL COMM CABLE HOME RUN (ALTERNATE) WIREMOLD RFB2 MULTI-SERVICE RECESSED FLOOR BOX WITH BRASS COVERPLATE. LOW VOLTAGE FURNISH WITH ALL APPURTENANCES FOR COMPLETE SYS LESS COMM CABLING. PHASE—►III WIRE DESIGNATION TIC INDICATES NUMBER OF CONDUCTORS, 2-POLE SINGLE RECEPTACLE 240V, AMPERAGE AS REQUIRED. EX: 3#12 (PH), 1#12 (N) & 1#12 GND

TVSS RECEPTACLE DUPLEX RECEPTACLE, 120V, 20A. EQUAL TO PASS & SEYMOUR #5362WSP

("GF"=GROUND FAULT PROTECTED, "WP"= (WR & GF TYPE) WEATHER PROOF & GFI PROTECTED)

HVAC CONTROLS, 54" AFF U.N.O. WITH 3/4"C TO ACCESSIBLE CEILING. TSTAT WIRING BY HVAC

LIGHTING CONTACTOR. ELECTRICALLY HELD, 4-POLE MINIMUM WITH HOA SWITCH. COORDINATE ACTUAL NUMBER OF

POLES WITH NUMBER OF EXTERIOR LIGHTING CIRCUITS. COIL VOLTAGE SHALL MATCH PHOTOCELL OUTPUT

SPECIAL PURPOSE RECEPTACLE OUTLET, NEMA CONFIGURATION TO MATCH PLUG.

USE GF RATED BREAKER WHERE DEVICE IS NOT READILY ACCESSIBLE PER NEC

COMMUNICATIONS, TELEPHONE / COMPUTER BACKBOARD.

---- UNDERGROUND CONDUIT

ABOVE GROUND CONDUIT

FIRE ALARM MANUAL PULL STATION, 3'-10" AFF FIRE ALARM STROBE / HORN-STROBE, 7'-6" AFF FIRE ALARM STROBE / HORN-STROBE. CEILING MOUNTED. FIRE ALARM SMOKE DETECTOR, CEILING MOUNTED. FIRE ALARM DUCT-MOUNTED SMOKE DETECTOR W/ SAMPLING TUBE. FIRE ALARM REMOTE TEST STATION, 3'-10" AFF FIRE ALARM HEAT DETECTOR. CEILING MOUNTED. MONITOR MODULE FOR AUXILIARY CONTROL FIRE ALARM FIRE SPRINKLER SYSTEM VALVE TAMPER SWITCH

FIRE ALARM FIRE SPRINKLER SYSTEM FLOW SWITCH

WALL MOUNTED TELEPHONE, MOUNT 60" AFF/UNO COMBINATION DATA/TELEPHONE OUTLET AND COVER PLATE. 18" ACC WITH

DATA OUTLET AND COVER PLATE, MOUNTED ON COLUMN OR POWER POLE, FLOOR BOX, ROUND WITH DUPLEX RECEPTACLE, TELEPHONE AND DATA OUTLET.

FLOOR BOX COVER SHALL BE BRASS WITH HINGED COVERS FOR DEVICES. ("2D"= DUAL DATA OUTLET, "4D"= QUAD DATA OUTLET) CATV OUTLET SINGLE GANG BOX WITH 3/4" C TO AAF. VERIFY HEIGHT

AUDIO SYSTEM SPEAKER. FURNISHED AND INSTALLED BY OTHERS. AUDIO VOLUME CONTROL. SINGLE GANG EMPTY OUTLET INSTALLED AT

SECURITY CAMERA. PROVIDE ROUGH-IN OUTLET ONLY WITH 3/4"C TO SERVER ROOM IN DESIGNATED AREA ALLOCATED FOR CAMERA HEADEND EQUIPMENT.

TYPE 'A' FIXTURE (SEE FIXTURE SCHEDULE). CIRCUIT NO. 2 (TYP) TYPE 'A' FIXTURE (SEE FIXTURE SCHEDULE). CIRCUIT NO. 2 (TYP) WALL OUTLET WITH RECEPTACLE NOTED, CONNECT TO CIRCUIT NO. 2 (TYP) HOMERUN (TYP) TO PANEL 'PPA'. CONNECT TO CIRCUIT NO.'S "5. 6. & 7" EX: 3#12 (PH), 1#12 (N) & 1#12 GND HOMERUN USING 2#8, EX: 3#12 (PH), 1#12 (N) & 1#12 GND

NOTES:

- 1. "NL" DESIGNATION REQUIRES FIXTURE TO BE CONFIGURED FOR ONE LAMP OPERATIONAL AT ALL TIMES.
- 2. ALL CIRCUITS SHALL CONTAIN A GREEN EQUIPMENT GROUNDING CONDUCTOR.
- 3. EQUIPMENT GROUND CONDUCTOR SHALL BE AS FOLLOWS UNLESS OTHERWISE INDICATED: #12 AWG CIRCUIT - #12 GND #10 AWG CIRCUIT - #10 GND # 8 AWG CIRCUIT - #10 GND
- 4. UNLESS OTHERWISE INDICATED, CONDUIT SIZE SHALL BE 3/4" MIN. AND SHALL NOT EXCEED A FILL OF 40% MAXIMUM, SEE NEC.

OF CIRCUIT CONDUCTORS — SIZE OF CIRCUIT CONDUCTORS "AWG" SIZE OF GROUNDING CONDUCTOR "AWG"

ELECTRICAL NOTES


- THE ELECTRICAL CONTRACTOR IS RESPONSIBLE FOR OBTAINING AND PAYING ALL REQUIRED PERMITS AND INSPECTION CERTIFICATES.
- ALL WORK SHALL COMPLY WITH IBC 2018, NEC 2017, STATE AND LOCAL CODES WHERE APPLICABLE. VERIFY WITH AUTHORITY HAVING JURISDICTION AND COMPLY AS REQUIRED.
- OMISSIONS OR MISDESCRIPTION OF DETAILS OF WORK WHICH ARE EVIDENTLY NECESSARY TO CARRY OUT THE INTENT OF THE DRAWINGS, OR WHICH ARE CUSTOMARILY PERFORMED, SHALL NOT RELIEVE THE CONTRACTOR FROM PERFORMING SUCH OMISSIONS AND DETAILS OF WORK, BUT THEY SHALL BE PERFORMED AS IF FULLY AND CORRECTLY SET FORTH &
- EQUIPMENT, MATERIALS, AND INSTALLATION SHALL BE GUARANTEED FOR A PERIOD OF ONE (1) YEAR FROM DATE OF ACCEPTANCE. DEFECTS WHICH APPEAR DURING THIS PERIOD SHALL BE CORRECTED AT THE EXPENSE OF THE ELECTRICAL
- MATERIALS AND ALL COMPONENTS THEREOF SHALL BE NEW AND SHALL BE UL APPROVED WHERE A STANDARD HAS BEEN ESTABLISHED. COMPONENTS SHALL BE EQUAL TO THOSE SCHEDULED ON DRAWINGS.
- ALL RACEWAY EXPOSED ON THE EXTERIOR SHALL BE RIGID GALVANIZED STEEL "RGS" OR "IMC". EMT SHALL NOT BE ACCEPTABLE. COORDINATE WITH ARCHITECT IF FINISH PAINTING SHALL BE REQUIRED.
- 7. VERIFY FIELD DIMENSIONS. COORDINATE WORK WITH OTHER TRADES TO AVOID INTERFERENCES.
- ALL EXIT AND EMERGENCY LIGHTS SHALL BE UNSWITCHED AND SHALL BE SERVED FROM THE SAME CIRCUIT AS THE GENERAL LIGHTING IN THE SAME AREA U.N.O.
- 9. ALL ELECTRICAL PANELS SHALL HAVE ENGRAVED LAMINATED (BLACK ON WHITE) LABELS IDENTIFYING THEM AS INDICATED
- 10. ENSURE THAT ALL PENETRATIONS OF FIRE WALLS AND DECKS ARE PROPERLY SEALED PER IBC, ANY APPLICABLE UL
- 11. COLOR OF WIRING DEVICES AND PLATES SHALL BE AS SELECTED BY THE ARCHITECT.

ASSEMBLIES, AND THE SPECIFICATIONS.


- COORDINATE LAYOUT CAREFULLY WITH SYSTEMS FURNITURE AND MILLWORK SHOP DRAWINGS PRIOR TO ROUGHING IN POWER AND COMMUNICATIONS OUTLETS TO ENSURE PROPER ORIENTATION OF OUTLETS WITH COMPONENTS OF THESE
- 13. AVOID PENETRATING THE OUTER SKIN OF METAL BUILDING WALLS AND ROOF. MOUNT EQUIPMENT ON STRUCTURAL COLUMNS AND PURLINS WHERE POSSIBLE. PROVIDE MOUNTING STRUT BETWEEN STRUCTURAL MEMBERS WHERE NECESSARY. FOR ANY UNAVOIDABLE ROOF PENETRATION, ENSURE THAT METAL BUILDING MANUFACTURER'S ROOF WARRANTY REQUIREMENTS ARE SATISFIED.
- 14. CONDUCTOR SIZES INDICATED ON THE DRAWINGS HAVE BEEN SELECTED TO PROVIDE FOR ACCEPTABLE VOLTAGE DROP. DO NOT REDUCE WIRE SIZES SHOWN WITHOUT CONSENT OF ENGINEER.
- 15. CONDUCTORS SHALL BE SINGLE CONDUCTOR COPPER, STRANDED FOR AWG #8 AND LARGER AND SOLID FOR AWG #10 AND SMALLER, WITH 600 VOLT THHN INSULATION.
- 16. ALL CONDUCTORS SHALL BE INSTALLED IN METALLIC CONDUIT. PVC SCHEDULE 40, MAY BE INSTALLED BELOW GRADE WITH TRANSITIONS TO PVC SCH 80 IF CONCEALED WALL OR "RGS" IF EXPOSED ABOVE GRADE.
- 17. THE USE OF MC CABLE IS PERMISSIBLE ONLY IN CONCEALED LOCATIONS AND FOR FLEXIBLE CONNECTIONS TO LIGHTING
- 18. THE LOCATION OF OUTLETS AND EQUIPMENT SHOWN ON THE DRAWINGS ARE APPROXIMATE AND THE OWNER SHALL HAVE
- THE RIGHT TO RELOCATE ANY OUTLETS OR FIXTURES BEFORE THEY ARE INSTALLED WITHOUT ANY ADDITIONAL COST.
- 19. TELECOM OUTLETS WHERE INSTALLED ADJACENT TO RECEPTACLE OUTLETS, SHALL HAVE UNIFORM SPACING BETWEEN RESPECTIVE DEVICES. E.C. SHALL UTILIZE MOUNTING PROVISIONS BETWEEN STUDS. IF REQUIRED. TO MAINTAIN THIS





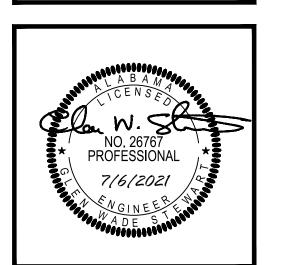

PHASE 1 DRAWINGS FOR ORANGE BEACH SHOP / WILDLIFE CENTER ORANGE BEACH

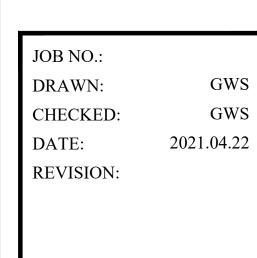


SCALE: AS SHOWN

SHEET NO.:

E1.1

POWER & AUX PLAN
BASE BID

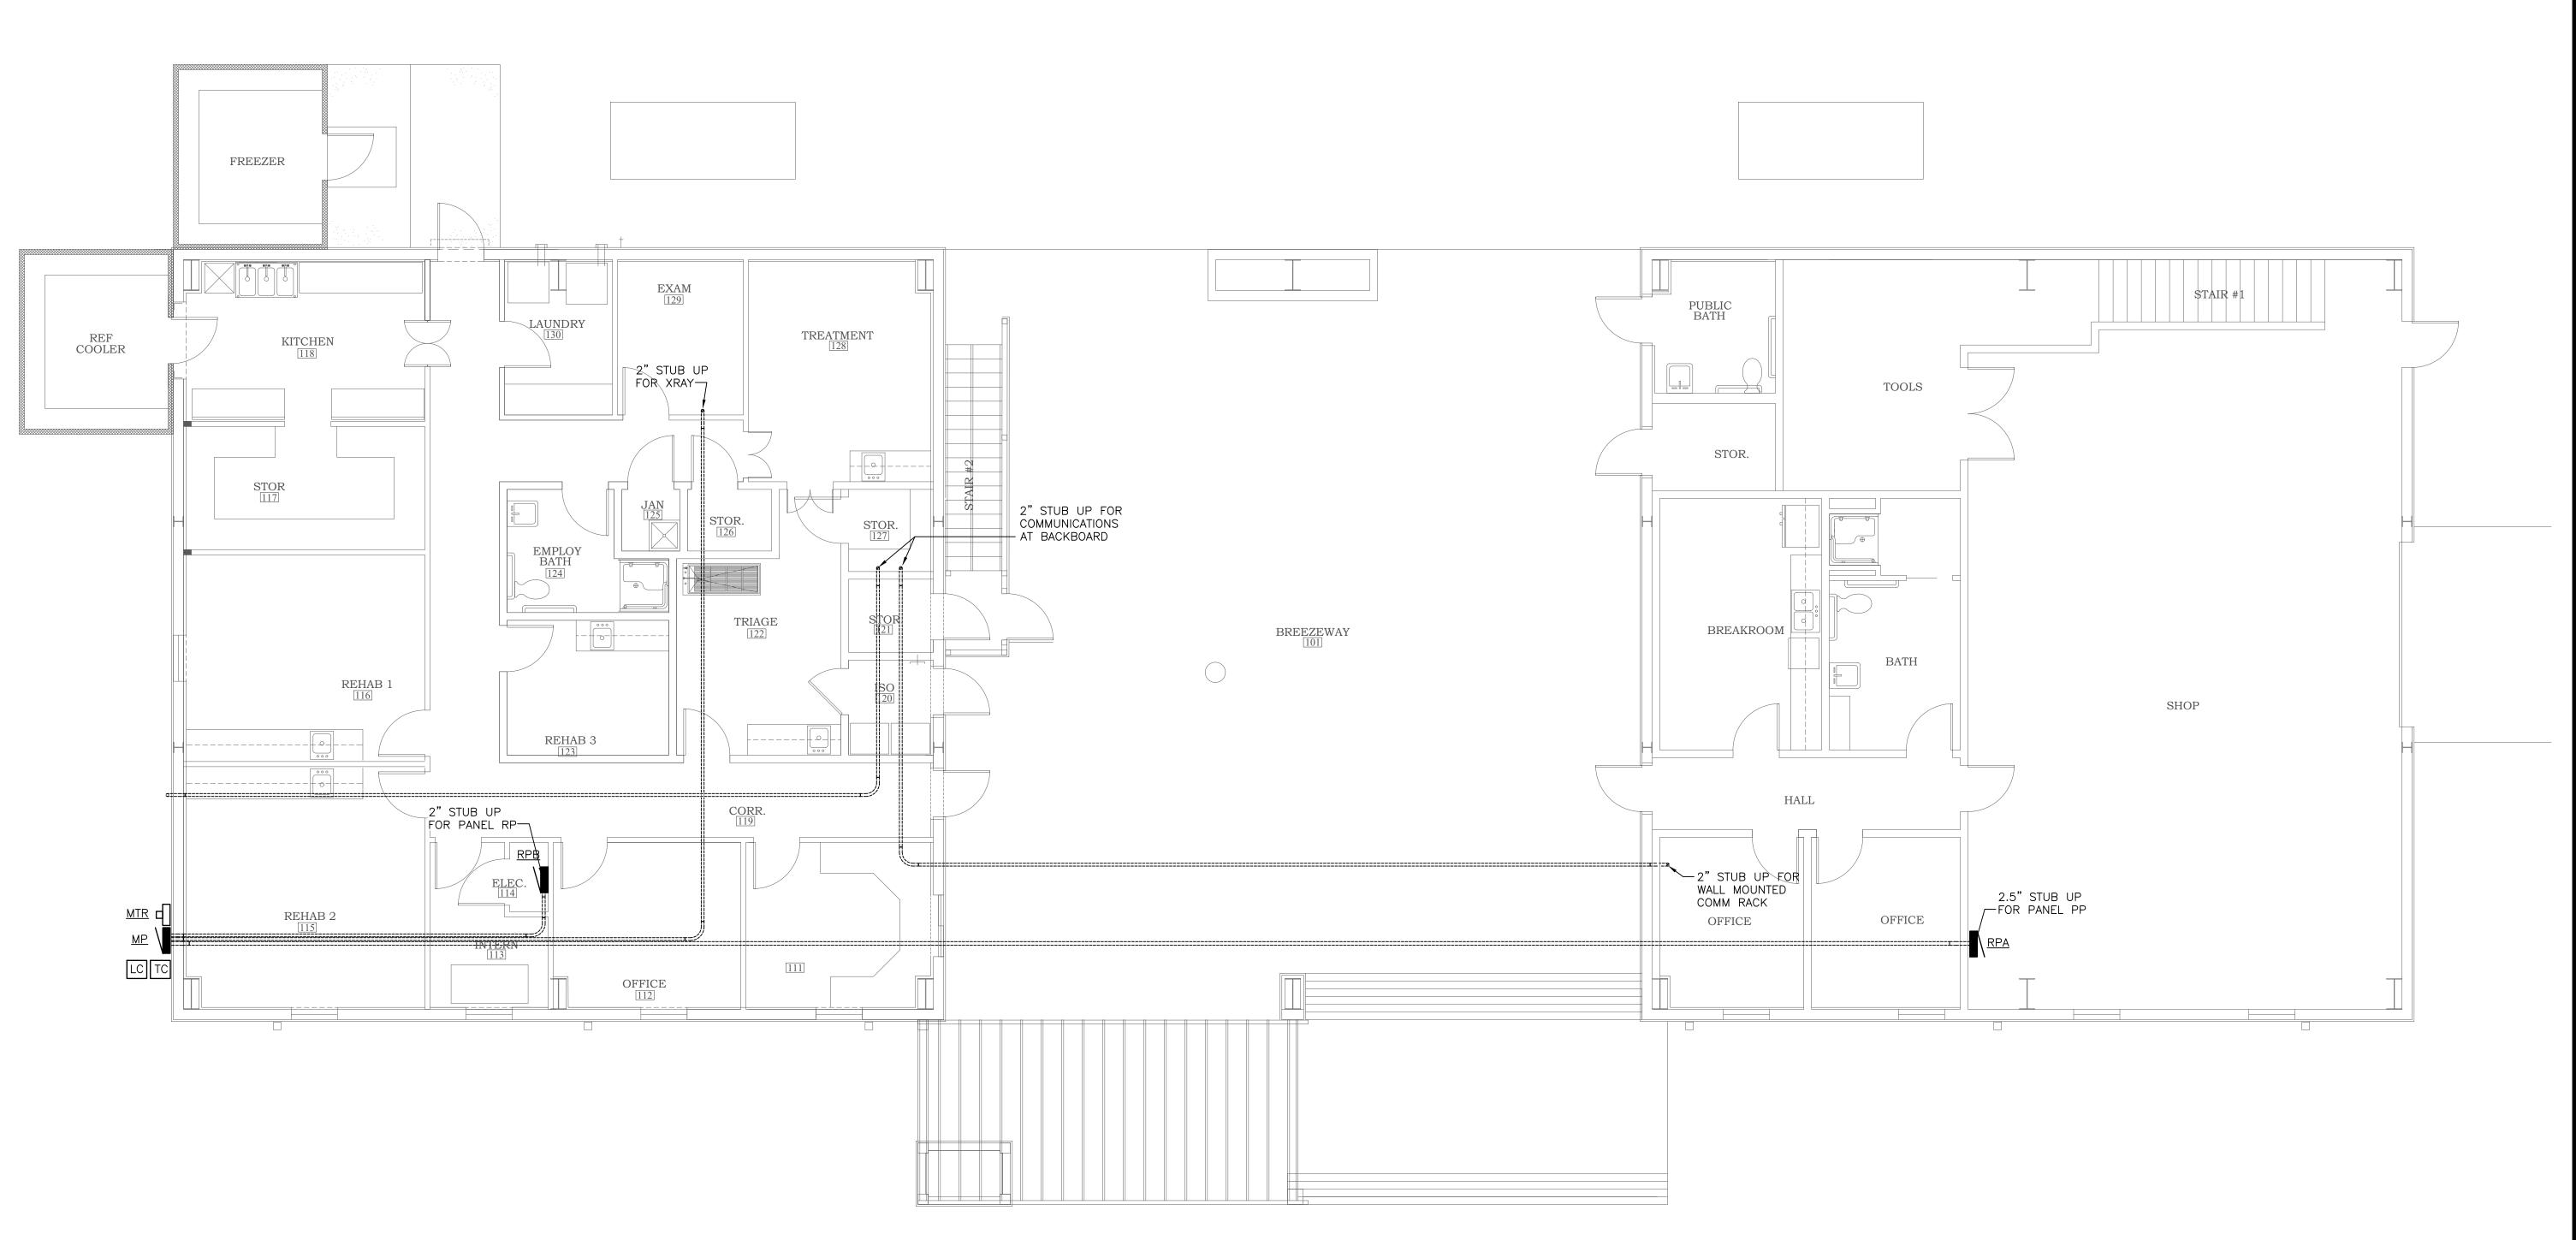

POWER & AUX. PHASE ONE:

- PIPING LAYOUT IS APPROXIMATE. COORDINATE WITH DIMENSIONED ARCHITECTURAL FLOOR PLANS FOR CONDUIT STUB UP LOCATIONS.
- 2. CONTRACTOR SHALL COORDINATE WITH ALL TRADES WITH RESPECT TO ROUTING AND CLEARANCES. PROVIDING OFFSETS, DROPS, RISES, ETC. AS REQUIRED TO ACCOMMODATE.
- 3. CONTRACTOR TO INCLUDE FEEDER CONDUIT FROM MP TO AHU-1 BELOW GRADE AND STUB UP AT COORDINATED LOCATION





PHASE 1 DRAWINGS FOR ORANGE BEACH 'RAIL SHOP / WILDLIFE CENTER


JOB NO.:
DRAWN: GWS
CHECKED: GWS
DATE: 2021.04.22
REVISION:

SCALE: AS SHOWN


SHEET NO.:

PHASE 1

E1.2

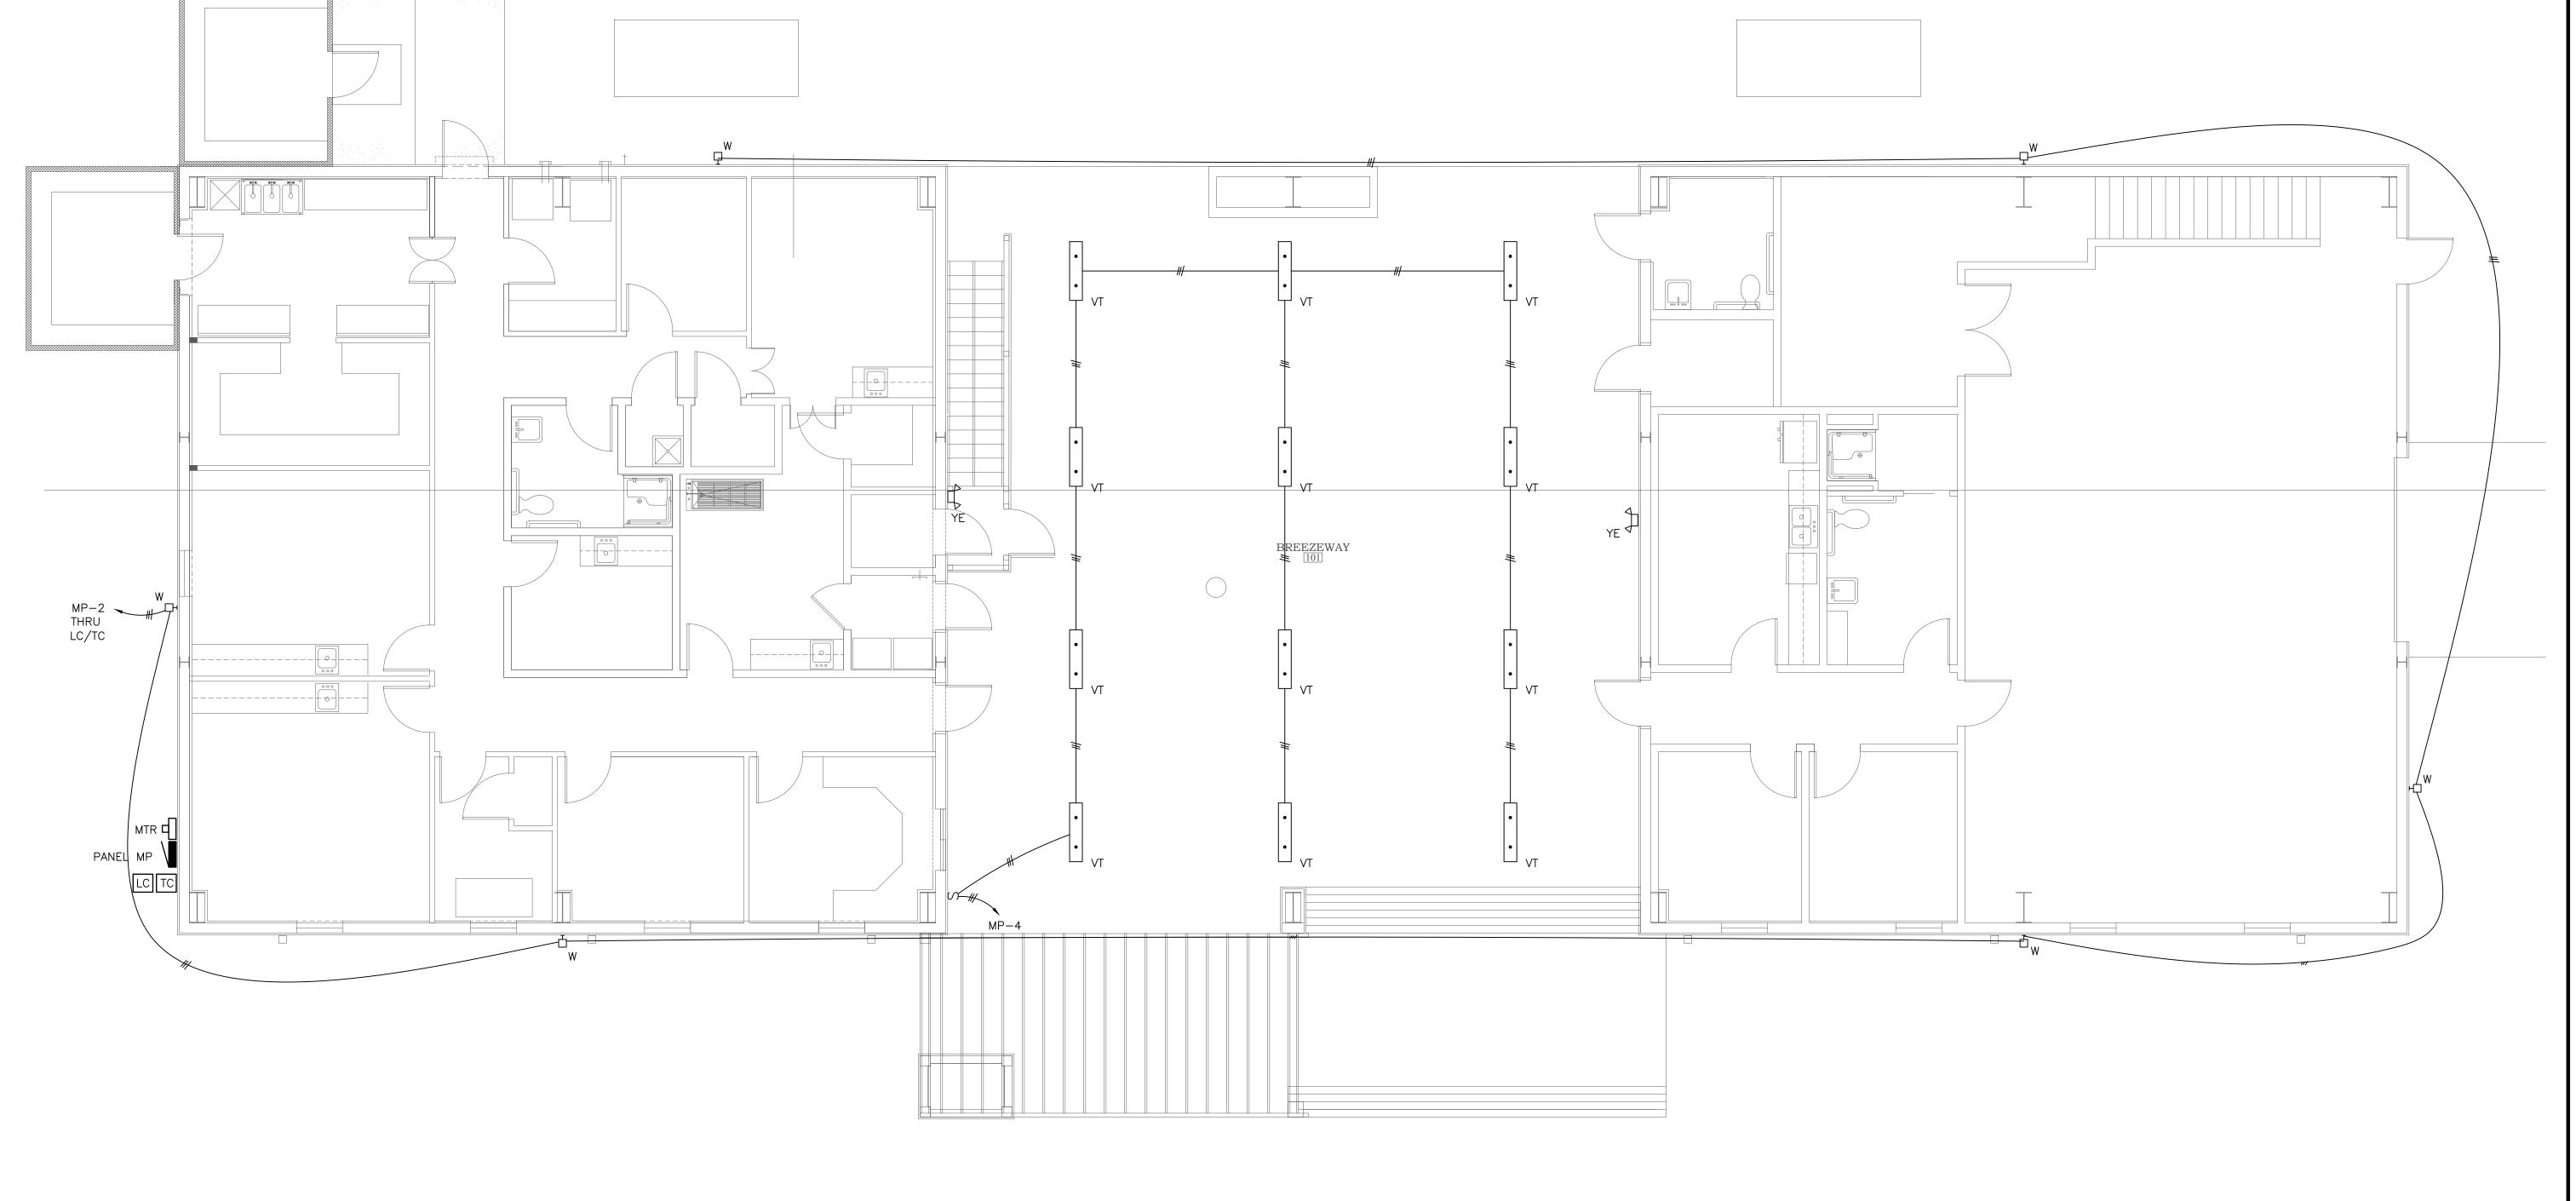



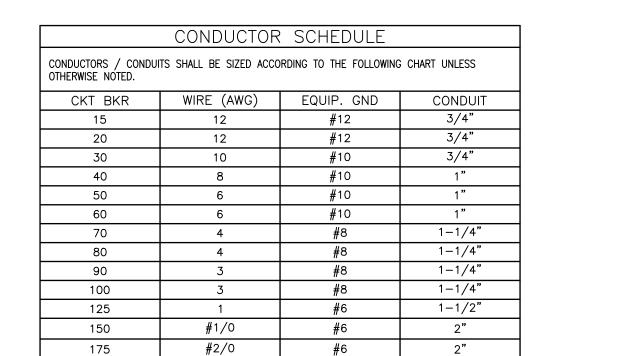

#4

#4

2"

2-1/2"

3**"**

400 600KCMIL I. NEUTRAL CONDUCTOR (IF REQUIRED) SHALL BE THE SAME SIZE AS PHASE CONDUCTORS. 2. ALL HVAC OR OTHER CYCLICAL EQUIPMENT SHALL UTILIZE HACR TYPE CIRCUIT BREAKERS. 3. CONTRACTOR TO PROVIDE QUANTITY OF CONDUCTORS AS NECESSARY TO 4. CONDUIT SIZES BASES ON FOUR CONDUCTORS MAXIMUM. CONTRACTOR SHALL FOLLOW NEC GUIDELINES FOR DERATING AMPACITIES AND CONDUIT SIZES FOR ALL COMBINED CIRCUITS. 5. CONDUCTORS SHALL BE COPPER. INDICATED SIZES ARE FOR USE WITH COPPER CONDUCTORS 6. FOR BREAKERS SIZES NOT INDICATED SUCH AS 25A, COMPLY WITH NEC SECTION 240.4 (PROTECTION OF CONDUCTORS.) 7. CONTRACTOR SHALL COORDINATE THE REQUIRED NUMBER OF CONDUCTORS WITH EQUIPMENT MFR PRIOR TO ROUGH IN.

#3/0


#4/0

250KCMIL

200


225

250

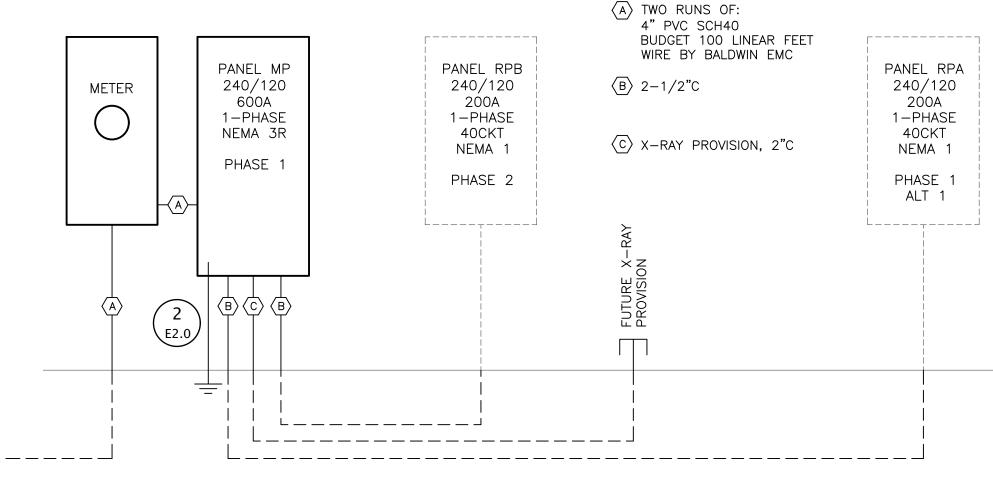

ELECTRICAL RISER


₹ E2.0 SCALE: NONE

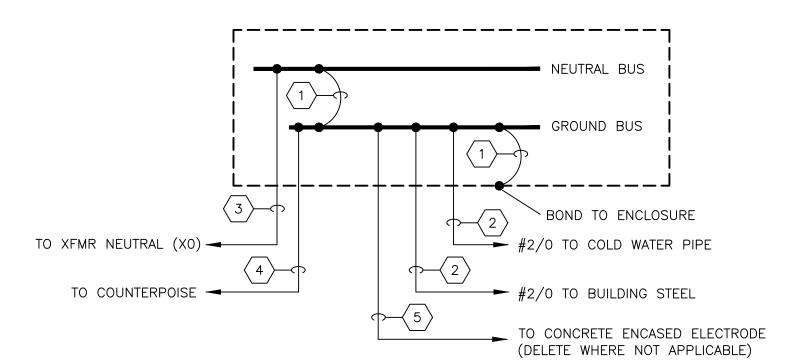

- 1) #2/0 MAIN BONDING JUMPER
- $\langle 2 \rangle$ #2/0 GROUNDING ELECTRODE BONDING JUMPER CONNECTION
- 3 SAME SIZE AS PHASE CONDUCTOR
- SUPPLEMENTAL GROUNDING ELECTRODE BONDING JUMPER SIZED AT #6 AWG (SIZE PER NEC 250.66 IF WATER PIPE AND BLDG. STEEL NOT AVAILABLE)
- 5 SIZE PER NEC 250.66 BUT NO LARGER THAN #4 THHN



				_	LIC	SHTING FIX	TURE SCHEDULE	_											
		ELECT	RICAL DATA	L	AMP DATA	BASIS OF DESIGN			MOUNT TO LOCATION						TYPE ARRANGEMENT				
ID	DESCRIPTION	LOAD VA	VOLTAGE	QTY	LUMENS	MANUFACTURER	MODEL OR SERIES	CEILING	FLOOR	GROUND	POLE	SUSPENDED	WALL	FLUSH	PEDESTAL	PENDANT	RECESSED	SURFACE	TRACK
А	DOWN LIGHT	20	120	1-1	1500	LITHONIA	LDN6 40/15 LO6AR LS												
В	DOWN LIGHT	20	120	1-1	2000	LITHONIA	LDN6 40/20 LO6AR LS												
BE	DOWN LIGHT	20	120	-	2000	LITHONIA	LDN6 40/20 LO6AR LS ELSD												
С	STRIP	15	120	-	1500	LITHONIA	ZL1N L24 1500LM FST MVOLT 4000K 80 WH												
D	2X4 TROFFER	49	120		5400	LITHONIA	EPANL 2X4 5400 80CRI 40K												
DE	2X4 TROFFER	49	120		5400	LITHONIA	EPANL 2X4 5400 80CRI 40K E10WCP												
F	2X2 TROFFER	31	120		3400	LITHONIA	EPANL 2X2 3400 80CRI 40K												
FE	2X2 TROFFER	31	120		3400	LITHONIA	EPANL 2X2 3400 80CRI 40K E10WCP												
٧	VANITY	20	120	T - T	-		ALLOWANCE \$150												
VT	VAPORTIGHT	116	120		15000	LITHONIA	VAP 15000LM PCL WD 40K 80CRI												
W	WALL PACK	30	120	-	4000	LITHONIA	ARC2 LED P4 40K MVOLT DDBXD												
RE	REMOTE EGRESS	6	120	_	_	EMERGI-LITE	EF44-2-LED-WP												
YE	EMERGENCY LIGHT	1	120		-	EMERGI-LITE	EL-2LED (LITE-2-LG-FINISH-N)												
ZE	EXIT/EMER. COMBO	1	120		_	EMERGI-LITE	ELXN400-G-2LED-R												

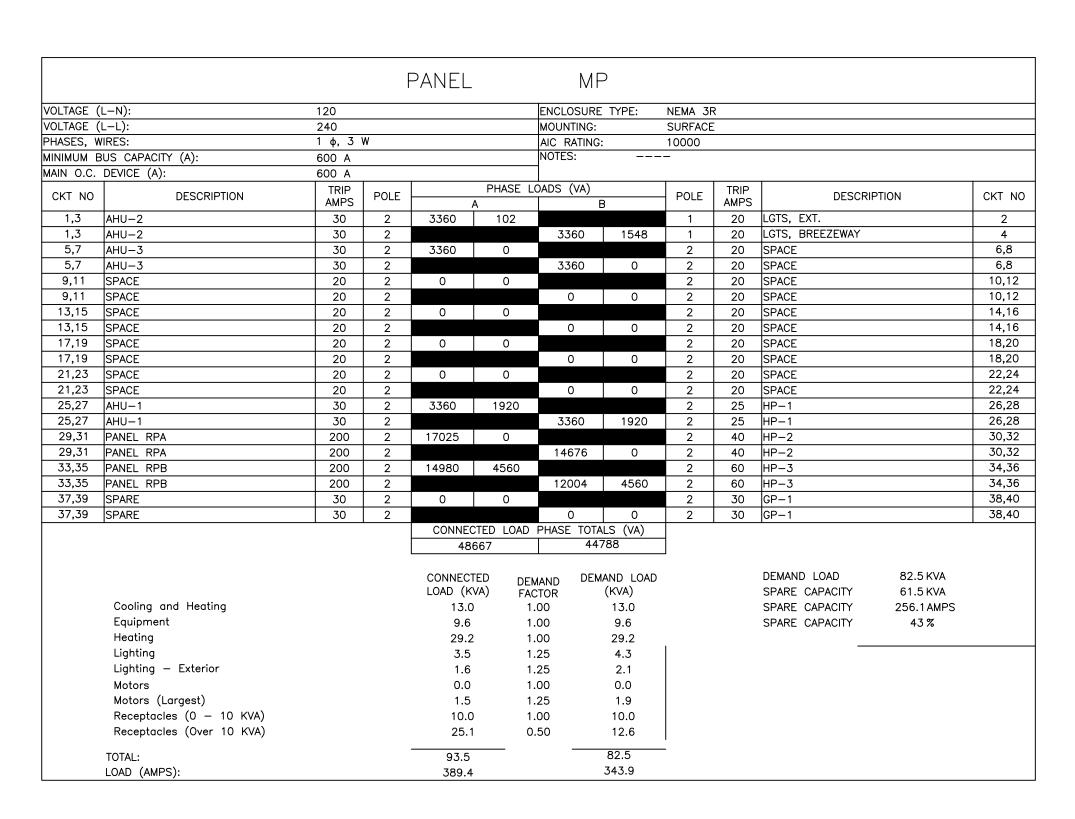


			Ť	PANEL	-	RP	А				
OLTAGE (L-N):	120				ENCLOSURE	TYPE:	NEMA 1			
/OLTAGE (L-L):	240				MOUNTING:		SURFACE	-		
HASES, W	/IRES:	1 φ, 3	W			AIC RATING	:	10000			
IINIMUM E	BUS CAPACITY (A):	200 A				NOTES:		-			
MAIN O.C.	DEVICE (A):	200 A									
CKT NO	DESCRIPTION	TRIP AMPS	POLE		PHASE L A	OADS (VA)	В	POLE	TRIP AMPS	DESCRIPTION	CKT N
1	LGTS, 101-109	20	1	399	1130			1	20	LGTS, 110	2
3	LGTS, BREEZEWAY	20	1			0	0	1	20	LGTS, EXTERIOR	4
5	SPARE	20	1	0	0			1	20	SPARE	6
7	REC, 102-4	20	1			1260	800	1	20	REC, 105/107/109	8
9	REC, 105 REF	20	1	1500	1500			1	20	REC, 105 CNTR	10
11	REC, 105 GARBAGE DISP.	20	1			500	1500	1	20	REC, 105 CNTR	12
13	REC, 105 CNTR	20	1	1500	1500			1	20	REC, 105 CNTR	14
15	REC, 106	20	1			1500	200	1	20	REC, 108	16
17	REC, EXT. & MEZZ	20	1	400	180			1	20	REC, WORK SHOP	18
19	REC, WORK SHOP	20	1			180	180	1	20	REC, WORK SHOP	20
21	REC, WORK SHOP	20	1	180	180			1	20	REC, WORK SHOP	22
23	REC, WORK SHOP	20	1			180	200	1	20	REC, WORK SHOP	24
25	REC, WORK SHOP	20	1	200	200			1	20	REC, WORK SHOP	26
27	REC, WORK SHOP	20	1			200	180	1	20	REC, TOOL RM	28
29	REC, BREEZEWAY TV	20	1	180	180			1	20	REC, TOOL RM	30
31	SPARE	20	1			0	0	1	20	SPARE	32
33,35	SPARE	30	2	0	746			2	20	VF-1	34,36
33,35	SPARE	30	2			0	746	2	20	VF-1	34,36
37,39	EWH-1	30	2	2250	4800			2	50	WELDER	38,40
37,39	EWH-1	30	2			2250	4800	2	50	WELDER	38,40
				CONNE	CTED LOAD	PHASE TOTA					
				17	025	14	676				
				CONNEC LOAD (K		MAND DEN	MAND LOAD (KVA)			DEMAND LOAD 30.2 KVA SPARE CAPACITY 17.8 KVA	
	Equipment			9.6		.00	9.6			SPARE CAPACITY 74.3 AMPS	
	Heating			4.5	1	.00	4.5			SPARE CAPACITY 37 %	
	Lighting			1.5	1	.25	1.9				
	Motors			0.0		.00	0.0				
	Motors (Largest)			1.5	1	.25	1.9				
	Receptacles (0 — 10 KVA)			10.0) 1	.00	10.0				
	Receptacles (Over 10 KVA)			4.6	0	.50	2.3				
	TOTAL:			31.7			30.2	_			
	LOAD (AMPS):			132.1	1		125.7				

PANELBOARD SCHEDULE AND DETAIL NOTES:

- PANELBOARD & PANELBOARD INSTALLATION SHALL BE IN ACCORDANCE WITH NFPA 70, ART. 384. ALL PANELBOARDS SHALL BE UL LISTED AND INSTALLED IN ACCORDANCE WITH THIS LISTING AND FULLY SUPPORTED BY MEANS DESIGNED FOR THAT LISTED INSTALLATION. ALL CLEARANCES REQUIRED BY CODE SHALL BE MAINTAINED AS MINIMUM.
- 2. EACH PANELBOARD SHALL BE FURNISHED COMPLETE WITH THE PROPERLY SIZED CAN, INTERNAL HARDWARD, DEVICES, COMPONENTS, SUPPORTING STRUCTURES, ETC., FOR A COMPLETE INSTALLATION TO PROVIDE THE DESIGNED PERFORMANCE UNDER THE AMBIENT CONDITIONS ENCOUNTERED. ALL DEVICES, COMPONENTS, FITTINGS, SUPPORTS, ETC., SHALL BE COORDINATED TO PROVIDE A COMPLETE UL LISTED INSTALLATION. ALL DEVICES INSTALLED SHALL HAVE AN INTERRUPTING RATING GREATER THAN OR EQUAL TO THE SPECIFIED SCCR.
- 3. EACH PANELBOARD SHALL BE FURNISHED WITH A GROUND BAR BONDED TO THE PANEL ENCLOSURE. THIS GROUND BUS SHALL BE UTILIZED TO BOND ALL GROUNDING PROVISIONS IN ORDER TO ESTABLISH EQUAL POTENTIAL TO ALL GROUNDED COMPONENTS OF THE POWER SYSTEM.
- 4. PANELBOARD CANS SHALL BE RIGID AND CONTAIN KNOCKOUT PROVISIONS TO FACILITATE THE TERMINATION OF THE NUMBER AND SIZE OF CONDUIT SYSTEMS REQUIRED.
- 5. THE TERMINATION POINT OF THE FEEDER SERVING EACH ASSEMBLY SHALL BE AT THE NEAREST POINT OF FEEDER ENTRY TO MINIMIZE CONDUCTOR FILL IN THE CAN. COORDINATE TOP AND BOTTOM FEED PANELBOARD PROVISIONS WITH EACH FEEDER INSTALLATION.
- 6. PROVIDE THE PROPERLY SIZED CONDUCTOR TERMINATION POINTS OR LUGS (MULTIPLE LUGS WHEN PARALLEL FEEDERS ARE USED) FOR THE NUMBER AND SIZE CIRCUITS INDICATED.
- 7. CONDUCTORS, SPLICES AND TERMINATIONS SHALL BE ACCESSIBLE. ONLY CONDUCTORS RATED AND SIZED FOR THE TEMPERATURE OF THE TERMINATION SHALL BE USED.
- 8. PANELBOARDS SHALL NOT BE INSTALLED IN CONTACT WITH COMBUSTIBLE MATERIALS. ADEQUATE SPACE FOR AIR CIRCULATION AND CODE COMPLIANCE SHALL BE PROVIDED AS A MINIMUM. FURNISH SPACERS, WASHERS, SUPPORTING DEVICES, ETC., AS REQUIRED TO MAINTAIN PROPER CLEARANCES.
- 9. ALL FLUSH MOUNTED PANELBOARDS SHALL BE PROVIDED WITH FOUR (4) 1" EMPLY SPARE CONDUITS TO ABOE THE NEAREST ACCESSIBLE CEILING.

McCollough Architecture, Inc. P.O. BOX 6310 GULF SHORES, ALABAMA 36547-6310 PHONE: 251-968-7222

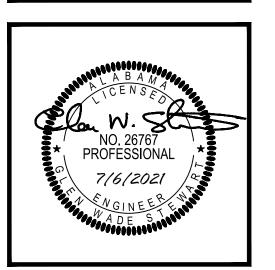

PHASE 1 DRAWINGS FOR

ORANGE BEACH

(PRAIL SHOP / WILDLIFE CENTE)

JOB NO.:
DRAWN: GWS
CHECKED: GWS
DATE: 2021.04.22
REVISION:

AS SHOWN

SHEET NO.:

SCALE:

E3.0

ELECTRICAL RISER AND DETAILS

PLUMBING SYMBOL LEGEND

	DCW PIPING
	DHW PIPING
	DHC PIPING
SAN	WASTE PIPING
- V - -	VENT PIPING
—— G ——	GAS PIPING
— ТР —	TRAP PRIMER PIPING
 0	PIPE TURNING UP
 ə	PIPE TURNING DOWN
	BALL VALVE
$\longrightarrow \!$	GATE VALVE
	CHECK VALVE
4	TEMP/PRESSURE RELIEF VALVE
—	GAS COCK
 	UNION
O -	CLEANOUT
—— FD	FLOOR DRAIN
	FLOOR SINK
ഥ	HOSE BIBB
P wha	WATER HAMMER ARRESTOR TYPE "A" (TYP)

PLUMBING ABBREVIATIONS

ALL ABBREVIATIONS SHOWN MAY NOT APPEAR IN DRAWINGS.
REFER TO HVAC DRAWINGS FOR HVAC EQUIPMENT ABBREVIATIONS.

	EVIATIONS SHOWN MAY NOT A D HVAC DRAWINGS FOR HVAC
AFF	ABOVE FINISHED FLOOR
AUX	AUXILIARY
CEIL	CEILING
CIRC	CIRCULATING
CO	CLEANOUT
CW	COLD WATER
DCW	DOMESTIC COLD WATER
DHC	DOMESTIC HOT CIRCULATED
DHW	DOMESTIC HOT WATER
DIA	DIAMETER
DST	DEEP SEAL TRAP
EQUIP	EQUIPMENT
EWC	ELECTRIC WATER COOLER
EWH	ELECTRIC WATER HEATER
FCO	FLOOR CLEANOUT
FD	FLOOR DRAIN
FIXT	FIXTURE
GWH	GAS WATER HEATER
HB	HOSE BIBB
HR	HOUR
HW	HOT WATER
HWR	HOT WATER RETURN
MAX	MAXIMUM
MECH	MECHANICAL
MIN	MINIMUM
MTR	METER
NIC	NOT IN CONTRACT
PENE	PENETRATION
RM	ROOM
SAN	SANITARY
SURF	SURFACE
SYS	SYSTEM
T & P	TEMPERATURE & PRESSURE
TEMP	TEMPERATURE
TP	TRAP PRIMER
TYP	TYPICAL
VTR	VENT TO ROOF

WALL CLEANOUT

WALL HYDRANT

YARD CLEANOUT

WATER HAMMER ARRESTOR

WET PIPNG

WITH

ID	DESCRIPTION
CB-1	ICE MAKER WATER CONNECTION. USE SIOUX CHIEF ICE MAKER OUTLET BOX WITH MINIRESTER 696 SERIES WITH 1/2" PEX CONNECTION; MOUNT @ 48" U.N.O. FURNISH FLEXIBLE CONNECTION FROM OUTLET BOX TO WALL MOUNTED WATER FILTER WITH FLEXIBLE CONNECTION TO APPLICANCE. WATER FILTER SHALL BE EQUAL TO WHIRLPOOL WHKF-DWHV OR EQUAL. FURNISH WITH ONE EXTRA FILTER. VERIFY WITH OWNER/CONTRACTOR. APPLIANCES FURNISHED BY OTHERS.
EWC-1	EWC-1, ELECTRIC WATER COOLER, SPLIT LEVEL, WALL MOUNTED WITH BOTTLE FILLER ELKAY LZSTL8WSVRSK OR EQUAL WITH BOTTLE FILLER/FOUNTAIN ON LEFT AT ADA LEVEL; MCGUIRE 8902 TRAP; BRASSCRAFT 1912-A SUPPLY. MOUNT WITI LOWER SPOUT AT 36" AFF. CONNECTIONS: CW 1/2", WASTE 2", VENT 2" MIN.
FD-1	FLOOR DRAIN, J.R. SMITH 2005/2010 SERIES COATED CAST IRON BODY WITH ADJUSTABLE COLLAR, COMBINATION MEMBRANE CLAMP. PROVIDE WITH 6" ROUND, POLISHED NICKEL BRONZE STRAINER AND GREEN DRAIN TRAP SEAL.
HB-1	HOSE BIBB, OUTDOOR TYPE, ZURN Z-1320 WITH CERAMIC DISC, NON-FREEZE, ENCASED, ANTI-SIPHON, AUTO DRAIN, S.S. BOX & HINGED COVER, KEY LOCK, ALL BRONZE INTERIOR PARTS. COVER STAMPED "WATER".
MS-1	MOP BASIN — ZURN Z1996—24 COMPOSITE MOP SINK WITH INTEGRAL 3" DRAIN; Z1996—SF SERVICE FAUCET WITH PALE HOOK, —SDL DRAIN, STRAINER & LINT BASKET, —MH MOP HANGER, —HH HOSE & BRACKET, —BV VINYL BUMPER GUARDS —WG SS WALL GUARD. COORDINATE WITH GENERAL CONTRACTOR TO INSURE THAT 2" THICK BLOCKING IS PROVIDED IN WALL FOR FAUCET MOUNTING. CONNECTIONS: CW 1/2", HW 1/2" (140°F), WASTE 3", VENT 2" MIN.
SH-1	SHOWER, ARRAY ADA3636, W/ CENTER DRAIN AS DESIGNATED IN PLAN DWGS, SHOWER, SOLID—SURFACE, SMOOTH SHOWER, SOAP HOLDER, GRAB BARS, FOLDING SEAT, ZURN Z7301—SS—MT—DV2P—HW—H7—S8 TEMP—GARD III SHOWER UNIT KIT WITH SINGLE HANDLE PRESSURE BALANCING & MIXING UNIT, 1.5 GPM SHOWER HEAD, FLEX METAL HOSE, INLINI VACUUM BREAKER, WALL CONNECTION, FLANGE AND WALL HOOK FOR HAND SHOWER, PRESSURE BALANCING MIXING VALV WITH ADJUSTABLE STOP SCREW TO LIMIT HANDLE TURN, 2.5 GPM SHOWER HEAD WITH ARM AND FLANGE. CONNECTIONS CW 1/2", HW 1/2" TEMPERATURE LIMITING TO 110°F, WASTE 2", VENT 1—1/2" MIN.
SK-1	KITCHEN SINK, ELKAY CR3322, 20 GAUGE, STAINLESS STEEL, DOUBLE BOWL, 7" DEPTH, DROP IN TYPE, FURNISH WITH ELKAY LKD2437BHC GOOSENECK FAUCET WITH LEVER HANDLES AND GRID WASTE. PROVIDE 1-1/2" P-TRAP AT EXISTING SAN CONNECTION, NEW 1/4" FLEXIBLE SUPPLIES AND WATER STOPS. INCLUDE 1/4" FLEXIBLE SUPPLY CONNECTION TO REFRIGERATOR ICE MAKER UNIT. ROUTE TUBING CONCEALED IN BASE CABINET. STRAP TUBING TO REAR OF CABINET. EXISTING CONNECTIONS: CW 1/2", HW 1/2", WASTE 1 1/4". FURNISH WITH TEMPERATURE LIMITING DEVICE SET FOR 110°F
SK-3	3 COMPARTMENT SINK — PROVIDED BY OWNER, INSTALLED BY CONTRACTOR. COORDINATE EXACT REQUIREMENTS PRIOR TO ROUGH—IN.
WC-1H	WC-1H WATER CLOSET, ZURN SERIES Z5660, <u>FLOOR MOUNTED</u> , ELONGATED WATER CLOSET, ZURN Z6000AV-WS1 (1.6 gpf) FLUSH VALVE W/ SPLIT RING PIPE SUPPORT, & ZURN Z5955SS-EL OPEN FRONT SEAT WITHOUT COVER MOUNT FIXTURE AT ADA HEIGHT WITH RIM AT 16-3/4" AFF. CONNECTIONS: CW 1", WASTE 3", VENT 2" MIN.
FS-1	FLOOR SINK, MIFAB FS1520-FLC-3-P, 8" SQUARE, 6" DEEP, CAST IRON, A.R.E. INTERIOR ALUMINUM DOME STRAINER, STAINLESS STEEL TOP W/CLAMPING DEVICE. FURNISH WITH PRO-SET TRAP SEAL. COORDINATE EXACT LOCATION OF DRAIWITH ARCHITECTURAL PLANS SO AS TO CENTER FLOOR DRAIN CENTER OF TILE. FLOOR SHALL BE SLOPED TOWARD DRAIN.
HS-1	HAND SINK, ELKAY CR1721, 20 GAUGE, STAINLESS STEEL, SINGLE BOWL, DROP IN TYPE, FURNISH WITH ELKAY LK800GN05T4 GOOSENECK FAUCET WITH LEVER HANDLES AND GRID WASTE. PROVIDE 1-1/2" P-TRAP AT EXISTING SAN CONNECTION, NEW 1/4" FLEXIBLE SUPPLIES AND WATER STOPS. CONNECTIONS: CW 1/2", HW 1/2", WASTE 1 1/4". FURNISH WITH TEMPERATURE LIMITING DEVICE SET FOR 110°F
LV-1H	ZURN Z5840 SERIES WITH VITREOUS CHINA CONSTRUCTION AND 4" FAUCET CENTERS; ZURN Z81104—XL FAUCET WITH LEVER HANDLES, ZURN Z8800 SUPPLIES; ZURN Z8700 TRAP; Z8746—PC ADA GRID STRAINER; ZURN Z8946—3—NT ADA PROTECTORS, ASSE 1070 APPROVED TEMPERATURE LIMITING VALVE SET TO 110°F, ZURN Z1231 CONCEALED ARM CARRIED CONNECTIONS: CW 1/2", HW 1/2", WASTE 1 1/4". MOUNT AT 34" TOP OF RIM FOR ADA REQUIRED MOUNTING HEIGHT.
MV-1	MIXING VALVE, EQUAL TO SYMMONS, 0.5 GPM MINIMUM, 5.5 GPM MAXIMUM @ 10 PSI PRESSURE DROP

COPYRIGHT 2020, McCOLLOUGH ARCHITECTURE, IN



GENERAL PLUMBING NOTES:


- COMPLY WITH 2018 INTERNATIONAL MECHANICAL & PLUMBING CODE, NFPA, STATE AND LOCAL CODES.
- 2. PLUMBING CONTRACTOR SHALL OBTAIN AND PAY FOR ALL REQUIRED PERMITS AND INSPECTION CERTIFICATES.
- 3. OMISSIONS OR MISDESCRIPTION OF DETAILS OF WORK WHICH ARE EVIDENTLY NECESSARY TO CARRY OUT THE INTENT OF THE DRAWINGS, OR WHICH ARE CUSTOMARILY PERFORMED, SHALL NOT RELIEVE THE CONTRACTOR FROM PERFORMING SUCH OMISSIONS AND DETAILS OF WORK, BUT THEY SHALL BE PERFORMED AS IF FULLY AND CORRECTLY SET FORTH & DESCRIBED.
- PORTIONS OF WALLS AND ARCHITECTURAL FEATURES MAY HAVE BEEN OMITTED FROM THIS PLAN FOR CLARITY OF MECHANICAL FEATURES. REFER TO ARCHITECTURAL DRAWINGS FOR EXACT LOCATION OF FIXTURES, AND DIMENSIONS.
- 5. VERIFY FIELD DIMENSIONS. COORDINATE WORK WITH OTHER TRADES TO AVOID INTERFERENCES.
- 6. LAY OUT PIPING BASICALLY AS SHOWN. MAJOR CHANGES IN LAYOUT MAY BE MADE ONLY WITH WRITTEN CONSENT OF ARCHITECT OR ENGINEER.
- 7. ALL COMPONENTS USED IN PLENUM SPACES MUST BE CONSTRUCTED OF NON-COMBUSTIBLE MATERIAL.
- 8. COLOR OF FIXTURES AND TRIM SHALL BE AS SELECTED BY OWNER/ARCHITECT.
- 9. FIXTURES INDICATED AS BARRIER FREE SHALL COMPLY WITH THE AMERICANS WITH DISABILITIES ACT (ADA).
- 10. PROVIDE ELECTRICAL CONTRACTOR WITH EXACT WIRING REQUIREMENTS. IF ELECTRICAL REQUIREMENTS VARY FROM THOSE INDICATED ON PLANS, PLUMBING CONTRACTOR SHALL BE RESPONSIBLE FOR ANY ASSOCIATED ADDITIONAL COSTS.
- 11. REFER TO SITE PLAN FOR ROUTING OF WATER AND SEWER.
- 12. ENSURE THAT ALL PENETRATIONS OF FIRE WALLS ARE PROPERLY FIRESTOPPED.
- 13. ALL WATER LINES, BOTH HOT AND COLD, SHALL BE AS FOLLOWS:
 A. LINES BELOW GRADE SHALL BE TYPE "K" SOFT COPPER OR PEX.
 B. LINES ABOVE GRADE SHALL BE TYPE "L" HARD COPPER.
 C. FITTINGS SHALL BE OF HARD DRAWN COPPER OF ASTM SPEC B-88.
 D. ALL JOINTING SHALL BE WITH LEAD-FREE SILVER SOLDER.
 E. EQUIPPED WITH SHOCK ABSORBERS AS REQUIRED.
- 14. PLUMBING CONTRACTOR SHALL FURNISH & INSTALL SHUT-OFF VALVES TO ALL FIXTURES NOT OTHERWISE EQUIPPED.
- 15. ALL WASTE PIPING SHALL BE SCHEDULE 40 PVC CONFORMING TO ASTM D-1785. PIPING SMALLER THAN 3" SHALL BE LAID OUT AT 1/4" PER FOOT GRADE. PIPING 3" AND LARGER SHALL BE LAID OUT AT 1/8" PER FOOT GRADE. ALL VENT PIPING WITHIN PLENUM OR AIR-HANDLING SPACES SHALL BE COPPER OR CAST IRON.
- 16. ALL FLOOR DRAINS SHALL BE EQUIPPED WITH TRAP PRIMER. LOCATE TRAP PRIMER EQUIPMENT CONCEALED IN ACCESSIBLE LOCATION.
- 17. ALL WATER LINES, BOTH HOT AND COLD, SHALL BE CAPPED AND TESTED AT 180 PSI FOR 24 HOURS. ALL WASTE PIPING SHALL BE TESTED WITH A 10' WATER COLUMN FOR A 2 HR PERIOD WITH NO CHANGE IN LEVEL.
- 18. VENT PIPING SHALL BE LAID OUT SUCH THAT ALL ROOF PENETRATIONS SHALL BE ON BACK SIDE OF ROOF. PAINT EXPOSED VENT PIPING TO MATCH ROOF.
- 19. COORDINATE ROOF PENETRATIONS WITH ROOFING CONTRACTOR. ENSURE THAT WARRANTY REQUIREMENTS OF ROOFING MANUFACTURER ARE SATISFIED.
- 20. MATERIALS, EQUIPMENT, AND INSTALLATION SHALL BE GUARANTEED FOR A PERIOD OF ONE (1) YEAR FROM DATE OF ACCEPTANCE. DEFECTS WHICH APPEAR DURING THIS PERIOD SHALL BE CORRECTED AT THE MECHANICAL CONTRACTOR'S EXPENSE.

FIXTURE CONNECTION NOTES:

OR FLOOR.

- 1. CONNECT TO PLUMBING FIXTURES AND EQUIPMENT PROVIDED UNDER THIS AND OTHER SECTIONS OF SPECIFICATION, ARCHITECTURAL DRAWINGS, AND MANUFACTURER'S SHOP DRAWINGS. PROVIDE ROUGH—IN CONNECTION AS SHOWN IN DRAWINGS.
- 2. USE FIXTURE SCHEDULE AND DETAILS ON DRAWINGS OR MANUFACTURER'S SHOP DRAWINGS FOR CONNECTION SIZES TO FIXTURES.
- 3. PROVIDE SEPARATE P-TRAP FOR EACH FIXTURE, FLOOR DRAIN, AND PIECE OF EQUIPMENT.
- 4. PROVIDE PVC (SCH 80) P-TRAPS FOR UNDER FLOOR DRAINS.
- 5. MOUNT FIXTURES RIGID TO WALLS AS SHOWN ON DRAWINGS OR DETAILS.
- 6. PROVIDE OUTLET DEVICES WHICH LIMIT FLOW OF HOT WATER TO LAVATORIES AND HAND SINKS TO A MAXIMUM OF 0.5 GPM AND SIZED AS RECOMMENDED BY MANUFACTURER AND AS REQUIRED BY ASHRAE STANDARD 90-75, PARAGRAPH 7.7.2, LOCAL AND STATE ENERGY CODES.
- 7. INSTALL LAVATORIES AND HAND SINKS WITH A MINIMUM OF 4" CLEARANCE ON EACH SIDE FROM WALL OR PARTITION.
- 8. COORDINATE DIMENSIONS REQUIRED FOR MINIMUM FIXTURE CLEARANCE WITH OTHER DIVISIONS.
- 9. INSTALL APPROVED CAULKING AROUND JOINTS AT FIXTURES MOUNTED ON WALL



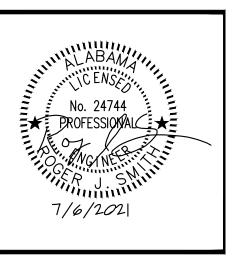

ORANGE BEACH TRAIL SHOP / WILDLIFE CENTE

JOB NO.:
DRAWN: RJS
CHECKED: RJS
DATE: 2021.07.06

REVISION:

SCALE: AS SHOWN

SHEET NO.:


PHASE


P1.0

PLUMBING NOTES, SCHEDULES AND LEGEND





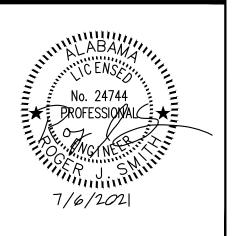

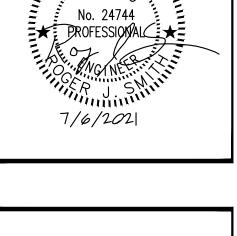




JOB NO.: DRAWN: CHECKED: DATE: 2021.07.06 REVISION:

SCALE:

SHEET NO.:

PLUMBING PLAN


AS SHOWN

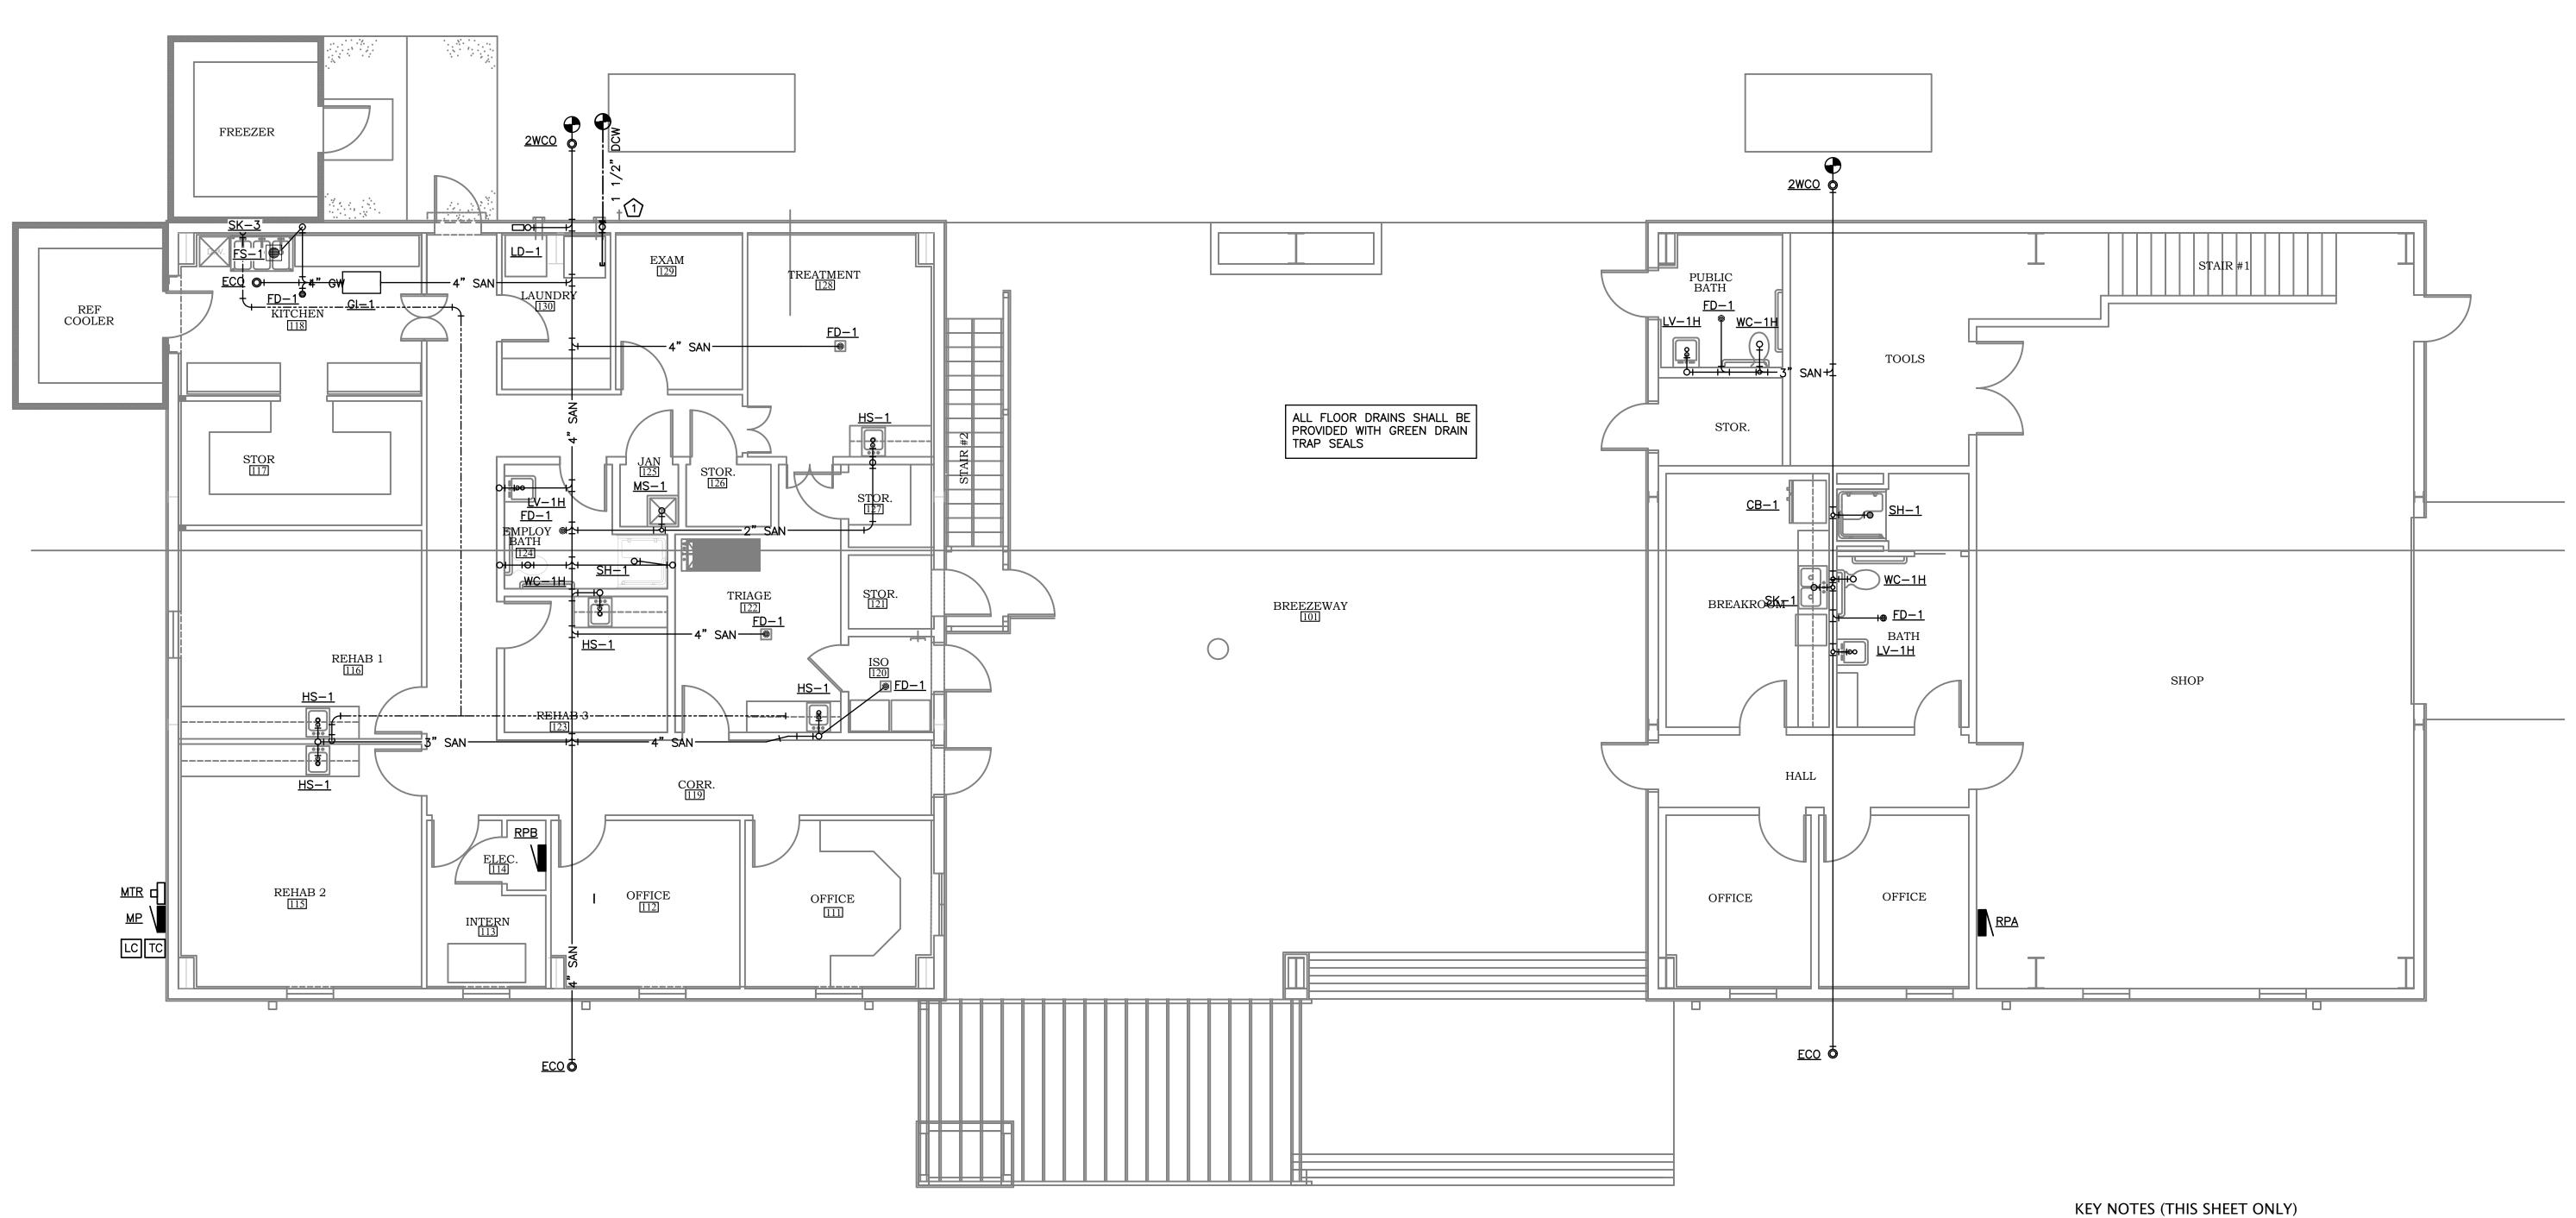

PROVIDE ISOLATION SHUT OFF VALVE IN RISER AT 24"
A.F.F. PROVIDE ACCESS DOOR IN WALL AT VALVE AND
TURN UP INSIDE EXTERIOR WALL. ROUTE UP INTO CEILING
SPACE AND CAP FOR FUTURE EXTENSION IN PHASE 1 ALT.
1 AND PHASE 2.

NOTE: PHASE ONE CONSISTS OF THE UNDERSLAB SANITARY WASTE PIPING ONLY. TOP OUT AND ABOVE SLAB DOMESTIC WATER WILL BE PROVIDED UNDER PHASE 1, ALTERNATE 1 AND PHASE 2 DRAWINGS. FIXTURES SHOWN IN THIS SHEET ARE FOR CLARITY ONLY.



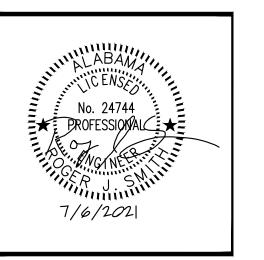

ENTER **PHASE**


JOB NO.: DRAWN: CHECKED: 2021.07.06 DATE: REVISION:

SCALE:

SHEET NO.:

SANITARY WASTE RISERS


AS SHOWN

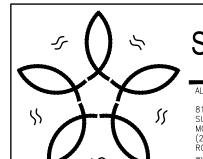

Smith Mechanical Consulting & Design 813 DOWNTOWNER BLVD.

MOBILE, AL 36609 ROGÉR J. SMITH, PE 24744



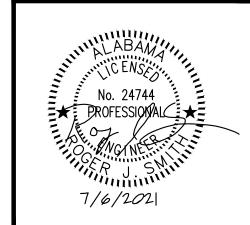

PHONE: 251-968-7222

TE

Z

3. THIS CONTRACTOR SHALL SECURE AND PAY FOR ALL REQUIRED PERMITS AND INSPECTIONS AND PERFORM ALL TESTS CALLED FOR OR REQUIRED AS A PART OF HIS WORK. FURNISHED APPROVED CERTIFICATE OF FINAL INSPECTION, AND TURN OVER TO OWNER AT COMPLETION OF PROJECT.

1. ALL WORK SHALL BE IN STRICT ACCORDANCE WITH ALL FEDERAL, STATE AND

MECHANICAL CODE AND 2018 INTERNATIONAL ENERGY CONSERVATION CODE.

NECESSARY TO PROVIDE A COMPLETE HEATING, VENTILATING, AIR CONDITIONING

BUT NECESSARY TO PROVIDE A COMPLETE AND OPERATING SYSTEM. ALL WORK

SHALL BE INSTALLED IN A PROFESSIONAL MANNER AND SHALL MEET ALL THE REQUIREMENTS OF THE STATE BUILDING CODE, CITY BUILDING CODE, SAFETY AND HEALTH CODES, NFPA CODES AND ALL OTHER APPLICABLE CODES AND

REQUIREMENTS. ALL COSTS FOR SAID REQUIREMENTS SHALL BE INCLUDED IN

SYSTEM. INCLUDE ANY LABOR AND MATERIAL NOT SPECIFICALLY MENTIONED,

LOCAL CODES AND ORDINANCES. COMPLY WITH 2018 INTERNATIONAL

2. FURNISH ALL LABOR, MATERIALS, TOOLS, INCIDENTALS AND DETAILS

4. MECHANICAL PLANS ARE DIAGRAMMATIC, NOT SHOWING EVERY ITEM IN EXACT LOCATION OR DETAIL. MEASUREMENTS AND LOCATIONS MUST BE FIELD VERIFIED AND COORDINATED WITH ARCHITECTURAL, HVAC, FIRE PROTECTION, STRUCTURAL, ELECTRICAL AND OTHER BUILDING DRAWINGS.

GENERAL HVAC NOTES

THIS CONTRACTORS BID PRICE.

DIFFUSERS/GRILLES/LOUVERS

- DISTRIBUTION DEVICE

C-CEILING, D-DOOR,

D-DIFFUSER, G-GRILLE,

BLOW PATTERN (4-WAY)

F-FLOOR, W-WALL

FOURTH CHARACTER:

SECOND LETTER:

FIRST LETTER:

L-LOUVER

THIRD LETTER:

TYPE CODE

OF DUPLICATE AIR -

DEVICES DESIGNATED

BY THIS SYMBOL (2)

DELIVERED BY DEVICE

IN CFM (200 CFM)

INCHES (12")

AIR QUANTITY -

NECK SIZE IN ______12"ø

- 5. MECHANICAL CONTRACTOR TO PROVIDE GENERAL CONTRACTOR WITH AS-BUILT DRAWINGS, ALL EQUIPMENT SHOP DRAWINGS, INFORMATION ON THERMOSTATS, CONTROL WIRING DIAGRAMS AND OTHER PERTINENT INFORMATION AT
- 6. DUCTS USED TO CONVEY THE CONDITIONED AIR SUPPLY AND VENTILATION AIR ARE TO BE MADE OF CONTINUOUS SHEET METAL.
- 7. DUCT LININGS (THERMAL AND ACOUSTICAL), VIBRATION ISOLATION CONNECTORS, FLEXIBLE DUCT CONNECTORS, AND DUCT TYPE SHALL BE APPROVED BY APPLICABLE CODE AND MECHANICAL ENGINEER.
- 8. ALL RETURN AIR, AND SUPPLY AIR DUCTWORK SHALL BE EXTERNALLY INSULATED WITH 1" THICK, 1.5 LBS. DENSITY FOIL FACED FIBERGLASS INSULATION. LINED DUCTWORK DOES NOT REQUIRE EXTERIOR INSULATION. DUCT DIMENSIONS SHOWN ARE INSIDE NET DIMENSIONS, ADD TO SHEET METAL SIZE FOR INSULATION. IN GENERAL, INSTALL DUCTWORK TIGHT TO UNDERSIDE OF STRUCTURE UNLESS OTHERWISE NOTED OR REQUIRED BY FIELD CONDITIONS. COORDINATE EXACT MOUNTING HEIGHT IN FIELD WITH GENERAL CONTRACTOR. ROUND DUCTWORK IN CONDITIONED SPACE DOES NOT REQUIRE INSULATION UNLESS OTHERWISE NOTED.
- 9. ALL DUCTWORK SHALL BE SHEET METAL FABRICATED IN ACCORDANCE WITH ASHRAE GUIDE AND SMACNA MANUAL LATEST EDITIONS.
- 10. ALL BRANCH TAKE-OFFS SHALL BE PROVIDED WITH MANUAL BALANCING
- 11. FLEXIBLE INSULATED DUCTS SHALL BE MAXIMUM 10'-0" LONG AND SHALL MEET INSTALLATION AND MATERIAL REQUIREMENTS OF LOCAL CODES.
- 12. THE MECHANICAL CONTRACTOR SHALL FURNISH AND INSTALL A COMPLETE TEMPERATURE CONTROL SYSTEM TO INCLUDE: PANELS, MODULES, RELAYS, WIRING, THERMOSTATS, SENSORS, DAMPERS, ACTUATORS AND ALL MISCELLANEOUS ITEMS AS REQUIRED TO FULFILL THE DESIGN INTENT AS INDICATED ON THE PLANS AND IN THE CODED NOTES.
- 13. ALL TEMPERATURE CONTROLS, FIRE ALARM COMPONENTS, EQUIPMENT NAMEPLATES, LABELS, OR COLOR CODED COMPONENTS SHALL BE MASKED DURING PAINTING TO PREVENT DAMAGE FROM OVER—SPRAY OR OBSCURING
- 14. ALL LOW VOLTAGE WIRING AND CONDUIT REQUIRED FOR MECHANICAL EQUIPMENT SHALL BE FURNISHED AND INSTALLED BY MECHANICAL CONTRACTOR. MECHANICAL CONTRACTOR SHALL COORDINATE POWER
- 15. SEAL & TAPE ALL OPENINGS IN DUCTWORK AIRTIGHT AFTER TESTING.
- 16. CHECK & VERIFY ALL FIELD CONDITIONS & ACTUAL DIMENSIONS BEFORE PREPARING SHOP DRAWINGS BEFORE INSTALLATION. NOTIFY ARCHITECT IMMEDIATELY OF ANY AND ALL DISCREPANCIES.
- 17. TEST & BALANCE ALL SUPPLY & EXHAUST SYSTEMS ACCORDING TO CFM INDICATED ON PLANS.
- 18. ALL APPLIANCE AND PLUMBING VENTS SHALL BE AT LEAST TEN (10) FEET IN A HORIZONTAL DIRECTION. OR THREE (3) FEET ABOVE THE OUTSIDE AIR INTAKES FOR HVAC AND MAKE-UP AIR UNITS.

SEQUENCE OF OPERATION

OCCUPIED MODE

AHU SHALL RUN IN AUTO MODE WITH HEAT PUMP UNIT CYCLING AS REQUIRED TO MAINTAIN SPACE TEMPERATURE IN COOL OR HEAT MODE. SETPOINT FOR COOLING SHALL BE 75°F ADJUSTABLE AND HEATING SHALL BE 70°F ADJUSTABLE.

A CALL FOR COOLING FROM THE SPACE THERMOSTAT SHALL ENERGIZE THE AIR HANDLER

A CALL FOR HEATING FROM THE SPACE THERMOSTAT SHALL ENERGIZE THE AIR HANDLER AND REFRIGERATION CIRCUITS IN STAGES IN REVERSE MODE AS DICTATED BY THE HEAT PUMP UNIT'S INTERNAL CONTROLS. THE AIR HANDLER AND ALL REFRIGERATION CIRCUITS SHALL BE DE-ENERGIZED WHEN SPACE TEMPERATURE REQUIREMENT HAS BEEN MET.

IF THE SPACE HEATING REQUIREMENTS CAN NOT BE MET USING THE REVERSE CYCLE ALONE, THE ELECTRIC HEATER WILL BE ENERGIZED IN STAGES AND CONTROLLED BY THE HEAT PUMP UNIT'S INTERNAL CONTROLS TO PROVIDE SUPPLEMENTAL HEAT. THE ELECTRIC HEATER AND THE REFRIGERATION CIRCUITS

SHALL BE DE-ENERGIZED WHEN SPACE TEMPERATURE REQUIREMENT HAS BEEN

UNOCCUPIED MODE

AHU AND HEAT PUMP SHALL CYCLE AS REQUIRED TO MAINTAIN SETPOINT. TEMPERATURE SETPOINT FOR COOLING SHALL BE 80°F. SETPOINT FOR HEATING SHALL BE 65°F. BOTH COOLING AND HEATING SETPOINTS SHALL BE ADJUSTABLE.

																						_
							SPLIT SY	STEM HE	AT PUMP	SCHEDU	JLE (PHAS	E 1 ALTE	ERNATE	1)								
MADI	4 NO	ADEA CEDVED	TONG	TOTAL	O.A.	MIN EFF	TICIENCY	COOLING	CAPACITY	HEATING	CAPACITY		II	NDOOR UN	Т			OUTDOC	R UNIT		NOTEC	
MAKI	K NO.	AREA SERVED	TONS	CFM	(CFM)	HSPF	SEER	TOTAL MBH	SENS. MBH	CAPACITY MBH	AUX. HEAT KW	VOLT PHASE	HP	E.S.P.	MCA	MOCP	VOLT PHASE	MCA	MOCP	WEIGHT (LBS)	NOTES	
AHU-1	HP-1	OFFICES & BREAKROOM	2	800	100	8.2	14	24.2	17	8	5	240/1	1/2	0.5	28	30	240/1	16	25	275	ALL	

MATERIAL

NOTES

- 1. BASIS OF DESIGN CARRIER FX4D FAN COIL WITH 25HNB6 2-STAGE HEAT PUMP (COASTAL APPLICATIONS) 2. FURNISH WITH PROGRAMMABLE THERMOSTAT WITH REMOTE BULB SENSOR AT AHU RETURN.
- 3. FURNISH WITH LOW AMBIENT CONTROLS.

4. FURNISH WITH ANTI-SHORT CYCLE TIMER.

5. FURNISH WITH EVAPORATOR DEFROST CONTROL. 6. FURNISH AND INSTALL VIBRATION ISOLATOR FEET TO OUTDOOR UNITS.

7. FASTEN OUTDOOR UNITS TO HOUSEKEEPING PAD.

		AIR TERMIN	AL DEVICE SCHEDUI	_E
MARK	DESRIPTION	MFGR	MODEL	
CDA	DIFFUSER, LAY-IN, LOUVERED FACE	TITUS	TDC-AA	
CGA	CLG RETURN AIR GRILLE — GRID CLG	TITUS	50FF	
CGB	CLG RETURN AIR GRILLE — GYP CLG	TITUS	55FL	

CDA	DIFFUSER, LAY-IN, LOUVERED FACE	TITUS	TDC-AA	ALUM.	ROUND	1,2,3
CGA	CLG RETURN AIR GRILLE — GRID CLG	TITUS	50FF	ALUM	ROUND	1,2,3
CGB	CLG RETURN AIR GRILLE — GYP CLG	TITUS	55FL	ALUM.	RECTANGULAR	1,2,3
CGC	CLG SUPPLY REGISTER	TITUS	112RL	ALUM	RECTANGULAR	1,2,3
WGA	WALL SUPPLY GRILLE	TITUS	300FL	ALUM	RECTANGULAR	1,2,3
WGB	WALL RETURN GRILLE	TITUS	55FL	ALUM	RECTANGULAR	1,2,3
WLA	OUTDOOR AIR LOUVER	RUSKIN	ELF811DD	ALUM.	RECTANGULAR	1,2,4,5,6

- . BASIS OF DESIGN
- 2. FINISH SHALL BE VERIFIED W/ARCHITECT
- . PROVIDE W/ MFR'S PLASTER FRAME OF SAME MATERIAL. 4. FRAME DEPTH TO COORDINATE WITH EXTERIOR WALL.
- 5. FURNISHED WITH INSECT SCREEN.
- 6. STATIONARY EXTRUDED ALUMINUM DOUBLE-DRAINABLE 4" DEEP FRAME WITH BIRD SCREEN
- 7. COORDINATE INSTALLATION AND WATERPROOFING WITH GEN. CONTRACTOR.

			F.A	AN PERFORMA	ANCE DATA				
TAG	SERVICE	CFM	SONES	E	ELECTRICAL DAT	A	BASIS OF	DESIGN	NOTES
., , , ,	32,,,,,,	J	33,723	POWER	E.S.P.	VOLTAGE	MFGR	MODEL	
EF-1	BATH 108	70	1.3	21	0.25	120/1	GREENHECK	SP-B90	ALL
EF-2	BATH 106	90	3.0	80	0.25	120/1	GREENHECK	SP-B110	ALL

EQUIPMENT NOTES: MFGR SPECIED IS "BASIS OF DESIGN" OR EQUAL. CONTRACTOR SHALL SUBMIT MFGR, MODEL AND PERFORMANCE DATA.

1. INTEGRAL DISCONNECT

- 2. VIBRATION ISOLATION KIT
- 3. INTEGRAL BACKDRAFT KIT

5. INTERLOCK WITH LIGHTING	т.	TAN SI EED CONTINGE	
	5.	INTERLOCK WITH LIGHTING	
6. ALUMINUM CEILING GRILL	6.	ALUMINUM CEILING GRILL	

AHU-1 VENTILATION	Floor		Required	Required	Corrected	Required
CALCULATIONS	Area	Maximum	Outdoor Air	Outdoor Air	Outdoor Air	Exhaust Air
Zone Name / Space Name	(ft²)	Occupants	(CFM/person)	(CFM/ft^2)	(CFM)	(CFM)
102 OFFICE	104	1	5	0.06	11	-
103 OFFICE	104	1	5	0.06	11	-
104 HALL	94	0	0	0.06	6	-
105 BREAKROOM	180	3	5	0.06	26	-
106 BATHROOM	139	0	0	0	-	90
107 STORAGE	45	0	0	0.12	5	_
108 PUBLIC BATH	70	0	0	0	-	-
109 TOOLS	173	0	0	0.12	21	-
Totals					80	90

TER REQUIREMENTS FOR HVAC EQUIPMENT WITH ELECTRICAL CONTRACTOR.

JOB NO.: DRAWN: RJS CHECKED: 2021.07.06 DATE:

AS SHOWN SCALE:

REVISION:

SHEET NO.:

HVAC LEGEND, NOTES, AND SCHEDULES

PHASE 1 ALTERNATE 1

EXHAUST AIR ELBOW W/ TURNING VANES ¬↓ SPLITTER ____ BALANCING DAMPER FIRE DAMPER - VERTICAL FIRE DAMPER - HORIZONTAL ■ ■ MOTORIZED DAMPER † THERMOSTAT EXHAUST FAN FLEX DUCT DUCT TURNING UP/DOWN UNDERCUT DOOR 1" MIN. → SUPPLY AIR DOOR GRILLE, SIGHT-PROOF

ALL SYMBOLS SHOWN MAY NOT APPEAR IN DRAWINGS.

HVAC ABBREVIATIONS

BDD BACK DRAFT DAMPER

→ → EXHAUST AIR

SD **SMOKE DAMPER**

HVAC SYMBOL LEGEND

SUPPLY AIR

RETURN AIR

ALL ABBREVIATIONS SHOWN MAY NOT APPEAR IN DRAWINGS.

AFF	ABOVE FINISHED FLOOR
AHU	AIR HANDLING UNIT
AUX	AUXILIARY
BDD	BACK DRAFT DAMPER
BRD	BAROMETRIC RELIEF DAMPER
CEIL	CEILING
COND	CONDENSATE
DIA	DIAMETER
EAT	ENTERING AIR TEMPERATURE
EF	ROOM EXHAUST FAN
EQUIP	EQUIPMENT
FD	FIRE DAMPER
FURN	FURNACE
GA	GAUGE
GRH	GAS RADIANT HEATER
GUH	GAS UNIT HEATER
HP	HEAT PUMP
HR	HOUR
MAX	MAXIMUM
MCA	MINIMUM CIRCUIT AMPACITY
MD	MOTORIZED DAMPER
MECH	MECHANICAL
MFR	MANUFACTURER
MIN	MINIMUM

OUTSIDE AIR PENE PENETRATION PTAC PACKAGED TERMINAL AIR CONDITIONER RA RETURN AIR RM ROOM REG REGISTER RND ROUND ROOFTOP UNIT RTU SYS SYSTEM **TEMPERATURE** TSTAT THERMOSTAT TYP TYPICAL

NOT IN CONTRACT

VEL VELOCITY VENTILATION FAN WITH

OA

MAXIMUM OVERCURRENT PROTECTION


4 FAN SPEED CONTROL

Paguired Paguired Corrected Paguired ALILI 1 VENITU ATION

VENTILATION NOTE: EXCEEDING MINIMUM TO ACCOUNT FOR EXHAUST AIR





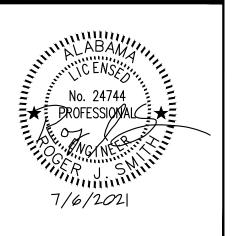


JOB NO.: DRAWN: CHECKED: 2021.07.06 DATE: REVISION:

SCALE: SHEET NO.:

HVAC PLAN FIRST FLOOR

AS SHOWN

PHASE 1 ALTERNATE 1

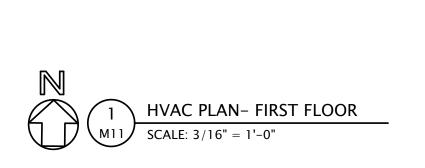

BREEZEWAY

<u>MP</u> \

KEY NOTES (THIS SHEET ONLY)

STOR. 107

BREAKROOM 105

CGB -12x12 119

CGC3 12x4 140

CGB 12x12 119

CGC3

OFFICE 103

CGB 12x12 268

CGC3 12x4 2 175

2)_{CGC3}


CONDENSATE DRYWELL

EXHAUST DUCT UP FOR CONNECTION TO EXHAUST TRUNK DUCT

SHOP 110

- SUPPLY BRANCH DUCT UP FOR CONNECTION TO SUPPLY TRUNK DUCT
- RETURN BRANCH DUCT UP FOR CONNECTION TO RETURN TRUNK DUCT



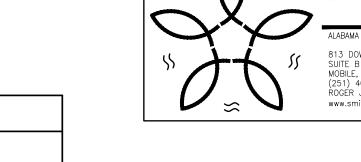



MFGR SPECIED IS "BASIS OF DESIGN" OR EQUAL. CONTRACTOR SHALL SUBMIT MFGR, MODEL AND PERFORMANCE DATA.

208/1

VOLTAGE

BASIS OF DESIGN

GREENHECK

AER-E20C-415-A

NOTES

FAN PERFORMANCE DATA

POWER

28 | 3/4 HP |

ELECTRICAL DATA

E.S.P.

0.5

INTEGRAL DISCONNECT
 VIBRATION ISOLATION KIT

SERVICE

CFM

2500

3. INTEGRAL BACKDRAFT KIT

EQUIPMENT NOTES:


TAG


4. FAN SPEED CONTROL

				LO	UVER 3	СПЕРОГ	_C					
TAG	DESCRIPTION	MGFR	MODEL	CFM	SI	ZE			DA	MPER		NOTES
IAG	DESCRIPTION	MGFK	MODEL	CFM	W	Н	FREE AREA	HP	VOLT	PHASE	MODEL	NOTES
LV-1	INTAKE	GREENHECK	EHV-550D-32x32	2500	32	32	45%	_	_	_	-	ALL
												,


EQUIPMENT NOTES:

- MFGR SPECIED IS "BASIS OF DESIGN" OR EQUAL. CONTRACTOR SHALL SUBMIT MFGR, MODEL AND PERFORMANCE DATA.
- 1. DRAINABLE COMBINATION LOUVER WITH GRAVITY BACKDRAFT DAMPER
- 2. LOUVERS PRIMED FOR FIELD PAINTING
- 3. FURNISH WITH BIRD/INSECT SCREEN 4. COORDINATE LOCATION WITH BLDG ELEVATIONS AND GENERAL CONTRACTOR

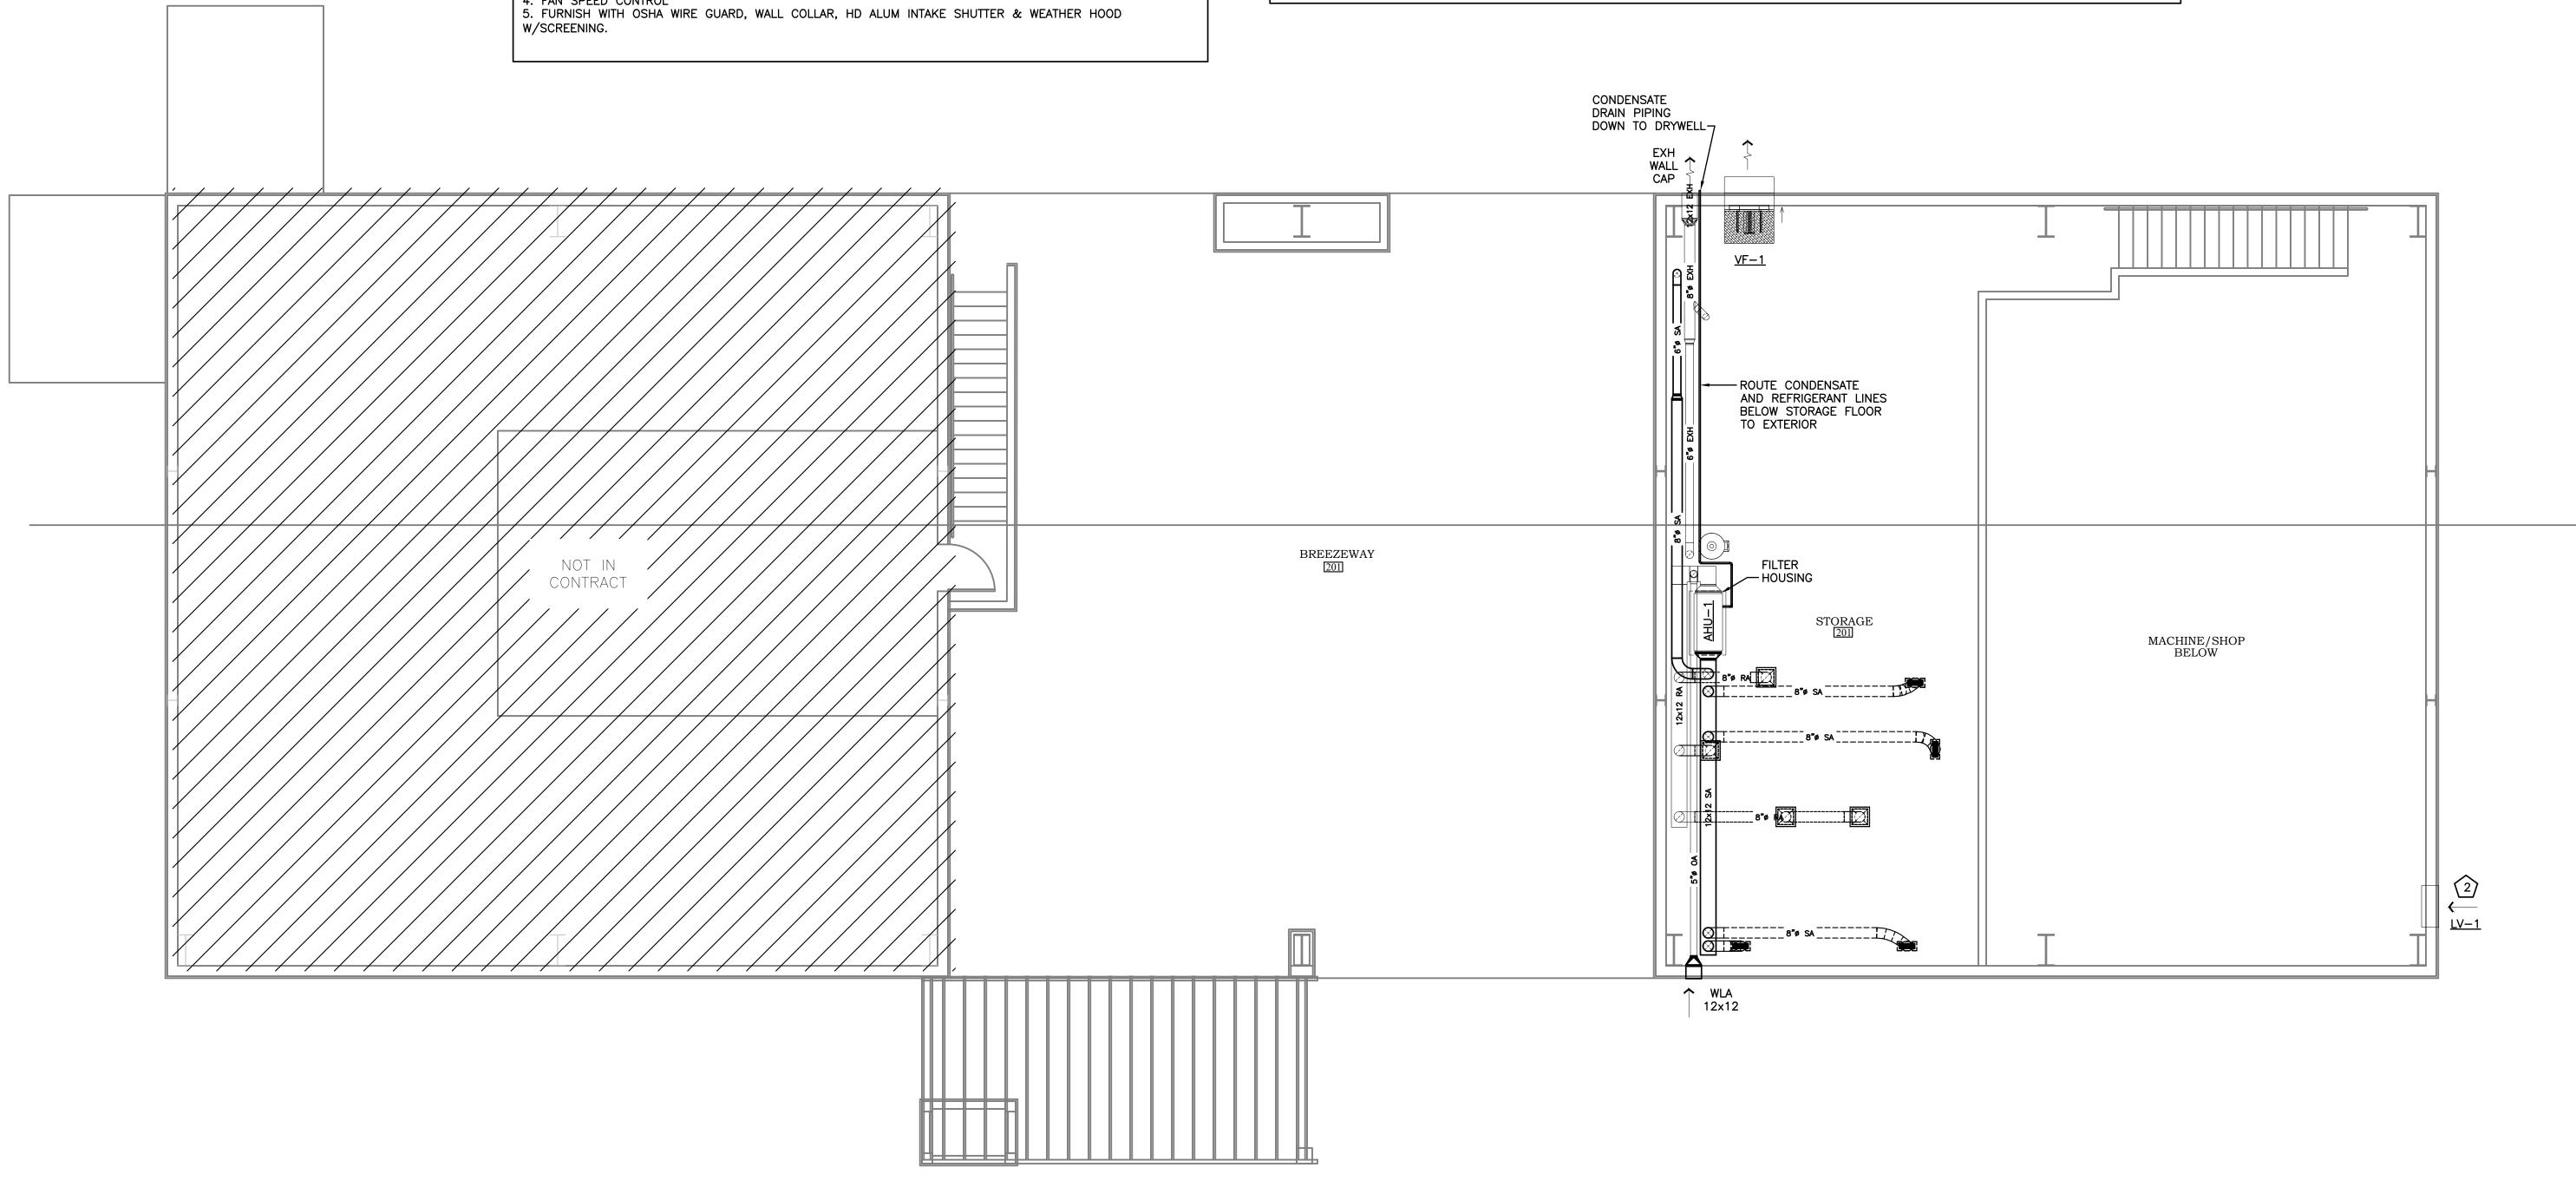

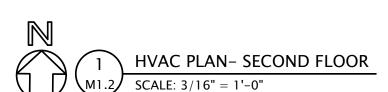

McCollough Architecture, Inc. P.O. BOX 6310 GULF SHORES, ALABAMA 36547-6310 PHONE: 251-968-7222

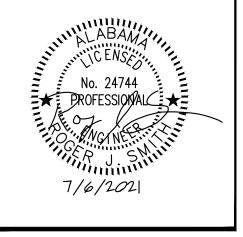

JOB NO.: DRAWN: CHECKED: 2021.07.06 DATE: REVISION:

SCALE:

SHEET NO.:


HVAC PLAN SECOND FLOOR


AS SHOWN

— FLEXIBLE CONNECTION

1" OVERFLOW TO BLDG.
 EAVE. TURN DOWN 1"
 PAST FINISH WITH BUG

SCREEN.

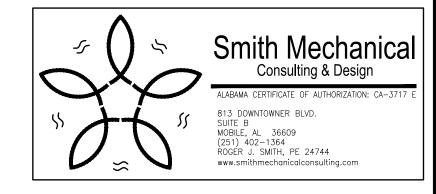

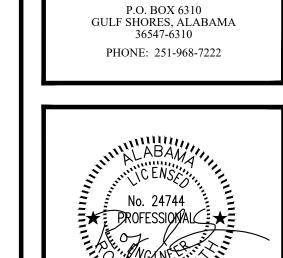

McCollough

Architecture, Inc.

7/6/2021

DRA ALTERNA

SE


PHA

JOB NO.: RJS DRAWN: RJS CHECKED: 2021.07.06 DATE: **REVISION:**

AS SHOWN SCALE:

SHEET NO.:

HVAC DETAILS

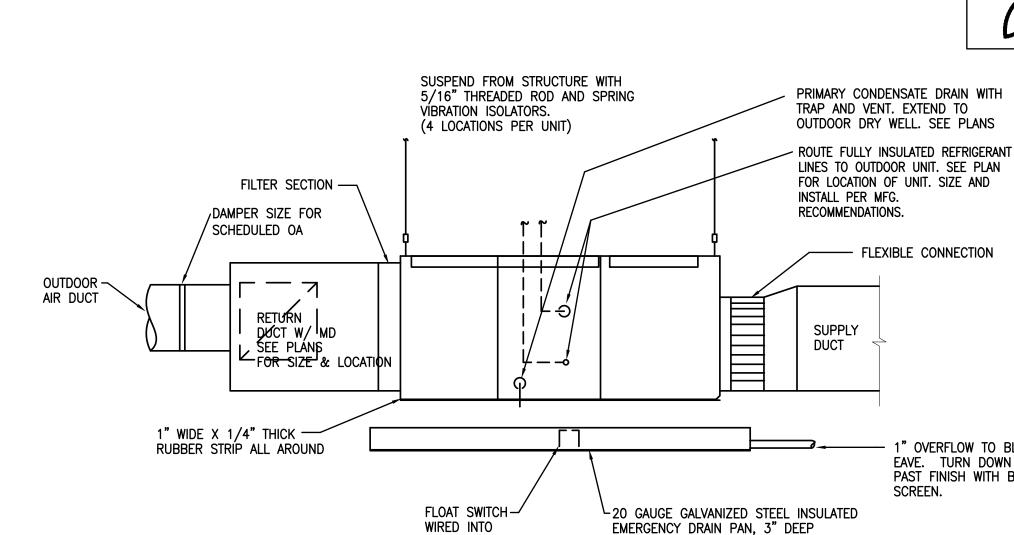

CONTROL CIRCUIT

AHU INSTALLATION DETAIL

NOTE: FOR BRANCH DUCT CONNECTIONS IN EXCESS OF 8'-0" PROVIDE RIGID ROUND DUCT TO WITHIN 6'-0" OF DIFFUSER AND CONNECT WITH FLEXIBLE DUCT.

NYLON DRAWBAND AND MASTIC AT EACH CONNECTION (TYPICAL)

BLANKET TYPE INSULATION

- LOUVERED FACE CEILING DIFFUSER WITH 2' X 2'

- GALVANIZED STEEL ROD OR STRAP SUPPORTS PER SMACNA STANDARDS

— SPIN—IN TAP FITTING WITH AIR SCOOP & DAMPER AND MASTIC AT FLANGE.

- 1-1/2" x 1-1/2" x 1/8" GALVANIZED ANGLE OR STRAP PER SMACNA

- SHEET METAL SUPPLY DUCT WITH 2" THICK WRAP INSULATION.





LOCKING QUADRANT TO BE EXPOSED AND ACCESSIBLE

TIE TO STRUCTURAL SUPPORT

FLEXIBLE DUCT WITH 1.5" THICK-INSULATION AND VAPOR BARRIER MAX. RUN TO BE 8'-0"

SQUARE TO ——— ROUND ADAPTER

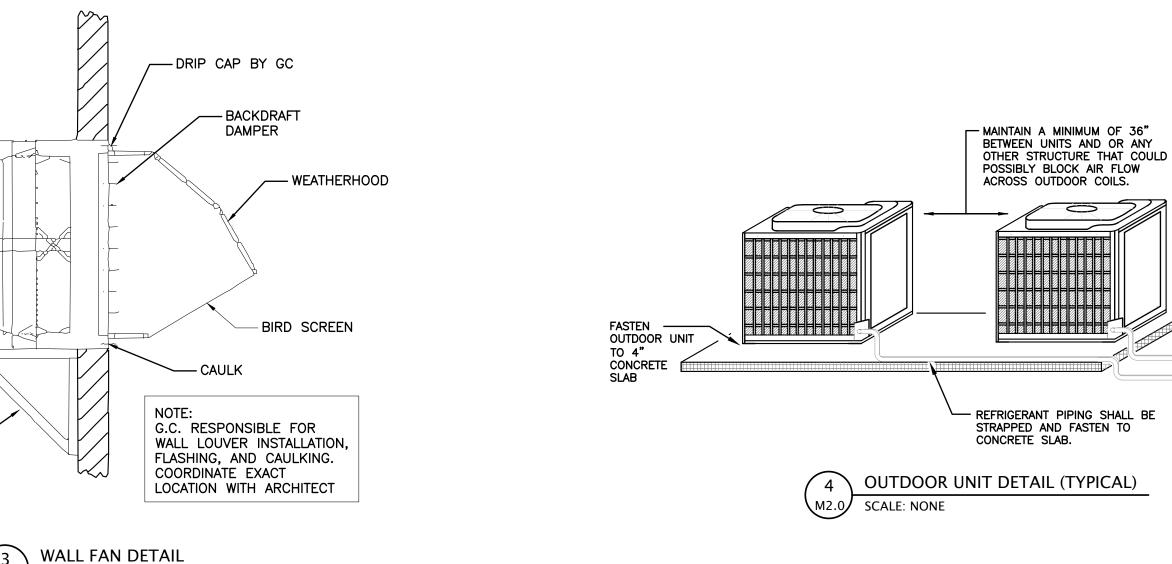

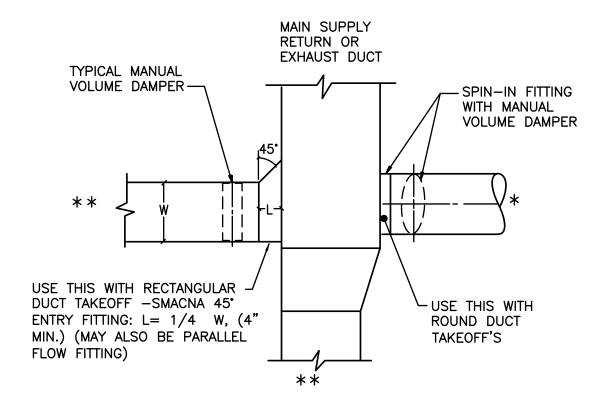


AND 3" WIDER THAN UNIT ALL AROUND CROSS BREAK BOTTOM OF SHEET METAL PAN


TO PROVIDE SLOPED DRAINAGE TO OUTLET

* = BRANCH TO INDIVIDUAL DIFFUSER OR GRILLE

** = SUBMAIN, BRANCHMAIN, OR BRANCH.




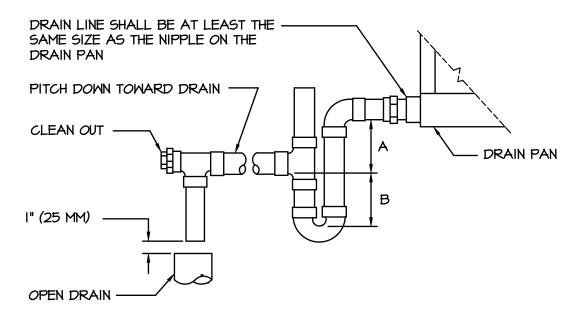

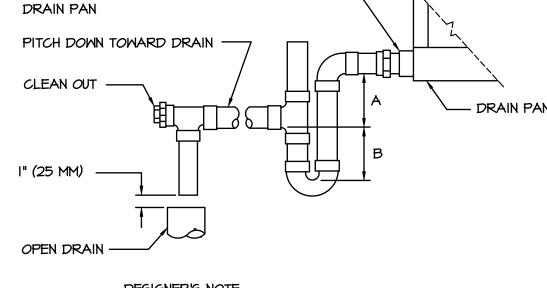

DESIGNER'S NOTE: UNIT TYPE DRAW THRU 2" PLUS X I" MIN. 2X BLOW THRU WHERE X = STATIC PRESSURE IN PAN

6 AHU DRAIN TRAP DETAIL M2.0 SCALE: NONE

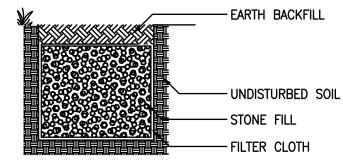

M2.0 SCALE: NONE

WALL SLEEVE -

MOTOR

SUPPORT BY GC


(UNO)

3"x3"x3/8" ANGLE IRON


REMOVABLE 1/2" — MESH SCREEN GUARD

> 36" DEEP x 24" DIAMETER DRYWELL. LINE WITH FILTER CLOTH AND FILL WITH 1" TO 2" DIAMETER WASHED STONE TO WITHIN 6" OF TOP. FOLD FILTER CLOTH OVER TOP OF STONE FILL. COVER REMAINING 6" WITH

9 DRYWELL DETAIL M2.0 SCALE: NONE

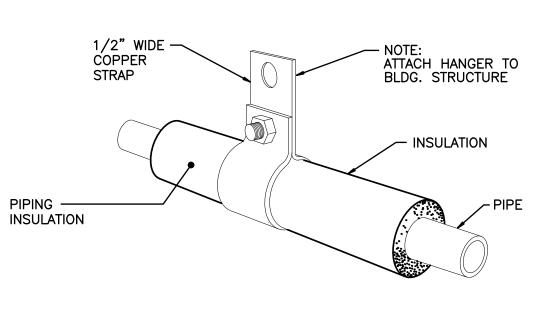

REFRIGERANT PIPING HANGER DETAIL SCALE: NONE

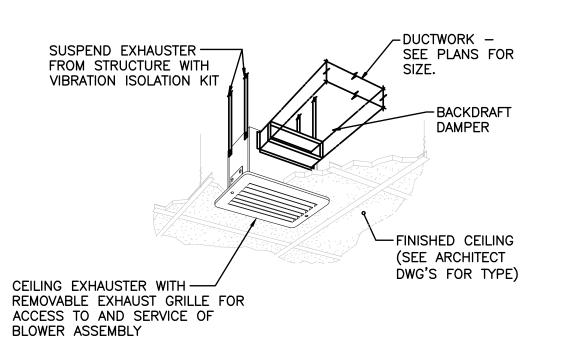


— ROUTE REFRIGERANT

ASSOCIATED INDOOR SECTION OF

7 CEILING EXHAUST FAN DETAIL M2.0 SCALE: NONE



McCollough ${f A}$ rchitecture, ${f I}$ nc.

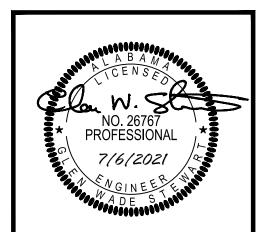

GULF SHORES, ALABAMA 36547-6310 PHONE: 251-968-7222

GE , **-**

LTERN OR

JOB NO. DRAWN:

CHECKED: 2021.04.22 DATE:

GWS

GWS

REVISION:

AS SHOWN SCALE:

SHEET NO.:

ELECTRICAL NOTES

AND LEGEND

POWER & LIGHTING LEGEND ELECTRICAL ABBREVIATIONS AUXILIARY LEGEND ALL ABBREVIATIONS SHOWN MAY NOT APPEAR IN DRAWINGS. ALL ABBREVIATIONS SHOWN MAY NOT APPEAR IN DRAWINGS. ALL SYMBOLS SHOWN MAY NOT APPEAR IN DRAWINGS. FIRE ALARM MANUAL PULL STATION, 3'-10" AFF MAXIMUM MAIN CIRCUIT BREAKER FIXTURE STRIP, OVERHEAD / WALL MOUNTED. AMPERE MOTOR CONTROL CENTER 1000 CIRCULAR MILS FIRE ALARM STROBE / HORN-STROBE, 7'-6" AFF FIXTURE STRIP, OVERHEAD / WALL MOUNTED, EMERGENCY. ALTERNATING CURRENT MECH MECHANICAL AIR CONDITIONING MANHOLE \square/\square FIXTURE, 2X2, 1X4, 2X4. FIRE ALARM STROBE / HORN-STROBE. CEILING MOUNTED. ABOVE FINISH CEILING MINIMUM ABOVE FINISH FLOOR MISCELLANEOUS FIRE ALARM SMOKE DETECTOR, CEILING MOUNTED. FIXTURE, 2X2, 1X4, 2X4. W/ BATTERY BACKUP. MAIN LUGS ONLY ABOVE FINISH GRADE AMPERE INTERRUPTING CAPACITY MANUFACTURER ALUMINUM MOUNTED FIRE ALARM DUCT-MOUNTED SMOKE DETECTOR W/ SAMPLING TUBE. EMERGENCY BATTERY PACK FIXTURE, WALL / CEILING MOUNTED. APPROXIMATE(L) MOUNTING ARCHITECT(URAL MANUAL TRANSFER SWITCH FIRE ALARM REMOTE TEST STATION, 3'-10" AFF $\phi/\emptyset/Q$ FIXTURE, SURFACE MTD. / RECESSED / WALL MOUNTED. NEUTRAL NOT APPLICABLE AUTOMATIC TRANSFER SWITCH AMERICAN WIRE GAGE NORMALLY CLOSED FIRE ALARM HEAT DETECTOR. CEILING MOUNTED. ♦/﴿ FIXTURE, SURFACE MTD. / RECESSED / WALL MOUNTED. W/ BATTERY BACKUP. NATIONAL ELECTRICAL CODE NATIONAL ELECTRICAL MANUFACTURER'S ASSO. BACKBOARD FIRE ALARM AUXILIARY RELAY. EXIT SIGN, CEILING/WALL MOUNTED W/BATTERY. PROVIDE ARROWS AS INDICATED NFPA N.I.C. NATIONAL FIRE PROTECTION ASSOCIATION NOT IN CONTRACT BUILDING CONDUIT MONITOR MODULE FOR AUXILIARY CONTROL NIGHT LIGHT SINGLE POLE TOGGLE SWITCH, 120/277V, 20A. 3'-10" AFF NORMALLY OPEN NO. OR # NUMBFR THREE-WAY TOGGLE SWITCH/FOUR-WAY TOGGLE SWITCH, 120/277V, 20A. 3'-10" AFF FIRE ALARM FIRE SPRINKLER SYSTEM VALVE TAMPER SWITCH CONTROL OUTSIDE DIAMETER CURRENT TRANSFORMER CABLE TELEVISION MOTOR RATED SWITCH, VERIFY REQUIREMENT AND # OF POLES W/ EQUIPMENT POWER FACTOR FIRE ALARM FIRE SPRINKLER SYSTEM FLOW SWITCH COLD WATER PIPE PAD MOUNTED SWITCH FIRE ALARM CONTROL PANEL. SINGLE POLE, THREE POSITION MOMENTARY CONTACT, 120/277 V, 20A. 3'-10" AFF PAD_MOUNTED TRANSFORMER DIRECT BURIAL DIRECT CURRENT FIRE ALARM REMOTE PANEL DIMMER SWITCH. 120/277V, FLUOR/INC AND AMPERAGE AS REQUIRED. 3'-10" AFF DUAL ELEMENT TIME DELAY PROVIDE FURNISH AND INSTALL TELEPHONE/DATA OUTLET AND COVER PLATE. 18" AFF WITH 3/4" C. AAC/UNO POTENTIAL TRANSFORMER KEYED SWITCH. 120/277V, AMPERAGE AS REQUIRED. 3'-10" AFF DISCONNECT SWITCH POLYVINYL CHLORIDE PART WINDING WALL MOUNTED TELEPHONE, MOUNT 60" AFF/UNO LOW VOLTAGE SWITCH. 3'-10" AFF GARBAGE DISPOSAL REFERENCE COMBINATION DATA/TELEPHONE OUTLET AND COVER PLATE. 18" ACC WITH - DOUBLE THROW RATED LOAD AMPERES OCCUPANCY SENSOR, 3'-10" AFF WALL/CEILING MTD. 3/4"C TO ACC/UNO JISHWASHER RIGID NONMETALLIC CONDUIT DATA OUTLET AND COVER PLATE, MOUNTED ON COLUMN OR POWER POLE, ELECTRICAL RANGE OCCUPANCY SENSOR, 3'-10" AFF DUAL RELAY FOR LIGHTING/EXHAUST FAN REFERIGERATOR RAIN TIGHT FLOOR BOX, ROUND WITH DUPLEX RECEPTACLE, TELEPHONE AND DATA OUTLET. OCCUPANCY SENSOR, RELAY/POWER PACK, CONCEALED, ACCESSIBLE. LECTRICAL METALLIC TUBING SCCR SHORT CIRCUIT CURRENT RATING FLOOR BOX COVER SHALL BE BRASS WITH HINGED COVERS FOR DEVICES. XPLOSION PROOF SCHEDULE QUIPMENT SOFT DRAWN ("2D"= DUAL DATA OUTLET, "4D"= QUAD DATA OUTLET) RISTING, REMOVE. SERVICE ENTRANCE ELECTRIC WATER COOLER SECONDARY PANEL, LIGHTING OR POWER AS SPECIFIED IN PANEL SCHEDULE. CATV OUTLET SINGLE GANG BOX WITH 3/4" C TO AAF. VERIFY HEIGHT EXISTING, REPLACE WITH NEW INTERNATIONAL SYSTEM OF UNITS AUDIO SYSTEM SPEAKER. FURNISHED AND INSTALLED BY OTHERS. FUSED DISCONNECT SPECIFY AMP/POLE SINGLE LINE DIAGRAM FIRE ALARM SURFACE METALLIC RACEWAY AUDIO VOLUME CONTROL. SINGLE GANG EMPTY OUTLET INSTALLED AT FINISHED SOLID NEUTRAL NON-FUSED DISCONNECT SPECIFY AMP/POLE 46" AFF WITH 3/4"C TO AAF WITH DATA BUSHING. **SPECIFICATIONS** FULL LOAD AMPERES SINGLE POLE — DOUBLE THROW SINGLE POLE — SINGLE THROW MOTOR STARTER. NUMBER NEXT TO SYMBOL INDICATES SIZE, SEE SPECIFICATIONS FOR DESCRIPTION SECURITY CAMERA. PROVIDE ROUGH-IN OUTLET ONLY WITH 3/4"C TO SERVER ROOM FLEXIBLE METAL CONDUIT WHEN SHOWN WITHIN BOUNDARY OF EQUIPMENT PROVIDED AS PART OF THE EQUIPMENT. IN DESIGNATED AREA ALLOCATED FOR CAMERA HEADEND EQUIPMENT. STATIC TRANSFER SWITCH GAI VANIZED GROUND FAULT INTERRUPTER SWITCH BOARD COMBINATION NONFUSIBLE DISCONNECT SWITCH/MAGNETIC MOTOR STARTER IN NEMA 1 ENCLOSURE, GALVANIZED RIGID METAL CONDUIT SWITCHGEAR NUMBER NEXT TO SYMBOL INDICATES SIZE, SEE SPECIFICATIONS FOR DESCRIPTION GROUND FERMINAL BACKBOARD **ELECTRICAL DESIGNATIONS** HEAVY DUTY TELEPHONE EXHAUST FAN FURNISHED AND INSTALLED BY HVAC. REFER TO HANDHOLE TEMPERATURE MECHANICAL DWG'S FOR EXACT LOCATION AND ELECTRICAL REQUIREMENTS. HORSEPOWER TRANSIENT VOLTAGE SURGE SUPPRESSORS FIXTURE NOTE HIGH VOLTAGE TYPE 'A' FIXTURE (SEE FIXTURE SCHEDULE). CIRCUIT NO. 2 (TYP) SINGLE RECEPTACLE 120/277V, AMPERAGE AS REQUIRED. 1'-6" AFF HEATING/VENTILATION/AIR COND. UNDERWRITER'S LABORATORY HERTZ (CYCLES PER' SECOND) DUPLEX/QUAD RECEPTACLE OUTLET, 120/277V, 20A. 1'-6" AFF INSIDE DIAMETER VOLTS ALTERNATING CURRENT FIXTURE NOTE TYPE 'A' FIXTURE (SEE FIXTURE SCHEDULE). CIRCUIT NO. 2 (TYP) ISOLATED GROUND VOLTS DIRECT CURRENT INTERMEDIATE METAL CONDUIT VENTILATION ♠ /

B

DUPLEX/QUAD RECEPTACLE OUTLET, 120/277V, 20A. 6" ABOVE COUNTER U.N.O.

Outlier

ABOVE COUNTER U.N.O.

DUPLEX/QUAD RECEPTACLE OUTLET, 120/277V, 20A. 6" ABOVE COUNTER U.N.O.

DUPLEX/QUAD RECEPTACLE OUTLET, 120/277V, 20A. 6" ABOVE COUNTER U.N.O.

DUPLEX/QUAD RECEPTACLE OUTLET, 120/27V, 20A. 6" ABOVE COUNTER U.N.O.

DUPLEX/QUAD RECEPTACLE OUTLET, 120/27V, 20A. 6" ABOVE COUNTER U.N.O.

DUPLEX/QUAD REC JUNCTION BOX RECPT NOTE WALL OUTLET WITH RECEPTACLE NOTED, CONNECT TO CIRCUIT NO. 2 (TYP) ↑ ★ DUPLEX/QUAD RECEPTACLE OUTLET, ISOLATED GROUND, 120/277V, 20A. 1'-6" KILO ČIRCUĹAR MILS **WEATHERPROOF** WATERTIGHT HOMERUN (TYP) TO PANEL 'PPA', CONNECT TO CIRCUIT NO.'S "5, 6, & 7" KILO VOLT - AMPERES HOME RUN RECEPTACLE, FLOOR / CEILING FLUSH MOUNTED. 120/277V, 20A. PPA-5.6.7 KILO WATTS LIQUIDTIGHT FLEXIBLE CONDUIT EX: 3#12 (PH), 1#12 (N) & 1#12 GND INCHES TWO GANG FLOOR BOX WITH ONE RECEPT AND PROVISION FOR DUAL COMM CABLE HOME RUN (ALTERNATE) HOMERUN USING 2#8, EX: 3#12 (PH), 1#12 (N) & 1#12 GND WIREMOLD RFB2 MULTI-SERVICE RECESSED FLOOR BOX WITH BRASS COVERPLATE. LOW VOLTAGE FURNISH WITH ALL APPURTENANCES FOR COMPLETE SYS LESS COMM CABLING. PHASE--Ⅲ WIRE DESIGNATION TIC INDICATES NUMBER OF CONDUCTORS, 2-POLE SINGLE RECEPTACLE 240V, AMPERAGE AS REQUIRED. EX: 3#12 (PH), 1#12 (N) & 1#12 GND TVSS RECEPTACLE DUPLEX RECEPTACLE, 120V, 20A. EQUAL TO PASS & SEYMOUR #5362WSP NOTES: SPECIAL PURPOSE RECEPTACLE OUTLET, NEMA CONFIGURATION TO MATCH PLUG. 1. "NL" DESIGNATION REQUIRES FIXTURE TO BE CONFIGURED FOR ONE LAMP ("GF"=GROUND FAULT PROTECTED, "WP"= (WR & GF TYPE) WEATHER PROOF & GFI PROTECTED) OPERATIONAL AT ALL TIMES. USE GF RATED BREAKER WHERE DEVICE IS NOT READILY ACCESSIBLE PER NEC 2. ALL CIRCUITS SHALL CONTAIN A GREEN EQUIPMENT GROUNDING CONDUCTOR. 3. EQUIPMENT GROUND CONDUCTOR SHALL BE AS FOLLOWS UNLESS OTHERWISE INDICATED: ABOVE GROUND CONDUIT #12 AWG CIRCUIT - #12 GND #10 AWG CIRCUIT - #10 GND ---- UNDERGROUND CONDUIT # 8 AWG CIRCUIT - #10 GND COMMUNICATIONS, TELEPHONE / COMPUTER BACKBOARD. 4. UNLESS OTHERWISE INDICATED, CONDUIT SIZE SHALL BE 3/4" MIN. AND SHALL NOT EXCEED A FILL OF 40% MAXIMUM, SEE NEC. HVAC CONTROLS, 54" AFF U.N.O. WITH 3/4"C TO ACCESSIBLE CEILING. TSTAT WIRING BY HVAC

LIGHTING CONTACTOR. ELECTRICALLY HELD, 4-POLE MINIMUM WITH HOA SWITCH. COORDINATE ACTUAL NUMBER OF

POLES WITH NUMBER OF EXTERIOR LIGHTING CIRCUITS. COIL VOLTAGE SHALL MATCH PHOTOCELL OUTPUT

ELECTRICAL NOTES


SIZE OF GROUNDING CONDUCTOR "AWG"


OF CIRCUIT CONDUCTORS -

SIZE OF CIRCUIT CONDUCTORS "AWG"

- THE ELECTRICAL CONTRACTOR IS RESPONSIBLE FOR OBTAINING AND PAYING ALL REQUIRED PERMITS AND INSPECTION
- ALL WORK SHALL COMPLY WITH IBC 2018, NEC 2017, STATE AND LOCAL CODES WHERE APPLICABLE. VERIFY WITH AUTHORITY HAVING JURISDICTION AND COMPLY AS REQUIRED.
- OMISSIONS OR MISDESCRIPTION OF DETAILS OF WORK WHICH ARE EVIDENTLY NECESSARY TO CARRY OUT THE INTENT OF THE DRAWINGS, OR WHICH ARE CUSTOMARILY PERFORMED, SHALL NOT RELIEVE THE CONTRACTOR FROM PERFORMING SUCH OMISSIONS AND DETAILS OF WORK, BUT THEY SHALL BE PERFORMED AS IF FULLY AND CORRECTLY SET FORTH &
- EQUIPMENT, MATERIALS, AND INSTALLATION SHALL BE GUARANTEED FOR A PERIOD OF ONE (1) YEAR FROM DATE OF ACCEPTANCE. DEFECTS WHICH APPEAR DURING THIS PERIOD SHALL BE CORRECTED AT THE EXPENSE OF THE ELECTRICAL
- MATERIALS AND ALL COMPONENTS THEREOF SHALL BE NEW AND SHALL BE UL APPROVED WHERE A STANDARD HAS BEEN ESTABLISHED. COMPONENTS SHALL BE EQUAL TO THOSE SCHEDULED ON DRAWINGS.
- ALL RACEWAY EXPOSED ON THE EXTERIOR SHALL BE RIGID GALVANIZED STEEL "RGS" OR "IMC". EMT SHALL NOT BE ACCEPTABLE. COORDINATE WITH ARCHITECT IF FINISH PAINTING SHALL BE REQUIRED.
- 7. VERIFY FIELD DIMENSIONS. COORDINATE WORK WITH OTHER TRADES TO AVOID INTERFERENCES.
- ALL EXIT AND EMERGENCY LIGHTS SHALL BE UNSWITCHED AND SHALL BE SERVED FROM THE SAME CIRCUIT AS THE GENERAL LIGHTING IN THE SAME AREA U.N.O.
- 9. ALL ELECTRICAL PANELS SHALL HAVE ENGRAVED LAMINATED (BLACK ON WHITE) LABELS IDENTIFYING THEM AS INDICATED
- 10. ENSURE THAT ALL PENETRATIONS OF FIRE WALLS AND DECKS ARE PROPERLY SEALED PER IBC, ANY APPLICABLE UL ASSEMBLIES, AND THE SPECIFICATIONS.
- 11. COLOR OF WIRING DEVICES AND PLATES SHALL BE AS SELECTED BY THE ARCHITECT.
- COORDINATE LAYOUT CAREFULLY WITH SYSTEMS FURNITURE AND MILLWORK SHOP DRAWINGS PRIOR TO ROUGHING IN POWER AND COMMUNICATIONS OUTLETS TO ENSURE PROPER ORIENTATION OF OUTLETS WITH COMPONENTS OF THESE
- 13. AVOID PENETRATING THE OUTER SKIN OF METAL BUILDING WALLS AND ROOF. MOUNT EQUIPMENT ON STRUCTURAL COLUMNS AND PURLINS WHERE POSSIBLE. PROVIDE MOUNTING STRUT BETWEEN STRUCTURAL MEMBERS WHERE NECESSARY. FOR ANY UNAVOIDABLE ROOF PENETRATION, ENSURE THAT METAL BUILDING MANUFACTURER'S ROOF WARRANTY REQUIREMENTS ARE SATISFIED.
- 14. CONDUCTOR SIZES INDICATED ON THE DRAWINGS HAVE BEEN SELECTED TO PROVIDE FOR ACCEPTABLE VOLTAGE DROP. DO NOT REDUCE WIRE SIZES SHOWN WITHOUT CONSENT OF ENGINEER.
- 15. CONDUCTORS SHALL BE SINGLE CONDUCTOR COPPER, STRANDED FOR AWG #8 AND LARGER AND SOLID FOR AWG #10 AND SMALLER, WITH 600 VOLT THHN INSULATION.
- 16. ALL CONDUCTORS SHALL BE INSTALLED IN METALLIC CONDUIT. PVC SCHEDULE 40, MAY BE INSTALLED BELOW GRADE WITH TRANSITIONS TO PVC SCH 80 IF CONCEALED WALL OR "RGS" IF EXPOSED ABOVE GRADE.
- 17. THE USE OF MC CABLE IS PERMISSIBLE ONLY IN CONCEALED LOCATIONS AND FOR FLEXIBLE CONNECTIONS TO LIGHTING
- 18. THE LOCATION OF OUTLETS AND EQUIPMENT SHOWN ON THE DRAWINGS ARE APPROXIMATE AND THE OWNER SHALL HAVE
- THE RIGHT TO RELOCATE ANY OUTLETS OR FIXTURES BEFORE THEY ARE INSTALLED WITHOUT ANY ADDITIONAL COST. 19. TELECOM OUTLETS WHERE INSTALLED ADJACENT TO RECEPTACLE OUTLETS. SHALL HAVE UNIFORM SPACING BETWEEN
- RESPECTIVE DEVICES. E.C. SHALL UTILIZE MOUNTING PROVISIONS BETWEEN STUDS. IF REQUIRED. TO MAINTAIN THIS



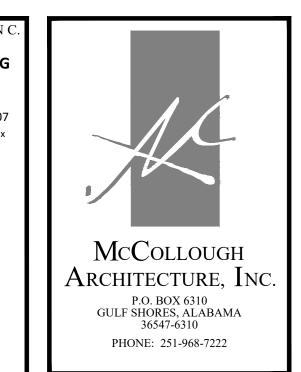

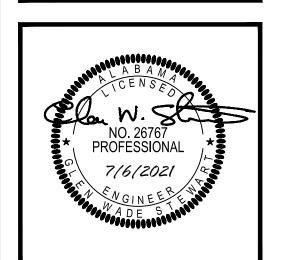






DRAWN: CHECKED: 2021.04.22 2022.01.04 REVISION:

AS SHOWN


SHEET NO.:

LIGHTING PLAN ALTERNATES

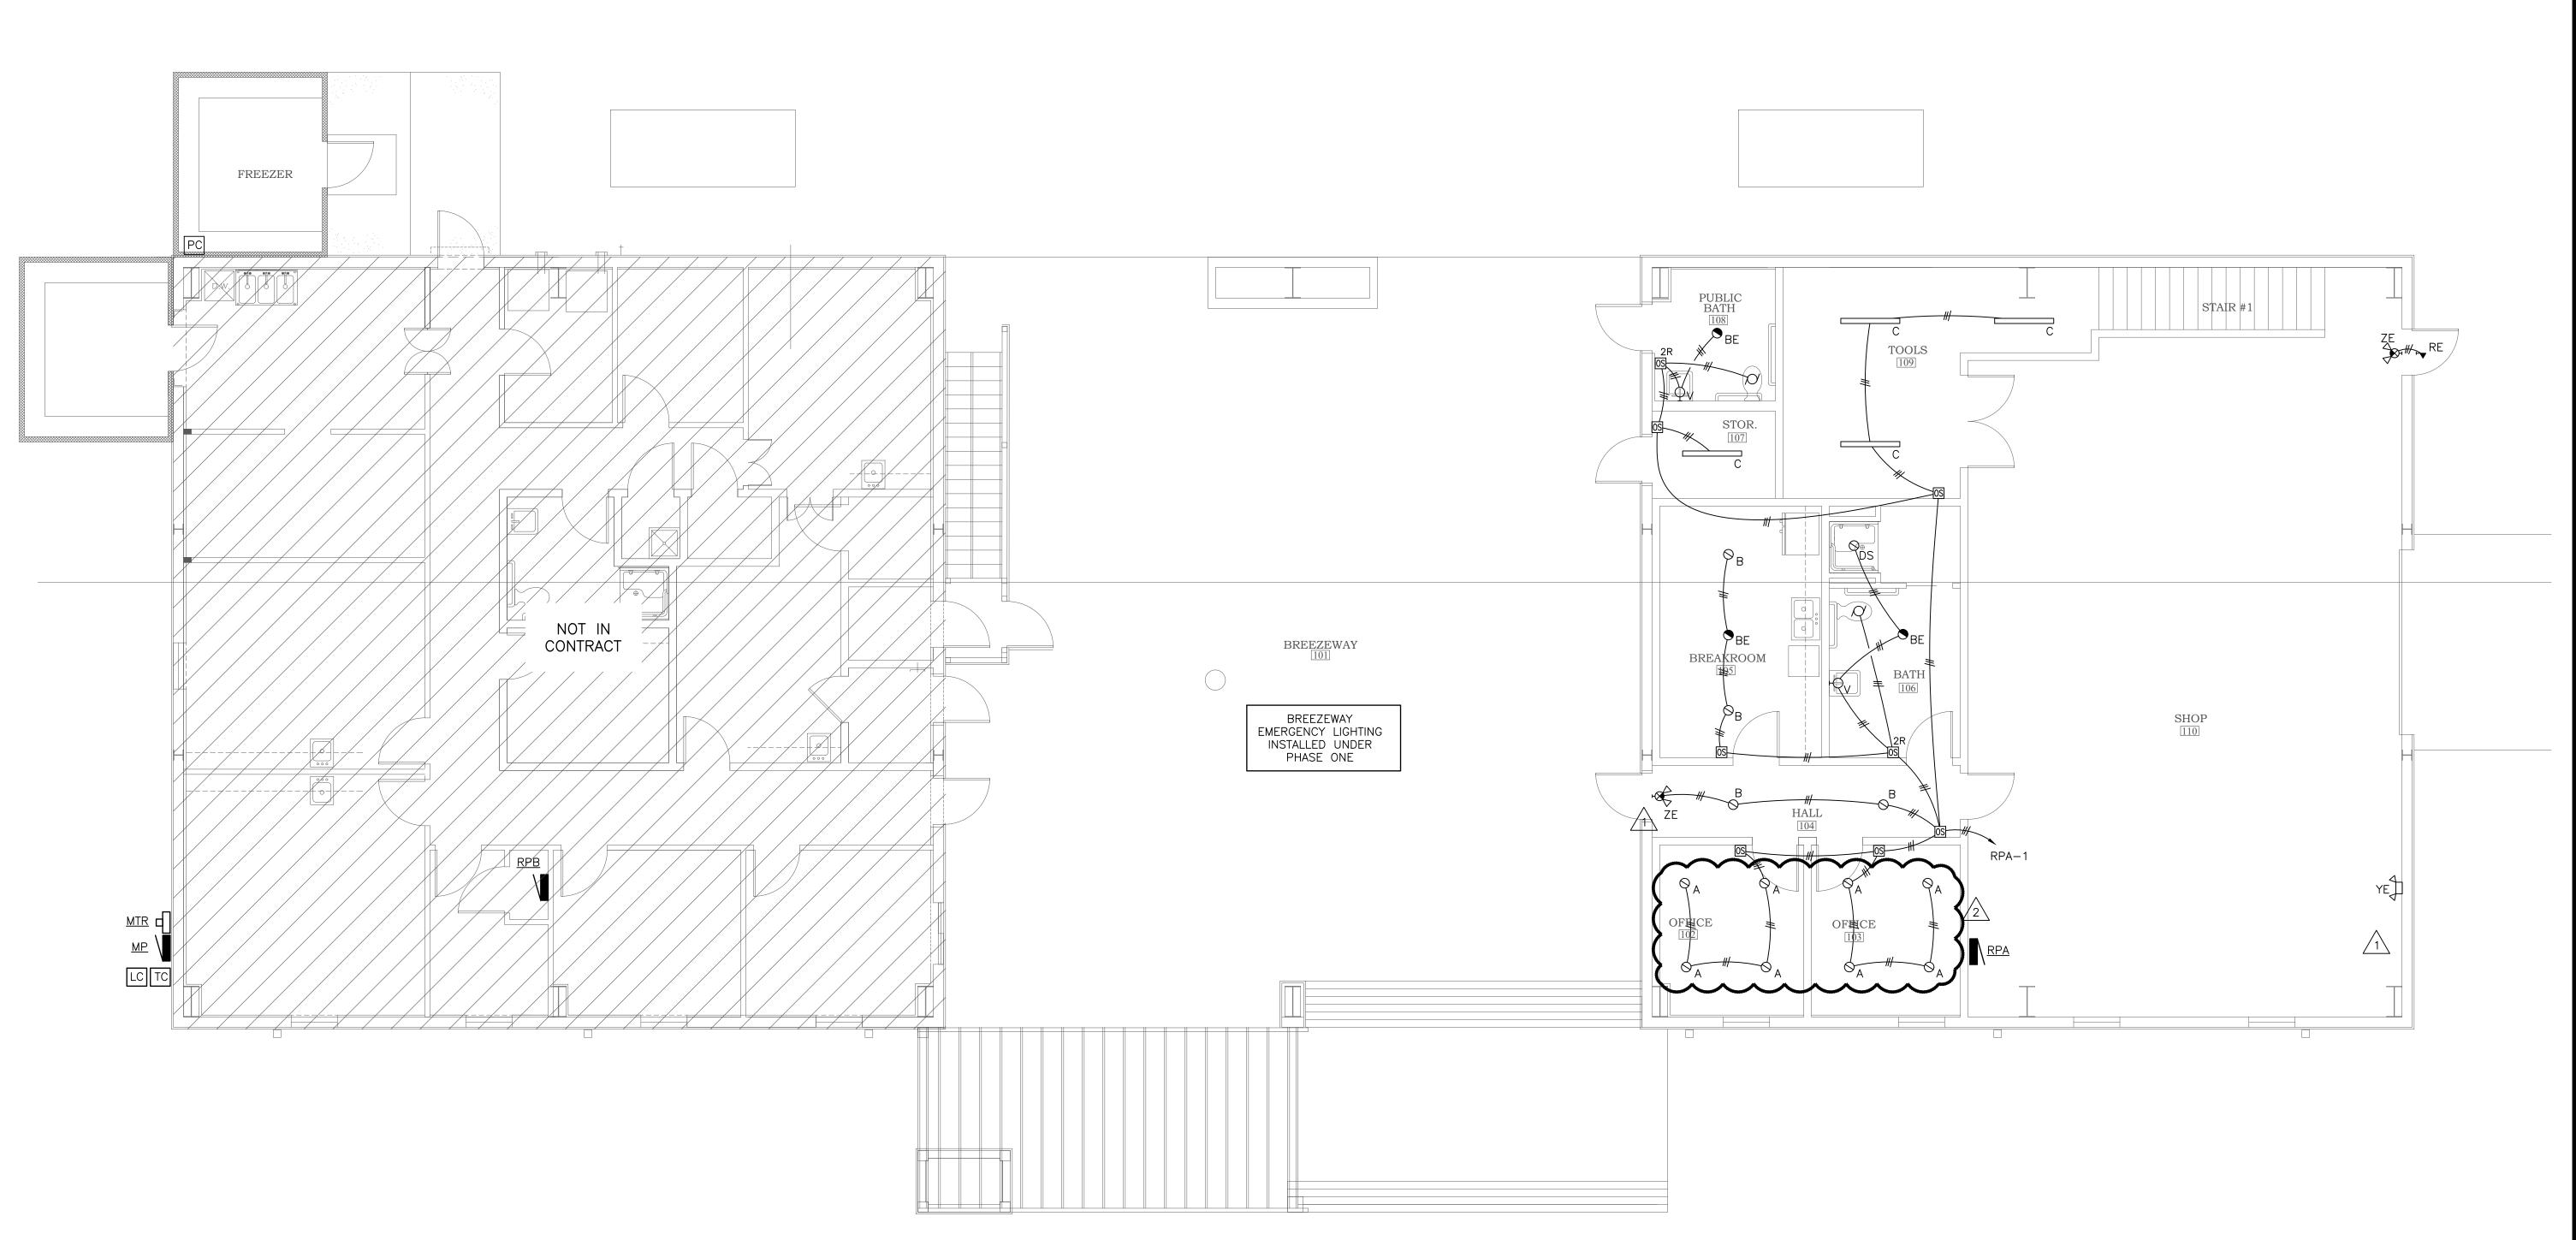





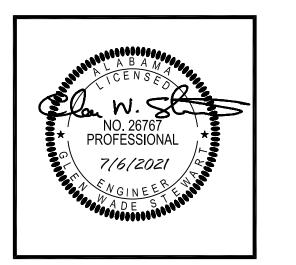


JOB NO.: DRAWN: CHECKED: 2021.04.22 DATE: REVISION:

> AS SHOWN SCALE:

SHEET NO.:


LIGHTING PLAN 2ND FLOOR ALTERNATES

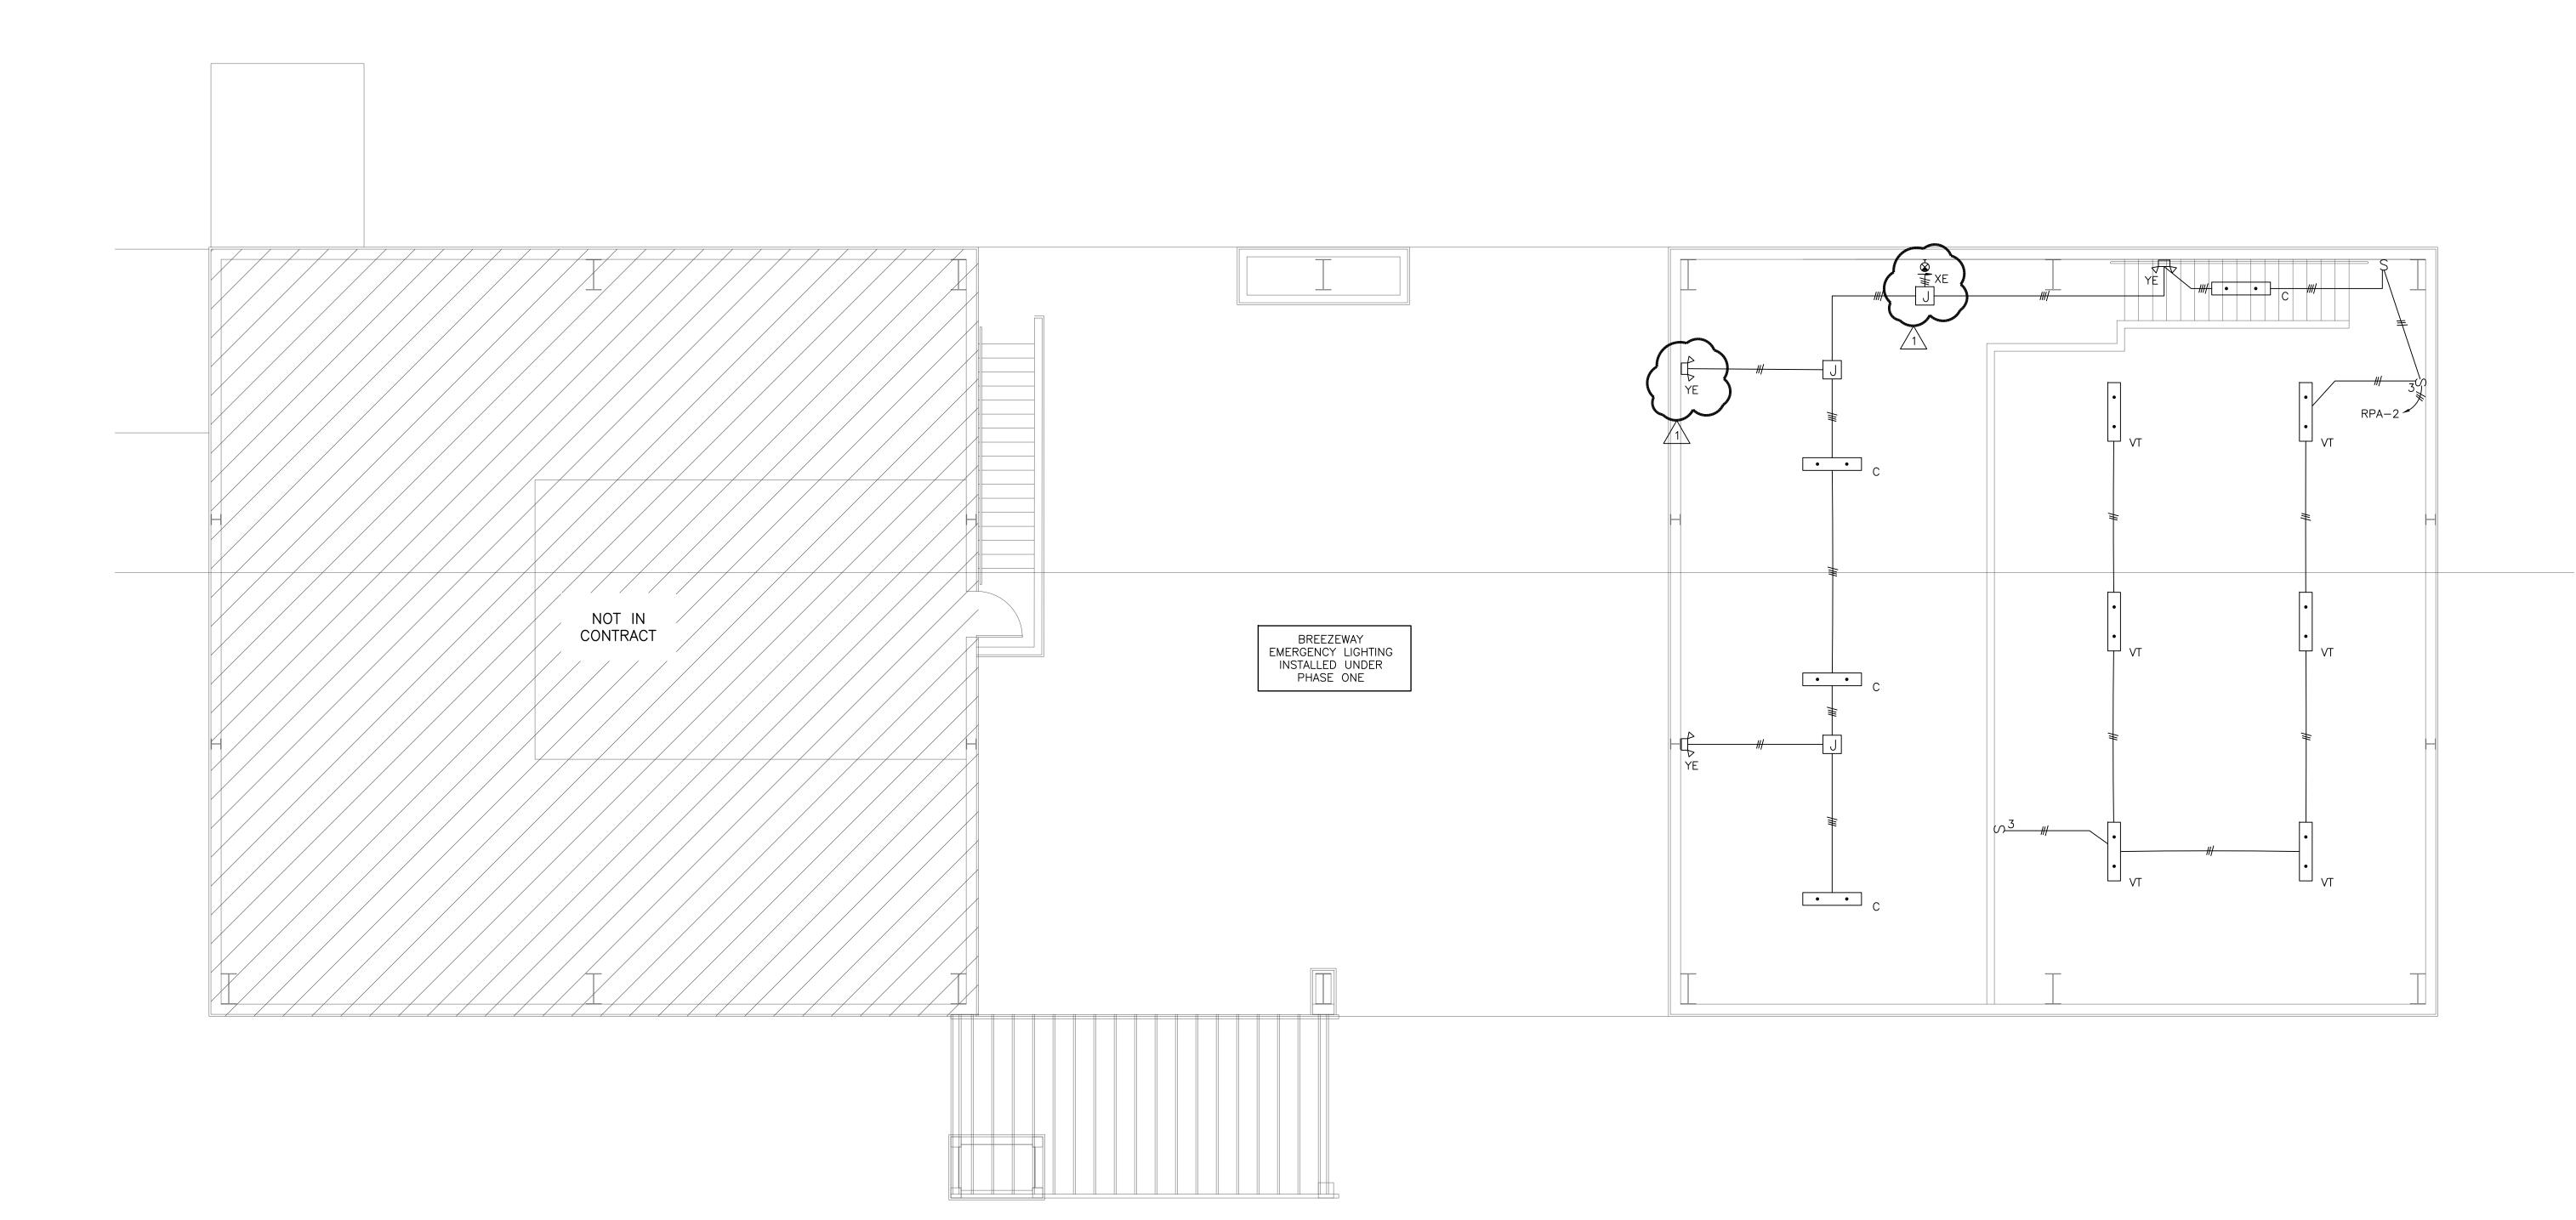



COPYRIGHT 2020, McCOLLOUGH ARCHITECTURE, INC

STEWART ENGINEERING

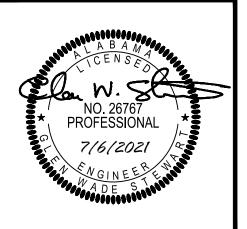

ALTERNATE 1 DRAWINGS FOR ORANGE BEACH

JOB NO.:
DRAWN: GWS
CHECKED: GWS
DATE: 2021.04.22
REVISION: 2022.01.04

SCALE: AS SHOWN


SHEET NO.:

E2.1

POWER & AUX FIRST FLOOR ALTERNATES





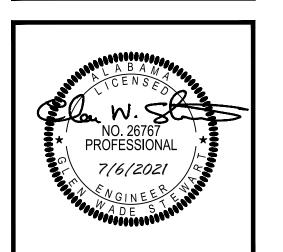

ALTERNATE I ORANGE B TRAIL S

DRAWN: CHECKED:

2021.04.22


GWS

REVISION:

AS SHOWN

SHEET NO.:


POWER PLAN SECOND FLOOR

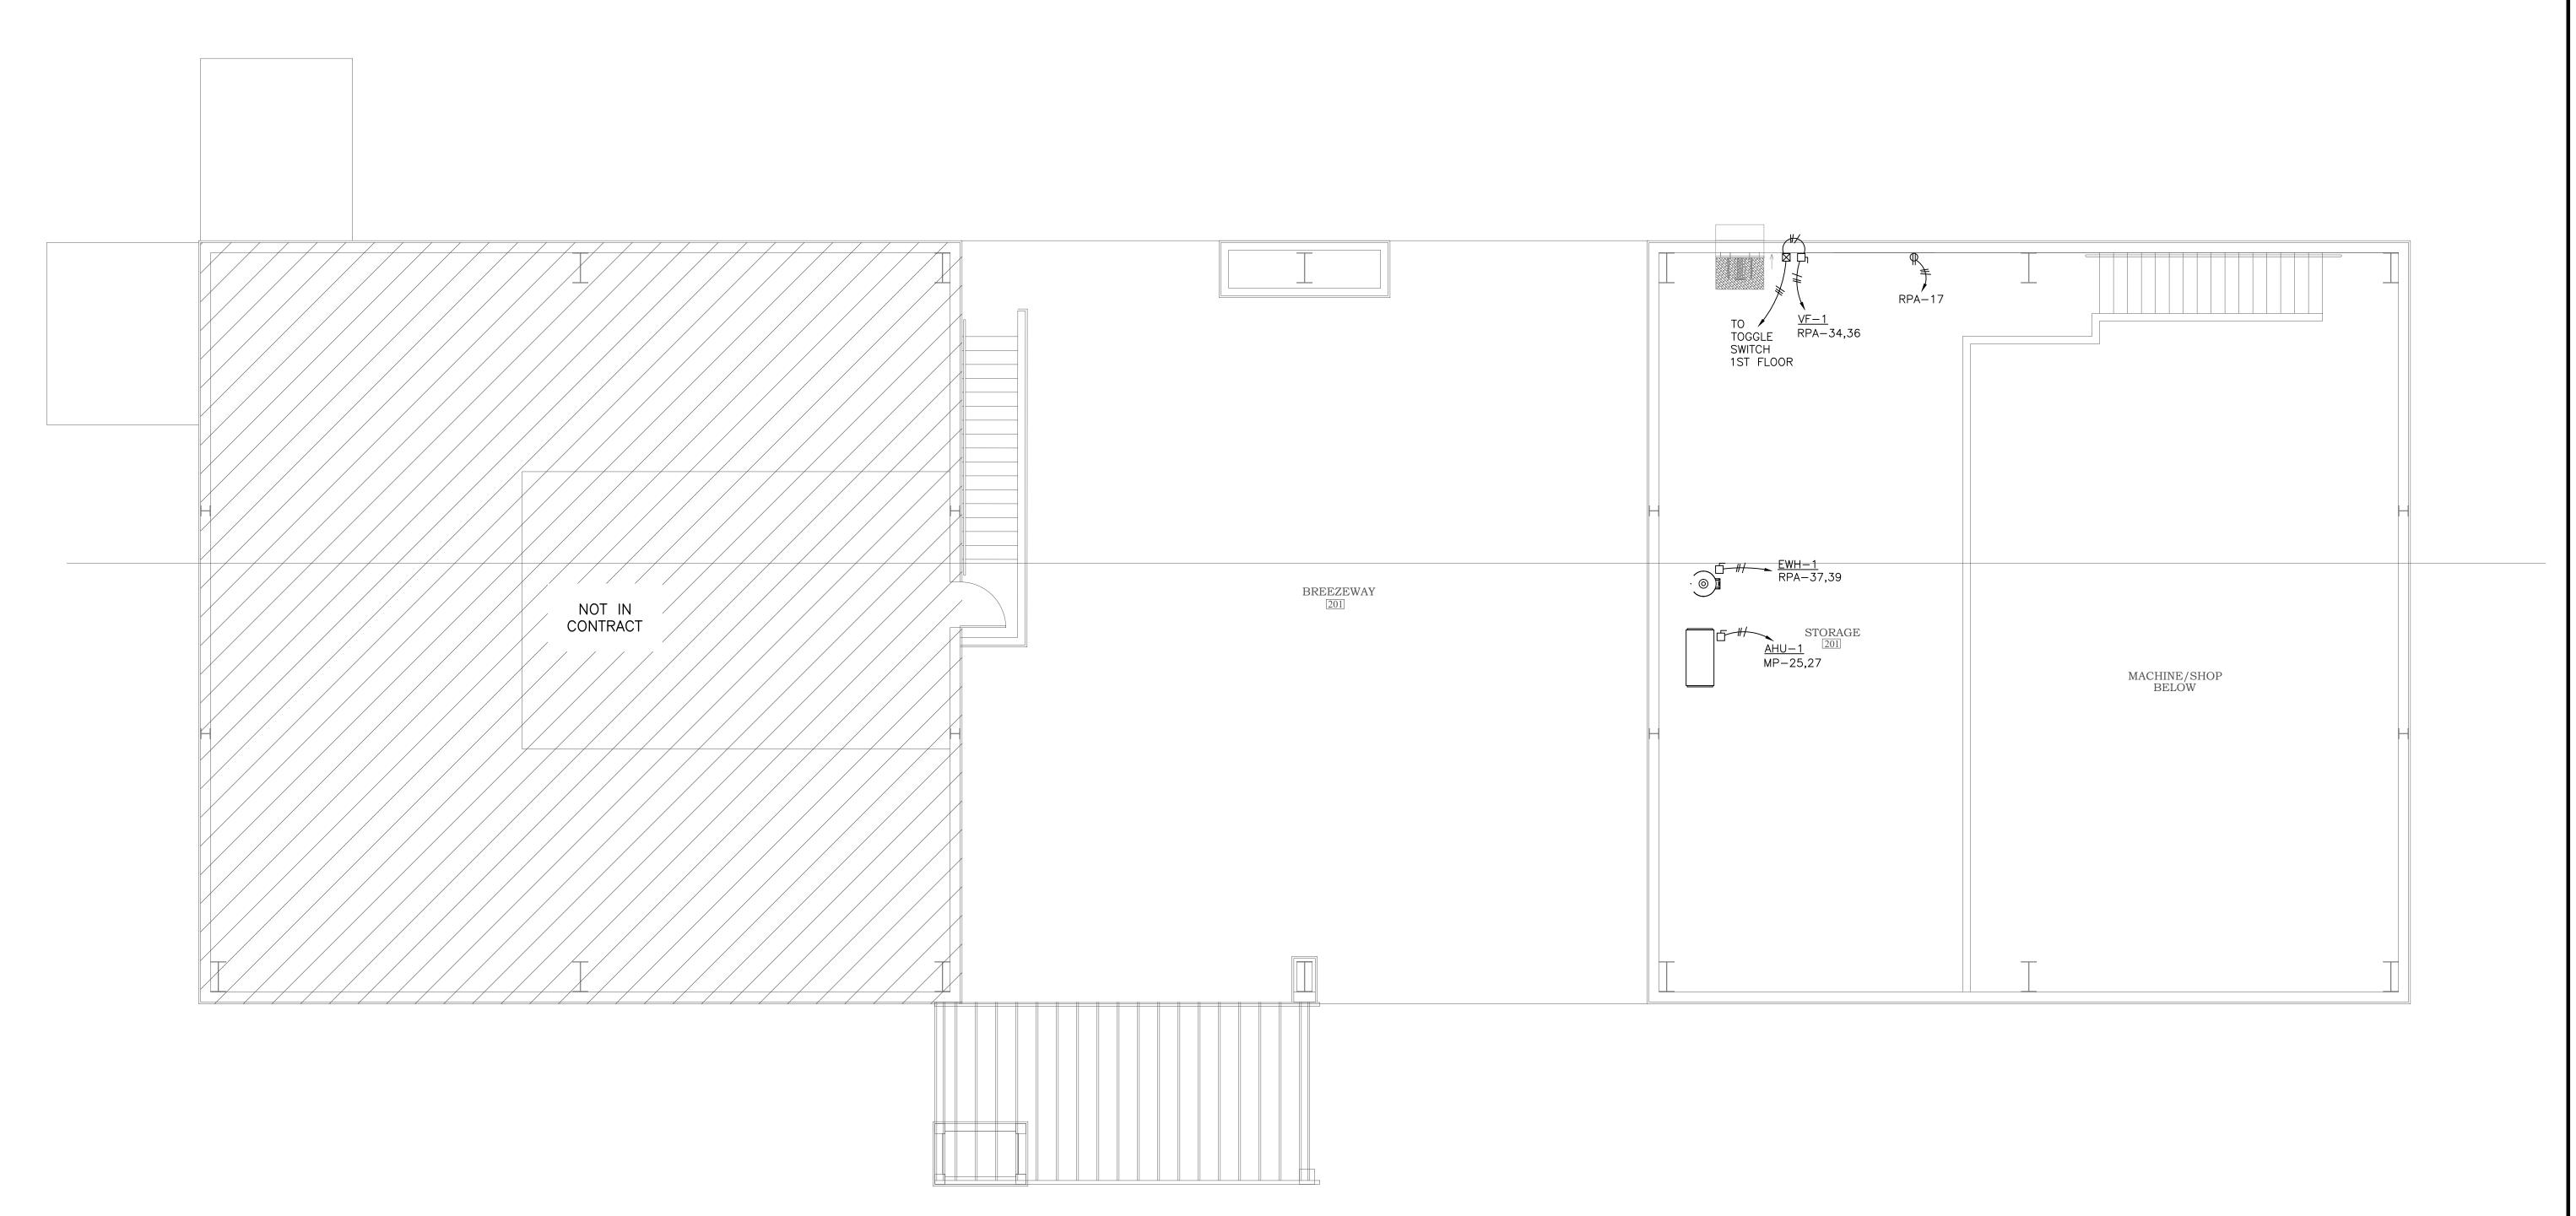








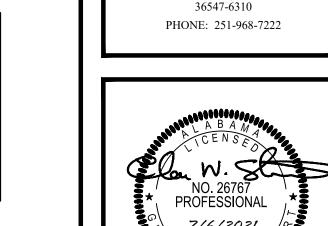


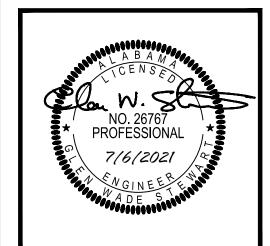

Architecture, Inc.

P.O. BOX 6310

GULF SHORES, ALABAMA

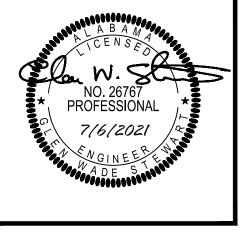

DRAWING LTERN ORA

OB NO.:	
RAWN:	GWS
HECKED:	GWS
ATE:	2021.04.22
EVISION:	


SCALE: AS SHOWN

SHEET NO.:

ELECTRICAL RISER

AND DETAILS

	RT ENGINEERING ONSTRUCTION
40680 ST	ATE HWY 59
BAY MINE	ETTE, ALABAMA 36507
` ,	313 (251)-937-1782 Fax stewartengineering.net

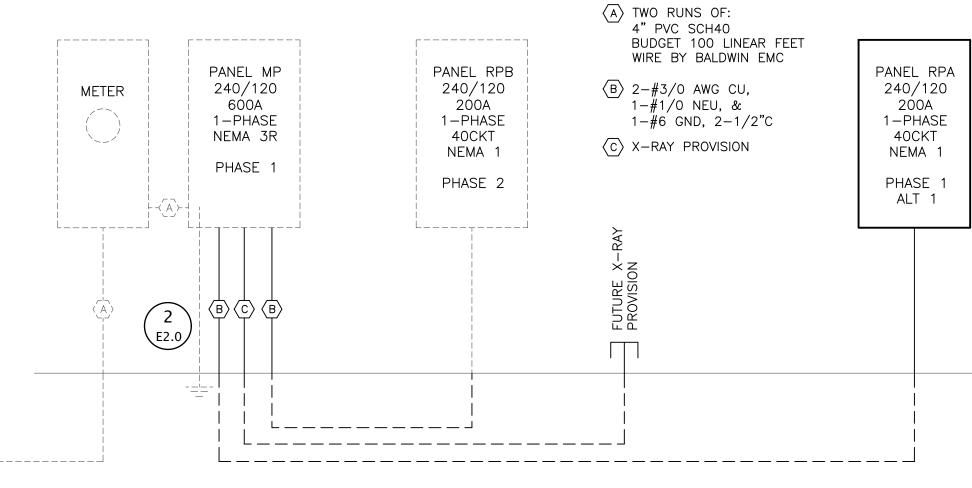

ELECTRICAL RISER

E2.0 SCALE: NONE

CONDUCTOR SCHEDULE

EQUIP. GND

#12

#10

#10

#10

#8

#8

#6

#4

#4

CONDUIT

3/4"

3/4"

3/4"

1-1/4"

1-1/4"

1-1/4"

1-1/4"

1-1/2"

2"

2"

2"

2-1/2"

CONDUCTORS / CONDUITS SHALL BE SIZED ACCORDING TO THE FOLLOWING CHART UNLESS

WIRE (AWG)

12

12

10

4

3

#1/0

#2/0

#3/0

#4/0

250KCMIL

600KCMIL

I. NEUTRAL CONDUCTOR (IF REQUIRED) SHALL BE THE SAME SIZE AS PHASE

2. ALL HVAC OR OTHER CYCLICAL EQUIPMENT SHALL UTILIZE HACR TYPE

3. CONTRACTOR TO PROVIDE QUANTITY OF CONDUCTORS AS NECESSARY TO 4. CONDUIT SIZES BASES ON FOUR CONDUCTORS MAXIMUM. CONTRACTOR SHALL FOLLOW NEC GUIDELINES FOR DERATING AMPACITIES AND CONDUIT

5. CONDUCTORS SHALL BE COPPER. INDICATED SIZES ARE FOR USE WITH

6. FOR BREAKERS SIZES NOT INDICATED SUCH AS 25A, COMPLY WITH NEC

7. CONTRACTOR SHALL COORDINATE THE REQUIRED NUMBER OF CONDUCTORS WITH EQUIPMENT MFR PRIOR TO ROUGH IN.

OTHERWISE NOTED.

CKT BKR

50

70

80

100

125

150

175

200

225

250

400


CIRCUIT BREAKERS.

COPPER CONDUCTORS.

SIZES FOR ALL COMBINED CIRCUITS.

SECTION 240.4 (PROTECTION OF CONDUCTORS.)

CONDUCTORS.

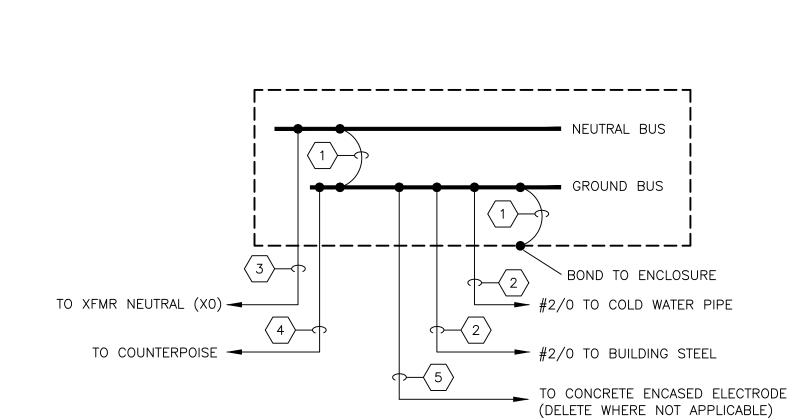

- #2/0 MAIN BONDING JUMPER
- 2 #2/0 GROUNDING ELECTRODE BONDING JUMPER CONNECTION
- SAME SIZE AS PHASE CONDUCTOR
- SUPPLEMENTAL GROUNDING ELECTRODE BONDING JUMPER SIZED AT #6 AWG (SIZE PER NEC 250.66 IF WATER PIPE AND BLDG. STEEL NOT AVAILABLE)

E2.0 SCALE: NONE

5 SIZE PER NEC 250.66 BUT NO LARGER THAN #4 THHN 2 MAIN SERVICE GROUNDING

					110	HTING FIX	TURE SCHEDULE													_
						T	TONE SOMEDOLE						MOL	JNT T	YPE					
		ELECT	RICAL DATA		LAMP DATA		BASIS OF DESIGN			L	OCATIO	NC				Al	RRANG	EMEN	Т	
ID	DESCRIPTION	LOAD VA	VOLTAGE	QTY	LUMENS	MANUFACTURER	MODEL OR SERIES	CEILING	FLOOR	GROUND	POLE	ROOF	SUSPENDED	WALL	FLUSH	PEDESTAL	PENDANT	RECESSED	SURFACE	TRACK
Α	DOWN LIGHT	20	120	-	1500	LITHONIA	LDN6 40/15 LO6AR LS													
В	DOWN LIGHT	20	120	-	2000	LITHONIA	LDN6 40/20 LO6AR LS													
BE	DOWN LIGHT	20	120	_	2000	LITHONIA	LDN6 40/20 LO6AR LS ELSD													
С	STRIP	15	120	-	1500	LITHONIA	ZL1N L24 1500LM FST MVOLT 4000K 80 WH													
D	2X4 TROFFER	49	120		5400	LITHONIA	EPANL 2X4 5400 80CRI 40K													
DE	2X4 TROFFER	49	120		5400	LITHONIA	EPANL 2X4 5400 80CRI 40K E10WCP													
F	2X2 TROFFER	31	120		3400	LITHONIA	EPANL 2X2 3400 80CRI 40K													
FE	2X2 TROFFER	31	120		3400	LITHONIA	EPANL 2X2 3400 80CRI 40K E10WCP													
٧	VANITY	20	120	-	ı		ALLOWANCE \$150													
VT	VAPORTIGHT	116	120	-	15000	LITHONIA	VAP 15000LM PCL WD 40K 80CRI													
W	WALL PACK	30	120	-	4000	LITHONIA	ARC2 LED P4 40K MVOLT DDBXD													
RE	REMOTE EGRESS	6	120	_	ı	EMERGI-LITE	EF44-2-LED-WP													
YE	EMERGENCY LIGHT	1	120	_	П	EMERGI-LITE	EL-2LED (LITE-2-LG-FINISH-N)													
ZE	EXIT/EMER. COMBO	1	120	_	Т	EMERGI-LITE	ELXN400-G-2LED-R													

			F	PANEL		Mf)				
/OLTAGE	(L-N):	120				ENCLOSURE	TYPE:	NEMA 3F	₹		
OLTAGE		240				MOUNTING:		SURFACE			
HASES, Y		1 φ, 3	W			AIC RATING	:	10000			
IINIMUM	BUS CAPACITY (A):	600 A				NOTES:					
IAIN O.C.	DEVICE (A):	600 A				1					
CKT NO	DESCRIPTION	TRIP AMPS	POLE		PHASE L A	OADS (VA)	В	POLE	TRIP AMPS	DESCRIPTION	CKT N
1,3	AHU-2	30	2	3360	102		_	1	20	LGTS, EXT.	2
1,3	AHU-2	30	2			3360	1548	1	20	LGTS, BREEZEWAY	4
5,7	AHU-3	30	2	3360	0			2	20	SPACE	6,8
5,7	AHU-3	30	2			3360	0	2	20	SPACE	6,8
9,11	SPACE	20	2	0	0			2	20	SPACE	10,12
9,11	SPACE	20	2			0	0	2	20	SPACE	10,12
13,15	SPACE	20	2	0	0			2	20	SPACE	14,16
13,15	SPACE	20	2			0	0	2	20	SPACE	14,16
17,19	SPACE	20	2	0	0			2	20	SPACE	18,20
17,19	SPACE	20	2			0	0	2	20	SPACE	18,20
21,23	SPACE	20	2	0	0			2	20	SPACE	22,24
21,23	SPACE	20	2			0	0	2	20	SPACE	22,24
25,27	AHU-1	30	2	3360	1920			2	25	HP-1	26,28
25,27	AHU-1	30	2			3360	1920	2	25	HP-1	26,28
29,31	PANEL RPA	200	2	17025	0			2	40	HP-2	30,32
29,31	PANEL RPA	200	2	4.4000	4500	14676	0	2	40	HP-2	30,32
33,35	PANEL RPB	200	2	14980	4560	10001	4500	2	60	HP-3	34,36
33,35 37,39	PANEL RPB SPARE	30	2	0		12004	4560	2 2	60 30	HP-3 GP-1	34,36 38,40
37,39	SPARE	30		U	0	0	0	2	30	GP-1 GP-1	38,40
37,39	SPARE	30	2	CONNEC	TED LOAD	PHASE TOTA	_	 2	30	GP	30,40
					667		788				
				CONNEC ⁻ LOAD (K	. 0	MAND DEM CTOR	IAND LOAD (KVA)			DEMAND LOAD 82.5 KVA SPARE CAPACITY 61.5 KVA	
	Lighting — Exterior			1.6		.25	2.1			SPARE CAPACITY 256.1 AMPS	
	Motors			0.0		.00	0.0			SPARE CAPACITY 43%	
	Motors (Largest)			1.5		.25	1.9				
	Receptacles (0 - 10 KVA)			10.0		.00	10.0	1			
	Receptacles (Over 10 KVA)			25.1		.50	12.6				
	Cooling and Heating			13.0		.00	13.0				
	Equipment			9.6		.00	9.6				
	Heating			29.2		.00	29.2				
	Lighting			3.5		.25	4.3				
	TOTAL:			93.5			82.5	_			
	LOAD (AMPS):			389.4			343.9				

			F	PANEL		RP	PΑ					
VOLTAGE (L-N):	120				ENCLOSUR	E TYPE:	NEMA 1				
VOLTAGE (L-L):	240				MOUNTING:		SURFACE	Ī			
PHASES, V		1 φ, 3	W			AIC RATING	} :	10000				
MINIMUM E	BUS CAPACITY (A):	200 A				NOTES:		_				
MAIN O.C.	DEVICE (A):	200 A										
CKT NO	DESCRIPTION	TRIP AMPS	POLE		PHASE L	OADS (VA)	В	POLE	TRIP AMPS	DESCRIPT	ION	CKT N
1	LGTS, 101-109	20	1	399	1130			1	20	LGTS, 110		2
3	LGTS, BREEZEWAY	20	1			0	0	1	20	LGTS, EXTERIOR		4
5	SPARE	20	1	0	0			1	20	SPARE		6
7	REC, 102-4	20	1			1260	800	1	20	REC, 105/107/109		8
9	REC, 105 REF	20	1	1500	1500			1	20	REC, 105 CNTR		10
11	REC, 105 GARBAGE DISP.	20	1			500	1500	1	20	REC, 105 CNTR		12
13	REC, 105 CNTR	20	1	1500	1500			1	20	REC, 105 CNTR		14
15	REC, 106	20	1			1500	200	1	20	REC, 108		16
17	REC, EXT. & MEZZ	20	1	400	180			1	20	REC, WORK SHOP		18
19	REC, WORK SHOP	20	1		,	180	180	1	20	REC, WORK SHOP		20
21	REC, WORK SHOP	20	1	180	180			1	20	REC, WORK SHOP		22
23	REC, WORK SHOP	20	1			180	200	1	20	REC, WORK SHOP		24
25	REC, WORK SHOP	20	1	200	200			1	20	REC, WORK SHOP		26
27	REC, WORK SHOP	20	1			200	180	1	20	REC, TOOL RM		28
29	REC, BREEZEWAY TV	20	1	180	180			1	20	REC, TOOL RM		30
31	SPARE	20	1			0	0	1	20	SPARE		32
33,35	SPARE	30	2	0	746			2	20	VF-1		34,36
33,35	SPARE	30	2			0	746	2	20	VF-1		34,36
37,39	EWH-1	30	2	2250	4800			2	50	WELDER		38,40
37,39	EWH-1	30	2			2250	4800	2	50	WELDER		38,40
	•			CONNEC	CTED LOAD	PHASE TOTA	ALS (VA)					
				17	025	14	676					
				CONNEC		ואו וואו	MAND LOAD			DEMAND LOAD	30.2 KVA	
	Matara			LOAD (K		CTOR	(KVA)			SPARE CAPACITY	17.8 KVA	
	Motors Motors (Largest)			0.0		.00	0.0			SPARE CAPACITY	74.3 AMPS 37 %	
	Receptacles (0 - 10 KVA)			1.5		.25	1.9			SPARE CAPACITY	31%	
	Receptacles (0 - 10 KVA) Receptacles (Over 10 KVA)			10.0		.00	10.0	ı				
	Equipment			4.6		0.50	2.3					
	Heating			9.6		.00	9.6					
	Lighting			4.5 1.5		.00 .25	4.5 1.9					
	TOTAL:			31.7			30.2	-				
	LOAD (AMPS):			132.1			125.7					

PANELBOARD SCHEDULE AND DETAIL NOTES:

- PANELBOARD & PANELBOARD INSTALLATION SHALL BE IN ACCORDANCE WITH NFPA 70, ART. 384. ALL PANELBOARDS SHALL BE UL LISTED AND INSTALLED IN ACCORDANCE WITH THIS LISTING AND FULLY SUPPORTED BY MEANS DESIGNED FOR THAT LISTED INSTALLATION. ALL CLEARANCES REQUIRED BY CODE SHALL BE MAINTAINED AS MINIMUM.
- 2. EACH PANELBOARD SHALL BE FURNISHED COMPLETE WITH THE PROPERLY SIZED CAN, INTERNAL HARDWARD, DEVICES, COMPONENTS, SUPPORTING STRUCTURES, ETC., FOR A COMPLETE INSTALLATION TO PROVIDE THE DESIGNED PERFORMANCE UNDER THE AMBIENT CONDITIONS ENCOUNTERED. ALL DEVICES, COMPONENTS, FITTINGS, SUPPORTS, ETC., SHALL BE COORDINATED TO PROVIDE A COMPLETE UL LISTED INSTALLATION. ALL DEVICES INSTALLED SHALL HAVE AN INTERRUPTING RATING GREATER THAN OR EQUAL TO THE SPECIFIED SCCR.
- 3. EACH PANELBOARD SHALL BE FURNISHED WITH A GROUND BAR BONDED TO THE PANEL ENCLOSURE. THIS GROUND BUS SHALL BE UTILIZED TO BOND ALL GROUNDING PROVISIONS IN ORDER TO ESTABLISH EQUAL POTENTIAL TO ALL GROUNDED COMPONENTS OF THE POWER SYSTEM.
- 4. PANELBOARD CANS SHALL BE RIGID AND CONTAIN KNOCKOUT PROVISIONS TO FACILITATE THE TERMINATION OF THE NUMBER AND SIZE OF CONDUIT SYSTEMS REQUIRED.
- 5. THE TERMINATION POINT OF THE FEEDER SERVING EACH ASSEMBLY SHALL BE AT THE NEAREST POINT OF FEEDER ENTRY TO MINIMIZE CONDUCTOR FILL IN THE CAN. COORDINATE TOP AND BOTTOM FEED PANELBOARD PROVISIONS WITH EACH FEEDER INSTALLATION.
- PROVIDE THE PROPERLY SIZED CONDUCTOR TERMINATION POINTS OR LUGS (MULTIPLE LUGS WHEN PARALLEL FEEDERS ARE USED) FOR THE NUMBER AND SIZE CIRCUITS INDICATED.
- 7. CONDUCTORS, SPLICES AND TERMINATIONS SHALL BE ACCESSIBLE. ONLY CONDUCTORS RATED AND SIZED FOR THE TEMPERATURE OF THE TERMINATION SHALL BE USED.
- 8. PANELBOARDS SHALL NOT BE INSTALLED IN CONTACT WITH COMBUSTIBLE MATERIALS. ADEQUATE SPACE FOR AIR CIRCULATION AND CODE COMPLIANCE SHALL BE PROVIDED AS A MINIMUM. FURNISH SPACERS, WASHERS, SUPPORTING DEVICES, ETC., AS REQUIRED TO MAINTAIN PROPER CLEARANCES.
- 9. ALL FLUSH MOUNTED PANELBOARDS SHALL BE PROVIDED WITH FOUR (4) 1" EMPLY SPARE CONDUITS TO ABOE THE NEAREST ACCESSIBLE CEILING.

— — — DHC PIPING ——SAN —— WASTE PIPING

— — — DHW PIPING

----V---- VENT PIPING GAS PIPING

— TP — TRAP PRIMER PIPING

——WET —— FIRE WATER WET PIPING

PIPE TURNING DOWN

BALL VALVE

GATE VALVE

CHECK VALVE

PIPE TURNING UP

TEMP/PRESSURE RELIEF VALVE

CLEANOUT

FLOOR DRAIN

FLOOR SINK

WATER HAMMER ARRESTOR TYPE "A" (TYP)

PLUMBING ABBREVIATIONS

ALL ABBREVIATIONS SHOWN MAY NOT APPEAR IN DRAWINGS. REFER TO HVAC DRAWINGS FOR HVAC EQUIPMENT ABBREVIATIONS.

ABOVE FINISHED FLOOR

AUXILIARY CEIL CEILING

CIRC CIRCULATING CO CLEANOUT

COLD WATER

DOMESTIC COLD WATER DOMESTIC HOT CIRCULATED

DOMESTIC HOT WATER

DEEP SEAL TRAP

DST **EQUIP** EQUIPMENT

ELECTRIC WATER COOLER

ELECTRIC WATER HEATER

FLOOR CLEANOUT

FLOOR DRAIN FIXT FIXTURE

GAS WATER HEATER

HOSE BIBB HOUR

HOT WATER

HOT WATER RETURN

MAX MAXIMUM MECH MECHANICAL

MIN MINIMUM MTR METER

NOT IN CONTRACT

PENE PENETRATION RM ROOM

SAN SANITARY SURF SURFACE

SYS SYSTEM T & P TEMPERATURE & PRESSURE

TEMPERATURE

TRAP PRIMER TYPICAL

VENT TO ROOF

WALL CLEANOUT

WET PIPNG WALL HYDRANT

WATER HAMMER ARRESTOR

WITH YCO YARD CLEANOUT

	PLUMBING FIXTURE SCHEDULE (PHASE 1 ALTERNATE 1)
ID	DESCRIPTION
CB-1	ICE MAKER WATER CONNECTION. USE SIOUX CHIEF ICE MAKER OUTLET BOX WITH MINIRESTER 696 SERIES WITH 1/2" PEX CONNECTION; MOUNT @ 48" U.N.O. FURNISH FLEXIBLE CONNECTION FROM OUTLET BOX TO WALL MOUNTED WATER FILTER WITH FLEXIBLE CONNECTION TO APPLICANCE. WATER FILTER SHALL BE EQUAL TO WHIRLPOOL WHKF—DWHV OR EQUAL. FURNISH WITH ONE EXTRA FILTER. VERIFY WITH OWNER/CONTRACTOR. APPLIANCES FURNISHED BY OTHERS.
EWC-1	EWC-1, ELECTRIC WATER COOLER, SPLIT LEVEL, WALL MOUNTED WITH BOTTLE FILLER ELKAY LZSTL8WSVRSK OR EQUAL WITH BOTTLE FILLER/FOUNTAIN ON LEFT AT ADA LEVEL; MCGUIRE 8902 TRAP; BRASSCRAFT 1912-A SUPPLY. MOUNT WITH LOWER SPOUT AT 36" AFF. CONNECTIONS: CW 1/2", WASTE 2", VENT 2" MIN.
FD-1	FLOOR DRAIN, J.R. SMITH 2005/2010 SERIES COATED CAST IRON BODY WITH ADJUSTABLE COLLAR, COMBINATION MEMBRANE CLAMP. PROVIDE WITH 6" ROUND, POLISHED NICKEL BRONZE STRAINER AND GREEN DRAIN TRAP SEAL.
HB-1	HOSE BIBB, OUTDOOR TYPE, ZURN Z-1320 WITH CERAMIC DISC, NON-FREEZE, ENCASED, ANTI-SIPHON, AUTO DRAIN, S.S. BOX & HINGED COVER, KEY LOCK, ALL BRONZE INTERIOR PARTS. COVER STAMPED "WATER".
MS-1	MOP BASIN - ZURN Z1996-24 COMPOSITE MOP SINK WITH INTEGRAL 3" DRAIN; Z1996-SF SERVICE FAUCET WITH PALE HOOK, -SDL DRAIN, STRAINER & LINT BASKET, -MH MOP HANGER, -HH HOSE & BRACKET, -BV VINYL BUMPER GUARDS, -WG SS WALL GUARD. COORDINATE WITH GENERAL CONTRACTOR TO INSURE THAT 2" THICK BLOCKING IS PROVIDED IN WALL FOR FAUCET MOUNTING. CONNECTIONS: CW 1/2", HW 1/2" (140°F), WASTE 3", VENT 2" MIN.
SH-1	SHOWER, ARRAY ADA3636, W/ CENTER DRAIN AS DESIGNATED IN PLAN DWGS, SHOWER, SOLID—SURFACE, SMOOTH SHOWER, SOAP HOLDER, GRAB BARS, FOLDING SEAT, ZURN Z7301—SS—MT—DV2P—HW—H7—S8 TEMP—GARD III SHOWER UNIT KIT WITH SINGLE HANDLE PRESSURE BALANCING & MIXING UNIT, 1.5 GPM SHOWER HEAD, FLEX METAL HOSE, INLINE VACUUM BREAKER, WALL CONNECTION, FLANGE AND WALL HOOK FOR HAND SHOWER, PRESSURE BALANCING MIXING VALVE WITH ADJUSTABLE STOP SCREW TO LIMIT HANDLE TURN, 2.5 GPM SHOWER HEAD WITH ARM AND FLANGE. CONNECTIONS: CW 1/2", HW 1/2" TEMPERATURE LIMITING TO 110°F, WASTE 2", VENT 1—1/2" MIN.
SK-1	KITCHEN SINK, ELKAY CR3322, 20 GAUGE, STAINLESS STEEL, DOUBLE BOWL, 7" DEPTH, DROP IN TYPE, FURNISH WITH ELKAY LKD2437BHC GOOSENECK FAUCET WITH LEVER HANDLES AND GRID WASTE. PROVIDE 1-1/2" P-TRAP AT EXISTING SAN CONNECTION, NEW 1/4" FLEXIBLE SUPPLIES AND WATER STOPS. INCLUDE 1/4" FLEXIBLE SUPPLY CONNECTION TO REFRIGERATOR ICE MAKER UNIT. ROUTE TUBING CONCEALED IN BASE CABINET. STRAP TUBING TO REAR OF CABINET. EXISTING CONNECTIONS: CW 1/2", HW 1/2", WASTE 1 1/4". FURNISH WITH TEMPERATURE LIMITING DEVICE SET FOR 110°F
SK-3	3 COMPARTMENT SINK — PROVIDED BY OWNER, INSTALLED BY CONTRACTOR. COORDINATE EXACT REQUIREMENTS PRIOR TO ROUGH—IN.
WC-1H	WC-1H WATER CLOSET, ZURN SERIES Z5660, <u>FLOOR MOUNTED</u> , ELONGATED WATER CLOSET, ZURN Z6000AV-WS1 (1.6 gpf) FLUSH VALVE W/ SPLIT RING PIPE SUPPORT, & ZURN Z5955SS-EL OPEN FRONT SEAT WITHOUT COVER MOUNT FIXTURE AT ADA HEIGHT WITH RIM AT 16-3/4" AFF. CONNECTIONS: CW 1", WASTE 3", VENT 2" MIN.
FS-1	FLOOR SINK, MIFAB FS1520-FLC-3-P, 8" SQUARE, 6" DEEP, CAST IRON, A.R.E. INTERIOR ALUMINUM DOME STRAINER, STAINLESS STEEL TOP W/CLAMPING DEVICE. FURNISH WITH PRO-SET TRAP SEAL. COORDINATE EXACT LOCATION OF DRAIN WITH ARCHITECTURAL PLANS SO AS TO CENTER FLOOR DRAIN CENTER OF TILE. FLOOR SHALL BE SLOPED TOWARD DRAIN.
HS-1	HAND SINK, ELKAY CR1721, 20 GAUGE, STAINLESS STEEL, SINGLE BOWL, DROP IN TYPE, FURNISH WITH ELKAY LK800GN05T4 GOOSENECK FAUCET WITH LEVER HANDLES AND GRID WASTE. PROVIDE 1-1/2" P-TRAP AT EXISTING SAN CONNECTION, NEW 1/4" FLEXIBLE SUPPLIES AND WATER STOPS. CONNECTIONS: CW 1/2", HW 1/2", WASTE 1 1/4". FURNISH WITH TEMPERATURE LIMITING DEVICE SET FOR 110°F
LV-1H	ZURN Z5840 SERIES WITH VITREOUS CHINA CONSTRUCTION AND 4" FAUCET CENTERS; ZURN Z81104-XL FAUCET WITH LEVER HANDLES, ZURN Z8800 SUPPLIES; ZURN Z8700 TRAP; Z8746-PC ADA GRID STRAINER; ZURN Z8946-3-NT ADA PROTECTORS, ASSE 1070 APPROVED TEMPERATURE LIMITING VALVE SET TO 110°F, ZURN Z1231 CONCEALED ARM CARRIER, CONNECTIONS: CW 1/2", HW 1/2", WASTE 1 1/4". MOUNT AT 34" TOP OF RIM FOR ADA REQUIRED MOUNTING HEIGHT.
MV-1	MIXING VALVE, EQUAL TO SYMMONS, 0.5 GPM MINIMUM, 5.5 GPM MAXIMUM @ 10 PSI PRESSURE DROP

							WATER HE	EATER SCH	EDULE				
		ELECT	RIC DATA				HYDRONIC	DATA					
TAG	FLA	МОСР	VOLT PHASE	KW	EWT	LWT	RATE OF RECOVERY	RISE OF RECOVERY	CAPACITY (GAL)	BASIS	OF DESIGN	WEIGHT	NOTES
	AMPS	AMPS	PHASE		DEG.F	DEG.F	GPM	DEG. F	(GAL)	MFGR	MODEL	LBS	
EWH-1	28	30	240/1	4	60	140	0.33	80	40	RHEEM	ELD40	108	ALL

LNOTES:
110 20

. 3/4" INLET OUTLET CONNECTIONS

2. SUPPLY 140°F WATER TO MOP SINK AND 110°F WATER TO LAVATORIES. LAVATORIES SHALL BE EQUIPPED WITH INDIVIDUAL TEMPERATURE

LIMITING DEVICES THAT CONFORM WITH ASSE 1070. 3. OPERATING PRESSURE BETWEEN 20PSI TO 150 PSI

PUMP SHALL BE SUITABLE FOR POTABLE WATER USE.

4. 1/2" INLET OUTLET CONNECTIONS 5. INSTALL HOT WATER CIRC. PUMP RATED FOR 5 GPM, 20 FT HEAD PRESSURE, 120VAC, 1/12 HP, WITH AQUASTAT.

			НС	OT WATER RECIRCULATION PU	MP SCHEDULE				
MARK RCP	CONTROL WITH	CAPACITY (GPM)	TOTAL HEAD (FT)	PUMP CONSTRUCTION	MOTOR (HP)	VOLTS	Hz	PHASE	NOTES
1	AQUASTAT	5	20	STAINLESS STEEL	1/5	120	60	1	1, 2, 3, 4
NOTES									
1	COORDINATE ALL	ELECTRICAL REC	QUIREMENTS WITH THE	ELECTRICAL CONTRACTOR.					
2	PROVIDE WITH AQ	UASTAT WITH A	TEMPERATURE SETPOII	NT OF 110F.					
3	PROVIDE WITH 24 I	HOUR TIME CLOC	CK. PUMP SHALL OPER	ATE DURING OCCUPIED HOUR	S, ELSE IT SHALL B	E OFF.			

COPYRIGHT 2020, McCOLLOUGH ARCHITECTURE, INC.



GENERAL PLUMBING NOTES:

- 1. COMPLY WITH 2018 INTERNATIONAL MECHANICAL & PLUMBING CODE, NFPA, STATE AND LOCAL CODES.
- 2. PLUMBING CONTRACTOR SHALL OBTAIN AND PAY FOR ALL REQUIRED PERMITS AND INSPECTION CERTIFICATES.
- 3. OMISSIONS OR MISDESCRIPTION OF DETAILS OF WORK WHICH ARE EVIDENTLY NECESSARY TO CARRY OUT THE INTENT OF THE DRAWINGS, OR WHICH ARE CUSTOMARILY PERFORMED, SHALL NOT RELIEVE THE CONTRACTOR FROM PERFORMING SUCH OMISSIONS AND DETAILS OF WORK, BUT THEY SHALL BE PERFORMED AS IF FULLY AND CORRECTLY SET FORTH & DESCRIBED.
- PORTIONS OF WALLS AND ARCHITECTURAL FEATURES MAY HAVE BEEN OMITTED FROM THIS PLAN FOR CLARITY OF MECHANICAL FEATURES. REFER TO ARCHITECTURAL DRAWINGS FOR EXACT LOCATION OF FIXTURES, AND DIMENSIONS.
- 5. VERIFY FIELD DIMENSIONS. COORDINATE WORK WITH OTHER TRADES TO AVOID
- 6. LAY OUT PIPING BASICALLY AS SHOWN. MAJOR CHANGES IN LAYOUT MAY BE MADE ONLY WITH WRITTEN CONSENT OF ARCHITECT OR ENGINEER.
- 7. ALL COMPONENTS USED IN PLENUM SPACES MUST BE CONSTRUCTED OF NON-COMBUSTIBLE MATERIAL.
- 8. COLOR OF FIXTURES AND TRIM SHALL BE AS SELECTED BY OWNER/ARCHITECT.
- 9. FIXTURES INDICATED AS BARRIER FREE SHALL COMPLY WITH THE AMERICANS WITH DISABILITIES ACT (ADA).
- 10. PROVIDE ELECTRICAL CONTRACTOR WITH EXACT WIRING REQUIREMENTS. IF ELECTRICAL REQUIREMENTS VARY FROM THOSE INDICATED ON PLANS, PLUMBING CONTRACTOR SHALL BE RESPONSIBLE FOR ANY ASSOCIATED ADDITIONAL COSTS.
- 11. REFER TO SITE PLAN FOR ROUTING OF WATER AND SEWER.
- 12. ENSURE THAT ALL PENETRATIONS OF FIRE WALLS ARE PROPERLY FIRESTOPPED.
- 13. ALL WATER LINES, BOTH HOT AND COLD, SHALL BE AS FOLLOWS: A. LINES BELOW GRADE SHALL BE TYPE "K" SOFT COPPER OR PEX. B. LINES ABOVE GRADE SHALL BE TYPE "L" HARD COPPER. C. FITTINGS SHALL BE OF HARD DRAWN COPPER OF ASTM SPEC B-88. D. ALL JOINTING SHALL BE WITH LEAD-FREE SILVER SOLDER. E. EQUIPPED WITH SHOCK ABSORBERS AS REQUIRED.
- 14. PLUMBING CONTRACTOR SHALL FURNISH & INSTALL SHUT-OFF VALVES TO ALL FIXTURES NOT OTHERWISE EQUIPPED.
- 15. ALL WASTE PIPING SHALL BE SCHEDULE 40 PVC CONFORMING TO ASTM D-1785. PIPING SMALLER THAN 3" SHALL BE LAID OUT AT 1/4" PER FOOT GRADE. PIPING 3" AND LARGER SHALL BE LAID OUT AT 1/8" PER FOOT GRADE. ALL VENT PIPING WITHIN PLENUM OR AIR-HANDLING SPACES SHALL BE COPPER OR CAST IRON.
- 16. ALL FLOOR DRAINS SHALL BE EQUIPPED WITH TRAP PRIMER. LOCATE TRAP PRIMER EQUIPMENT CONCEALED IN ACCESSIBLE LOCATION.
- 17. ALL WATER LINES, BOTH HOT AND COLD, SHALL BE CAPPED AND TESTED AT 180 PSI FOR 24 HOURS. ALL WASTE PIPING SHALL BE TESTED WITH A 10' WATER COLUMN FOR A 2 HR PERIOD WITH NO CHANGE IN LEVEL.
- 18. VENT PIPING SHALL BE LAID OUT SUCH THAT ALL ROOF PENETRATIONS SHALL BE ON BACK SIDE OF ROOF. PAINT EXPOSED VENT PIPING TO MATCH ROOF.
- 19. COORDINATE ROOF PENETRATIONS WITH ROOFING CONTRACTOR. ENSURE THAT WARRANTY REQUIREMENTS OF ROOFING MANUFACTURER ARE SATISFIED.
- 20. MATERIALS, EQUIPMENT, AND INSTALLATION SHALL BE GUARANTEED FOR A PERIOD OF ONE (1) YEAR FROM DATE OF ACCEPTANCE. DEFECTS WHICH APPEAR DURING THIS PERIOD SHALL BE CORRECTED AT THE MECHANICAL CONTRACTOR'S EXPENSE.


FIXTURE CONNECTION NOTES:

- 1. CONNECT TO PLUMBING FIXTURES AND EQUIPMENT PROVIDED UNDER THIS AND OTHER SECTIONS OF SPECIFICATION, ARCHITECTURAL DRAWINGS, AND MANUFACTURER'S SHOP DRAWINGS. PROVIDE ROUGH-IN CONNECTION AS SHOWN IN DRAWINGS.
- 2. USE FIXTURE SCHEDULE AND DETAILS ON DRAWINGS OR MANUFACTURER'S SHOP DRAWINGS FOR CONNECTION SIZES TO FIXTURES.
- 3. PROVIDE SEPARATE P-TRAP FOR EACH FIXTURE, FLOOR DRAIN, AND PIECE OF EQUIPMENT.
- 4. PROVIDE PVC (SCH 80) P-TRAPS FOR UNDER FLOOR DRAINS.
- 6. PROVIDE OUTLET DEVICES WHICH LIMIT FLOW OF HOT WATER TO LAVATORIES AND HAND SINKS TO A MAXIMUM OF 0.5 GPM AND SIZED AS RECOMMENDED BY MANUFACTURER AND AS REQUIRED BY ASHRAE STANDARD 90-75, PARAGRAPH 7.7.2, LOCAL AND STATE ENERGY CODES.

5. MOUNT FIXTURES RIGID TO WALLS AS SHOWN ON DRAWINGS OR DETAILS.

- 7. INSTALL LAVATORIES AND HAND SINKS WITH A MINIMUM OF 4" CLEARANCE ON EACH SIDE FROM WALL OR PARTITION.
- 8. COORDINATE DIMENSIONS REQUIRED FOR MINIMUM FIXTURE CLEARANCE WITH OTHER DIVISIONS.
- 9. INSTALL APPROVED CAULKING AROUND JOINTS AT FIXTURES MOUNTED ON WALL OR FLOOR.

McCollough ${f A}$ rchitecture, ${f I}$ nc P.O. BOX 6310 GULF SHORES, ALABAMA 36547-6310 PHONE: 251-968-7222

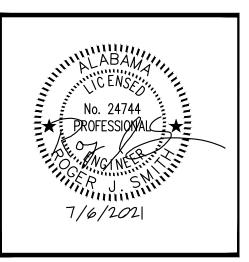

\simeq 10 TER

JOB NO.:

DRAWN:

DATE:

SCALE:

SHEET NO.:

PLUMBING NOTES,

CHECKED:

REVISION:

RJS

2021.07.06

AS SHOWN

PHASE 1 ALTERNATE 1 SCHEDULES AND LEGEND

4 3/4" HW/CW DOWN TO SH-1

1. PIPING LAYOUT IS DIAGRAMMATIC.

SANITARY SEWER PHASE ONE ALTERNATE ONE:

4. CONTRACTOR TO ENSURE FLOORS WILL SLOPE TO FLOOR DRAINS.


2. CONTRACTOR SHALL COORDINATE WITH ALL TRADES WITH RESPECT TO ROUTING AND CLEARANCES. PROVIDING OFFSETS, DROPS, RISES, ETC. AS REQUIRED TO ACCOMMODATE.

3. ALL FLOOR DRAINS WILL REQUIRE TRAP PRIMERS BY PRECISION PRODUCTS PRIME RITE OR EQUAL. INSTALL PER MANUFACTURES RECOMMENDATIONS IN ACCESSIBLE LOCATION. ROUTE SOFT COPPER PRIMER LINES WITH OUT JOINTS TO DRAINS.

5 1/2" CW DOWN TO CB-1






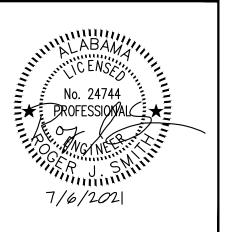



JOB NO.: DRAWN: CHECKED: DATE: 2021.07.06 REVISION:

AS SHOWN SCALE: SHEET NO.:

PHASE 1 ALTERNATE 1 PLUMBING PLAN BASE BID

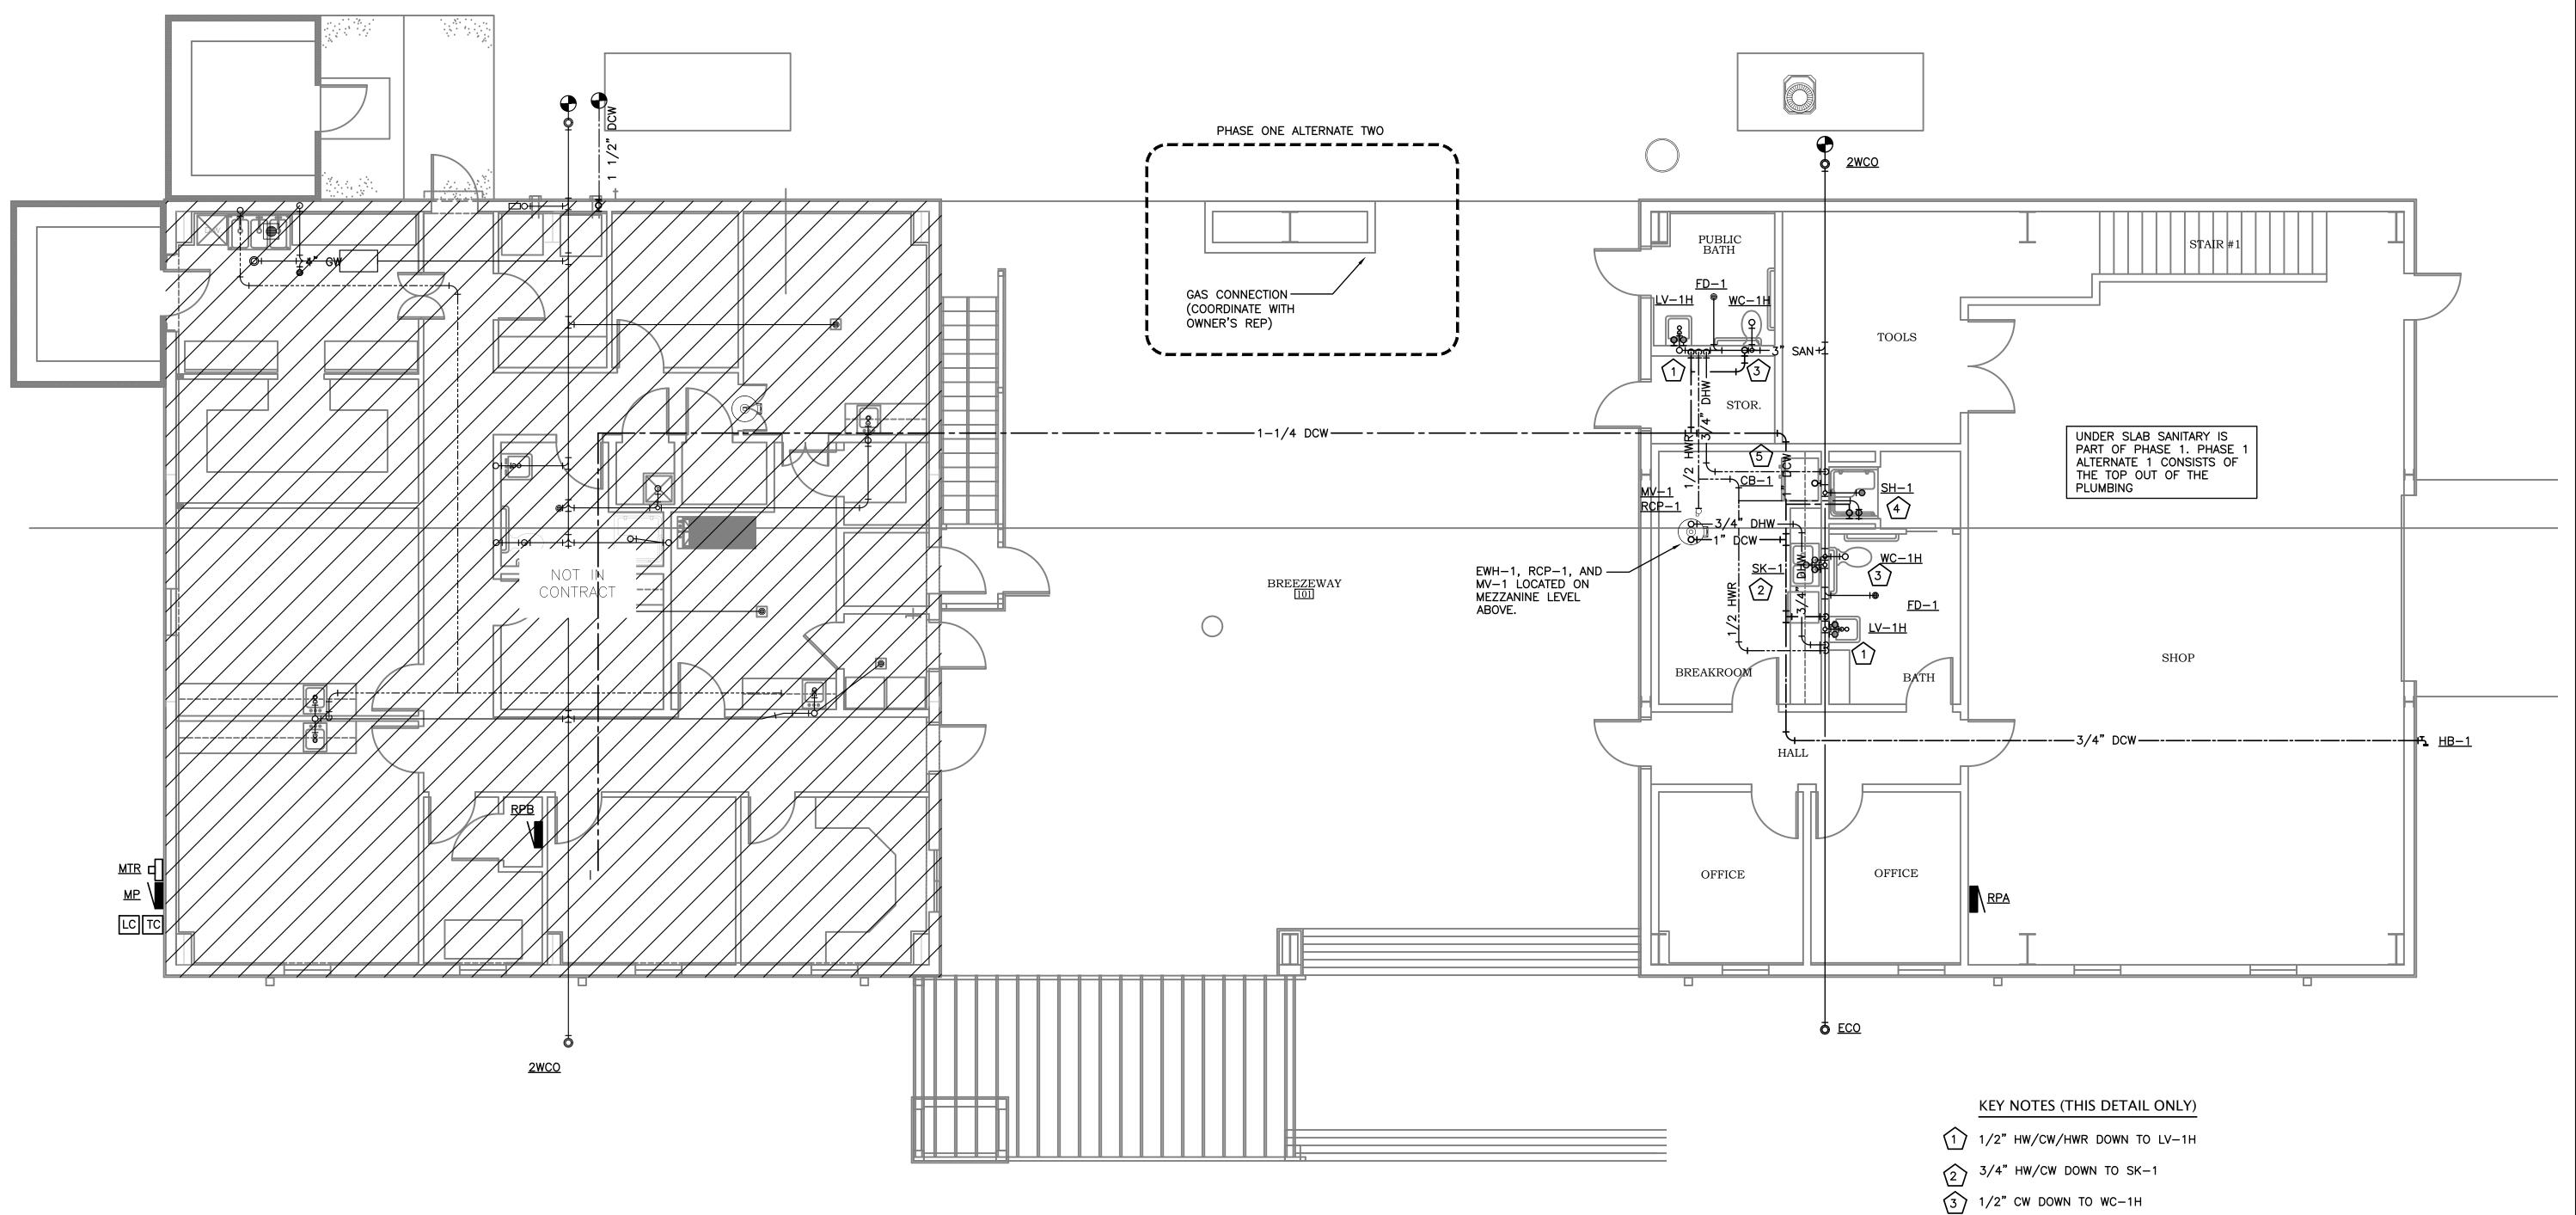

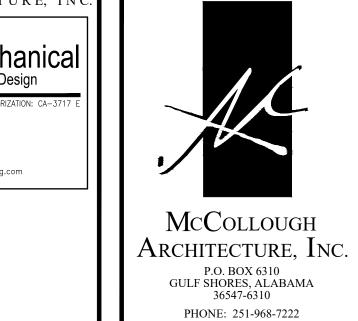

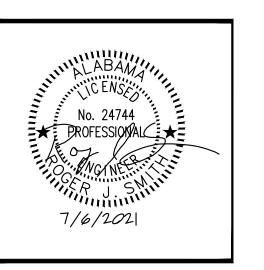

JOB NO.: CHECKED: 2021.07.06 DATE: REVISION:


> AS SHOWN SCALE:

SHEET NO.:


SANITARY WASTE RISERS







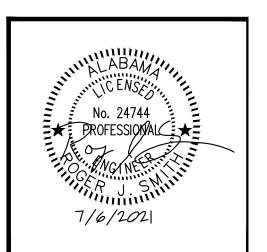


PHONE: 251-968-7222

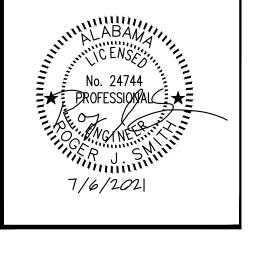

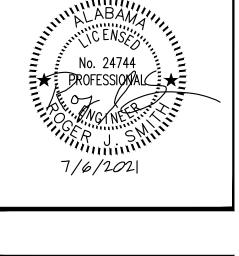

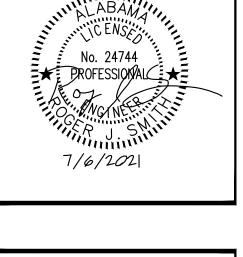

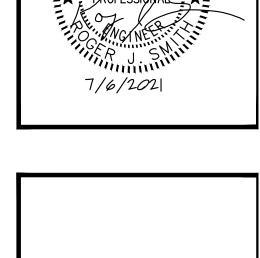

TERNA

AS SHOWN

SCALE: SHEET NO.:

PH

PLUMBING DETAILS

PHASE 1 ALTERNATE 1

CLEANOUT PLUG


— FINISHED GRADE


— TWO-WAY CLEANOUT


FITTING

8 TWO-WAY CLEANOUT DETAIL


P2.1 SCALE: NONE

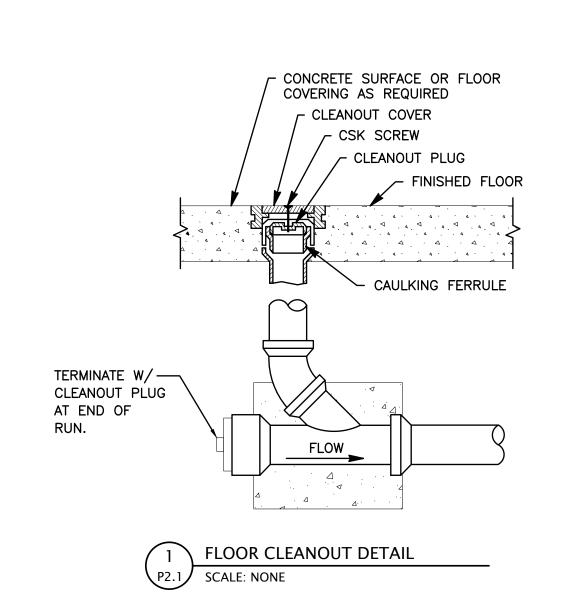

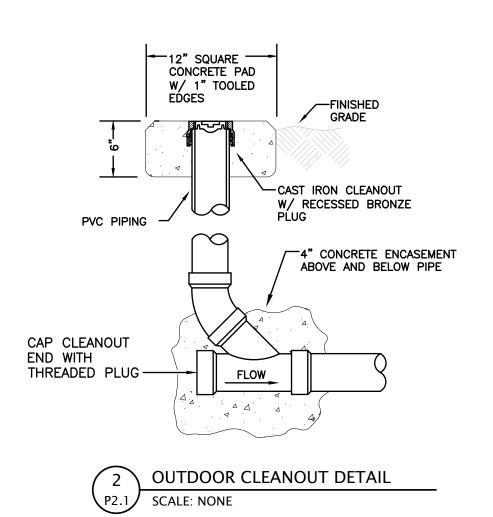

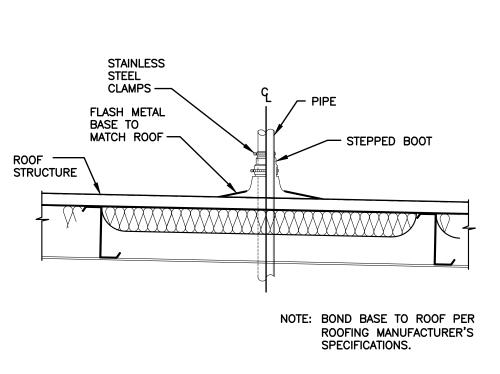

VENT THRU ROOF DETAIL P2.1 SCALE: NONE

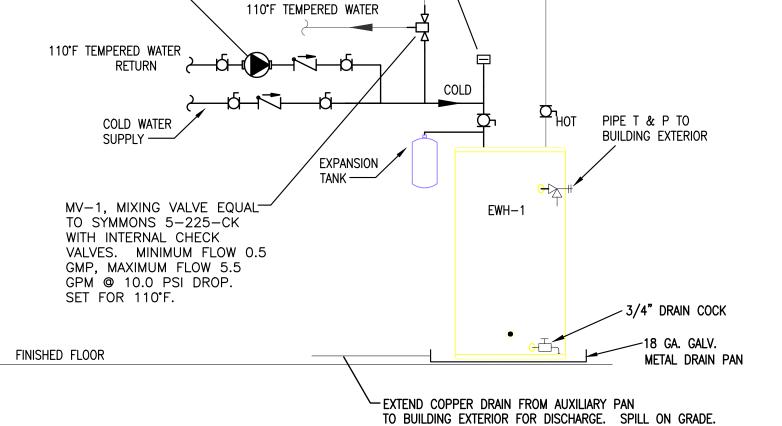

EXTERIOR CLEANOUT

COVER & FRAME.

12" SQ. X 4"

CONC. PAD

VACUUM BREAKER -ABOVE WATER


HEATER.

NOTES: 1. PIPING DIAGRAM. SEE MANUFACTURERS RECOMMENDATIONS FOR ADDITIONAL INFORMATION.


RCP−1 —


- 2. THE TEMPERATURE AND PRESSURE RELIEF VALVE SETTING SHALL NOT EXCEED PRESSURE RATING OF ANY
- ANY COMPONENT IN THE SYSTEM. 3. SERVICE VALVES ARE SHOWN FOR SERVICING UNIT. HOWEVER, LOCAL CODES SHALL GOVERN THEIR USAGE.



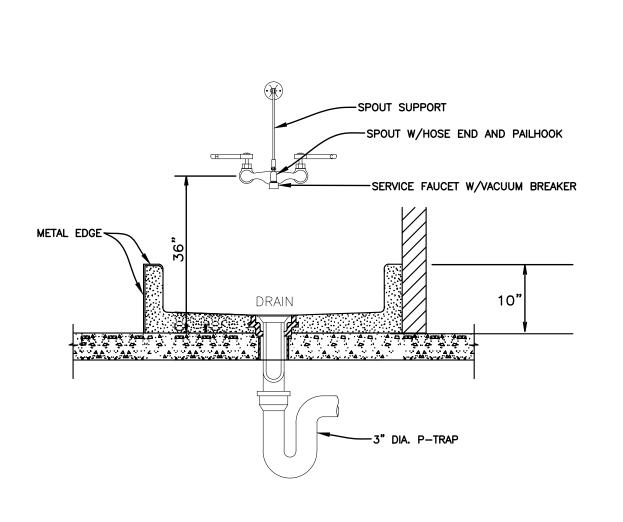



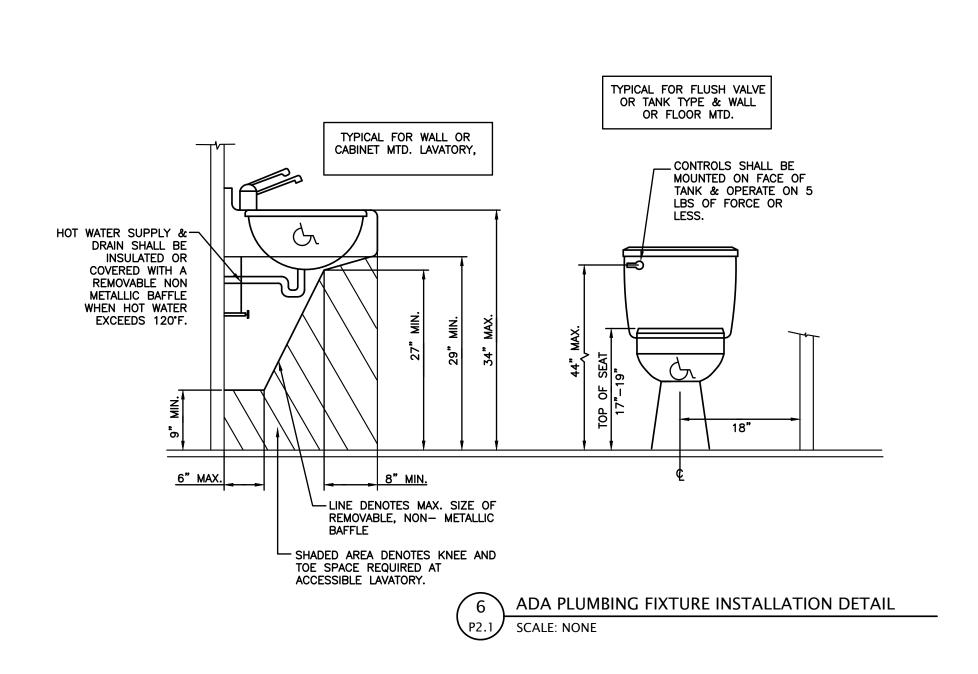

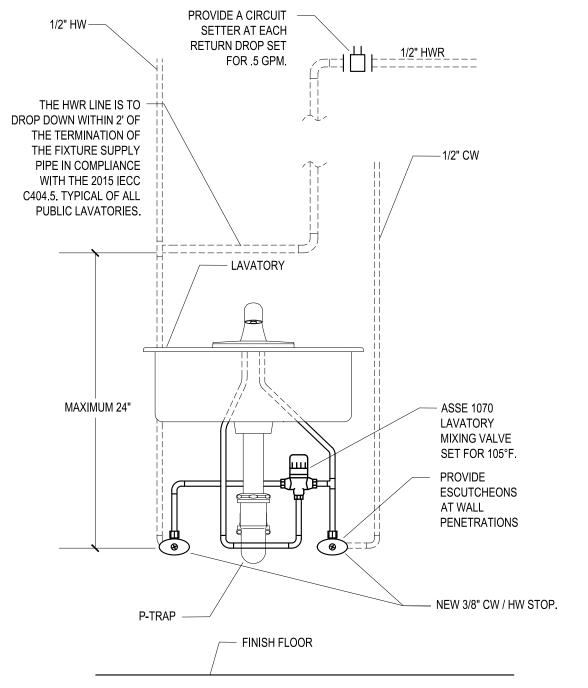



A NEW BUILDING FOR ORANGE BEACH WILDLIFE CENTER

ORANGE BEACH, ALABAMA

GENERAL NOTES

- I. ALL NEW CONSTRUCTION SHALL COMPLY WITH ALL APPLICABLE BUILDING CODES AND RESTRICTIVE ORDINANCES. AND INDUSTRY STANDARDS FOR CONSTRUCTION. ELECTRICAL. PLUMBING, AND MECHANICAL.
- 2. THE INTENT OF THESE DRAWINGS IS TO PROVIDE THE BUILDER WITH GENERAL GUIDELINES FOR THE SOUND CONSTRUCTION OF THE STRUCTURE INDICATED HEREIN. DEVIATIONS FROM THESE DRAWINGS ARE AT THE BUILDERS RISK UNLESS APPROVED IN WRITING OR WITH SUPPLEMENTAL DRAWINGS FROM THE ARCHITECT.
- 3. IT IS RECOMMENDED THAT THE SERVICES OF A REGISTERED LAND SURVEYOR BE EMPLOYED FOR THE PROPER PLACEMENT OF THE STRUCTURE IN RELATION TO PROPERTY LINES, SETBACK LINES, EASEMENTS, ETC.
- 4. DIMENSIONS INDICATED ON DRAWINGS ARE TO FACE OF STUD OR MASONRY UNLESS OTHERWISE NOTED.
- 5. THE CONTRACTOR SHALL FIELD VERIFY ALL DIMENSIONS INDICATED WITHIN THESE DOCUMENTS AND SHALL NOTIFY THE ARCHITECT OF ANY VARIATION PRIOR TO THE PURCHASE OF MATERIALS, FABRICATION, OR BEGINNING CONSTRUCTION.
- PROVIDE TEMPORARY SETTLING BASINS, HAY BALES, AND OTHER METHODS AS APPROPRIATE TO FILTER WATER AT ALL AREAS WHERE STORM WATER LEAVES THE PROJECT. CLEAN ALL SOIL WHICH FLOWS OFF-SITE.
- 7. ALL EXISTING SITE CONDITIONS ARE TO BE VERIFIED BY CONTRACTOR PRIOR TO START OF CONSTRUCTION.
- 8. PROVIDE CHEMICAL BARRIER TO BUILDING FROM SUBTERRANEAN TERMITE ATTACK.
- 9. NO QUALIFYING STATEMENTS OR EXCEPTIONS TO PLANS OR NOTES ARE ALLOWED. 10. ALL WORK RELATED DEBRIS SHALL BE REMOVED FROM THE SITE REGULARLY AND PROMPTLY. II. THE CONTRACTOR SHALL LEAVE ALL AREAS AND FINISHED SPACES IN A CLEAN AND ACCEPTABLE CONDITION AT THE PROJECT COMPLETION.
- 12. ALL MECHANICAL, PLUMBING, AND ELECTRICAL SYSTEMS ARE TO BE FULLY COORDINATED WITH THE ARCHITECTURAL DOCUMENTS.
- 13. ALL PLUMBING, MECHANICAL, AND ELECTRICAL SYSTEMS SHALL BE DESIGNED AND INSTALLED BY A STATE OF ALABAMA LICENSED AND CERTIFIED CONTRACTOR AND THEIR RESPECTIVE DISCIPLINE. PLUMBING CONTRACTOR SHALL SHOW EVIDENCE OF THEIR ALABAMA PLUMBERS AND GAS FITTERS LICENSE; HEATING AND COOLING CONTRACTOR'S LICENSE; AND ALABAMA ELECTRICAL CONTRACTOR'S LICENSE.
- 14. PLUMBING, MECHANICAL, AND ELECTRICAL CONTRACTOR'S SHALL PROVIDE THE OWNER WITH SHOP DRAWINGS AND SPECIFICATIONS PRIOR TO ORDERING AND INSTALLATION. ALL WORK SHALL COMPLY WITH THE 2018 INTERNATIONAL BUILDING CODE, 2018 INTERNATIONAL PLUMBING AND GAS CODES, 2018 INTERNATIONAL MECHANICAL CODE, 2018 INTERNATIONAL FIRE CODE, AND 2017 NATIONAL ELECTRICAL CODE.
- 15. DO NOT SCALE DRAWINGS! DIMENSIONS OR LINEAR MEASUREMENTS TAKE PRECEDENT OVER NOTED DIMENSIONS.
- 16. ALL CONTRACTOR'S AND SUB-CONTRACTOR'S SHALL COMPLY WITH OSHA REQUIREMENTS. 17. ALL EXTERIOR DOORS AND WINDOWS SHALL BE DESIGNED AND INSTALLED TO WITHSTAND DESIGN WIND LOADS BASED ON ASCE 7-16 AND 160 MPH WIND RATING.
- 18. ALL PRODUCTS, MATERIALS, AND CONSTRUCTION SHALL BE PROVIDED AND/OR INSTALLED IN STRICT ACCORDANCE WITH THE MANUFACTURER'S SPECIFICATIONS, GUIDELINES, AND/OR INDUSTRY STANDARDS.

PROJECT SUMMARY PHASE II

WALLS, DOORS, MILLWORK, FIXTURES, MECHANICAL EQUIPMENT, ELECTRICAL, APPLIANCES AND FINISHES THROUGHOUT. ALSO A 5 I 4 S.F. SECOND FLOOR OR "MEZZANINE" WILL BE PART OF THIS PHASE II, INCLUDING WOOD FRAMED STAIRS AND FINISHES

IN GENERAL, PHASE II IS MEANT TO TAKE THE TRAIL SHOP/WILDLIFE CENTER FROM ITS STATE AT COMPLETION OF PHASE I TO A COMPLETE "TURN KEY" BUILDING WITH ALL BUILDING SYSTEMS IN PLACE AND IN NEW WORKING ORDER. UPON COMPLETION OF PHASE II THIS PROJECT IS MEANT TO BE MOVE IN READY.

CONTACT INFORMATION

ARCHITECT

McCOLLOUGH ARCHITECTURE, INC. CONTACT: STED McCOLLOUGH 4790 MAIN STREET #209 ORANGE BEACH, ALABAMA 36561 PHONE: 251-968-7222

MECHANICAL, PLUMBING, & ELECTRICAL ENGINEERING

STEWART ENGINEERING CONTACT: WADE STEWART 40680 STATE HIGHWAY 59 BAY MINETTE, ALABAMA 36507 PHONE: 251-937-6313

STRUCTURAL ENGINEER

LARRY M. OLIVER ENTERPRISES. INC. CONTACT: LARRY OLIVER 7228 OAKBRIAR DRIVE S. MOBILE, ALABAMA 36619 PHONE: 251-377-6101

TITLE

A1.0 - ADA STANDARDS

A2.1 - DOOR, WINDOW & FINISH SCHEDULE A3.1 - EXTERIOR ELEVATIONS

A4.2 - SECTIONS AND DETAILS

A5.1 - ENLARGED PLANS & INTERIOR ELEVATIONS

MECHANICAL

M1.0 - HVAC LEGEND, NOTES AND SCHEDULES

M1.1 - HVAC PLAN FIRST FLOOR

E2.1 - POWER & AUX FIRST FLOOR

E3.0 - ELECTRICAL RISER AND DETAILS

P1.0 - PLUMBING NOTES, SCHEDULES AND LEGEND

P1.1 - PLUMBING PLAN BASE BID

P2.0 - SANITARY WASTE RISERS

SHEET INDEX

T1.1 - TITLE SHEET AND GENERAL NOTES

ARCHITECTURAL

LS1.1 - LIFE SAFETY PLAN

A1.1 - FLOOR PLAN

A4.1 - BUILDING SECTIONS

A6.1 - REFLECTED CEILING PLAN

M1.2 - HVAC PLAN SECOND FLOOR


ELECTRICAL


E1.0 - ELECTRICAL NOTES AND LEGEND

E1.1 - LIGHTING PLAN 1ST FLOOR E1.2 - LIGHTING PLAN 2ND FLOOR

E2.2 - POWER PLAN SECOND FLOOR

PLUMBING

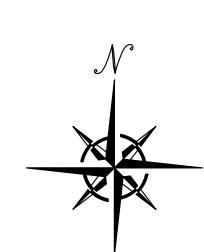

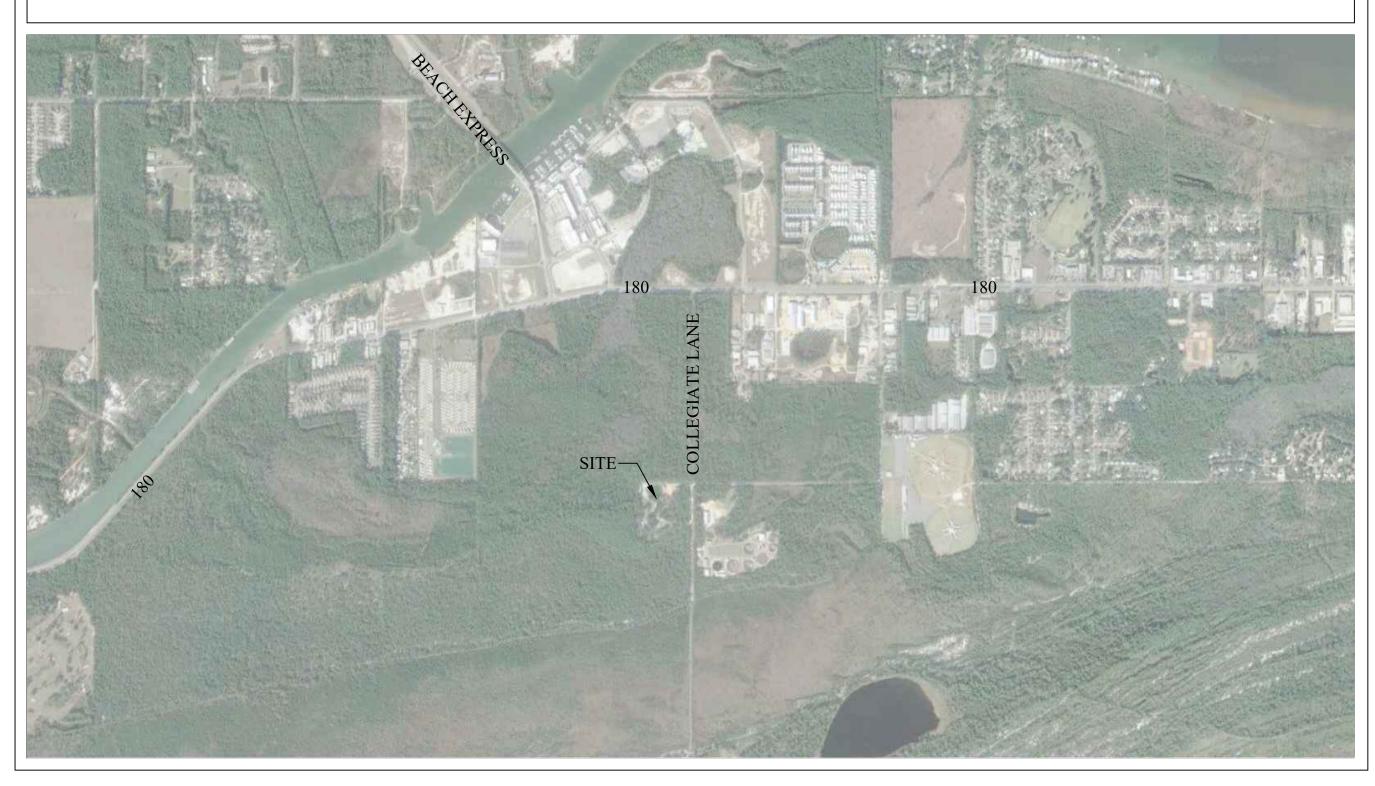

VICINITY MAP

JOB NO.: DRAWN: CHECKED: 21-06

2021.06.01 DATE: **REVISION:**

AS NOTED SCALE:


SHEET NO .:

TITLE SHEET PHASE II

PHASE II


McCollough

 ${f A}$ rchitecture. ${f I}$ nc. P.O. BOX 6310 GULF SHORES, ALABAMA 36547-6310 PHONE: 251-968-7222

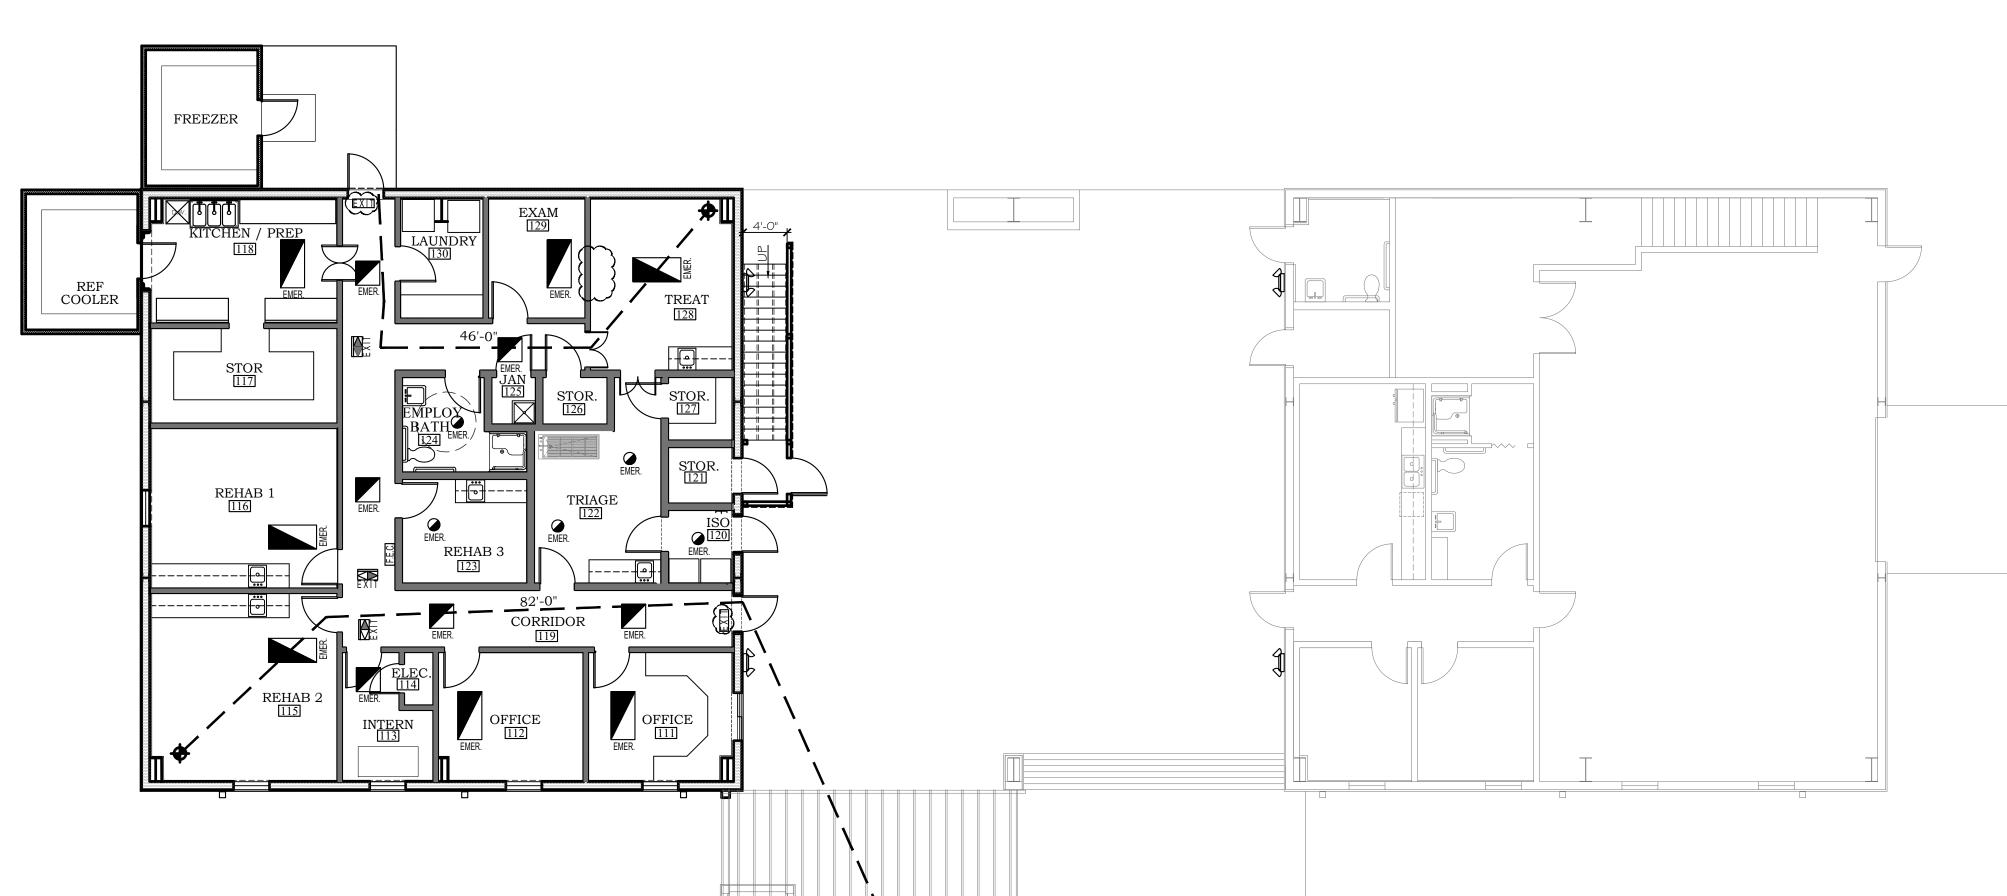


FIRST FLOOR PLAN

SCALE: 1/8"=1'-0" FLOORED AREA:2,368 S.F.

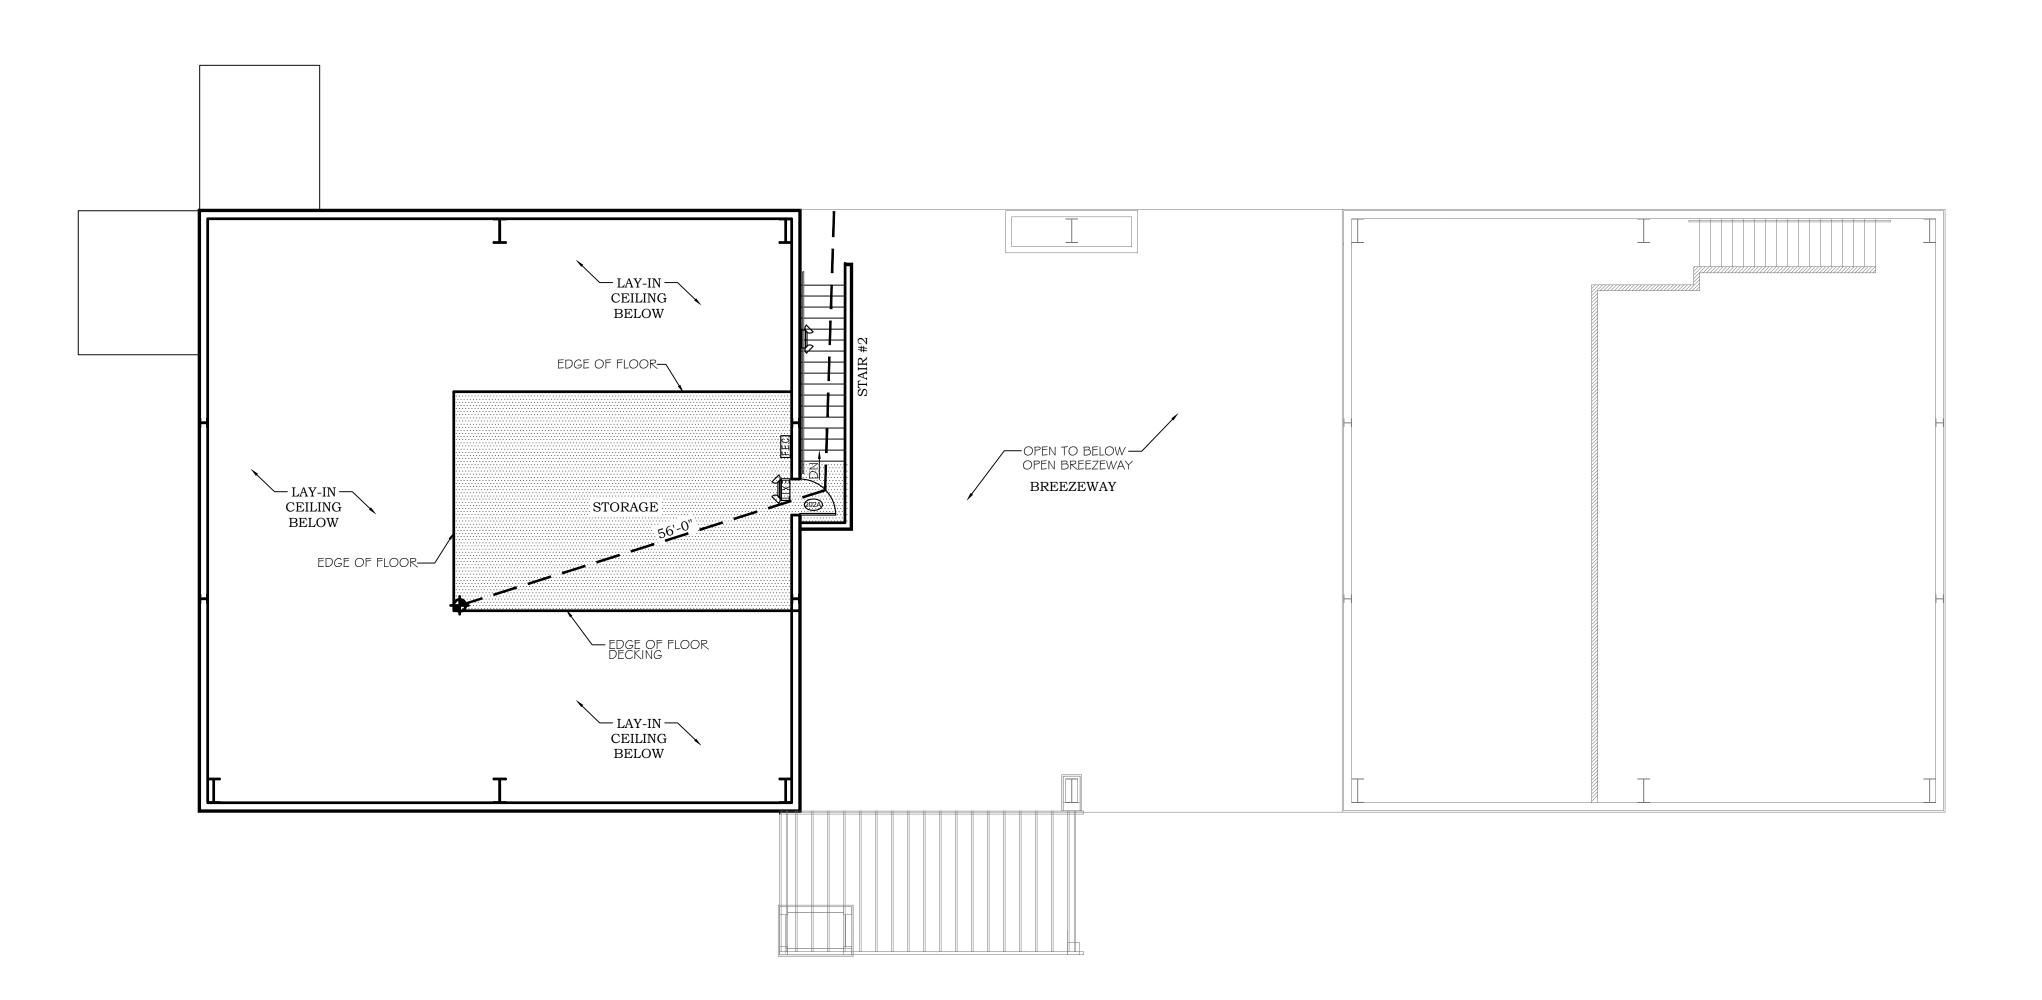




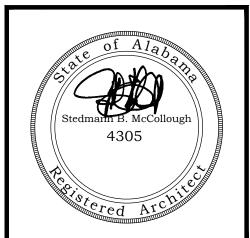

GENERAL NOTES

ALL GREYED OUT ITEMS WERE CONSTRUCTED DURING PHASE I

ALL DOOR THRESHOLDS TO HAVE MAXIMUM $\frac{1}{2}$ " TRANSITION, RE: A1.0

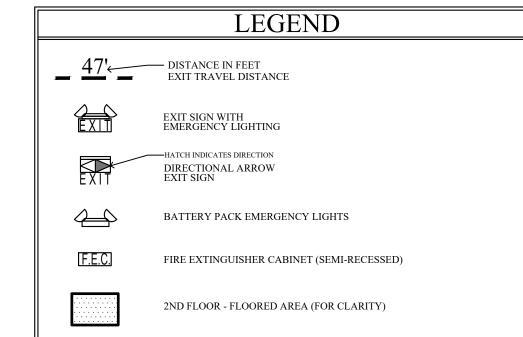

PROJECT SUMMARY

THIS PROJECT PROVIDES FOR A NEW BUILD OUT (APPROXIMATELY 2,882 SQUARE FEET UNDER ROOF) FOR ORANGE BEACH COASTAL RESOURCES WILDLIFE CENTER. THE WILDLIFE CENTER SPACES INCLUDE TREATMENT AND SUPPORT ROOMS FOR ANIMALS AND ADMINISTRATIVE OFFICES.

THE OVERALL STRUCTURE IS A PRE-ENGINEERED METAL BUILDING STRUCTURE BUILT DURING PHASE I. THIS PHASE II BUILD OUT INCLUDES WOOD-FRAMED INTERIOR WALL CONSTRUCTION.

APPLICABLE BUILDING CODES

-2018 INTERNATIONAL BUILDING CODE -2018 INTERNATIONAL PLUMBING CODE -2018 INTERNATIONAL MECHANICAL CODE -2018 INTERNATIONAL FIRE CODE -2017 NATIONAL ELECTRICAL CODE -AMERICANS WITH DISABILITIES ACT (ADA)

PROJECT CODE DATA

-CONSTRUCTION TYPE -OCCUPANCY	IIB, UNSPRINKLERED MIXED, NON-SEPARATED ¹
PHASE II-BUSINESS (WILDLIFE CENTER)-2,882 @150 S.F/PERSO: PHASE I-S1 (MAINTENANCE SHOP) - 3,390 @100 S.F./PERSON= 3 PHASE I-BUSINESS (BREEZEWAY)-2,265 @150 S.F/PERSON= 16 F	N= 20 PEOPLE 4 PEOPLE
-OCCUPANT LOAD	70 PEOPLE
-TOTAL AREA UNDER ROOF	8,852 S.F.
-FIRE RATED WALLS	NONE ²
-REQUIRED EXIT TRAVEL DISTANCE	<200'
-REQUIRED FIRE EXTINGUISHER/PROVIDED	3,000 S.F/75FT. TRAVEL

¹ UNSEPARATED MIXED OCCUPANCY (B) BUSINESS; (S1) STORAGE ² CORRIDOR FOR WILDLIFE CENTER SERVES LESS THAN 30 PEOPLE (NO RATING)

JOB NO.: DRAWN: CHECKED:

21-06

CLT

SBM

ORANGE E
WILDLIFE
ORANGE E
ALABAN

2021.06.01 DATE: REVISION:


SCALE: 1/8" = 1'-0"

SHEET NO.:

LIFE SAFETY PLAN

SECOND FLOOR PLAN
SCALE: 1/8"=1'-0" FLOORED AREA: 514 S.F.

PHASE II

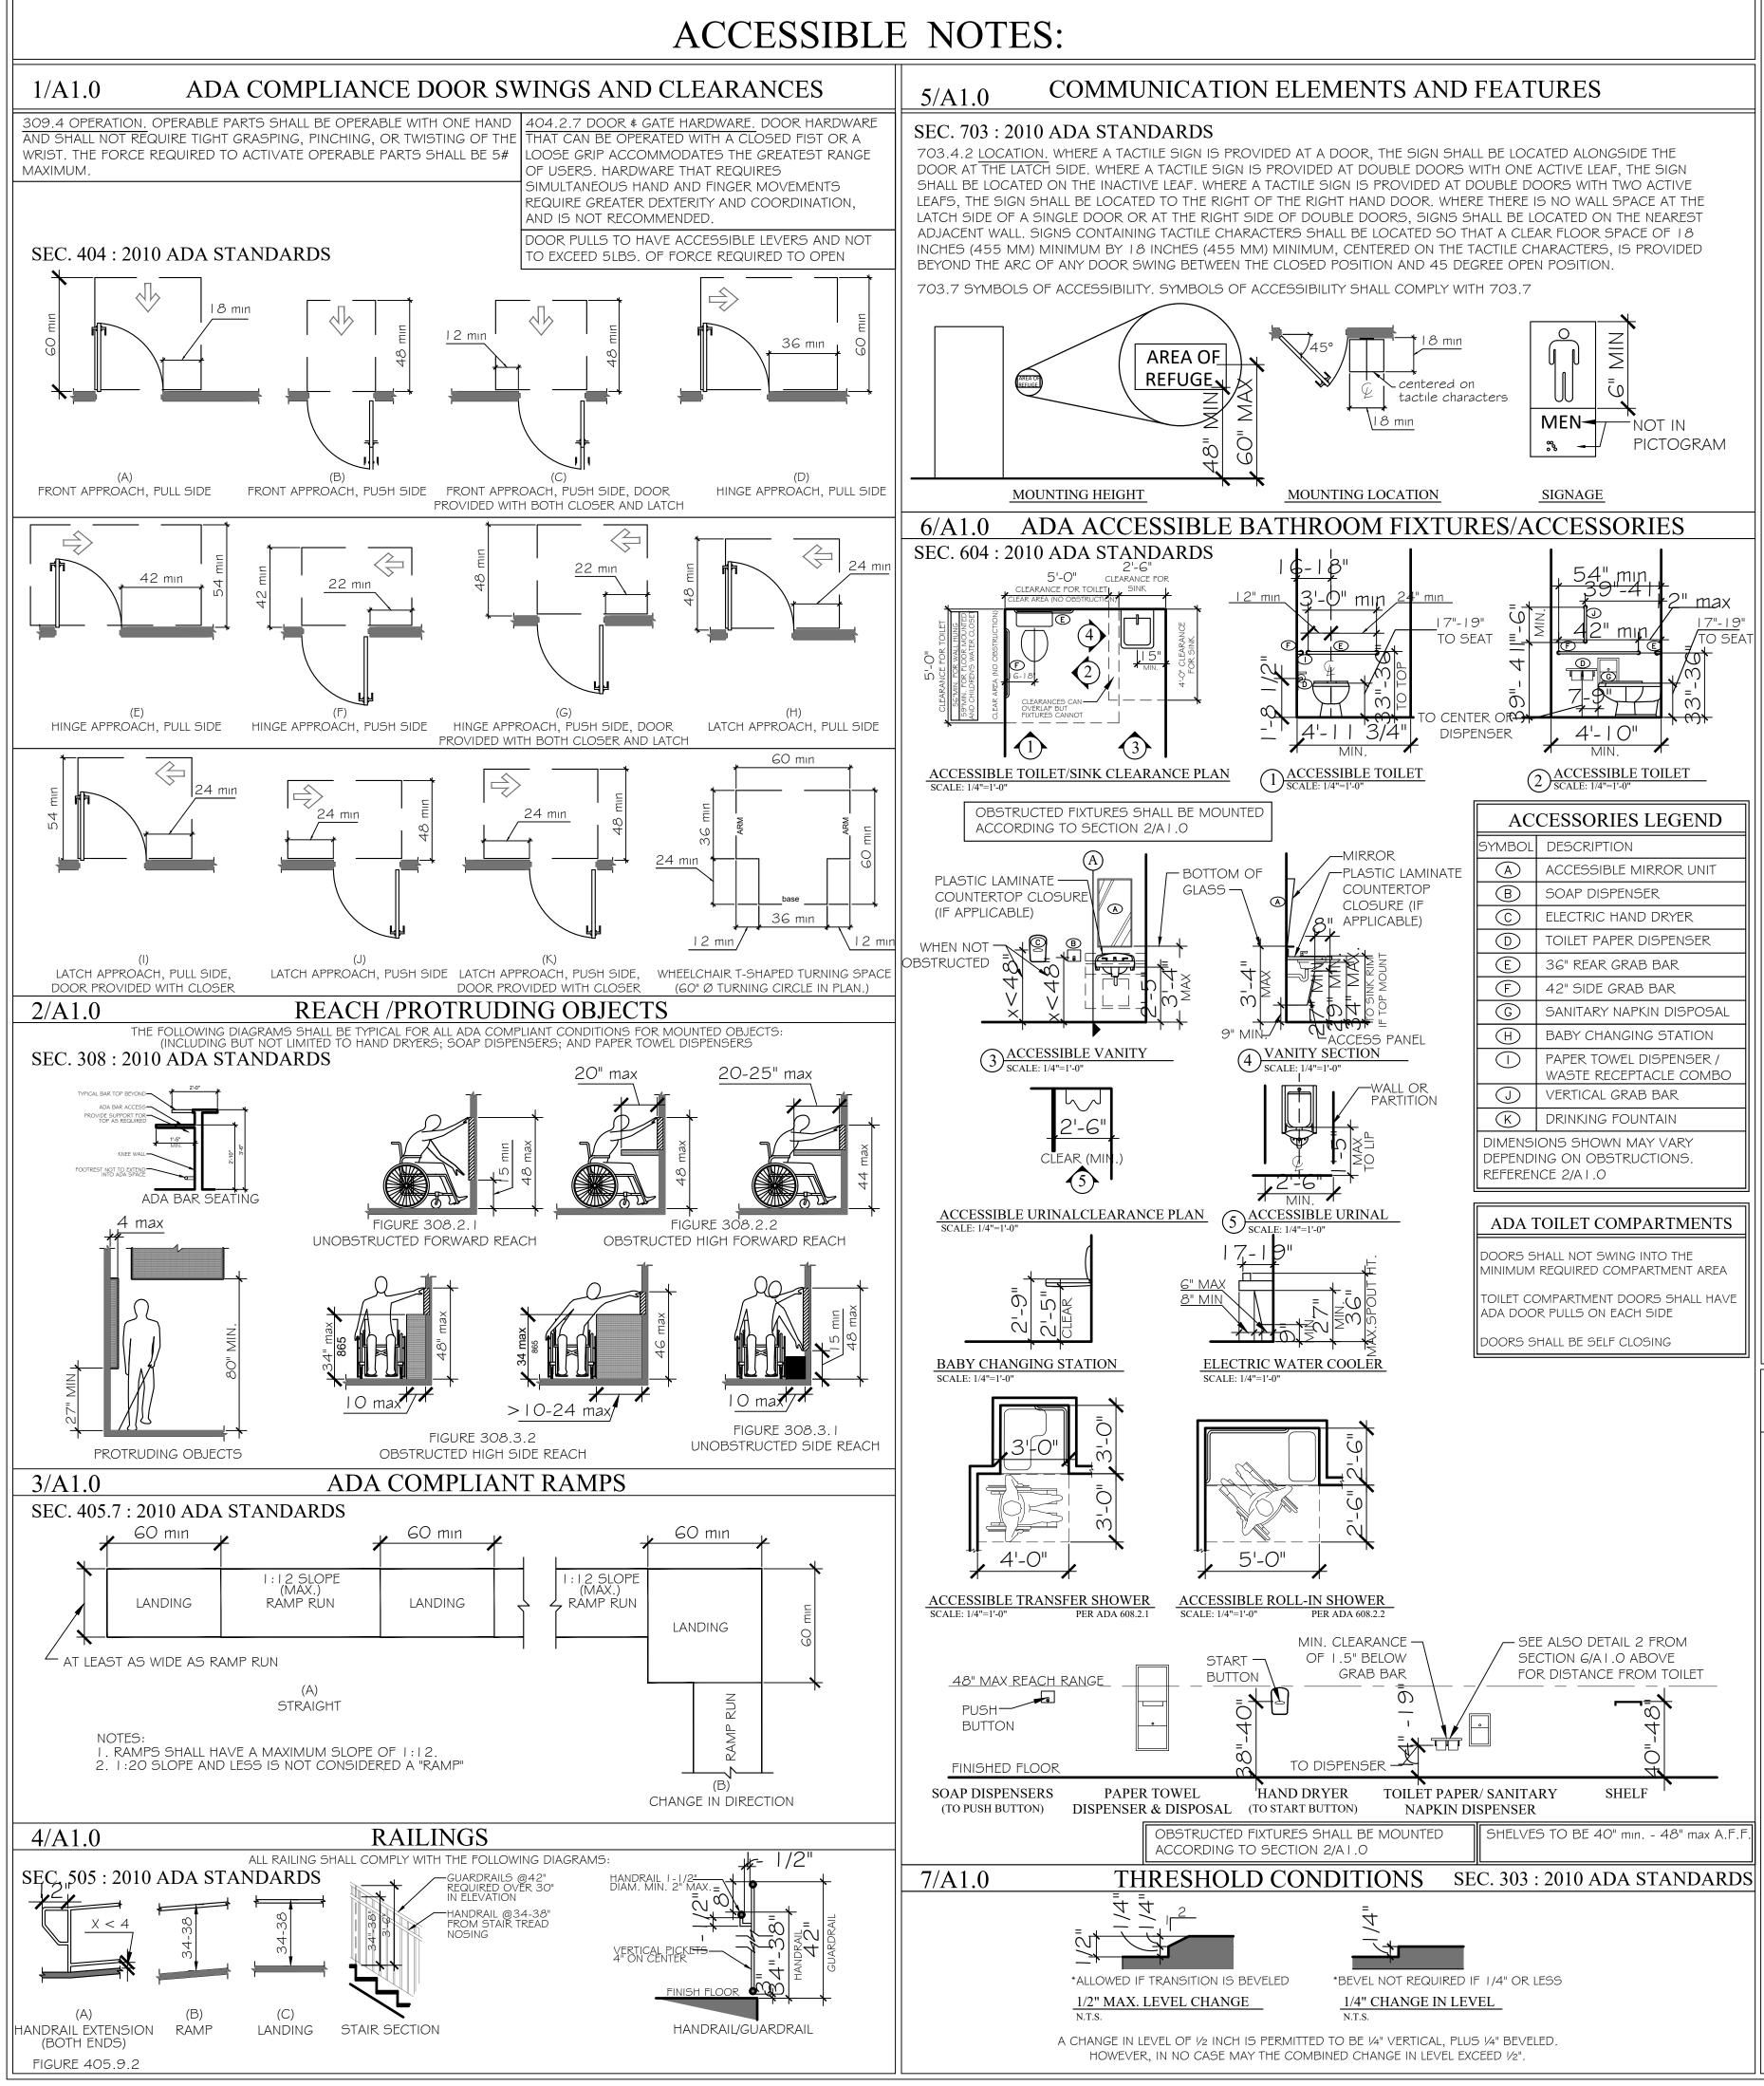


ABBREV.	TERM
ACC.	ACCESSIBLE
ACT	ACOUSTICAL CEILING TILE
ADA	AMERICANS WITH DISABILITIES
A.F.F.	ABOVE FINISHED FLOOR
ALUM.	ALUMINUM
ASSEM.	ASSEMBLY READ BOARD
B.B. CONC.	BEAD BOARD CONCRETE
CONT.	CONTINUOUS
CPT.	CARPET
DIM	DIMINSION(S)
D/W	DISHWASHER
ELEC.	ELECTRIC / ELECTRICAL
ELEV.	ELEVATOR
EQUIP.	EQUIPMENT
E.P.	EPOXY PAINT
EXT.	EXTERIOR
EWC	ELECTRIC WATER COOLER
FEC	FIRE EXTINGUISHER CABINET
FG.	FIBERGLASS
FIN.	FINISH / FINISHED
FLR.	FLOOR
FRP	FIBER-REINFORCED PLASTIC
FT.	FOOT / FEET
GFI ON STREET	GROUND FAULT INTERRUPTOR
GYP.BD.	GYPSUM BOARD
H.C. H.M.	HOLLOW CORE HOLLOW METAL
HORIZ.	HORIZONTAL
HR	HOUR
INT.	INTERIOR
JAN.	JANITOR
MAX	MAXIMUM
MECH.	MECHANICAL
MT.	METAL
MICRO.	MICROWAVE
MIN.	MINIMUM
M.R.	MOISTURE RESISTANT
N.T.S.	NOT TO SCALE
O.C.	ON CENTER
PRE-FAB	PRE FABRICATED
PT.	PAINT / PAINTED
P.T.	PRESSURE TREATED
Q.T.	QUARRY TILE
REF.	REFRIGERATOR
REINF.	REINFORCED
REQ. SC.	REQUIRED SOLID CORE
S.F.	SQUARE FOOT / FEET
SHWR.	SHOWER
5.5.	SCORED & STAINED
5.5. S/S	STAINLESS STEEL
ST.	STAINED
STOR.	STORAGE
TYP.	TYPICAL
U/C	UNDER COUNTER
VEND.	VENDING MACHINE
V.W.P.	VINYL WOOD PLANK
WD	WOOD
W/	WITH
W/D	WASHER DRYER
W/O	WITH OUT


130	ROOM NUMBER
124	DOOR NUMBER
DETAIL NUMBER AG. I SHEET NUMBER	INTERIOR ELEVAT
SECTION IDENTIFICATION BB SECTION LOCATION A4.2 SHEET NUMBER	SECTION CUT LOCATION MARK
DRAWING DESIGNATION A A A 2.5 SHEET NUMBER	DETAIL MARKER
WALL TYPE NUMBER INTERSECTS WALL REFERENCED	WALL TYPE MARK
STOREFRONT	STOREFRONT TY
HEIGHT OF CEILING A.F.F.	ELEVATION MAR
REVISION NUMBER	REVISION MARKER

GENERAL NOTES

- I. ALL PRODUCTS, MATERIALS, AND CONSTRUCTION SHALL BE PROVIDED AND/OR INSTALLED IN STRICT ACCORDANCE WITH THE MANUFACTURERS SPECIFICATIONS, GUIDELINES, AND/OR INDUSTRY STANDARDS.
- . THE INTENT OF THESE DRAWINGS IS TO PROVIDE THE BUILDER WITH GENERAL GUIDELINES FOR THE SOUND CONSTRUCTION OF THE STRUCTURE INDICATED WITHIN. DEVIATIONS FROM THESE DRAWINGS ARE THE BUILDERS RISK UNLESS APPROVED IN WRITING OR WITH SUPPLEMENTAL DRAWINGS FROM THE ARCHITECT.
- SURVEYOR BE EMPLOYED FOR THE PROPER PLACEMENT OF THE STRUCTURE IN RELATION TO PROPERTY LINES, SETBACK LINES, EASEMENTS, ETC.
- CONTRACTOR TO SECURE AND PAY FOR ALL NECESSARY FEES AND PERMITS FOR CONSTRUCTION, ELECTRICAL, AND PLUMBING INSPECTORS, ETC.
- 5. DO NOT SCALE DRAWINGS!!! DIMENSIONS OR LINEAR MEASUREMENTS TAKE PRECEDENCE OVER NOTED DIMENSIONS.
- G. DIMENSIONS INDICATED ON DRAWINGS ARE TO FACE OF STUDS.
- 7. THE CONTRACTOR SHALL FIELD VERIFY ALL DIMENSIONS INDICATED WITHIN THESE DOCUMENTS AND SHALL NOTIFY THE ARCHITECT OF ANY VARIATION PRIOR TO THE PURCHASING OF ANY MATERIALS, STARTING FABRICATION, OR BEGINNING CONSTRUCTION

- 8. PROVIDE TEMPORARY SETTLING BASINS, HAY BALES, AND OTHER METHODS AS APPROPRIATE TO FILTER WATER AT ALL AREAS WHERE STORM WATER LEAVES THE PROJECT. CLEAN UP ALL SOIL WHICH FLOWS OFF SITE AT THE END OF THE DAY.
- 9. ALL EXISTING SITE CONDITIONS ARE TO BE VERIFIED BY CONTRACTOR BEFORE START OF CONSTRUCTION.
- I O. PROVIDE CHEMICAL BARRIER TO BUILDING FROM SUBTERRANEAN TERMITE ATTACK.
- I I . NO QUALIFYING STATEMENTS OR EXCEPTIONS TO PLANS OR NOTES TO BE ALLOWED.
- 12. ALL WORK RELATED DEBRIS SHALL BE REMOVED FROM THE SITE REGULARLY AND PROPERLY.
- 13. THE CONTRACTOR SHALL LEAVE ALL AREAS AND FINISHED SPACES IN A CLEAN AND ACCEPTABLE CONDITION AT THE PROJECT COMPLETION.
- 14. ALL CONTRACTORS AND SUBCONTRACTORS SHALL COMPLY w/ OSHA REQUIREMENTS.
- 15. ALL NEW CONSTRUCTION SHALL COMPLY WITH ALL APPLICABLE BUILDING CODES AND RESTRICTIVE ORDINANCES FOR CONSTRUCTION, ELECTRICAL, PLUMBING, AND MECHANICAL.

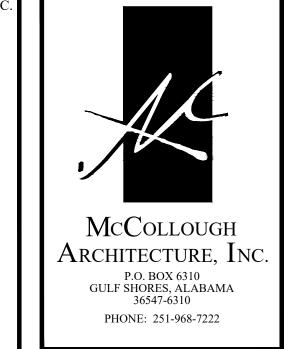

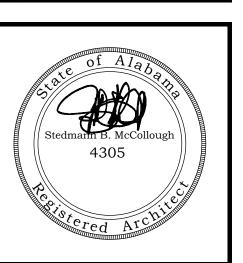

ORANGE BEACH
WILDLIFE CENTE

ORANGE BEACH

JOB NO.: 21-06
DRAWN: CLT
CHECKED: SBM
DATE: 2021.06.01
REVISION:


SCALE:


SHEET NO.:

1.0

1/4"-1'-0"

ADA STADARDS

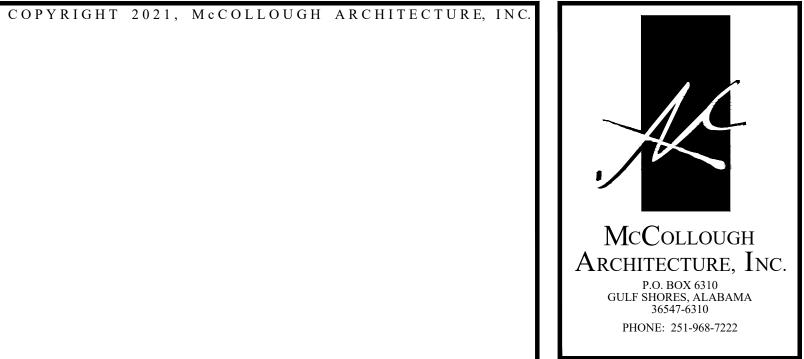

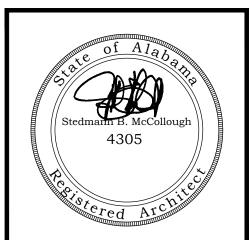

ACH EN BE/C ORANGE I
DLIFE
ORANGE I

21-06 JOB NO.: CLT DRAWN: SBM CHECKED: DATE: 2021.06.01 REVISION:

1/8" = 1'-0"SCALE:

SHEET NO.:

FLOOR PLANS


				DOO	R SCH	EDU:	LE				
DOOR NO.	DOOR SIZE	DOOR TYPE	DOOR MATERIAL	DOOR	DOOR FINISH	FRAME	FRAME FINISH	RATING	PANIC HDWE	DOOR CLOSURE	REMARKS
0.1.4	01 011 1/ 71 011		14/000	EVERIOR	CTAIN		CTAIN		1	1	WOOD CLAT DOOR TO MATCH STAIR FRANKIS
OIA	3'-0" X 7'-0"	F	WOOD	EXTERIOR	STAIN	WOOD		-	-	 -	WOOD SLAT DOOR TO MATCH STAIR FRAMING
02A	3'-0" X 7'-0"	С	WOOD	INTERIOR	PAINT	METAL	PAINT	-	-	-	INSTALLED DURING PHASE I
03A	3'-0" X 7'-0"	C G	WOOD	INTERIOR EXTERIOR	PAINT PAINT	METAL	PAINT PAINT	-	-	-	INSTALLED DURING PHASE I
04A 04B	3'-0" X 7'-0" 3'-0" X 7'-0"	В	METAL METAL	INTERIOR	PAINT	METAL METAL	PAINT	-	-	-	INSTALLED DURING PHASE I INSTALLED DURING PHASE I
05A	3'-0" X 7'-0"	С	WOOD	INTERIOR	PAINT	METAL	PAINT	-	-	-	INSTALLED DURING PHASE I
06A	3'-0" X 7'-0"	С	WOOD	INTERIOR	PAINT	METAL	PAINT	-	-	-	INSTALLED DURING PHASE I
06A 07A	3'-0" X 7'-0"	В	METAL	EXTERIOR	PAINT	METAL	PAINT	_	-	-	INSTALLED DURING PHASE I
07A 08A	3'-0" X 7'-0"	В	METAL	EXTERIOR	PAINT	METAL	PAINT	-	-	-	INSTALLED DURING PHASE I
09A	PR 3'-0" X 7'-0"	D	METAL	INTERIOR	PAINT	METAL	PAINT	_	-	-	INSTALLED DURING PHASE I
IOA	12'-0"X12'-0"	E	METAL	EXTERIOR	I AINI	IVILIAL	I MINI	_	-	_	INSTALLED DURING PHASE I
IOB	3'-0" X 7'-0"	В	METAL	EXTERIOR	PAINT	METAL	PAINT	-	-	_	INSTALLED DURING PHASE I
IIA	3'-0" X 7'-0"	С	WOOD	INTERIOR	PAINT	METAL	PAINT	_	+	 -	INSTALLED DUNING THASE T
12A	3'-0" X 7'-0"	С	WOOD	INTERIOR	PAINT		PAINT	_	-	 -	
13A	3'-0" X 7'-0"	С	WOOD	INTERIOR	PAINT	METAL		-	 -	+-	
14A	3'-0" X 7'-0"	С	WOOD	INTERIOR	PAINT	METAL			+-	+-	
15A	3'-0" X 7'-0"	С	WOOD	INTERIOR	PAINT	METAL			 -	 -	
16A	3'-0" X 7'-0"	С	WOOD	INTERIOR	PAINT	METAL		_	 	+	
18A	PR 1'-6" X 7'-0"	A	WD W/ LAM.	INTERIOR	1 AINI	METAL			+	+	HARDWARE BY DOOR MANF.
19A	3'-0" X 7'-0"	G	METAL	EXTERIOR	PAINT	METAL		_	+-	 -	INSTALLED DURING PHASE I
19B	3'-0" X 7'-0"	В	METAL	EXTERIOR	PAINT	METAL		_	 	<u> </u>	INSTALLED DURING PHASE I
20A	3'-0" X 7'-0"	В	METAL	EXTERIOR	PAINT	METAL		_	 	_	INSTALLED DURING PHASE I
20B	3'-0" X 7'-0"	С	WOOD	INTERIOR	PAINT	METAL		_	<u> </u>	<u> </u>	INOTALLED DURING FITAGE I
21A	3'-0" X 7'-0"	В	METAL	EXTERIOR	PAINT	METAL	PAINT	_	+-	 	INSTALLED DURING PHASE I
22A	3'-0" X 7'-0"	С	WOOD	INTERIOR	PAINT	METAL		_	 	+	THO TALLED DOTTING LITTLE TO
23A	3'-0" X 7'-0"	С	WOOD	INTERIOR	PAINT	METAL		_	 	+	
24A	3'-0" X 7'-0"	С	WOOD	INTERIOR	PAINT	METAL		_	 	† <u>-</u>	** CLOSER BY DOOR MANF.
25A	3'-0" X 7'-0"	С	WOOD	INTERIOR	PAINT	METAL		_	† <u>-</u>	 	CLOCK OF DOOR WINNEY.
26A	3'-0" X 7'-0"	С	WOOD	INTERIOR	PAINT	METAL		_	+ -	† <u> </u>	
27A	3'-0" X 7'-0"	С	WOOD	INTERIOR	PAINT	METAL		_	† -	 	
28A	PR 1'-6" X 7'-0"	A	WD W/ LAM.	INTERIOR	-	METAL		_	1 -	 	HARDWARE BY DOOR MANF.
28B	PR 1'-6" X 7'-0"	A	WD W/ LAM.	INTERIOR	-	METAL		_	_	† <u>-</u>	HARDWARE BY DOOR MANF.
29A	3'-0" X 7'-0"	С	WOOD	INTERIOR	PAINT	METAL		_	_	† <u>-</u>	
30A	3'-0" X 7'-0"	С	WOOD	INTERIOR	PAINT			-	 -	+-	
/\		<u> </u>	1		1, (1141					1	
202A	3'-0" X 7'-0"	В	METAL	EXTERIOR	PAINT	METAL	PAINT	_	 	† -	
									-		
	1					<u> </u>				1	

			ROOM F	INISH SCHEDUI	LE		
ROOM NAME		FLOOR	WALLS	1	CEILING	Ī	REMARKS
	FLOORS	BASE	MATERIALS	FINISH	MATERIAL	FINISH	
OI BREEZEWAY	SEALED CONCRETE	EXPOSED METAL BUILDING	METAL PANEL SIDING	-	EXPOSED METAL BUILDING	EXPOSED METAL BUILDING	COMPLETED DURING PHASE I
102 OFFICE	VCT	6" VINYL	GYP. BD	PAINT	GYP. BD.	_	COMPLETED DURING PHASE I
03 OFFICE	VCT	6" VINYL	GYP. BD	PAINT	GYP. BD.	_	COMPLETED DURING PHASE I
04 HALL	VCT	6" VINYL	GYP. BD	PAINT	GYP. BD.	_	COMPLETED DURING PHASE I
05 BREAKROOM	VCT	6" VINYL	GYP. BD	PAINT	GYP. BD.	_	COMPLETED DURING PHASE I
06 BATH	VCT	6" VINYL	MOISTURE RESISTANT GYP. BD	PAINT	GYP. BD.	_	COMPLETED DURING PHASE I
07 STORAGE	VCT	6" VINYL	GYP. BD	PAINT	GYP. BD.	_	COMPLETED DURING PHASE I
08 BATH	VCT	6" VINYL	MOISTURE RESISTANT GYP. BD	PAINT	GYP. BD.	_	COMPLETED DURING PHASE I
109 TOOLS	SEALED CONCRETE	EXPOSED METAL BUILDING	EXPOSED FRAMING / METAL BUILDING	EXPOSED METAL BUILDING	GYP. BD.	-	COMPLETED DURING PHASE I
10 SHOP	SEALED CONCRETE	EXPOSED METAL BUILDING	PLYWOOD AT MEZZ. WALL / METAL BUILDING	EXPOSED METAL BUILDING	EXPOSED METAL BUILDING	-	COMPLETED DURING PHASE I
OFFICE	VCT	6" VINYL	GYP. BD	PAINT	LAY IN CEILING	_	
12 OFFICE	VCT	6" VINYL	GYP. BD	PAINT	LAY IN CEILING	_	
13 INTERN	VCT	6" VINYL	GYP. BD	PAINT	LAY IN CEILING	_	
14 ELECTRICAL	SEALED CONCRETE	6" VINYL	GYP. BD	PAINT	LAY IN CEILING	_	
15 REHAB #2	VCT	6" VINYL	MOISTURE RESISTANT GYP. BD	FRP	LAY IN CEILING	_	
16 REHAB #1	VCT	6" VINYL	MOISTURE RESISTANT GYP. BD	FRP	LAY IN CEILING	_	
17 STORAGE	VCT	6" VINYL	GYP. BD	PAINT	LAY IN CEILING	_	
18 KITCHEN / PREP.	VCT	6" VINYL	MOISTURE RESISTANT GYP. BD	FRP	* LAY IN CEILING	_	*PROVIDE VINYL FACED WASHABLE LAY IN . CEIL. SURFACE
19 CORRIDOR	VCT	6" VINYL	GYP. BD	PAINT	LAY IN CEILING	_	
20 ISOLATION	VCT	6" VINYL	MOISTURE RESISTANT GYP. BD	FRP	GYP. BD.	PAINT	
21 STORAGE	VCT	6" VINYL	GYP. BD	PAINT	GYP. BD.	PAINT	
22 TRIAGE	VCT	6" VINYL	MOISTURE RESISTANT GYP. BD	FRP	GYP. BD.	PAINT	
23 REHAB #3	VCT	6" VINYL	MOISTURE RESISTANT GYP. BD	FRP	GYP. BD.	PAINT	
24 EMPLOYEE BATH	VCT	6" VINYL	GYP. BD	PAINT	GYP. BD.	PAINT	
25 JANITOR	SEALED CONCRETE	6" VINYL	MOISTURE RESISTANT GYP. BD	FRP	GYP. BD.	PAINT	
26 STORAGE	VCT	6" VINYL	GYP. BD	PAINT	GYP. BD.	PAINT	
27 STORAGE	VCT	6" VINYL	GYP. BD	PAINT	GYP. BD.	PAINT	
28 TREATMENT	VCT	6" VINYL	MOISTURE RESISTANT GYP. BD	FRP	LAY IN CEILING	_	
29 EXAM	VCT	6" VINYL	MOISTURE RESISTANT GYP. BD	FRP	LAY IN CEILING	_	
30 LAUNDRY	VCT	6" VINYL	MOISTURE RESISTANT GYP. BD	FRP	LAY IN CEILING	_	
201 STORAGE	EXPOSED PLYWOOD	EXPOSED METAL BUILDING	EXPOSED FRAMING / METAL BUILDING				COMPLETED DURING PHASE I
02 STORAGE	EXPOSED PLYWOOD	EXPOSED METAL BUILDING	EXPOSED FRAMING / METAL BUILDING				

GENERAL NOTES

ALL GREYED OUT ITEMS WERE CONSTRUCTED DURING PHASE I


A B ELIASON SCP-8 HOLLOW METAL SWINGING TRAFFIC DOOR DOOR IN H.M. CASED OPENING SOLID CORE SINGLE PANEL DOOR E) COILING ROLL UP DOOR HOLLOW METAL INTERIOR DOOR

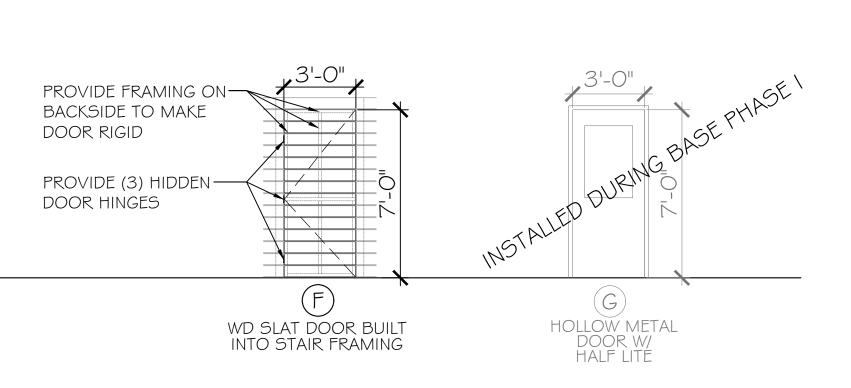

NOTES: * ALL FRP PANELS INSTALLED TO 9'-0" A,F,F,

VCT - 12"X12" 1/8" STANDARD VINYL COMPOSITION TILE

DOOR FRAME / TYPES

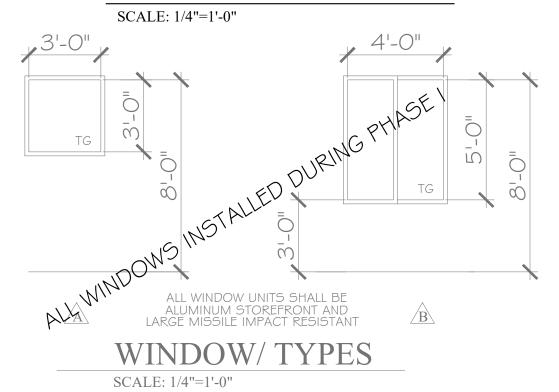

21-06 JOB NO.: DRAWN: CLT CHECKED:

ORANGE B
WILDLIFE

SBM 2021.06.01 DATE: REVISION:

1/4"=1'-0" SCALE:

SHEET NO.:

DOOR, WINDOW & FINISH SCHEDULE


McCollough Architecture, Inc. P.O. BOX 6310 GULF SHORES, ALABAMA 36547-6310 PHONE: 251-968-7222




GENERAL NOTE

DURING A PREVIOUS PHASE, OTHER THAN THE COOLER, FREEZER AND ASSOCIATED CONCRETE

ALL EXTERIOR ITEMS HAVE BEEN COMPLETED

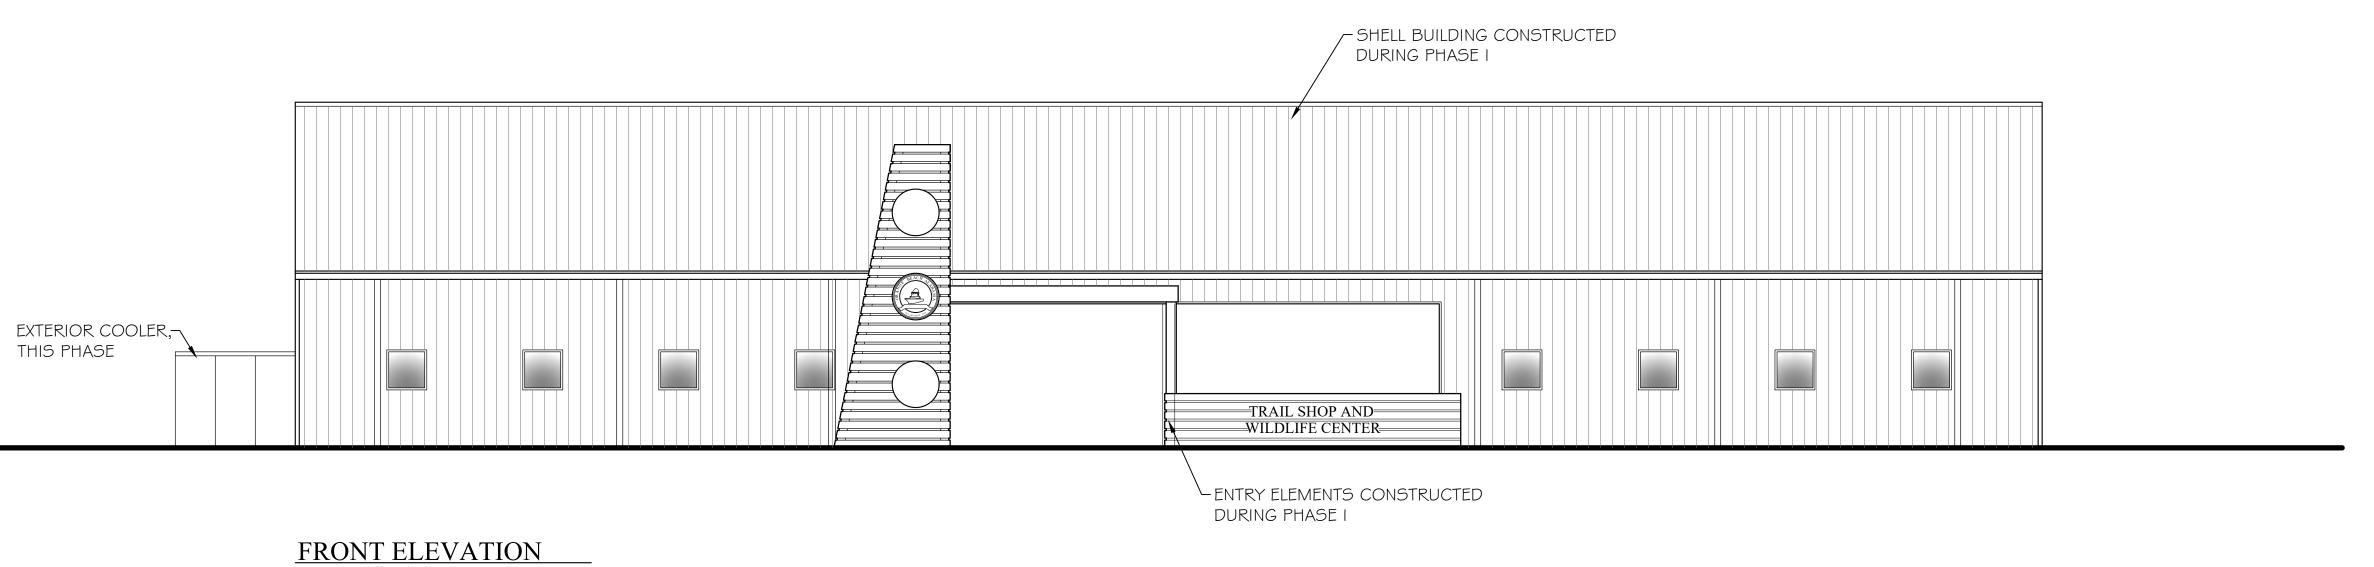

FRONT ELEVATION
SCALE: 1/8"=1'-0"

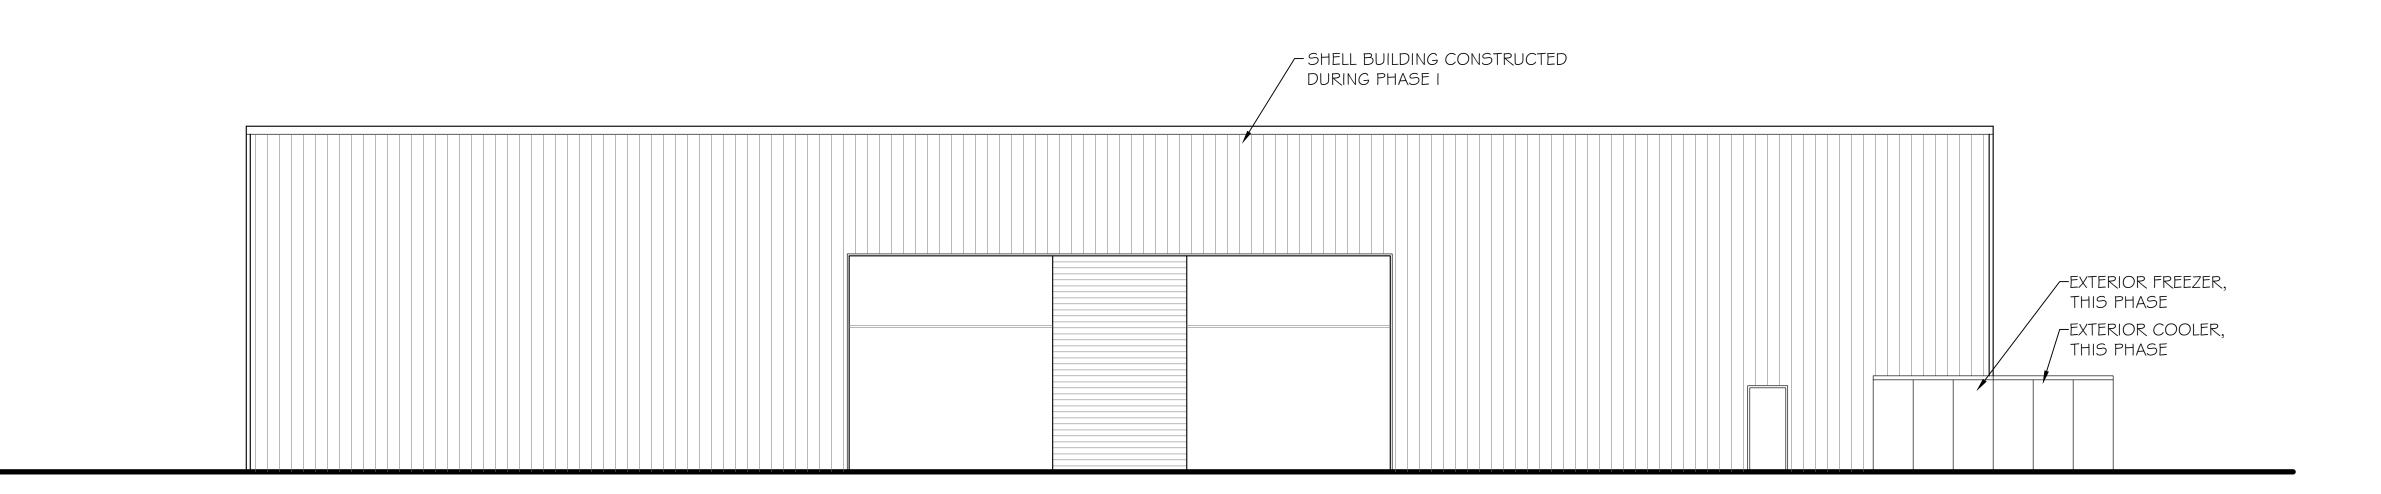


REAR ELEVATION
SCALE: 1/8"=1'-0"

PADS WHICH ARE TO BE CONSTRUCTED /
INSTALLED DURING THIS PHASE II. SHELL BUILDING CONSTRUCTED DURING PHASE I SHELL BUILDING CONSTRUCTED DURING PHASE I EXTERIOR FREEZER, THIS PHASE EXTERIOR FREEZER, THIS PHASE EXTERIOR COOLER, THIS PHASE

LEFT SIDE ELEVATION
SCALE: 1/8"=1'-0"

RIGHT SIDE ELEVATION
SCALE: 1/8"=1'-0"

McCollough Architecture, Inc. P.O. BOX 6310 GULF SHORES, ALABAMA 36547-6310 PHONE: 251-968-7222

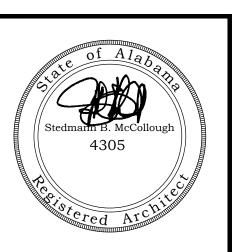

ORANGE E
WILDLIFE

21-06 JOB NO.: DRAWN: CLT SBM CHECKED: 2021.06.01 DATE: REVISION:

1/8" = 1'-0" SCALE:


SHEET NO.:

PHASE II EXTERIOR ELEVATIONS

PHASE II


GENERAL NOTE

ALL GREYED OUT ITEMS WERE CONSTRUCTED DURING PHASE I

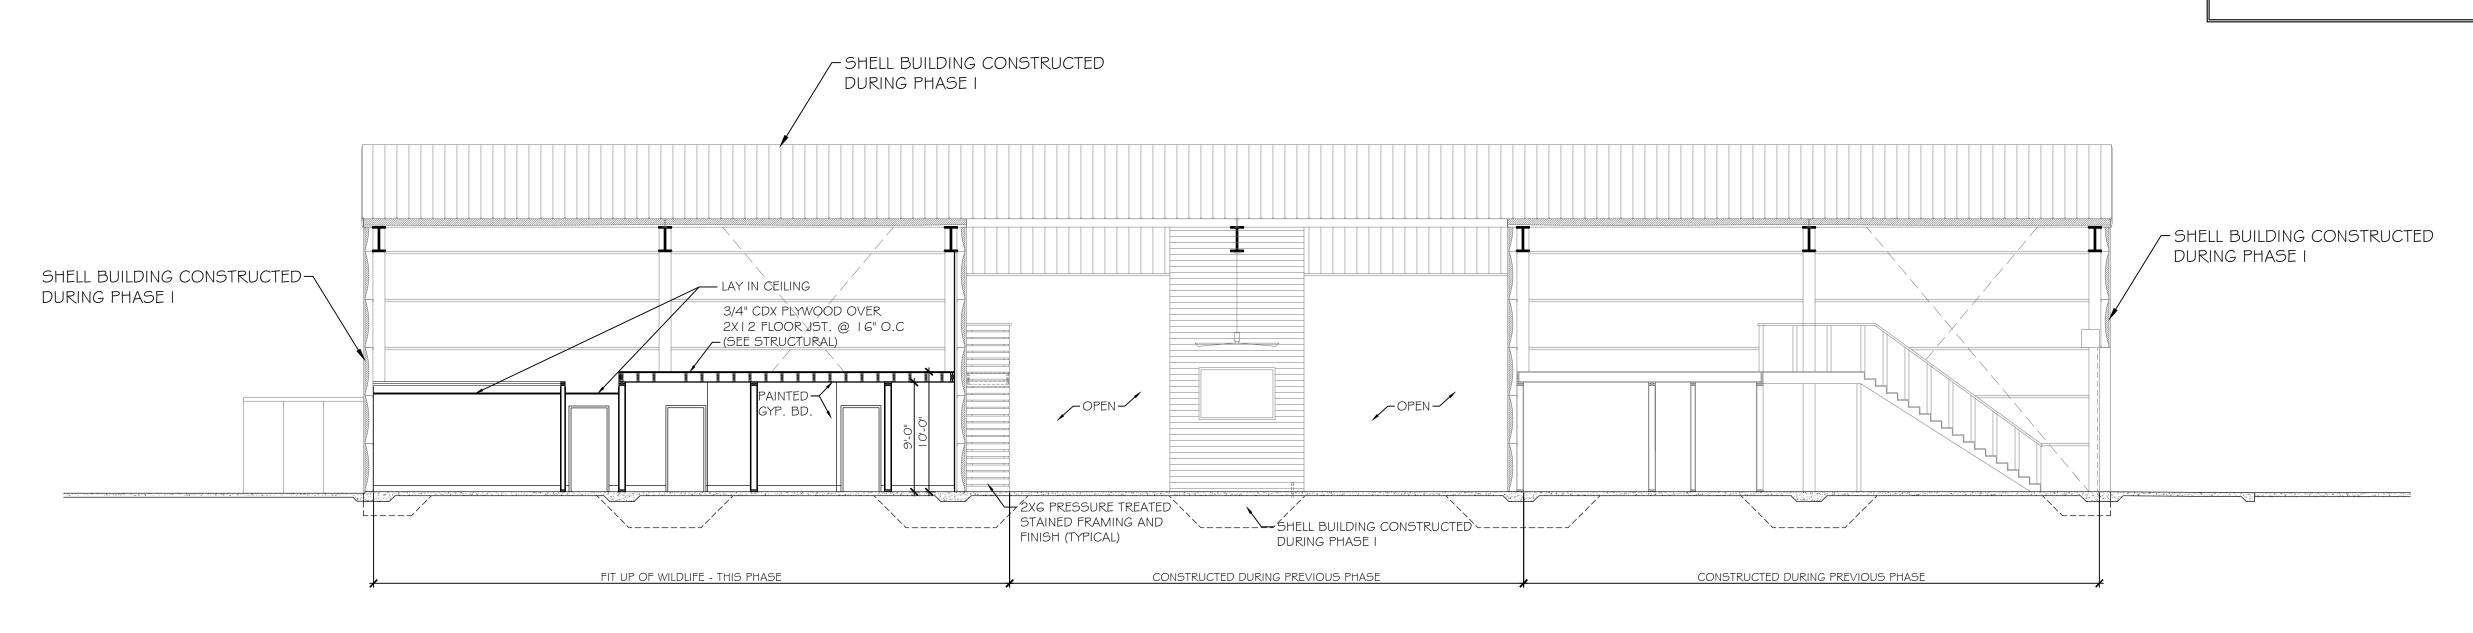


BUILDING SECTION

A4.1 SCALE: 1/8"=1'-0"

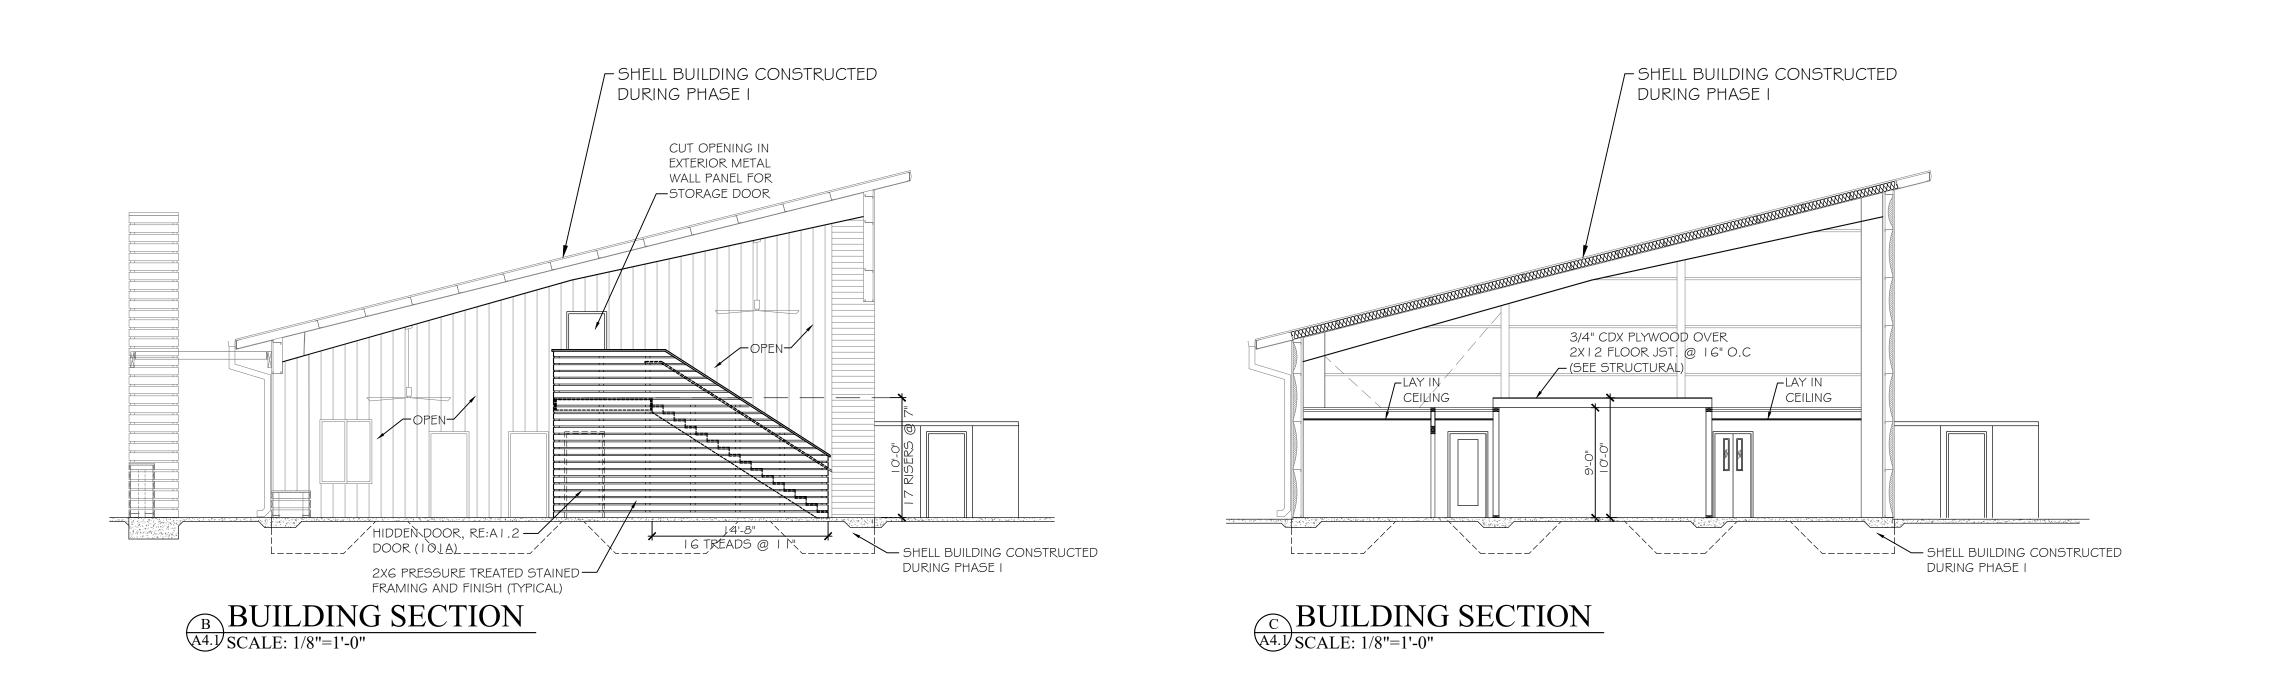

McCollough Architecture, Inc.
P.O. BOX 6310
GULF SHORES, ALABAMA
36547-6310
PHONE: 251-968-7222

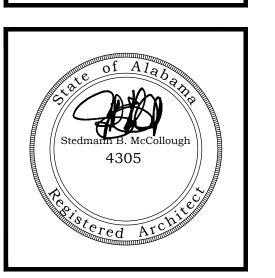

ORANGE BEACH
WILDLIFE CENTER
ORANGE BEACH

JOB NO.: 21-06
DRAWN: CLT
CHECKED: SBM
DATE: 2021.06.01
REVISION:


SCALE:


SCALE: 1/8" = 1'-0"

SHEET NO.:


A4.1

PHASE II BUILDING SECTIONS

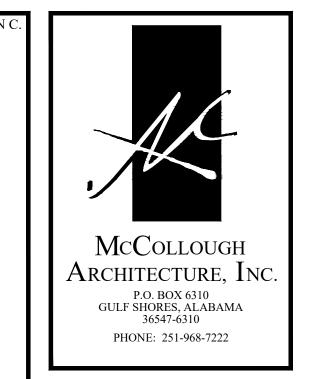

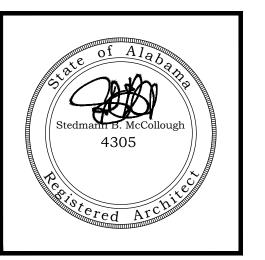

ORANGE BEACH WILDLIFE CENTER ORANGE BEACH ALABAMA

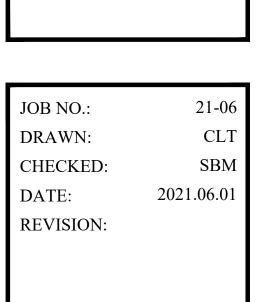


SCALE: 1/2" = 1'-0"


SHEET NO.:


A4.2

SECTIONS AND DETAILS

PHASE II

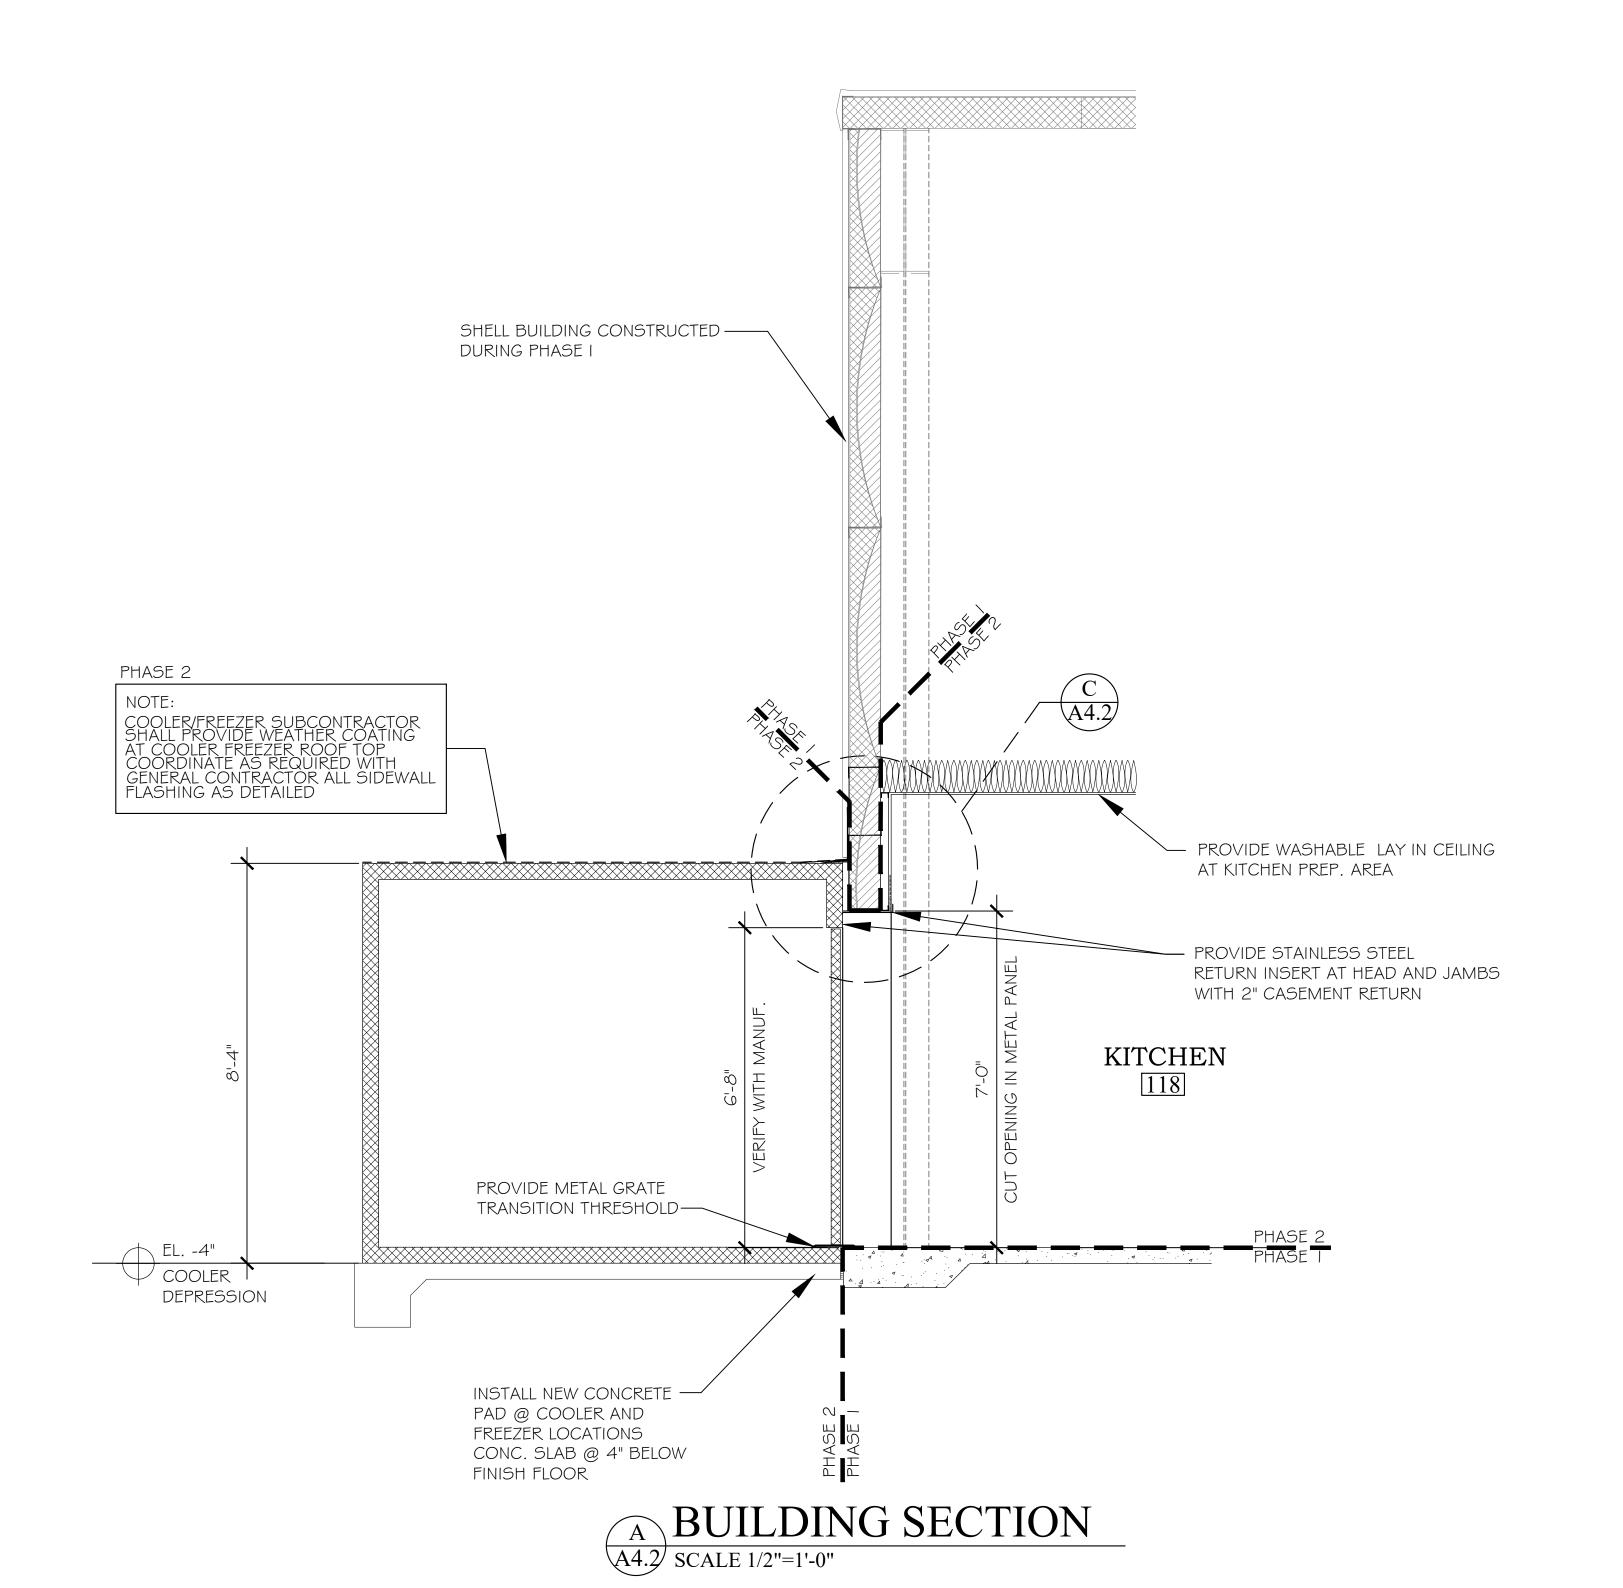

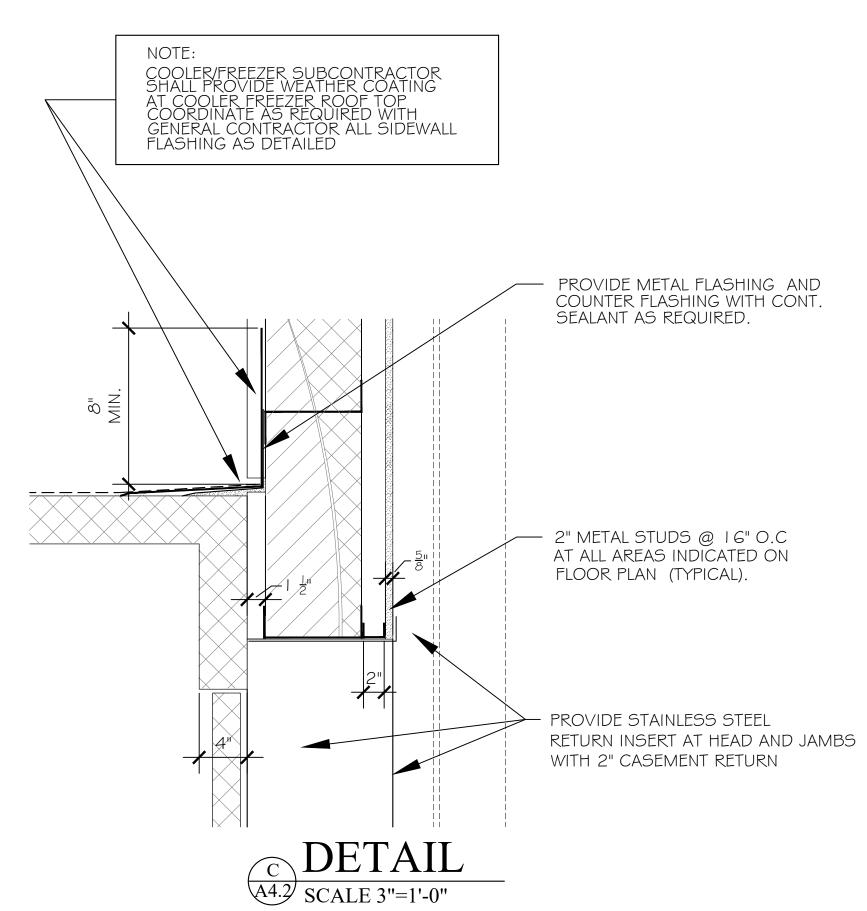


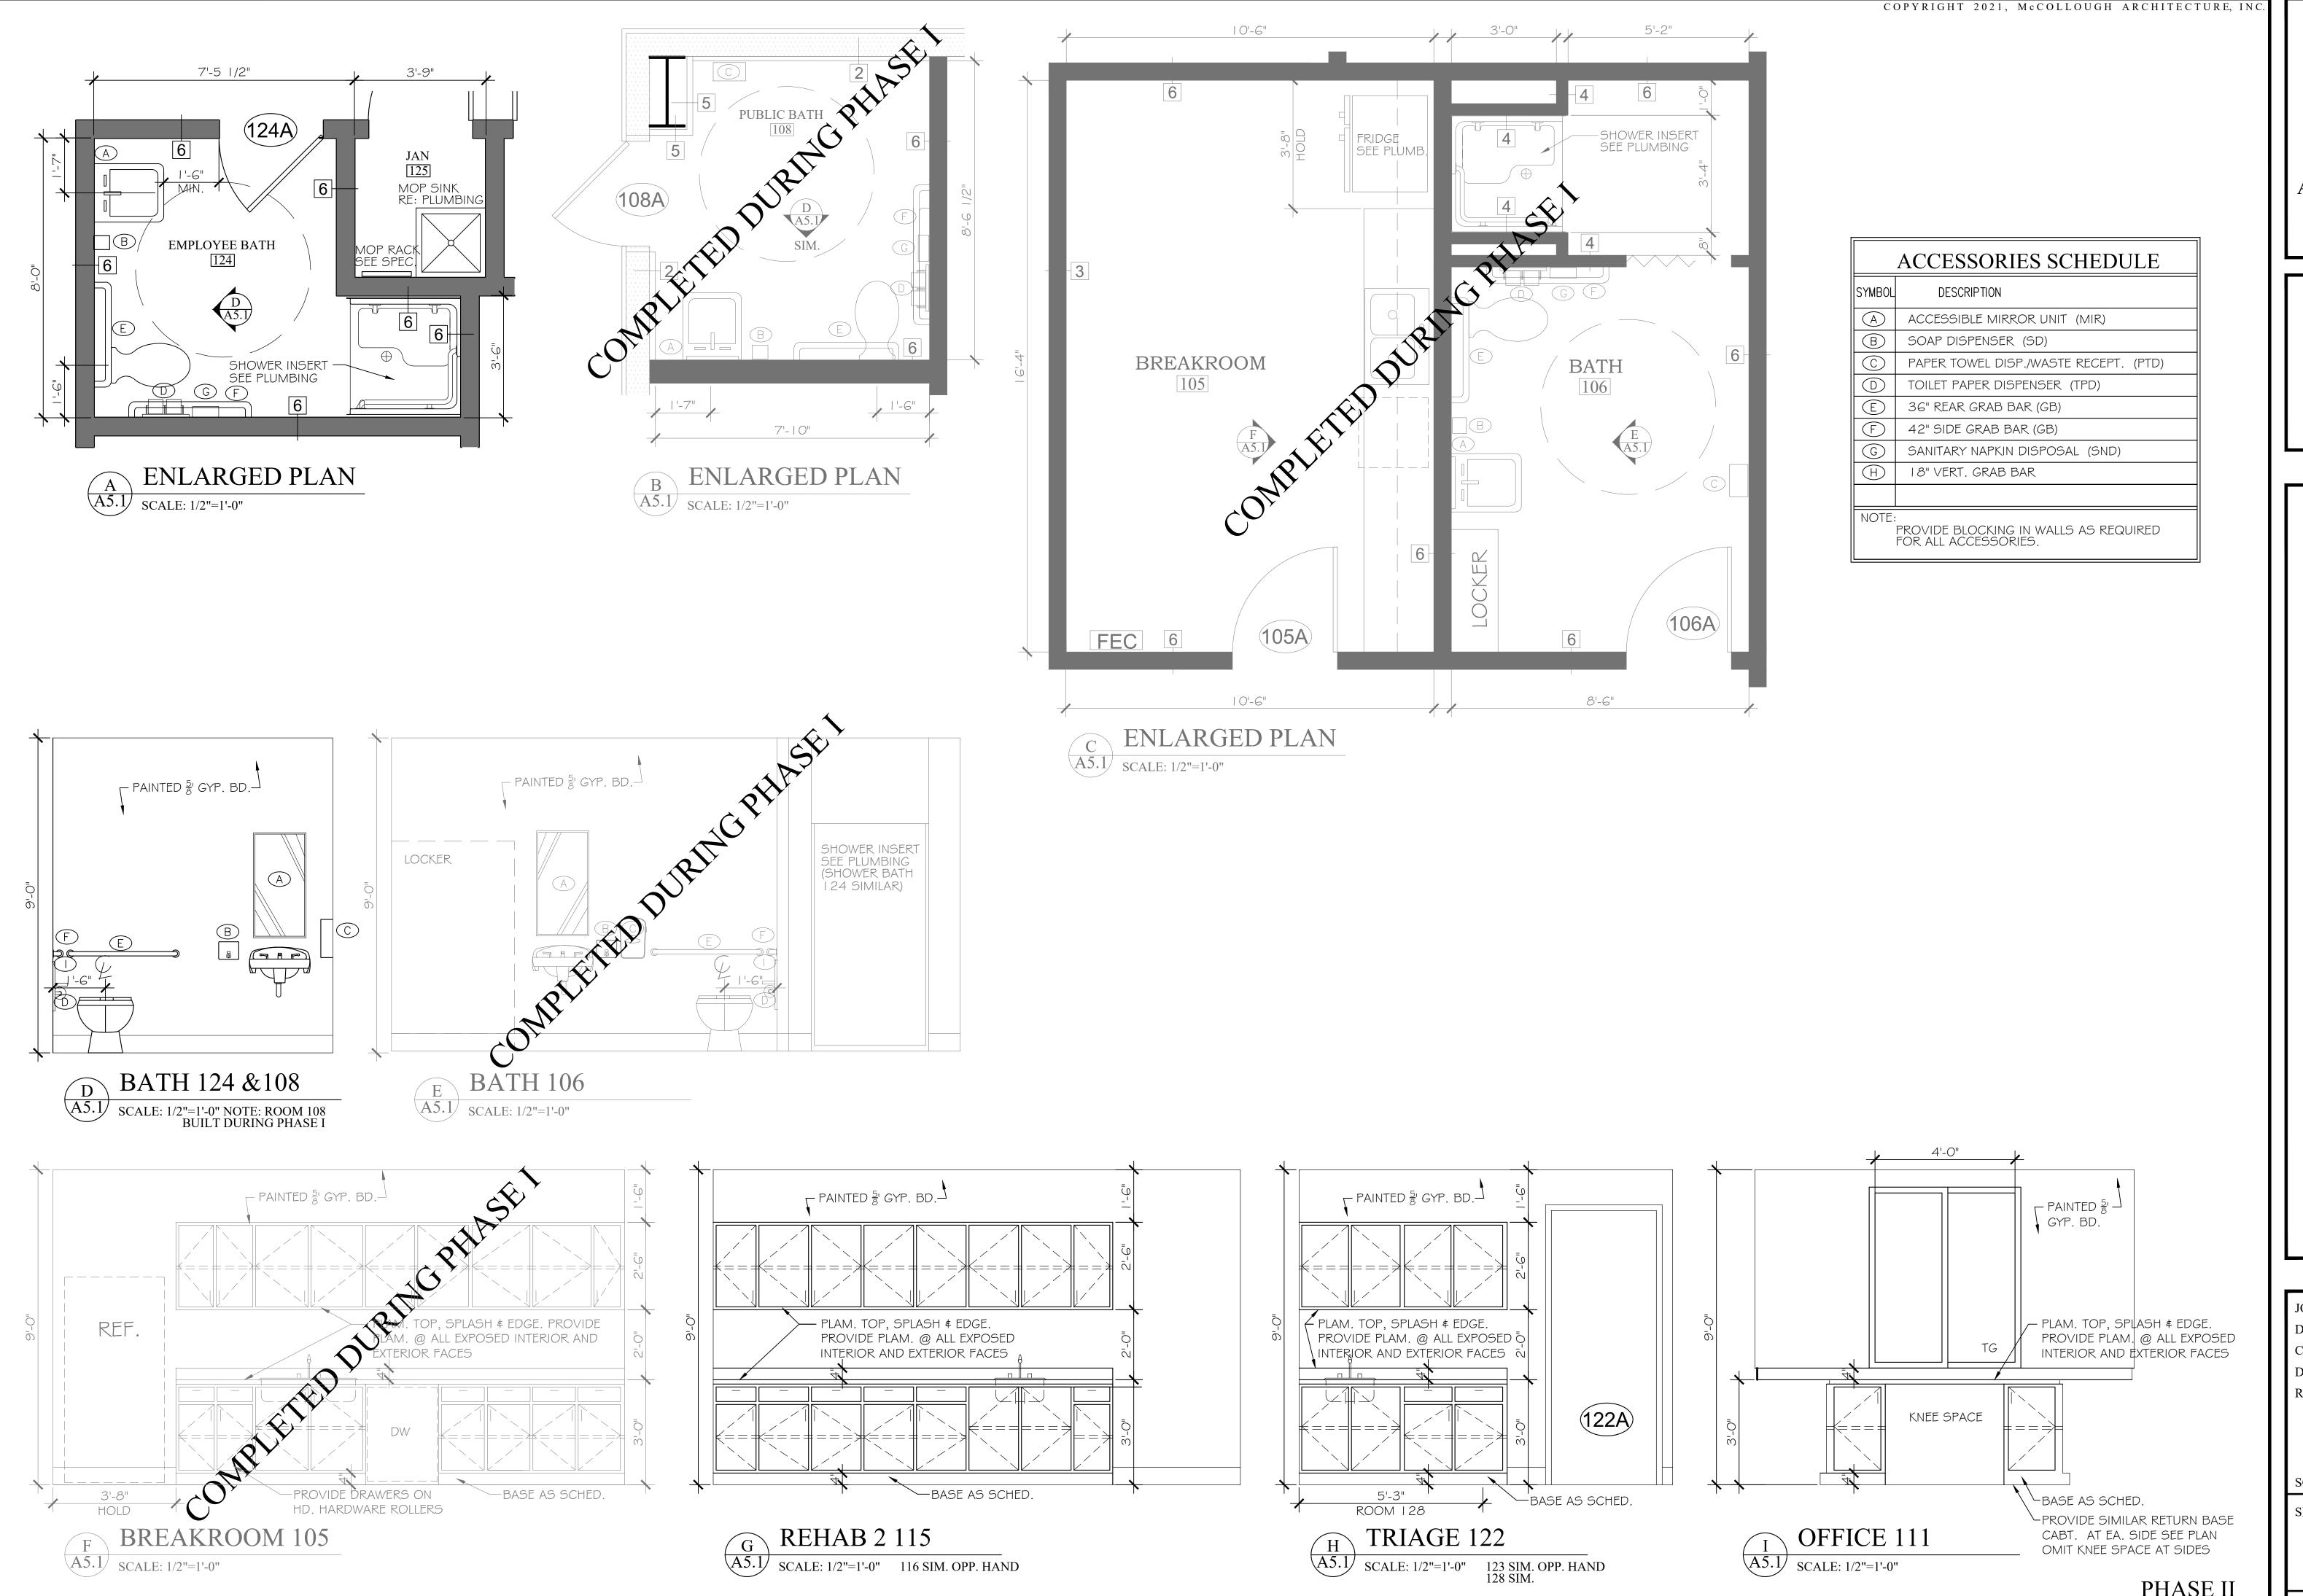

A5.1 SCALE: 1/2"=1'-0" 116 SIM. OPP. HAND

A5.1 SCALE: 1/2"=1'-0"

McCollough ARCHITECTURE, INC. P.O. BOX 6310 GULF SHORES, ALABAMA 36547-6310 PHONE: 251-968-7222

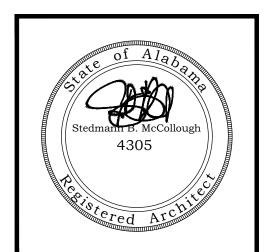

ORANGE E

LDLIFE

ORANGE E

ALABAN

21-06 JOB NO.: DRAWN: CHECKED: 2021.06.01 DATE: REVISION:


1/2" = 1'-0" SCALE:

SHEET NO.:


PHASE II

A5.1) SCALE: 1/2"=1'-0"

ENLARGED PLANS & INTERIOR ELEVATIONS

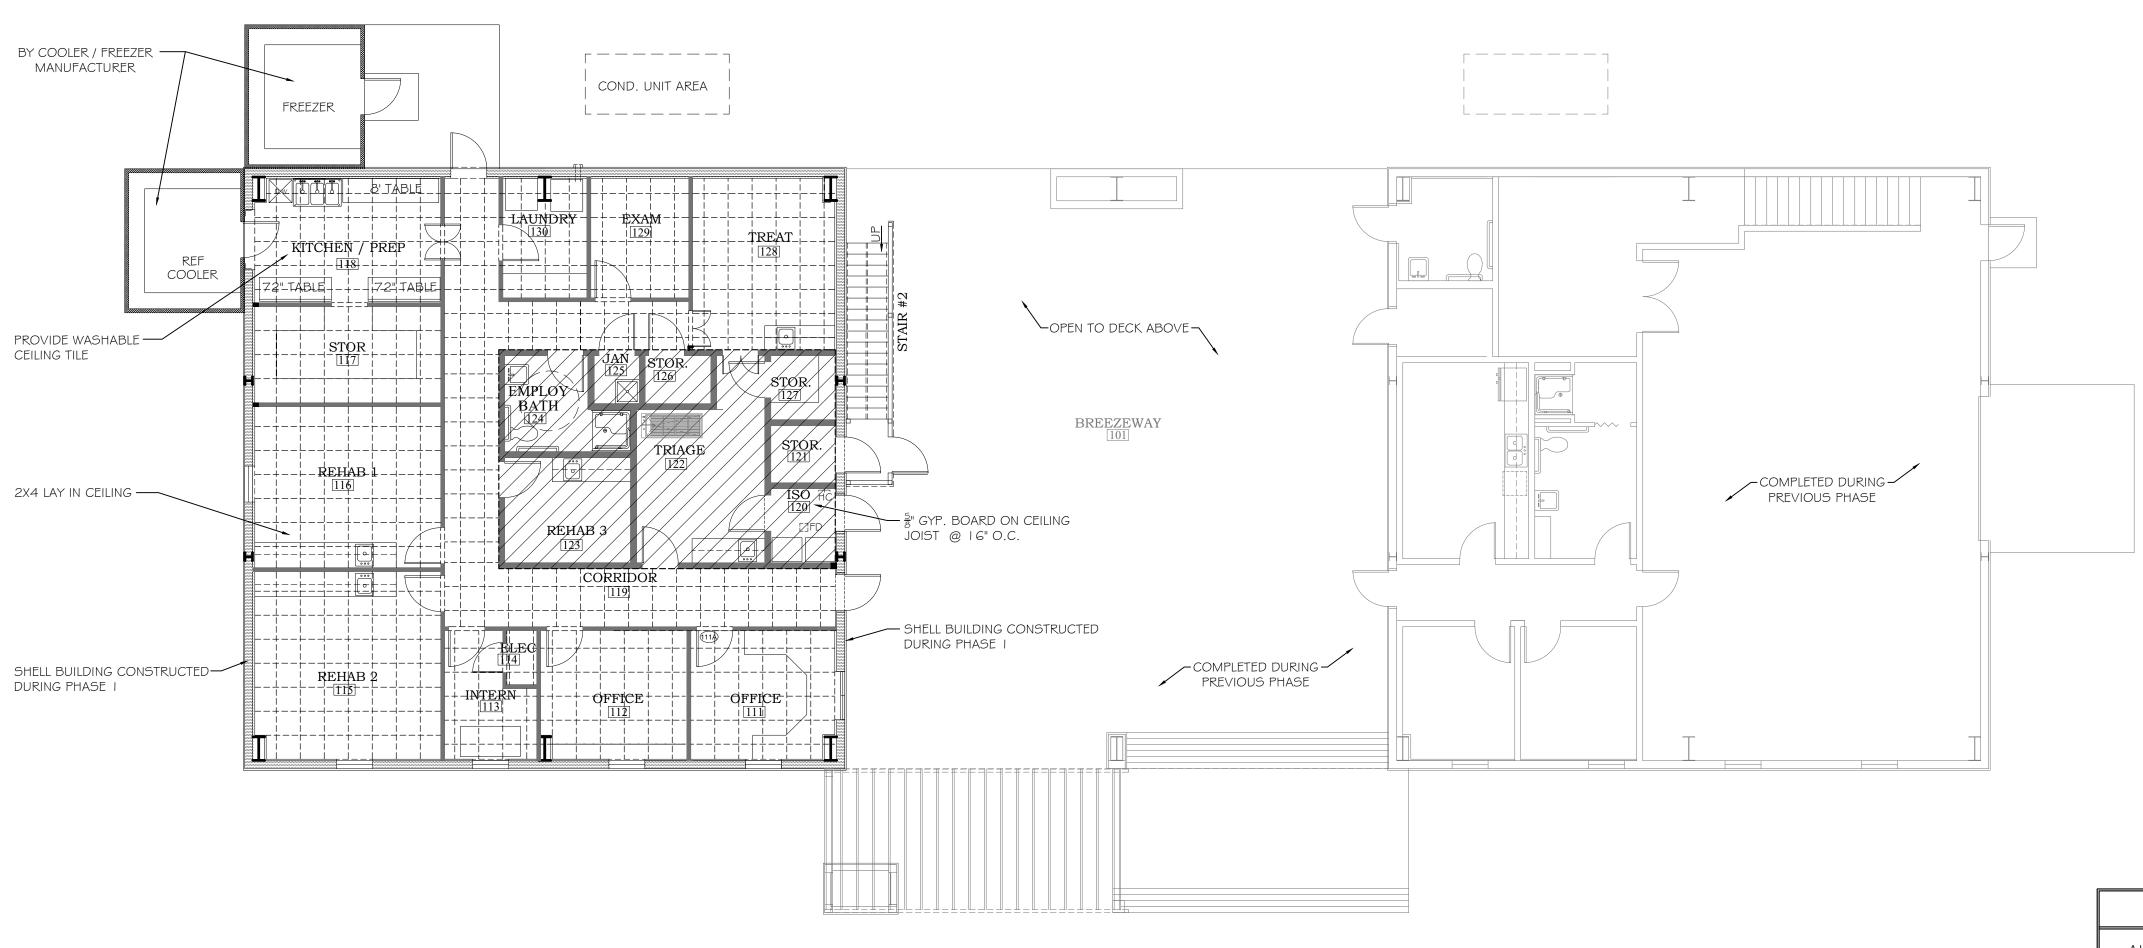

FIRST FLOOR REFLECTED CEILING PLAN SCALE: 1/8"=1'-0"

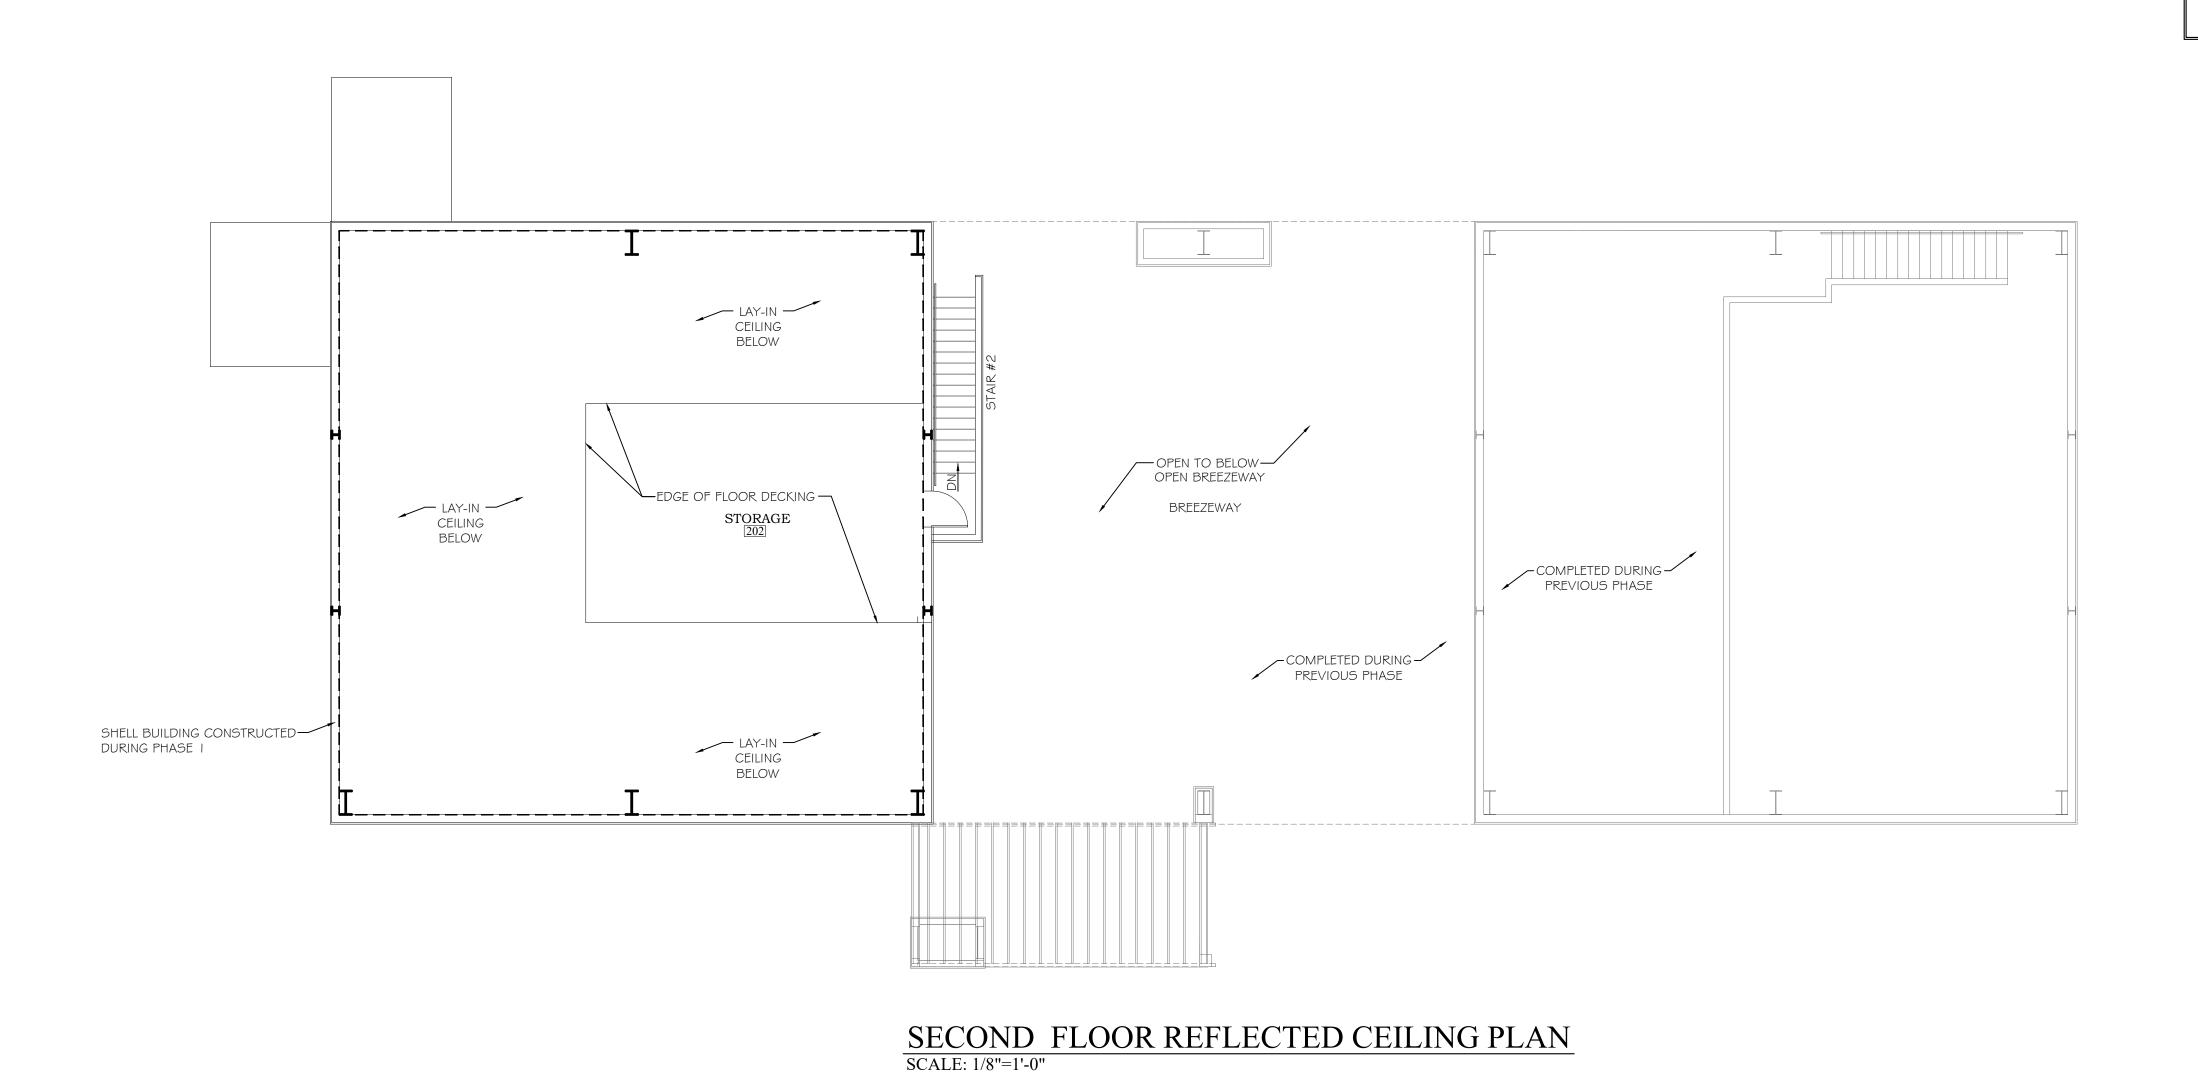

21-06 DRAWN: CHECKED: 2021.06.01 REVISION:

McCollough

Architecture, Inc.

P.O. BOX 6310 GULF SHORES, ALABAMA 36547-6310

PHONE: 251-968-7222

1/8" = 1'-0"

SHEET NO.:

REFLECTED CEILING PLAN

GENERAL NOTES

ALL GREYED OUT ITEMS WERE CONSTRUCTED DURING PHASE I


SEE ELECTRICAL AND LIFE SAFETY PLANS FOR LIGHT FIXTURES AND REQUIRED SAFETY DEVICES

SEE MECHANICAL PLANS FOR HVAC SUPPLY, RETURN AND EXHAUST VENTS







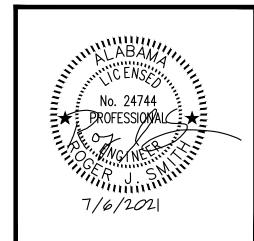

MECHANICAL CONTRACTOR TO PROVIDE GENERAL CONTRACTOR WITH AS-BUILT DRAWINGS, ALL EQUIPMENT SHOP DRAWINGS, INFORMATION ON THERMOSTATS, CONTROL WIRING DIAGRAMS AND OTHER PERTINENT INFORMATION AT COMPLETION

1. ALL WORK SHALL BE IN STRICT ACCORDANCE WITH ALL FEDERAL, STATE AND LOCAL CODES AND ORDINANCES. COMPLY WITH 2018 INTERNATIONAL MECHANICAL

2. FURNISH ALL LABOR, MATERIALS, TOOLS, INCIDENTALS AND DETAILS NECESSARY TO PROVIDE A COMPLETE HEATING, VENTILATING, AIR CONDITIONING SYSTEM. INCLUDE

ANY LABOR AND MATERIAL NOT SPECIFICALLY MENTIONED, BUT NECESSARY TO PROVIDE A COMPLETE AND OPERATING SYSTEM. ALL WORK SHALL BE INSTALLED IN

REQUIREMENTS SHALL BE INCLUDED IN THIS CONTRACTORS BID PRICE.

OVER TO OWNER AT COMPLETION OF PROJECT.

ELECTRICAL AND OTHER BUILDING DRAWINGS.

DIFFUSERS/GRILLES/LOUVERS

12"ø

- DISTRIBUTION DEVICE

C-CEILING, D-DOOR,

D-DIFFUSER, G-GRILLE,

BLOW PATTERN (4-WAY)

F-FLOOR, W-WALL

FOURTH CHARACTER:

SECOND LETTER:

FIRST LETTER:

L-LOUVER

THIRD LETTER:

TYPE CODE

OF DUPLICATE AIR -

DEVICES DESIGNATED

BY THIS SYMBOL (2)

DELIVERED BY DEVICE IN CFM (200 CFM)

NECK SIZE IN ——

INCHES (12")

AIR QUANTITY -

3. THIS CONTRACTOR SHALL SECURE AND PAY FOR ALL REQUIRED PERMITS AND

4. MECHANICAL PLANS ARE DIAGRAMMATIC, NOT SHOWING EVERY ITEM IN EXACT

LOCATION OR DETAIL. MEASUREMENTS AND LOCATIONS MUST BE FIELD VERIFIED

AND COORDINATED WITH ARCHITECTURAL, HVAC, FIRE PROTECTION, STRUCTURAL,

A PROFESSIONAL MANNER AND SHALL MEET ALL THE REQUIREMENTS OF THE STATE

BUILDING CODE, CITY BUILDING CODE, SAFETY AND HEALTH CODES, NFPA CODES AND ALL OTHER APPLICABLE CODES AND REQUIREMENTS. ALL COSTS FOR SAID

INSPECTIONS AND PERFORM ALL TESTS CALLED FOR OR REQUIRED AS A PART OF HIS WORK. FURNISHED APPROVED CERTIFICATE OF FINAL INSPECTION, AND TURN

GENERAL HVAC NOTES

- 6. DUCTS USED TO CONVEY THE CONDITIONED AIR SUPPLY AND VENTILATION AIR ARE TO BE MADE OF CONTINUOUS SHEET METAL.
- 7. DUCT LININGS (THERMAL AND ACOUSTICAL), VIBRATION ISOLATION CONNECTORS, FLEXIBLE DUCT CONNECTORS, AND DUCT TYPE SHALL BE APPROVED BY APPLICABLE CODE AND MECHANICAL ENGINEER.
- 8. ALL RETURN AIR, AND SUPPLY AIR DUCTWORK SHALL BE EXTERNALLY INSULATED WITH 1" THICK, 1.5 LBS. DENSITY FOIL FACED FIBERGLASS INSULATION. LINED DUCTWORK DOES NOT REQUIRE EXTERIOR INSULATION. DUCT DIMENSIONS SHOWN ARE INSIDE NET DIMENSIONS, ADD TO SHEET METAL SIZE FOR INSULATION. IN GENERAL, INSTALL DUCTWORK TIGHT TO UNDERSIDE OF STRUCTURE UNLESS OTHERWISE NOTED OR REQUIRED BY FIELD CONDITIONS. COORDINATE EXACT MOUNTING HEIGHT IN FIELD WITH GENERAL CONTRACTOR. ROUND DUCTWORK IN CONDITIONED SPACE DOES NOT REQUIRE INSULATION UNLESS OTHERWISE NOTED.
- 9. ALL DUCTWORK SHALL BE SHEET METAL FABRICATED IN ACCORDANCE WITH ASHRAE GUIDE AND SMACNA MANUAL LATEST EDITIONS.
- 10. ALL BRANCH TAKE-OFFS SHALL BE PROVIDED WITH MANUAL BALANCING DAMPERS.
- 11. FLEXIBLE INSULATED DUCTS SHALL BE MAXIMUM 10'-0" LONG AND SHALL MEET
- INSTALLATION AND MATERIAL REQUIREMENTS OF LOCAL CODES. 12. THE MECHANICAL CONTRACTOR SHALL FURNISH AND INSTALL A COMPLETE TEMPERATURE CONTROL SYSTEM TO INCLUDE: PANELS, MODULES, RELAYS, WIRING, THERMOSTATS, SENSORS, DAMPERS, ACTUATORS AND ALL MISCELLANEOUS ITEMS AS REQUIRED TO FULFILL THE DESIGN INTENT AS INDICATED ON THE PLANS AND IN
- 13. ALL TEMPERATURE CONTROLS, FIRE ALARM COMPONENTS, EQUIPMENT NAMEPLATES, LABELS, OR COLOR CODED COMPONENTS SHALL BE MASKED DURING PAINTING TO
- PREVENT DAMAGE FROM OVER-SPRAY OR OBSCURING INFORMATION. 14. ALL LOW VOLTAGE WIRING AND CONDUIT REQUIRED FOR MECHANICAL EQUIPMENT SHALL BE FURNISHED AND INSTALLED BY MECHANICAL CONTRACTOR. MECHANICAL CONTRACTOR SHALL COORDINATE POWER REQUIREMENTS FOR HVAC EQUIPMENT WITH ELECTRICAL CONTRACTOR.
- 15. SEAL & TAPE ALL OPENINGS IN DUCTWORK AIRTIGHT AFTER TESTING.
- 16. CHECK & VERIFY ALL FIELD CONDITIONS & ACTUAL DIMENSIONS BEFORE PREPARING SHOP DRAWINGS BEFORE INSTALLATION. NOTIFY ARCHITECT IMMEDIATELY OF ANY AND ALL DISCREPANCIES.
- 17. TEST & BALANCE ALL SUPPLY & EXHAUST SYSTEMS ACCORDING TO CFM INDICATED ON PLANS.
- 18. ALL APPLIANCE AND PLUMBING VENTS SHALL BE AT LEAST TEN (10) FEET IN A HORIZONTAL DIRECTION. OR THREE (3) FEET ABOVE THE OUTSIDE AIR INTAKES FOR HVAC AND MAKE-UP AIR UNITS.

SEQUENCE OF OPERATION

THE CODED NOTES.

OCCUPIED MODE

AHU SHALL RUN CONTINUOUSLY WITH HEAT PUMP UNIT CYCLING AS REQUIRED TO MAINTAIN SPACE TEMPERATURE IN COOL OR HEAT MODE. SETPOINT FOR COOLING SHALL BE 75°F ADJUSTABLE AND HEATING SHALL BE 70°F ADJUSTABLE.

A CALL FOR COOLING FROM THE SPACE THERMOSTAT SHALL ENERGIZE THE AIR <u>HEATING</u>


A CALL FOR HEATING FROM THE SPACE THERMOSTAT SHALL ENERGIZE THE AIR HANDLER AND REFRIGERATION CIRCUITS IN STAGES IN REVERSE MODE AS DICTATED BY THE HEAT PUMP UNIT'S INTERNAL CONTROLS. THE AIR HANDLER AND ALL REFRIGERATION CIRCUITS SHALL BE DE-ENERGIZED WHEN SPACE TEMPERATURE

REQUIREMENT HAS BEEN MET. IF THE SPACE HEATING REQUIREMENTS CAN NOT BE MET USING THE REVERSE CYCLE ALONE, THE ELECTRIC HEATER WILL BE ENERGIZED IN STAGES AND CONTROLLED BY THE HEAT PUMP UNIT'S INTERNAL CONTROLS TO PROVIDE SUPPLEMENTAL HEAT. THE ELECTRIC HEATER AND THE REFRIGERATION CIRCUITS SHALL BE DE-ENERGIZED WHEN SPACE TEMPERATURE REQUIREMENT HAS BEEN MET.

UNOCCUPIED MODE

AHU AND HEAT PUMP SHALL CYCLE AS REQUIRED TO MAINTAIN SETPOINT. TEMPERATURE SETPOINT FOR COOLING SHALL BE 80°F. SETPOINT FOR HEATING SHALL BE 65°F. BOTH COOLING AND HEATING SETPOINTS SHALL BE ADJUSTABLE.

McCollough
Architecture, Inc
P.O. BOX 6310 GULF SHORES, ALABAMA 36547-6310

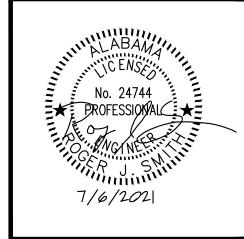

DR SE

JOB NO.:	
DRAWN:	R
CHECKED:	R
DATE:	2021.07.
REVISION:	

AS SHOWN SCALE:

SHEET NO.:

HVAC LEGEND, NOTES, AND SCHEDULES

						SPL	IT SYSTE	M HEAT	PUMP SC	HEDULE	(WILDLIFE	CENTER	R / PHASI	E TWO)	
HVAC SYMBOL LEGEND				TOTAL	O.A.	MIN EFF	TCIENCY	COOLING	CAPACITY	HEATING	CAPACITY		II.	NDOOR UN	17
ALL SYMBOLS SHOWN MAY NOT APPEAR IN DRAWINGS.	MARK NO.	AREA SERVED	TONS	CFM	(CFM)	HSPF	SEER	TOTAL MBH	SENS. MBH	CAPACITY MBH	AUX. HEAT KW	VOLT PHASE	HP	E.S.P.	
SUPPLY AIR															r

MARK NO. AREA SERVED TONS		TOTAL	O.A.	MIN EFF	TICIENCY	COOLING	CAPACITY	HEATING	CAPACITY		IN	IDOOR UN	IT			OUTDOO	R UNIT				
MARK	NO.	AREA SERVED	TONS	CFM	(CFM)	HSPF	SEER	TOTAL MBH	SENS. MBH	CAPACITY MBH	AUX. HEAT KW	VOLT PHASE	HP	E.S.P.	MCA	МОСР	VOLT PHASE	MCA	МОСР	WEIGHT (LBS)	NOTES
AHU-2	HP-2	WILDLIFE CENTER	3	1200	138	8.2	14	36	25.2	8	5	240/1	1/2	0.5	28	30	240/1	24	40	296	ALL
AHU-3	HP-3	WILDLIFE CENTER	3	1200	101	8.2	14	32.3	22.6	8	5	240/1	1/2	0.5	28	30	240/1	24	40	296	ALL

- 1. BASIS OF DESIGN CARRIER FX4D FAN COIL WITH 25HNB6 2-STAGE HEAT PUMP (COASTAL APPLICATIONS)
- 2. FURNISH WITH PROGRAMMABLE THERMOSTAT WITH REMOTE BULB SENSOR AT AHU RETURN.
- 3. FURNISH WITH LOW AMBIENT CONTROLS.
- 4. FURNISH WITH ANTI-SHORT CYCLE TIMER.
- 5. FURNISH WITH EVAPORATOR DEFROST CONTROL.
- 6. FURNISH AND INSTALL VIBRATION ISOLATOR FEET TO OUTDOOR UNITS. 7 FASTEN OUTDOOR UNITS TO HOUSEKEEPING PAD.

FIRE DAMPER - HORIZONTAL	/.	FASIEN	OUTDOOR	UNITS	10	HOUSE	LKEI

RETURN AIR

¬↓— SPLITTER

EXHAUST AIR

ELBOW W/ TURNING VANES

___ BALANCING DAMPER

■ ■ MOTORIZED DAMPER

(†) THERMOSTAT

DUCT TURNING UP/DOWN

→ UNDERCUT DOOR 1" MIN.

DOOR GRILLE, SIGHT-PROOF

FLEX DUCT

→ SUPPLY AIR

→ EXHAUST AIR

AUX

BDD

BRD

CEIL

COND

EQUIP

FURN

GA

GRH

GUH HP

MAX

MCA

MECH

MFR

MIN

OA

MOCP

PENE

PTAC

RA

RM

REG

RND

RTU

SYS

TEMP

TSTAT

TYP

VEL

MD

DIA

EAT

SD **SMOKE DAMPER**

BDD **BACK DRAFT DAMPER**

HVAC ABBREVIATIONS

ALL ABBREVIATIONS SHOWN MAY NOT APPEAR IN DRAWINGS.

ABOVE FINISHED FLOOR

BAROMETRIC RELIEF DAMPER

ENTERING AIR TEMPERATURE

MINIMUM CIRCUIT AMPACITY

MAXIMUM OVERCURRENT PROTECTION

PACKAGED TERMINAL AIR CONDITIONER

AIR HANDLING UNIT

BACK DRAFT DAMPER

ROOM EXHAUST FAN

GAS RADIANT HEATER

MOTORIZED DAMPER

GAS UNIT HEATER

AUXILIARY

CEILING

DIAMETER

EQUIPMENT

FURNACE

GAUGE

HOUR

MAXIMUM

FIRE DAMPER

HEAT PUMP

MECHANICAL

MINIMUM

MANUFACTURER

OUTSIDE AIR

PENETRATION

RETURN AIR

ROOFTOP UNIT

TEMPERATURE

VENTILATION FAN

THERMOSTAT

ROOM

REGISTER

ROUND

SYSTEM

TYPICAL

VELOCITY

WITH

NOT IN CONTRACT

CONDENSATE

FIRE DAMPER - VERTICAL

		AIR TERMIN	AL DEVICE SCHEDU	LE		
MARK	DESRIPTION	MFGR	MODEL	MATERIAL	NECK	NOTES
CDA	DIFFUSER, LAY-IN, LOUVERED FACE	TITUS	TDC-AA	ALUM.	ROUND	1,2,3
CGA	CLG RETURN AIR GRILLE - GRID CLG	TITUS	50FF	ALUM	ROUND	1,2,3
CGB	CLG RETURN AIR GRILLE - GYP CLG	TITUS	55FL	ALUM.	RECTANGULAR	1,2,3
CGC	CLG SUPPLY REGISTER	TITUS	112RL	ALUM	RECTANGULAR	1,2,3
WGA	WALL SUPPLY GRILLE	TITUS	300FL	ALUM	RECTANGULAR	1,2,3
WGB	WALL RETURN GRILLE	TITUS	55FL	ALUM	RECTANGULAR	1,2,3
WLA	OUTDOOR AIR LOUVER	RUSKIN	ELF811DD	ALUM.	RECTANGULAR	1,2,4,5,6

- . BASIS OF DESIGN 2. FINISH SHALL BE VERIFIED W/ARCHITECT
- 5. PROVIDE W/ MFR'S PLASTER FRAME OF SAME MATERIAL.
- . FRAME DEPTH TO COORDINATE WITH EXTERIOR WALL. 5. FURNISHED WITH INSECT SCREEN.
- 6. STATIONARY EXTRUDED ALUMINUM DOUBLE—DRAINABLE 4" DEEP FRAME WITH BIRD SCREEN
- 7. COORDINATE INSTALLATION AND WATERPROOFING WITH GEN. CONTRACTOR.

			F.A	AN PERFORMA	ANCE DATA				
TAG	SERVICE	CFM	SONES	E	LECTRICAL DATA	A	BASIS OF	DESIGN	NOTES
				POWER	E.S.P.	VOLTAGE	MFGR	MODEL	
EF-2	EMPLOYEE BATH 124	90	0.6	17	0.25	120/1	GREENHECK	SP-A110	ALL
EF-3	JAN 125	45	0.6	14	0.25	120/1	GREENHECK	SP-A90	ALL

- 2. VIBRATION ISOLATION KIT

	FAN SPEED CONTROL
5.	INTERLOCK WITH LIGHTING
6.	ALUMINUM CEILING GRILL

AHU-2 VENTILATION	Floor		Required	Required	Corrected	Required
CALCULATIONS	Area	Maximum	Outdoor Air	Outdoor Air	Outdoor Air	Exhaust Air
Zone Name / Space Name	(ft²)	Occupants	(CFM/person)	(CFM/ft^2)	(CFM)	(CFM)
111 OFFICE	130	1	5	0.06	16	-
112 OFFICE	130	1	5	0.06	16	-
113 ON CALL	82	1	5	0.06	12	-
115 REHAB 2	242	1	5	0.06	24	-
116 REHAB 1	208	1	5	0.06	22	-
120 ISO	33	0	5	0.06	3	-
121 STORAGE	26	0	0	0.12	4	-
122 TRIAGE	154	2	5	0.06	24	-
123 REHAB 3	92	1	5	0.06	13	-
127 STORAGE	26	0	0	0.12	4	-
Totals					138	_

AHU-3 VENTILATION	Floor		Required	Required	Corrected	Required
CALCULATIONS	Area	Maximum	Outdoor Air	Outdoor Air	Outdoor Air	Exhaust Air
Zone Name / Space Name	(ft²)	Occupants	(CFM/person)	(CFM/ft²)	(CFM)	(CFM)
117 STORAGE	124	0	0	0.12	15	-
118 KITCHEN	161	2	7.5	0.12	34	-
124 EMPLOYEE BATH	68	0	0	0	-	90
125 JANITOR	15	0	0	0.12	2	8
126 STORAGE	21	0	0	0.12	3	-
128 TREAT/SURGERY	170	1	5	0.06	15	-
129 XRAY	82	1	5	0.06	10	-
130 LAUNDRY	70	0	0	0	-	-
119 CORRIDOR	367	0	0	0.06	22	-
Totals					101	98


TAG	SERVICE	CFM	SONES	E	ELECTRICAL DATA BA		BASIS OF	DESIGN	NOTES
				POWER	E.S.P.	VOLTAGE	MFGR	MODEL	
EF-2	EMPLOYEE BATH 124	90	0.6	17	0.25	120/1	GREENHECK	SP-A110	ALL
EF-3	JAN 125	45	0.6	14	0.25	120/1	GREENHECK	SP-A90	ALL


EQUIPMENT NOTES:


- MFGR SPECIED IS "BASIS OF DESIGN" OR EQUAL. CONTRACTOR SHALL SUBMIT MFGR, MODEL AND PERFORMANCE DATA.
- 1. INTEGRAL DISCONNECT
- 3. INTEGRAL BACKDRAFT KIT

CALCULATIONS	Area	iviaximum	Outdoor Air	Outdoor Air	Outdoor Air	Exnaust Air
Zone Name / Space Name	(ft²)	Occupants	(CFM/person)	(CFM/ft^2)	(CFM)	(CFM)
111 OFFICE	130	1	5	0.06	16	-
112 OFFICE	130	1	5	0.06	16	-
113 ON CALL	82	1	5	0.06	12	-
115 REHAB 2	242	1	5	0.06	24	-
116 REHAB 1	208	1	5	0.06	22	-
120 ISO	33	0	5	0.06	3	-
121 STORAGE	26	0	0	0.12	4	-
122 TRIAGE	154	2	5	0.06	24	-
123 REHAB 3	92	1	5	0.06	13	-
127 STORAGE	26	0	0	0.12	4	-



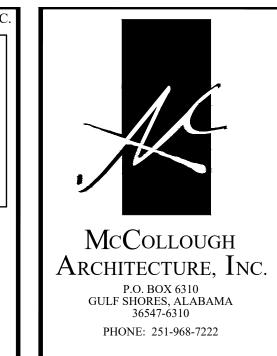

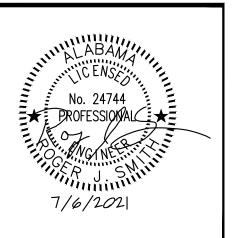

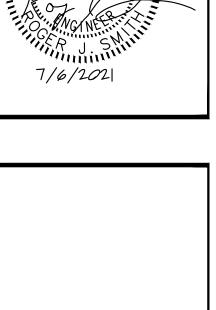

PHASE 2 DRAWINGS FOR ORANGE BEACH ORANGE BEACH ORANGE BEACH

JOB NO.:
DRAWN: RJS
CHECKED: RJS
DATE: 2021.07.06
REVISION:

AS SHOWN

SCALE:
SHEET NO.:

M1.1

HVAC PLAN
FIRST FLOOR

1 HVAC PLAN- FIRST FLOOR
SCALE: 3/16" = 1'-0"

HP-3

EXH WALL CAP

LAUNDRY
| 130 | CDA4 | 8"ø | 125 | \frac{1}{25} | \

EMPLOY BATH [124] EF-2

6"ø 42

INTERN
[113]

CDA4
6"\$
50

SEE SHEET M1.2 FOR DUCT INSTALLATION

5"ø EXH

REHAB 3 123

> CGA 8"ø 144

CGA ± 6"ø 50 %

CGC4 6"ø 50

CDA4 8"ø 150

> CGA _____ 8"ø 135

CGA 6"ø STOR. 67 [126]

CGB 8"ø _ 137_-

CDA4 8"ø 150

CDA2 6"ø 100

CDA2 6"ø 50

CGA

REHAB 1

CGA 8"ø 152

CGA 8"ø

KITCHEN 118 CONDENSATE DRYWELL

8"ø _ 170 _

ISO 120

CDA4 8"ø 165

CDA2-6"ø 50

CGA - 8"ø __ 148 |

CGC1 6"ø

TRIAGE

122 CGC4
6"ø
100

CGA 8"ø 159

FREEZER

CDA4

₹8"ø F


160

CDA4

REF COOLER





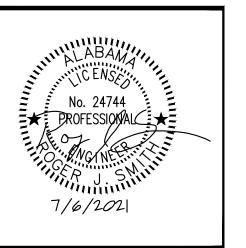

PHASE 2 DRAWINGS FOR ORANGE BEACH WILDLIFE CENTER


JOB NO.:
DRAWN:
CHECKED:
RJS
DATE:
2021.07.06
REVISION:

SCALE: SHEET NO.:


M1.2

HVAC PLAN
SECOND FLOOR

AS SHOWN

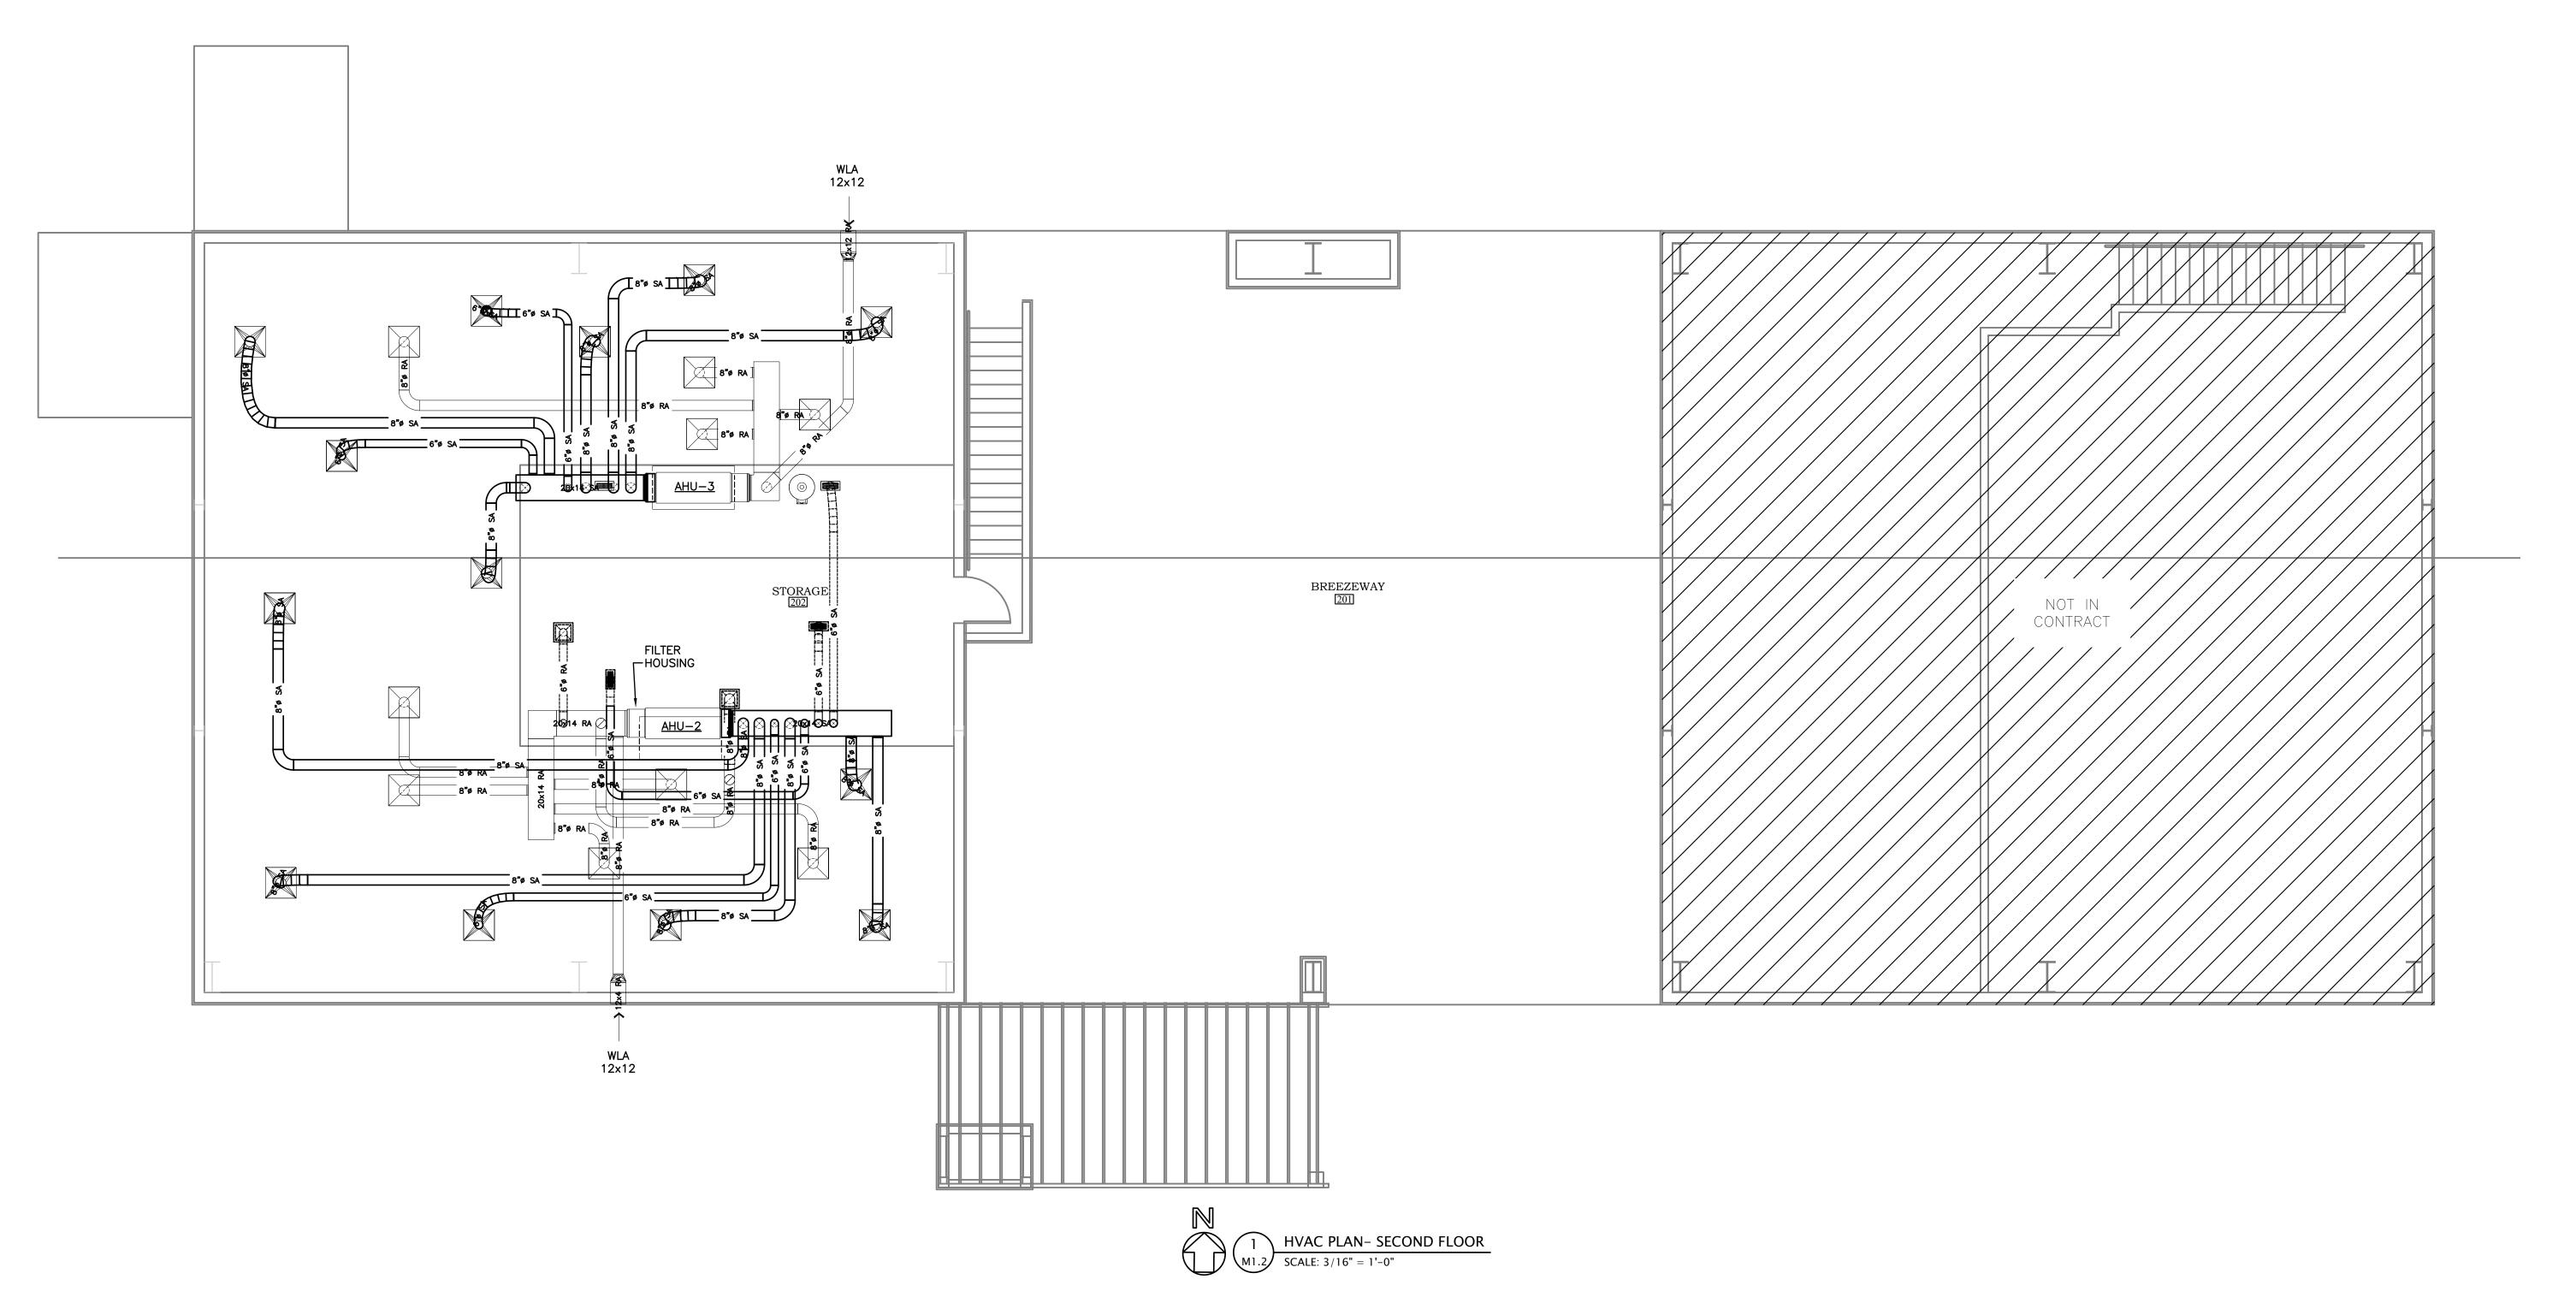



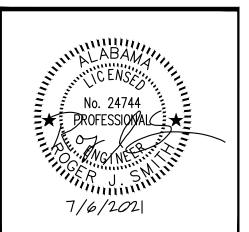

PHASE 2 DRAWINGS FOR ORANGE BEACH WILDLIFE CENTER

JOB NO.:
DRAWN: RJS
CHECKED: RJS
DATE: 2021.07.06
REVISION:

SCALE:
SHEET NO.:

SHEET NO..

M2.0

HVAC DETAILS

AS SHOWN

6 AHU DRAIN TRAP DETAIL

M2.0 SCALE: NONE



wstewart@stewartengineering.net

McCollough ${f A}$ rchitecture, ${f I}$ nc. P.O. BOX 6310 GULF SHORES, ALABAMA 36547-6310



PHONE: 251-968-7222

(H) 田

JOB NO. DRAWN: GWS CHECKED: GWS 2021.04.22 DATE: **REVISION:**

SCALE: AS SHOWN

SHEET NO.:

ELECTRICAL NOTES

AND LEGEND

ALL ABBREVIATIONS SHOWN MAY NOT APPEAR IN DRAWINGS. ALL ABBREVIATIONS SHOWN MAY NOT APPEAR IN DRAWINGS. ALL SYMBOLS SHOWN MAY NOT APPEAR IN DRAWINGS. FIRE ALARM MANUAL PULL STATION, 3'-10" AFF MAXIMUM MAIN CIRCUIT BREAKER FIXTURE STRIP, OVERHEAD / WALL MOUNTED. AMPERE MOTOR CONTROL CENTER 1000 CIRCULAR MILS FIRE ALARM STROBE / HORN-STROBE, 7'-6" AFF FIXTURE STRIP, OVERHEAD / WALL MOUNTED, EMERGENCY. ALTERNATING CURRENT MECH MECHANICAL AIR CONDITIONING MANHOLE \square/\square FIXTURE, 2X2, 1X4, 2X4. FIRE ALARM STROBE / HORN-STROBE. CEILING MOUNTED. ABOVE FINISH CEILING MINIMUM ABOVE FINISH FLOOR MISCELLANEOUS FIRE ALARM SMOKE DETECTOR, CEILING MOUNTED. FIXTURE, 2X2, 1X4, 2X4. W/ BATTERY BACKUP. MAIN LUGS ONLY ABOVE FINISH GRADE AMPERE INTERRUPTING CAPACITY MANUFACTURER ALUMINUM MOUNTED FIRE ALARM DUCT-MOUNTED SMOKE DETECTOR W/ SAMPLING TUBE. EMERGENCY BATTERY PACK FIXTURE, WALL / CEILING MOUNTED. APPROXIMATE(L) MOUNTING ARCHITECT(URAL MANUAL TRANSFER SWITCH FIRE ALARM REMOTE TEST STATION, 3'-10" AFF $\phi/\emptyset/Q$ FIXTURE, SURFACE MTD. / RECESSED / WALL MOUNTED. NEUTRAL NOT APPLICABLE AUTOMATIC TRANSFER SWITCH NORMALLY CLOSED AMERICAN WIRE GAGE FIRE ALARM HEAT DETECTOR. CEILING MOUNTED. ♦/﴿ FIXTURE, SURFACE MTD. / RECESSED / WALL MOUNTED. W/ BATTERY BACKUP. NATIONAL ELECTRICAL CODE NATIONAL ELECTRICAL MANUFACTURER'S ASSO. BACKBOARD FIRE ALARM AUXILIARY RELAY. ₩ / M EXIT SIGN, CEILING/WALL MOUNTED W/BATTERY. PROVIDE ARROWS AS INDICATED NFPA N.I.C. NATIONAL FIRE PROTECTION ASSOCIATION NOT IN CONTRACT BUILDING CONDUIT MONITOR MODULE FOR AUXILIARY CONTROL NIGHT LIGHT SINGLE POLE TOGGLE SWITCH, 120/277V, 20A. 3'-10" AFF NORMALLY OPEN NO. OR # NUMBFR THREE-WAY TOGGLE SWITCH/FOUR-WAY TOGGLE SWITCH, 120/277V, 20A. 3'-10" AFF FIRE ALARM FIRE SPRINKLER SYSTEM VALVE TAMPER SWITCH CONTROL OUTSIDE DIAMETER CURRENT TRANSFORMER CABLE TELEVISION MOTOR RATED SWITCH, VERIFY REQUIREMENT AND # OF POLES W/ EQUIPMENT POWER FACTOR FIRE ALARM FIRE SPRINKLER SYSTEM FLOW SWITCH COLD WATER PIPE PAD MOUNTED SWITCH FIRE ALARM CONTROL PANEL. SINGLE POLE, THREE POSITION MOMENTARY CONTACT, 120/277 V, 20A. 3'-10" AFF PAD_MOUNTED TRANSFORMER DIRECT BURIAL DIRECT CURRENT FIRE ALARM REMOTE PANEL DIMMER SWITCH. 120/277V, FLUOR/INC AND AMPERAGE AS REQUIRED. 3'-10" AFF DUAL ELEMENT TIME DELAY PROVIDE FURNISH AND INSTALL TELEPHONE/DATA OUTLET AND COVER PLATE. 18" AFF WITH 3/4" C. AAC/UNO POTENTIAL TRANSFORMER KEYED SWITCH. 120/277V, AMPERAGE AS REQUIRED. 3'-10" AFF DISCONNECT SWITCH POLYVINYL CHLORIDE PART WINDING WALL MOUNTED TELEPHONE, MOUNT 60" AFF/UNO LOW VOLTAGE SWITCH. 3'-10" AFF GARBAGE DISPOSAL REFERENCE COMBINATION DATA/TELEPHONE OUTLET AND COVER PLATE. 18" ACC WITH - DOUBLE THROW RATED LOAD AMPERES OCCUPANCY SENSOR, 3'-10" AFF WALL/CEILING MTD. 3/4"C TO ACC/UNO JISHWASHER RIGID NONMETALLIC CONDUIT DATA OUTLET AND COVER PLATE, MOUNTED ON COLUMN OR POWER POLE, ELECTRICAL RANGE OCCUPANCY SENSOR, 3'-10" AFF DUAL RELAY FOR LIGHTING/EXHAUST FAN REFERIGERATOR RAIN TIGHT FLOOR BOX, ROUND WITH DUPLEX RECEPTACLE, TELEPHONE AND DATA OUTLET. OCCUPANCY SENSOR, RELAY/POWER PACK, CONCEALED, ACCESSIBLE. LECTRICAL METALLIC TUBING SCCR SHORT CIRCUIT CURRENT RATING FLOOR BOX COVER SHALL BE BRASS WITH HINGED COVERS FOR DEVICES. XPLOSION PROOF SCHEDULE EQUIPMENT SOFT DRAWN ("2D"= DUAL DATA OUTLET, "4D"= QUAD DATA OUTLET) XISTING, REMOVE. SERVICE ENTRANCE ELECTRIC WATER COOLER SECONDARY PANEL, LIGHTING OR POWER AS SPECIFIED IN PANEL SCHEDULE. CATV OUTLET SINGLE GANG BOX WITH 3/4" C TO AAF. VERIFY HEIGHT EXISTING, REPLACE WITH NEW INTERNATIONAL SYSTEM OF UNITS AUDIO SYSTEM SPEAKER. FURNISHED AND INSTALLED BY OTHERS. SINGLE LINE DIAGRAM FUSED DISCONNECT SPECIFY AMP/POLE FIRE ALARM SURFACE METALLIC RACEWAY AUDIO VOLUME CONTROL. SINGLE GANG EMPTY OUTLET INSTALLED AT FINISHED SOLID NEUTRAL NON-FUSED DISCONNECT SPECIFY AMP/POLE 46" AFF WITH 3/4"C TO AAF WITH DATA BUSHING. **SPECIFICATIONS** FULL LOAD AMPERES SINGLE POLE — DOUBLE THROW SINGLE POLE — SINGLE THROW MOTOR STARTER. NUMBER NEXT TO SYMBOL INDICATES SIZE, SEE SPECIFICATIONS FOR DESCRIPTION SECURITY CAMERA. PROVIDE ROUGH-IN OUTLET ONLY WITH 3/4"C TO SERVER ROOM FLEXIBLE METAL CONDUIT WHEN SHOWN WITHIN BOUNDARY OF EQUIPMENT PROVIDED AS PART OF THE EQUIPMENT. IN DESIGNATED AREA ALLOCATED FOR CAMERA HEADEND EQUIPMENT. STATIC TRANSFER SWITCH GAI VANIZED GROUND FAULT INTERRUPTER SWITCH BOARD COMBINATION NONFUSIBLE DISCONNECT SWITCH/MAGNETIC MOTOR STARTER IN NEMA 1 ENCLOSURE, GALVANIZED RIGID METAL CONDUIT SWITCHGEAR NUMBER NEXT TO SYMBOL INDICATES SIZE, SEE SPECIFICATIONS FOR DESCRIPTION GROUND FERMINAL BACKBOARD **ELECTRICAL DESIGNATIONS** HEAVY DUTY TELEPHONE EXHAUST FAN FURNISHED AND INSTALLED BY HVAC. REFER TO HANDHOLE TEMPERATURE MECHANICAL DWG'S FOR EXACT LOCATION AND ELECTRICAL REQUIREMENTS. HORSEPOWER TRANSIENT VOLTAGE SURGE SUPPRESSORS FIXTURE NOTE HIGH VOLTAGE TYPE 'A' FIXTURE (SEE FIXTURE SCHEDULE). CIRCUIT NO. 2 (TYP) SINGLE RECEPTACLE 120/277V, AMPERAGE AS REQUIRED. 1'-6" AFF HEATING/VENTILATION/AIR COND. UNDERWRITER'S LABORATORY HERTZ (CYCLES PER' SECOND) DUPLEX/QUAD RECEPTACLE OUTLET, 120/277V, 20A. 1'-6" AFF INSIDE DIAMETER VOLTS ALTERNATING CURRENT FIXTURE NOTE TYPE 'A' FIXTURE (SEE FIXTURE SCHEDULE). CIRCUIT NO. 2 (TYP) ISOLATED GROUND VOLTS DIRECT CURRENT INTERMEDIATE METAL CONDUIT VENTILATION ♠ /

B

DUPLEX/QUAD RECEPTACLE OUTLET, 120/277V, 20A. 6" ABOVE COUNTER U.N.O.

Outlier

ABOVE COUNTER U.N.O.

DUPLEX/QUAD RECEPTACLE OUTLET, 120/277V, 20A. 6" ABOVE COUNTER U.N.O.

DUPLEX/QUAD RECEPTACLE OUTLET, 120/277V, 20A. 6" ABOVE COUNTER U.N.O.

DUPLEX/QUAD RECEPTACLE OUTLET, 120/27V, 20A. 6" ABOVE COUNTER U.N.O.

DUPLEX/QUAD RECEPTACLE OUTLET, 120/27V, 20A. 6" ABOVE COUNTER U.N.O.

DUPLEX/QUAD REC JUNCTION BOX RECPT NOTE WALL OUTLET WITH RECEPTACLE NOTED, CONNECT TO CIRCUIT NO. 2 (TYP) ↑ ★ DUPLEX/QUAD RECEPTACLE OUTLET, ISOLATED GROUND, 120/277V, 20A. 1'-6" KILO ČIRCULAR MILS **WEATHERPROOF** WATERTIGHT HOMERUN (TYP) TO PANEL 'PPA'. CONNECT TO CIRCUIT NO.'S "5. 6. & 7" KILO VOLT - AMPERES HOME RUN ● / 🗹 / 🕮 RECEPTACLE, FLOOR / CEILING FLUSH MOUNTED. 120/277V, 20A. PPA-5.6.7 EX: 3#12 (PH), 1#12 (N) & 1#12 GND LIQUIDTIGHT FLEXIBLE CONDUIT INCHES TWO GANG FLOOR BOX WITH ONE RECEPT AND PROVISION FOR DUAL COMM CABLE HOME RUN (ALTERNATE) HOMERUN USING 2#8, EX: 3#12 (PH), 1#12 (N) & 1#12 GND WIREMOLD RFB2 MULTI-SERVICE RECESSED FLOOR BOX WITH BRASS COVERPLATE. LOW VOLTAGE FURNISH WITH ALL APPURTENANCES FOR COMPLETE SYS LESS COMM CABLING. PHASE--Ⅲ WIRE DESIGNATION TIC INDICATES NUMBER OF CONDUCTORS, 2-POLE SINGLE RECEPTACLE 240V, AMPERAGE AS REQUIRED. EX: 3#12 (PH), 1#12 (N) & 1#12 GND TVSS RECEPTACLE DUPLEX RECEPTACLE, 120V, 20A. EQUAL TO PASS & SEYMOUR #5362WSP NOTES: SPECIAL PURPOSE RECEPTACLE OUTLET, NEMA CONFIGURATION TO MATCH PLUG. 1. "NL" DESIGNATION REQUIRES FIXTURE TO BE CONFIGURED FOR ONE LAMP ("GF"=GROUND FAULT PROTECTED, "WP"= (WR & GF TYPE) WEATHER PROOF & GFI PROTECTED) OPERATIONAL AT ALL TIMES. USE GF RATED BREAKER WHERE DEVICE IS NOT READILY ACCESSIBLE PER NEC 2. ALL CIRCUITS SHALL CONTAIN A GREEN EQUIPMENT GROUNDING CONDUCTOR. 3. EQUIPMENT GROUND CONDUCTOR SHALL BE AS FOLLOWS UNLESS OTHERWISE INDICATED: ABOVE GROUND CONDUIT #12 AWG CIRCUIT - #12 GND #10 AWG CIRCUIT - #10 GND ---- UNDERGROUND CONDUIT # 8 AWG CIRCUIT - #10 GND COMMUNICATIONS, TELEPHONE / COMPUTER BACKBOARD. 4. UNLESS OTHERWISE INDICATED, CONDUIT SIZE SHALL BE 3/4" MIN. AND SHALL NOT EXCEED A FILL OF 40% MAXIMUM, SEE NEC. HVAC CONTROLS, 54" AFF U.N.O. WITH 3/4"C TO ACCESSIBLE CEILING. TSTAT WIRING BY HVAC # OF CIRCUIT CONDUCTORS — LIGHTING CONTACTOR. ELECTRICALLY HELD, 4-POLE MINIMUM WITH HOA SWITCH. COORDINATE ACTUAL NUMBER OF POLES WITH NUMBER OF EXTERIOR LIGHTING CIRCUITS. COIL VOLTAGE SHALL MATCH PHOTOCELL OUTPUT

AUXILIARY LEGEND

SIZE OF CIRCUIT CONDUCTORS "AWG"———

—— SIZE OF GROUNDING CONDUCTOR "AWG"

ELECTRICAL ABBREVIATIONS

POWER & LIGHTING LEGEND

ELECTRICAL NOTES


- THE ELECTRICAL CONTRACTOR IS RESPONSIBLE FOR OBTAINING AND PAYING ALL REQUIRED PERMITS AND INSPECTION CERTIFICATES.
- ALL WORK SHALL COMPLY WITH IBC 2018, NEC 2017, STATE AND LOCAL CODES WHERE APPLICABLE. VERIFY WITH AUTHORITY HAVING JURISDICTION AND COMPLY AS REQUIRED.
- OMISSIONS OR MISDESCRIPTION OF DETAILS OF WORK WHICH ARE EVIDENTLY NECESSARY TO CARRY OUT THE INTENT OF THE DRAWINGS, OR WHICH ARE CUSTOMARILY PERFORMED, SHALL NOT RELIEVE THE CONTRACTOR FROM PERFORMING SUCH OMISSIONS AND DETAILS OF WORK, BUT THEY SHALL BE PERFORMED AS IF FULLY AND CORRECTLY SET FORTH &
- EQUIPMENT, MATERIALS, AND INSTALLATION SHALL BE GUARANTEED FOR A PERIOD OF ONE (1) YEAR FROM DATE OF ACCEPTANCE. DEFECTS WHICH APPEAR DURING THIS PERIOD SHALL BE CORRECTED AT THE EXPENSE OF THE ELECTRICAL
- MATERIALS AND ALL COMPONENTS THEREOF SHALL BE NEW AND SHALL BE UL APPROVED WHERE A STANDARD HAS BEEN ESTABLISHED. COMPONENTS SHALL BE EQUAL TO THOSE SCHEDULED ON DRAWINGS.
- ALL RACEWAY EXPOSED ON THE EXTERIOR SHALL BE RIGID GALVANIZED STEEL "RGS" OR "IMC". EMT SHALL NOT BE ACCEPTABLE. COORDINATE WITH ARCHITECT IF FINISH PAINTING SHALL BE REQUIRED.
- 7. VERIFY FIELD DIMENSIONS. COORDINATE WORK WITH OTHER TRADES TO AVOID INTERFERENCES.
- 8. ALL EXIT AND EMERGENCY LIGHTS SHALL BE UNSWITCHED AND SHALL BE SERVED FROM THE SAME CIRCUIT AS THE GENERAL LIGHTING IN THE SAME AREA U.N.O.
- 9. ALL ELECTRICAL PANELS SHALL HAVE ENGRAVED LAMINATED (BLACK ON WHITE) LABELS IDENTIFYING THEM AS INDICATED
- 10. ENSURE THAT ALL PENETRATIONS OF FIRE WALLS AND DECKS ARE PROPERLY SEALED PER IBC, ANY APPLICABLE UL ASSEMBLIES, AND THE SPECIFICATIONS.
- 11. COLOR OF WIRING DEVICES AND PLATES SHALL BE AS SELECTED BY THE ARCHITECT.

NOT REDUCE WIRE SIZES SHOWN WITHOUT CONSENT OF ENGINEER.

- 12. COORDINATE LAYOUT CAREFULLY WITH SYSTEMS FURNITURE AND MILLWORK SHOP DRAWINGS PRIOR TO ROUGHING IN POWER AND COMMUNICATIONS OUTLETS TO ENSURE PROPER ORIENTATION OF OUTLETS WITH COMPONENTS OF THESE
- 13. AVOID PENETRATING THE OUTER SKIN OF METAL BUILDING WALLS AND ROOF. MOUNT EQUIPMENT ON STRUCTURAL COLUMNS AND PURLINS WHERE POSSIBLE. PROVIDE MOUNTING STRUT BETWEEN STRUCTURAL MEMBERS WHERE NECESSARY. FOR ANY UNAVOIDABLE ROOF PENETRATION, ENSURE THAT METAL BUILDING MANUFACTURER'S ROOF WARRANTY
- REQUIREMENTS ARE SATISFIED. 14. CONDUCTOR SIZES INDICATED ON THE DRAWINGS HAVE BEEN SELECTED TO PROVIDE FOR ACCEPTABLE VOLTAGE DROP. DO
- 15. CONDUCTORS SHALL BE SINGLE CONDUCTOR COPPER, STRANDED FOR AWG #8 AND LARGER AND SOLID FOR AWG #10 AND SMALLER, WITH 600 VOLT THHN INSULATION.
- 16. ALL CONDUCTORS SHALL BE INSTALLED IN METALLIC CONDUIT. PVC SCHEDULE 40, MAY BE INSTALLED BELOW GRADE WITH TRANSITIONS TO PVC SCH 80 IF CONCEALED WALL OR "RGS" IF EXPOSED ABOVE GRADE.
- 17. THE USE OF MC CABLE IS PERMISSIBLE ONLY IN CONCEALED LOCATIONS AND FOR FLEXIBLE CONNECTIONS TO LIGHTING
- 18. THE LOCATION OF OUTLETS AND EQUIPMENT SHOWN ON THE DRAWINGS ARE APPROXIMATE AND THE OWNER SHALL HAVE THE RIGHT TO RELOCATE ANY OUTLETS OR FIXTURES BEFORE THEY ARE INSTALLED WITHOUT ANY ADDITIONAL COST.
- 19. TELECOM OUTLETS WHERE INSTALLED ADJACENT TO RECEPTACLE OUTLETS. SHALL HAVE UNIFORM SPACING BETWEEN RESPECTIVE DEVICES. E.C. SHALL UTILIZE MOUNTING PROVISIONS BETWEEN STUDS, IF REQUIRED, TO MAINTAIN THIS REQUIREMENT.





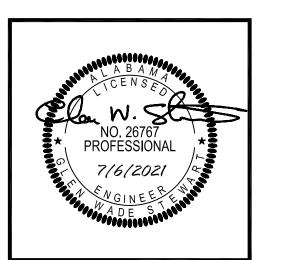

WILDLIFE CENTER

JOB NO.:
DRAWN:
CHECKED:
DATE: 2

CHECKED: GWS

DATE: 2021.04.22

REVISION: 2021.08.10

GWS


REVISION: 20

SCALE: AS SHOWN

SHEET NO.:


E1.1

LIGHTING PLAN
ALTERNATES

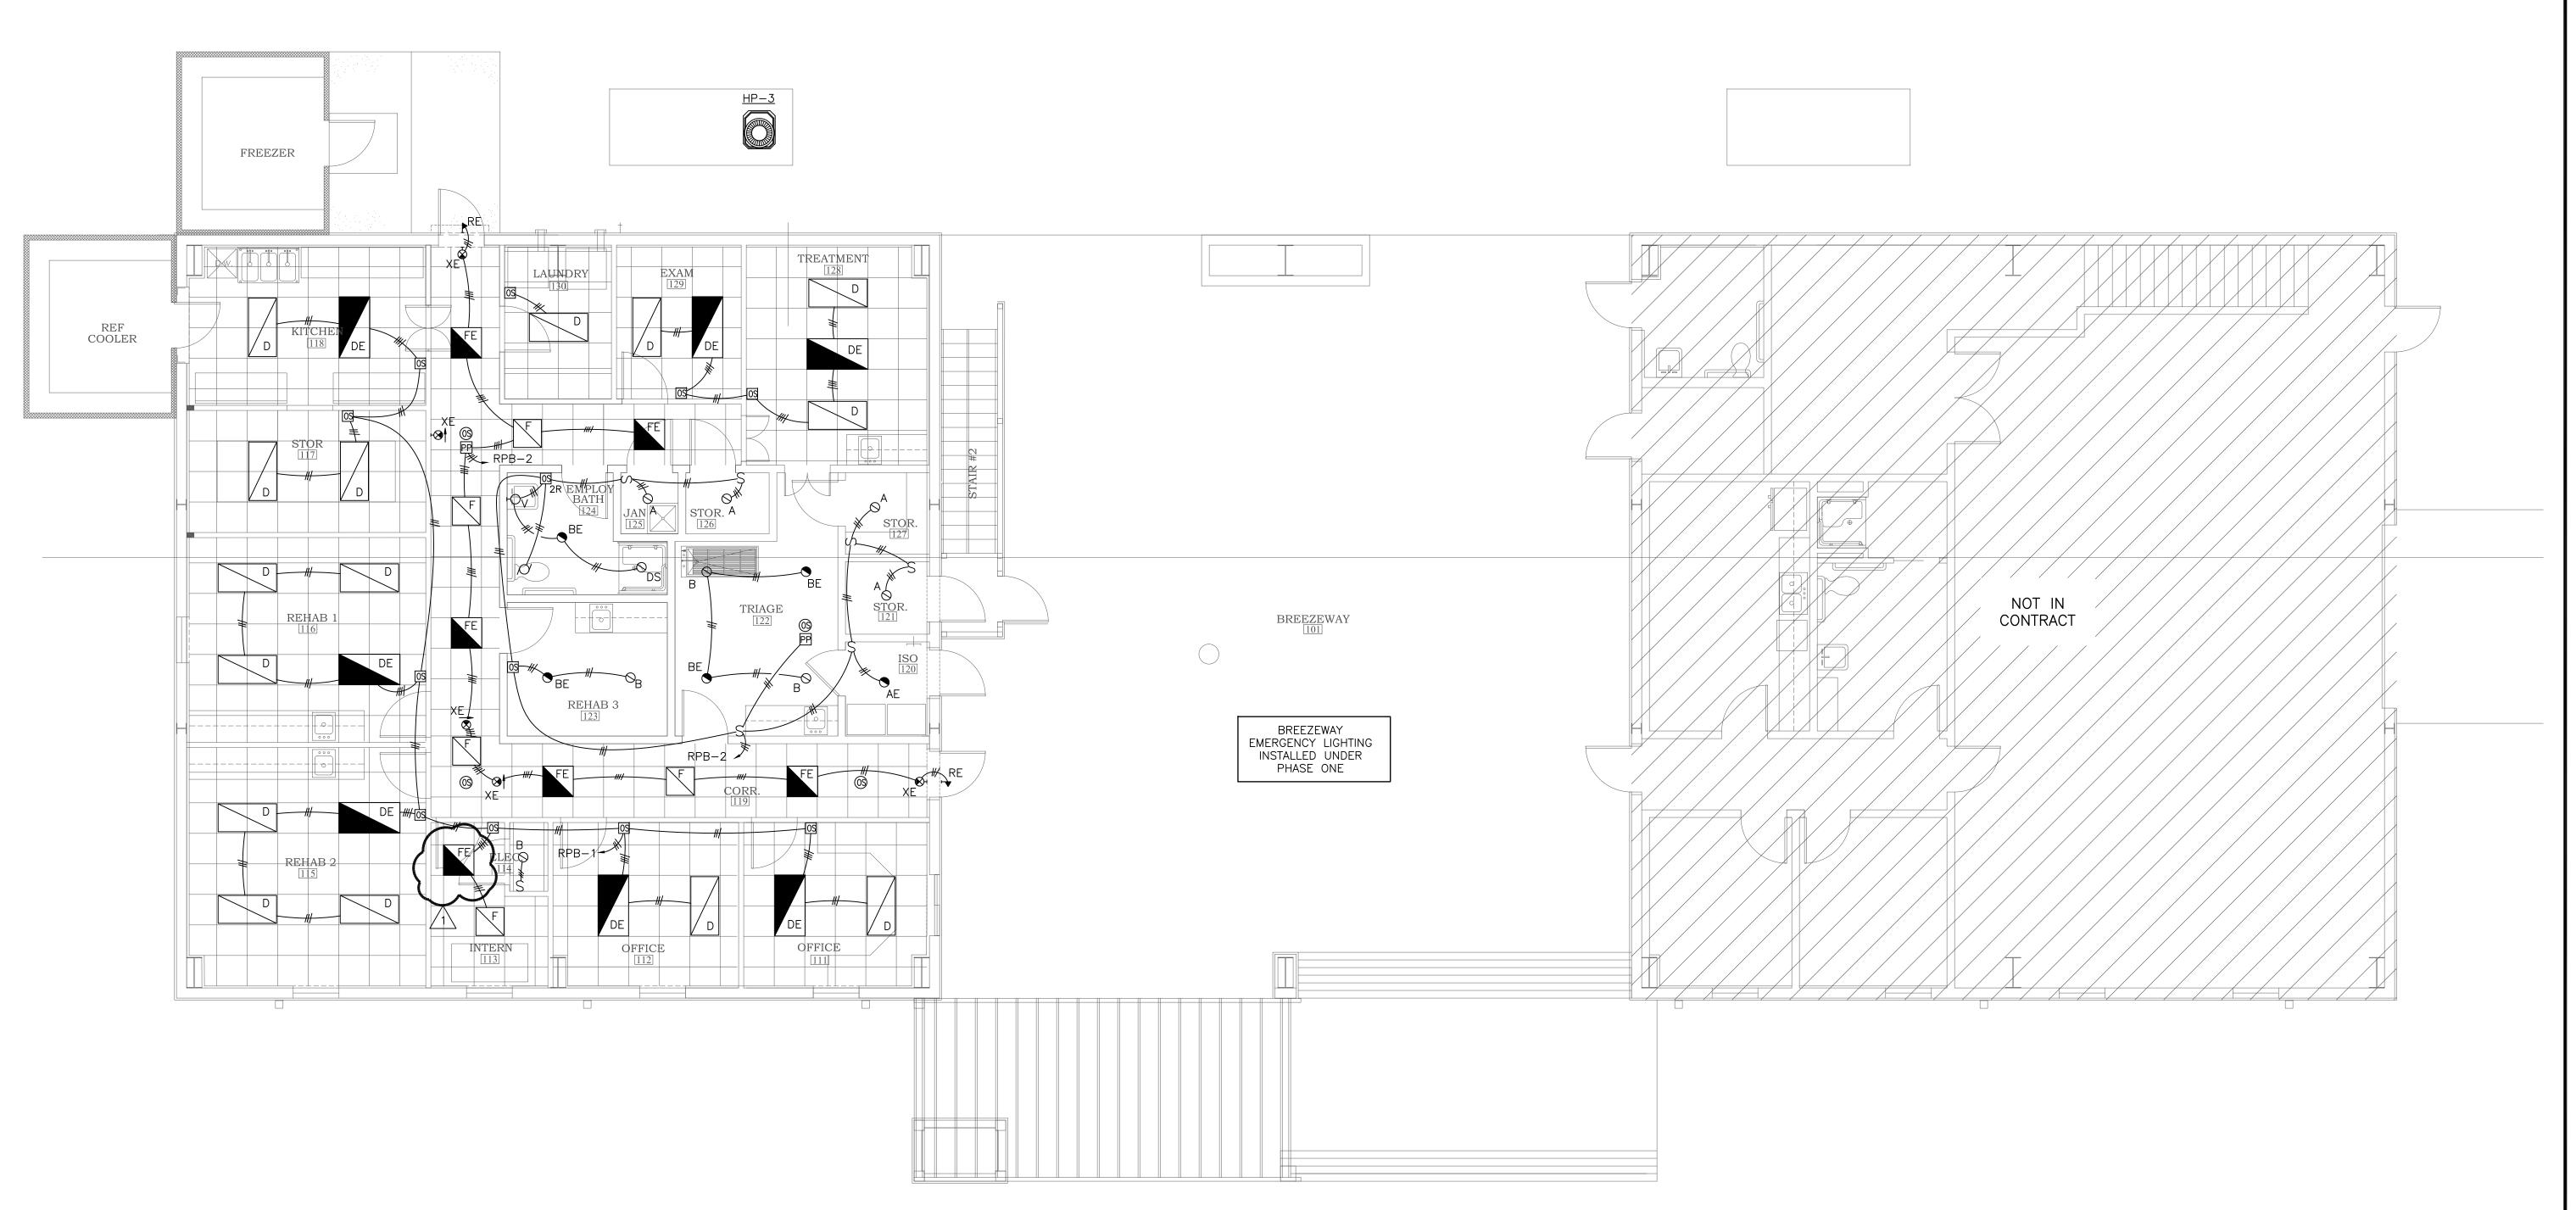





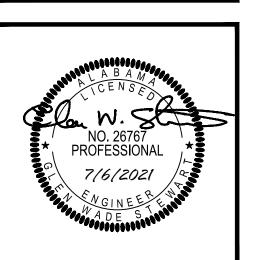

WILDLIFE CENTER
ORANGE BEACH
ALABAMA


JOB NO.:
DRAWN: GWS
CHECKED: GWS
DATE: 2021.04.22
REVISION:


SCALE: AS SHOWN

SHEET NO.:

E1.2


LIGHTING PLAN 2ND FLOOR ALTERNATES

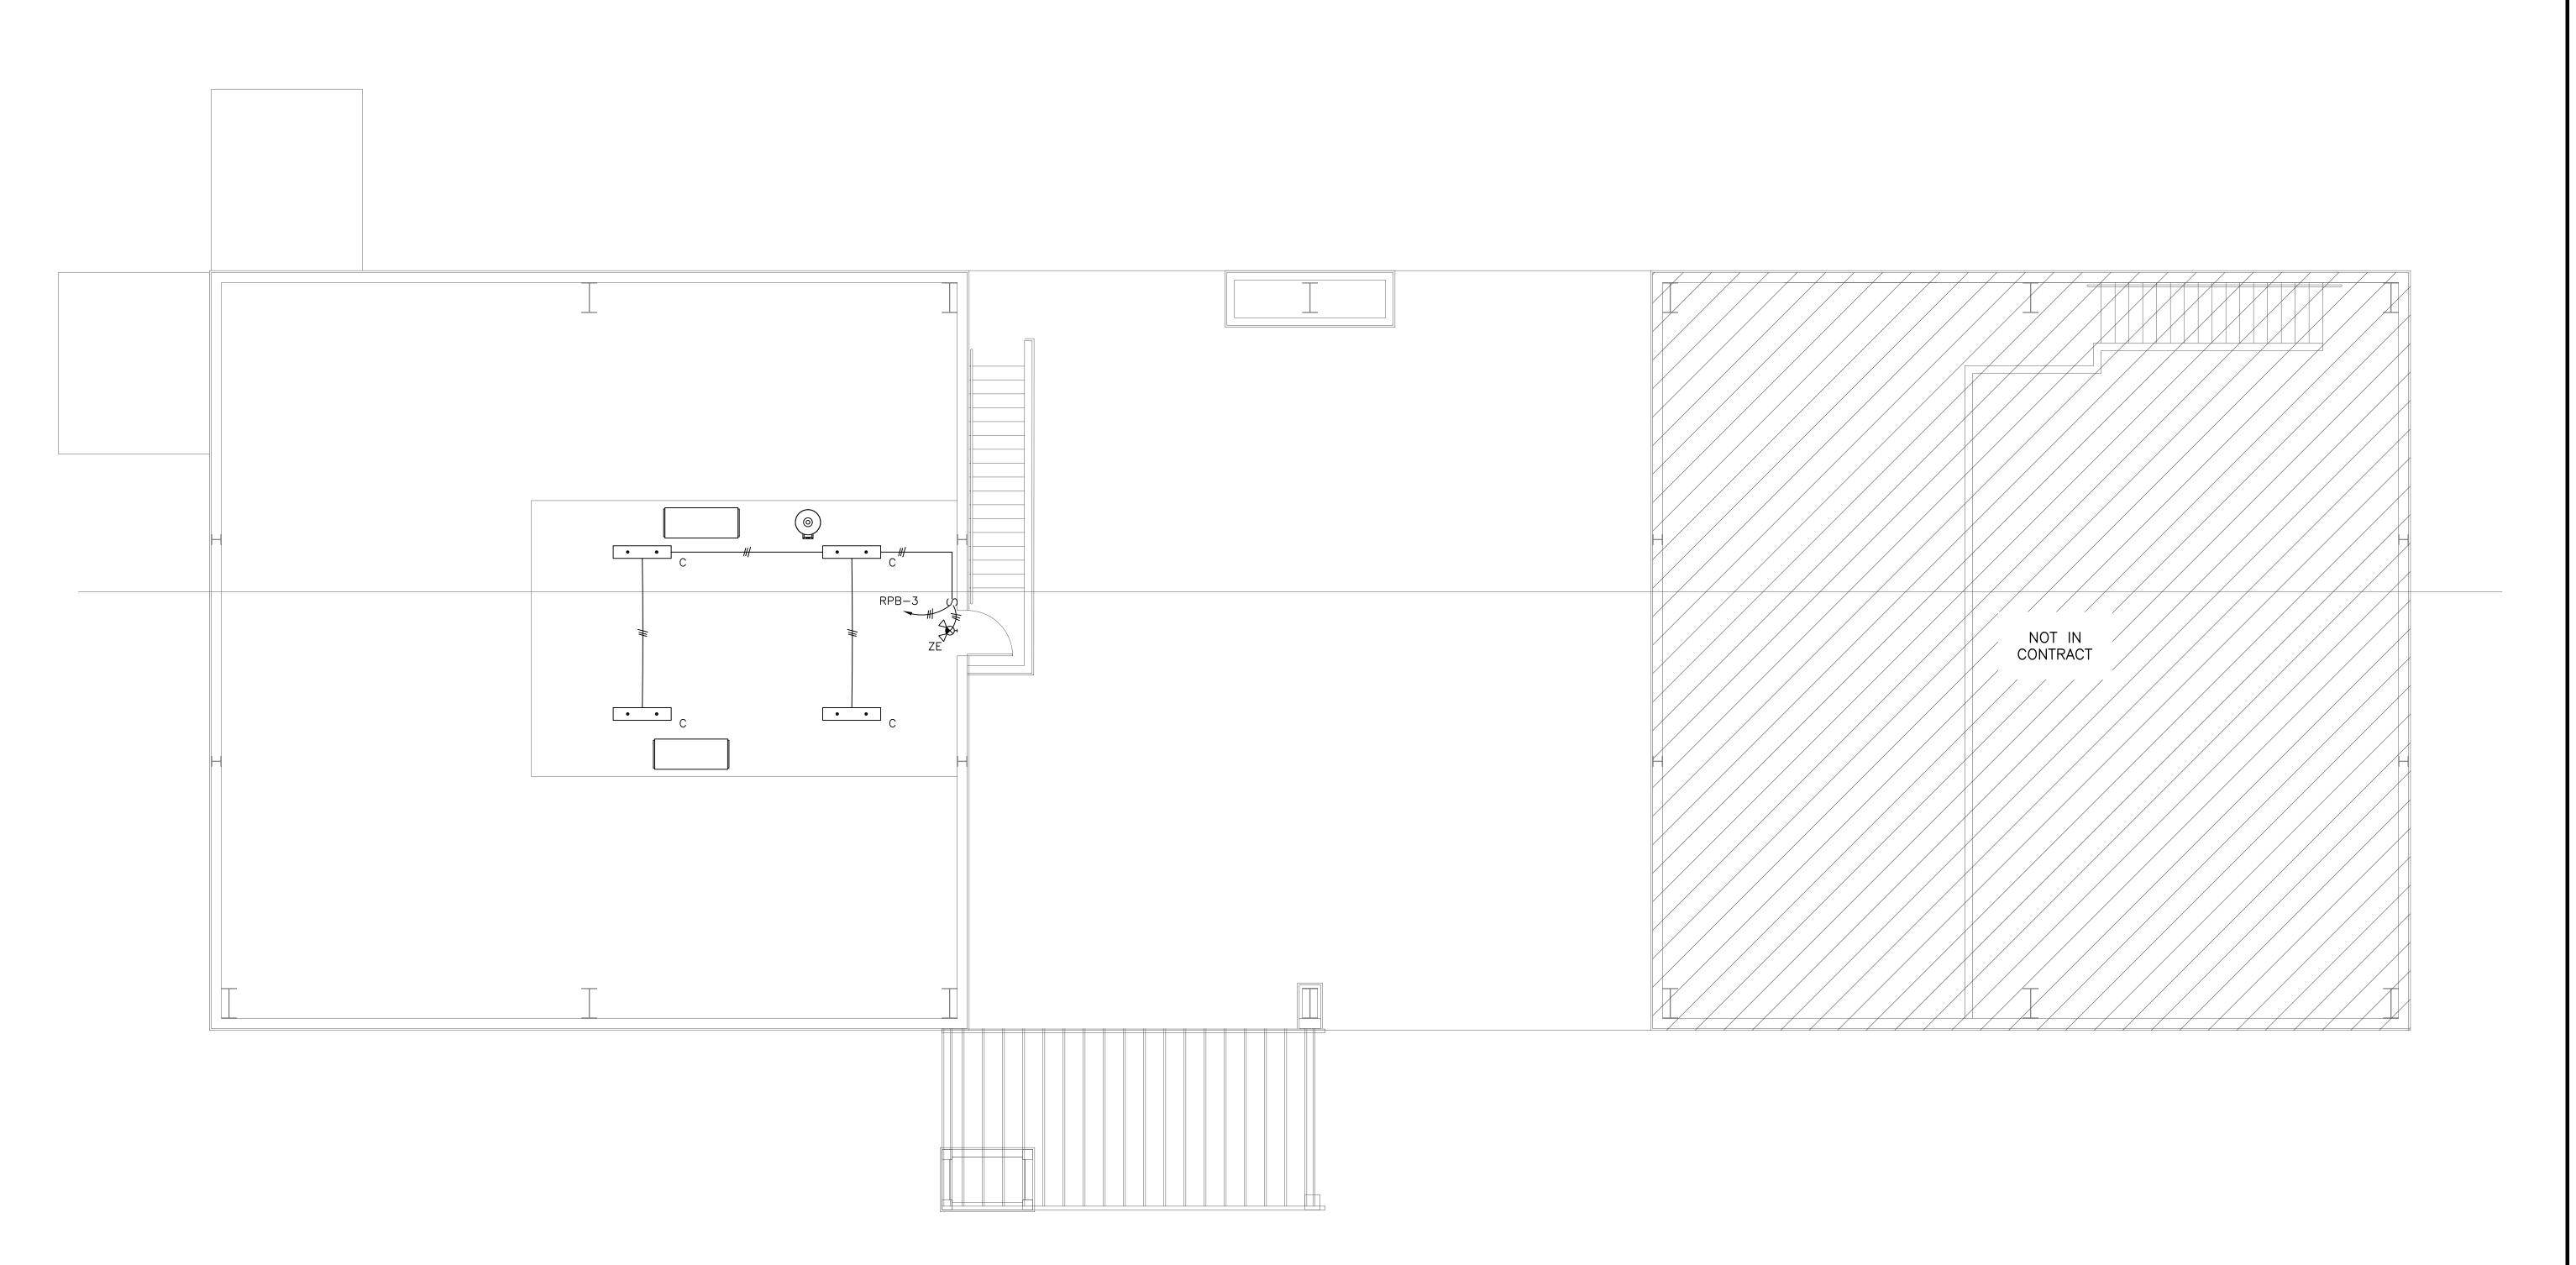

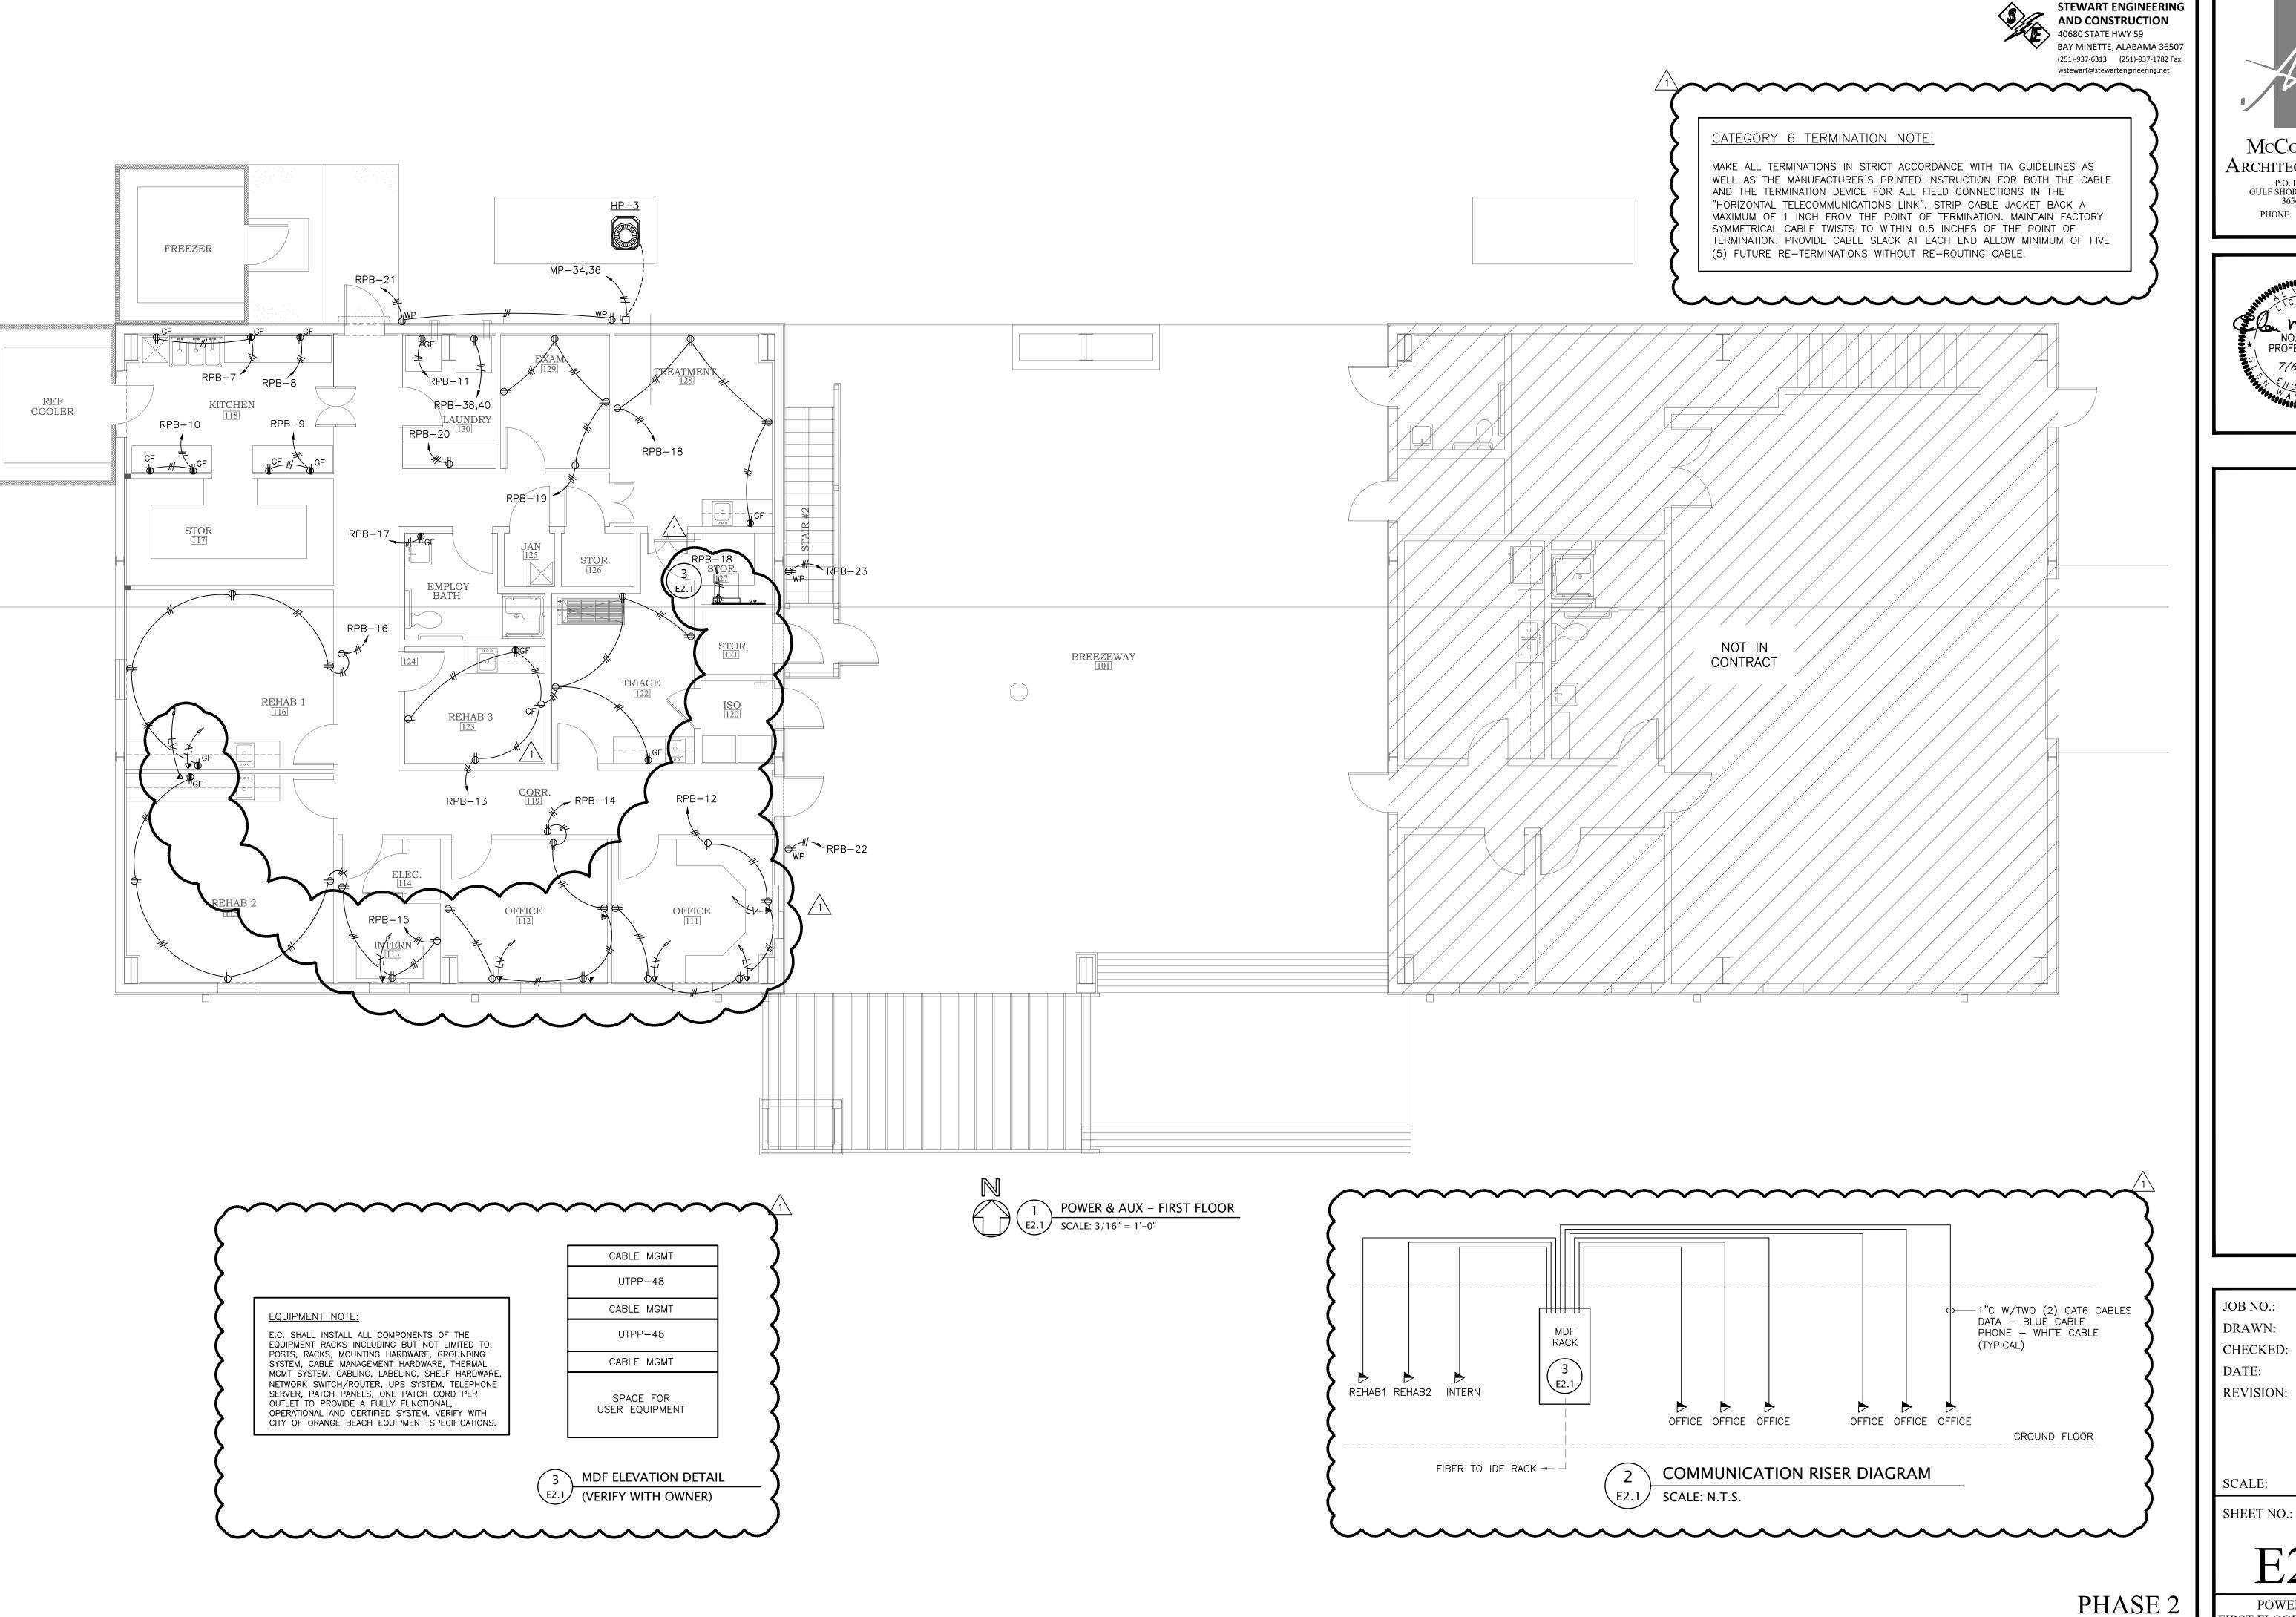

McCollough Architecture, Inc. P.O. BOX 6310 GULF SHORES, ALABAMA 36547-6310 PHONE: 251-968-7222

COPYRIGHT 2020, McCOLLOUGH ARCHITECTURE, INC

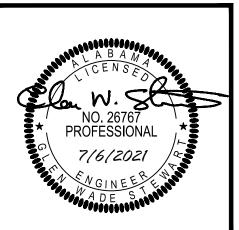


JOB NO.: GWS DRAWN: CHECKED: **GWS** 2021.04.22 2022.01.04 **REVISION:**

AS SHOWN SCALE:

POWER & AUX FIRST FLOOR ALTERNATES





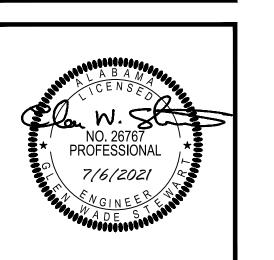

CENTER WILDLIFE ORANGE BALABAN

DRAWN: CHECKED: 2021.04.22


GWS

REVISION:

SCALE: AS SHOWN

SHEET NO.:


POWER PLAN SECOND FLOOR

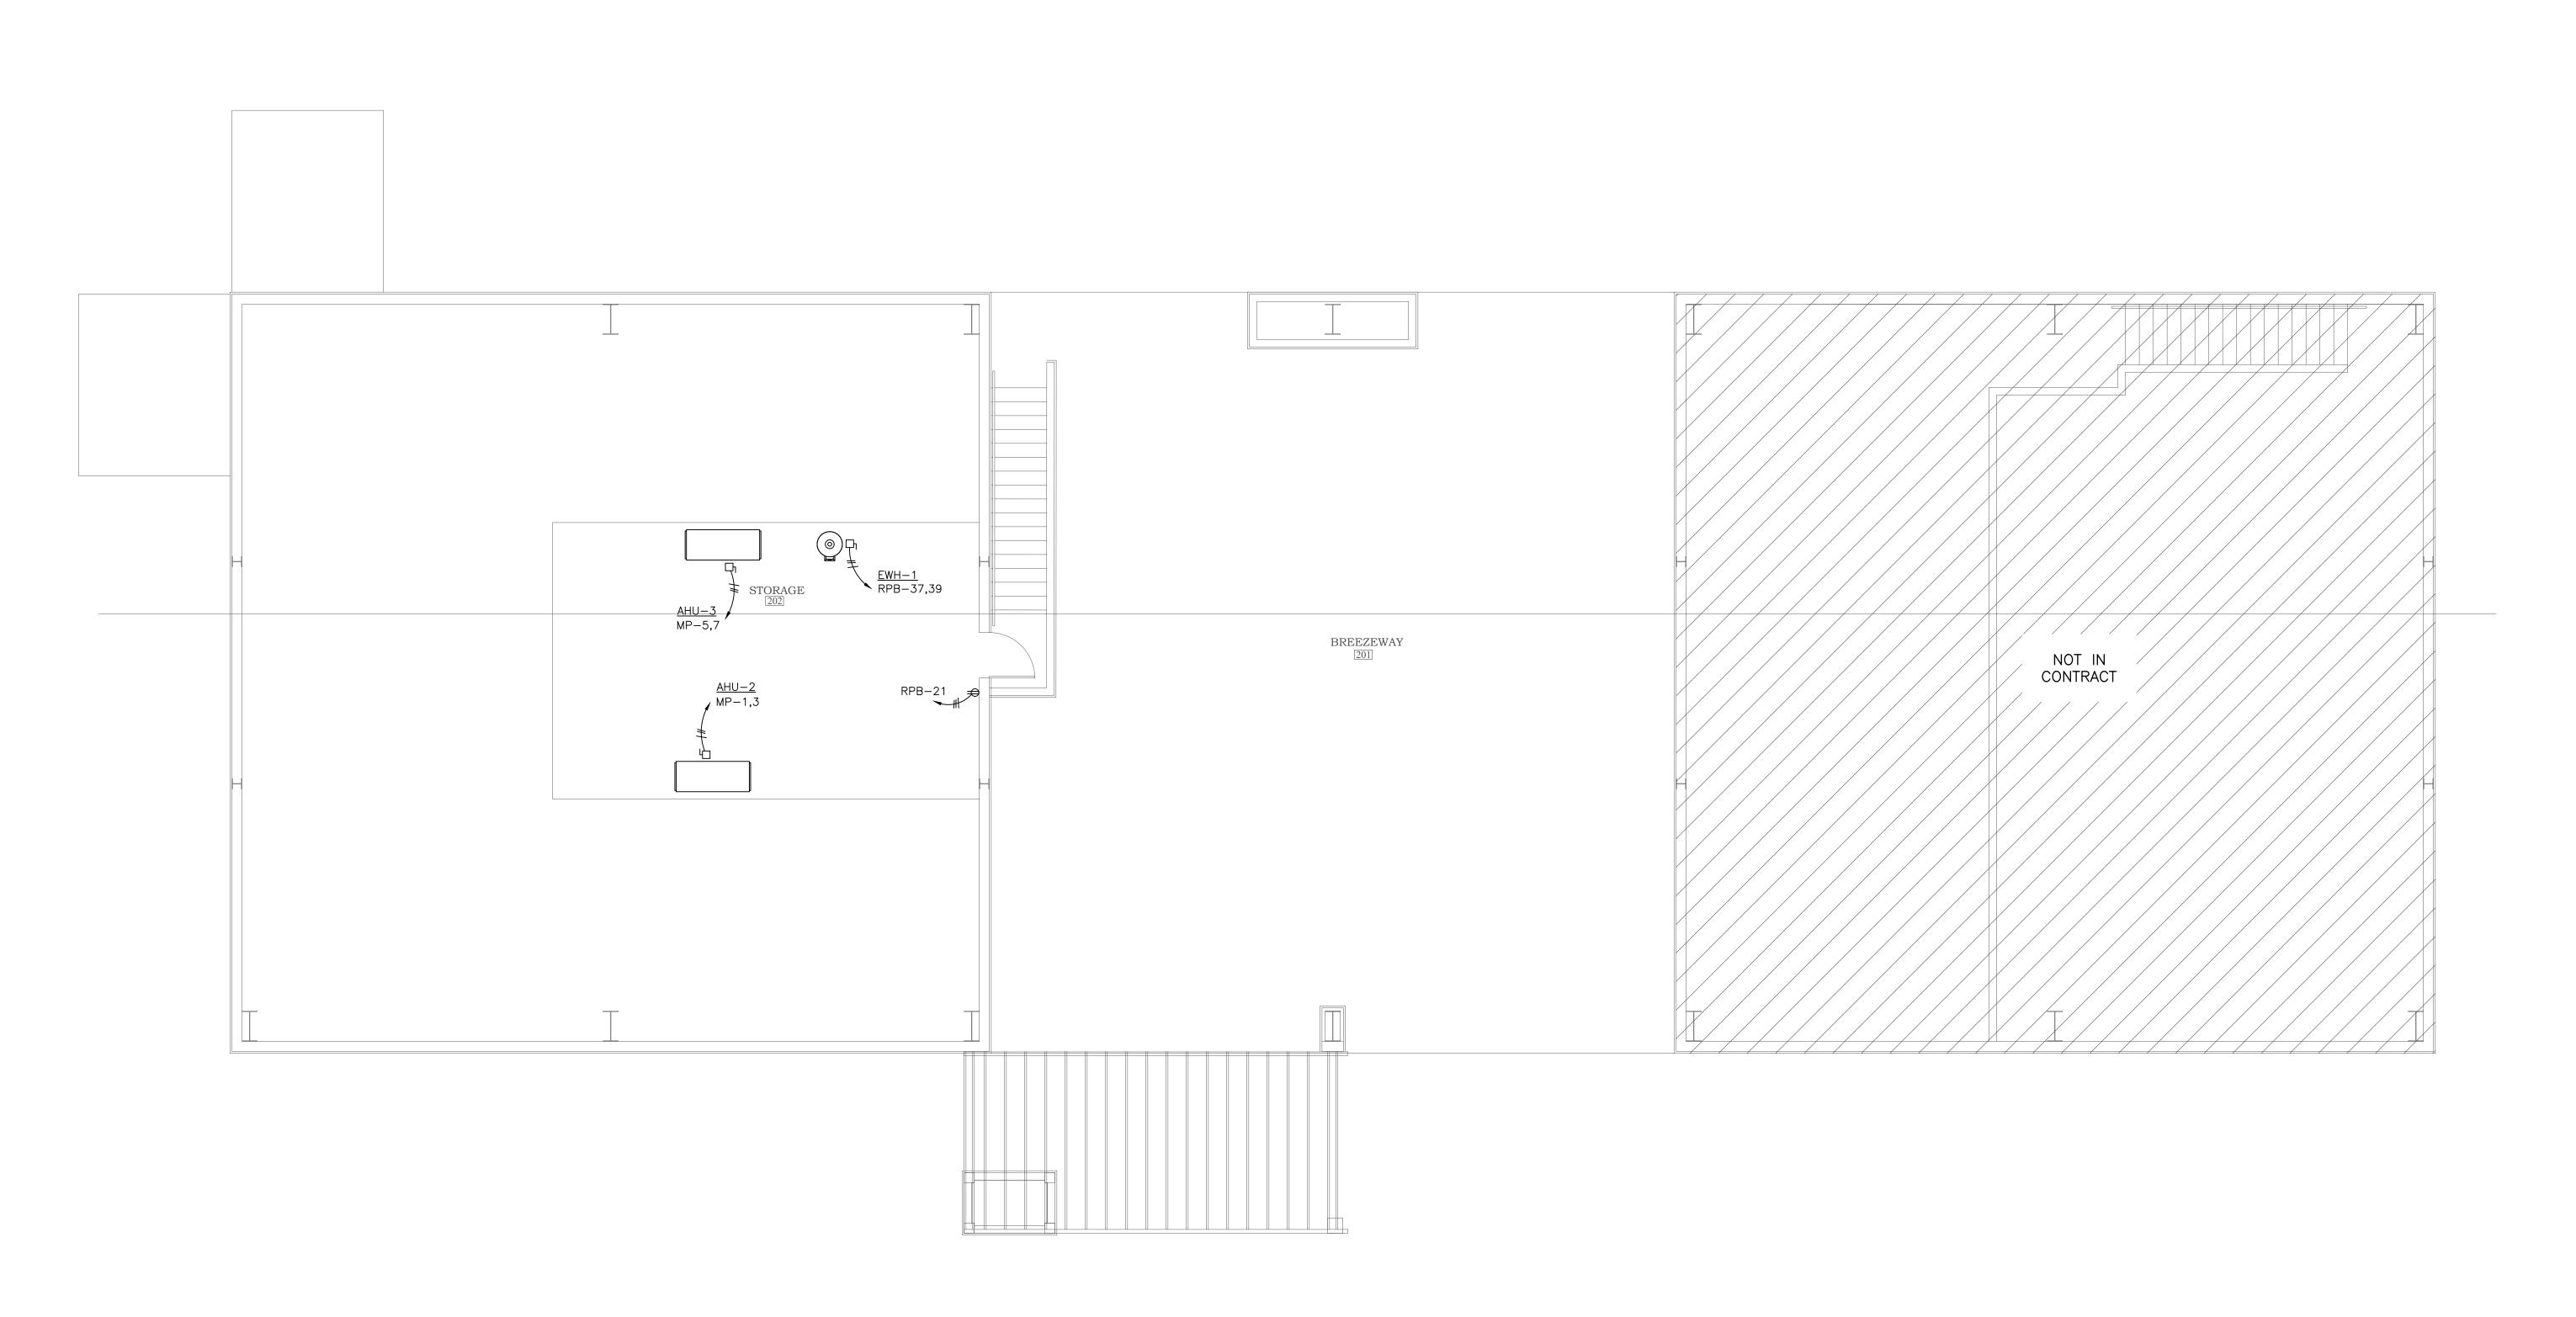






McCollough Architecture, Inc. P.O. BOX 6310 GULF SHORES, ALABAMA 36547-6310 PHONE: 251-968-7222

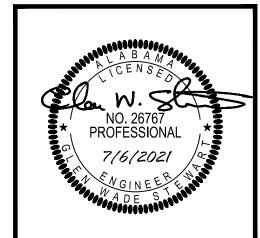

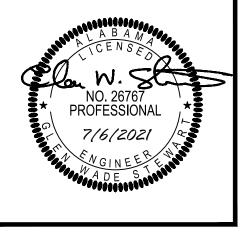



ENTE FE

JOB NO. DRAWN: GWS CHECKED: 2021.04.22 DATE: **REVISION:**


SCALE: AS SHOWN


SHEET NO.:

ELECTRICAL RISER AND DETAILS

CKT BKR	WIRE (AWG)	EQUIP. GND	CONDUIT
15	12	#12	3/4"
20	12	#12	3/4"
30	10	#10	3/4"
40	8	#10	1"
50	6	#10	1"
60	6	#10	1"
70	4	#8	1-1/4"
80	4	#8	1-1/4"
90	3	#8	1-1/4"
100	3	#8	1-1/4"
125	1	#6	1-1/2"
150	#1/0	#6	2"
175	#2/0	#6	2"
200	#3/0	#6	2"
225	#4/0	#4	2-1/2"
250	250KCMIL	#4	3"
400	600KCMIL	#2	4"
ONDUCTORS. ALL HVAC OR (CIRCUIT BREAKERS CONTRACTOR TO OWER LOADS.	OTHER CYCLICAL EQU O PROVIDE QUANTITY) SHALL BE THE SAM JIPMENT SHALL UTILIZE OF CONDUCTORS AS ONDUCTORS MAXIMUM.	E HACR TYPE NECESSARY TO

250	250KCMIL	#4	3
400	600KCMIL	#2	4"
NOTES: 1. NEUTRAL CONDUCTORS. 2. ALL HVAC OR OTHER CONTROLL OR OTHER CONTRACTOR TO POWER LOADS. 4. CONDUIT SIZES BOTH SIZES FOR ALL COMMOUNT SIZES FOR BREAKERS SIZECTION 240.4 (PROTE TO CONTRACTOR SHAWITH EQUIPMENT ME	CTOR (IF REQUIRED) THER CYCLICAL EQUI PROVIDE QUANTITY BASES ON FOUR CO GUIDELINES FOR DI MBINED CIRCUITS. ALL BE COPPER. IN RS. BIZES NOT INDICATED DIECTION OF CONDU	SHALL BE THE SAM PMENT SHALL UTILIZI OF CONDUCTORS AS NDUCTORS MAXIMUM. ERATING AMPACITIES DICATED SIZES ARE D SUCH AS 25A, CO JCTORS.) E REQUIRED NUMBER	E SIZE AS PHASE E HACR TYPE NECESSARY TO CONTRACTOR AND CONDUIT FOR USE WITH MPLY WITH NEC

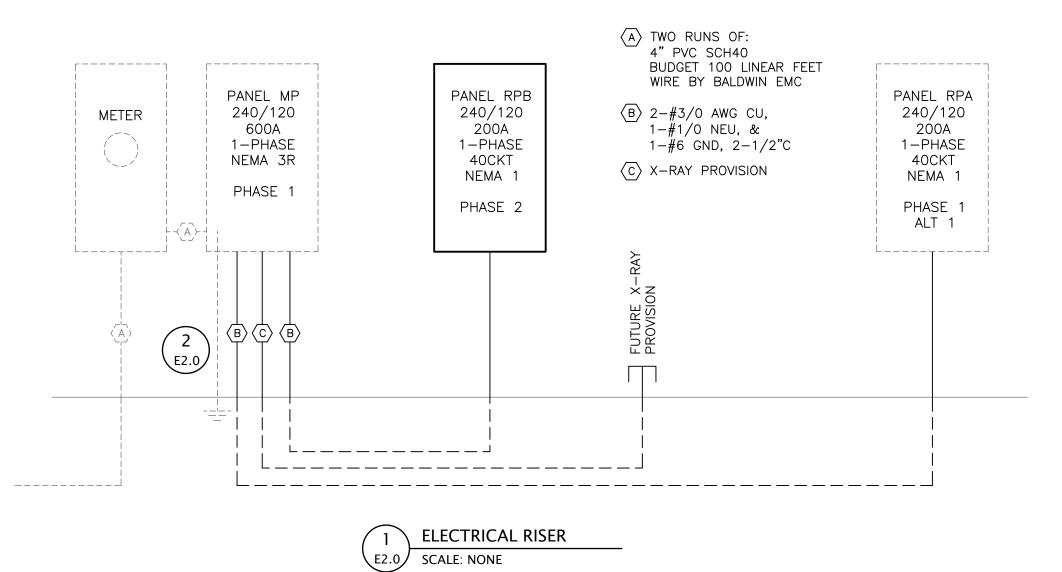

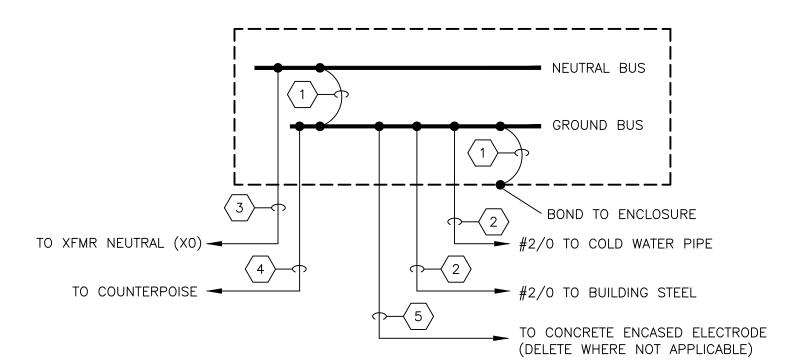

- $\langle 1 \rangle$ #2/0 MAIN BONDING JUMPER
- 2 #2/0 GROUNDING ELECTRODE BONDING JUMPER CONNECTION
- SAME SIZE AS PHASE CONDUCTOR
- SUPPLEMENTAL GROUNDING ELECTRODE BONDING JUMPER SIZED AT #6 AWG (SIZE PER NEC 250.66 IF WATER PIPE AND BLDG. STEEL NOT AVAILABLE)
- SIZE PER NEC 250.66 BUT NO LARGER THAN #4 THHN

	"	
2	MAIN SERVICE GROUNDING	
	SCALE: NONE	

IIV 0.0.	DEVICE (A):	200 A											
KT NO	DESCRIPTION	TRIP AMPS	POLE		PHASE L	OADS (\	VA) B		POLE	TRIP AMPS	DESCRI	PTION	CKT NO
1	LGTS, 111-119	20	1	1117	713		Ь		1	20	LGTS,120-130		2
3	LGTS, MEZZ STOR	20	1	1117	7 10	104	4	0	1		SPARE		4
5	SPARE	20	1	0	0				1		SPARE		6
7	REC, KITCHEN	20	1			115	0 15	500	1		REC, KITCHEN		8
9	REC, KITCHEN	20	1	1500	1500				1		REC, KITCHEN		10
11	WASHER	20	1	, , ,	, 555	400	0 10	000	1		REC, 111		12
13	REC, 122/123	20	1	1600	1200				1		REC, 111/112		14
15	REC, 113/115	20	1			140	0 10	000	1		REC, 116/COOR		16
17	REC, 124	20	1	1500	800				1		REC, 128		18
19	REC, 129	20	1			800	0 2	200	1		REC, 130		20
21	REC, EXT/MEZZ.	20	1	600	200				1		SPARE		22
23	SPARE	20	1			200	0	0	1		SPARE		24
25	SPARE	20	1	0	0				1		SPARE		26
27	SPARE	20	1			0		0	1		SPARE		28
29	SPARE	20	1	0	0				1		SPARE		30
31	SPARE	20	1			0		0	1		SPARE		32
33	SPARE	20	1	0	0				1	20	SPARE		34
35	SPARE	20	1			0		0	1		SPARE		36
37,39	EWH-1	30	2	2250	2000				2	30	DRYER		38,40
37,39	EWH-1	30	2			225	50 20	.000	2	30	DRYER		38,40
				CONNEC	CTED LOAD	PHASE	TOTALS (VA)					
				14	980		12004						
			'			•			•				
				CONNEC	TED DEN	MAND	DEMAND	LOAD			DEMAND LOAD	22.2 KVA	
				LOAD (K		CTOR	(KVA	\)			SPARE CAPACITY	25.8 KVA	
	Receptacles (0 — 10 KVA)			10.0	1.	.00	10.	.0			SPARE CAPACITY	107.5 AMPS	
	Receptacles (Over 10 KVA)			10.6	0	.50	5.3	3			SPARE CAPACITY	54 %	
	Equipment			0.0	1.	.00	0.0	C					
	Heating			4.5	1.	.00	4.5	5					
	Lighting			1.9	1.	.25	2.4	4					
	TOTAL:			27.0		_	22.2	2	•				
	LOAD (AMPS):			112.4			92.5						
	LOAD (AIVII 3).			112.4	•		02.0	,					

PANEL

LOAD (KVA)

0.0

1.5

10.0

25.1

13.0

9.6

29.2

3.5

389.4

PANEL

240 1 ф, 3 W

200 A

200 A

600 A

600 A

TRIP POLE

VOLTAGE (L-N):

VOLTAGE (L-L):

PHASES, WIRES:

CKT NO

MINIMUM BUS CAPACITY (A)

DESCRIPTION

MAIN O.C. DEVICE (A):

1,3 AHU-2

5,7 AHU-3

9,11 SPACE

9,11 SPACE

13,15 SPACE 13,15 SPACE

17,19 SPACE 17,19 SPACE

21,23 SPACE

21,23 SPACE 25,27 AHU-1

25,27 AHU-1 29,31 PANEL RPA

29,31 PANEL RPA 33,35 PANEL RPB 33,35 PANEL RPB 37,39 SPARE 37,39 SPARE

Lighting — Exterior

Motors (Largest)

Cooling and Heating

Receptacles (0 - 10 KVA)

Receptacles (Over 10 KVA)

Motors

Equipment

LOAD (AMPS):

Heating

Lighting

TOTAL:

MINIMUM BUS CAPACITY (A):

VOLTAGE (L-N):

VOLTAGE (L-L):

PHASES, WIRES:

MAIN O.C. DEVICE (A):

MP

44788

FACTOR

1.25

1.00

1.25

1.00

0.50

1.00

1.00

1.00

1.25

DEMAND LOAD

(KVA)

2.1

0.0

1.9

10.0

12.6

13.0

9.6

29.2

4.3

343.9

ENCLOSURE TYPE: NEMA 1

RPB

AIC RATING:

NOTES:

ENCLOSURE TYPE: NEMA 3R

SURFACE

POLE | IKIF |

CKT NO

14,16

14,16

18,20

26,28

26,28

82.5 KVA

61.5 KVA

256.1 AMPS

43 %

DESCRIPTION

DEMAND LOAD

SPARE CAPACITY

SPARE CAPACITY

SPARE CAPACITY

10000

PANELBOARD SCHEDULE AND DETAIL NOTES:

- PANELBOARD & PANELBOARD INSTALLATION SHALL BE IN ACCORDANCE WITH NFPA 70, ART. 384. ALL PANELBOARDS SHALL BE UL LISTED AND INSTALLED IN ACCORDANCE WITH THIS LISTING AND FULLY SUPPORTED BY MEANS DESIGNED FOR THAT LISTED INSTALLATION. ALL CLEARANCES REQUIRED BY CODE SHALL BE MAINTAINED AS MINIMUM.
- 2. EACH PANELBOARD SHALL BE FURNISHED COMPLETE WITH THE PROPERLY SIZED CAN, INTERNAL HARDWARD, DEVICES, COMPONENTS, SUPPORTING STRUCTURES, ETC., FOR A COMPLETE INSTALLATION TO PROVIDE THE DESIGNED PERFORMANCE UNDER THE AMBIENT CONDITIONS ENCOUNTERED. ALL DEVICES, COMPONENTS, FITTINGS, SUPPORTS, ETC., SHALL BE COORDINATED TO PROVIDE A COMPLETE UL LISTED INSTALLATION. ALL DEVICES INSTALLED SHALL HAVE AN INTERRUPTING RATING GREATER THAN OR EQUAL TO THE SPECIFIED SCCR.
- 3. EACH PANELBOARD SHALL BE FURNISHED WITH A GROUND BAR BONDED TO THE PANEL ENCLOSURE. THIS GROUND BUS SHALL BE UTILIZED TO BOND ALL GROUNDING PROVISIONS IN ORDER TO ESTABLISH EQUAL POTENTIAL TO ALL GROUNDED COMPONENTS OF THE POWER SYSTEM.
- 4. PANELBOARD CANS SHALL BE RIGID AND CONTAIN KNOCKOUT PROVISIONS TO FACILITATE THE TERMINATION OF THE NUMBER AND SIZE OF CONDUIT SYSTEMS REQUIRED.
- 5. THE TERMINATION POINT OF THE FEEDER SERVING EACH ASSEMBLY SHALL BE AT THE NEAREST POINT OF FEEDER ENTRY TO MINIMIZE CONDUCTOR FILL IN THE CAN. COORDINATE TOP AND BOTTOM FEED PANELBOARD PROVISIONS WITH EACH FEEDER INSTALLATION.
- PROVIDE THE PROPERLY SIZED CONDUCTOR TERMINATION POINTS OR LUGS (MULTIPLE LUGS WHEN PARALLEL FEEDERS ARE USED) FOR THE NUMBER AND SIZE CIRCUITS INDICATED.
- 7. CONDUCTORS, SPLICES AND TERMINATIONS SHALL BE ACCESSIBLE. ONLY CONDUCTORS RATED AND SIZED FOR THE TEMPERATURE OF THE TERMINATION SHALL BE USED.
- 8. PANELBOARDS SHALL NOT BE INSTALLED IN CONTACT WITH COMBUSTIBLE MATERIALS. ADEQUATE SPACE FOR AIR CIRCULATION AND CODE COMPLIANCE SHALL BE PROVIDED AS A MINIMUM. FURNISH SPACERS, WASHERS, SUPPORTING DEVICES, ETC., AS REQUIRED TO MAINTAIN PROPER CLEARANCES.
- 9. ALL FLUSH MOUNTED PANELBOARDS SHALL BE PROVIDED WITH FOUR (4) 1" EMPLY SPARE CONDUITS TO ABOE THE NEAREST ACCESSIBLE CEILING.

					LI(GHTING FIX	TURE SCHEDULE												
		5, 507					Didlo of Declar					М	OUN	T TYPE	YPE				
		ELECT	RICAL DATA		LAMP DATA		BASIS OF DESIGN			LOC	OITA	١			ARRANGEMENT				
ID	DESCRIPTION	LOAD VA	VOLTAGE	QTY	LUMENS	MANUFACTURER	MODEL OR SERIES	CEILING	FLOOR	GROUND	POLE	ROOF		WALL	PEDESTAL	PENDANT	RECESSED	SURFACE	TRACK
Α	DOWN LIGHT	20	120		1500	LITHONIA	LDN6 40/15 LO6AR LS												
В	DOWN LIGHT	20	120	-	2000	LITHONIA	LDN6 40/20 LO6AR LS												1
BE	DOWN LIGHT	20	120	_	2000	LITHONIA	LDN6 40/20 LO6AR LS ELSD												
С	STRIP	15	120	-	1500	LITHONIA	ZL1N L24 1500LM FST MVOLT 4000K 80 WH												
D	2X4 TROFFER	49	120		5400	LITHONIA	EPANL 2X4 5400 80CRI 40K												
DE	2X4 TROFFER	49	120		5400	LITHONIA	EPANL 2X4 5400 80CRI 40K E10WCP												
F	2X2 TROFFER	31	120		3400	LITHONIA	EPANL 2X2 3400 80CRI 40K												
FE	2X2 TROFFER	31	120		3400	LITHONIA	EPANL 2X2 3400 80CRI 40K E10WCP												
٧	VANITY	20	120	-	_		ALLOWANCE \$150												1
VT	VAPORTIGHT	116	120	-	15000	LITHONIA	VAP 15000LM PCL WD 40K 80CRI												
W	WALL PACK	30	120	-	4000	LITHONIA	ARC2 LED P4 40K MVOLT DDBXD												
RE	REMOTE EGRESS	6	120	-	-	EMERGI-LITE	EF44-2-LED-WP												
YE	EMERGENCY LIGHT	1	120	-	_	EMERGI-LITE	EL-2LED (LITE-2-LG-FINISH-N)												_
ZE	EXIT/EMER. COMBO	1	120	_	_	EMERGI-LITE	ELXN400-G-2LED-R												ī —

PLUMBING ABBREVIATIONS

FLOOR SINK

OT APPEAR IN DRAWINGS VAC EQUIPMENT ABBREVIATIONS.

WATER HAMMER ARRESTOR TYPE "A" (TYP)

	REVIATIONS SHOWN MAY NO O HVAC DRAWINGS FOR HV
AFF	ABOVE FINISHED FLOOR
AUX	AUXILIARY
CEIL	CEILING
CIRC	CIRCULATING
CO	CLEANOUT
CW	COLD WATER
DCW	DOMESTIC COLD WATER
DHC	DOMESTIC HOT CIRCULATE
DHW	DOMESTIC HOT WATER
DIA	DIAMETER
DST	DEEP SEAL TRAP
EQUIP	EQUIPMENT
EWC	ELECTRIC WATER COOLER
EWH	ELECTRIC WATER HEATER
FCO	FLOOR CLEANOUT
FD	FLOOR DRAIN
FIXT	FIXTURE
GWH	GAS WATER HEATER
НВ	HOSE BIBB
HR	HOUR
HW	HOT WATER
HWR	HOT WATER RETURN
MAX	MAXIMUM
MECH	MECHANICAL
	MINIMUM
MTR	METER
	NOT IN CONTRACT
PENE	PENETRATION
RM	ROOM
SAN	SANITARY
SURF	SURFACE
SYS	SYSTEM
T & P	TEMPERATURE & PRESSU
TEMP	TEMPERATURE
TP	TRAP PRIMER
TYP	TYPICAL
VTR	VENT TO ROOF
wco	WALL CLEANOUT
WET	WET PIPNG
WH	WALL HYDRANT

WATER HAMMER ARRESTOR

YARD CLEANOUT

	PLUMBING FIXTURE SCHEDULE (PHASE 2)
ID	DESCRIPTION
CB-1	ICE MAKER WATER CONNECTION. USE SIOUX CHIEF ICE MAKER OUTLET BOX WITH MINIRESTER 696 SERIES WITH 1/2" PEX CONNECTION; MOUNT @ 48" U.N.O. FURNISH FLEXIBLE CONNECTION FROM OUTLET BOX TO WALL MOUNTED WATER FILTER WITH FLEXIBLE CONNECTION TO APPLICANCE. WATER FILTER SHALL BE EQUAL TO WHIRLPOOL WHKF-DWHV OR EQUAL. FURNISH WITH ONE EXTRA FILTER. VERIFY WITH OWNER/CONTRACTOR. APPLIANCES FURNISHED BY OTHERS.
EWC-1	EWC-1, ELECTRIC WATER COOLER, SPLIT LEVEL, WALL MOUNTED WITH BOTTLE FILLER ELKAY LZSTL8WSVRSK OR EQUAL WITH BOTTLE FILLER/FOUNTAIN ON LEFT AT ADA LEVEL; MCGUIRE 8902 TRAP; BRASSCRAFT 1912-A SUPPLY. MOUNT WITH LOWER SPOUT AT 36" AFF. CONNECTIONS: CW 1/2", WASTE 2", VENT 2" MIN.
FD-1	FLOOR DRAIN, J.R. SMITH 2005/2010 SERIES COATED CAST IRON BODY WITH ADJUSTABLE COLLAR, COMBINATION MEMBRANE CLAMP. PROVIDE WITH 6" ROUND, POLISHED NICKEL BRONZE STRAINER AND GREEN DRAIN TRAP SEAL.
HB-1	HOSE BIBB, OUTDOOR TYPE, ZURN Z-1320 WITH CERAMIC DISC, NON-FREEZE, ENCASED, ANTI-SIPHON, AUTO DRAIN, S.S. BOX & HINGED COVER, KEY LOCK, ALL BRONZE INTERIOR PARTS. COVER STAMPED "WATER".
MS-1	MOP BASIN - ZURN Z1996-24 COMPOSITE MOP SINK WITH INTEGRAL 3" DRAIN; Z1996-SF SERVICE FAUCET WITH PALE HOOK, -SDL DRAIN, STRAINER & LINT BASKET, -MH MOP HANGER, -HH HOSE & BRACKET, -BV VINYL BUMPER GUARDS, -WG SS WALL GUARD. COORDINATE WITH GENERAL CONTRACTOR TO INSURE THAT 2" THICK BLOCKING IS PROVIDED IN WALL FOR FAUCET MOUNTING. CONNECTIONS: CW 1/2", HW 1/2" (140°F), WASTE 3", VENT 2" MIN.
SH-1	SHOWER, ARRAY ADA3636, W/ CENTER DRAIN AS DESIGNATED IN PLAN DWGS, SHOWER, SOLID—SURFACE, SMOOTH SHOWER, SOAP HOLDER, GRAB BARS, FOLDING SEAT, ZURN Z7301—SS—MT—DV2P—HW—H7—S8 TEMP—GARD III SHOWER UNIT KIT WITH SINGLE HANDLE PRESSURE BALANCING & MIXING UNIT, 1.5 GPM SHOWER HEAD, FLEX METAL HOSE, INLINE VACUUM BREAKER, WALL CONNECTION, FLANGE AND WALL HOOK FOR HAND SHOWER, PRESSURE BALANCING MIXING VALVE WITH ADJUSTABLE STOP SCREW TO LIMIT HANDLE TURN, 2.5 GPM SHOWER HEAD WITH ARM AND FLANGE. CONNECTIONS: CW 1/2", HW 1/2" TEMPERATURE LIMITING TO 110°F, WASTE 2", VENT 1—1/2" MIN.
SK-1	KITCHEN SINK, ELKAY CR3322, 20 GAUGE, STAINLESS STEEL, DOUBLE BOWL, 7" DEPTH, DROP IN TYPE, FURNISH WITH ELKAY LKD2437BHC GOOSENECK FAUCET WITH LEVER HANDLES AND GRID WASTE. PROVIDE 1-1/2" P-TRAP AT EXISTING SAN CONNECTION, NEW 1/4" FLEXIBLE SUPPLIES AND WATER STOPS. INCLUDE 1/4" FLEXIBLE SUPPLY CONNECTION TO REFRIGERATOR ICE MAKER UNIT. ROUTE TUBING CONCEALED IN BASE CABINET. STRAP TUBING TO REAR OF CABINET. EXISTING CONNECTIONS: CW 1/2", HW 1/2", WASTE 1 1/4". FURNISH WITH TEMPERATURE LIMITING DEVICE SET FOR 110°F
SK-3	3 COMPARTMENT SINK - PROVIDED BY OWNER, INSTALLED BY CONTRACTOR. COORDINATE EXACT REQUIREMENTS PRIOR TO ROUGH-IN.
WC-1H	WC-1H WATER CLOSET, ZURN SERIES Z5660, <u>FLOOR MOUNTED</u> , ELONGATED WATER CLOSET, ZURN Z6000AV-WS1 (1.6 gpf) FLUSH VALVE W/ SPLIT RING PIPE SUPPORT, & ZURN Z5955SS-EL OPEN FRONT SEAT WITHOUT COVER MOUNT FIXTURE AT ADA HEIGHT WITH RIM AT 16-3/4" AFF. CONNECTIONS: CW 1", WASTE 3", VENT 2" MIN.
FS-1	FLOOR SINK, MIFAB FS1520-FLC-3-P, 8" SQUARE, 6" DEEP, CAST IRON, A.R.E. INTERIOR ALUMINUM DOME STRAINER, STAINLESS STEEL TOP W/CLAMPING DEVICE. FURNISH WITH PRO-SET TRAP SEAL. COORDINATE EXACT LOCATION OF DRAIN WITH ARCHITECTURAL PLANS SO AS TO CENTER FLOOR DRAIN CENTER OF TILE. FLOOR SHALL BE SLOPED TOWARD DRAIN.
HS-1	HAND SINK, ELKAY CR1721, 20 GAUGE, STAINLESS STEEL, SINGLE BOWL, DROP IN TYPE, FURNISH WITH ELKAY LK800GN05T4 GOOSENECK FAUCET WITH LEVER HANDLES AND GRID WASTE. PROVIDE 1-1/2" P-TRAP AT EXISTING SAN CONNECTION, NEW 1/4" FLEXIBLE SUPPLIES AND WATER STOPS. CONNECTIONS: CW 1/2", HW 1/2", WASTE 1 1/4". FURNISH WITH TEMPERATURE LIMITING DEVICE SET FOR 110°F
LV-1H	ZURN Z5840 SERIES WITH VITREOUS CHINA CONSTRUCTION AND 4" FAUCET CENTERS; ZURN Z81104—XL FAUCET WITH LEVER HANDLES, ZURN Z8800 SUPPLIES; ZURN Z8700 TRAP; Z8746—PC ADA GRID STRAINER; ZURN Z8946—3—NT ADA PROTECTORS, ASSE 1070 APPROVED TEMPERATURE LIMITING VALVE SET TO 110°F, ZURN Z1231 CONCEALED ARM CARRIER, CONNECTIONS: CW 1/2", HW 1/2", WASTE 1 1/4". MOUNT AT 34" TOP OF RIM FOR ADA REQUIRED MOUNTING HEIGHT.
MV-1	MIXING VALVE, EQUAL TO SYMMONS, 0.5 GPM MINIMUM, 5.5 GPM MAXIMUM @ 10 PSI PRESSURE DROP

							WATER HE	EATER SCH	EDULE				
		ELECT	RIC DATA				HYDRONIC	DATA					
TAG	FLA	МОСР	VOLT PHASE	KW	EWT	LWT	RATE OF RECOVERY	RISE OF RECOVERY	CAPACITY (GAL)	BASIS	OF DESIGN	WEIGHT	NOTES
	AMPS	AMPS	PHASE		DEG.F	DEG.F	GPM	DEG. F	(GAL)	MFGR	MODEL	LBS	
EWH-1	28	30	240/1	4	60	140	0.33	80	40	RHEEM	ELD40	108	ALL

NOTES:

. 3/4" INLET OUTLET CONNECTIONS

2. SUPPLY 140°F WATER TO MOP SINK AND 110°F WATER TO LAVATORIES. LAVATORIES SHALL BE EQUIPPED WITH INDIVIDUAL TEMPERATURE

LIMITING DEVICES THAT CONFORM WITH ASSE 1070.

3. OPERATING PRESSURE BETWEEN 20PSI TO 150 PSI 4. 1/2" INLET OUTLET CONNECTIONS

5. INSTALL HOT WATER CIRC. PUMP RATED FOR 5 GPM, 20 FT HEAD PRESSURE, 120VAC, 1/12 HP, WITH AQUASTAT.

	HOT WATER RECIRCULATION PUMP SCHEDULE												
MARK RCP	CONTROL WITH	CAPACITY (GPM)	TOTAL HEAD (FT)	PUMP CONSTRUCTION	MOTOR (HP)	VOLTS	Hz	PHASE	NOTES				
1	AQUASTAT 5 20 STAINLESS STEEL 1/5 120 60 1 1, 2, 3, 4												
NOTES													
1	COORDINATE ALL	ELECTRICAL REC	UIREMENTS WITH THE	ELECTRICAL CONTRACTOR.									
2	PROVIDE WITH AQUASTAT WITH A TEMPERATURE SETPOINT OF 110F.												
3	PROVIDE WITH 24 HOUR TIME CLOCK. PUMP SHALL OPERATE DURING OCCUPIED HOURS, ELSE IT SHALL BE OFF.												
4	PUMP SHALL BE S	UITABLE FOR PO	TABLE WATER USE.										

COPYRIGHT 2020, McCOLLOUGH ARCHITECTURE, INC.



GENERAL PLUMBING NOTES:

- 1. COMPLY WITH 2018 INTERNATIONAL MECHANICAL & PLUMBING CODE, NFPA, STATE AND LOCAL CODES.
- 2. PLUMBING CONTRACTOR SHALL OBTAIN AND PAY FOR ALL REQUIRED PERMITS AND INSPECTION CERTIFICATES.
- 3. OMISSIONS OR MISDESCRIPTION OF DETAILS OF WORK WHICH ARE EVIDENTLY NECESSARY TO CARRY OUT THE INTENT OF THE DRAWINGS, OR WHICH ARE CUSTOMARILY PERFORMED, SHALL NOT RELIEVE THE CONTRACTOR FROM PERFORMING SUCH OMISSIONS AND DETAILS OF WORK, BUT THEY SHALL BE PERFORMED AS IF FULLY AND CORRECTLY SET FORTH & DESCRIBED.
- PORTIONS OF WALLS AND ARCHITECTURAL FEATURES MAY HAVE BEEN OMITTED FROM THIS PLAN FOR CLARITY OF MECHANICAL FEATURES. REFER TO ARCHITECTURAL DRAWINGS FOR EXACT LOCATION OF FIXTURES, AND DIMENSIONS.
- 5. VERIFY FIELD DIMENSIONS. COORDINATE WORK WITH OTHER TRADES TO AVOID
- 6. LAY OUT PIPING BASICALLY AS SHOWN. MAJOR CHANGES IN LAYOUT MAY BE MADE ONLY WITH WRITTEN CONSENT OF ARCHITECT OR ENGINEER.
- 7. ALL COMPONENTS USED IN PLENUM SPACES MUST BE CONSTRUCTED OF NON-COMBUSTIBLE MATERIAL.
- 8. COLOR OF FIXTURES AND TRIM SHALL BE AS SELECTED BY OWNER/ARCHITECT.
- 9. FIXTURES INDICATED AS BARRIER FREE SHALL COMPLY WITH THE AMERICANS WITH DISABILITIES ACT (ADA).
- 10. PROVIDE ELECTRICAL CONTRACTOR WITH EXACT WIRING REQUIREMENTS. IF ELECTRICAL REQUIREMENTS VARY FROM THOSE INDICATED ON PLANS, PLUMBING CONTRACTOR SHALL BE RESPONSIBLE FOR ANY ASSOCIATED ADDITIONAL COSTS.
- 11. REFER TO SITE PLAN FOR ROUTING OF WATER AND SEWER.
- 12. ENSURE THAT ALL PENETRATIONS OF FIRE WALLS ARE PROPERLY FIRESTOPPED.
- 13. ALL WATER LINES, BOTH HOT AND COLD, SHALL BE AS FOLLOWS: A. LINES BELOW GRADE SHALL BE TYPE "K" SOFT COPPER OR PEX. B. LINES ABOVE GRADE SHALL BE TYPE "L" HARD COPPER. C. FITTINGS SHALL BE OF HARD DRAWN COPPER OF ASTM SPEC B-88. D. ALL JOINTING SHALL BE WITH LEAD-FREE SILVER SOLDER. E. EQUIPPED WITH SHOCK ABSORBERS AS REQUIRED.
- 14. PLUMBING CONTRACTOR SHALL FURNISH & INSTALL SHUT-OFF VALVES TO ALL FIXTURES NOT OTHERWISE EQUIPPED.
- 15. ALL WASTE PIPING SHALL BE SCHEDULE 40 PVC CONFORMING TO ASTM D-1785. PIPING SMALLER THAN 3" SHALL BE LAID OUT AT 1/4" PER FOOT GRADE. PIPING 3" AND LARGER SHALL BE LAID OUT AT 1/8" PER FOOT GRADE. ALL VENT PIPING WITHIN PLENUM OR AIR-HANDLING SPACES SHALL BE COPPER OR CAST IRON.
- 16. ALL FLOOR DRAINS SHALL BE EQUIPPED WITH TRAP PRIMER. LOCATE TRAP PRIMER EQUIPMENT CONCEALED IN ACCESSIBLE LOCATION.
- 17. ALL WATER LINES, BOTH HOT AND COLD, SHALL BE CAPPED AND TESTED AT 180 PSI FOR 24 HOURS. ALL WASTE PIPING SHALL BE TESTED WITH A 10' WATER COLUMN FOR A 2 HR PERIOD WITH NO CHANGE IN LEVEL.
- 18. VENT PIPING SHALL BE LAID OUT SUCH THAT ALL ROOF PENETRATIONS SHALL BE ON BACK SIDE OF ROOF. PAINT EXPOSED VENT PIPING TO MATCH ROOF.
- 19. COORDINATE ROOF PENETRATIONS WITH ROOFING CONTRACTOR. ENSURE THAT
- WARRANTY REQUIREMENTS OF ROOFING MANUFACTURER ARE SATISFIED.
- 20. MATERIALS, EQUIPMENT, AND INSTALLATION SHALL BE GUARANTEED FOR A PERIOD OF ONE (1) YEAR FROM DATE OF ACCEPTANCE. DEFECTS WHICH APPEAR DURING THIS PERIOD SHALL BE CORRECTED AT THE MECHANICAL CONTRACTOR'S EXPENSE.

FIXTURE CONNECTION NOTES:

- 1. CONNECT TO PLUMBING FIXTURES AND EQUIPMENT PROVIDED UNDER THIS AND OTHER SECTIONS OF SPECIFICATION, ARCHITECTURAL DRAWINGS, AND MANUFACTURER'S SHOP DRAWINGS. PROVIDE ROUGH-IN CONNECTION AS SHOWN IN DRAWINGS.
- 2. USE FIXTURE SCHEDULE AND DETAILS ON DRAWINGS OR MANUFACTURER'S SHOP DRAWINGS FOR CONNECTION SIZES TO FIXTURES.
- 3. PROVIDE SEPARATE P-TRAP FOR EACH FIXTURE, FLOOR DRAIN, AND PIECE OF EQUIPMENT.
- 4. PROVIDE PVC (SCH 80) P-TRAPS FOR UNDER FLOOR DRAINS.
- 5. MOUNT FIXTURES RIGID TO WALLS AS SHOWN ON DRAWINGS OR DETAILS.
- 6. PROVIDE OUTLET DEVICES WHICH LIMIT FLOW OF HOT WATER TO LAVATORIES AND HAND SINKS TO A MAXIMUM OF 0.5 GPM AND SIZED AS RECOMMENDED BY MANUFACTURER AND AS REQUIRED BY ASHRAE STANDARD 90-75, PARAGRAPH 7.7.2, LOCAL AND STATE ENERGY CODES.
- 7. INSTALL LAVATORIES AND HAND SINKS WITH A MINIMUM OF 4" CLEARANCE ON EACH SIDE FROM WALL OR PARTITION.
- 8. COORDINATE DIMENSIONS REQUIRED FOR MINIMUM FIXTURE CLEARANCE WITH OTHER DIVISIONS.
- 9. INSTALL APPROVED CAULKING AROUND JOINTS AT FIXTURES MOUNTED ON WALL OR FLOOR.





SE

JOB NO.: DRAWN: CHECKED: 2021.07.06 DATE: REVISION:

SHEET NO.:

SCALE:


PHASE 2

PLUMBING NOTES, SCHEDULES AND LEGEND

AS SHOWN





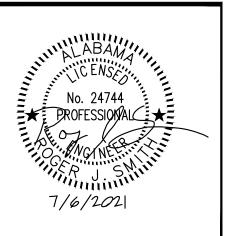

PHASE

JOB NO.:


2021.07.06

AS SHOWN

DRAWN: CHECKED: DATE: REVISION:

SCALE: SHEET NO.:

PHASE 2 PLUMBING PLAN BASE BID

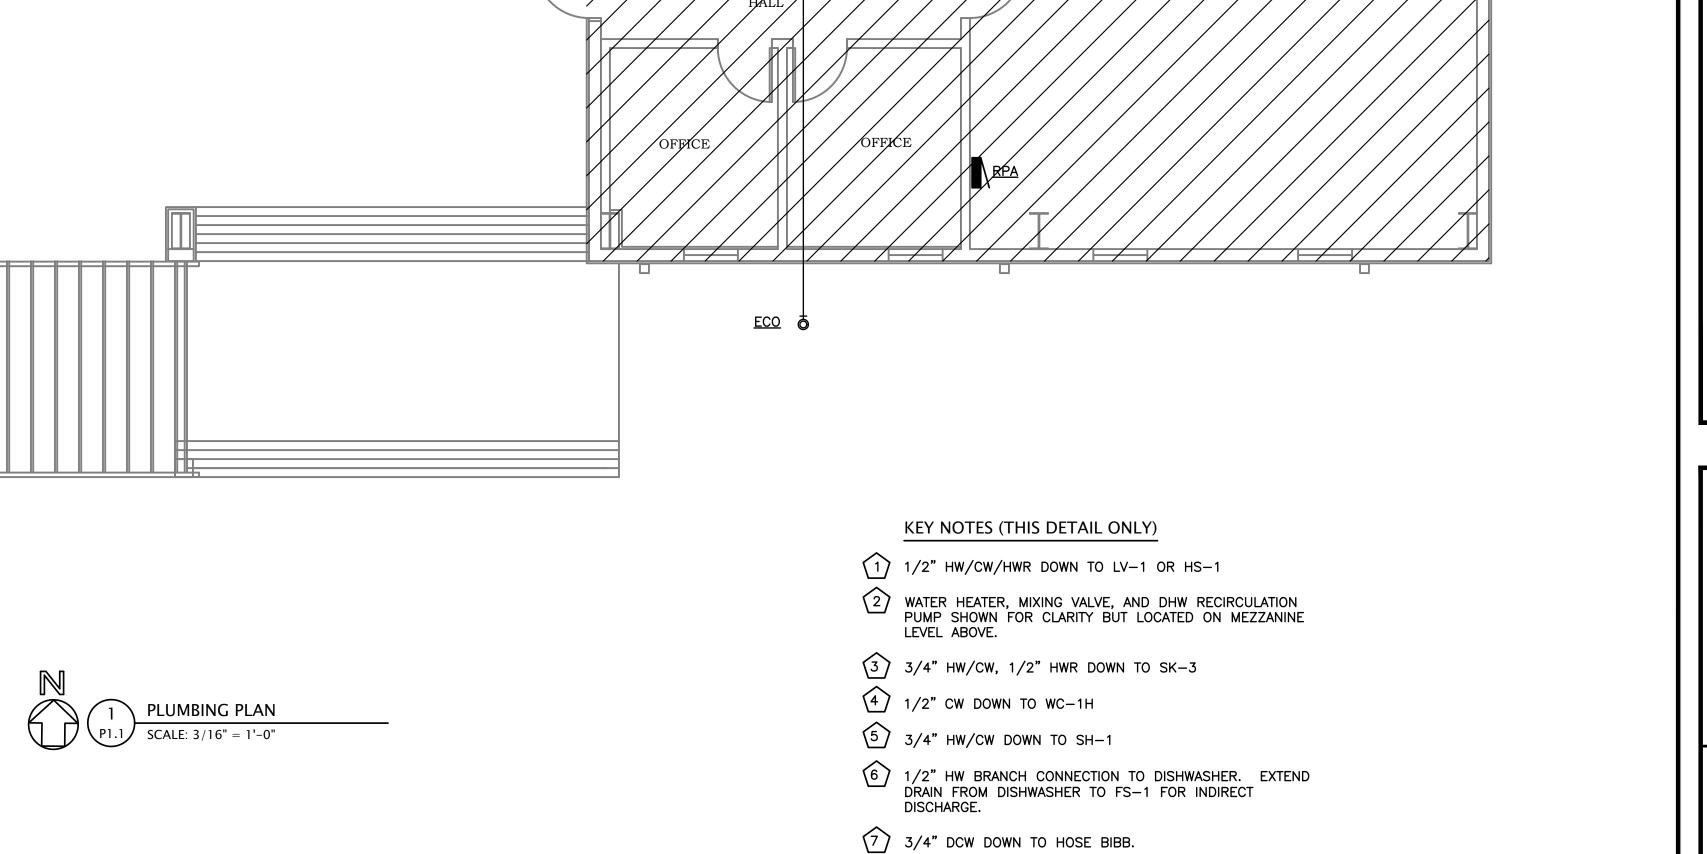

<u>2WCO</u>

CONTRACT

— INSTALLED

PHASE 1

TREATMENT

STOR. [121]

1-1/4" DCW

RCP-1, MV-1, EWH-1

3/4" DHW 1) HS-1

111

<u> 2₩CO</u> 🍳

3/4" HWR

REHAB 3

RPB

ECO 🖣

OFFICE

— INSTALLED UNDER PHASE 1

INTERN 113

FREEZER

UNDER SLAB SANITARY IS PART OF PHASE 1. PHASE 2 CONSISTS OF THE TOP OUT

REHAB 1 116

1) HS-1 3/4" DHW

OF THE PLUMBING

1) HS-1

REHAB 2 115


REF COOLER

MTR d

MP \

LC TC



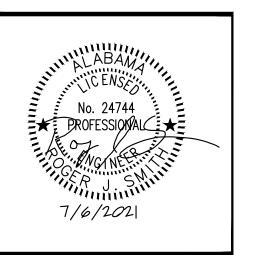


JOB NO.: DRAWN: CHECKED: 2021.07.06 DATE: REVISION:


> SCALE: SHEET NO.:

SANITARY WASTE RISERS

AS SHOWN



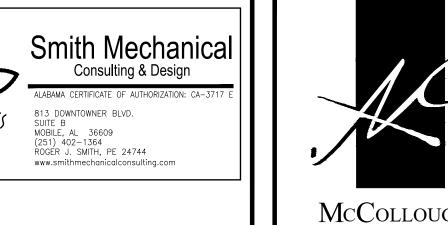

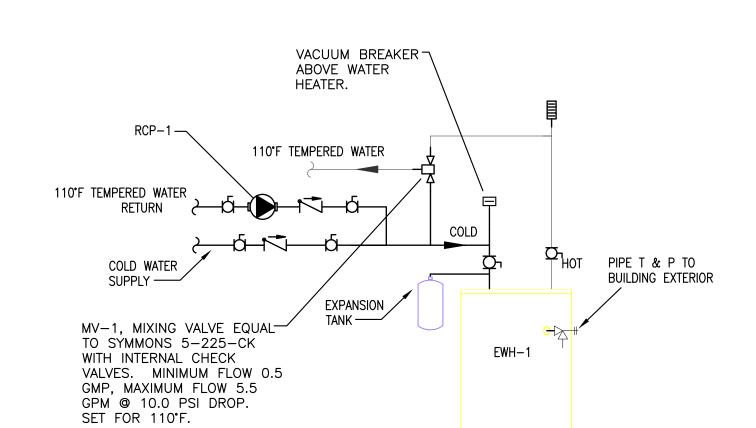

3/4" DRAIN COCK —18 GA. GALV. FINISHED FLOOR METAL DRAIN PAN EXTEND COPPER DRAIN FROM AUXILIARY PAN TO BUILDING EXTERIOR FOR DISCHARGE. SPILL ON GRADE. NOTES:

EXTERIOR CLEANOUT


COVER & FRAME.


12" SQ. X 4"

CONC. PAD

1. PIPING DIAGRAM. SEE MANUFACTURERS RECOMMENDATIONS FOR ADDITIONAL INFORMATION. 2. THE TEMPERATURE AND PRESSURE RELIEF VALVE SETTING SHALL NOT EXCEED PRESSURE RATING OF ANY ANY COMPONENT IN THE SYSTEM. 3. SERVICE VALVES ARE SHOWN FOR SERVICING UNIT. HOWEVER, LOCAL CODES SHALL GOVERN THEIR USAGE.


DOMESTIC HOT WATER WITH RECIRC. DETAIL SCALE: N.T.S.

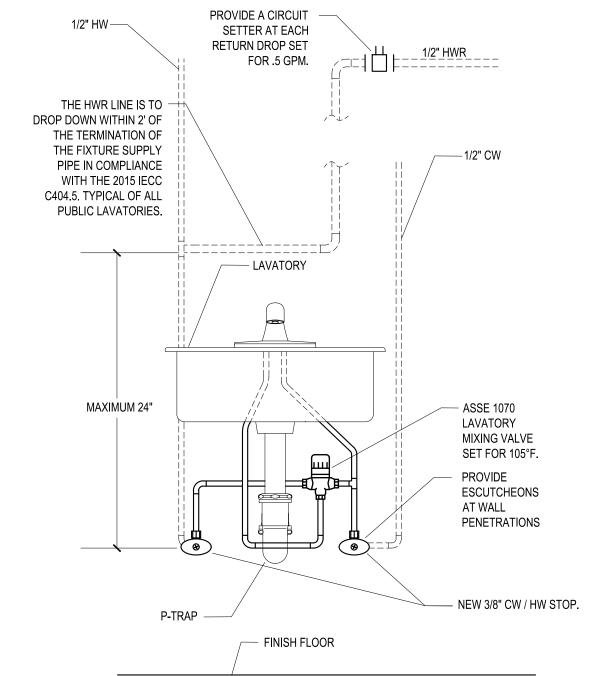

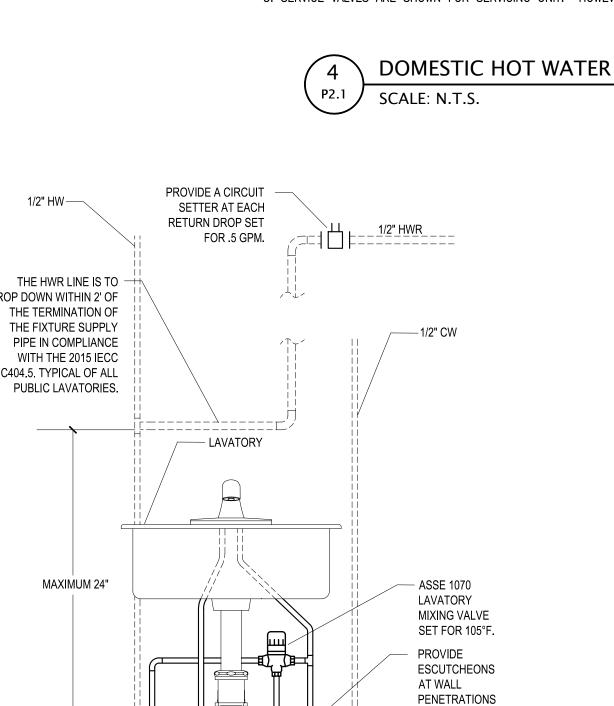

LAVATORY MIXING VALVE DETAIL SCALE: NONE



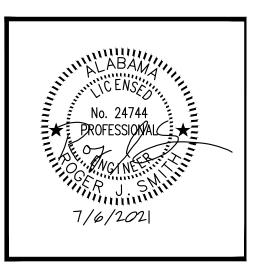

SE

JOB NO.: RJS DRAWN: RJS CHECKED: 2021.07.06 DATE: REVISION: AS SHOWN

SHEET NO.:

SCALE:

PLUMBING DETAILS

PHASE 2

CLEANOUT PLUG


— FINISHED GRADE

- TWO-WAY CLEANOUT

FITTING

TWO-WAY CLEANOUT DETAIL

SCALE: NONE

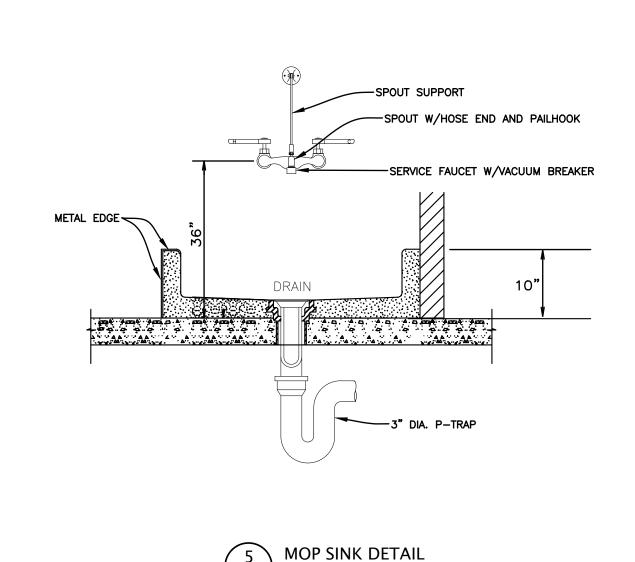

P2.1 SCALE: NONE

TERMINATE W/——CLEANOUT PLUG

AT END OF

RUN.

- CONCRETE SURFACE OR FLOOR

CLEANOUT PLUG

FINISHED FLOOR

· CAULKING FERRULE

12" SQUARE
CONCRETE PAD
W/ 1" TOOLED
EDGES

PVC PIPING

CAP CLEANOUT END WITH

THREADED PLUG-

-FINISHED

CAST IRON CLEANOUT

OUTDOOR CLEANOUT DETAIL

SCALE: NONE

W/ RECESSED BRONZE PLUG

-4" CONCRETE ENCASEMENT

ABOVE AND BELOW PIPE

STAINLESS STEEL CLAMPS —

FLASH METAL BASE TO

MATCH ROOF -

STRUCTURE

- STEPPED BOOT

NOTE: BOND BASE TO ROOF PER

VENT THRU ROOF DETAIL

SCALE: NONE

ROOFING MANUFACTURER'S SPECIFICATIONS.

COVERING AS REQUIRED

CLEANOUT COVER

FLOW

FLOOR CLEANOUT DETAIL

SCALE: NONE

CSK SCREW

