MARTIN COUNTY SCHOOL DISTRICT ADMINISTRATIVE OFFICES ROOF REPLACEMENT

1939 SE Federal Highway, Stuart, Florida 34994 100% CONSTRUCTION DOCUMENTS

BOARD MEMBERS:

DR. JOHN D. MILLAY

MARSHA POWERS
TONY ANDERSON
CHRISTIA LI ROBERTS
VICTORIA DEFENTHALER
MICHAEL DITERLIZZI

CHAIR VICE CHAIR MEMBER MEMBER MEMBER SUPERINTENDENT





	PROJEC	TNARRATIVE	
LOCATED AT OFFICE. ALL SPECIFICAT GIVEN FROM MANUFACTU AREAS, RECONTRACTO THE SCOPE THE MARTIN AND AUTHOR REQUIREME	T THE MARTIN COUNTY NEW WORK SHALL BE IONS SET FORTH IN TH THE MARTIN COUNTY JRERS RECOMMENDED GARDLESS OF THE LOC UND PREPPED FOR THE DR SHALL VISIT THE SIT OF WORK. ALL NEW WI I COUNTY SCHOOL DIS RITY HAVING JURISDIC	ROOFING OF ALL THE BUILDIN SCHOOL DISTRICT ADMINIST IN ACCORDANCE WITH DRAW ESE DOCUMENTS, FROM DIRE SCHOOL DISTRICT AND PER INSTALLATION REQUIREMENTATION, WILL BE REQUIRED TO INSTALLATION OF THE SCOPIE TO RECOGNIZE THE AREAS ORK SHALL BE IN CONFORMATRICT STANDARDS, APPLICABLION. THIS INCLUDES THE DISTORMATION CODE SERVENTION CODE.	RATIVE //INGS AND ECTION TS. ALL) BE E OF WORK. S WITHIN INCE WITH BLE CODES
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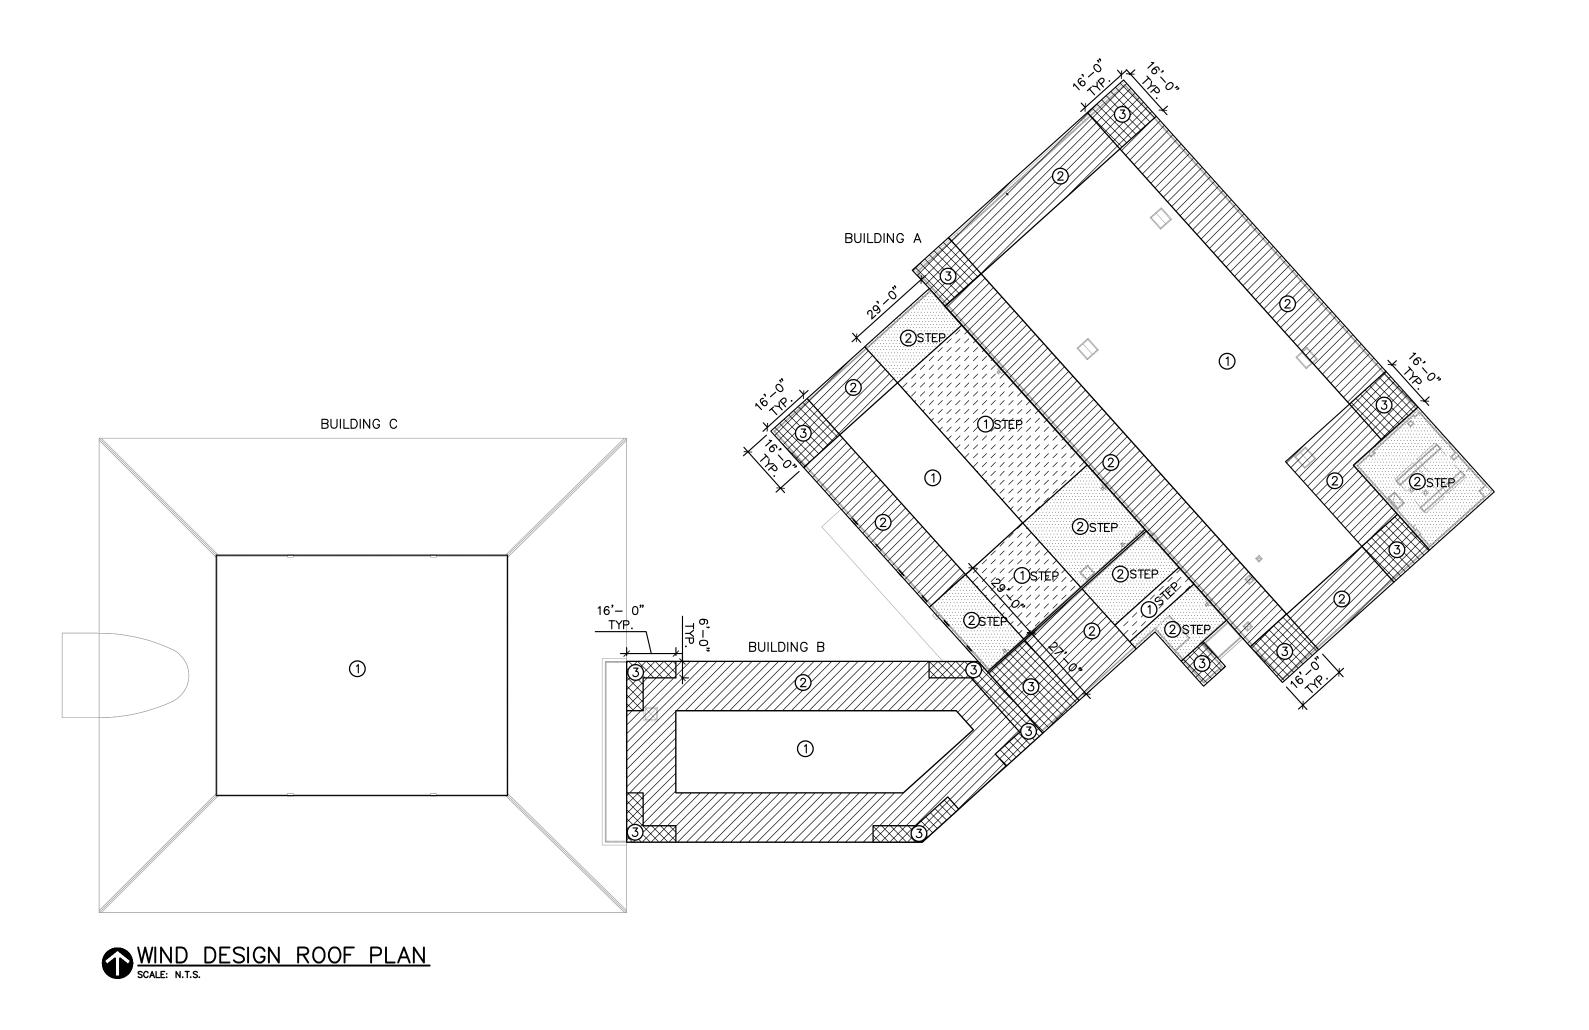
SHEET NO.	TITLE	ORIGINAL DATE	REVISION NO.	LATEST REVISION DATE
	GENERAL			
G-100	COVER SHEET & INDEX	07/14/2021		
	STRUCTURAL			
S-102	WIND DESIGN DATA AND LOAD SCHEDULE	07/14/2021		
	ARCHITECTURAL			
AD-101	OVERALL DEMOLITION ROOF PLAN	07/14/2021		
AD-102	PARTIAL DEMOLITION ROOF PLAN	07/14/2021		
AD-103	PARTIAL DEMOLITION ROOF PLAN	07/14/2021		
A-101	OVERALL PROPOSED ROOF PLAN	07/14/2021		
A-102	PARTIAL PROPOSED ROOF PLAN	07/14/2021		
A-103	PARTIAL PROPOSED ROOF PLAN	07/14/2021		
A-104	ROOF DETAILS	07/14/2021		
A-105	ROOF DETAILS	07/14/2021		

Con	nm. No:	17042.04		
Date	e :	07/14/2021		
Drav	vn:	MFH		
	Rev	isions		
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PLANS	AND SPECIFIC	ATIONS COMPLY WITH		
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Daniel T Canavan, AIA
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COVER SHEET
& INDEX

G-100



BUILDING A

WIND DESIGN DATA (BUILDING A): CODE: FLORIDA BUILDING CODE, (SEVENTH EDITION) 2020 ASCE/SEI 7-16 163 MPH (Vult) 126 MPH (Vasd) BASIC WIND SPEED: CATEGORY (RISK): II
EXPOSURE CATEGORY: C
BUILDING HEIGHT: 40.67 ft.
ENCLOSURE CLASSIFICATION: ENCLOSED
INTERNAL PRESSURE COEFFICIENT: ±0.18

				MAIN ROOF			
PATTERN	ZONE	EFFECTIVE WIND AREA					
		10 SQ. FT.	20 SQ. FT.	50 SQ. FT.	100 SQ. FT.	200 SQ. FT.	500 SQ. FT.
	1	+29 PSF/-113 PSF	+27 PSF/-106 PSF	+25 PSF/-96 PSF	+23 PSF/-89 PSF	+23 PSF/-81 PSF	+23 PSF/-71
	2	+29 PSF/-150 PSF	+27 PSF/-140 PSF	+25 PSF/-127 PSF	+23 PSF/-118 PSF	+23 PSF/-108 PSF	+23 PSF/-95
	3	+29 PSF/-204 PSF	+27 PSF/-185 PSF	+25 PSF/-159 PSF	+23 PSF/-140 PSF	+23 PSF/-120 PSF	+23 PSF/-95
/////	1)STEP	+65 PSF/-113 PSF	+62 PSF/-106 PSF	+58 PSF/-96 PSF	+56 PSF/-89 PSF	+53 PSF/-82 PSF	+49 PSF/-71
	2 STEP	+65 PSF/-150 PSF	+62 PSF/-140 PSF	+58 PSF/-127 PSF	+56 PSF/-118 PSF	+53 PSF/-108 PSF	+49 PSF/-95

NOTE:

1. ALL EXTERIOR DOORS & WINDOW ASSEMBLIES SHALL SATISFY THE REQUIREMENTS OF THE FLORIDA BUILDING CODE (SEVENTH EDITION 2020, SECTION 1709.5). ALL CONNECTIONS TO BUILDING STRUCTURE SHALL HAVE THE CAPACITY TO WITHSTAND THE PRESSURES INDICATED IN THIS SCHEDULE.

2. PLUS AND MINUS SIGNS SIGNIFY PRESSURES ACTING TOWARD AND AWAY FROM THE SURFACES, RESPECTIVELY.

3. ALL WIND PRESSURE VALUES INDICATED ARE IN POUNDS PER SQUARE FOOT (PSF). MULTIPLY ULTIMATE WIND PRESSURE BY 0.60 FOR ASD PRESSURE.

BUILDING B

WIND DESIGN DATA (BUILDING B): CODE: FLORIDA BUILDING CODE, (SEVENTH EDITION) 2020 ASCE/SEI 7-16 163 MPH (Vult) 126 MPH (Vasd) BASIC WIND SPEED: CATEGORY (RISK): II
EXPOSURE CATEGORY: C
BUILDING HEIGHT: 27.33 ft.
ENCLOSURE CLASSIFICATION: ENCLOSED
INTERNAL PRESSURE COEFFICIENT: ±0.18

COMPONENTS AND CLADDING NET UPLIFT SCHEDULE (ULTIMATE) BUILDING B								
MAIN ROOF								
PATTERN	ZONE	EFFECTIVE WIND AREA						
		10 SQ. FT.	20 SQ. FT.	50 SQ. FT.	100 SQ. FT.	200 SQ. FT.	500 SQ. FT.	
	1	+27 PSF/-104 PSF	+25 PSF/-97 PSF	+23 PSF/-88 PSF	+21 PSF/-81 PSF	+21 PSF/-75 PSF	+21 PSF/-65 PS	
	2	+27 PSF/-137 PSF	+25 PSF/-129 PSF	+23 PSF/-117 PSF	+21 PSF/-108 PSF	+21 PSF/-99 PSF	+21 PSF/-88 PSF	
	3	+27 PSF/-187 PSF	+25 PSF/-170 PSF	+23 PSF/-146 PSF	+21 PSF/-129 PSF	+21 PSF/-111 PSF	+21 PSF/-88 PSI	

NOTE:

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3. ALL WIND PRESSURE VALUES INDICATED ARE IN POUNDS PER SQUARE FOOT (PSF). MULTIPLY ULTIMATE WIND PRESSURE BY 0.60 FOR ASD PRESSURE.

BUILDING C

WIND DESIGN DATA (BUILDING C): CODE: FLORIDA BUILDING CODE, (SEVENTH EDITION) 2020 ASCE/SEI 7-16 BASIC WIND SPEED: CATEGORY (RISK): II
EXPOSURE CATEGORY: C
BUILDING HEIGHT: 42.83 ft.
ENCLOSURE CLASSIFICATION: ENCLOSED
INTERNAL PRESSURE COEFFICIENT: ±0.18

COMPONENTS AND CLADDING NET UPLIFT SCHEDULE (ULTIMATE) BUILDING C								
				MAIN ROOF				
PATTERN	ZONE	EFFECTIVE WIND AREA						
		10 SQ. FT.	20 SQ. FT.	50 SQ. FT.	100 SQ. FT.	200 SQ. FT.	500 SQ. FT.	
	1	+54 PSF/-98 PSF	+47 PSF/-86 PSF	+37 PSF/-72 PSF	+30 PSF/-61 PSF	+30 PSF/-61 PSF	+30 PSF/-61 PSF	

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District Administrative Offices ReMartin County School
1939 SE Federal Hig
Stuart, Florida 349
100% Construction Doc Comm. No: 17042.04 07/14/2021 Date: AF Drawn: Revisions No. Date


TO THE BEST OF OUR KNOWLEDGE, INFORMATION AND BELIEF, THESE STRUCTURAL PLANS CONFORM TO AND SATISFY THE FLORIDA BUILDING CODE, 2020 EDITION, ACI 318-14, AND LOCAL CODES AS APPLICABLE.

No 43453

ARMANDO A. CASTELLON, P.E FL. LIC. No. 43453 ©2020 HARVARD JOLLY, INC.

WIND DESIGN DATA

AND LOAD SCHEDULE

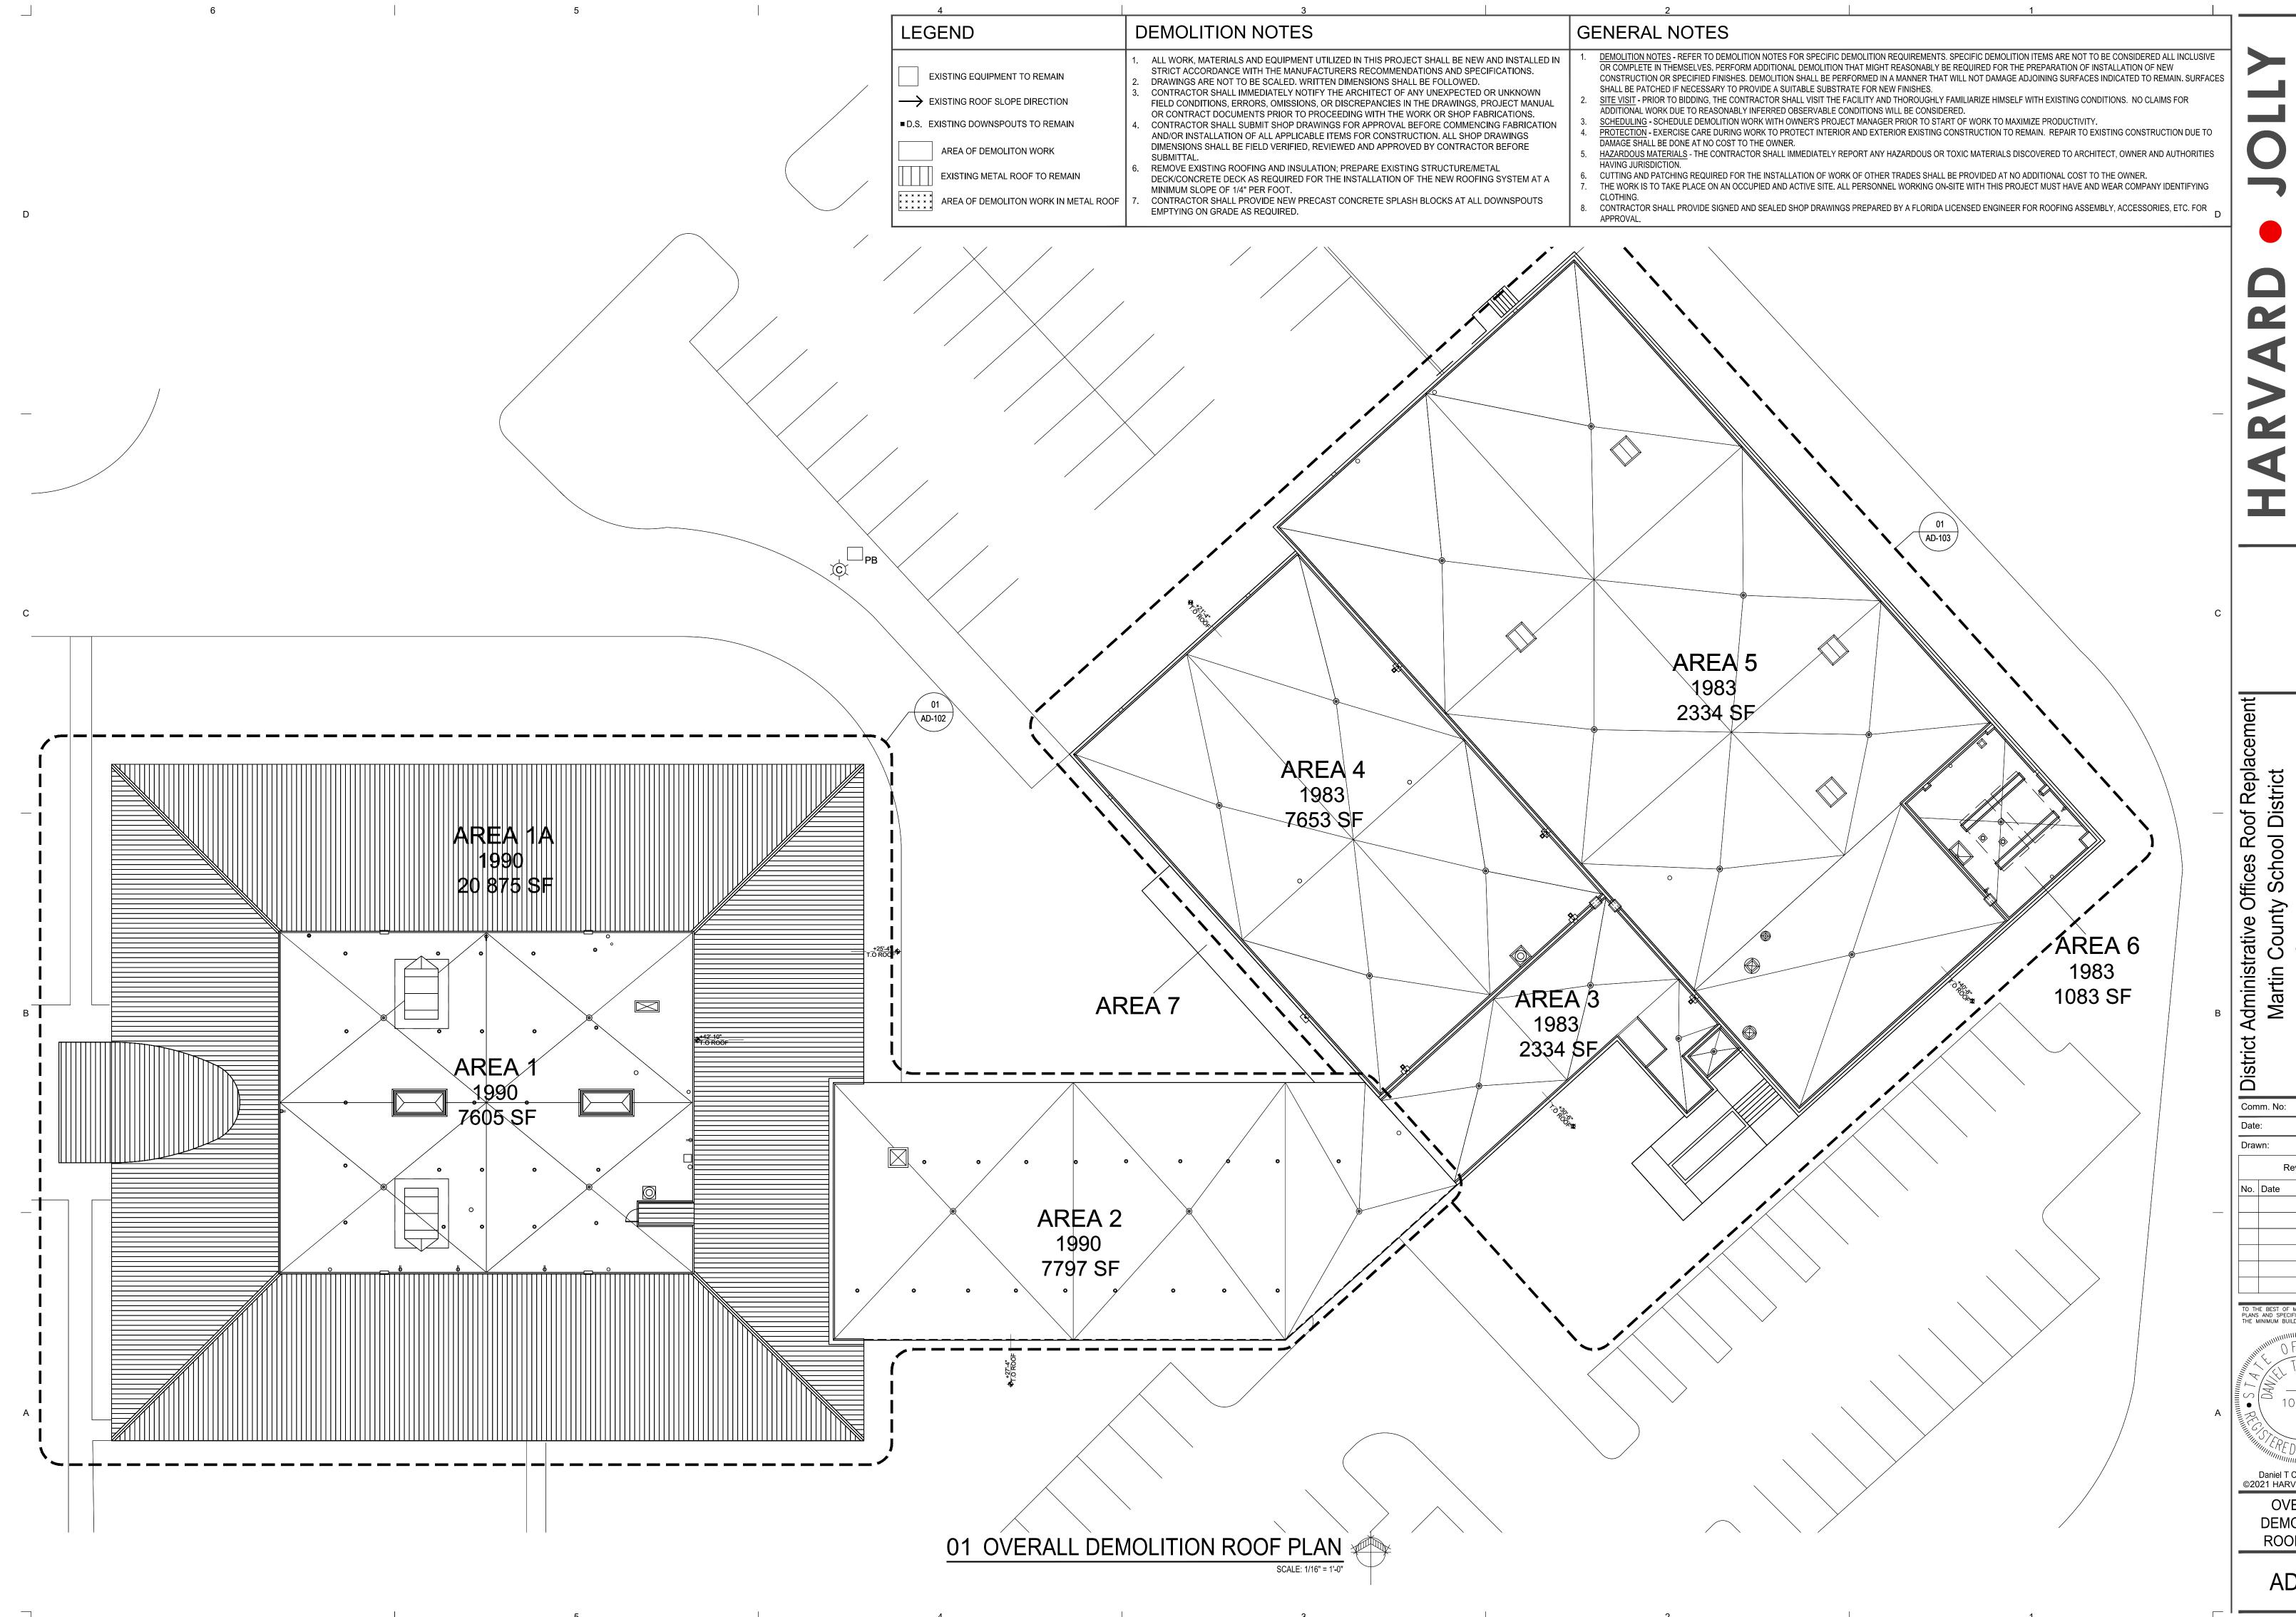

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District Administrative Offices Roof Replacemer

Martin County School District

1939 SE Federal Highway

Stuart, Florida 34994

100% Construction Documents

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Revisions

Date Note

TO THE BEST OF MY KNOWLEDGE, THE PLANS AND SPECIFICATIONS COMPLY WITH THE MINIMUM BUILDING CODES.


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HE MINIMUM BUILDING CODES.

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Daniel T Canavan, AIA ©2021 HARVARD JOLLY, INC. OVERALL DEMOLITION ROOF PLAN

AD-101



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ARRARD TO Mest Palm Beach, FL 33411 | 561-478-457 | www.HarvardJolly.com | AR001314
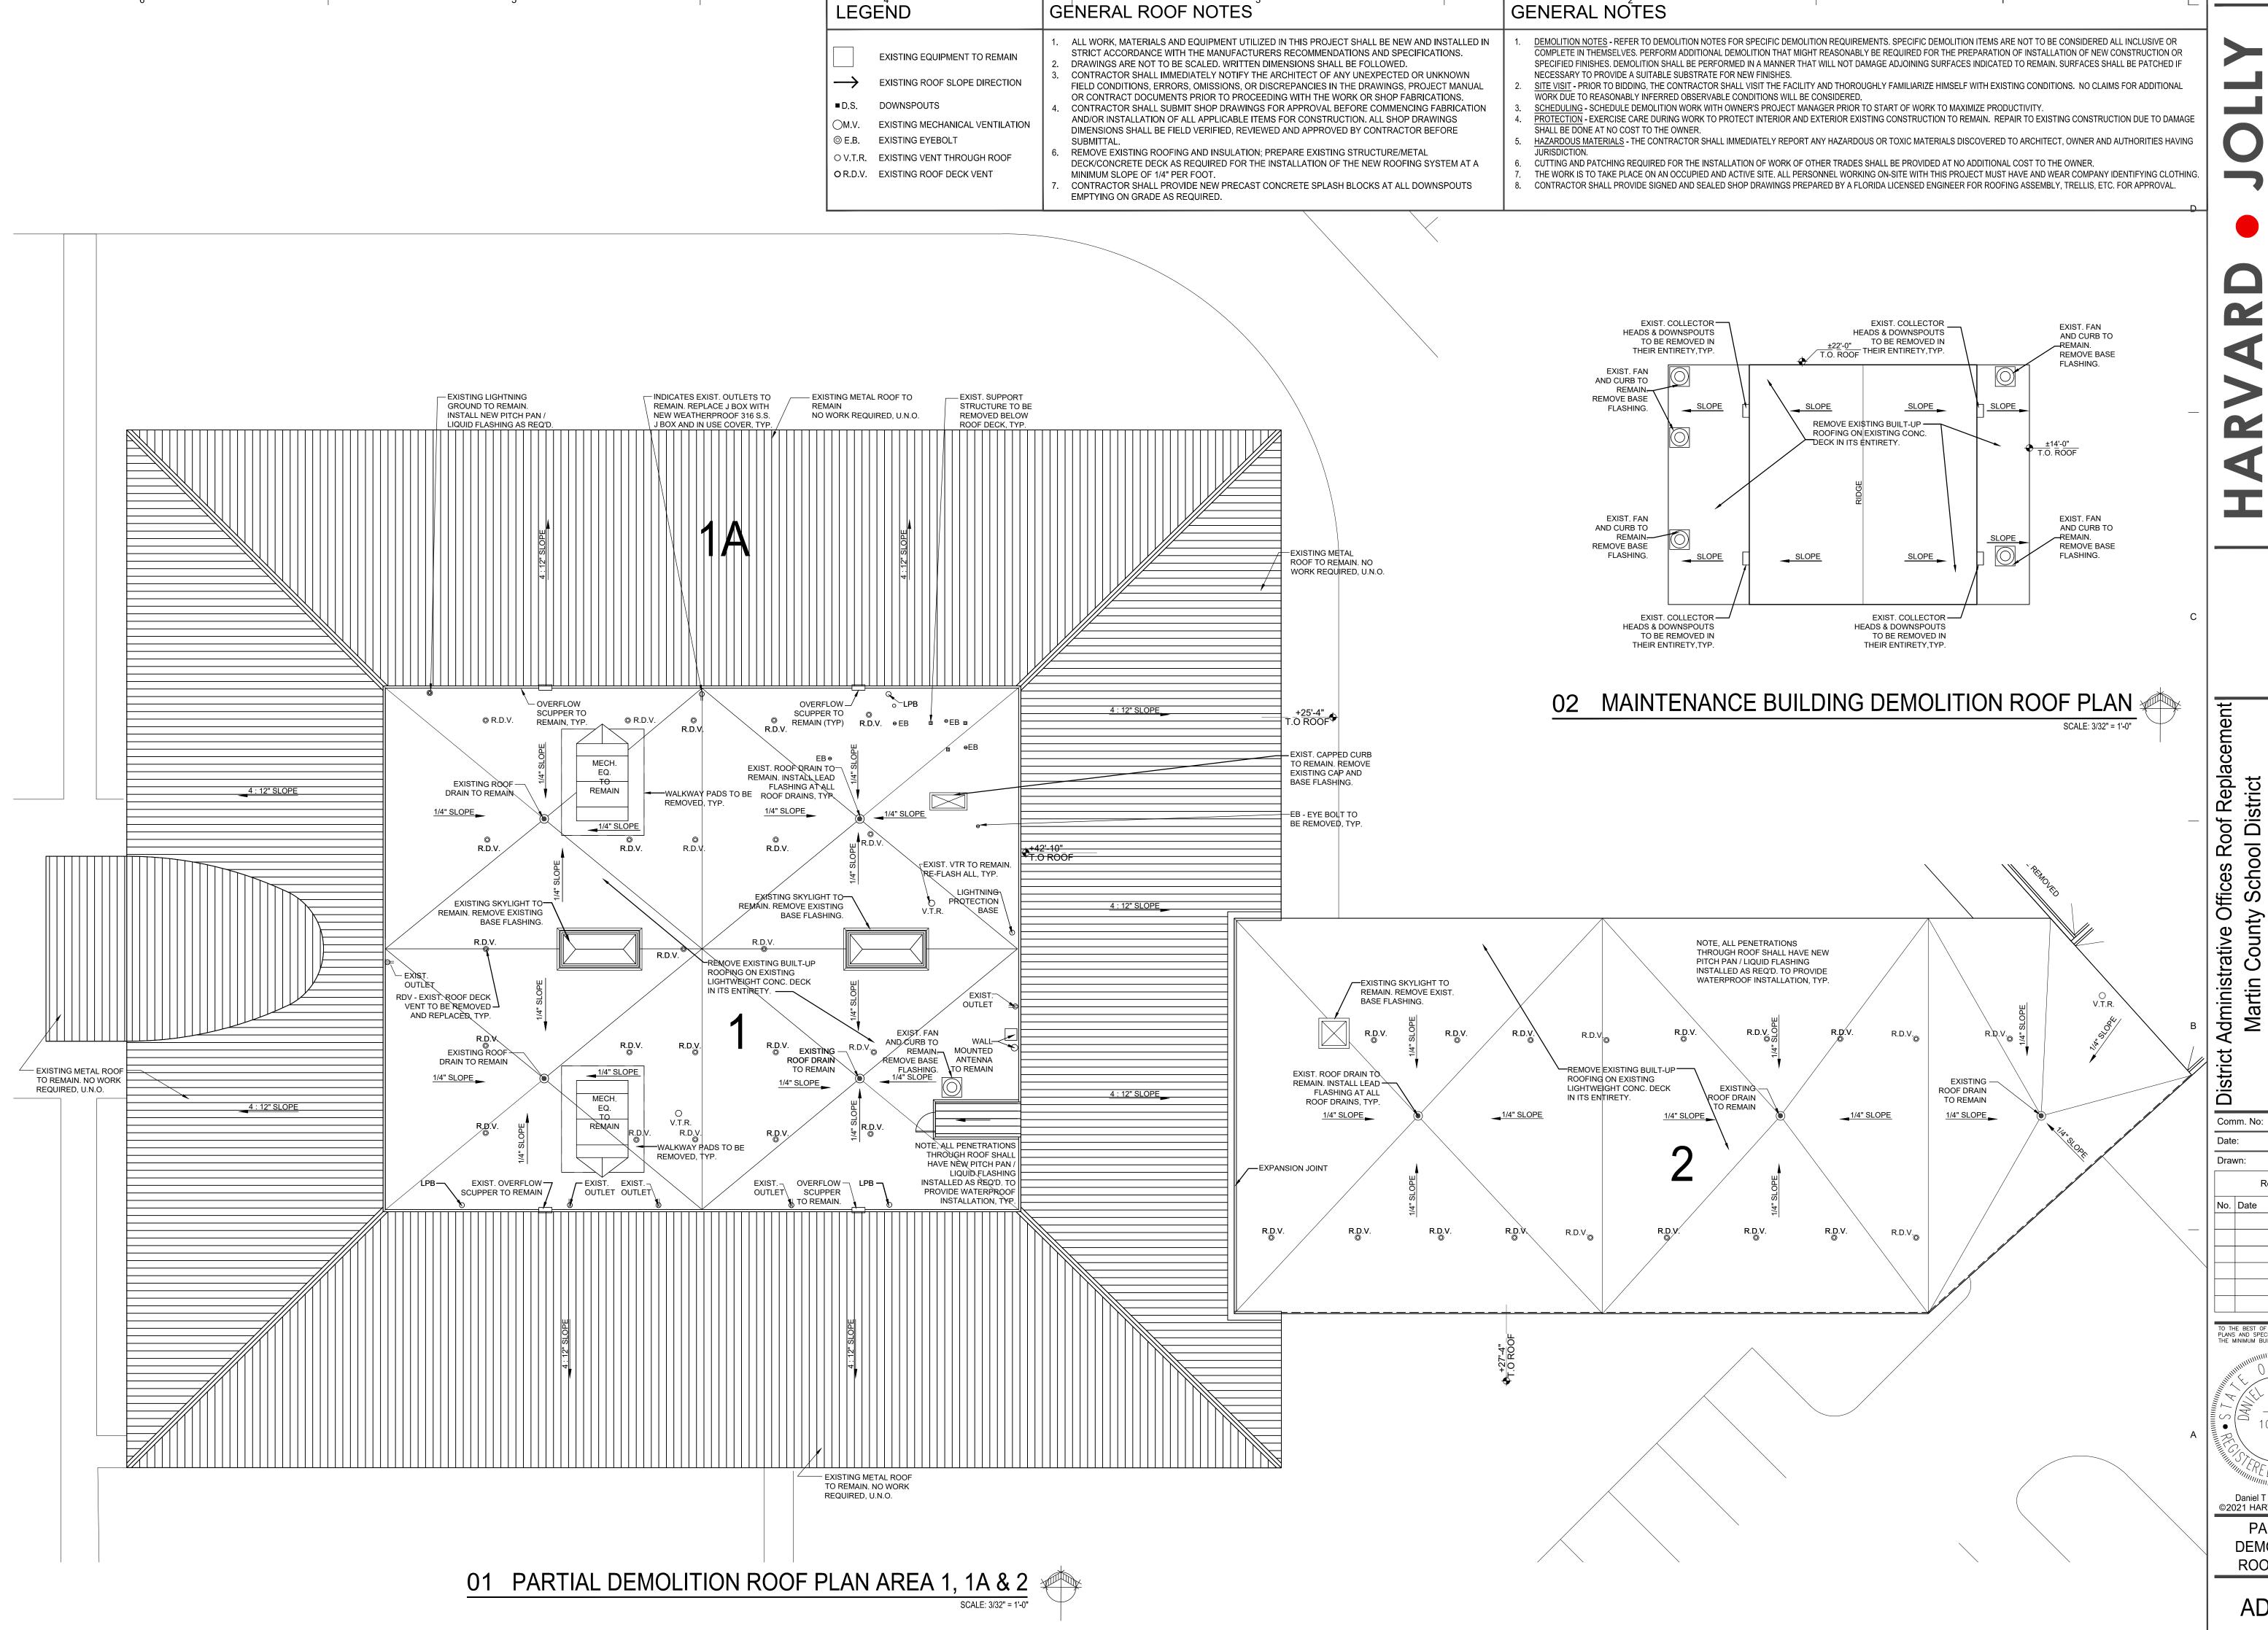
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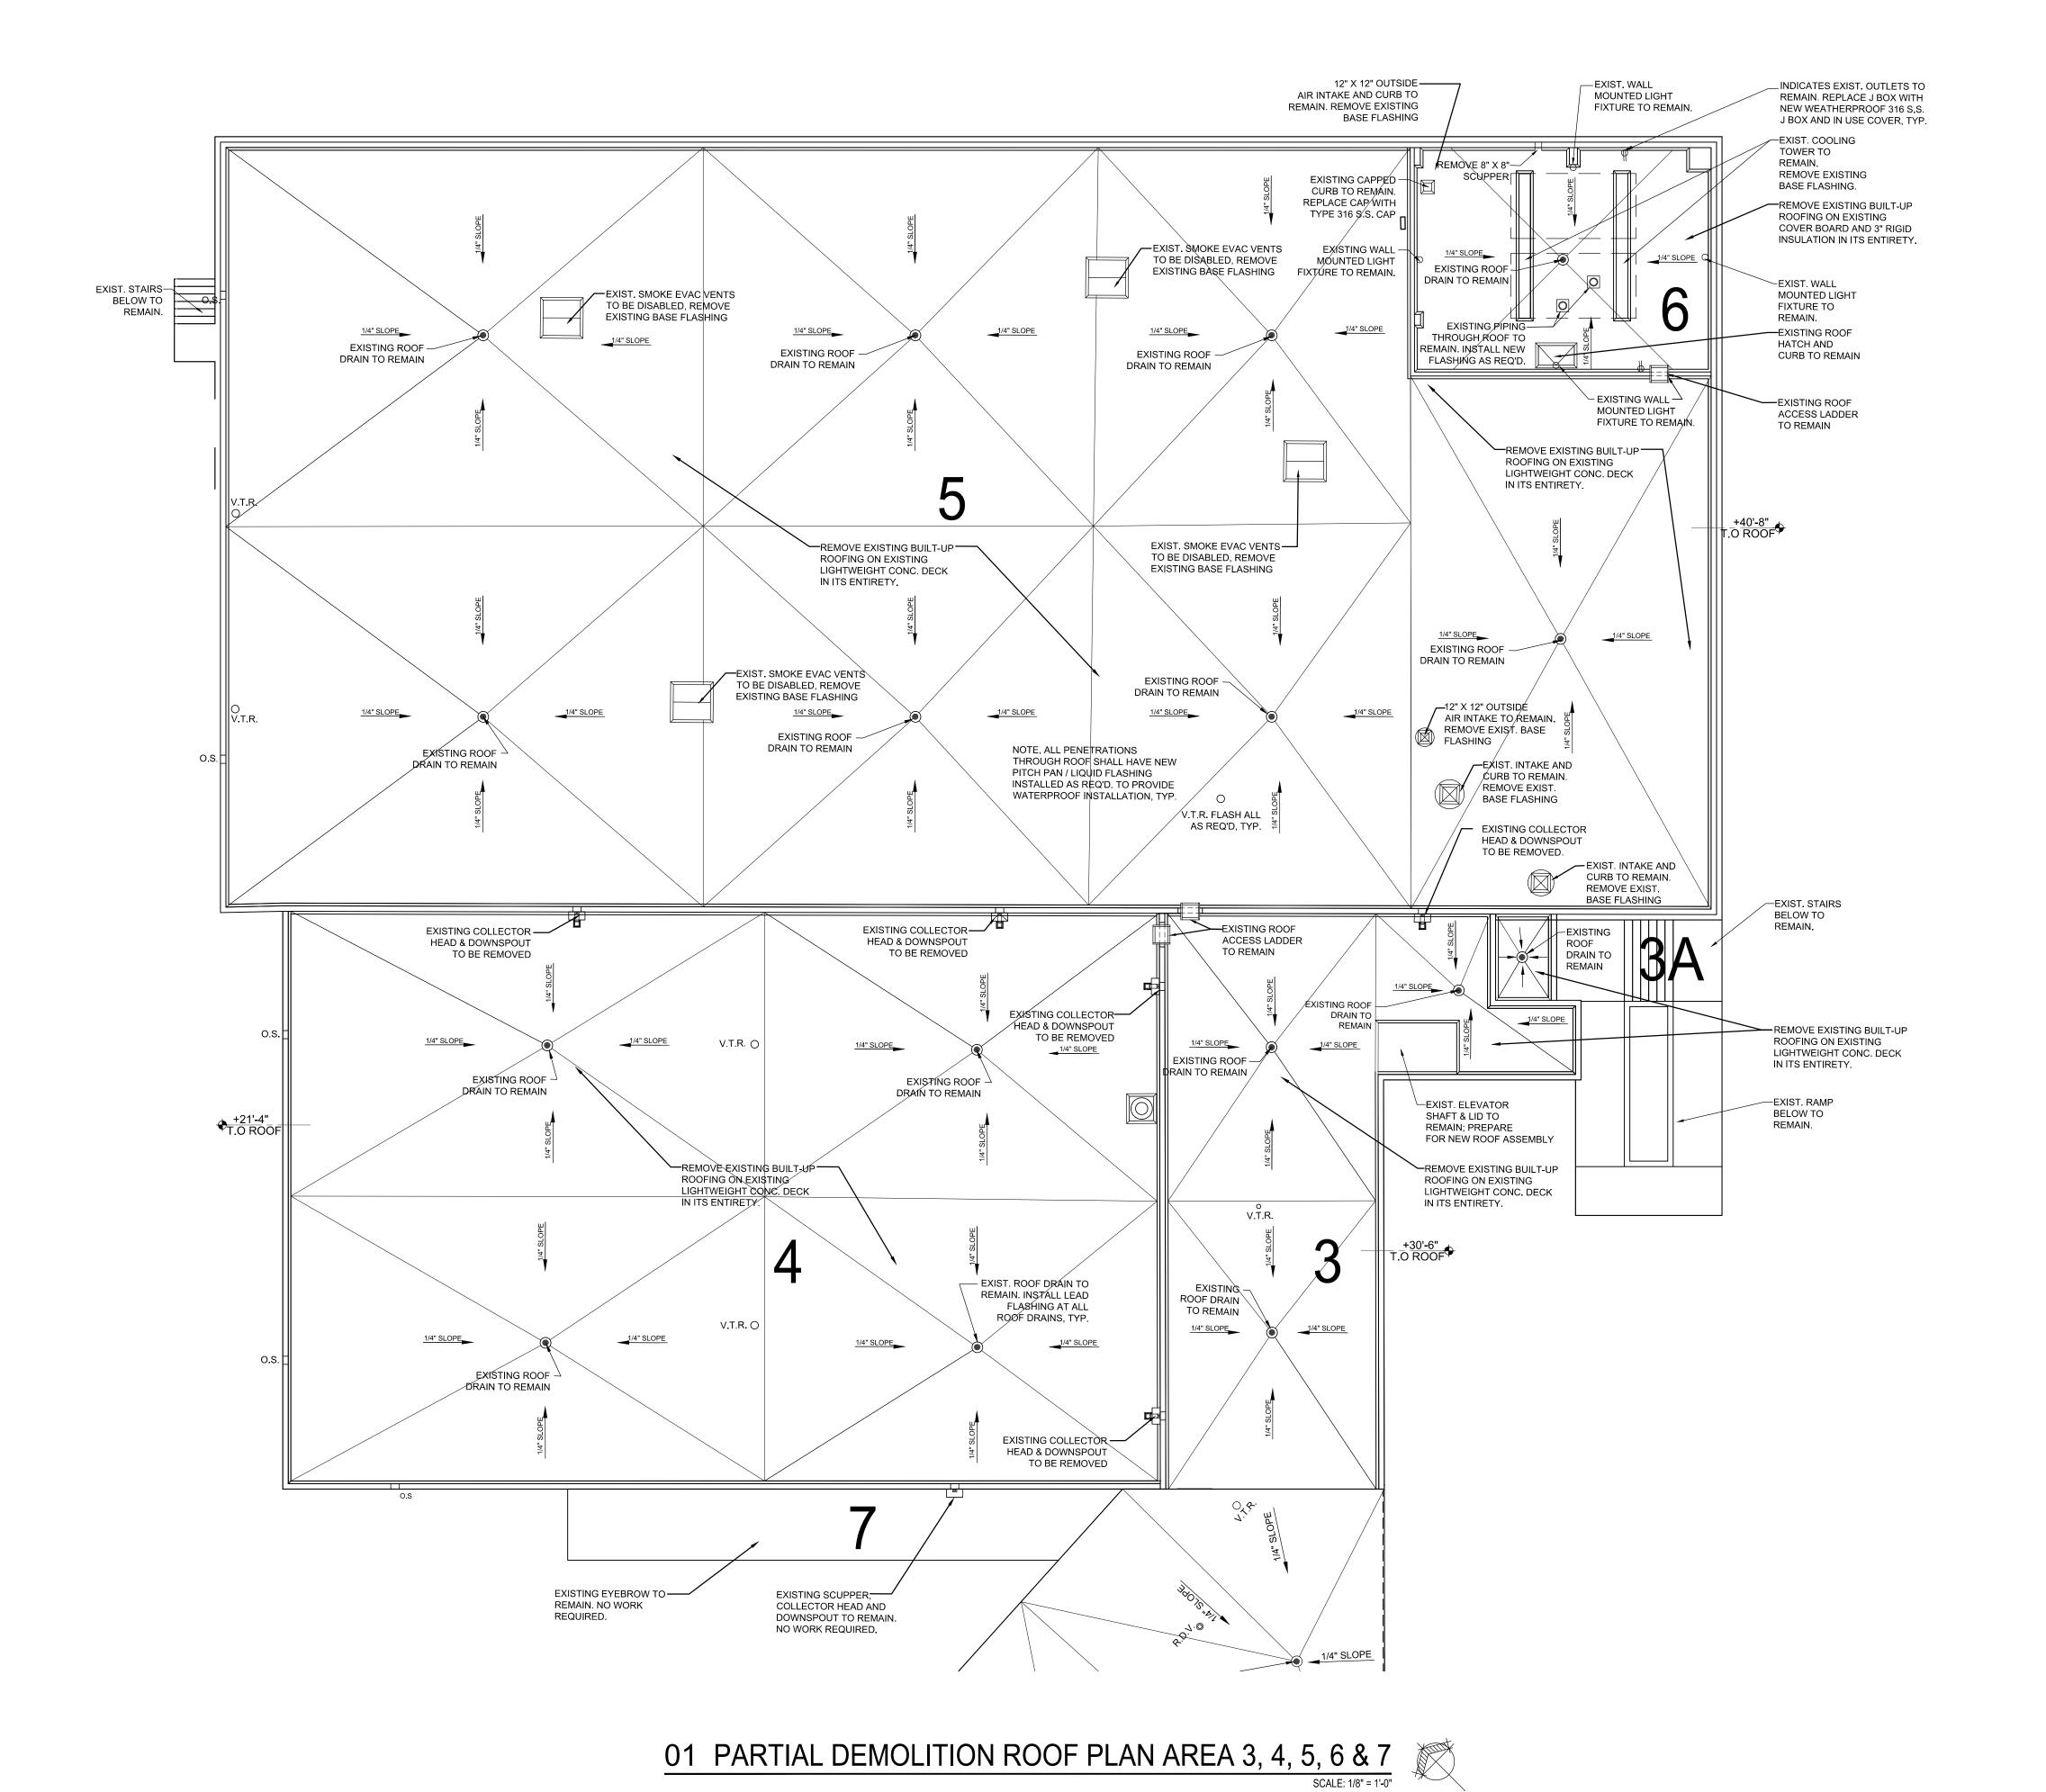
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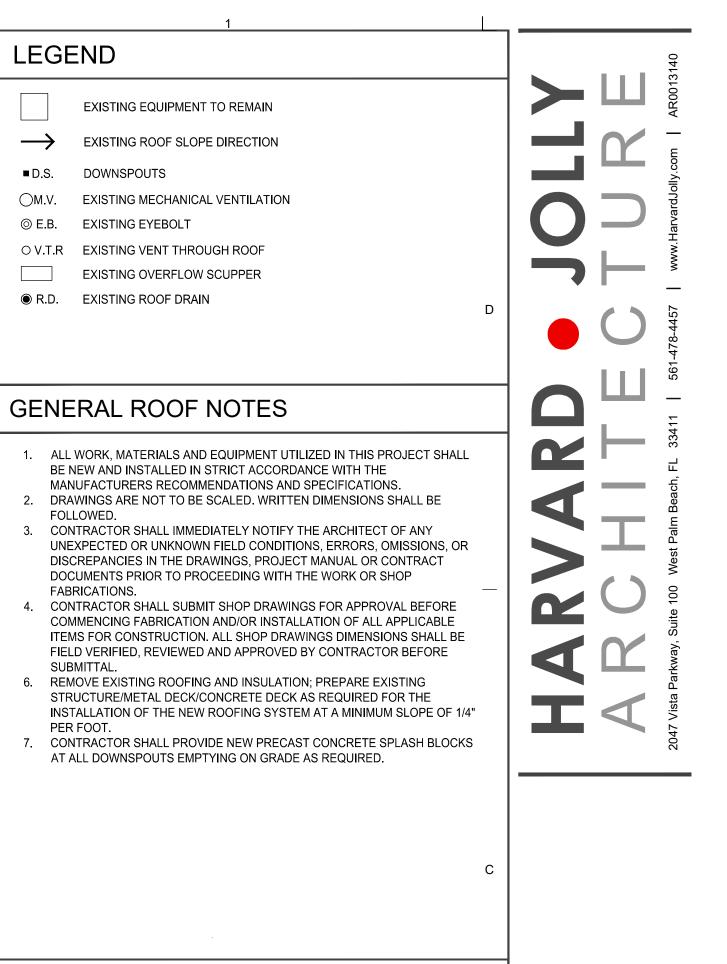
PARTIAL

DEMOLITION

ROOF PLAN

AD-102





GENERAL NOTES

LEGEND

■ D.S. DOWNSPOUTS

FOLLOWED.

FABRICATIONS.

SUBMITTAL.


- 1. DEMOLITION NOTES REFER TO DEMOLITION NOTES FOR SPECIFIC DEMOLITION REQUIREMENTS. SPECIFIC DEMOLITION ITEMS ARE NOT TO BE CONSIDERED ALL INCLUSIVE OR COMPLETE IN THEMSELVES. PERFORM ADDITIONAL DEMOLITION THAT MIGHT REASONABLY BE REQUIRED FOR THE PREPARATION OF INSTALLATION OF NEW CONSTRUCTION OR SPECIFIED FINISHES. DEMOLITION SHALL BE PERFORMED IN A MANNER THAT WILL NOT DAMAGE ADJOINING SURFACES INDICATED TO REMAIN. SURFACES SHALL BE PATCHED IF NECESSARY TO PROVIDE A SUITABLE SUBSTRATE FOR NEW FINISHES.
- SITE VISIT PRIOR TO BIDDING, THE CONTRACTOR SHALL VISIT THE FACILITY AND THOROUGHLY FAMILIARIZE HIMSELF WITH EXISTING CONDITIONS. NO CLAIMS FOR ADDITIONAL WORK DUE TO REASONABLY INFERRED OBSERVABLE CONDITIONS WILL
- SCHEDULING SCHEDULE DEMOLITION WORK WITH OWNER'S PROJECT MANAGER PRIOR TO START OF WORK TO MAXIMIZE PRODUCTIVITY.
- 4. <u>PROTECTION</u> EXERCISE CARE DURING WORK TO PROTECT INTERIOR AND EXTERIOR EXISTING CONSTRUCTION TO REMAIN. REPAIR TO EXISTING CONSTRUCTION DUE TO DAMAGE SHALL BE DONE AT NO COST TO THE OWNER.
- HAZARDOUS MATERIALS THE CONTRACTOR SHALL IMMEDIATELY REPORT ANY HAZARDOUS OR TOXIC MATERIALS DISCOVERED TO ARCHITECT, OWNER AND AUTHORITIES HAVING JURISDICTION.
- CUTTING AND PATCHING REQUIRED FOR THE INSTALLATION OF WORK OF OTHER TRADES SHALL BE PROVIDED AT NO ADDITIONAL COST TO THE OWNER.
- THE WORK IS TO TAKE PLACE ON AN OCCUPIED AND ACTIVE SITE. ALL PERSONNEL WORKING ON-SITE WITH THIS PROJECT MUST HAVE AND WEAR COMPANY IDENTIFYING CLOTHING.
- 8. CONTRACTOR SHALL PROVIDE SIGNED AND SEALED SHOP DRAWINGS PREPARED BY A FLORIDA LICENSED ENGINEER FOR ROOFING ASSEMBLY, ETC. FOR APPROVAL.


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Comm. No: 17042.04 07/14/2021 MFH Revisions No. Date

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THE WORK IS TO TAKE PLACE ON AN OCCUPIED AND ACTIVE SITE. ALL PERSONNEL WORKING ON-SITE WITH THIS PROJECT MUST HAVE AND WEAR COMPANY IDENTIFYING CLOTHING.

8. CONTRACTOR SHALL PROVIDE SIGNED AND SEALED SHOP DRAWINGS PREPARED BY A FLORIDA LICENSED ENGINEER FOR ROOFING ASSEMBLY, TRELLIS, ETC. FOR APPROVAL.

17042.04 Comm. No: 07/14/2021 MFH Drawn: Revisions No. Date
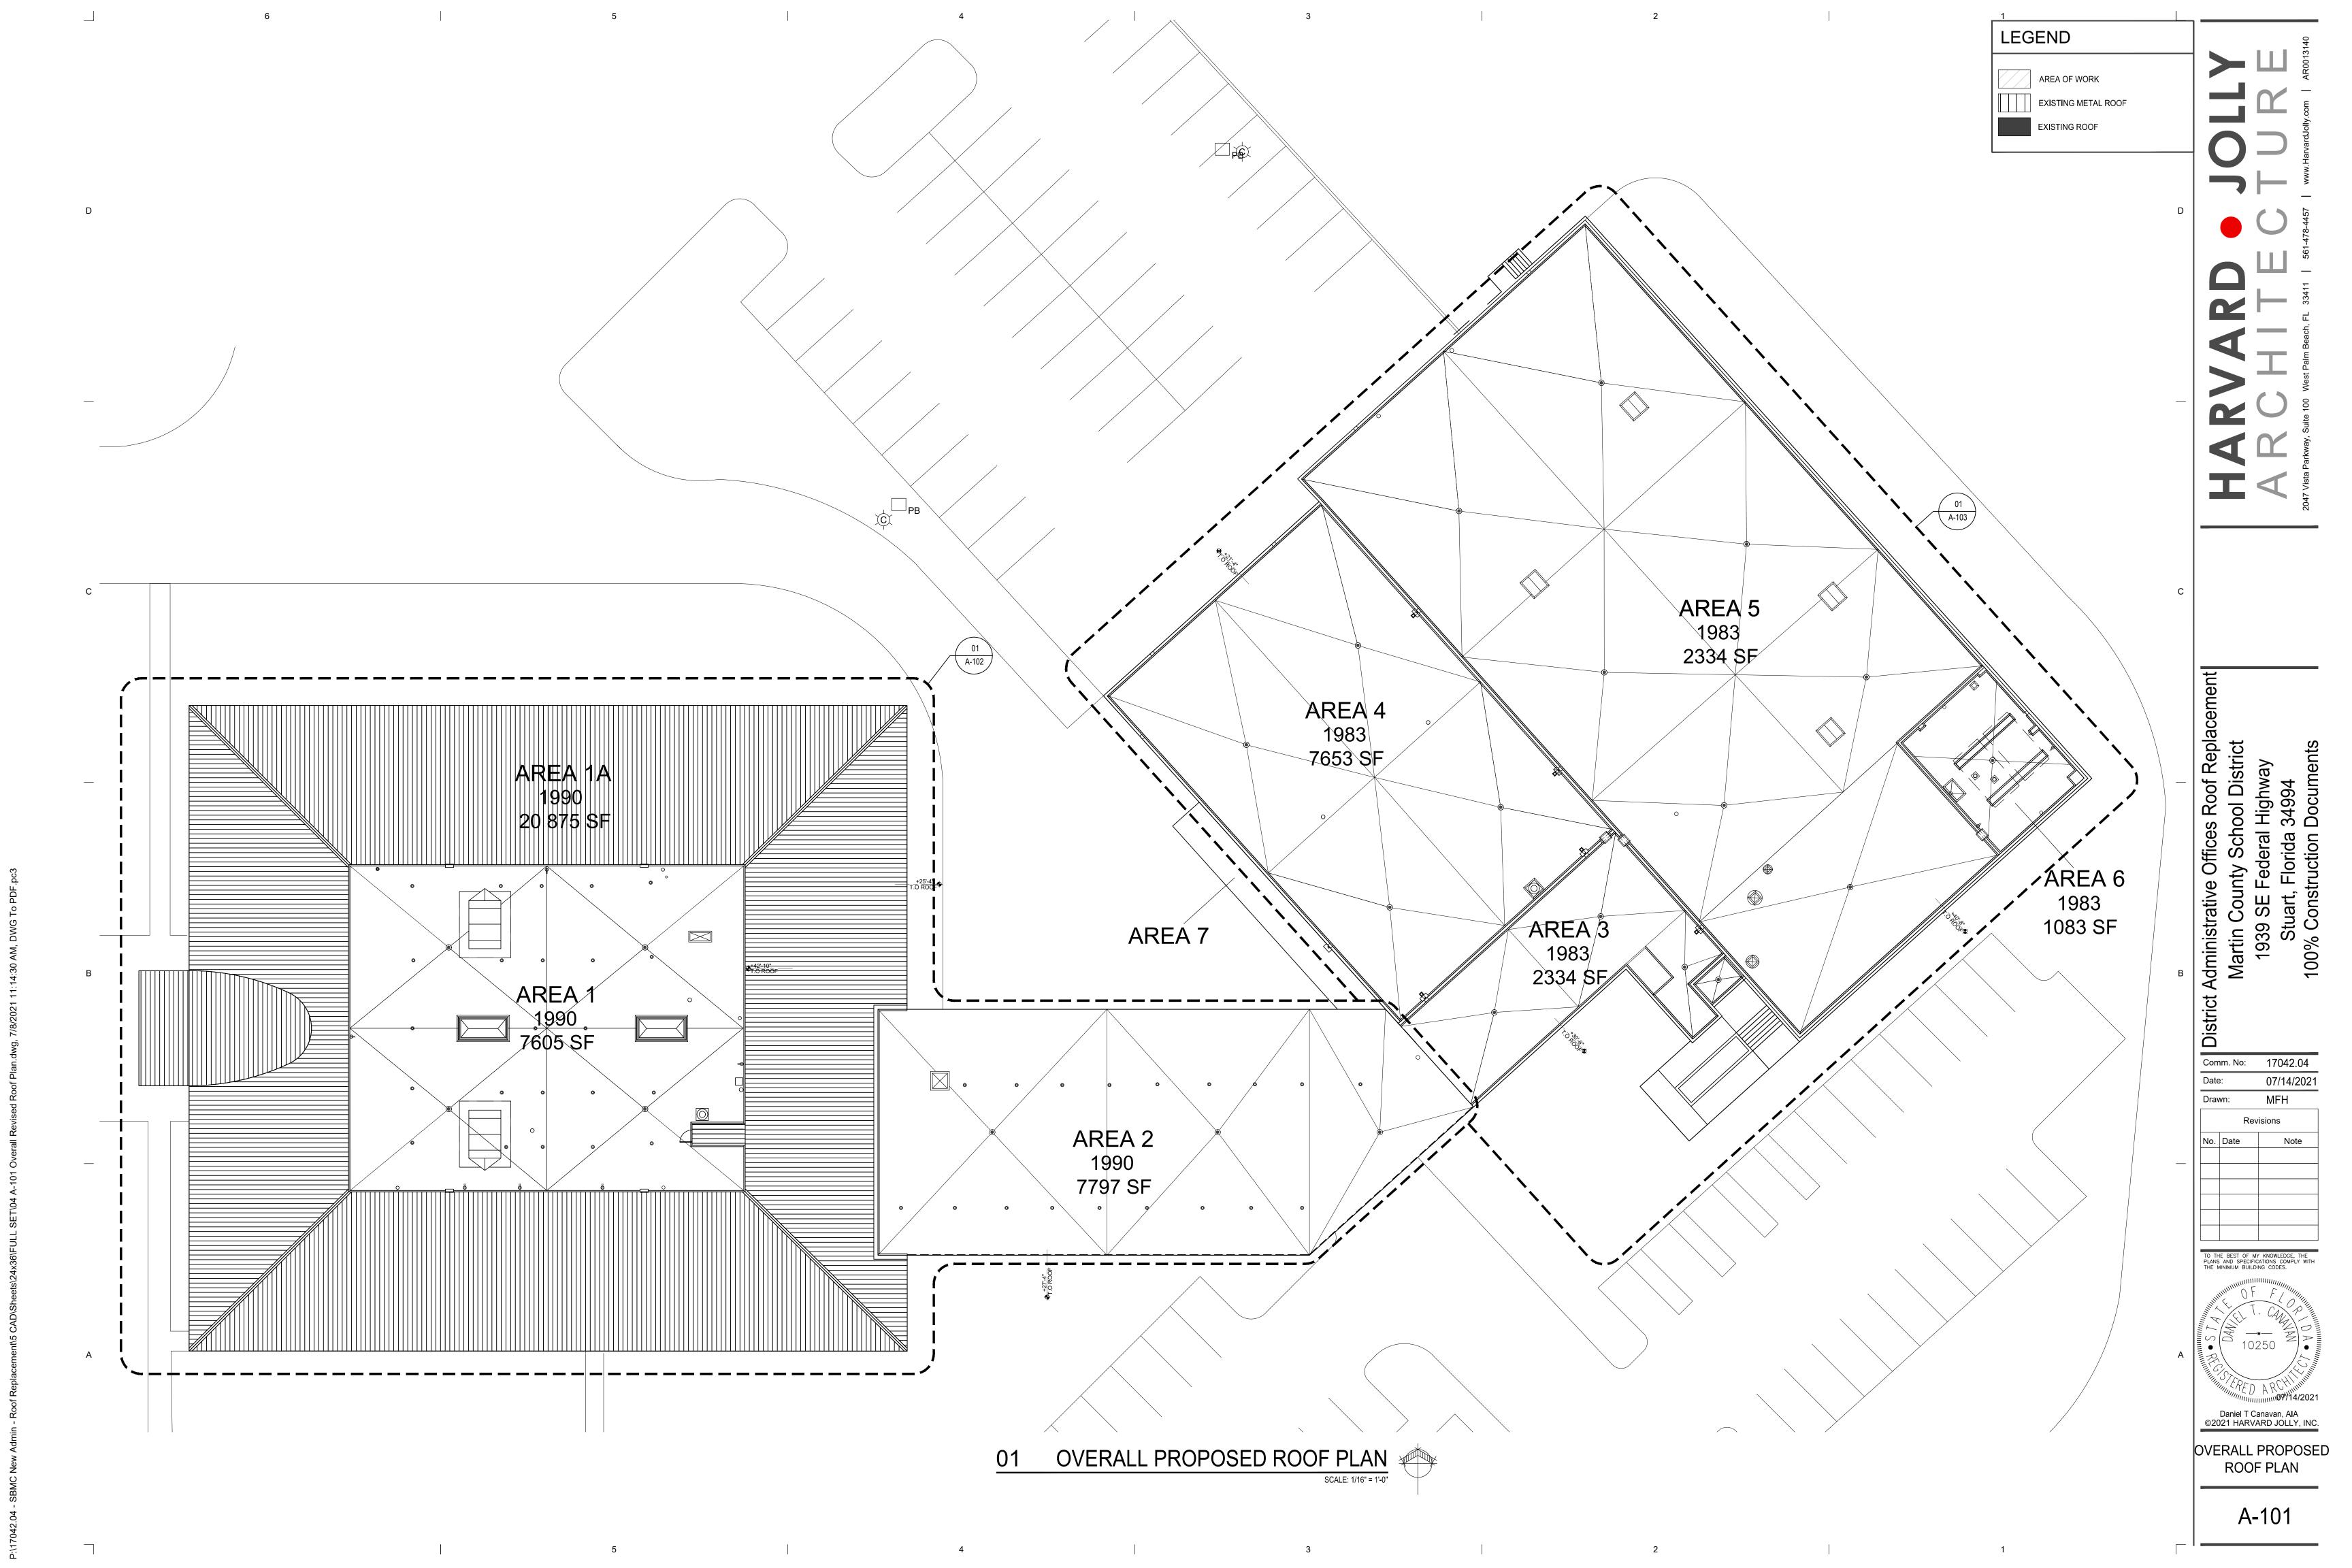
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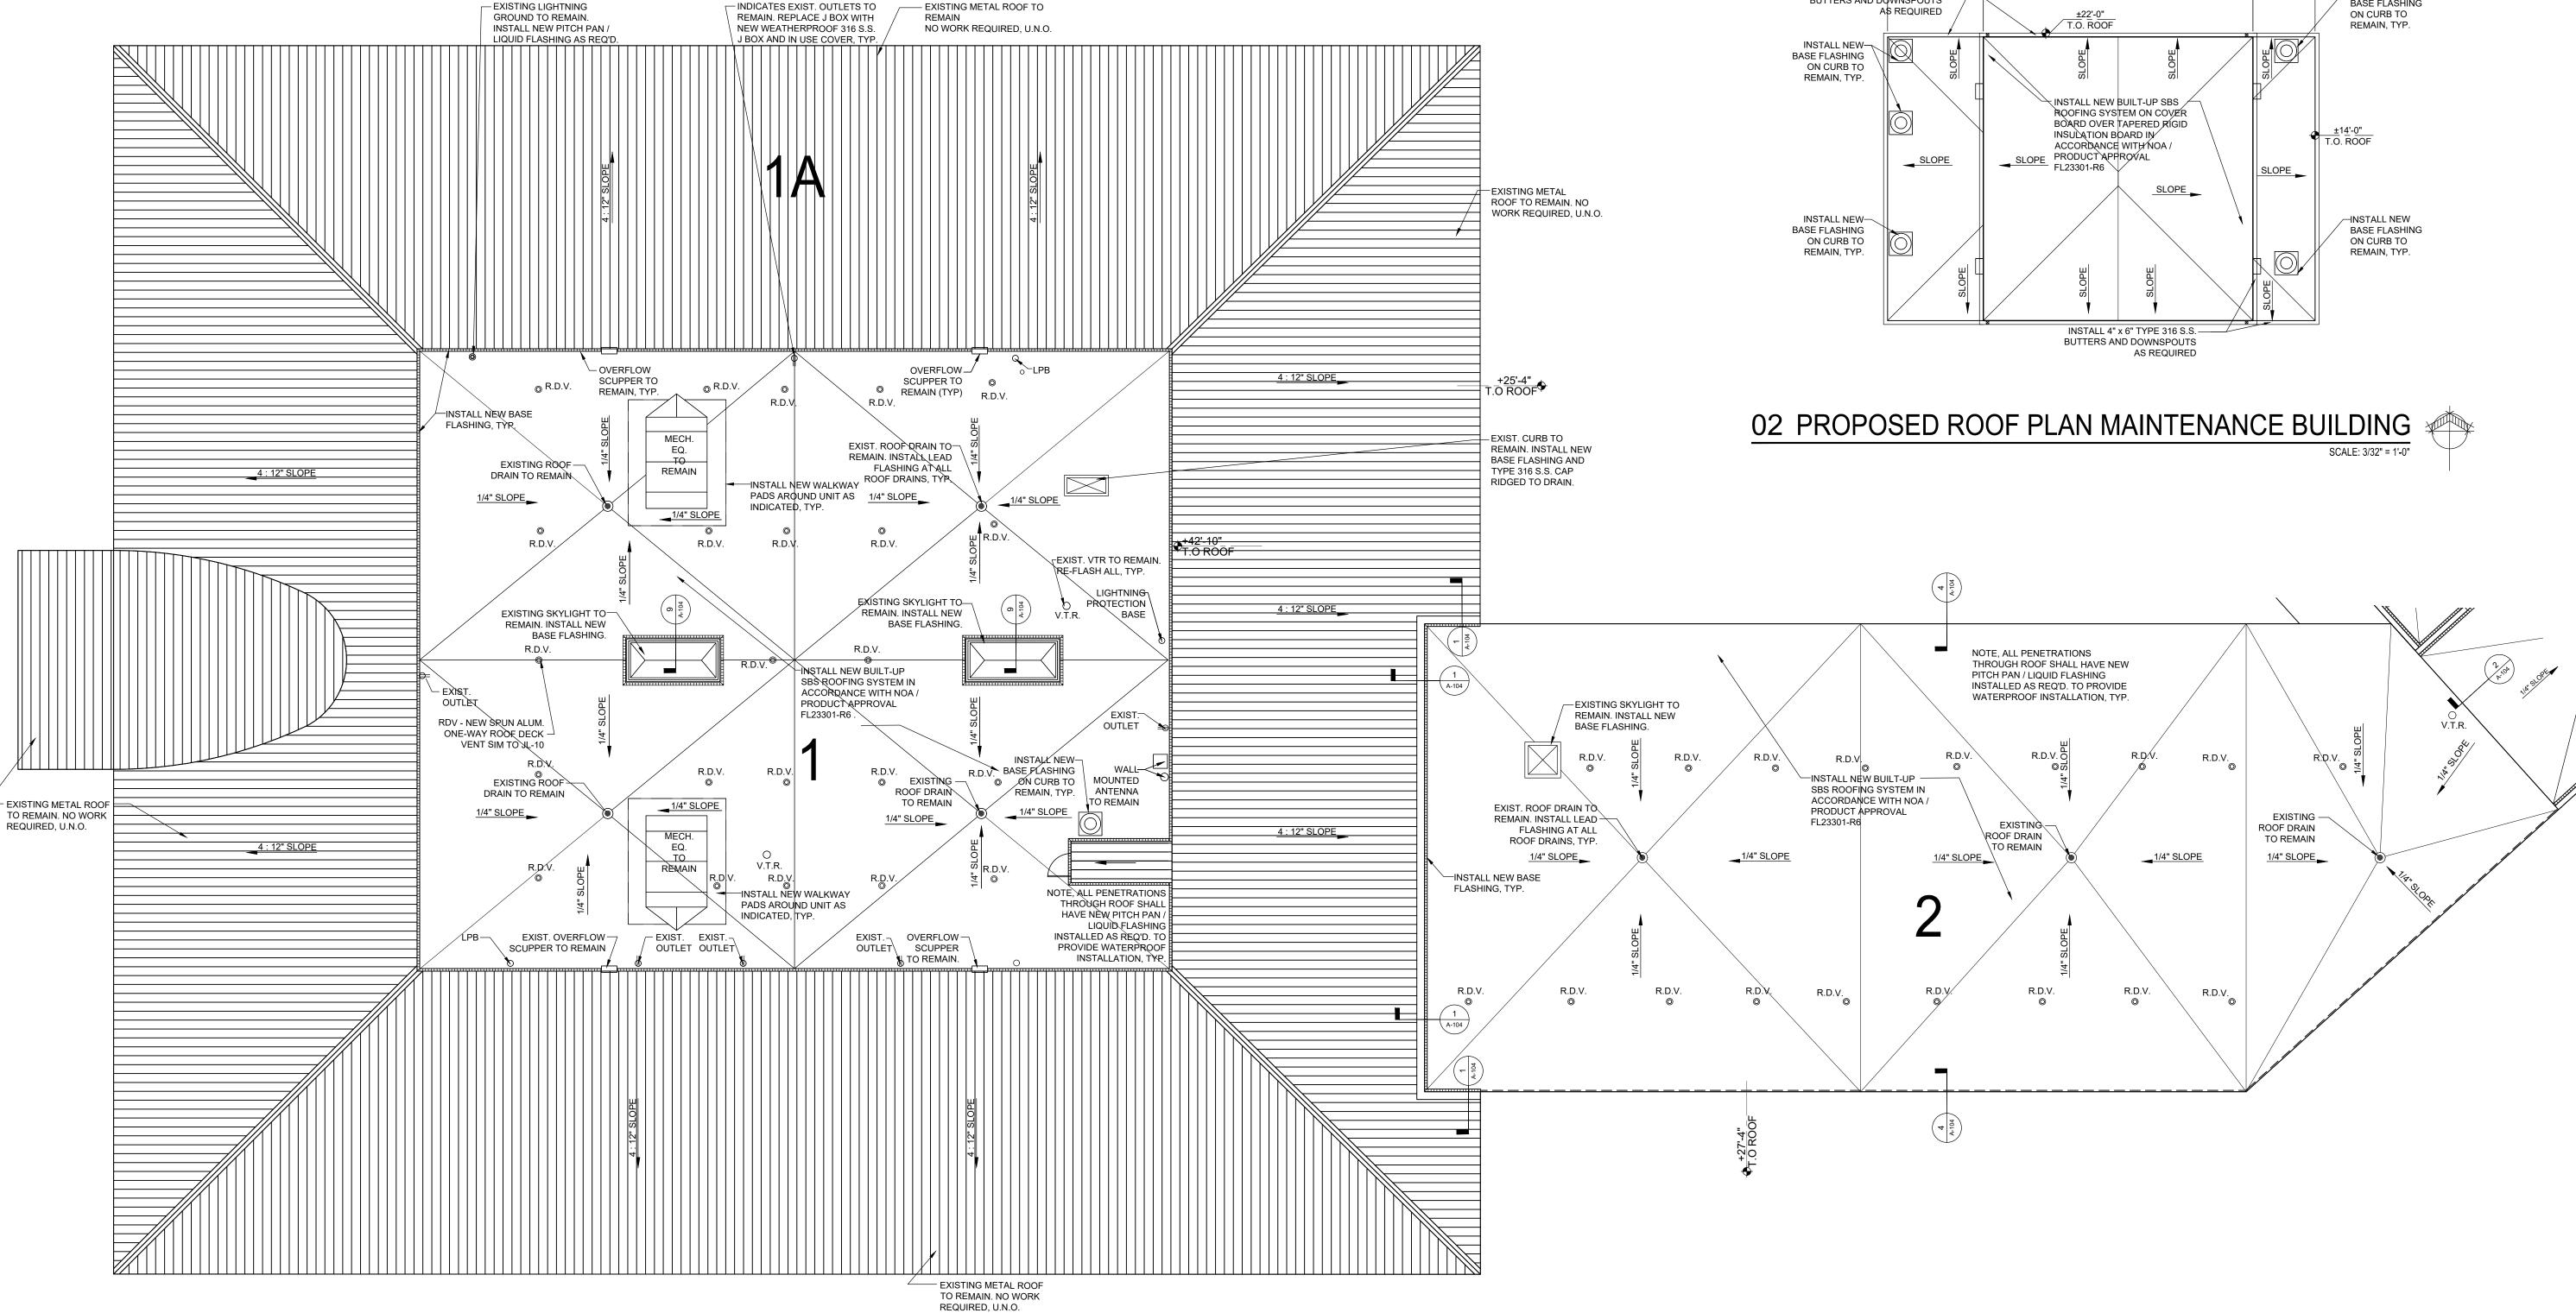
Roof Replacement of District

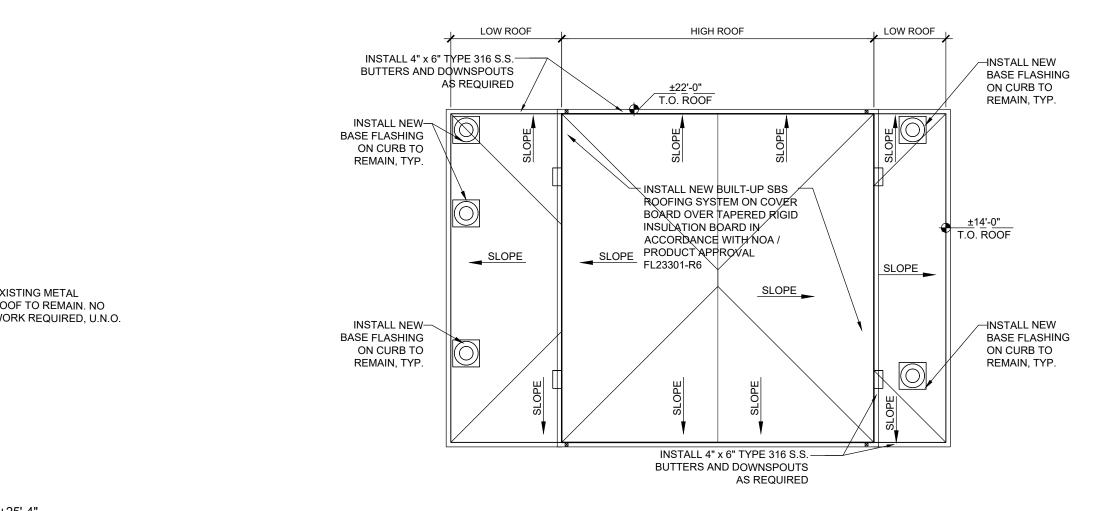Daniel T Canavan, AIA

PARTIAL PROPOSED **ROOF PLAN**

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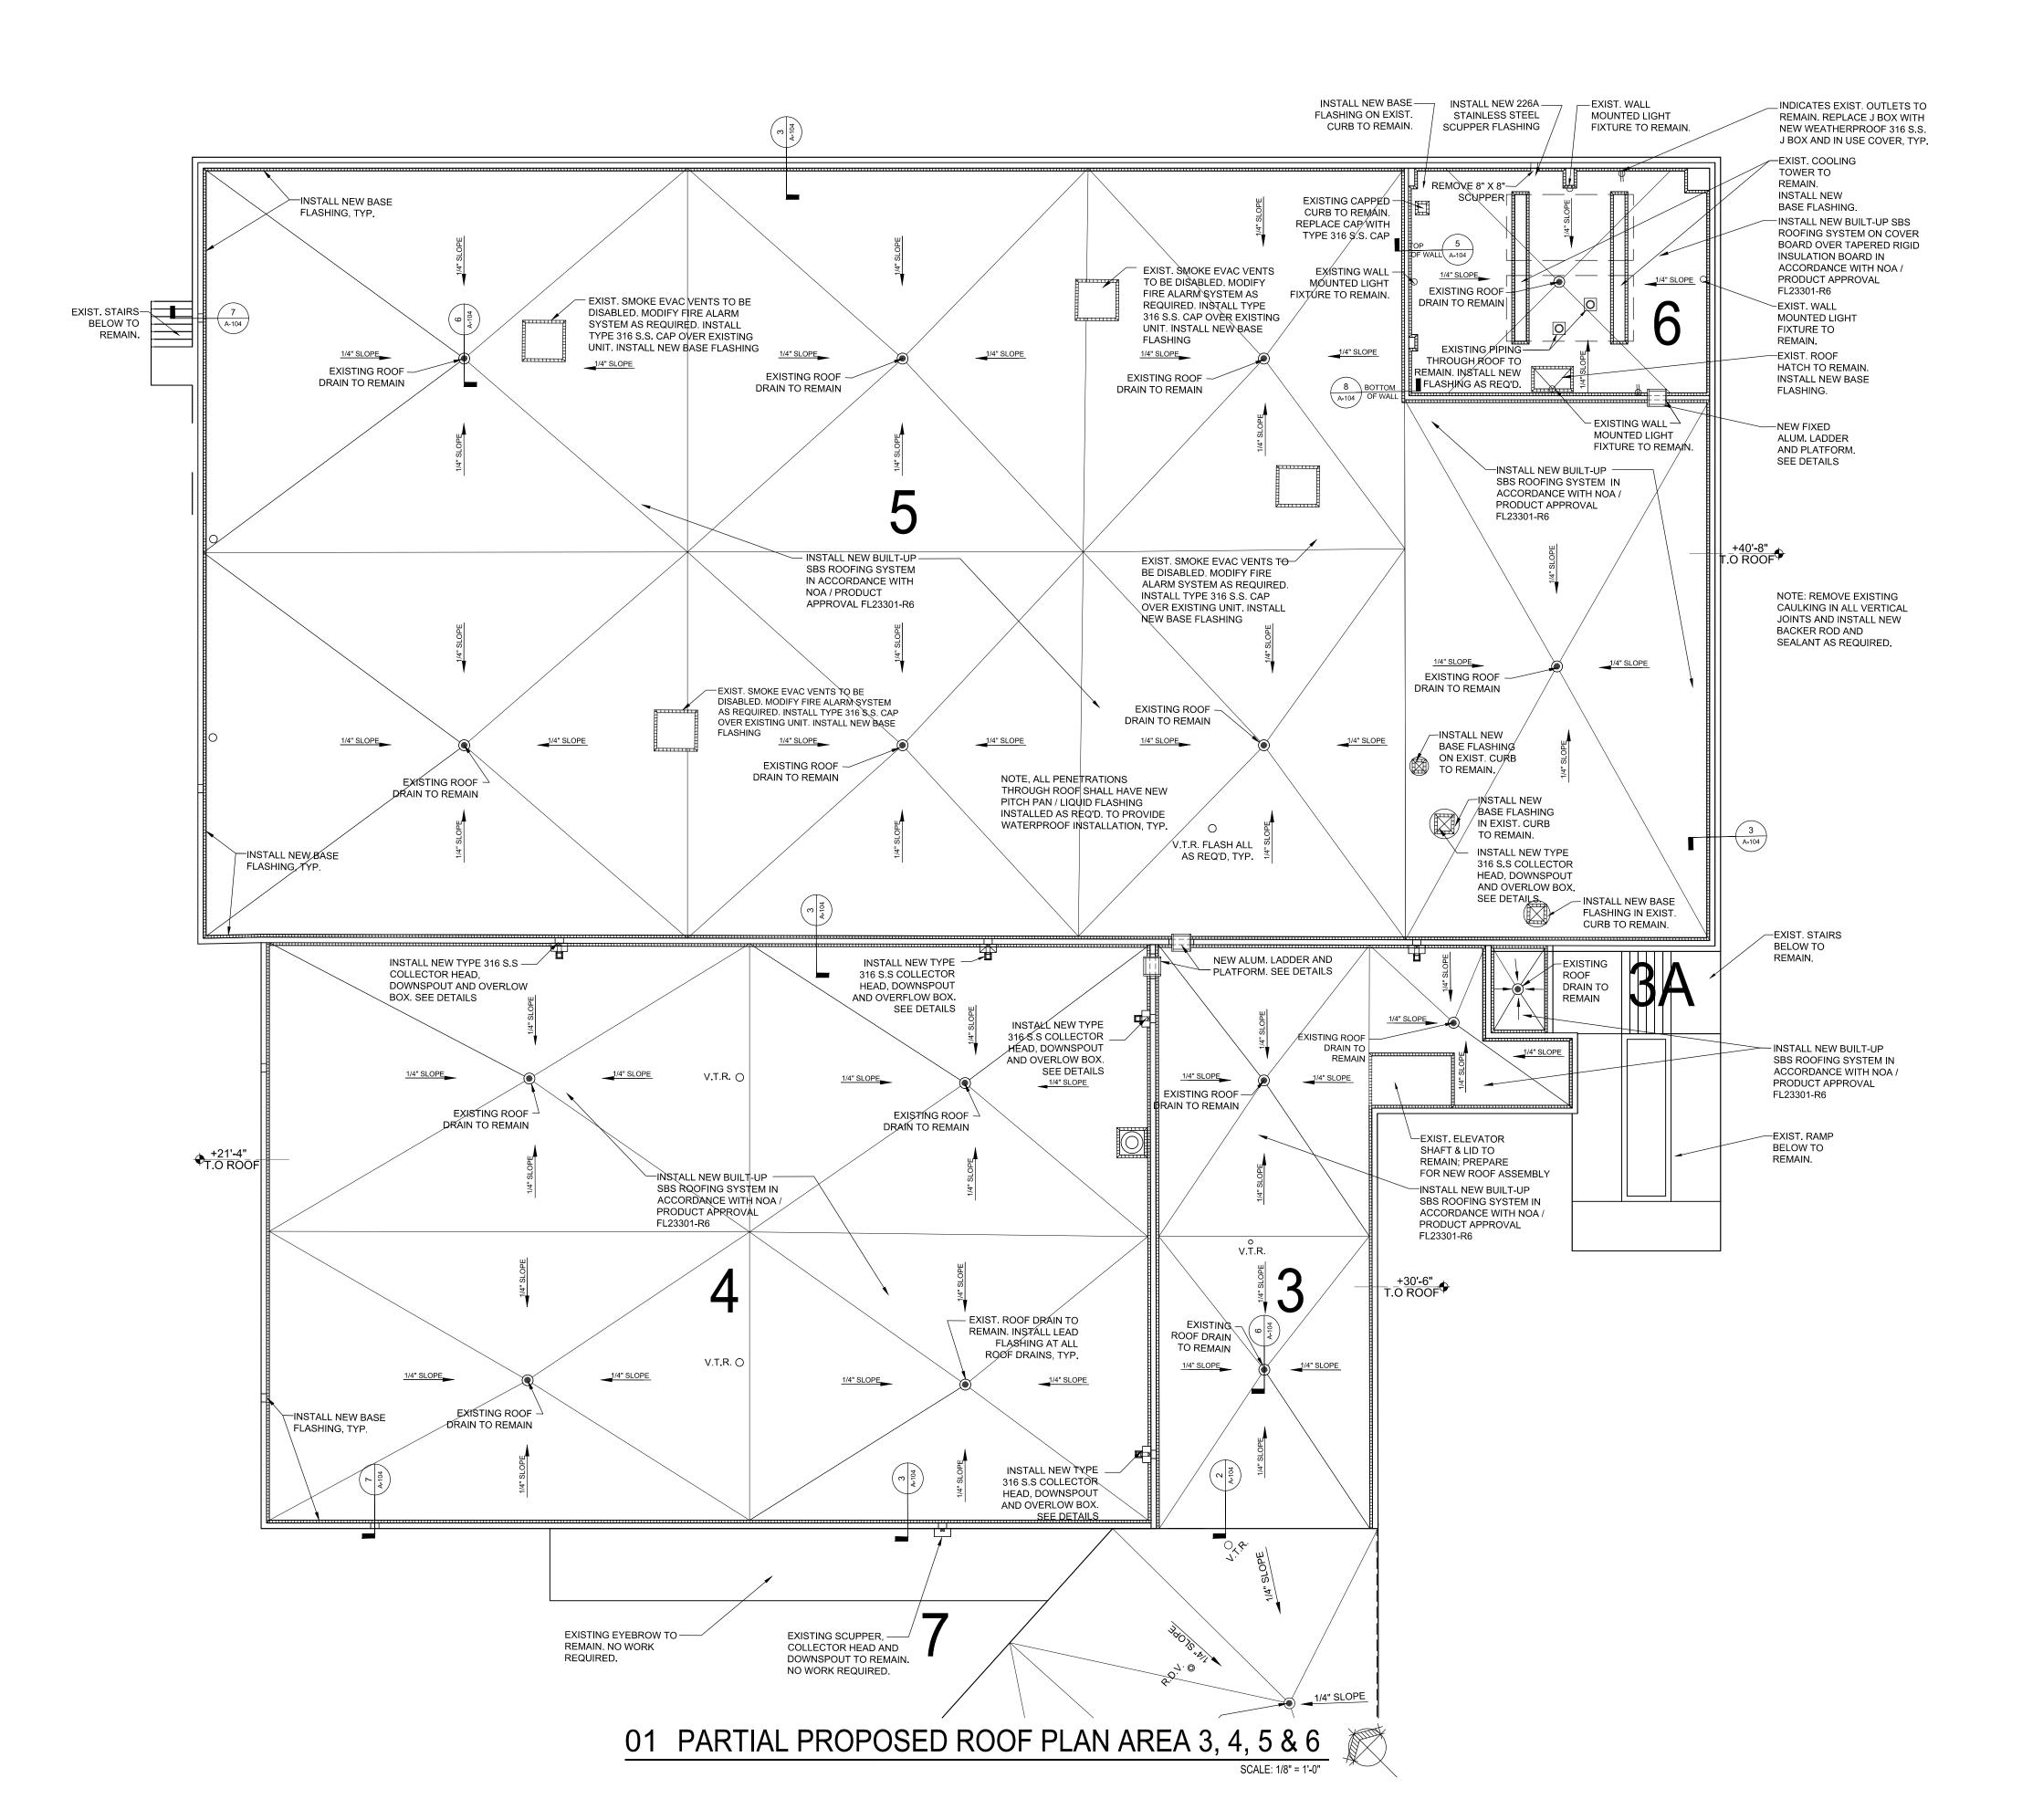
MINIMUM SLOPE OF 1/4" PER FOOT.


EMPTYING ON GRADE AS REQUIRED.

CONTRACTOR SHALL PROVIDE NEW PRECAST CONCRETE SPLASH BLOCKS AT ALL DOWNSPOUTS

O R.D.V. EXISTING ROOF DECK VENT

01 PARTIAL PROPOSED ROOF PLAN AREA 1, 1A & 2



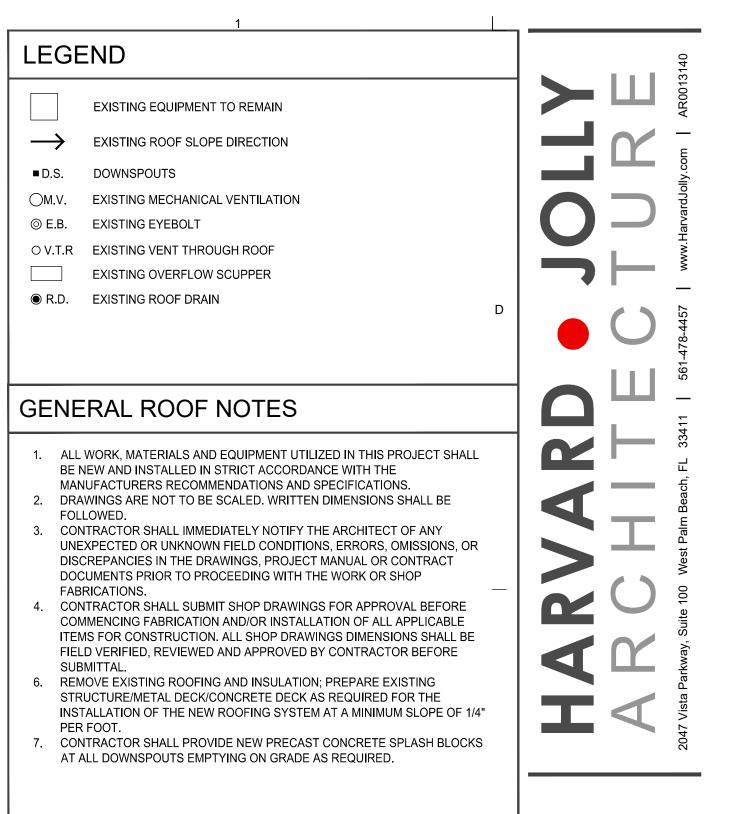

GENERAL NOTES

IDENTIFYING CLOTHING.

- 1. DEMOLITION NOTES REFER TO DEMOLITION NOTES FOR SPECIFIC DEMOLITION REQUIREMENTS. SPECIFIC DEMOLITION ITEMS ARE NOT TO BE CONSIDERED ALL INCLUSIVE OR COMPLETE IN THEMSELVES. PERFORM ADDITIONAL DEMOLITION THAT MIGHT REASONABLY BE REQUIRED FOR THE PREPARATION OF INSTALLATION OF NEW CONSTRUCTION OR SPECIFIED FINISHES. DEMOLITION SHALL BE PERFORMED IN A MANNER THAT WILL NOT DAMAGE ADJOINING SURFACES INDICATED TO REMAIN. SURFACES SHALL BE PATCHED IF NECESSARY TO PROVIDE A SUITABLE SUBSTRATE FOR NEW FINISHES.
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Revisions No. Date

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PARTIAL PROPOSED **ROOF PLAN**



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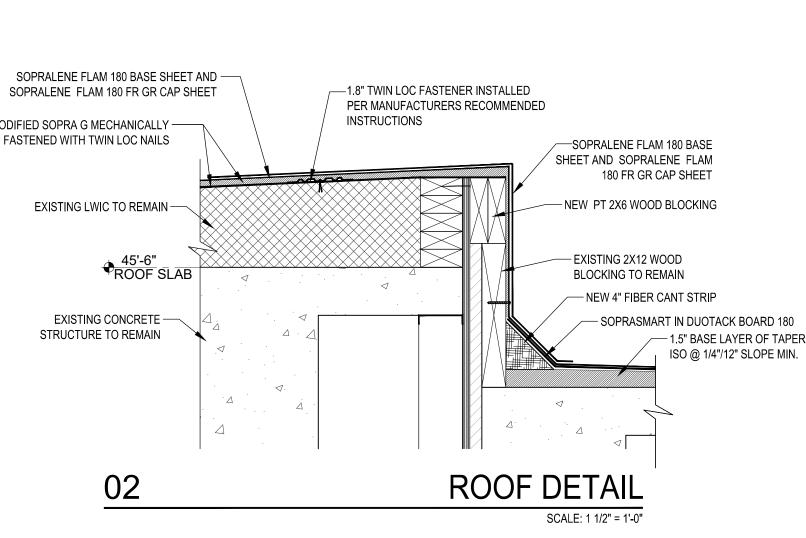
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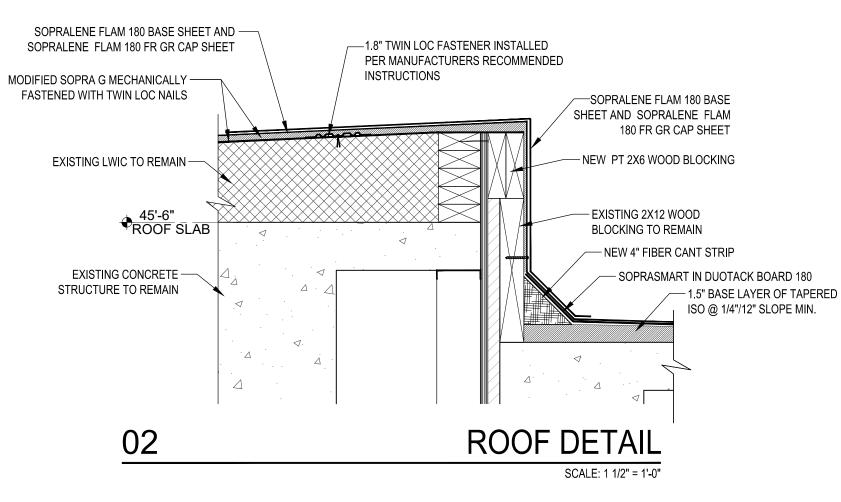
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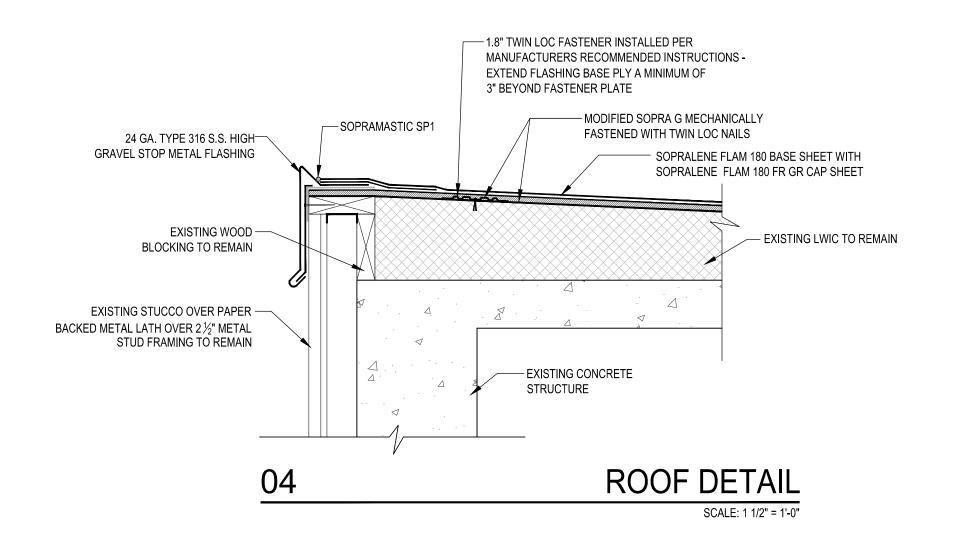
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ROOF **DETAILS**

A-104







ALSAN RS METAL PRIMER —

EXISTING STANDING SEAM —

MTL. ROOF TO REMAIN

EXISTING WOOD BLKG. TO REMAIN

TO REMAIN

EXISTING CONCRETE — STRUCTURE TO REMAIN

EXISTING FILLER

MATERIAL TO REMAIN

46'-4" ROOF SLAB

EXISTING 2" COMPRESSIBLE FILLER -

- ALSAN RS230, FLEECE 230

- ALSAN RS PASTE

FASTENED WITH NAILS

- NEW 4" FIBER

CANT STRIP

- MODIFIED SOPRA G MECHANICALLY

— ALSAN RS 222PRIMER

- LINE OF EXISTING

INSTRUCTIONS

SOPRALENE FLAM 180 BASE SHEET WITH

SOPRALENE FLAM 180 FR GR CAP SHEET

-1.8" TWIN-LOC FASTENER INSTALLED

PER MANUFACTURERS RECOMMENDED

— EXISTING LWIC TO REMAIN

- EXISTING CONCRETE STRUCTURE TO REMAIN

— MODIFIED SOPRA G MECHÂÑICALLY

FASTENED WITH TWIN LOC NAILS

ROOF DETAIL

ROOF BEYOND

EXISTING STANDING SEAM — METAL ROOF TO REMAIN


— ALSAN RS METAL PRIMER


REMOVE 6" OF THE EXISTING STANDING SEAM MTL. ROOF


AND PREPARE THE AREA FOR THE ALSAN RS 222 PRIMER


FRONT VIEW METAL ROOF

ALSAN RS PASTE —

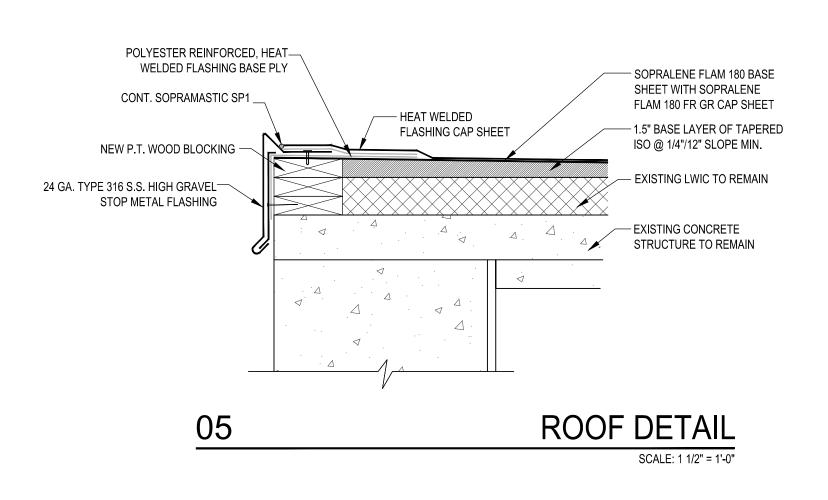

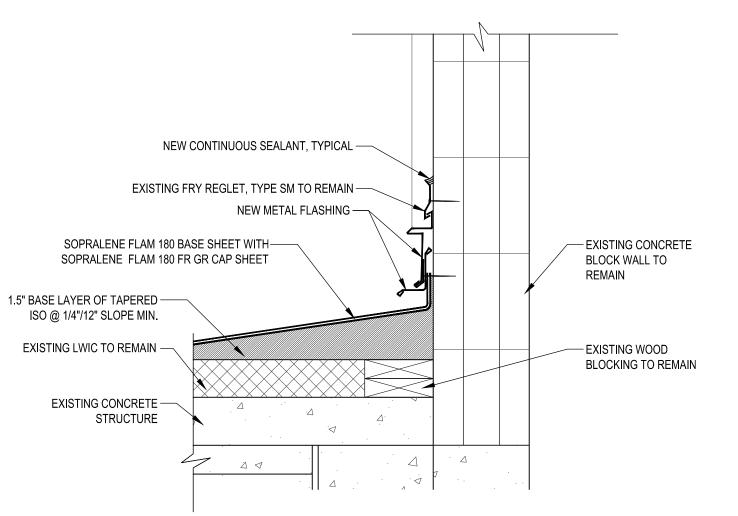

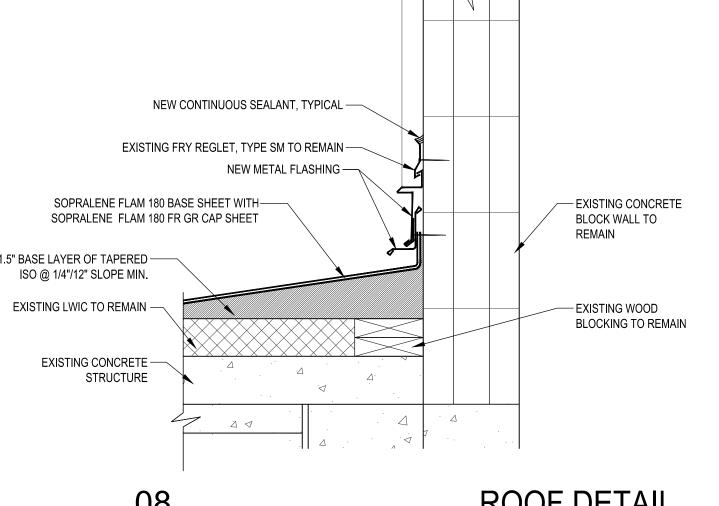

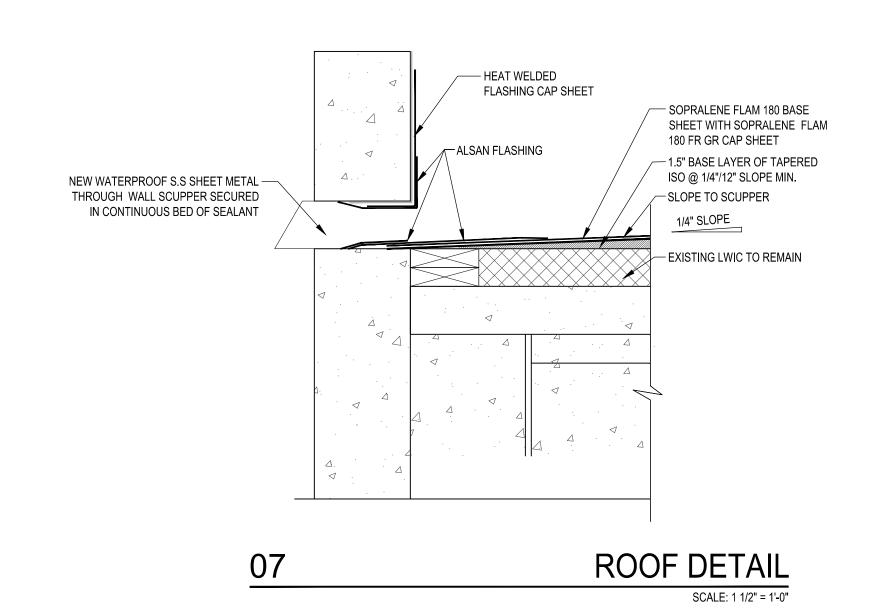

— SOPRAMASTIC SP1, CONTINUOUS -DRIVE PIN -NEW FRY REGLET, TYPE SM - NEW 4" FIBER EXISTING 2X12 WOOD -CANT STRIP BLOCKING TO REMAIN

EXISTING SKYLIGHT TO REMAIN

REPLACE ALL EXISTING INTERNAL ROOF —

STRAINERS WITH CAST IRON DOMES, TYP.

EXISTING LWIC TO REMAIN -

ON TOP - 1.8" TWIN LOC FASTENER INSTALLED PER MANUFACTURERS RECOMMENDED INSTRUCTIONS - MODIFIED SOPRA G MECHANICALLY FASTENED WITH TWIN LOC NAILS - EXISTING LWIC TO REMAIN

SOPRALENE FALM 180 WITH SOPRALENE FALM 180 FR GR

- EXISTING CONCRETE STRUCTURE TO REMAIN

ROOF DETAIL SCALE: 1 1/2" = 1'-0"

FLASHING CAP SHEET & POLYESTER REINFORCED

FLASHING BASE PLY -SLOPE TO INSIDE FACE

— CONT. SOPRAMASTIC SP1

/— NEW FRY REGLET, TYPE SM

SOPRALENE FLAM 180 BASE SHEET WITH

SOPRALENE FALM 180 FR GR CAP SHEET

— 1.5" BASE LAYER OF TAPERED

- EXISTING CONCRETE

SOPRALENE FLAM 180 BASE SHEET WITH

SOPRALENE FLAM 180 FR GR CAP SHEET

FASTENED WITH TWIN LOC NAILS

- EXISTING LWIC TO REMAIN

- EXISTING CONCRETE STRUCTURE TO REMAIN

POLYESTER REINFORCED, HEAT

WELDED FLASHING BASE PLY

ROOF DETAIL

STRUCTURE

— EXISTING LWIC TO REMAIN

ISO @ 1/4"/12" SLOPE MIN.

OF WALL

AS REQUIRED

CONT. MIN. .040" ALUM. COPING W/ -

CONT. CLEAT SET IN BED OF MASTIC &

FULL BED OF SEALANT AT ALL JOINTS

CAULK PERIMETER WITH -


EXISTING WOOD BLOCKING TO REMAIN -

CONTINUOUS SEALANT

CONT. FIBEROUS CANT STRIP —


EXISTING PARAPET TO REMAIN -

ROOF DETAIL SCALE: 1 1/2" = 1'-0"

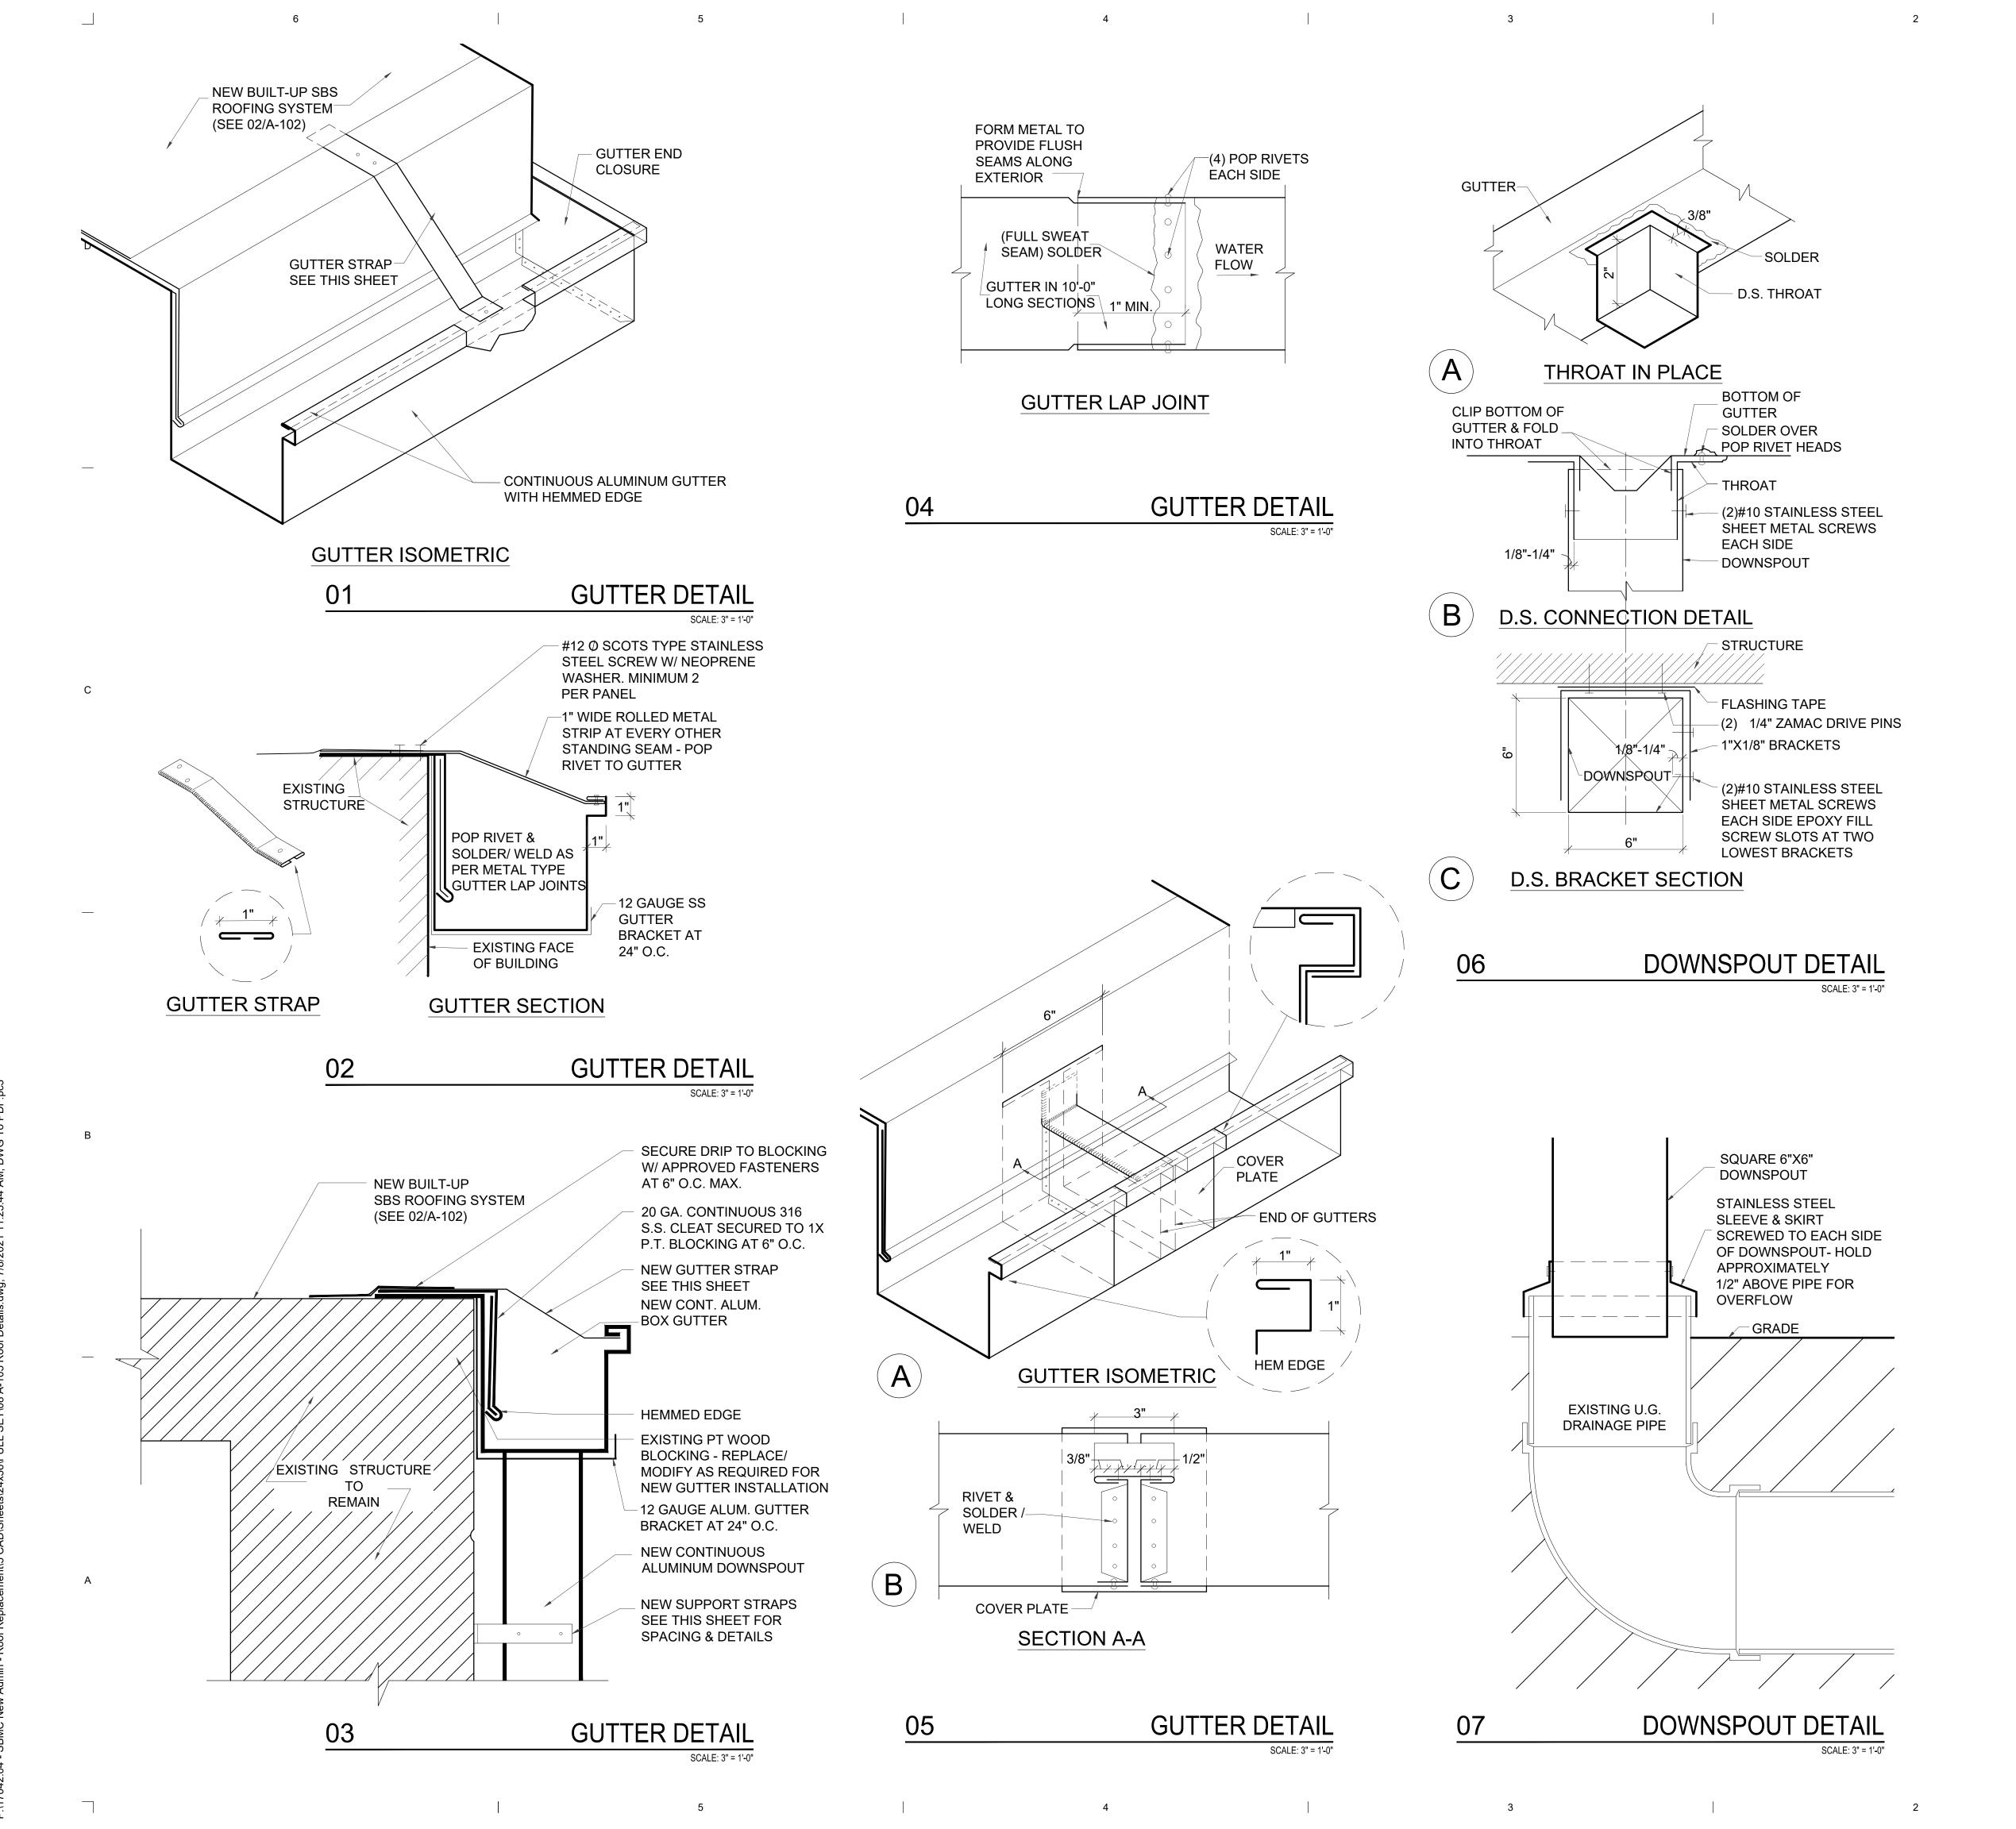

GENERAL NOTES:

- SOLDER/WELD (AS PER METAL TYPE) ALL LAPS & CORNER INSERT TO FORM ONE CONTINUOUS PIECE.
- 2. DIMENSIONS NOT SHOWN ARE TO BE FIELD VERIFIED.
- 3. CONTRACTOR SHALL PROVIDE NO DISSIMILAR MATERIALS IN THE REPLACEMENT OF THE GUTTERS AND DOWNSPOUTS; THIS INCLUDES FASTENERS, STRAPS, ETC.
- 4. CONTRACTOR SHALL PROVIDE AN ALLOWANCE FOR THE REPLACEMENT OF DETERIORATED FASCIA BOARD AS REQUIRED & DISCOVERED DURING THE REMOVAL OF THE EXISTING GUTTERS. FASCIA BOARD SHALL BE REPLACED WITH LIKE KIND.
- 5. PROVIDE NEW PRECAST CONCRETE SPLASH BLOCKS AT ALL DOWNSPOUTS EMPTYING ON GRADE.

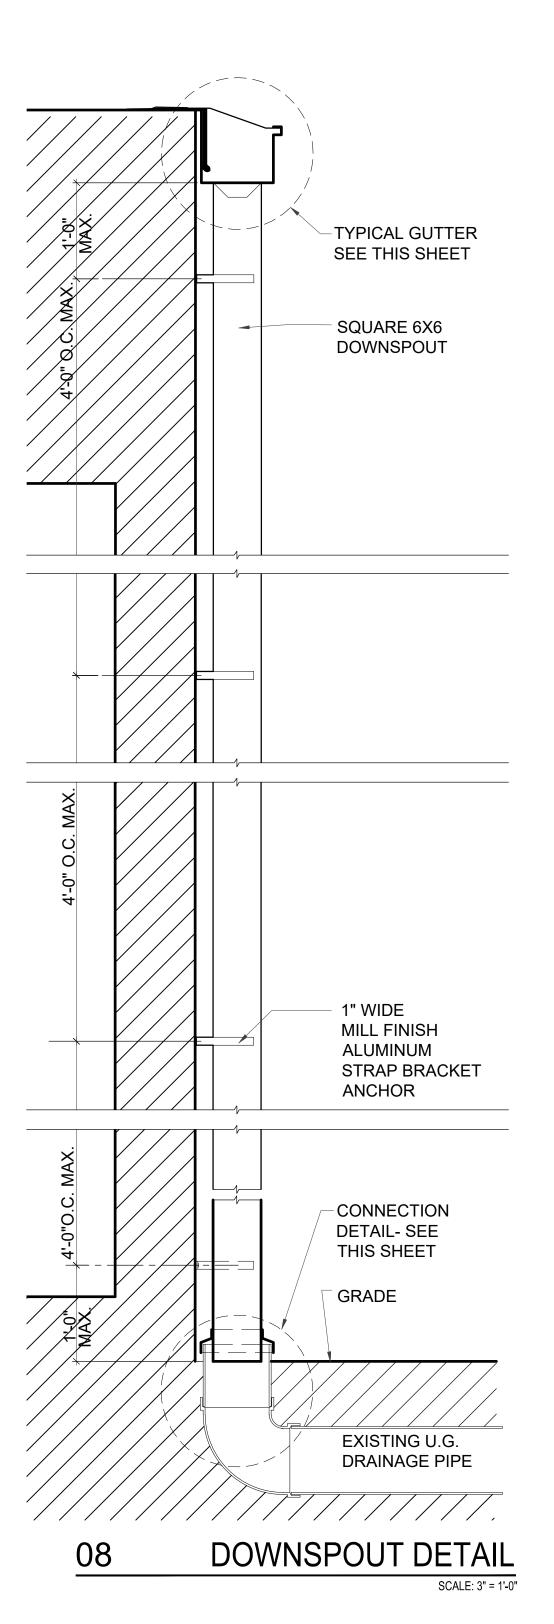

HARRAR PD - JOLL Y LAST VISTA PARVAL AND AROO PROPERTY Suite 100 West Palm Beach, FL 33411 | 561-478-4457 | www.HarvardJolly.com | AR00

rict Administrative Offices Roof Replace
Martin County School District
1939 SE Federal Highway
Stuart, Florida 34994
100% Construction Documents

Comm. No: 17042.04

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Drawn: MFH

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No. Date Note

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ROOF DETAILS

A-105