
# **COVINA-VALLEY UNIFIED SCHOOL DISTRICT** SOUTH HILLS HIGH SCHOOL RE-ROOFING PROJECT

#### **SYMBOLS**

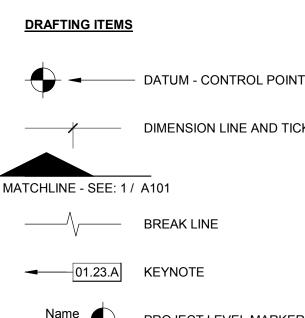

DIMENSION LINE AND TICK

BREAK LINE

Elevation 0

1 CMNT # REVISION TAG




PROJECT LEVEL MARKER

COLUMN GRID MARKER

REVISION CLOUD

PROJECT NORTH ARROW

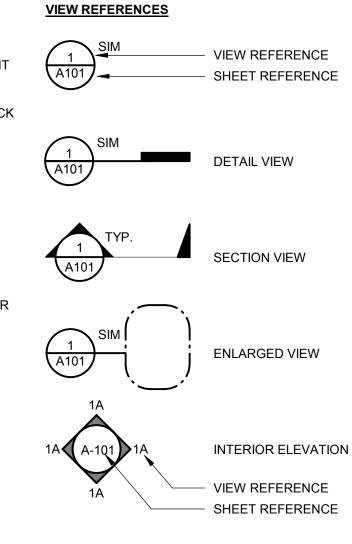

EXTERIOR ELEVATION

# (CCR)

- OR A CONSTRUCTION CHANGE DOCUMENT (CCD).
- THE DISTRICT BEFORE PROCEEDING WITH THE WORK. ANY DIFFERENCE BETWEEN THE EXISTING CONSTRUCTION AS OBSERVED IN THE FIELD AND
- WITH THE WORK. THE CONTRACTOR SHALL VERIFY ALL DIMENSIONS PRIOR TO STARTING WORK. THE DISTRIC
- RESPONSIBLE FOR CHECKING AND COORDINATING DIMENSIONS.
- APPLICABLE SAFETY LAWS ARE STRICTLY ENFORCED AND TO MAINTAIN A SAFE CONSTRUCTION PROJECT
- APPROVED PLANS AND SPECIFICATIONS. THE DISTRICT WILL PROVIDE ONLY PERIODIC OBSERVATION OF THE WORK.
- ADDITIONAL COST TO THE OWNER.
- WELDING SHALL BE SPECIALLY INSPECTED BY AN AWS-CWI QUALIFIED INSPECTOR. ALL CONTRACTOR AND KEPT ON THE JOB AT ALL TIMES.
- 12. SHOULD ANY EXISTING CONDITIONS SUCH AS DETERIORATION OR NON COMPLYING REPAIR WORK.
- CONDUCT ALL THE REQUIRED TESTS AND INSPECTIONS FOR THE PROJECT.
- 14. ALL WORK (AS APPLICABLE) MUST MEET THE MANDATORY MEASURES OF THE 2019 CALIFORNIA GREEN BUILDING STANDARDS (CAL GREEN) CODE (TITLE 24, PART II).
- 15. THE INTENT OF THESE DRAWINGS AND SPECIFICATIONS IS THAT THE WORK OF THE CONSTRUCTION CHANGE DOCUMENT (CCD), OR SEPARATE SET OF PLANS AND TITLE 24, CCR).
- FIRE CODE CHAPTER 33.
- AND/OR PERSONNEL.
- WORK INCLUDING BUT NOT LIMITED TO WATER AND POWER.

<u>ABBR</u>	EVIATIONS		
@	AT		
@ Ф Ч	CENTER LINE	ID	INSIDE DIAMETER
a 0#	PENNY POUND	INSUL INV	INSULATION OR INSULATED
$\bot$	PERPENDICULAR	LAV	LAVATORY
Ϋ́	ANGLE	MATL	MATERIAL
AB	ANCHOR BOLT	MAX	MAXIMUM
AC ACT	ASPHALTIC CONCRETE ACOUSTICAL CEILING TILE	MB MECH	MACHINE BOLT MECHANICAL
AFF	ABOVE FINISH FLOOR	MFR	MANUFACTURE OR MANUFACTURER
ALT	ALTERNATE	MH	MAN HOLE
ALUM ANOD	ALUMINUM ANODIZED	MIN MISC	MINIMUM MISCELLANEOUS
APPROX	APPROXIMATE	MO	MASONRY OPENING
ARCH	ARCHITECT OR ARCHITECTURAL	Ν	NORTH
BD BLDG	BOARD BUILDING	(N) NIC	NEW NOT IN CONTRACT
BLDG BLK(G)	BLOCK(ING)	NO OR #	NUMBER
BOB	BOTTOM OF BEAM	NTS	NOT TO SCALE
BM	BEAM	00	ON CENTER
CB CI	CATCH BASIN CAST IRON	OD OPNG	OUTSIDE DIAMETER OPENING
CJ	CONSTRUCTION JOINT	PL	PLATE OR PROPERTY LINE
CLG	CEILING	PLAM	PLASTIC LAMINATE
CLR		PLAS	PLASTER (NUMBER - SEE SPECS)
CMU CO	CONCRETE MASONRY UNIT CLEAN OUT	PLYWD PNT	PLYWOOD PAINT (NUMBER - SEE SPECS)
COL	COLUMN	PTDF	PRESSURE TREATED DOUGLAS FUR
CONC	CONCRETE	QT	QUARRY TILE
CONT CSK	CONTINUOUS COUNTERSINK	RD REF	ROOF DRAIN REFRIGERATOR
CW	COLD WATER	REINF	REINFORCE OR REINFORCING
	CHANNEL	RH	ROUND HEAD
DBL	DOUBLE	RM	ROOM
DEPT DET	DEPARTMENT DETAIL	RO RWD	ROUGH OPENING REDWOOD
DF		S	SOUTH
DIA	DIAMETER	SCH	SCHEDULE
DIAG DN	DIAGONAL DOWN	SD SHR	STORM DRAIN SHOWER
DN DS	DOWN	SHT	SHEET
DWG	DRAWING	SHTHG	SHEATHING
E	EAST	SIM	
(E) EB	EXISTING EXPANSION BOLT	SMACNA SPEC	THE ARCH SHEET METAL MANUAL SPECIFICATION
EJ	EXPANSION JOINT	SQ	SQUARE
ELEV	ELEVATION	SSTL	STAINLESS STEEL
ELEC EP	ELECTRIC(AL) EDGE OF PAVING	STD STL	STANDARD STEEL
EQ	EQUAL	SUSP	SUSPENDED
EQUIP	EQUIPMENT	SYM	SYMMETRICAL
FD		TOB	TOP OF BEAM
FE(C) FF	FIRE EXTINGUISHER (& CABINET) FINISHED FLOOR	TOC TCB	TOP OF CURB OR TOP OF CONCRETE TOP OF CATCH BASIN
FG	FINISHED GRADE	TEL	TELEPHONE
FH	FLAT HEAD OR FIRE HYDRANT	TEMP	TEMPERATURE OR TEMPERED
FIN FL	FINISH FLOW LINE	T&G TP	TONGUE & GROOVE TOP OF PAVING
FLG	FLASHING	TS	STRUCTURAL TUBING
FLR	FLOOR	TV	TELEVISION
FOC FOF	FACE OF CONCRETE FACE OF FINISH	TOW	TOP OF WALL
FOF	FACE OF MASONRY	TYP	TYPICAL (ITEMS TYPICAL UNLESS SHOWN OR NOTED OTHERWISE)
FOS	FACE OF STUD	UON	UNLESS OTHERWISE NOTED
FRP	FIBERGLASS REINFORCED PANEL	VCT	VINYL COMPOSITION TILE
FT FTG	FOOT OR FEET FOOTING	VERT VGDF	VERTICAL VERTICAL GRAIN DOUGLAS FIR
GA	GAUGE	VTR	VENT THRU ROOF
GALV	GALVANIZED	W	WEST
GB GL	GRAB BAR, GRADE BREAK GLASS	WC W.C.	WATER CLOSET WHEELCHAIR ACCESSIBLE
GLB	GLUE LAMINATED BEAM	WD	WOOD
GYP	GYPSUM	WF	WIDE FLANGE
GWB	GYPSUM WALL BOARD	WH	WATER HEATER
HB HDR	HOSE BIBB HEADER	WP WS	WATERPROOF WOOD SCREW
HGT	HEIGHT	WSCT	WAINSCOT
HORIZ	HORIZONTAL	WWF	WELDED WIRE FABRIC
HTR		W/	WITH
HVAC	HEATING/VENTILATING/AIR	W/O	WITHOUT

CONDITIONING

#### **GENERAL PROJECT NOTES - K12**

ALL WORK SHALL CONFORM TO 2019 EDITION TITLE 24 CALIFORNIA CODE OF REGULATIONS

CHANGES TO APPROVED DRAWINGS AND SPECIFICATIONS SHALL BE MADE BY AN ADDENDUM

A CERTIFIED INSPECTOR WITH SHALL BE EMPLOYED BY THE DISTRICT AND SHALL PROVIDE CONTINUOUS INSPECTION OF THE WORK. THE DUTIES OF THE INSPECTION ARE DEFINED IN SECTION 4-342, PART 1, T24, CCR. THE PROJECT INSPECTOR SHALL BE CERTIFIED TO

APPARENT DISCREPANCIES ON DRAWINGS AND/OR SPECIFICATIONS SHALL BE REPORTED TO

AS SHOWN ON THE DRAWING SHALL BE REPORTED TO THE DISTRICT BEFORE PROCEEDING

SHALL BE NOTIFIED OF ANY DISCREPANCIES OR INCONSISTENCIES. THE CONTRACTOR IS

IT SHALL BE THE RESPONSIBILITY OF THE GENERAL CONTRACTOR TO ENSURE THAT ALL

IT SHALL BE THE RESPONSIBILITY OF THE GENERAL CONTRACTOR TO PROVIDE SUPERVISION OF THE CONSTRUCTION WORK TO ENSURE THAT IT IS BUILT IN CONFORMANCE WITH THE

ANY DAMAGE DONE TO THE EXISTING CONSTRUCTION DURING THE COURSE OF THIS WORK SHALL BE REPLACED BY THE CONTRACTOR AT THE CONTRACTOR'S EXPENSE WITH NO

ENVIRONMENTAL HEALTH CONSIDERATIONS SHALL COMPLY WITH ALL LOCAL ORDINANCES 11. CUTTING, BORING, SAWCUTTING OR DRILLING THROUGH THE NEW OR EXISTING STRUCTURAL ELEMENTS TO BE DONE ONLY WITH THE APPROVAL OF DISTRICT REPRESENTATIVE. ALL

BRACING OF DUCTS AND PIPING SHALL BE INSTALLED IN ACCORDANCE WITH SMACNA GUIDELINES. WHERE BRACING DETAILS ARE NOT SHOWN ON THE DRAWINGS OR IN THE GUIDELINES, THE FIELD INSTALLATION SHALL BE SUBJECT TO THE APPROVAL OF THE DISTRICT, MECHANICAL ENGINEER AND FIELD ENGINEER HIRED BY THE DISTRICT WHEN NEEDED. A COPY OF THE GUIDELINES PUBLISHED BY SMACNA SHALL BE PROVIDED BY THE

CONSTRUCTION BE DISCOVERED WHICH IS NOT COVERED BY THE APPROVED DOCUMENTS WHEREIN THE FINISHED WORK WILL NOT COMPLY WITH TITLE 24, C.C.R., OR SEPARATE SET OF PLANS AND SPECIFICATIONS, DETAILING AND SPECIFYING THE REQUIRED REPAIR WORK SHALL BE SUBMITTED TO AND APPROVED BY DISTRICT BEFORE PROCEEDING WITH THE

13. AN ACCEPTED TESTING LABORATORY DIRECTLY EMPLOYED BY THE SCHOOL DISTRICT SHALL

ALTERATION, REHABILITATION OR RECONSTRUCTION IS TO BE IN ACCORDANCE WITH THE TITLE 24 CCR. SHOULD ANY EXISTING CONDITIONS SUCH AS DETERIORATION OR NON-COMPLING CONSTRUCTION TO BE DISCOVERED WHICH IS NOT COVERED BY THE CONTRACT DOCUMENTS WHEREIN THE THE FINISH WORK WILL NOT COMPLY WITH TITLE 24, CCR, A SPECIFICATIONS, DETAILING AND SPECIFYING THE REQUIRED WORK SHALL BE SUBMITTED TO AND APPROVED BY DSA BEFORE PROCEEDING WITH THE WORK. (SECTION 4-317(C), PART 1,

16. FIRE SAFETY DURING CONSTRUCTION AND DEMOLITION TO COMPLY WITH 2019 CALIFORNIA

17. CONTRACTOR OPERATIONS SHALL NOT BLOCK, HINDER, IMPEDE OR OTHERWISE INHIBIT THE USE OF REQUIRED EXITS AT ANY TIME. CONTRACTOR SHALL MAINTAIN UNOBSTRUCTED ACCESS TO FIRE EXTINGUISHERS. FIRE HYDRANTS. TEMPORARY FIRE PROTECTION FACILITIES, STAIRWAYS, AND OTHER ACCESS ROUTES FOR FIRE-FIGTHING EQUIPMENT

18. CONTRACTOR TO PROVIDE ALL UTILITIES NECESSARY TO CARRY OUT THE SITE SPECIFIC

	DESCR	DT	
FNU.	DEJUNI		

PROVIDE ALL LABOR, MATERIALS, AND EQUIPMENT AS REQUIRED TO INSTALL NEW REPLACEMENT ROOFING TO EXISTING BUILDINGS. INCLUDING, BUT NOT LIMITED TO ALL LABOR, MATERIALS, AND EQUIPMENT AS REQUIRED FOR DEMOLITION (IF NECESSARY) AND REMOVAL OF EXISTING ROOFING AND EXISTING ROOFING STRUCTURE AS NOTED IN DRAWINGS AND RELATED EQUIPMENT. AS NDICATED ON THESE DRAWINGS AND SPECIFICATIONS.

SCOPE BUILDING 'ADMIN' ROOFS: COMPLETELY REMOVE & REPLACE XISTING ROOFING SYSTEM WITH NEW 20-YEAR BUILT-UP ROOFING SYSTEM. ADD GUTTER & DOWNSPOL SYSTEM. SEAL ALL PIPE AND VENT PENETRATIONS. SCOPE BUILDING 'GYM ADDITION' ROOF: INSTALL 10 YEAR ROOF RESTORATION SYSTEM

DEFERRED APPROVALS

NONE.

#### **APPLICABLE CODES & STANDARDS**

PARTIAL LIST OF APPLICABLE CODES AS OF JANUARY 1, 2020\* 2019 CALIFORNIA ADMINISTRATIVE CODE (CAC), PART 1, TITLE 24 CCR\*

2019 CALIFORNIA BUILDING CODE (CBC), PART 2, TITLE 24 CCR (2018 INTERNATIONAL BUILDING CODE, VOL. 1 & 2, AND 2019 CALIFORNIA AMENDMENTS) 2019 CALIFORNIA ELECTRICAL CODE (CEC), PART 3, TITLE 24 CCR

(2017 NATIONAL ELECTRICAL CODE AND 2019 CALIFORNIA AMENDMENTS) 2019 CALIFORNIA MECHANICAL CODE (CMC), PART 4, TITLE 24 CCR

(2018 IAPMO UNIFORM MECHANICAL CODE AND 2019 CALIFORNIA AMENDMENTS) 2019 CALIFORNIA PLUMBING CODE (CPC), PART 5, TITLE 24 CCR (2018 IAPMO UNIFORM PLUMBING CODE AND 2019 CALIFORNIA AMENDMENTS)

2019 CALIFORNIA ENERGY CODE (CEC), PART 6, TITLE 24 CCR 2019 CALIFORNIA FIRE CODE (CFC), PART 9, TITLE 24 CCR

(2018 INTERNATIONAL FIRE CODE AND 2019 CALIFORNIA AMENDMENTS) 2019 CALIFORNIA EXISTING BUILDING CODE (CEBC), PART 10, TITLE 24 CCR (2018 INTERNATIONAL EXISTING BUILDING CODE AND 2019 CALIFORNIA AMENDMENTS)

2019 CALIFORNIA GREEN BUILDING STANDARDS CODE (CALGREEN), PART 11, TITLE 24 CCR 2019 CALIFORNIA REFERENCED STANDARDS CODE, PART 12, TITLE 24 CCR TITLE 19 CCR, PUBLIC SAFETY, STATE FIRE MARSHAL REGULATIONS 2016 ASME A17.1/CSA B44-13 SAFETY CODE FOR ELEVATORS AND ESCALATORS

(PER 2019 CBC PART 2 CH 35) NOTE: CAL/OSHA ELEVATOR UNIT ENFORCES CCR TITLE 8 AND USES THE 2004 ASME A17.1 BY ADOPTION

PARTIAL LIST OF APPLICABLE STANDARDS NFPA 13 - STANDARD FOR THE INSTALLATION OF SPRINKLER SYSTEMS

(CA AMENDED 2016 EDITION) NFPA 14 - STANDARD FOR THE INSTALLATION OF STANDPIPE AND HOSE SYSTEMS

(CA AMENDED 2016 EDITION) NFPA 17 - STANDARD FOR DRY CHEMICAL EXTINGUISHING SYSTEMS (2017 EDITION) NFPA 17A - STANDARD FOR WET CHEMICAL EXTINGUISHING SYSTEMS (2017 EDITION) NFPA 20 - STANDARD FOR THE INSTALLATION OF STATIONARY PUMPS FOR FIRE PROTECTION (2016 EDITION)

NFPA 22 - STANDARD FOR WATER TANKS FOR PRIVATE FIRE PROTECTION (2013 EDITION) NFPA 24 - STANDARD FOR THE INSTALLATION OF PRIVATE FIRE SERVICE MAINS AND THEIR APPURTENANCES (CA AMENDED 2016 EDITION)

NFPA 72 - NATIONAL FIRE ALARM AND SIGNALING CODE (CA AMENDED 2016 EDITION) NFPA 80 - STANDARD FOR FIRE DOORS AND OTHER OPENING PROTECTIVES (2016 EDITION)

NFPA 2001 - STANDARD ON CLEAN AGENT FIRE EXTINGUISHING SYSTEMS (CA AMENDED 2015 EDITION) UL 300 - STANDARD FOR FIRE TESTING OF FIRE EXTINGUISHING SYSTEMS FOR

PROTECTION OF COMMERCIAL COOKING EQUIPMENT (2005 - R2010) UL 464 - AUDIBLE SIGNALING DEVICES FOR FIRE ALARM AND SIGNALING SYSTEMS,

INCLUDING ACCESSORIES (2003 EDITION) UL 521 - STANDARD FOR HEAT DETECTORS FOR FIRE PROTECTIVE SIGNALING SYSTEMS (1999 FDITION)


JL 1971 - STANDARD FOR SIGNALING DEVICES FOR THE HEARING IMPAIRED (2002 -R2010) ICC 300 - STANDARD FOR BLEACHERS, FOLDING AND TELESCOPIC SEATING, AND GRANDSTANDS (2017 EDITION)

FOR A COMPLETE LIST OF APPLICABLE NFPA STANDARDS REFER TO 2019 CBC (SFM) CHAPTER 35 AND CALIFORNIA FIRE CODE CHAPTER 80.

SEE CALIFORNIA BUILDING CODE CHAPTER 35 FOR STATE OF CALIFORNIA AMENDMENTS TO THE NFPA STANDARDS.

\*ALL PARTS OF THE 2019 CALIFORNIA BUILDING CODE BECOME EFFECTIVE JANUARY 1, 2020 EXCEPT THE EFFECTIVE DATE FOR THE USE OF THE 2019 BUILDING ENERGY EFFICIENCY STANDARDS (TITLE 24, PART 1, CHAPTER 10) IS JANUARY 8, 2019 AND THE EFFECTIVE DATE FOR THE USE OF THE CALIFORNIA ADMINISTRATIVE CODE (TITLE 24, PART 1, CHAPTER 4) IS JANUARY 8, 2019.

## VICINITY MAP

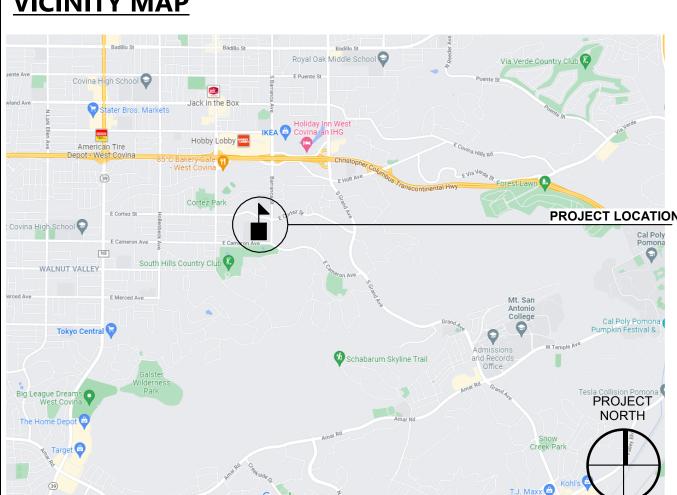

**SHEET INDEX** SHEET NAME 1. OVERALL GENERAL INFORMATION TITLE SHEET SITE PLAN GENERAL SHEETS TOTAL: 2

<u>SHEET #</u>

4. DRAWINGS

**OVERALL SHEET TOTAL: 7** 

G-001

G-101

A1-021

A1-221

A2-021

A2-221

A-701

(E) BUILDING 'ADMIN' ROOF DEMOLITION PLAN (E) BUILDING 'ADMIN' ROOF PLAN (E) BUILDING 'GYM ADDITION' ROOF DEMOLITION PLAN (E) BUILDING 'GYM ADDITION' ROOF PLAN DETAILS


SHEET #

REV # DATE

SHEET NAME

REV # DATE

BID 22-23-108			
ΔR	CHITECT STAMP	CONSULTANT STAMP	
REVISI	ONS		
/# NO.	DATE	DESCRIPTION	
PROJECT OWNER & TITLE			
<b>COVINA-VALLEY UNIFIED SCHOOL DISTRICT</b> 519 E. Badillo St. Covina, CA 91723			
SOUTH HILLS HIGH SCHOOL 645 Barranca street			
West Covina, CA 91791 SHEET TITLE			
DRAWN BY: JOB NUMBER:			
DRAW		JOB NUMBER:	
DATE:			

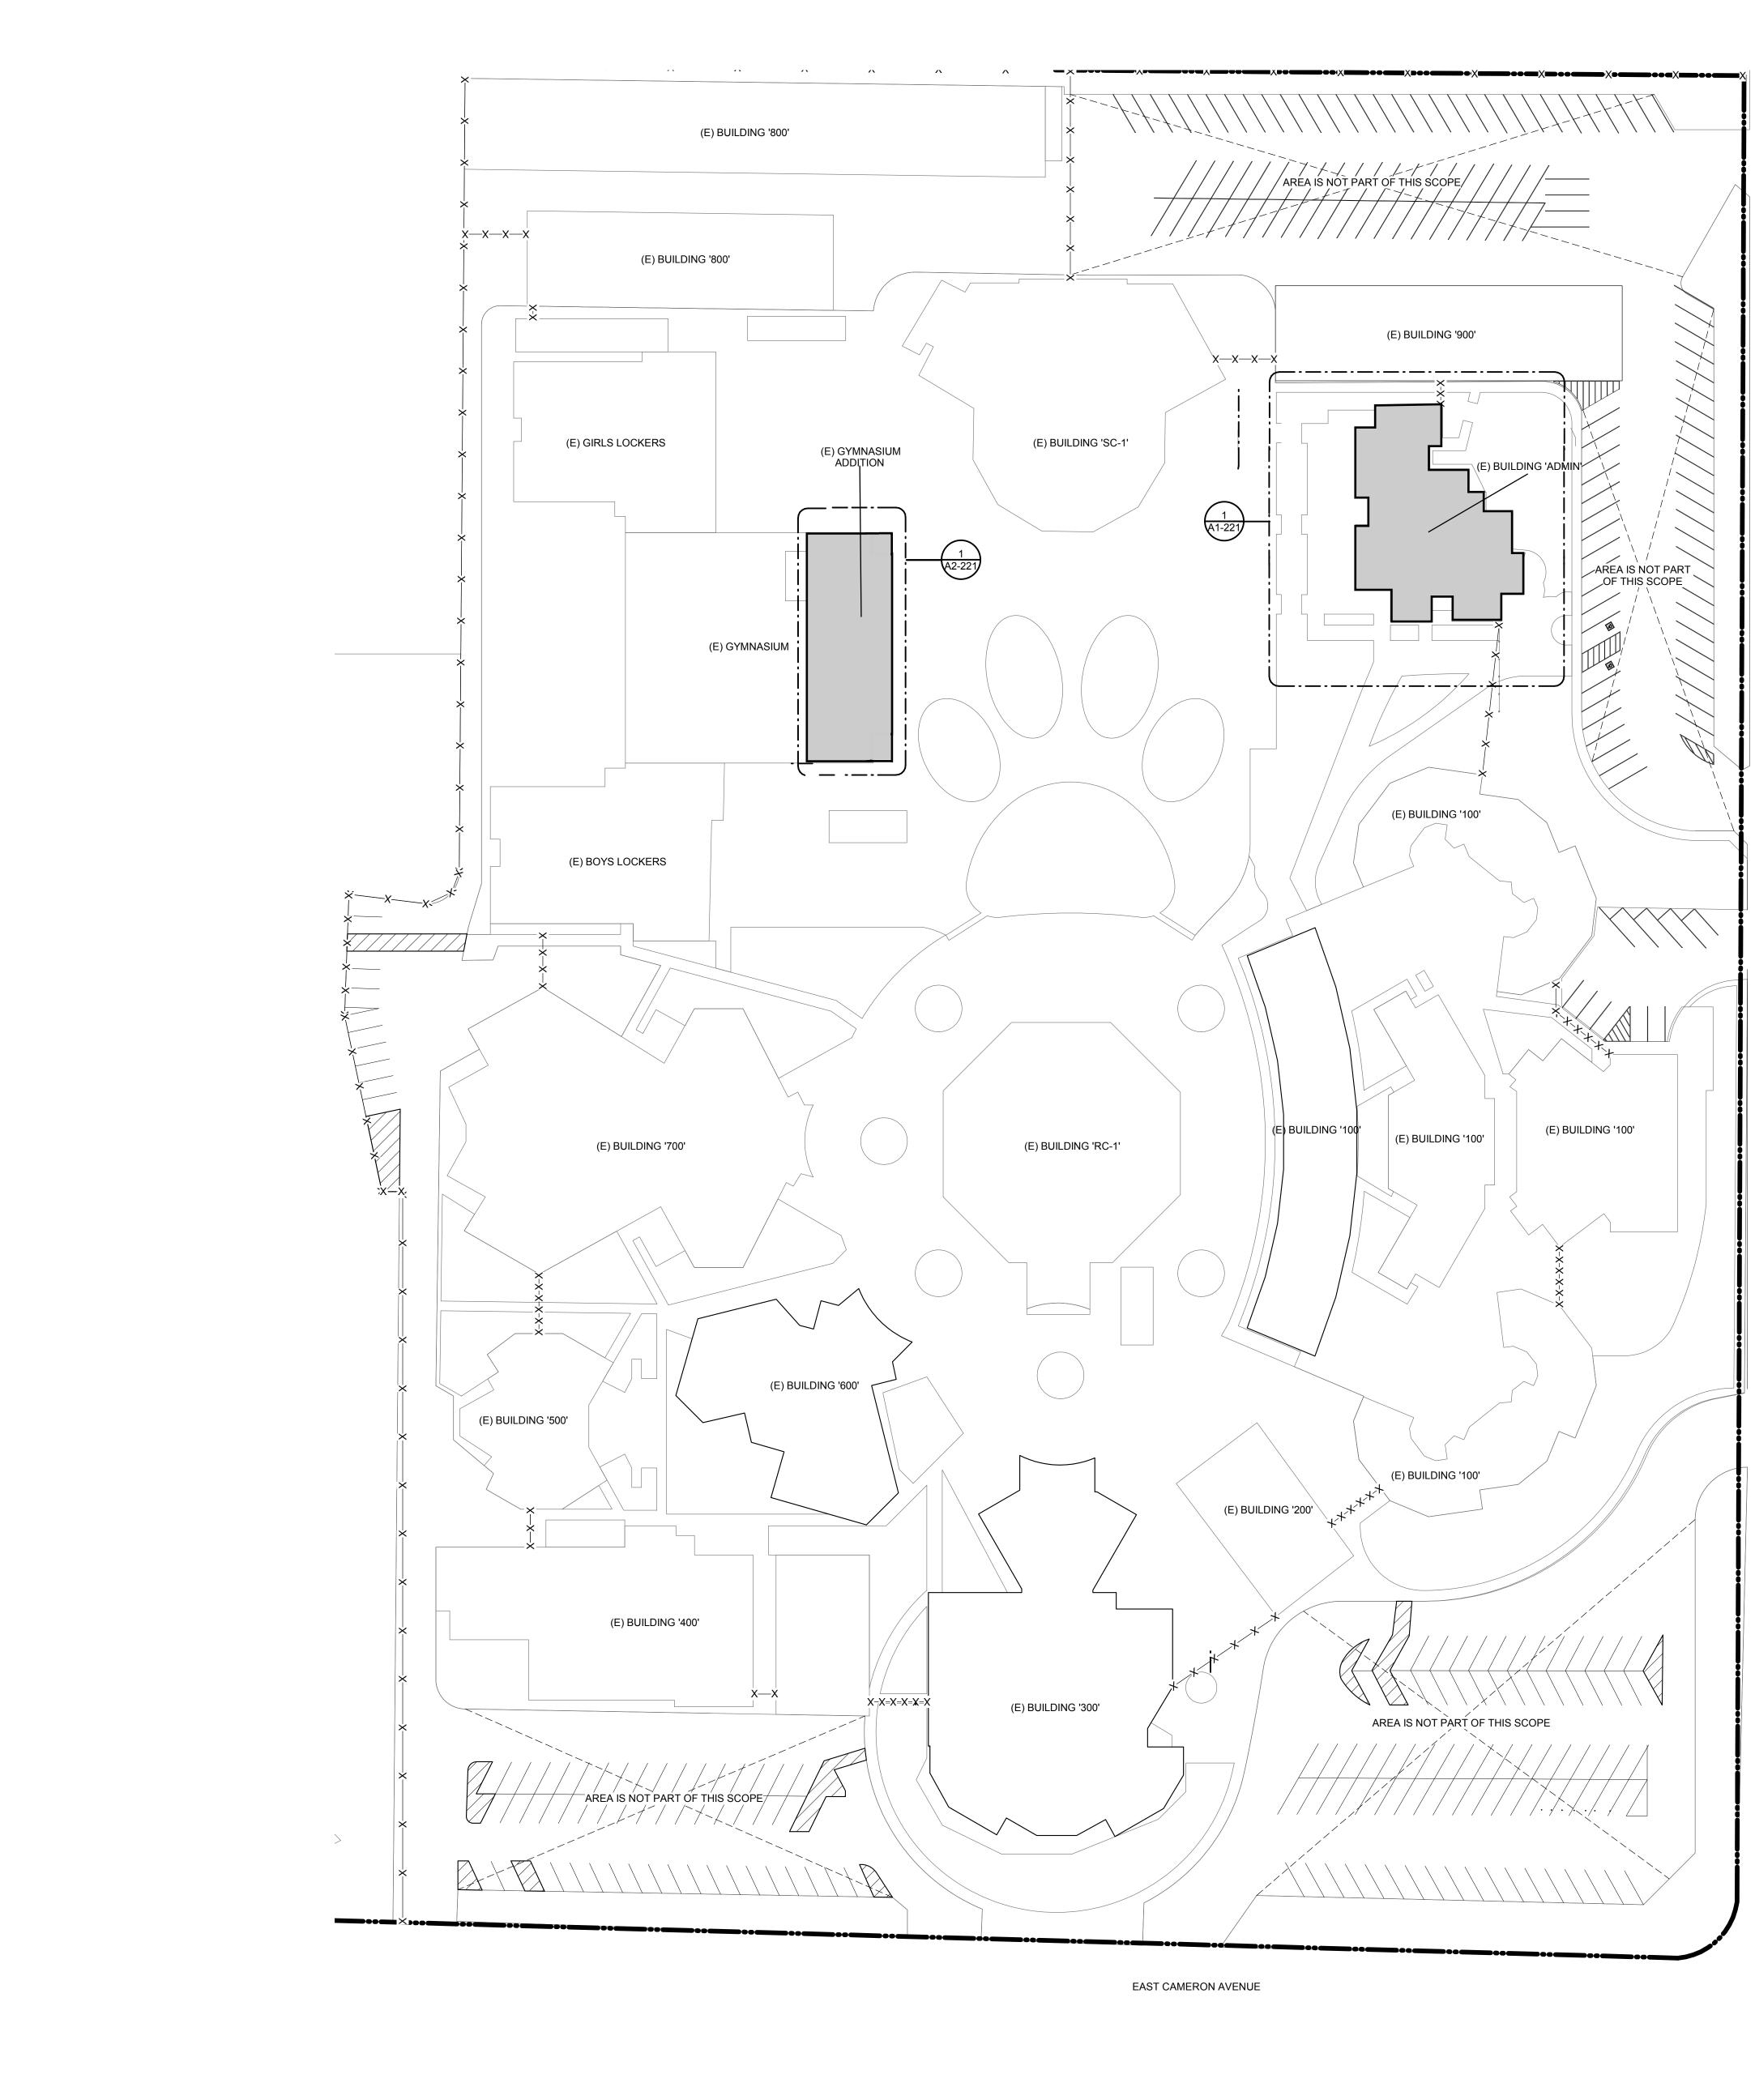

### <u>SITE PLAN LEGEND</u>

(E) PROPERTY LINE


X————X—————X (E) CHAIN LINK FENCE

BUILDING NOT A PART OF THIS SCOPE.

REMOVE (E) ROOFING DOWN TO EXISTING ROOF DECK AND PREPARE FOR INSTALLATION OF NEW SINGLE PLY ROOFING MEMBRANE. THIS INCLUDES BUT IS NOT LIMITED TO THE EXISTING BUILT UP ROOF, ROOFING ALONG THE CURBS AND PARAPET CAPS.

SITE PLAN	N.T.S.
	PROJECT NORTH


BID 22-23-108		
ARCHITECT STAMP	CONSULTANT STAMP	
REVISIONS		
NO. DATE	DESCRIPTION	
PROJECT OWNER & TITLE <b>COVINA-VALLEY UNIFIED</b> <b>SCHOOL DISTRICT</b> 519 E. Badillo St. Covina, CA 91723		
<b>SOUTH HILLS HIGH</b> <b>SCHOOL</b> 645 Barranca street West Covina, CA 91791		
SHEET TITLE		
DRAWN BY: SHEET NO.	JOB NUMBER:	
DATE:	01	

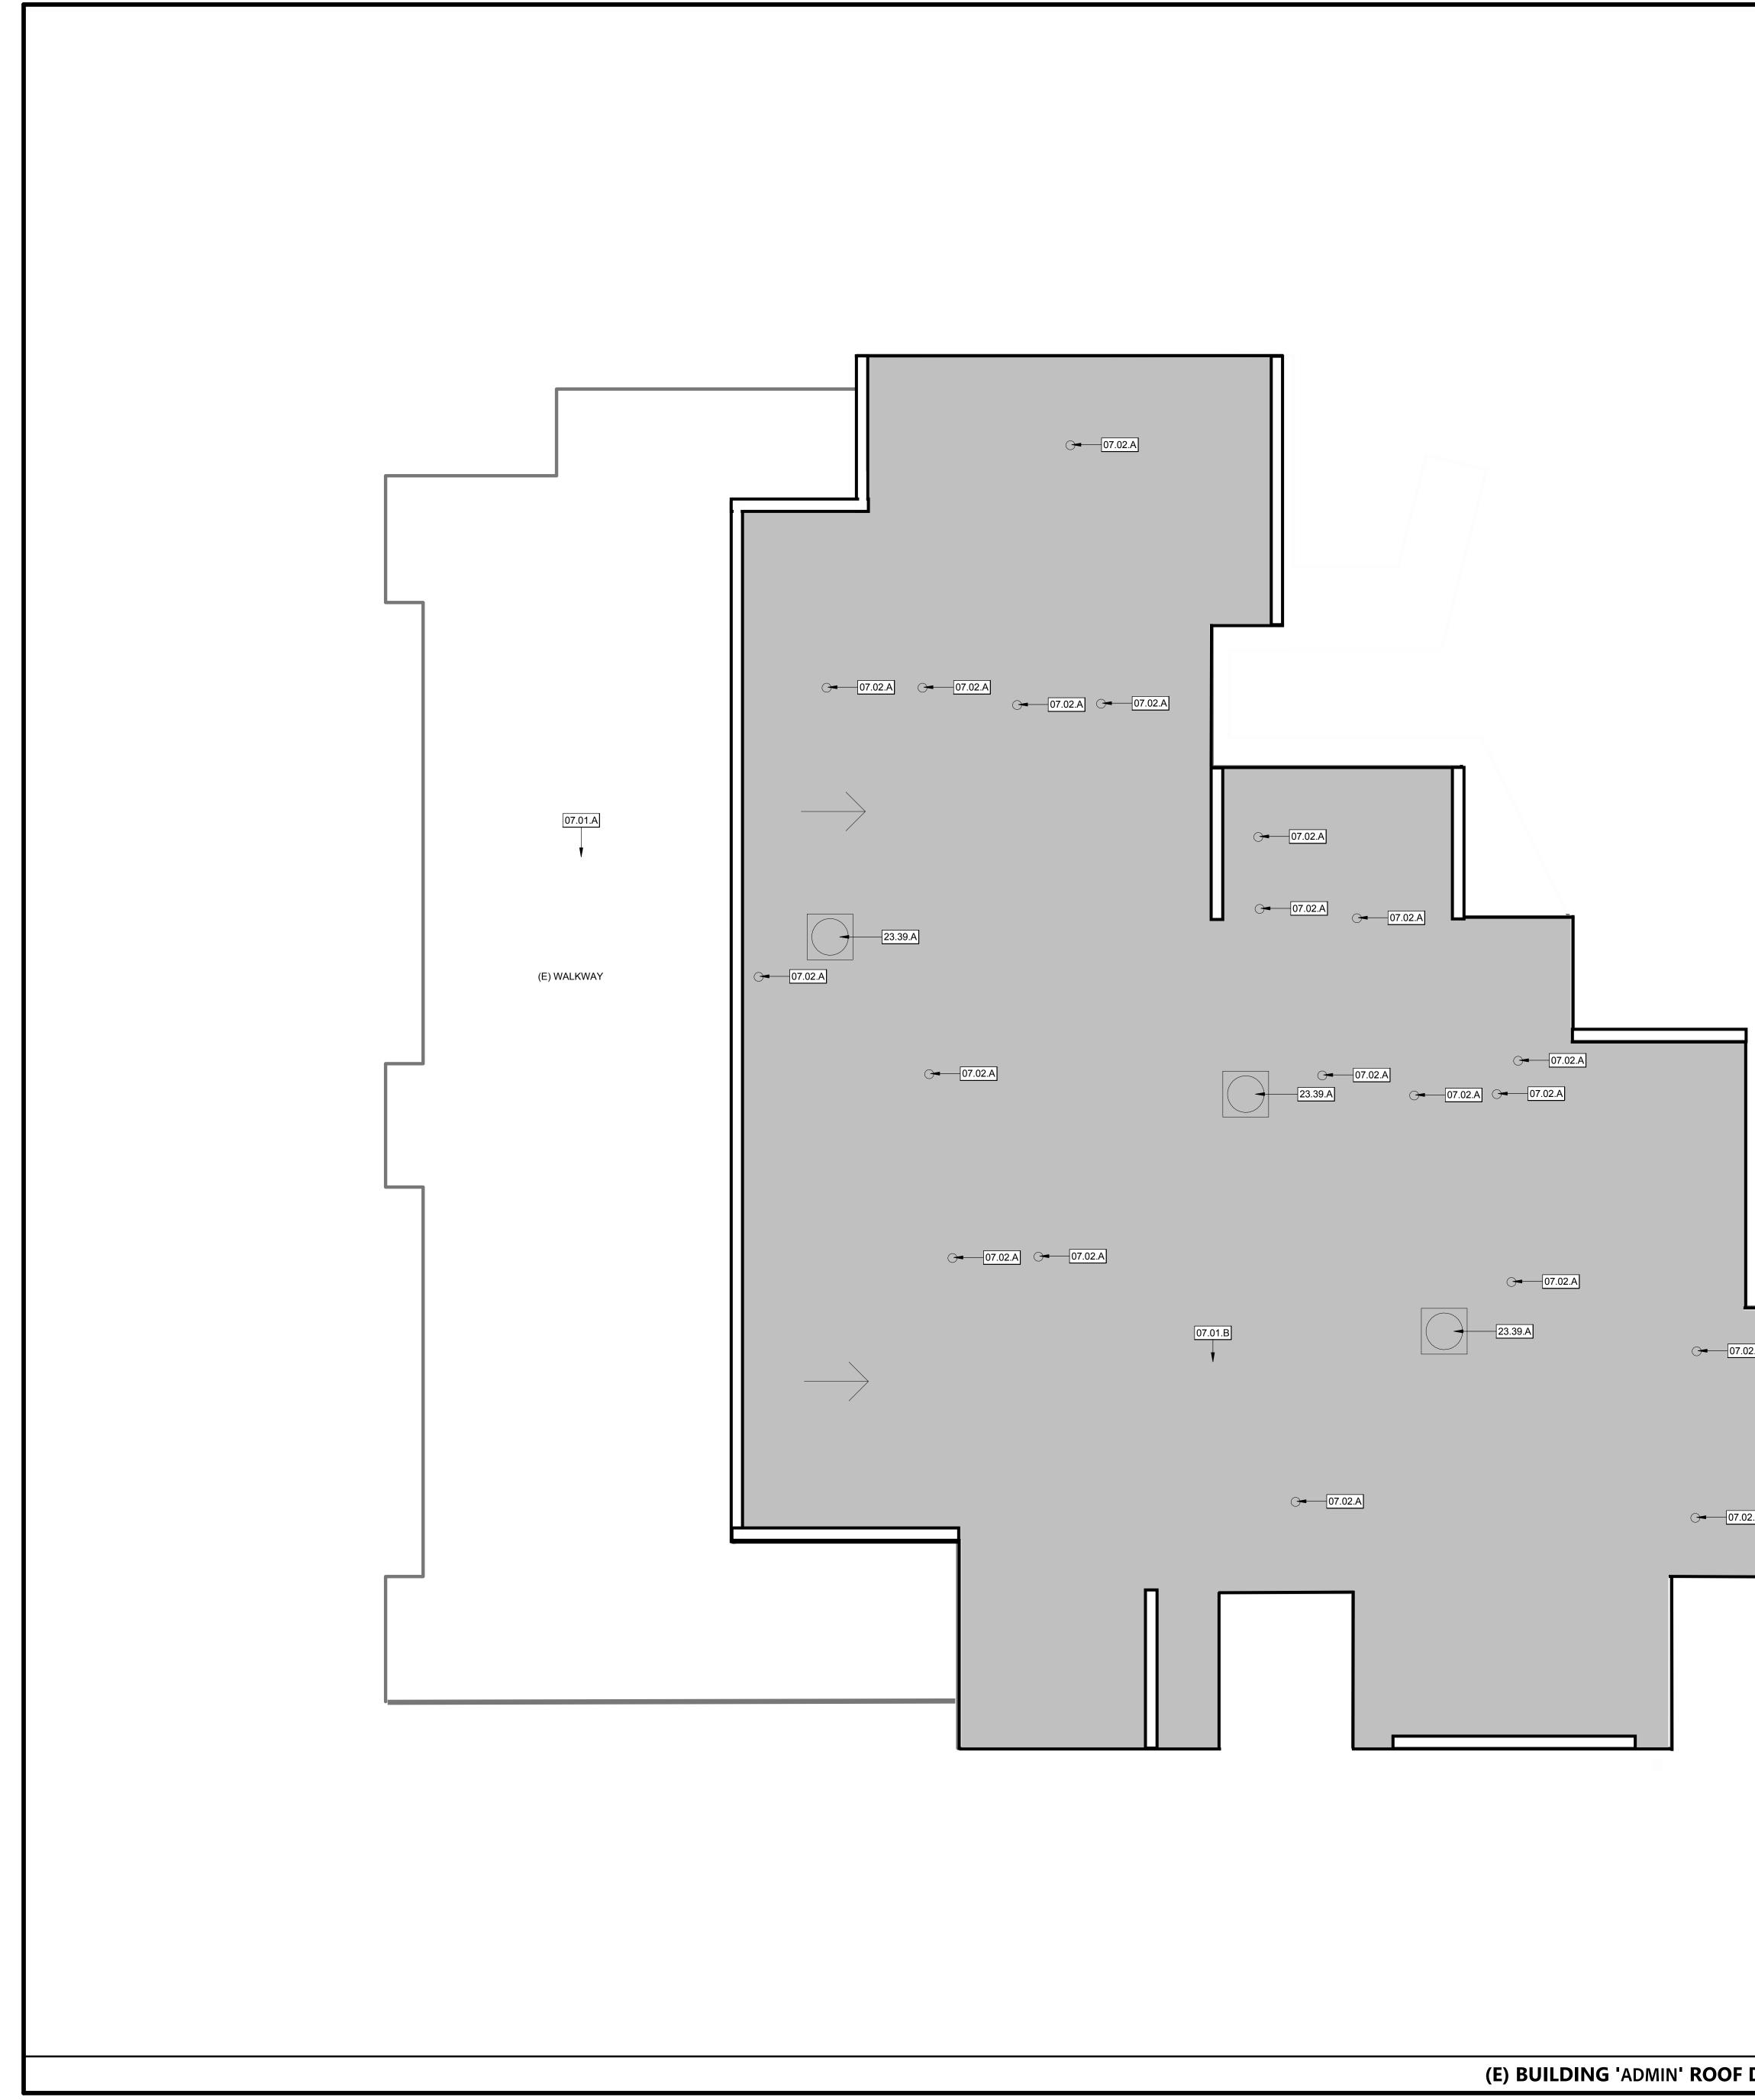


		<u>KEYNOTES</u>
		<ul> <li>07.01.A (E) ROOF TO REMAIN</li> <li>07.01.B REMOVE (E) BUILT-UP ROOFING SYSTEM AND ALL ASSOCIATED FLASHING. REMOVE ROOFING MATERIAL DOWN TO EXISTING DECK AND PREPARE FOR INSTALLATION OF NEW BUILT-UP ROOFING. REMOVE (E) ROOFING MATERIAL FROM THE PARAPET WALLS. PATCH AND REPAIR PENETRATIONS TO PARAPET WALLS AND DAMAGED DECKING AS REQUIRED.</li> <li>07.02.A PREP (E) PIPE AND VENT PENETRATIONS FOR (N) SEALS. REMOVE ALL NECESSARY ROOFING OR (E) SEALANT MATERIAL &amp; PROTECT IN PLACE ALL AREAS NOT AFFECTED BY NEW PIPE/VENT PENETRATION SEALS.</li> <li>23.39.A (E) EXHAUST FAN. PROTECT IN PLACE</li> </ul>
		<u>GENERAL NOTES</u>
		<ol> <li>THE DEMOLITION KEYNOTES ARE THE RESPONSIBILITY OF THE GENERAL CONTRACTOR.</li> <li>GENERAL CONTRACTOR SHALL SALVAGE MECHANICAL EQUIPMENT, DISCONNECTS AND CONTROLS FOR REINSTALLATION. PROTECT WITHIN LAY DOWN AREA.</li> <li>REPLACE ALL WOOD BLOCKS AND METAL SUPPORTS WITH (N) DURABLOCKS; TYPICAL AT ALL ROOFS. USE REDWOOD BLOCKS SET ON OVERSIZED WALKPAD SECTIONS FOR CONDUITS THAT CANNOT BE LIFTED AT LEAST 5 INCHES TO ACCOMMODATE DURABLOCK</li> <li>PROTECT IN PLACE ALL (E) ELECTRICAL CONDUITS, TYPICAL OF ALL ROOF CONDITIONS.</li> <li>CONTRACTOR TO REPLACE ANY DAMAGED FASCIA OR WOOD DECKING.</li> </ol>
		DEMOLITION LEGEND         (E) ROOFING MATERIAL TO REMAIN.         (E) ROOF SYSTEM, REMOVE IN ITS ENTIRETY.
2.A		<ul> <li>DEMOLITION NOTES</li> <li>IN ACCORDANCE WITH PERTINENT ITEMS OF THESE NOTES AND THOSE ITEMS SO INDICATED ON THE DRAWINGS "CAREFULLY" DEMOLISH AND REMOVE FROM THE JOB SITE THOSE ITEMS SCHEDULED TO BE SO DEMOLISHED AND REMOVED.</li> <li>PREPARE AND FOLLOW AN ORGANIZED PLAN FOR DEMOLITION AND REMOVAL OF ITEMS. SHARE PLAN WITH DISTRICT.</li> <li>DEMOLITION. BY CAREFUL STUDY OF THE DRAWINGS, DETERMINE THE LOCATION AND EXTENT OF SELECTIVE DEMOLITION REQUIRED.</li> <li>VISIT THE SITE AND LOTION REQUIRED.</li> <li>VISIT THE SITE AND LOVERIPY THE EXTENT AND LOCATION OF SELECTIVE DEMOLITION REQUIRED. CAREFULLY IDENTIFY LIMITS OF SELECTIVE DEMOLITION.</li> <li>KEYNYOTED ELEMENTS SCHEDULED FOR DEMOLITION.</li> <li>KEYNYOTED ELEMENTS SCHEDULED FOR DEMOLITION ARE NOTED FOR CLARIFICATION ONLY. SEE GENERAL NOTES, LEGENDS, PLANS, ELEVATIONS AND DETAILS FOR ADDITIONAL DEMOLITION REQUIREMENTS.</li> <li>USE ADEQUATE NUMBERS OF SKILLED WORKMAN WHO ARE THOROUGHLY TRAINED AND EXPERIENCED IN THE NECESSARY CRAFTS AND WHO ARE THOROUGHLY TANINED AND EXPERIENCED IN THE NECESSARY CRAFTS AND WHO ARE THOROUGHLY TANINED AND EXPERIENCED IN THE NECESSARY CRAFTS AND WHO ARE THOROUGHLY TANINED AND EXPERIENCED ON THE NECEDED UNTIL UNSATISFACTORY CONDITIONS ARE CORRECTOR.</li> <li>SURFACE CONDITIONS: EXAMINE THE AREAS AND CONDITIONS UNDER WHICH WORK WILL BE PERFORMANCE OF THE WORK.</li> <li>SURFACE SURFACES AS REQUIRED TO ENABLE WORKMAN ALSO TO IDENTIFY ITEMS TO BE REMOVED AND TEMS TO BE CERTINENTIAL TO TIMELY AND PROPER COMPLETION OF THE WORK DO NOT PROCEED LEFT IN PLACE INTACT.</li> <li>COMPLETELY REMOVE ITEMS SCHEDULED TO BE DEMOLISHED AND REMOVED LEAVING SUNFACES ILEXING TO THE DESTRICT.</li> <li>REPLACEMENTS: IN THE EVENT FOR DEMOLITION OF ITEMS NOT SO SCHEDULED TO BE DEMOLISHED, PROVIDE THE STRICT.</li> <li>REPLACEMENTY: IN THE EVENT OF DEMOLITION OF INDICATED FOR DISCONNECTION AND REVERTION AND REVERY THE EXISTING CONDITIONS AND WILL BE RESPONSIBLE FOR DISCONNECT AND AT NO ADDI</li></ul>
		KEY PLAN       NORTH       800         SCALE: NTS       Image: scale sca
DEMOLITION PLAN	N.T.S.	

	BID 22-23-108
	ARCHITECT STAMP CONSULTANT STAMP
	REVISIONS
	Image:
	THE ARCHITECT DOES NOT REPRESENT THAT THESE PLANS OR THE SPECIFICATIONS ARE SUITABLE FOR ANY SITE OTHER THAN THE ONE FOR WHICH THEY WERE SPECIFICALLY PREPARED. THE ARCHITECT DISCLAIMS RESPONSIBILITY FOR THESE PLANS AND SPECIFICATIONS IF THEY ARE USED IN WHOLE OR IN PART AT ANY OTHER SITE. WRITTEN DIMENSIONS ON THESE DRAWINGS SHALL HAVE PRECEDENCE OVER SCALED DIMENSIONS.
	PROJECT OWNER & TITLE COVINA-VALLEY UNIFIED SCHOOL DISTRICT 519 E. Badillo St. Covina, CA 91723
ΛIN	<b>SOUTH HILLS HIGH</b> <b>SCHOOL</b> 645 Barranca street West Covina, CA 91791
)	SHEET TITLE (E) BUILDING 'ADMIN' ROOF DEMOLITION PLAN
	DRAWN BY: JOB NUMBER: SHEET NO. <b>A 1 - 0 2 1</b> DATE:

'ATUS Ś PROJECT

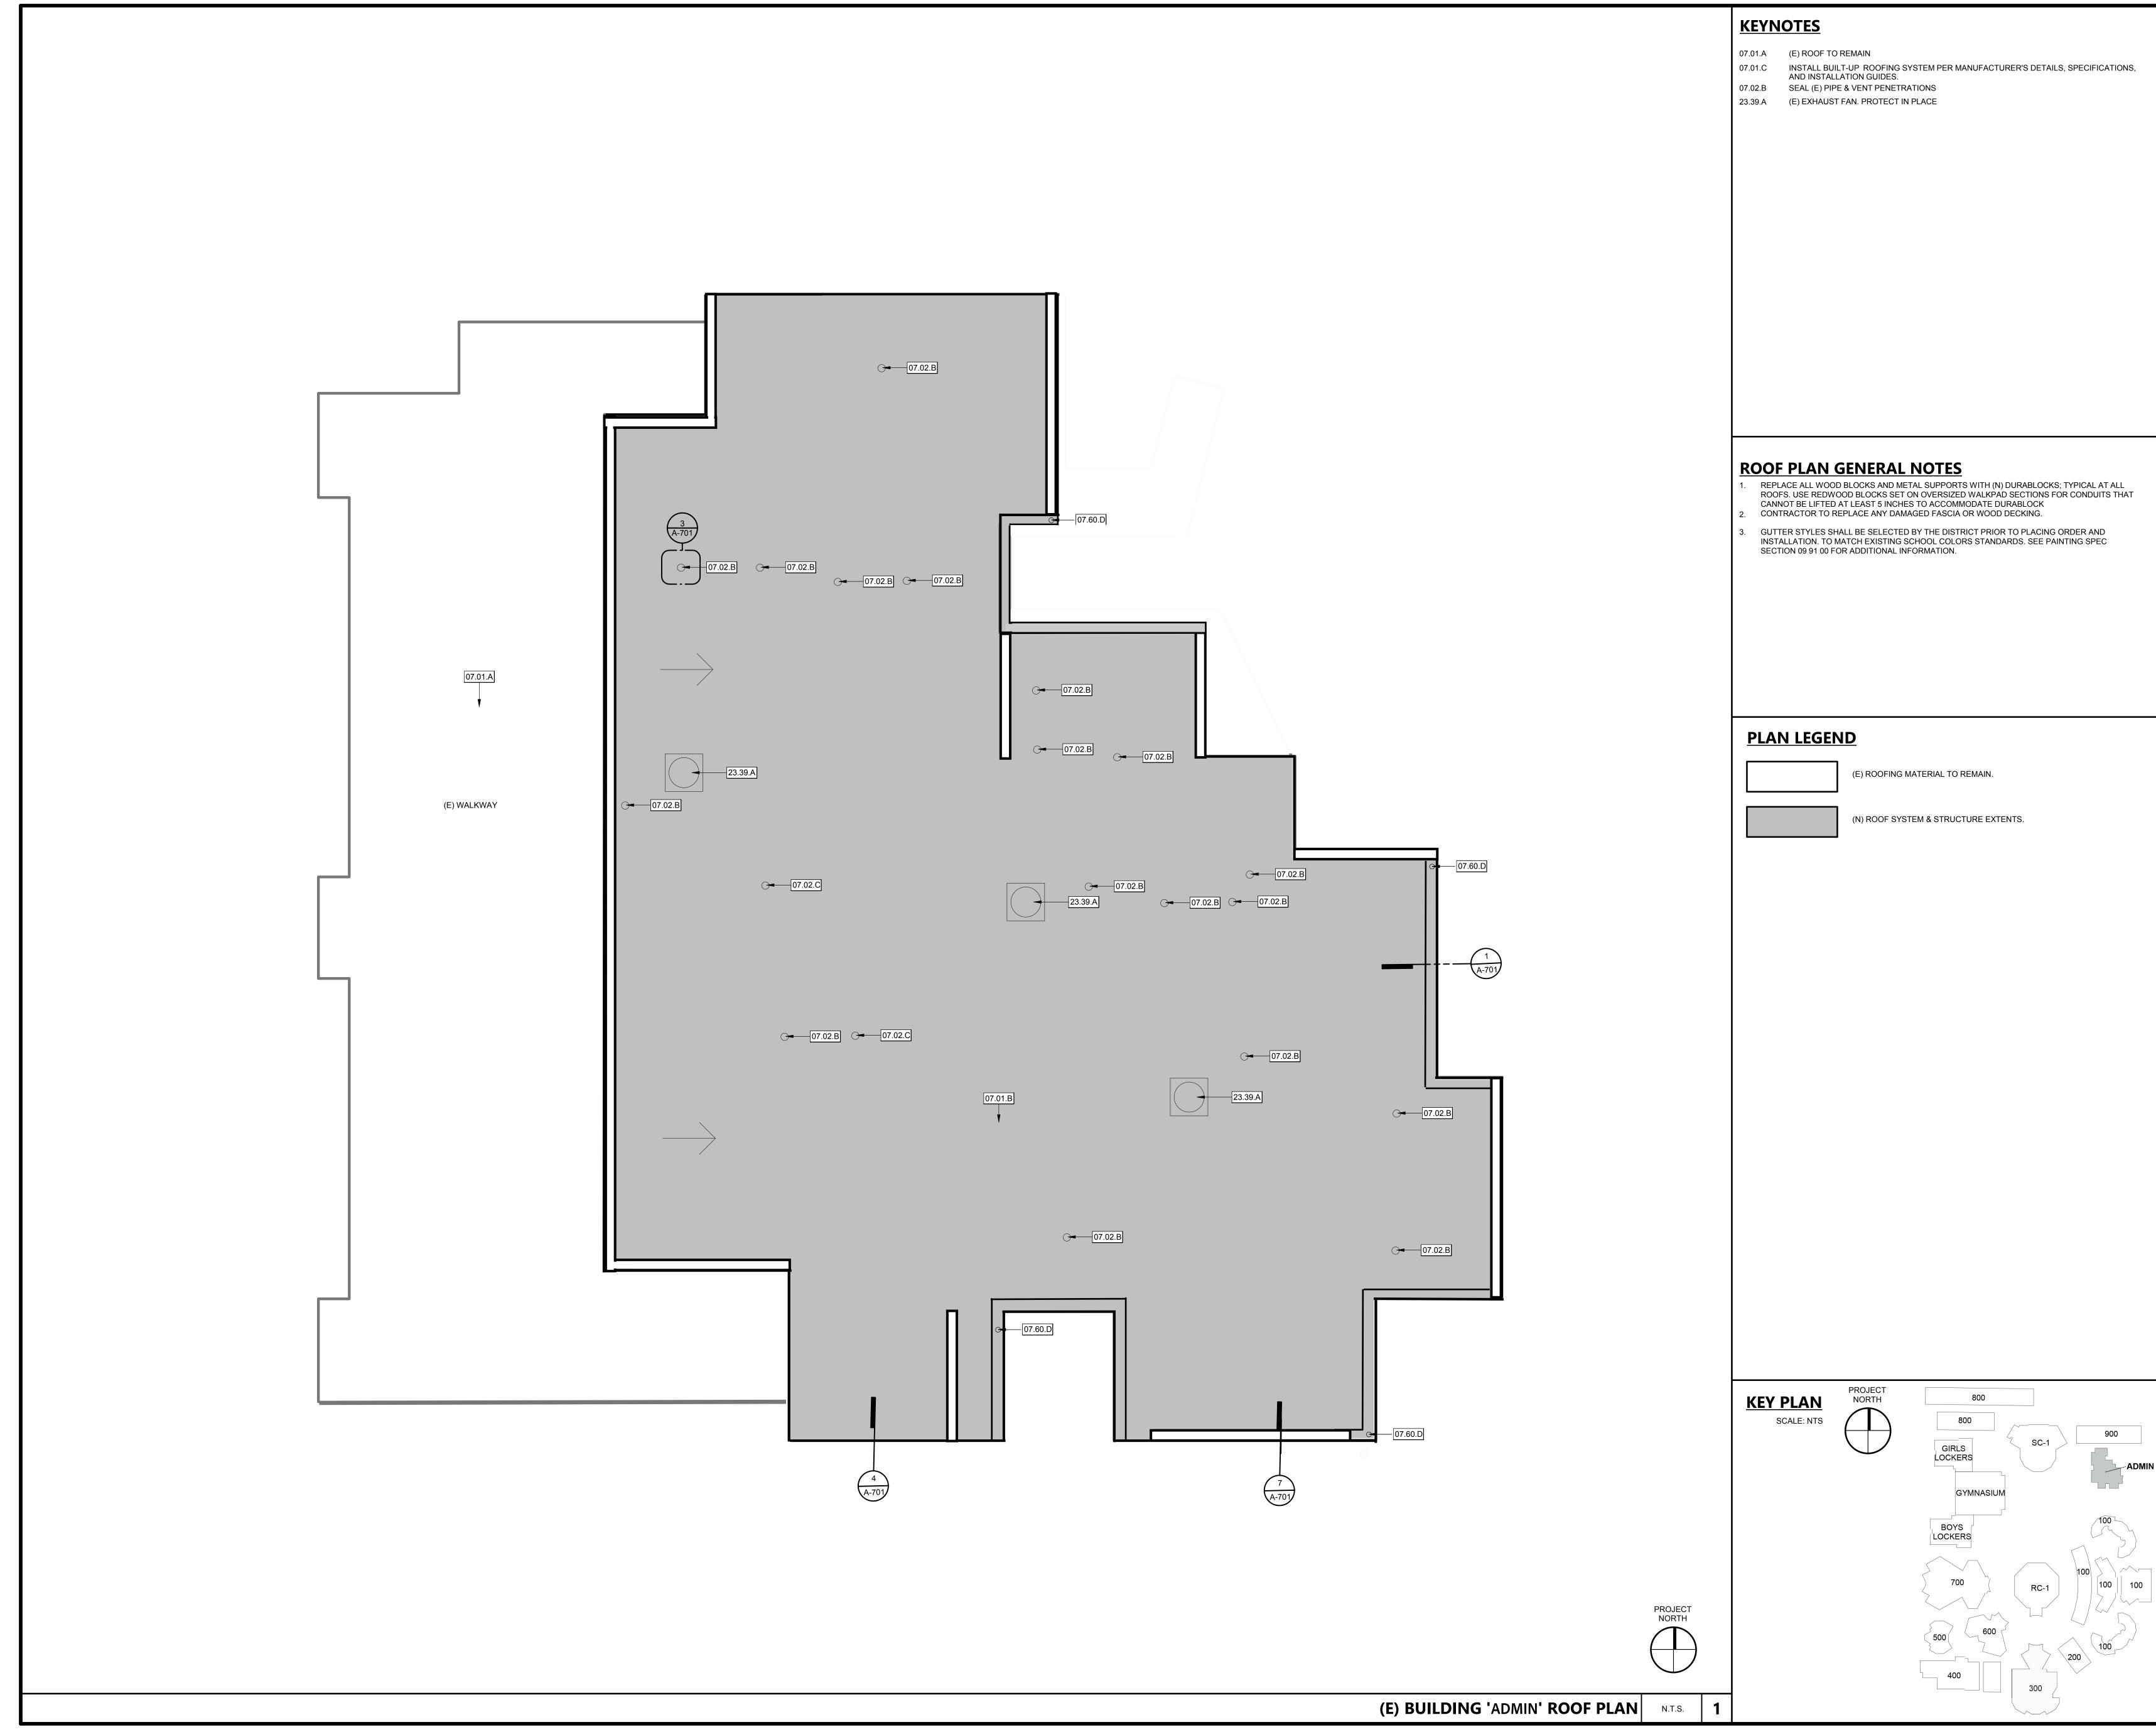


		ID 3-108	
AR	CHITECT STAMP	CONSULTANT STAMP	
REVISI	ONS DATE	DESCRIPTION	
<b>COV</b> SCH 519	CT OWNER & TITLE <b>INA-VALLEY</b> <b>OOL DISTRIC</b> E. Badillo St. na, CA 91723		
<b>SC</b> 645	<b>HOOL</b> Barranca stree		
sнеет <b>(Е)</b>	BUILDI		JS
DRAW SHEET	NO.	JOB NUMBER:	PROJECT STATUS
DATE:	A1-	221	PROJEC

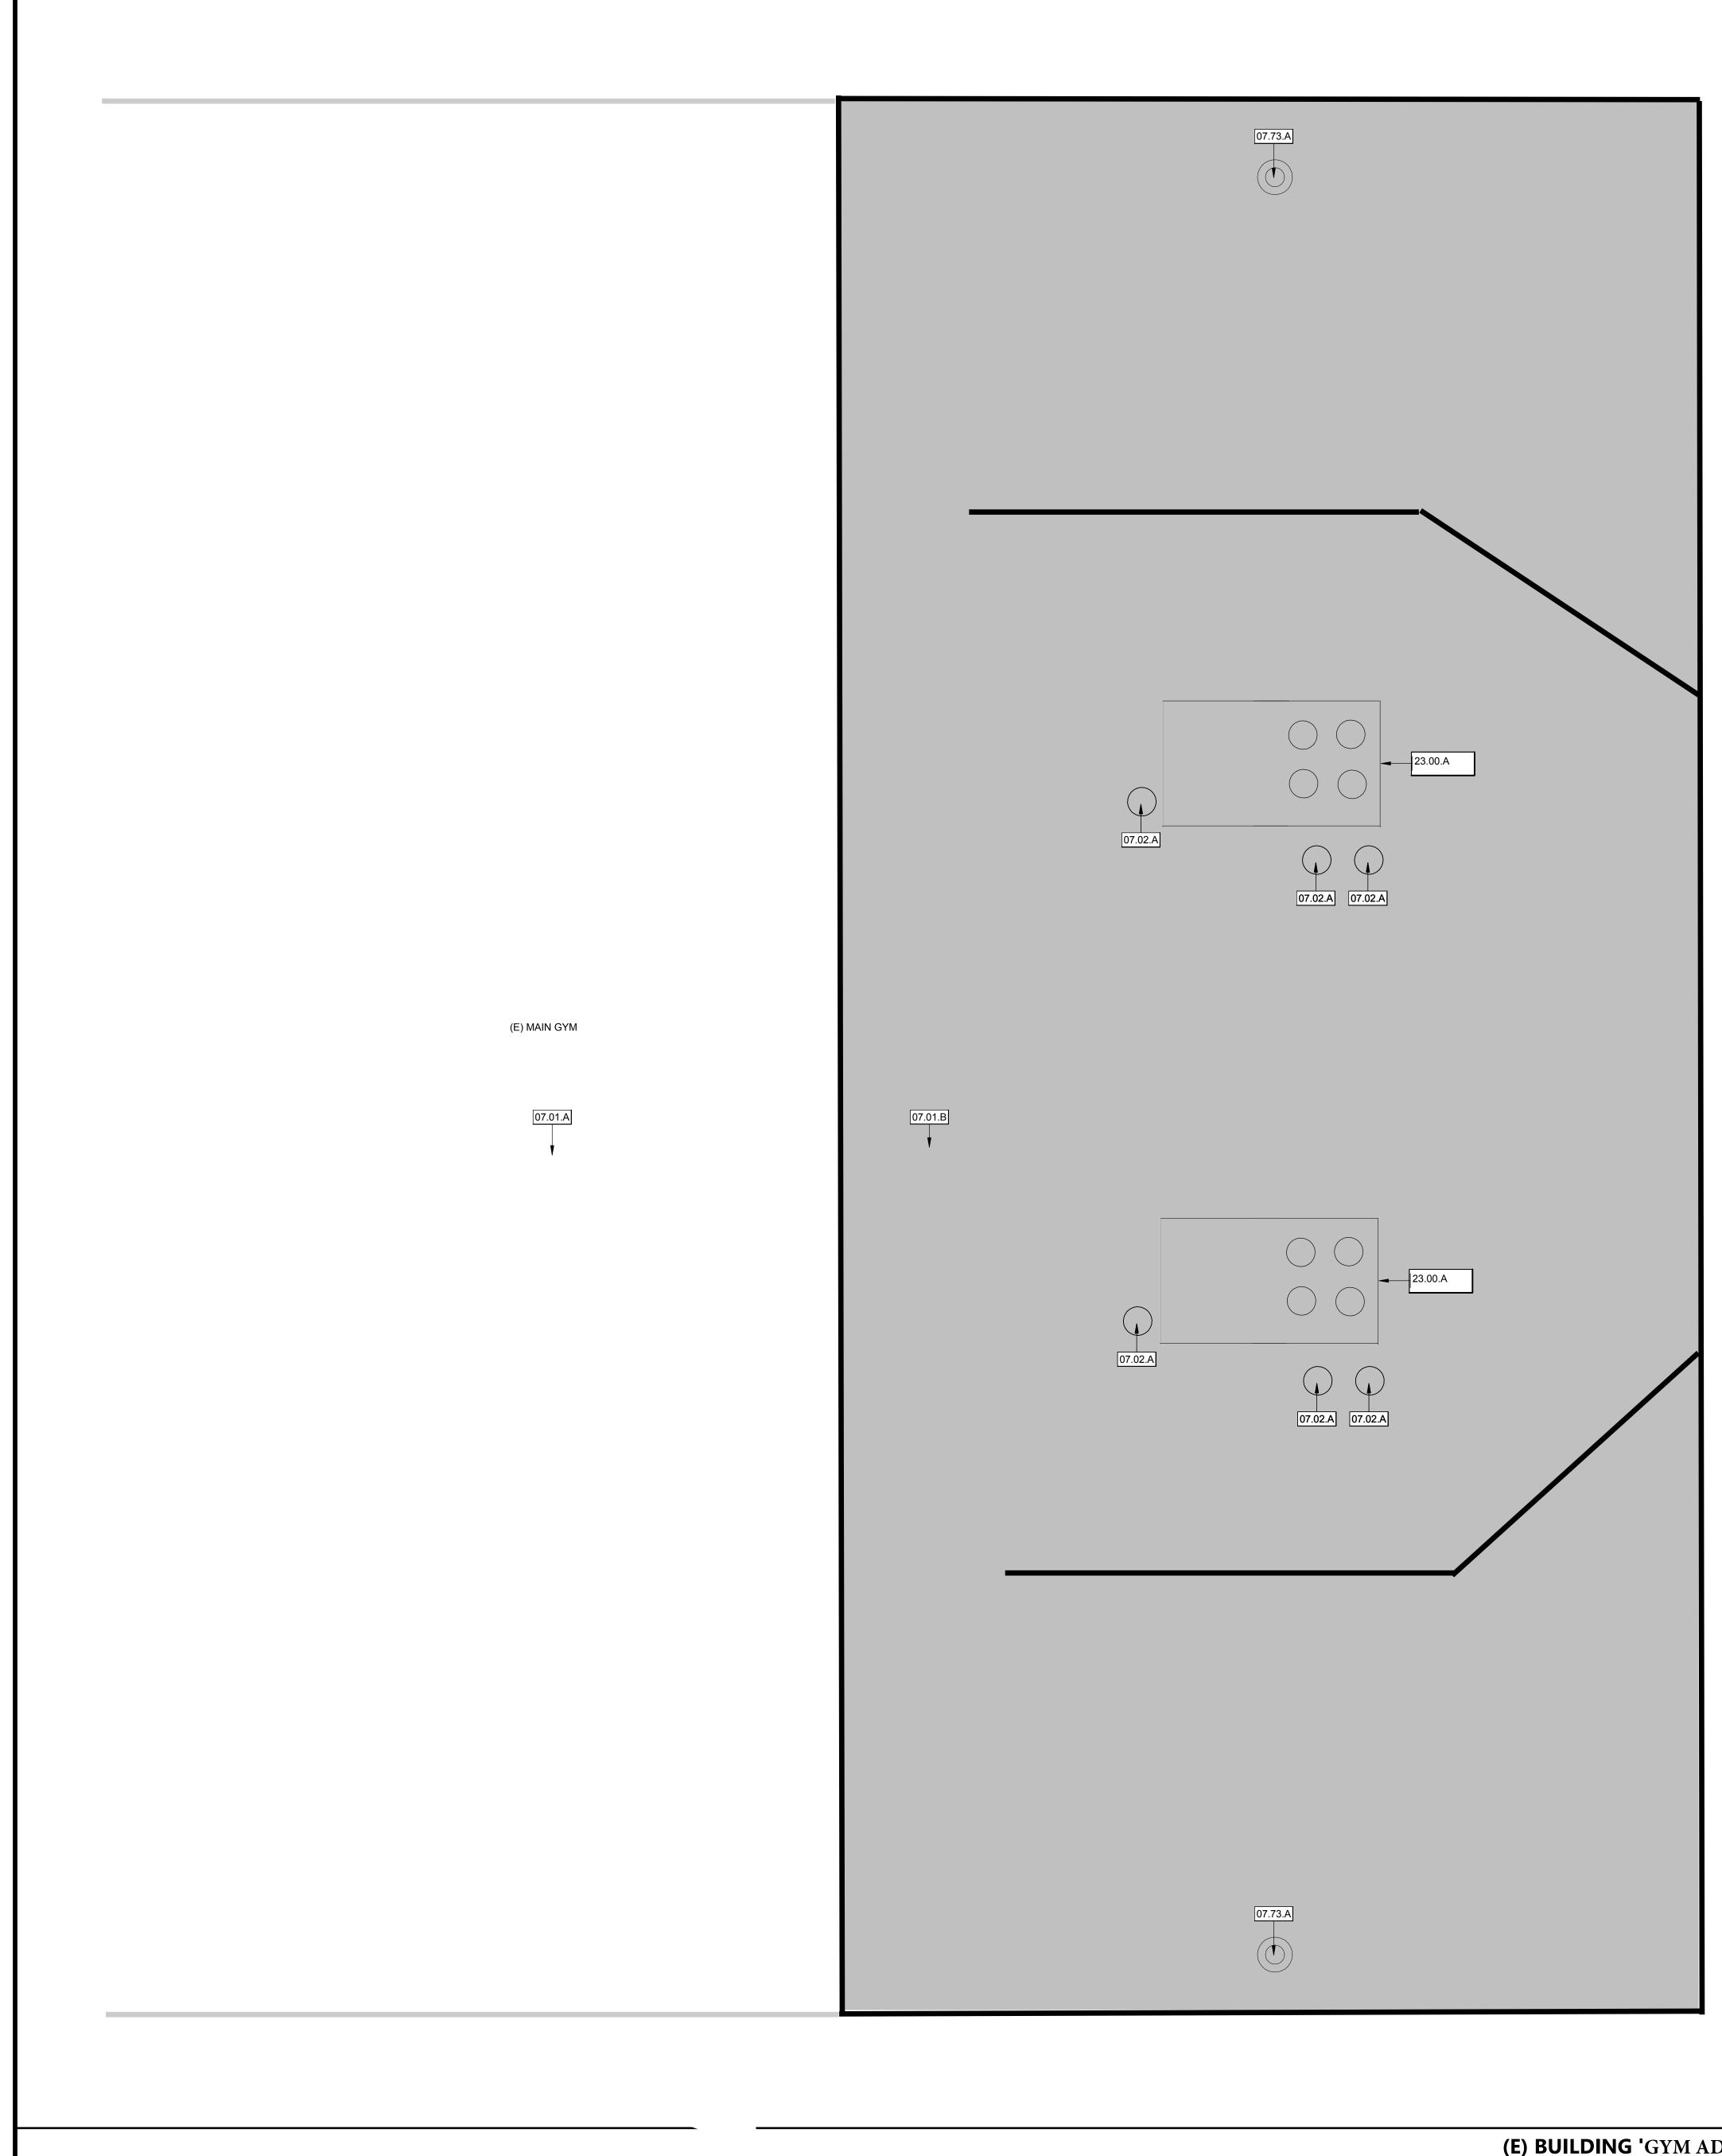

	KEYNOTES         07.01.A       (E) ROOF TO REMAIN         07.01.B       PREPARE ROOF FOR RESTORATION PER MANUFACTUERS DETAILS, SPECIFICATIONS, AND INSTALLATION GUIDES.         07.02.A       PREP (E) PIPE AND VENT PENETRATIONS FOR (N) SEALS. REMOVE ALL NECESSARY ROOFING OR (E) SEALANT MATERIAL & PROTECT IN PLACE ALL AREAS NOT AFFECTED BY NEW PIPE/VENT PENETRATION SEALS.         07.73.A       (E) PRESSURE CLEAN AND FLUSH OUT ROOF DRAIN AND OVERFLOW PIPING PRIOR TO INSTALLATION OF ROOF RESTORATION.         23.00.A       (E) MECHANICAL EQUIPMENT, PROTECT IN PLACE.	BID 22-23-108
	<ul> <li>GENERAL NOTES</li> <li>THE DEMOLITION KEYNOTES ARE THE RESPONSIBILITY OF THE GENERAL CONTRACTOR.</li> <li>GENERAL CONTRACTOR SHALL SALVAGE MECHANICAL EQUIPMENT, DISCONNECTS AND CONTROLS FOR REINSTALLATION. PROTECT WITHIN LAY DOWN AREA.</li> <li>REPLACE ALL WOOD BLOCKS AND METAL SUPPORTS WITH (N) DURABLOCKS; TYPICAL AT ALL ROOFS. USE REDWOOD BLOCKS SET ON OVERSIZED WALKPAD SECTIONS FOR CONDUITS THAT CANNOT BE LIFTED AT LEAST 5 INCHES TO ACCOMMODATE DURABLOCK</li> <li>PROTECT IN PLACE ALL (E) ELECTRICAL CONDUITS, TYPICAL OF ALL ROOF CONDITIONS.</li> <li>CONTRACTOR TO REPLACE ANY DAMAGED FASCIA OR WOOD DECKING.</li> </ul>	
	DEMOLITION LEGEND         (E) ROOFING MATERIAL TO REMAIN.         (E) ROOF SYSTEM, PREP FOR RESTORATION ACCORDING TO MANUFACTURE'S SPECIFICATIONS	
	DEMOLITION NOTES         1. IN ACCORDANCE WITH PERTINENT ITEMS OF THESE NOTES AND THOSE ITEMS SO INDICATED ON THE DRAWINGS "CAREFULLY" DEMOLISH AND REMOVE FROM THE JOB SITE THOSE ITEMS SCHEDULED TO BE SO DEMOLISHED AND REMOVED.         2. PREPARE AND FOLLOW AN ORGANIZED PLAN FOR DEMOLITION AND REMOVAL OF ITEMS. SHARE	ARCHITECT STAMP CONSULTANT STAMP
	<ul> <li>PLAN WITH DISTRICT.</li> <li>3. DEMOLITION: BY CAREFUL STUDY OF THE DRAWINGS, DETERMINE THE LOCATION AND EXTENT OF SELECTIVE DEMOLITION REQUIRED.</li> <li>4. VISIT THE SITE AND VERIFY THE EXTENT AND LOCATION OF SELECTIVE DEMOLITION REQUIRED. CAREFULLY IDENTIFY LIMITS OF SELECTIVE DEMOLITION.</li> <li>5. KEYNOTED ELEMENTS SCHEDULED FOR DEMOLITION ARE NOTED FOR CLARIFICATION ONLY. SEE GENERAL NOTES, LEGENDS, PLANS, ELEVATIONS AND DETAILS FOR ADDITIONAL DEMOLITION REQUIREMENTS.</li> <li>6. USE ADEQUATE NUMBERS OF SKILLED WORKMAN WHO ARE THOROUGHLY TRAINED AND EXPERIENCED IN THE NECESSARY CRAFTS AND WHO ARE COMPLETELY FAMILIAR WITH THE SPECIFIED REQUIREMENTS AND THE METHODS NEEDED FOR PROPER PERFORMANCE OF THE WORK.</li> <li>7. SURFACE CONDITIONS: EXAMINE THE AREAS AND CONDITIONS UNDER WHICH WORK WILL BE PERFORMED. INCORRECT CONDITIONS ARE DETRIMENTAL TO TIMELY AND PROPER COMPLETION OF THE WORK. DO NOT PROCEED UNTIL UNSATISFACTORY CONDITIONS ARE CORRECTED.</li> <li>8. MARK INTERFACE SURFACES AS REQUIRED TO ENABLE WORKMAN ALSO TO IDENTIFY ITEMS TO BE REMOVED AND ITEMS TO BE LEFT IN PLACE INTACT.</li> <li>9. COMPLETELY REMOVE ITEMS SCHEDULED TO BE DEMOLISHED AND REMOVED, LEAVING SURFACES CLEAN, SOLID AND READY TO RECEIVE NEW MATERIALS SPECIFIED ELSEWHERE.</li> <li>10. REPLACEMENTS: IN THE EVENT OF DEMOLITION OF ITEMS NOT SO SCHEDULED TO BE</li> </ul>	REVISIONS MO. DATE DESCRIPTION DATE DESCRIPTION DATE DESCRIPTION
	DEMOLISHED, PROMPTLY REPLACE SUCH ITEMS TO THE APPROVAL OF THE DISTRICT AND AT NO ADDITIONAL COST TO THE DISTRICT. 11. THE PLANS AND SPECIFICATIONS INDICATE THE GENERAL EXTENT OF WORK BASED ON OWNER PROVIDED "EXISTING" DRAWINGS AND LIMITED FIELD VERIFICATION, THE CONTRACTOR SHALL VERIFY THE EXISTING CONDITIONS AND WILL BE RESPONSIBLE FOR DISCONNECTING AND RECONNECTING PLUMBING, MECHANICAL AND ELECTRICAL SYSTEMS NECESSARY TO ACCOMPLISH WORK WHETHER SPECIFICALLY INDICATED OR NOT. 12. ALL EXISTING MATERIAL NOT TO BE REUSED OR NOT INDICATED TO BE RETAINED BY THE OWNER SHALL BE REMOVED FROM THE SITE AND BECOME THE PROPERTY OF THE CONTRACTOR FOR SALVAGE. 13. THE CONTRACTOR IS RESPONSIBLE FOR DAILY REMOVAL OF DEBRIS AND CLEANING THE AREA WHERE THEY ARE WORKING. THE CONTRACTOR MUST PROVIDE THEIR OWN MEANS OF DEBRIS AND WASTE REMOVAL AND MAY NOT USE THE OWNER'S WASTE RECEPTACLES 14. ANY ADJACENT ITEMS OR SURFACES TO THE DEMOLITION WORK THAT IS DAMAGED DURING THE CONSTRUCTION SHALL BE RESTORED TO ITS ORIGINAL CONDITION OR FINISHED TO MATCH ADJACENT SURFACES AT NO ADDITIONAL COST TO THE OWNER. PROJECT NORTH 800	PROJECT OWNER & TITLE COVINA-VALLEY UNIFIED SCHOOL DISTRICT 519 E. Badillo St.
	SCALE: NTS     800       GIRLS     900       GIRLS     AD-1       GYM     ADDITION       BOYS     100       LOCKERS     100	Covina, CA 91723 SOUTH HILLS HIGH SCHOOL 645 Barranca street West Covina, CA 91791 SHEET TITLE (E) BUILDING 'GYM ADDITION' BOOE
N.T.S.	700 RC-1 500 600 400 300 300	ADDITION' ROOF DEMOLITION PLAN DRAWN BY: PI JOB NUMBER: 21296 SHEET NO. AQQ-QQ1 DATE: JANUARY 7, 2022


**ROJECT STATU** 

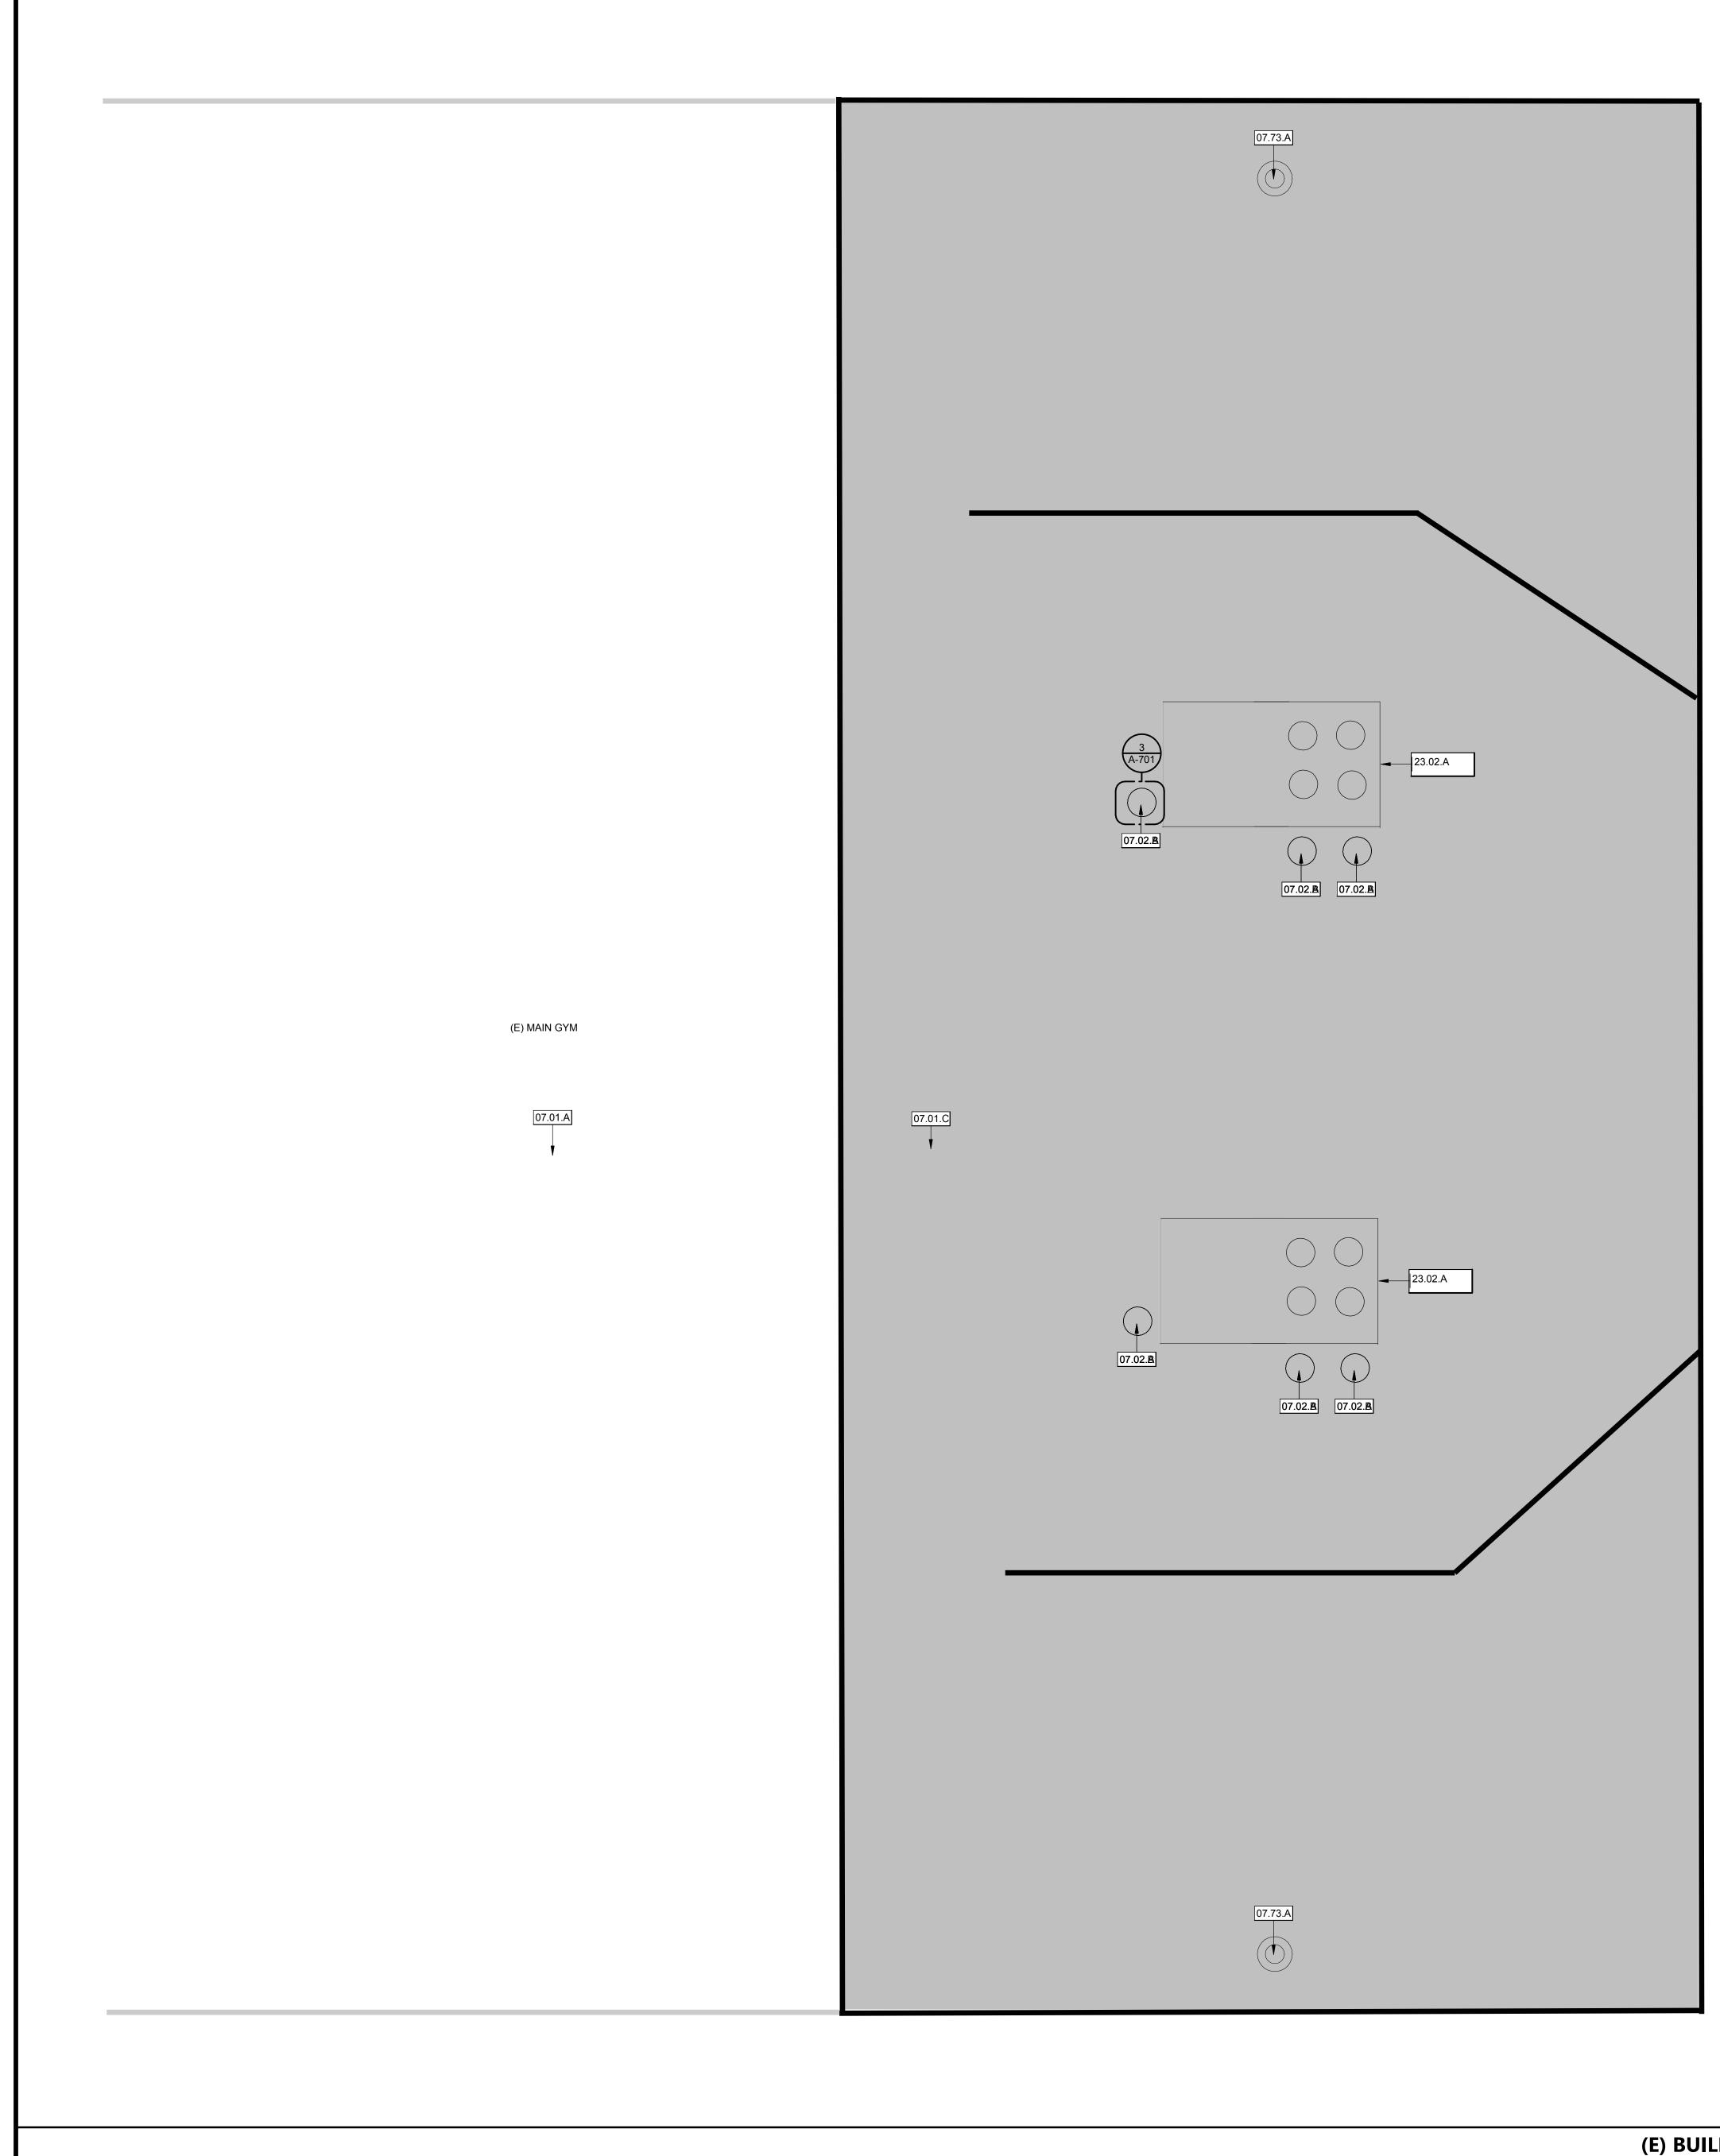

	<u>KEYNOTES</u>
	<ul> <li>07.01.A (E) ROOF TO REMAIN</li> <li>07.01.C INSTALL RESTORATION ROOFING SYSTEM PER MANUFACTURER'S DETAILS, SPECIFICATIONS, AND INSTALLATION GUIDES.</li> <li>07.02.B SEAL (E) PIPE &amp; VENT PENETRATIONS</li> <li>07.73.A (E) PREMOVE DRAIN RINGS TO INSTALL ROOF RESTORATION AND REINSTALL.</li> <li>23.02.A (E) MECHANICAL EQUIPMENT AND CURB, PROTECT IN PLACE.</li> </ul>
	ROOF PLAN GENERAL NOTES         1. (E) DURABLOCKS SHALL REMAIN; REPLACE ALL WOOD BLOCKS AND METAL SUPPORTS WITH (N) DURABLOCKS; TYPICAL AT ALL ROOFS.         2. CONTRACTOR TO REPLACE ANY DAMAGED FASCIA OR WOOD DECKING.         3. GUTTER STYLES SHALL BE SELECTED BY DISTRICT PRIOR TO PLACING ORDER AND INSTALLATION.
	PLAN LEGEND         (E) ROOFING MATERIAL TO REMAIN.         (N) ROOF SYSTEM & STRUCTURE EXTENTS.
	KEY PLAN     PROJECT     800       SCALE: NTS     SCALE     800
MADDITION' ROOF PLAN	BOYS     100       LOCKERS     100       700     RC-1       100     100       500     600       400     300

	BID 22-23-108	
	ARCHITECT STAMP CONSULTANT STAMP	
	REVISIONS	
	NO.     DATE     DESCRIPTION	
	PROJECT OWNER & TITLE COVINA-VALLEY UNIFIED SCHOOL DISTRICT	
	519 E. Badillo St. Covina, CA 91723 SOUTH HILLS HIGH SCHOOL	
	645 Barranca street West Covina, CA 91791	
)	(E) BUILDING 'GYM ADDITION' ROOF PLAN	\TUS
	DRAWN BY: JOB NUMBER: SHEET NO. A2-221	PROJECT STATUS
	DATE:	PRC

INSTRUCTION
CANT

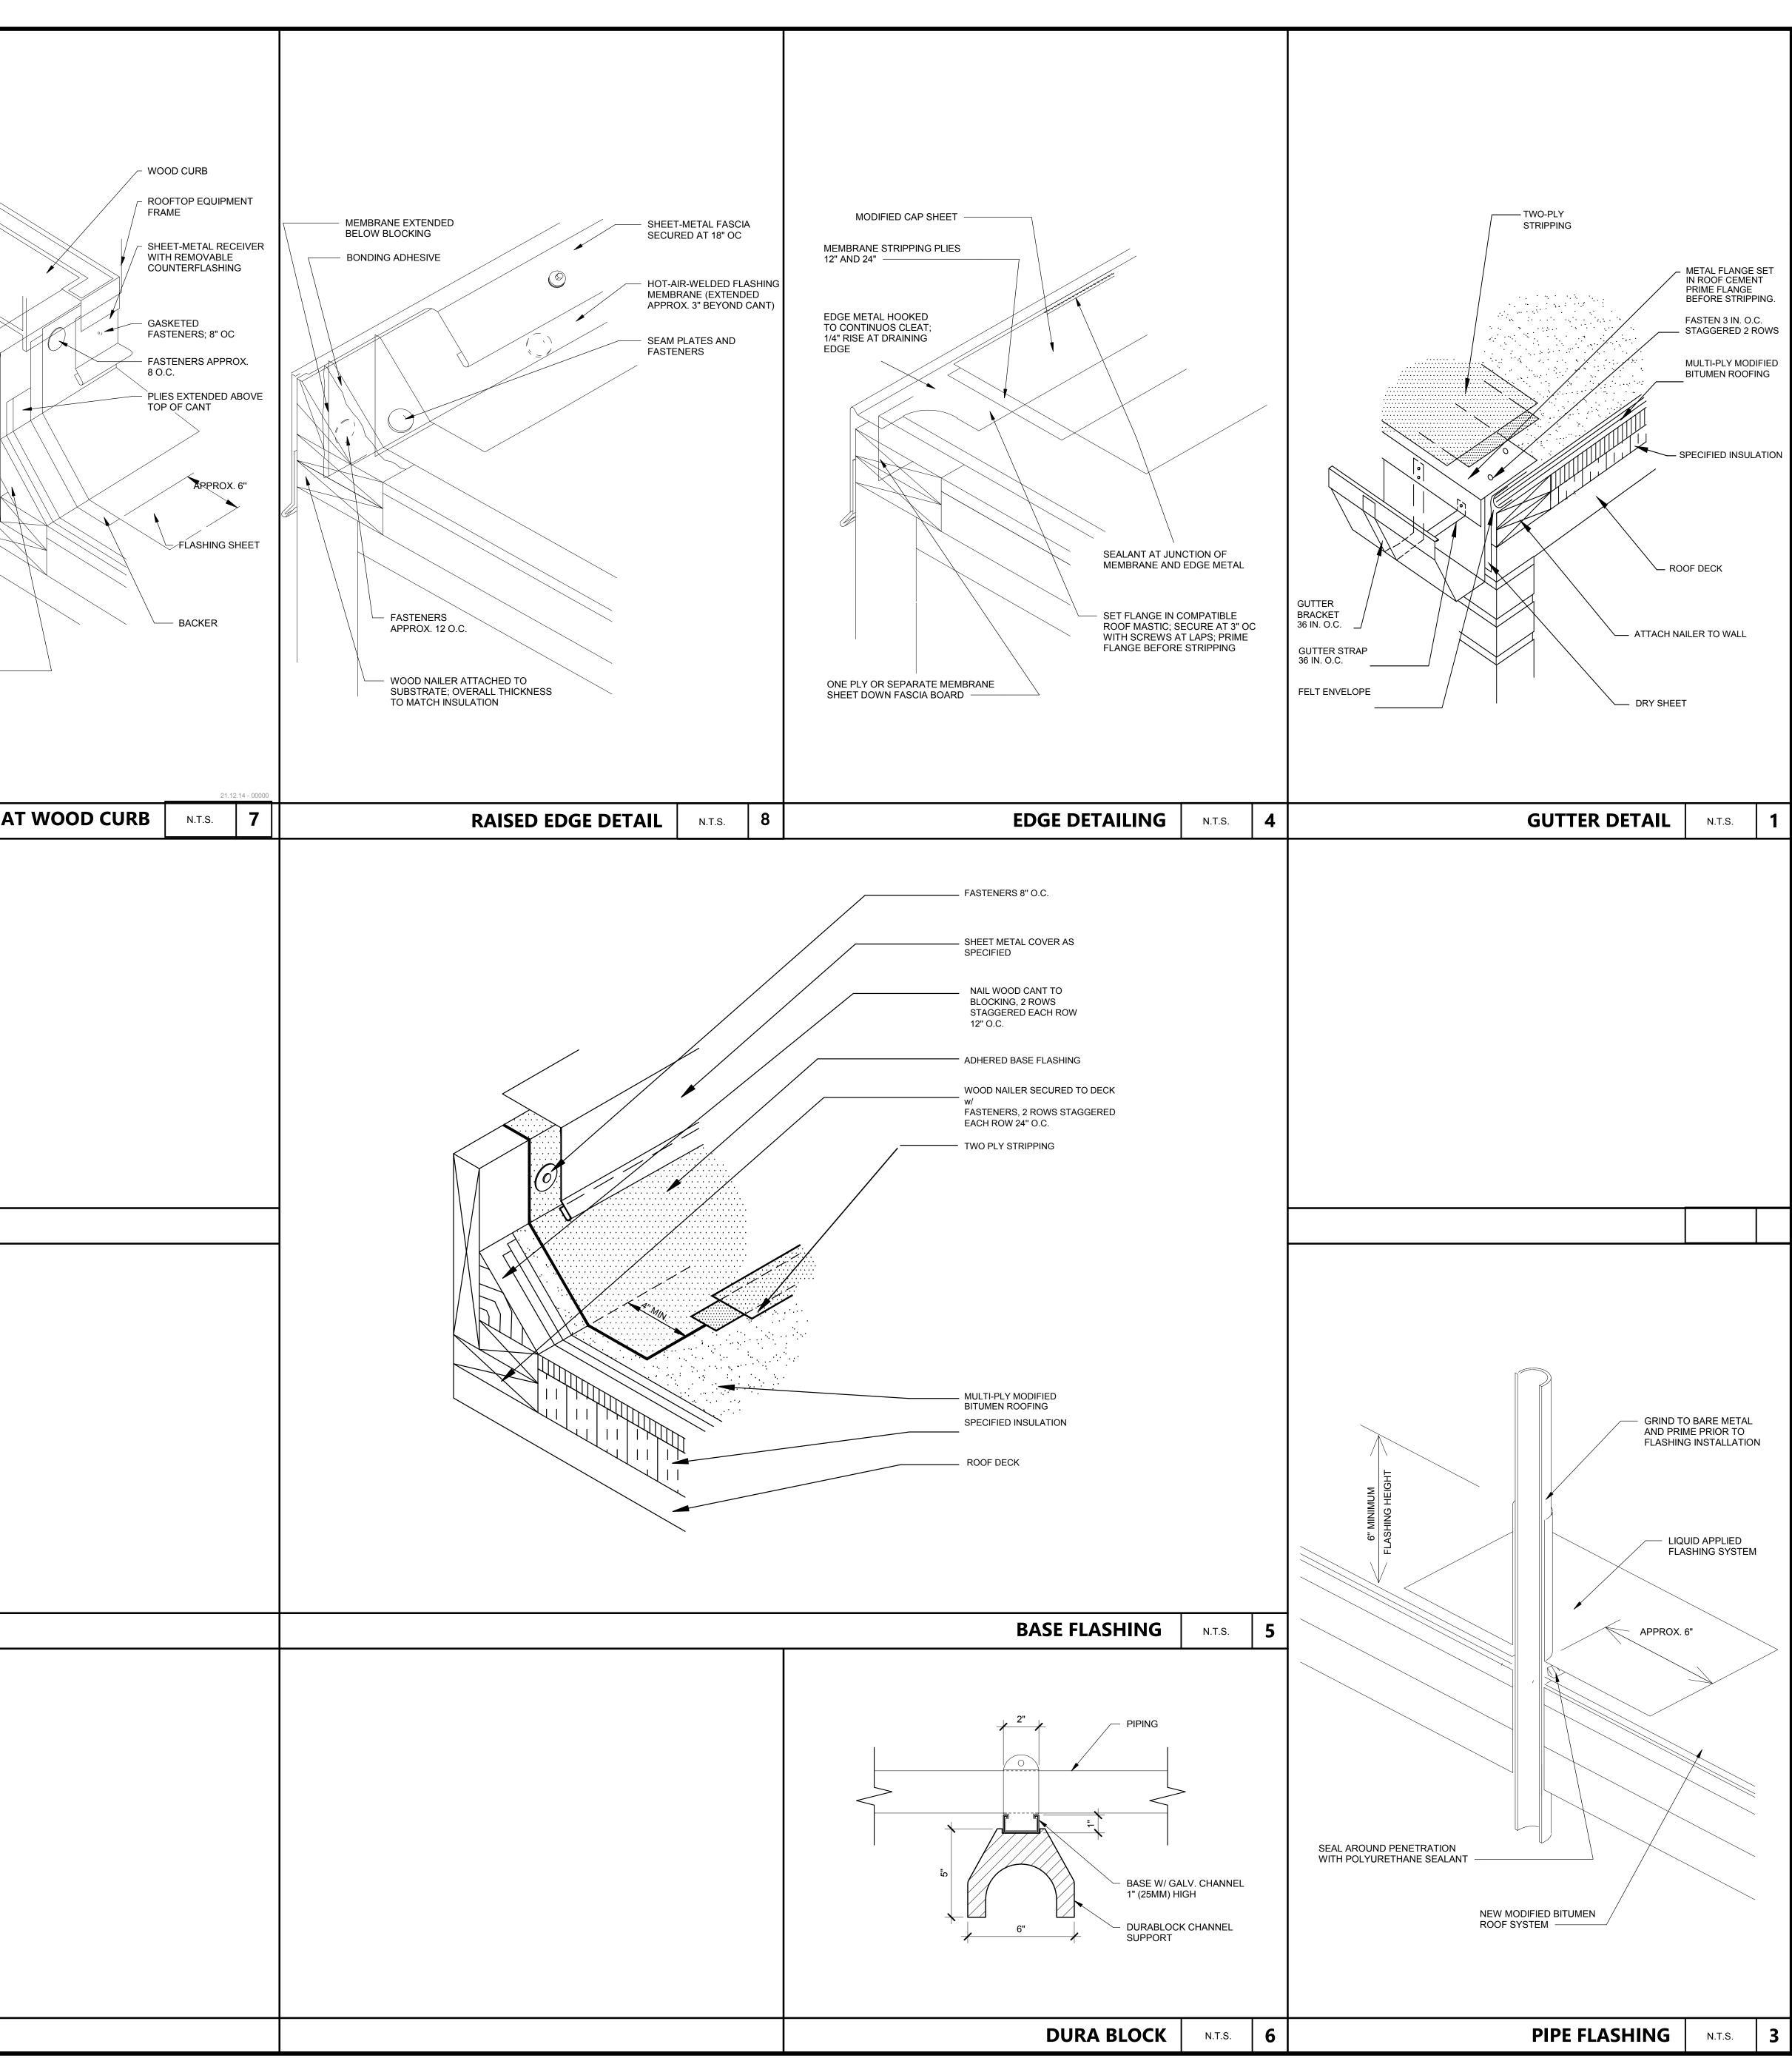

AGENCY APPROVAL BID 22-23-108			
AR	CHITECT STAMP	CONSULTANT STAMP	
REVISI NO.	ONS DATE	DESCRIPTION	
COVINA-VALLEY UNIFIED SCHOOL DISTRICT 519 E. Badillo St. Covina, CA 91723 SOUTH HILLS HIGH			
<b>SCHOOL</b> 645 Barranca street West Covina, CA 91791			
SHEET TITLE DETAILS			TUS
DRAWN BY: JOB NUMBER: SHEET NO. <b>A-701</b> DATE:			PROJECT STATUS