

Invitation to Bid

City of Canton, Ohio

Purchasing Department 218 Cleveland Ave. SW, 4th floor Canton, Ohio 44702

Contact Person	Phone No.	Email Address		
City	State	Zip		
Street Address				
Company Name				
Company Name				
	ый Ргорозаі Зивіпіцей ву.			
	Bid Proposal Submitted By:			
Bids Due				
2:00:00 PM, 8/11/2020				
Responsible Departm	ent			
Collection Systems Dep	Collection Systems Department			
Item/Project				
Large Diameter Sanitary Sewer - Cleaning & Televising - 2020				




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Bidder's Checklist: The completed Bid Form shall be accompanied by the following completed

aocume	nts:
	Pre-Bid Substitution, if any proposed substitutes have been pre-approved.
	Bid Guaranty and, if applicable Contract Bond
	Contractor's Qualification Statement
(Contractor's List of Subcontracted Work Categories
	A list identifying its DBE subcontractors and participation rates as a percentage of the
	Contract Price, and if the DBE participation goal has not been met, certification of good
f	aith efforts to meet the DBE participation goal.
7	The Project Labor Agreement (PLA) Letter of Assent (See Appendix A).
I	f this project is funded in whole or part by the Ohio Public Works Commission, then
(certification of agreement and compliance with certain statements and covenants
r	regarding Bidder's subscription to the State's Equal Employment Opportunity
F	Requirements for State-assisted Construction Contracts.



Legal Notice

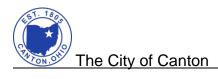
Sealed bids will be received by the City of Canton (the "City"), as provided in this notice for the <u>Large Diameter Sanitary Sewer - Cleaning & Televising - 2020</u> Project (the "Project"), Ordinance <u>2/2020</u>. Contract documents, which include additional details of the Project, are on file and available from the City of Canton's web site (https://cantonohio.gov/448/Purchasing-Procurement).

Bids shall be enclosed in a sealed envelope addressed to the City of Canton, 218 Cleveland Ave. SW, Purchasing Dept/Fourth Floor, Canton, Ohio 44702 and plainly marked on the outside "Large Diameter Sanitary Sewer - Cleaning & Televising - 2020 PROJECT BID." Bids will be received on or before 2:00 PM, local time, 8/11/2020 and will be opened shortly thereafter.

Questions regarding plans and specifications should be addressed in writing to Purchasing Department, at purchasing@cantonohio.gov.

All bids must include a Bid Guaranty, as described in the Instructions to Bidders. Prevailing wage rates apply. All bidders will be required to comply with the City Contract Compliance Program regarding equal employment opportunity. After submission and opening, no bidder may withdraw its bid within 60 days after the opening; the City reserves the right to waive irregularities, reject any or all bids, and conduct necessary investigations to determine bidder responsibility.

Published in The Repository on July 21, 2020 and July 28, 2020

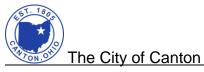

INSTRUCTIONS TO BIDDERS

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A. BIDDER'S PLEDGE AND AGREEMENT

1. Each Bidder acknowledges that this is a public project involving public funds and that the Owner expects and requires that each successful Bidder adhere to the highest ethical and performance standards. Each Bidder by submitting a bid pledges and agrees that (a) it will act at all times with absolute integrity and truthfulness in its dealings with the Owner and the Engineer, (b) it will use its best efforts to cooperate with the Owner and the Engineer and all other Contractors on the Project and at all times will act with professionalism and dignity in its dealings with the Owner, Engineer, and other Contractors, (c) it will assign only competent supervisors and workers to the Project, each of whom is fully qualified to perform the tasks that are assigned to him/her, and (d) it has read, understands and will comply with the terms of the Contract Documents.

B. EXAMINATION OF CONTRACT DOCUMENTS AND SITE CONDITIONS AND RELIANCE UPON TECHNICAL DATA

- 1. Each Bidder shall have a competent person carefully and diligently review each part of the Contract Documents, including the Divisions of the Specifications and parts of the Drawings that are not directly applicable to the Work on which the Bidder is submitting its bid. By submitting its bid, each Bidder represents and agrees, based upon its careful and diligent review of the Contract Documents, that it is not aware of any conflicts, inconsistencies, errors, or omissions in the Contract Documents for which it has not notified the Owner in writing at least ten (10) days prior to the bid opening. If there are any such conflicts, inconsistencies, errors, or omissions in the Contract Documents, the Bidder (i) will provide the labor, equipment, or materials of the better quality or greater quantity of Work and/or (ii) will comply with the more stringent requirements. The Bidder will not be entitled to any Change Order, additional compensation, or additional time on account of such conditions for any conflicts, inconsistencies, errors, or omissions that would have been discovered by such careful and diligent review, unless it has given prior written notice to the Owner.
- Each Bidder shall have a competent person carefully and diligently inspect and examine the entire site and the surrounding area, including all parts of the site applicable to the Work for which it is submitting its bid, including location, condition, and layout of the site and the location of utilities, and carefully correlate the results of the inspection with the requirements of the Contract Documents. The Bidder's bid shall include all costs attributable to site and surrounding area conditions that would have been discovered by such careful and diligent inspection and examination of the site and the surrounding area, and the Bidder shall not be entitled to any Change Order, additional compensation, or additional time on account of such conditions.
- 3. The Bidder may rely upon the general accuracy of any technical data identified in the Owner-Contractor Agreement (e.g., any soils exploration reports, soil boring logs, site survey, or abatement reports) in preparing its bid, but such technical data are not part of the Contract Documents. Except for the limited reliance described in the preceding sentence, Bidder may not, if awarded a contract for the Work, rely upon or make any Claim against the Owner or Engineer, or any of their agents or employees, with respect to any of the following:
 - a. the completeness of such reports and drawings for Bidder's purposes, including, but not limited to, any aspects of the means, methods, techniques, sequences, and procedures of construction to be employed by the successful Bidder and safety precautions and programs incident thereto; or
 - b. any interpretation by the successful Bidder of or conclusion drawn from any technical data or any such other data, interpretations, opinions, or information.

For example, all interpolations and extrapolations of data performed by the Bidder to estimate locations or quantities of subsurface strata are independent factual assumptions, which Owner does not warrant.

4. Each Bidder will be deemed to have actual knowledge of all information provided or discussed at the pre-bid meeting.

C. OWNER & ENGINEER

The Owner is:

The City of Canton 218 Cleveland Avenue SW Canton, OH 44702 Telephone: 330.489.3245 Fax: 330.489.3499

The Owner's Representative is:

Doug Harris

2. The Design Engineer for the Project is:

Burgess & Niple Inc. 50 S Main St, Suite 600 Akron, Ohio 44308

D. PROJECT

- The Project and Work for the Project consists of all labor, materials, equipment, and services necessary for construction of the project identified as <u>Large Diameter Sanitary Sewer Cleaning & Televising 2020 Project</u> ("the Project"), all in accordance with the Drawings and Specifications prepared by the Engineer and/or Owner. The Project must be substantially complete by the Date for Substantial Completion set forth in Section Q below.
- 2. The Mayor <u>has not</u> determined that a Project Labor Agreement ("PLA") will advance the City's procurement interest in cost, efficiency, and quality while promoting labor-management stability as well as compliance with applicable legal requirements governing safety and health, equal employment opportunity, labor and employment standards, and other related matters. Any such PLA shall be negotiated by the Mayor of the Owner with the East Central Ohio Building and Construction Trades Council and its affiliated local unions, or said Council's successor. The successful Bidder shall comply with and adhere to all of the provisions of any PLA for the Project.
- 3. A pre-bid conference will be held at **N/A** on **N/A** at **N/A**.

E. WORK

- This Project includes <u>sewer cleaning, internal sewer televising (CCTV)</u>, and the like as set forth in the Contract Documents.
- 2. Alternate No. 1 for this Project is **N/A**.
- 3. Alternate No. 2 for this Project is N/A.



- 4. Only one contract will be issued by the Owner for constructing the Project, the General Contract, which will cover all scopes of work necessary to construct the Project.
- The Contractor awarded the General Contract (General Contractor) will be responsible for the performance and coordination of any and all subcontractors and suppliers either directly or indirectly contracted with the General Contractor.
- 6. Owner will provide Bidders access to the Project site to conduct such examinations, investigations, explorations, tests, and studies as Bidder deems necessary for submission of a Bid. Bidder shall fill all holes, clean up, and restore the Site to its former condition upon completion of such explorations, investigations, tests, and studies. Bidder shall comply with all applicable laws, regulations and Owner's policies relative to excavation and utility locates. Bidders may contact Doug Harris, The City of Canton, at doug.harris@cantonohio.gov or 330-438-6944 if they have any interest in accessing the Project site, independent of any pre-bid meeting.

F. ESTIMATE OF COST

1. The total estimated construction cost for the Base Bid Work for the Project for which bids are being solicited at this time is **\$1,745,000.00**.

The estimated cost for Alternate 1 - N/A is: .

The estimated cost for Alternate 2 - N/A is: .

G. CONTRACT DOCUMENTS

The Contract Documents consist of the documents listed in Section 1 of the Owner-Contractor Agreement.

Bidders may view and download copies of the Contract Documents from The City of Canton Purchasing web site at https://cantonohio.gov/448/Purchasing-Procurement, which is the only authorized source of the Contract Documents. The City of Canton's sourcing tool, Vendor Registry, will maintain the Bidder's list and will provide notice and copies of Addenda as issued. It is the responsibility of any person or organization interested in a hard copy of the Contract Documents to pay all costs associated with printing.

Bidders shall use complete sets of Contract Documents in preparing bids. Neither the Owner nor the Design Engineer assumes any responsibility for errors or misinterpretations resulting from the use of incomplete sets of Contract Documents.

The Owner, in making the Contract Documents available on the above terms, does so only for the purpose of obtaining bids on the Work and does not confer a license or grant for any other use.

H. PREPARATION OF BIDS

- All bids must be submitted on the "Bid Form" furnished with the Contract Documents.
- 2. All blank spaces shall be filled in, in ink or typewritten, in words and figures, and in figures only where no space is provided for words, and signed by the Bidder. The wording on the Bid Form shall be used without change, alteration, or addition. Any change in the wording or omission of specified accompanying documents may cause the bid to be rejected. If there is an inconsistency or conflict in the Bid, the lowest amount shall control, whether expressed in numbers or words.
- 3. Bidders shall note receipt of Addenda on the Bid Form. If the Bidder fails to acknowledge receipt of each Addendum, the Bid shall be deemed non-responsive, unless the Bid

amount clearly and unambiguously reflects receipt of the Addendum or the Addendum involves only a matter of form and does not materially affect the price, quantity or quality of the Work to be performed.

- 4. Each Bidder shall submit an original of its bid to the Owner. The Bid Form shall be signed with the name typed or printed below the signature. A Bid shall not be submitted by facsimile transmission or any other electronic means. A Bidder that is a corporation shall sign its bid with the legal name of the corporation followed by the name of the state of incorporation and the legal signature of an officer authorized to bind the corporation to a contract.
- 5. Each Bid shall be enclosed in a sealed opaque envelope with the Bidder's name and the title of the Project printed in the upper left hand corner and addressed as follows:

The City of Canton ATTN: <u>Purchasing/Bids</u> 218 Cleveland Avenue SW Canton, OH 44702

Bids must be received at the designated location for the bid opening before 2:00:00 PM, local time, on 8/11/2020.

- 6. The completed Bid Form shall be accompanied by the following completed documents:
 - a. Pre-Bid Substitution, if any proposed substitutes have been pre-approved. (See Section K, below.)
 - b. Bid Guaranty and, if applicable Contract Bond (See Paragraph H.8, below.)
 - c. Contractor's Qualification Statement (See Paragraph I.4, below.)
 - d. Contractor's List of Subcontracted Work Categories (See Paragraph I.5, below.)
 - e. A list identifying its DBE subcontractors and participation rates as a percentage of the Contract Price, and if the DBE participation goal has not been met, certification of good faith efforts to meet the DBE participation goal. (See Section W, below.)
 - f. The Project Labor Agreement (PLA) Letter of Assent (See Appendix A).
 - g. If this project is funded in whole or part by the Ohio Public Works Commission, then certification of agreement and compliance with certain statements and covenants regarding Bidder's subscription to the State's Equal Employment Opportunity Requirements for State-assisted Construction Contracts (See Section Y, below.)
- 7. The Bidder shall take the following precautions in preparing its bid:
 - a. Sign the bid and check to ensure all blank spaces have been filled in with requested information and that the specified accompanying documents (listed in Paragraph H.6 above) have been included in a sealed opaque envelope addressed as described in Paragraph H.5 above.

- b. When the Bid Form provides for quoting either an addition or deduction for an Alternate item, indicate whether the sum named is an addition or deduction. If it is not indicated, it will be conclusively presumed that the amount is a deduction.
- c. When the Bid Form provides for quoting a unit price, the Bidder should quote the unit price as set forth in the Contract Documents as described in Paragraph M.1 below.
- d. When applicable, make sure that the Bid Guaranty is properly executed and signed by:
 - 1) The Bidder
 - 2) The Surety or Sureties
- e. Make sure that the amount of the Bid Guaranty (if the Bid Guaranty is in the form of a certified check, letter of credit, or cashier's check) is for a specific sum in an amount as instructed in Paragraph H.8.a below. If the Bid Guaranty is in the form of the Bid Guaranty and Contract Bond, the amount may be left blank; if an amount is inserted, it must equal the total of the base bid and all add alternates included. If inserted, then the failure to state an amount equal to the total of the base bid and all add alternates shall make the bid non-responsive if the Owner selects alternates not included in the amount.
- f. Make sure that the appropriate bid package and scope of work is inserted in the correct space on the Bid Guaranty and Contract Bond Form. Failure to include work covered by the bid submitted may make the bid nonresponsive.

8. Bonds and Guarantees

- a. <u>Bid Guaranty</u>: Bidder shall furnish a Bid Guaranty, as prescribed in Sections 153.54, 153.57, and 153.571 of the Ohio Revised Code, in the form of either: (1) a bond for the full amount of the bid in the form of the Bid Guaranty and Contract Bond included in the Contract Documents; or (2) a certified check, cashier's check, or irrevocable letter of credit in a form satisfactory to the Owner in an amount equal to 10% of the bid. Bid amount shall be the total of all sums bid, including all add alternatives, but excluding all deduct alternatives. **NOTE:** AIA or EJCDC Bid Bond forms are not acceptable.
- b. <u>Contract Bond</u>: The successful Bidder, who, as a Bid Guaranty, submits a certified check, cashier's check, or irrevocable letter of credit in an amount equal to 10% of the bid, shall furnish a Contract Bond in the form included in the Contract Documents in an amount equal to 100% of the Contract Sum. **NOTE:** AIA or EJCDC Bond forms are not acceptable.
- c. The bond must be issued by a surety company authorized by the Ohio Department of Insurance to transact business in the State of Ohio and acceptable to the Owner. The bond must be issued by a surety capable of demonstrating a record of competent underwriting, efficient management, adequate reserves, and sound investments. These criteria will be deemed to be met if the surety currently has an A.M. Best Company Policyholders Rating of "A-" or better and has or exceeds the

Best Financial Size Category of Class VI. Other sureties may be acceptable to the Owner, in its sole discretion.

- d. All bonds shall be signed by an authorized agent of an acceptable surety and by the Bidder.
- e. Surety bonds shall be supported by credentials showing the Power of Attorney of the agent, a certificate showing the legal right of the Surety Company to do business in the State of Ohio, and a financial statement of the Surety.
- f. The Bid Guaranty, as applicable, shall be in the name of or payable to the order of the Owner.
- g. The name and address of the Surety and the name and address of the Surety's Agent must be typed or printed on each bond.

9. Permits

a. Owner has obtained, or will obtain the following permits for the Project, as applicable:

NA

 Contractor shall secure and pay for all other permits necessary to complete the Project. Owner shall pay all charges of utility owners for connections for providing permanent service to the Work.

I. METHOD OF AWARD

- All bids shall remain open for acceptance for sixty (60) days following the day of the bid opening, but the Owner may, in its sole discretion, release any bid and return the Bid Guaranty prior to that date. The Bid Guaranty shall be subject to forfeiture, as provided in the Ohio Revised Code, if a bid is withdrawn during the period when bids are being held.
- 2. The Owner reserves the right to reject any, part of any, or all bids and to waive any informalities and irregularities. The Bidder expressly acknowledges this right of the Owner to reject any or all bids or to reject any incomplete or irregular bid. Bidders must furnish all information requested on the Bid Form. Failure to do so may result in disqualification of the bid.
- 3. Determination of the Lowest and Best Bid. Subject to the right of the Owner to reject any or all bids, pursuant to the Codified Ordinances of Canton Chapters 105, 182, and 507. the Owner will award the Contract for the Work to the bidder submitting the lowest and best bid, taking into consideration accepted alternates. In evaluating bids, the Owner will consider the qualifications of the Bidders, whether or not the bids comply with the prescribed requirements, and alternates and unit prices, if requested, on the Bid Form. The Owner may also consider the qualifications and experience of subcontractors and suppliers. The Owner may conduct such investigations as are deemed necessary to establish the qualifications and financial ability of the Bidder and its subcontractors and suppliers. The factors the Owner may consider in determining which bid is the lowest and best include the factors set forth below, including the Additional Criteria. Depending upon the type of work, the Owner, in its discretion, may also consider other essential factors, as the Owner may determine and as are included in the Specifications. The Owner, in its discretion, may consider and give such weight to these criteria as it deems appropriate. The Owner, in its discretion, reserves the right to request additional

information and documentation relating to these criteria from Bidders after the bid opening.

- a. Work to be subcontracted. The Bidder must identify all work to be subcontracted. See paragraph I.5 below. All subcontractors are subject to the approval of the Owner based on the criteria set forth in this Section I.
- b. The Bidder's work history. The Bidder should have a record of consistent customer satisfaction and of consistent completion of projects, including projects that are comparable to or larger and more complex than the Owner's Project, on time and in accordance with the applicable Contract Documents, and based upon the Bidder's claims history. If the Bidder's management operates or has operated another construction company, the Owner may consider the work history of that company in determining whether the Bidder submitted the lowest and best bid.

The Owner will consider the Bidder's prior experience on other projects of similar scope and/or complexity including prior projects with the Owner and/or Design Professional, including the Bidder's demonstrated ability to complete its work on these projects in accordance with the Contract Documents and on time, and will also consider its ability and capacity to perform a substantial portion of the project with its own forces and its ability to work with the Owner and Engineer as a willing, cooperative, and successful team member. Bringing overstated claims, an excessive number of claims, acting uncooperatively, and filing lawsuits against project owners and/or their design professionals on prior projects of similar scope and/or complexity will be deemed evidence of a Bidder's inability to work with the Owner and Engineer as a willing, cooperative, and successful team member.

The Bidder authorizes the Owner and its representatives to contact the owners and design professionals (and construction managers, if applicable) on projects on which the Bidder has worked and authorizes and requests such owners and design professionals (and construction managers) to provide the Owner with a candid evaluation of the Bidder's performance. By submitting its bid, the Bidder agrees that if it or any person, directly or indirectly, on its behalf or for its benefit brings an action against any of such owners or design professionals (or construction managers) or the employees of any of them as a result of or related to such candid evaluation, the Bidder will indemnify and hold harmless such owners, design professionals (and construction managers) and the employees of any of them from any claims, whether or not proven, that are part of or are related to such action and from all legal fees and expenses incurred by any of them arising out of or related to such legal action. This obligation is expressly intended for the benefit of such owners, design professionals (and construction managers), and the employees of each of them.

- c. The Bidder's prior history regarding timeliness of performance, quality of work, the Bidder's history of filing claims and having claims filed against it, extension requests, fines and penalties imposed and payments thereof, and contract defaults, with explanations.
- d. The Bidder's compliance with federal, state, and local laws, rules, and regulations, including but not limited to the Occupational Safety and Health Act, Ohio Prevailing Wage laws, Davis Bacon, and Ohio ethics laws.
- e. The Bidder's prior experience with similar work on comparable or more complex projects.

- f. The number of years the Bidder has been actively engaged as a contractor in the construction industry.
- g. The Bidder's recent experience record in the construction industry, including the original contract price for each construction job undertaken by the bidder, the amount of any change orders or cost overruns on each job, the reasons for the change orders or cost overruns, and the bidder's record for complying with and meeting completion deadlines on construction projects.
- h. A public entities' determination, within the previous five years, that the Bidder was not a responsible bidder, the reasons given by the public entity, and the Bidder's explanation thereof.
- The Bidder's financial ability to complete the Contract successfully and on time without resort to its Surety.
- j. Financial responsibility demonstrated by the Bidder and whether Bidder possesses adequate resources and availability of credit, the means and ability to procure insurance and acceptable performance bonds required for the Project and whether any claims have been made against performance bonds secured by the bidder on other construction projects.
- k. Any suspension or revocations of any professional license of any director, officer, owner, or managerial employees of the Bidder, to the extent that any work to be performed on this Project is within the field of such licensed profession.
- I. The Bidder's equipment and facilities.
- m. The size and experience of the Bidder's work force and the Bidder's ability to complete the Contract successfully and on time.
- n. The experience and the continuity of the Bidder's work force including the project manager and project superintendent's tenure with the Bidder.
- o. The Bidder's participation in a drug-free workplace program acceptable to the Owner, and the Bidder's record for both resolved and unresolved findings of the Auditor of State for recovery as defined in Section 9.24 of the Ohio Revised Code.
- p. The Owner's prior experience with the Bidder's surety.
- q. The Bidder's interest in the Project as evidenced by its attendance at any pre-bid meetings or conferences for bidders.
- r. The adequacy, in numbers and experience, of the Bidders' work force to complete the Contract successfully and on time.
- s. The foregoing information with respect to each of the Subcontractors and Suppliers that the Bidder intends to use on the Project.
- 4. <u>Qualifications Statement</u>. Each Bidder will submit with its bid a completed Contractor Qualifications Statement, which is included with the Contract Documents, and thereafter provide the Owner promptly with such additional information as the Owner may request regarding the Bidder's qualifications. A Bidder shall submit any requested additional information within three (3) business days of the date on the request.

- 5. <u>List of Subcontracted Work Categories.</u> Each Bidder will submit with its bid a completed list of Subcontracted Work Categories, which is included with the Contract Documents, and thereafter provide the Owner promptly with such additional information as the Owner may request regarding the Bidder's qualifications. A Bidder shall submit any requested information within three (3) business days of the date on the request.
- 6. <u>Additional Criteria for Determining Lowest and Best Bid.</u> Pursuant to the Codified Ordinances of the City of Canton, Chapter 105, the Owner, in its discretion, may consider any or all of the Additional Criteria below in determining which bid is lowest and best.
 - a. Any OSHA violations within the previous three years, as well as all notices of OSHA citations filed against the Bidder in the same three year period, together with a description and explanation of remediation or other steps taken regarding such violations and notices of violation.
 - b. Any violations within the previous five years pertaining to unlawful intimidation or discrimination against any employee by reason of race, creed, color, disability, gender, or national origin, and/or violation of any employee's civil or labor rights or equal employment opportunities.
 - c. Any litigation in which the Bidder has been named as a defendant or third party defendant in an action involving a claim for personal injury or wrongful death arising from performance of work related to any project in which it has been engaged within the previous five years. Bidders shall provide copies of pleadings.
 - d. Allegations of violations of the prevailing wage law and any other state or federal labor law, including, but not limited to, child labor violations, failure to pay wages, or unemployment insurance tax delinquencies or unfair labor practices within the past five years.
 - e. Violations of the workers compensation law.
 - f. Any criminal convictions or criminal indictments, involving the Bidder, its officers, directors, owners, and/or managers within the past five years.
 - g. Any violation within the past five years or pending charges concerning federal, state, or municipal environmental and/or health laws, codes, rules, and/or regulations.
 - h. Documentation that the Bidder provides health insurance and pension benefits to its employees.
 - i. Whether the Bidder participates in a bona fide apprenticeship program that is approved by the Ohio State Apprenticeship Council and the United States Department of Labor.
 - j. Whether the Bidder has adopted and implemented a comprehensive drug and alcohol testing program for its employees.
 - k. Whether the Bidder's employees are OSHA-10 and/or OSHA-30 certified.
 - I. The Bidder's commitment to comply with the Owner's Contract Compliance Program regarding equal employment opportunity. Each Bidder shall file contract employment reports with the Owner's contracting agency or as may be directed by the Owner or its representative. Such contract employment reports shall include such information as to the employment practices, policies, programs, and statistics of the Bidder and shall be in such form as the Owner may prescribe.

- m. The foregoing information with respect to each of the Subcontractors and Suppliers that the Bidder intends to use on the Project.
- 7. The failure to submit information that Owner has the right to receive under these Instructions to Bidders on a timely basis may result in the determination that the Bidder has not submitted the lowest and best bid.
- 8. By submitting its bid, the Bidder agrees that the Owner's determination of which bidder is the lowest and best bidder shall be final and conclusive, and that if the Bidder or any person on its behalf challenges such determination in any legal proceeding, the Bidder will indemnify and hold the Owner and its employees and agents harmless from any claims included or related to such legal proceeding, and from legal fees and expenses incurred by the Owner, its employees, or agents that arise out of or are related to such challenge.
- **9.** After bid opening, within three (3) business days of a request made by the Owner, the apparent low Bidder and any other Bidder so requested by the Owner must submit the following:

For all subcontracts with an estimated value of at least \$50,000, a list of all Subcontractors that the Bidder will use to construct the Project, as well as an indication of whether or not the Bidder has ever worked with a proposed Subcontractor before, including the following information for the three most recent projects on which the Bidder and each Subcontractor have worked together:

- i. Project Owner
- ii. Project Name
- iii. Subcontract Scope
- iv. Subcontract Value
- v. Owner's contact name and phone number.

If Bidder and a proposed Subcontractor have not worked together on at least three projects in the past five years, Bidder must submit the information set forth above for the three most recent similar projects to the Project that a proposed Subcontractor has worked on.

The above Subcontractor information, as well as the criteria set forth in Paragraph I.3 herein, as it pertains to each Subcontractor may be used in the Owner's determination of the lowest and best bid.

Once a Bidder identifies its proposed Subcontractors as set forth in this Paragraph I.9, the list shall not be changed unless written approval or direction for the change is made by Owner.

- 10. Additional Post-Bid Submittals
 - a) Affidavit as to Personal Property Taxes. The successful Bidder shall submit, prior to the time of the entry into the Contract, an affidavit in the form required by Section 5719.042, Ohio Revised Code, regarding the status of the Bidder's personal property taxes. A copy of the affidavit form is included with the Contract Documents.
- 11. The Owner reserves the right to disqualify bids, before or after opening, upon evidence of collusion with intent to defraud or other illegal practices on the part of the Bidder.

12. <u>Award of Contract</u>. The award of the Contract will only be made pursuant to approval of the City's Board of Control.

J. EXECUTION OF CONTRACT

1. Within the time designated by the Owner after award of the Contract, the successful Bidder shall execute and deliver to the Owner the required number of copies of the Owner-Contractor Agreement, in the form included in the Contract Documents, and all accompanying documents requested, including, but not limited to, a Contract Bond (if applicable), insurance certificates, and a valid Workers' Compensation Certificate. The successful Bidder shall have no property interest or rights under the Owner-Contractor Agreement until the Agreement is executed by the Owner.

K. SUBSTITUTIONS/NON-SPECIFIED PRODUCTS

- 1. Certain brands of material or apparatus may be specified. Should this be the case, each bid will be based on these brands, which may be referred to in the Contract Documents as Standards. The use of another brand (referred to as a substitution or proposed equal in the Contract Documents, when a bidder or the contractor seeks to have a different brand of material or apparatus than that specified approved by the Owner of use in the Project) may be requested as provided herein. Substitutions, however, will not be considered in determining the lowest and best bid.
- 2. The products specified in the Contract Documents establish a standard of required function, dimension, appearance, and quality.
- 3. Bidders wishing to obtain approval to bid non-specified products shall submit written requests to the Owner a minimum of seven (7) working days before the bid date and hour. To facilitate the submission of requests, a Substitution Form is included in the Contract Documents. The Bidder shall include the name of the material or equipment for which it is to be substituted and a complete description of the proposed substitution, including the name of the proposed manufacturer and/or product and a complete description of the product including the manufacturer's name and model number or system proposed, drawings, product literature, performance and test data, color selections or limitations, and any other information necessary for evaluation. Include a statement including any changes in other materials, equipment, or other work that would be required if the proposed product is incorporated in the work. The burden of proof of the merit of the proposed product is on the proposer. The Owner's decision on approval of a proposed product will be final.

The following will be cause for rejection of a proposed substitution:

- a. Requests submitted by subcontractors, material suppliers, and individuals other than Bidders:
- b. Requests submitted without adequate documentation;
- c. Requests received after the specified cut-off date;
- d. Requests, which in the sole discretion of the Owner, do not offer a sufficient benefit to the Project.
- 4. When the Owner approves a product submission before receipt of bids, the approval will be included in an Addendum, and Bidders may include the pricing of this product in their bid. Bidders shall not rely on approvals made in any other manner.

The City of Canton

- In proposing a non-specified product or a substitution, the Bidder represents and warrants that each proposed product will not result in any changes to the Project, including changes to the Work or other contractors, or any decrease in the performance of any equipment or systems to be installed in the Project and agrees to pay any additional costs incurred by the Owner and the Owner's consultants as a result of a nonspecified or substitute product that is accepted.
- 6. If an addendum is issued approving a substitution for a specified Standard, any Bidder proposed to use said substitution must indicate so with its Bid, using the form provided.
- 7. Following the award of the Contract, there shall be no substitution for specified products, except pursuant to a Change Order. The Owner in its sole discretion may decline to consider a substitution for a Change Order.
- The Owner reserves the right to value engineer any item within the specifications if it is 8. deemed to be in the best interest of the Owner.

L. **ALTERNATES**

- The Owner may request bids on alternates. At the time of awarding the Contract, the 1. Owner will select or reject alternates as it determines is in its best interest. A Bidder's failure to include on its Bid Form the cost of an alternate selected by the Owner and applicable to the Bidder's work shall render the bid non-responsive and be grounds for the rejection of the bid. Otherwise, the failure to include the cost of an alternate will not be deemed material.
- 2. The Bidder acknowledges that although there is an estimate for the cost of the Project, the market conditions may and frequently do result in the estimate being different from the sum of the bids received, either higher or lower. The Bidder understands that the Owner may include alternates, which may include deduct alternates as well as add alternates, to give it flexibility to build the Project with the funds available. The Bidder further understands and acknowledges that use of add and deduct alternates is a long held customary practice in the construction industry in the State of Ohio. The Bidder also acknowledges that the Owner will not make a decision about the alternates on which to base the award of contracts until the bids are received, and the Owner can compare its available funds with the base bids and the cost or savings from selecting different alternates. The Bidder understands that the award to the Bidder submitting the lowest and best bid will be based on the base bid plus selected alternates, and may result in an award to a Bidder other than the Bidder that submitted the lowest base bid.

UNIT PRICES М.

1. Where unit prices are requested in the Bid Form the Bidder should quote a unit price. Unless otherwise expressly provided in the Contract Documents, such unit prices shall include all labor, materials, and services necessary for the timely and proper installation of the item for which the unit prices are requested. The unit prices quoted in the bid shall be the basis for any Change Orders entered into under the Owner-Contractor Agreement, unless the Owner determines that the use of such unit prices will cause substantial inequity to either the Contractor or the Owner.

ADDENDA N.

All guestions should be submitted in writing at least five (5) business days prior to the bid 1. opening. This is 8/4/2020, 2:00:00 PM. The Owner reserves the right to issue Addenda changing, altering, or supplementing the Contract Documents prior to the time set for receiving bids. The Owner will issue the Addenda to clarify bidders' questions and/or to change, alter, or supplement the Contract Documents.

- 2. Any explanation, interpretation, correction, or modification of the Contract Documents will be issued in writing in the form of an Addendum, which shall be the only means considered binding; explanations, interpretations, etc., made by any other means shall NOT be legally binding. All Addenda shall become a part of the Contract Documents.
- 3. All Addenda will be issued, except as hereafter provided, via the current City bid tool at least seventy-two (72) hours prior to the published time for the opening of bids, excluding Saturdays, Sundays, and legal holidays. If any Addendum is issued within such seventy-two (72) hour period, then the time for opening of bids shall be extended one (1) week with no further advertising of bids required.
- 4. Copies of each Addendum will be posted via the Owner's current bid tool and it is the responsibility of the bidder or any other interested party to check the bid tool for any updates or addenda. Receipt of Addenda shall be indicated by Bidders in the space provided on the Bid Form. Bidders are responsible for acquiring issued Addenda in time to incorporate them into their bid. Bidders should check the Owner's bid tool prior to the bid opening to verify the number of Addenda issued.
- 5. Each Bidder shall carefully read and review the Contract Documents and immediately bring to the attention of the Owner any error, omission, inconsistency, or ambiguity therein.
- 6. If a Bidder fails to indicate receipt of all Addenda through the last Addendum issued by the Owner on its Bid Form, the bid of such Bidder will be deemed to be responsive only if:
 - The bid received clearly indicates that the Bidder received the Addendum, such as where the Addendum added another item to be bid upon and the Bidder submitted a bid on that item; or
 - b. The Addendum involves only a matter of form or is one which has either no effect or has merely a trivial or negligible effect on price, quantity, quality, or delivery of the item bid upon.

O. INTERPRETATION

- 1. If a Bidder contemplating submitting a bid for the proposed Project is in doubt as to the true meaning of any part of the Contract Documents, it may submit a written request for an interpretation thereof to the Owner at purchasing@cantonohio.gov. Requests received fewer than 5 days prior to bid opening may not be answered. Any interpretation of the proposed documents will be made by Addendum only and will be made available by the City's web tool. The Owner will not be responsible for any other explanation or interpretation of the proposed documents.
- 2. In interpreting the Contract Documents, words describing materials that have a well-known technical or trade meaning, unless otherwise specifically defined in the Contract Documents, shall be construed in accordance with the well-known meaning recognized by the trade.
- 3. Bidders are responsible for notifying the Owner in a timely manner of any ambiguities, inconsistencies, errors, or omissions in the Contract Documents. The Bidder shall not, at any time after the execution of the Contract, be compensated for a claim alleging insufficient data, incomplete Contract Documents, or incorrectly assumed conditions

regarding the nature or character of the Work, if no request was made by the Bidder prior to the bid opening.

P. STATE SALES AND USE TAXES

The Owner is a political subdivision of the State of Ohio and is exempt from taxation under the Ohio Sales Tax and Use Tax Laws. Building materials that the successful Bidder purchases for incorporation into the Project will be exempt from state sales and use taxes if the successful Bidder provides a properly completed Ohio Department of Taxation Construction Contract Exemption Certificate to the vendors or suppliers when the materials are acquired. The Owner will execute properly completed certificates on request.

Q. DATE FOR SUBSTANTIAL COMPLETION/DATE FOR FINAL COMPLETION/LIQUIDATED DAMAGES

- 1. <u>Dates for Substantial Completion</u>. The Contract Time shall run from the date of the Notice to Proceed or if there is no Notice to Proceed from the Effective Date of the Owner-Contractor Agreement. The Date for Substantial Completion and the Contract Time may be extended only by Change Order. **By submitting its Bid, each Bidder agrees that the period for performing its Work is reasonable.**
 - a. <u>Date for Overall Project Substantial Completion</u>. The successful Bidder shall have all of its Work on the Project Substantially Complete (as Substantial Completion is defined in the Contract Documents) by the following date as applicable to the Bidder's scope of work.

Date for Substantial Completion (aka Contract Time) expressed as calendar days from Notice to Proceed:

180 calendar days

2. Liquidated Damages.

- a. Overall Project Substantial Completion. If the successful Bidder does not have its Work Substantially Complete by its Date for Substantial Completion or Finally Complete within thirty (30) calendar days of achieving Substantial Completion, whichever may be applicable, the successful Bidder shall pay the Owner and the Owner may set off from amounts otherwise due the successful Bidder Liquidated Damages. The daily amounts of Liquidated Damages for Overall Project Substantial Completion are set forth in the tables included in the Owner-Contractor Agreement. The total amount of Liquidated Damages will be calculated based on the total number of calendar days beyond the Date for Substantial Completion that the Bidder's Work is not Substantially Complete or to the extent that its Work is not Finally Complete more than thirty (30) calendar days after the Substantial Completion of its Work, i.e., number of late days times the per diem rate(s) for Liquidated Damages in the tables.
- 3. The Bidder acknowledges and agrees, by submitting its bid for the Work and entering into a Contract with the Owner, that such amounts of Liquidated Damages represent a reasonable estimate of the actual damages for loss of or interference with the intended use of the Project that the Owner would incur if the Bidder's Work is not Substantially Complete by its Date for Substantial Completion and/or not Finally Complete by thirty (30) days of the Date of Substantial Completion. The Bidder further acknowledges, agrees and understands that it may seek an extension of the Contract Time (and its Date for Substantial Completion) to avoid or reduce Liquidated Damages by properly following the Claim procedures in the Contract Documents.



R. OWNER'S RIGHT TO WAIVE DEFECTS AND IRREGULARITIES

 The Owner reserves the right to waive any and all irregularities provided that the defects and irregularities do not affect the amount of the bid in any material respect or otherwise give the Bidder a competitive advantage.

S. MODIFICATION/WITHDRAWAL OF BIDS

- 1. <u>Modification</u>. A Bidder may modify its bid by written communication to the Owner at any time prior to the scheduled closing time for receipt of bids, provided such written communication is received by Owner prior to the bid deadline. The written communication shall not reveal the bid price, but should provide the addition or subtraction or other modification so that the final prices or terms will not be known until the sealed bid is opened. If the Bidder's written instructions with the change in bid reveal the bid amount in any way prior to the bid opening, the bid may be rejected as non-responsive.
- 2. <u>Withdrawal Prior to Bid Deadline</u>. A Bidder may withdraw its bid at any time for any reason prior to the bid deadline for the opening of bids established in the Legal Notice. The request to withdraw shall be made in writing to and received by the Owner prior to the time of the bid opening.
- 3. Withdrawal after Bid Deadline.
 - a. All bids shall remain valid and open for acceptance for a period of at least 60 days after the bid opening; provided, however, that a Bidder may withdraw its bid from consideration after the bid deadline when all of the following apply:
 - (1) the price bid was substantially lower than the other bids;
 - (2) the reason for the bid being substantially lower was a clerical mistake, rather than a mistake in judgment, and was due to an unintentional and substantial error in arithmetic or an unintentional omission of a substantial quantity of work, labor, or material;
 - (3) the bid was submitted in good faith; and
 - (4) the Bidder provides written notice to the Owner within two (2) business days after the bid opening for which the right to withdraw is claimed.
 - b. No bid may be withdrawn under this provision if the result would be the awarding of the contract on another bid for the bid package from which the Bidder is withdrawing its bid to the same Bidder.
 - c. If a bid is withdrawn under this provision, the Owner may award the Contract to another Bidder determined by the Owner to be the lowest and best bidder or the Owner may reject all bids and advertise for other bids. In the event the Owner advertises for other bids, the withdrawing Bidder shall pay the costs incurred in connection with the rebidding by the Owner, including the cost of printing new Contract Documents, required advertising, and printing and mailing notices to prospective bidders, if the Owner finds that such costs would not have been incurred but for such withdrawal.

T. COMPLIANCE WITH APPLICABLE LAWS

- By submitting a bid for Work on the Project, the Bidder acknowledges that it is in compliance with applicable federal, state, and local laws and regulations, including, but not limited to, the following:
 - a. Equal Employment Opportunity/Nondiscrimination. The Bidder agrees that if it is awarded a contract that in the hiring of employees for performance of work under the contract or any subcontract, neither it nor any subcontractor, or any person acting on its behalf or its subcontractor's behalf, by reason of race, creed, sex, disability as defined in Section 4112.01 of the Ohio Revised Code, or color, shall discriminate against any citizen of the state in the employment of labor or workers who are qualified and available to perform work to which the employment relates. The Bidder further agrees that neither it nor any subcontractor or any person on its behalf or on behalf of any subcontractor, in any manner, shall discriminate against or intimidate any employees hired for the performance of the work under the contract on account of race, creed, sex, disability as defined in Section 4112.01 of the Ohio Revised Code, or color.
 - b. <u>Ethics Laws</u>. The Bidder represents that it is familiar with all applicable ethics law requirements, including without limitation Sections 102.04 and 3517.13 of the Ohio Revised Code, and certifies that it is in compliance with such requirements.

U. FINDINGS FOR RECOVERY

1. By submitting its bid, each Bidder certifies for reliance of the Owner that it has no unresolved finding for recovery against it issued by the Auditor of the State of Ohio on or after January 1, 2001, except as permitted by Section 9.24 (F) of the Ohio Revised Code.

V. PREVAILING WAGES - Not Applicable on the Large Diameter Sanitary Sewer Cleaning & Televising 2020 Project

1. The Project is a "Construction" project as defined in Section 4115.03 of the Ohio Revised Code. If the Project is defined as such as "Construction" project, the successful Bidder and all of its subcontractors, regardless of tier, will strictly comply with its obligation to pay a rate of wages on the Project not less than the rate of wages fixed for this Project under Section 4115.04 of the Ohio Revised Code. Additionally, the successful Bidder will comply with all other provisions of Chapter 4115 of the Ohio Revised Code.

W. DBE PARTICIPATION GOALS

1. Owner has established the following Disadvantaged Business Enterprise ("DBE") participation goal for the Project as a percentage of the Contract Price:

0%

2. Any Minority Business Enterprise ("MBE") or Woman-Owned Business Enterprise ("WBE") proposed to count towards the DBE participation goal must first be certified at bid time as an MBE or WBE under the Ohio Department of Administrative Services MBE Cross Certification Program (which includes MBEs and WBEs certified by the City of Canton), or certified as a DBE under Ohio's Unified Certification Program administered by the Ohio Department of Transportation.

- 3. <u>Documentation of DBE Participation.</u> Each Bidder must submit with its bid a list identifying its DBE subcontractors and participation rates as a percentage of the Contract Price.
- 4. <u>Certification of Good Faith Efforts.</u> If a Bidder has <u>not</u> met the DBE participation goal, it must attach to its bid, a narrative (which may include exhibits) demonstrating the good faith efforts made by the Bidder to secure DBE participation in the Project. Good faith efforts include:
 - Conducting outreach and recruiting activities;
 - Informing DBEs of the opportunity to participate in the Project at least 30 calendar days before the bid closes;
 - Considering subcontracting with a consortium of DBEs; and
 - Using the services and assistance of the Small Business Administration and Minority Development Agency of the U.S. Department of Commerce.

Owner, in its sole discretion, will be the sole evaluator of whether any particular Bidders' efforts sufficiently demonstrate good faith efforts for securing DBE participation.

- 5. <u>Challenges to Owner's Discretion</u>. If any Bidder directly challenges, or indirectly challenges through contribution of money or other resources to a third party, Owner's discretion in determining any Bidder's compliance with the DBE goal stated in these Instructions to Bidders, or good faith efforts pertaining to same, that Bidder agrees to indemnify Owner for all claims, costs, losses and damages, including attorney and consultant fees, arising out of such challenge, should there be an adjudication by a court of competent jurisdiction that the Owner did not abuse its discretion in making its determination.
- 6. <u>Failure to Comply.</u> If a Bidder is awarded a contract for the Project, and later fails to fulfill its stated DBE participation goals, that Bidder agrees to indemnify Owner for all claims, costs, losses and damages, including attorney and consultant fees, arising out of such failure. That Bidder also agrees to cooperate with all reasonable requests to determine actual DBE participation, including but not limited to certifying actual participation and providing documentation in support of same.

X. OTHER LOCAL ORDINANCE REQUIREMENTS

- 1. Each Bidder, by the act of submitting its bid agrees to withhold all City income taxes due or payable under Chapter 182 of the Codified Ordinances of the City of Canton for wages, salaries, fees, and commissions paid to its employees and further agrees that any of its subcontractors shall be required to agree to withhold any such City income taxes due for services performed under this Agreement. Bidder agrees with the Owner regarding the manner of withholding of City income taxes as provided in Section 718.011(F) of the Ohio Revised Code. Municipal income tax withholding provisions of Section 718.011(B)(1) and 718.011(D) of the Ohio Revised Code shall not apply to qualifying wages paid to employees for work done or services performed or rendered inside the City or on City property. Each Bidder agrees to withhold income tax for the City from employees' qualifying wages earned inside the City or on City property, beginning with the first day of work done or services performed or rendered inside the City.
- 2. Each Bidder, by the act of submitting its bid agrees that all steel necessary in the construction of the Work performed under the Agreement shall be steel that is produced in the United States unless a specific product which is required is not produced by manufacturers in the United States in which event this prohibition does not apply.



- 3. Each Bidder, by the act of submitting its bid agrees that all materials used in the construction covered by the Agreement shall be purchased in the Canton area except such materials which are unavailable in the Canton area.
- 4. Chapter 105.12 Local Bidder Preference.
 - a. The Board of Control, in determining the lowest and best bidder in the award of contracts to which this section is applicable, is authorized to award contracts to local bidders as hereinafter defined, whose bid is not more than five percent (5%) higher, subject to a maximum amount of twenty thousand dollars (\$20,000.00), than the lowest dollar bid submitted by non-local bidders. The Board of Control's decision in making such an award shall be final.
 - b. For purposes of this section, "local bidder" means an individual or business entity which at the time of the award of the contract has a headquarters, division, sales office, sales outlet, manufacturing facility, or similar significant business-related location in Stark County, Ohio.
 - c. All contract specifications and/or bid documents that are distributed by Canton for the purpose of soliciting bids for goods and/or services shall contain the following notice:

Prospective bidders will take notice that the City of Canton, in determining the lowest and best bidder in the award of this contract, may award a local bidder preference to any qualified bidder pursuant to Section 105.12 of the Codified Ordinances of the City of Canton. The determination of whether a bidder qualifies for the local preference shall be made by Board of Control. The Board's decision shall be final. A copy of Section 105.12 is attached.

- d. This section shall be applicable to all contracts for equipment, goods, machinery, materials, supplies, vehicles and/or services, which are purchased, leased and/or constructed at a cost in excess of fifty thousand dollars (\$50,000.00) and which require bidding pursuant to Ohio R.C. 735.05 through 735.09 and Ohio R.C. 737.03. (Ord. 115-2018. Passed 5-14-18.)
- 5. Each Bidder, by the act of submitting its bid agrees as follows during the performance of the Agreement:
 - a. The Contractor shall not discriminate against any employee or applicant for employment because of race, age, handicap, religion, color, sex, national origin, sexual orientation, or gender identity. The Contractor shall take affirmative action to insure that applicants are employed and that employees are treated during employment without regard to race, religion, color, sex, national origin, military status, sexual orientation, or gender identity. As used herein, the word "treated" shall mean and include without limitation the following: recruited, whether by advertising or other means; compensation, whether in the form of rates or pay or other forms of compensation; selected for training, including apprenticeship; promoted; demoted; upgraded; downgraded; transferred; laid off; and terminated. The Contractor agrees to and shall post in conspicuous places available to employees and applicants for employment notices to be provided by the contracting officers setting forth the provisions of this nondiscrimination clause.
 - b. The Contractor shall, in all solicitations or advertisements for employees placed by or on behalf of the Contractor, state that all qualified applicants will receive consideration for employment without regard to race, age, handicap, religion, color, sex, national origin, military status, sexual orientation, or gender identity.

- c. The Contractor shall send to each labor union or representative of workers, with which he has a collective bargaining agreement or other contract or understanding, a notice advising the labor union or workers' representative of the Contractor's commitments under the equal opportunity clause of the Owner; and it shall post copies of the notice in conspicuous places available to employees and applicants for employment.
- d. The Contractor shall submit in writing to the Owner its affirmative action plan, and each subcontractor and supplier of equipment or supplies shall submit to the Contractor its affirmative action plan. The responsibility for securing these affirmative action plans falls upon the Contractor and shall be on file at the office of the Contractor. The Contractor shall furnish all information and reports required by the Owner or its representative pursuant to the Contract Documents, and shall permit access to its books, records, and accounts by the contracting agency of the Owner and by the Executive Secretary of the Owner for purposes of investigation to ascertain compliance with the program.
- e. The Contractor shall take such action with respect to any subcontractor as the Owner may direct as a means of enforcing the provisions of this equal opportunity clause, including penalties and sanctions for noncompliance; provided, however, that in the event the Contractor becomes involved in or is threatened with litigation as is necessary to protect the interests of the Owner and to effectuate the Owner's equal opportunity program and, in the case of contracts receiving Federal assistance, the Contractor or the Owner may request the United States to enter into such litigation to protect the interests of the United States.
- f. The Contractor shall file and shall cause its subcontractors, if any, to file compliance reports with the Owner in the form and to the extent prescribed by the Owner or its representative. Compliance reports filed at such times as directed shall contain information as to the employment practices, policies, programs, and statistics of the Contractor and its subcontractors.
- g. The Contractor shall include the provisions of this equal employment opportunity clause in every subcontract or purchase order, so that such provisions will be binding upon each subcontractor or vendor.
- h. Refusal by the Contractor or subcontractor to comply with any portion of this program as herein stated and described will subject the offending party to any or all of the following penalties:
 - (1) Withholding of all future payments under the involved public contract to the Contractor in violation, until it is determined that the Contractor or subcontractor is in compliance with the provisions of the Agreement.
 - (2) Refusal of all future bids for any public contract with the Owner or any of its departments or divisions, until such time as the Contractor or subcontractor demonstrates that it has established and shall carry out the policies of the program as herein outlined.
 - (3) Cancellation of the public contract and declaration of forfeiture of the performance bond.
 - (4) In cases is which there is substantial or material violation or the threat of substantial or material violation of the compliance procedure or as may be provided by contract, appropriate proceedings may be brought to

enforce these provisions, including enjoining within applicable laws of contractors, subcontractors, or other organizations, individuals, or groups who prevent, directly or indirectly, or seek to prevent, directly or indirectly, compliance with the policy as herein outlined.

2. A Project Labor Agreement (PLA) has not been required for this project (See Appendix A if applicable). Prevailing Wages are required for this Project (See Appendix B).

Y. OHIO PUBLIC WORKS COMMISSION FUNDING

- 1. **No** When this line is checked by the Owner, e.g. with an "X" or other mark, the Project is being funded in whole or part by the Ohio Public Works Commission ("OPWC"), and the requirements of the OPWC, attached to these Instructions to Bidders, apply.
- The OPWC requirements include that the Bidder include with its bid certification of agreement and compliance with certain statements and covenants regarding its subscription to the State's Equal Employment Opportunity Requirements for Stateassisted Construction Contracts.

END OF INSTRUCTIONS TO BIDDERS

OWNER-CONTRACTOR AGREEMENT

[Where Engineer is a Third Party Hired by Owner and Engineer Has Construction Administration Duties]

Owner: Contract:

The City of Canton
218 Cleveland Avenue SW

Ordinance: 2/2020
Alternates:

Canton, OH 44702

Telephone: 330.489.3283 Contractor: Telephone:

Fax:

Project: Large Diameter Sanitary Sewer - Cleaning &

Televising - 2020

This document is an agreement between the Owner and the Contractor for the Work described in the Contract Documents related to the Contract identified above for the Project defined above and is effective as of the date the Agreement is signed by the Owner (the "Effective Date").

The Owner and the Contractor agree as set forth in the following sections:

- 1. **CONTRACT DOCUMENTS.** The Contract Documents consist of the following documents:
 - A. Legal Notice;
 - B. Instructions to Bidders;
 - C. Bid Form;
 - D. Owner-Contractor Agreement:
 - E. General Conditions of the Contract for Construction (EJCDC C-700), as modified;
 - F. Supplementary Conditions (when applicable);
 - G. Drawings:
 - H. Specifications;
 - I. Addenda issued;
 - J. Contractor's Personal Property Tax Affidavit (O.R.C. 5719.042);
 - K. Statement of Claim Form; and
 - L. Modifications issued after the execution of the contract, including:
 - i. A Change Order;
 - ii. A Work Change Directive; or,
 - iii. A written order for a minor change of the Work issued by the Owner or Engineer in accordance with the General Conditions.
 - M. __ When this line is checked by the Owner, e.g. with an "X" or other mark, the State of Ohio Department of Transportation, Construction and Material Specifications, effective as of January 1, 2019, will be a Contract Document, but only as modified by the document titled ODOT Manual Supplement, prepared by Owner.
 - 1.1 Notwithstanding anything in the Contract Documents to the contrary, in the event of any inconsistency, the provisions of this Agreement shall control over any other Contract Document, proposal, document, or other attachment. In the event inconsistencies, conflicts, or ambiguities between or among the Contract Documents

are discovered after execution of the Agreement, Contractor shall provide the better quality or greater quantity of Work or comply with the more stringent requirements.

Note: <u>Non-Contract Documents</u>. The following are the reports and tests of subsurface conditions at or contiguous to the Site, if any, that the Engineer has used in preparing the Contract Documents. These are not Contract Documents. Geotechnical data is not a warranty of subsurface conditions and is not to be relied upon as a complete representation of all possible soil conditions. It is possible that there may be other reports, and/or tests of subsurface conditions at or contiguous to the Site not prepared by or on behalf of Owner. The Owner makes no representation about such reports and/or tests, assuming they exist. Additional information, if needed by Contractor for geotechnical data or site survey, shall be obtained by the Contractor at no additional cost to Owner. The General Conditions, as modified, contain additional terms related to these reports and tests.

Contractor may rely upon the general accuracy of the "technical data" contained in such reports and drawings listed below, and except for such reliance on "technical data," Contractor shall not rely upon or make any claim against Owner or Engineer with respect to: (1) the completeness of such reports and drawings for Contractor's purposes, including, but not limited to, any aspects of the means, methods, techniques, sequences, and procedures of construction to be employed by Contractor, and safety precautions and programs incident thereto; or (2) other data, interpretations, opinions, and information contained in such reports or shown or indicated in such drawings; or (3) any Contractor interpretation of or conclusion drawn from any "technical data" or any such other data, interpretations, opinions, or information. For example, all interpolations and extrapolations of data performed by Contractor to estimate locations or quantities of subsurface strata are independent factual assumptions which Owner does not warrant. (Not applicable, if none are listed).

Note: <u>Non-Contract Documents</u>. The following are those reports and drawings related to any Hazardous Conditions at the Site, if any. These are not Contract Documents. The General Conditions, as modified, contain additional terms related to these reports and drawings. (None if none are listed).

2. <u>ENGINEER RELATIONSHIP</u>. The Contract Documents shall not be construed to create a contractual relationship of any kind between the Engineer and the Contractor or any Subcontractor or Material Supplier to the Project. The Engineer, however, shall be entitled to performance of the obligations of the Contractor intended for its benefit and to enforcement of such obligations, but nothing contained herein shall be deemed to give the Contractor or any third party any claim or right of action against the Engineer that does not otherwise exist without regard to this Contract. The Contractor and its Subcontractors shall not be deemed to be beneficiaries of any of the acts or services of the Engineer that are performed for the sole benefit of the Owner. The Contractor shall forward all communications to the Owner through the Engineer and hereby acknowledges and agrees that any instructions, reviews, advice, approvals, orders, or directives that are rendered to it by the Engineer are specifically authorized and directed by the Owner to the Contractor through the Engineer acting on behalf of the Owner.

Engineer will be performing construction administration duties as identified in the General Conditions, including, but not limited to: reviewing Applications for Payment, Change Proposals, Claims, and Shop Drawings; measuring Work quantities; and issuing Work Change Directives.

2.1 The Engineer is:

Burgess & Niple Inc.

50 S Main St, Suite 600

Akron, Ohio 44308

3. TIME FOR COMPLETION AND PROJECT COORDINATION.

- **3.1 DATE OF COMMENCEMENT.** The date of commencement of the Work shall be the date identified in the Notice to Proceed issued by the Owner, or by the Owner through the Engineer, to the Contractor, or if there is no Notice to Proceed, the Effective Date of this Agreement.
- 3.2 <u>DATE OF SUBSTANTIAL COMPLETION</u>. The Project and Work for the Project consists of all labor, materials, equipment, and services necessary for construction of the Project, all in accordance with the Drawings and Specifications prepared by the Owner or Engineer. The Contractor shall achieve Substantial Completion of its Work on the Project, as defined in the General Conditions, within <u>180</u> calendar days of the Date of Commencement ("Date of Substantial Completion"). Substantial Completion is the time at which the Work has progressed to the point where the Work is sufficiently complete, in accordance with the Contract Documents, so that the Work can be utilized for the purposes for which it is intended.
- **3.2.1 DATE OF FINAL COMPLETION.** The Contractor shall achieve Final Completion of its Work on the Project, as defined in the General Conditions, within **30 calendar days** of the Date of Substantial Completion ("Date of Final Completion"). Final Completion shall mean that the Work is complete in accordance with the Contract Documents and the Contractor has submitted to the Owner or Engineer all documents required to be submitted to the Owner or Engineer for final payment.
- **3.2.2 <u>UTILITIES AND OPERATIONS.</u>** Contractor shall not interrupt utilities to facilities or existing operations without prior written notice and approval by Owner.
- **3.2.3 SHUTDOWN DATES.** Due to events scheduled by the Owner and/or other Owner considerations, Contractor will not be able to perform Work on the Project on the following dates (there are no shutdown dates if none are listed):

Contractor's Construction Schedule for performing the Work shall account for Contractor not being able to perform Work on these dates and the contractual dates for Substantial Completion and Final Completion will not be changed due to Contractor not being able to perform Work on these dates.

- **3.3 CONSTRUCTION SCHEDULE.** The Construction Schedule shall be developed by the Contractor as provided in the Contract Documents.
- 3.4 <u>LIQUIDATED DAMAGES</u>. If the Contractor does not have its Work on the Project Substantially Complete by the specified Date for Substantial Completion or Finally Complete by the Date of Final Completion, the Contractor shall pay the Owner (and the Owner may set off from sums coming due the Contractor) Liquidated Damages in the per diem amounts as set forth in the following tables, whichever may be applicable. "Contract Amount" of the Work will be determined by totaling the cost of all line items of Work.

LIQUIDATED DAMAGES – DATE FOR SUBSTANTIAL COMPLETION OF OVERALL PROJECT

Original Contract Amount	Dollars Per Day
\$1.00 to \$500,000.00	\$ 750.00
\$500,000.01 to \$2,000,000.00	\$ 1,000.00
\$2,000,000.01 to \$10,000,000.00	\$ 1,300.00
\$10,000,000.01 to \$50,000,000.00	\$ 2,000.00
\$50,000,000.01 and greater	\$ 2,500.00

LIQUIDATED DAMAGES - FINAL COMPLETION

Original Contract Amount	<u>Dollars Per Day</u>
\$1.00 to \$500,000.00	\$ 200.00
\$500,000.01 to \$2,000,000.00	\$ 250.00
\$2,000,000.01 to \$10,000,000.00	\$ 325.00
\$10,000,000.01 to \$50,000,000.00	\$ 500.00
\$50,000,000.01 and greater	\$ 625.00

LIQUIDATED DAMAGES FOR SUBSTANTIAL COMPLETION FOR ANY INTERIM MILESTONE SCOPE WILL BE \$1,000 PER DAY FOR EACH DAY OF UNEXCUSED DELAY BEYOND THE MILESTONE.

The Contractor acknowledges that such amounts of Liquidated Damages represent a reasonable estimate of the actual damages for loss of or interference with the intended use of the Project that the Owner would incur if the Contractor's Work is not Substantially Complete by its Date for Substantial Completion or Finally Complete by the required date for Final Completion.


- 4. CONTRACT SUM (also called Contract Price). The Contract Sum to be paid by the Owner to the Contractor, as provided herein, for the satisfactory performance and completion of the Work and all of the duties, obligations, and responsibilities of the Contractor under this Agreement and the other Contract Documents is, subject to adjustment as set forth in the Contract Documents. The Contract Sum includes Allowances, Accepted Alternates, and all federal, state, county, municipal, and other taxes imposed by law, including but not limited to any sales, use, commercial activity, and personal property taxes payable by or levied against the Contractor on account of the Work or the materials incorporated into the Work. The Contractor will pay any such taxes. The Contract Sum includes the following:
 - 4.1 Base Bid Amount: (Lump Sum Bid); and
 - **4.2** Accepted Alternates, included in the Contract Sum:

Alternate No.	Description	Amount
1	N/A	
2	N/A	

4.3 Allowances included in the Contract Sum:

Allowance Description	Amount
Allowance #1: Special Pipe Cleaning Tools (Time & Material)	\$70,000.00
Allowance #2: Local Off-Duty Police Assistance with Maintenance of	\$40,000.00
Traffic (MOT)	
Allowance #3: Bypass Pumping	\$75,000.00

4.4 If after Substantial Completion of its Work, the Contractor fails to submit its final payment application with all the documents required to be submitted with such application within ninety (90) days after written notice to do so from the Owner and without prejudice to any other rights and remedies the Owner may have available to it, the balance of the Contract Sum shall become the Owner's sole and exclusive property, and the Contractor shall have no further interest in or right to such balance.

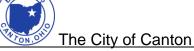

RETAINAGE. Retainage applicable to the Contract by Ohio Revised Code Sections 153.12, .13, and .14 will be withheld as defined in the Modified General Conditions. The Contractor agrees that the financial institution selected by the Owner for deposit of retained funds is acceptable to the Contractor and will sign any documents requested related to said account.

6. GENERAL.

- 6.1 MODIFICATION. No modification or waiver of any of the terms of this Agreement or of any other Contract Documents will be effective against a party unless set forth in writing and signed by or on behalf of a party. In the case of the Owner, the person executing the modification or waiver must have express authority to execute the Modification on behalf of the Owner pursuant to a resolution that is duly adopted by the Owner. Under no circumstances will forbearance, including the failure or repeated failure to insist upon compliance with the terms of the Contract Documents, constitute the waiver or modification of any such terms. The parties acknowledge that no person has authority to modify this Agreement or the other Contract Documents or to waive any of its or their terms, except as expressly provided in this section.
- **6.2 ASSIGNMENT.** The Contractor may not assign this Agreement without the written consent of the Owner, which the Owner may withhold in its sole discretion.
- **6.3 LAW AND JURISDICTION.** All questions regarding the validity, intention, or meaning of this Agreement or any modifications of it relating to the rights and obligation of the parties will be construed and resolved under the laws of the State of Ohio. Any suit, which may be brought to enforce any provision of this Agreement or any remedy with respect hereto, shall be brought in the Common Pleas Court of the county in which the Project is located and each party hereby expressly consents to the exclusive jurisdiction of such court to the exclusion of any other court, including any U.S. District Court or any other federal court.
- **6.4 CONSTRUCTION.** The parties acknowledge that each party has reviewed this Agreement and the other Contract Documents and entered into this Agreement as a free and voluntary act. Accordingly, the normal rule of construction to the effect that any ambiguities are to be resolved against the drafting party will not be employed in the interpretation of this Agreement, the other Contract Documents, or any amendments or exhibits to it or them.
- **APPROVALS**. Except as expressly provided herein, the approvals and determinations of the Owner and Engineer will be subject to the sole discretion of the respective party and be valid and binding on the Contractor, provided only that they be made in good faith, i.e., honestly. If the Contractor challenges any such approval or determination, the Contractor has the burden of proving that it was not made in good faith by clear and convincing evidence.
- **6.6 PARTIAL INVALIDITY.** If any term or provision of this Agreement is found to be illegal, unenforceable, or in violation of any laws, statutes, ordinances, or regulations of any public authority having jurisdiction, then, notwithstanding such term or provision, this Agreement will remain in full force and effect and such term will be deemed stricken; provided this Agreement will be interpreted, when possible, so as to reflect the intentions of the parties as indicated by any such stricken term or provision.
- **6.7 COMPLIANCE WITH LAWS AND REGULATIONS.** The Contractor, at its expense, will comply with all applicable federal, state, and local laws, rules, and regulations applicable to the Work, including but not limited to Chapter 4115 of the Ohio Revised Code and Sections 153.59 and 153.60 of the Ohio Revised Code, which prohibit discrimination in the hiring and treatment of employees, with respect to which the Contractor agrees to comply and to require its subcontractors to comply.

6.7.1 NON-DISCRIMINATION. Contractor agrees:


.1 That in the hiring of employees for the performance of Work under this Agreement or in any subcontract, neither the Contractor, subcontractor, or any person acting on behalf of either of them, shall by reason of race, creed, sex, disability as defined in Section 4112.01 of the Ohio Revised Code, or color discriminate against any citizen

CITY OF CANTON – OWNER-CONTRACTOR AGREEMENT

- of the state in the employment of labor or workers who are qualified and available to perform the Work to which the employment relates.
- .2 That neither the Contractor, subcontractor, nor any person acting on behalf of either of them shall, in any manner, discriminate against or intimidate any employee hired for the performance of Work under this Agreement on account of race, creed, sex, disability as defined in Section 4112.01 of the Ohio Revised Code, or color.
- .3 That there shall be deducted from the amount payable to the Contractor by the Owner under this Agreement a forfeiture of twenty-five dollars (\$25.00) as required by Ohio Revised Code Section 153.60 for each person who is discriminated against or intimidated in violation of this Agreement.
- .4 That this Agreement may be canceled or terminated by the Owner and all money to become due hereunder may be forfeited for a second or subsequent violation of the terms of this section of this Agreement.
- **PREVAILING WAGE RATES.** The Contractor and its subcontractors, regardless of tier, shall strictly comply with their obligation, if any, to pay their employees working on the Project site at the applicable prevailing wage rates for the type of work, including any changes thereto, pursuant to Ohio Revised Code Chapter 4115.
- **ETHICS.** By signing and entering into this agreement with the Owner, the Contractor represents that it is familiar with all applicable ethics law requirements, including without limitation Sections 102.04 and 3517.13 of the Ohio Revised Code, and certifies that it is in compliance with such requirements. The Contractor understands that failure to comply with the ethics laws is, in itself, grounds for termination of this contract and may result in the loss of other contracts with the Owner.
- **6.8 JOB MEETINGS.** The Contractor or one of its representatives with authority to bind the Contractor will attend all job meetings. The Owner anticipates that job meetings will be scheduled on a weekly basis during construction or as needed. The Contractor will ensure that its Subcontractors also hold regular job meetings at which safety issues and job matters are discussed as these relate to the Work being performed. Job meetings include, but are not limited to, pre-construction meetings, weekly job meetings, weekly safety tool box meetings, and monthly safety meetings.
- **6.9 PROPERTY TAX AFFIDAVIT.** The Contractor's affidavit given under Section 5719.024, Ohio Revised Code, is incorporated herein.
- **6.10** <u>WARRANTIES.</u> Notwithstanding anything to the contrary in the Contract Documents, including the Project Manual and Specifications, no warranties by Contractor shall be limited to any time shorter than the statute of limitations for written contracts in Ohio.

6.11 CONTRACTOR ATTESTATIONS.

- .1 Contractor attests that it has not scaled these contract documents to determine quantities for bids, as Contractor has field verified and taken its own dimensions to determine the quantities for its bid.
- .2 Contractor agrees that all the scales noted on the drawings are correct; so as to give it an "intent" of what is to be bid. Contractor has not relied on any other dimensions than what are noted in text and dimension lines.
- .3 Contractor has thoroughly read the Contract Documents and has asked any and all questions it has on the intent of the scope of work, or supposed errors and omissions contained in these drawings, during the bid process and prior to signing this Agreement.
- .4 Contractor will not be asserting a claim for additional time or money associated with the three issues listed above.
- .5 Contractor believes it has accurately interpreted the Contract Documents and has asked for clarification and received satisfactory response for all items not thoroughly addressed or

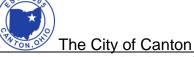

appeared to be conflicting in the Contract Documents and has found all stipulations and requirements contained in this Agreement are as stated in the bid specifications and are enforceable according to Ohio Law, including but not limited to the Owner's right of offset, and the Owner's right to assess liquidated damages for work not completed according to the milestones listed on the project schedule contained in the Contract Documents.

6.12 ENTIRE AGREEMENT. This Agreement and the other Contract Documents constitute the entire agreement among the parties with respect to their subject matter and will supersede all prior and contemporaneous, oral or written, agreements, negotiations, communications, representations, and understandings with respect to such subject matter, and no person is justified in relying on such agreements, negotiations, communications, representations, or understandings.

IN WITNESS WHEREOF, the parties have caused this Agreement to be executed by their properly authorized representatives and agree that this Agreement is effective as of the date first set forth above.

Owner: The City of Canton	Contractor:
	Ву:
By:	Name:
Name:	
Title:	Title:
Date:	Date:

CERTIFICATE (Section 5705.41, R.C.)

The undersigned, fiscal officer of the Owner, certifies that the moneys required to pay that part of the Contract Sum coming due during the current fiscal year, under the Agreement to which this Certificate is attached have been lawfully appropriated for such purpose and are in the appropriate account of the Owner, or in the process of collection to the credit of the appropriate account or fund, free from any previous encumbrances. Moneys due in excess of the Contract Sum shall require an additional and separate Fiscal Officer's Certificate.

DATED:			
	Fiscal C)fficer	

BID GUARANTY AND CONTRACT BOND

(O.R.C. § 153.571)

KNOW ALL PERSONS BY THESE PRESENTS, that we, the undersigned
("Contractor") as principal and
as surety are hereby held and firmly bound unto the City of Canton as
obligee in the penal sum of the dollar amount of the bid submitted by the principal to the obligee on
, 20, to undertake the construction of the Large Diameter Sanitary Sewer - Cleaning
& Televising - 2020 Project ("Project"). The penal sum referred to herein shall be the dollar amount of
the principal's bid to the obligee, incorporating any additive or deductive Alternates made by the principal
on the date referred to above to the obligee, which are accepted by the obligee. In no case shall the
penal sum exceed the amount of Dollars (\$
). (If the foregoing blank is not filled in, the penal sum will be the full amount of the principal's bid
including add Alternates. Alternatively, if the blank is filled in the amount stated must not be less than the
full amount of the bid including add Alternates, in dollars and cents. A percentage is not acceptable.) For
the payment of the penal sum well and truly to be made, we hereby jointly and severally bind ourselves
our heirs, executors, administrators, successors, and assigns.
Signed this day of, 20
THE CONDITION OF THE ADOVE ODI ICATION IC CHICK that whence the above remaining in all has

THE CONDITION OF THE ABOVE OBLIGATION IS SUCH that whereas the above named principal has submitted a bid for work on the Project.


Now, therefore, if the obligee accepts the bid of the principal and the principal fails to enter into a proper contract in accordance with the bid, plans, details, specifications, and bills of material; and in the event the principal pays to the obligee the difference not to exceed ten percent (10%) of the penalty hereof between the amount specified in the bid and such larger amount for which the obligee may in good faith contract with the next lowest bidder to perform the work covered by the bid; or in the event the obligee does not award the contract to the next lowest bidder and resubmits the project for bidding, the principal pays to the obligee the difference not-to-exceed ten percent (10%) of the penalty hereof between the amount specified in the bid, or the costs, in connection with the resubmission, of printing new contract documents, required advertising, and printing and mailing notices to prospective bidders, whichever is less, then this obligation shall be null and void, otherwise to remain in full force and effect; if the obligee accepts the bid of the principal and the principal within ten (10) days after the awarding of the contract enters into a proper contract in accordance with the bid, plans, details, specifications, and bills of material, which said contract is made a part of this bond the same as though set forth herein.

Now also, if the said principal shall well and faithfully do and perform the things agreed by said principal to be done and performed according to the terms of said contract; and shall pay all lawful claims of subcontractors, materialmen, and laborers, for labor performed and materials furnished in the carrying forward, performing, or completing of said contract; we agreeing and assenting that this undertaking shall be for the benefit of any materialman or laborer having a just claim, as well as for the obligee herein; then this obligation shall be void; otherwise the same shall remain in full force and effect; and surety shall indemnify the obligee against all damage suffered by failure of the principal to perform the contract according to its provisions and in accordance with the plans, details, specifications, and bills of material therefor and to pay all lawful claims of subcontractors, materialmen, and laborers for labor performed or material furnished in carrying forward, performing, or completing the contract and surety further agrees and assents that this undertaking is for the benefit of any subcontractor, materialman, or laborer having a just claim, as well as for the obligee; it being expressly understood and agreed that the liability of the surety for any and all claims hereunder shall in no event exceed the penal amount of this obligation as herein stated.

The said surety hereby stipulates and agrees that no modifications, omissions, or additions in or to the terms of the said contract or in or to the plans or specifications therefore shall in any wise affect the

obligations of said surety on its bond, and does hereby waive notice of any such modifications, omissions or additions to the terms of the contract or to the work or to the specifications.

Signed and sealed this	day of, 20
	PRINCIPAL
	Ву:
	Printed Name & Title:
	SURETY
	Ву:
	Printed Name & Title:
	Surety's Address:
	Surety's Telephone Number:
	Surety's Fax Number:
	SURETY'S AGENT
	Surety's Agent's Address:
	Surety's Agent's Telephone Number:
	Surety's Agent's Fax Number:

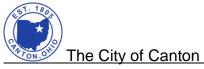

NOTE: The Contract Bond form that follows is to be used ONLY by a bidder that is awarded a contract and submits a form of bid guaranty other than the combined Bid Guaranty and Contract Bond with its bid. If a bidder submits a combined Bid Guaranty and Contract Bond, then the bid guaranty becomes the contract bond when the contract is awarded.

AIA and EJCDC Bid Bond or Payment and Performance Bond forms are not acceptable for this Project.

CONTRACT BOND

(O.R.C. § 153.57)


	RESENTS, that we, the undersigned ("Contractor"), as principal,
firmly bound unto the <u>City of Canton</u> ("Owner")	, as surety, are hereby held and as oblige, in the penal sum of
	Dollars (\$
), for the payment of which well and tr our heirs, executors, administrators, successors	uly to be made, we hereby jointly and severally bind ourselves, s, and assigns.
	BLIGATION IS SUCH that whereas, the above-named principal day of 20 enter into a contract
with the Owner for construction of the Large Di ("Project"), which said contract is made a part of	day of, 20, enter into a contract ameter Sanitary Sewer - Cleaning & Televising - 2020 Project f this bond the same as though set forth herein:
to be done and performed according to the subcontractors, materialmen, and laborers, for performing, or completing of said contract; we benefit of any materialman or laborer having a shall be void; otherwise the same shall remain	and faithfully do and perform the things agreed by the Contractor e terms of said contract; and shall pay all lawful claims of labor performed and materials furnished in the carrying forward, a agreeing and assenting that this undertaking shall be for the just claim, as well as for the obligee herein; then this obligation in full force and effect; it being expressly understood and agreed ims hereunder shall in no event exceed the penal amount of this
terms of the said contract or in or to the plans	agrees that no modifications, omissions, or additions in or to the or specifications therefore shall in any wise affect the obligations ve notice of any such modifications, omissions or additions to the ecifications.
Signed and sealed this day or	f, 20
(TD. 11.0.1.)	(0) (0)
(PRINCIPAL)	(SURETY)
Ву:	Ву:
Printed Name & Title:	Printed Name & Title:
	Surety's Address:
	Surety's Telephone Number:
	Surety's Fax Number:
	NAME OF SURETY'S AGENT
	Surety's Agent's Address:
	Surety's Agent's Telephone Number:
	Surety's Agent's Fax Number:
	outety's Agent's rax number

BID FORM

(Contractor)		
Date bid submitted:		
DELIVER TO:		
The City of Canton ATTN: Purchasing/Bio 218 Cleveland Avenue Canton, OH 44702		
Documents for the Project titled	structions to Bidders, Drawings, S Large Diameter Sanitary Sewer eived, read, and taken into account	- Cleaning & Televising - 2020
Addendum No.	Dated	

and likewise having inspected the site and the conditions affecting and governing the Project, the undersigned hereby proposes to furnish all materials and to perform all labor, as specified and described in the said Specifications and/or as shown on the said Drawings for all Work necessary to complete the Project on a timely basis and in accordance with the Contract Documents regardless of whether expressly provided for in such Specifications and Drawings.

- 1.04 Before completing the Bid Form, the undersigned represents that it has carefully reviewed the Legal Notice to Bidders, Instructions to Bidders, this Bid Form, Form of Bid Guaranty and Contract Bond, Contractor's Affidavit (O.R.C. 5719.042), Owner-Contractor Agreement, General Conditions of the Contract (EJCDC C-700) (as modified for the Project), Drawings, Project Specifications, and other Contract Documents. Failure to comply with provisions of the Contract Documents may be cause for disqualification of the bid.
- **1.05 BONDS AND CONTRACT:** If the undersigned is notified of bid acceptance, it agrees to furnish required bonds as indicated in the Instructions to Bidders.
- **1.06 COMPLETION OF WORK:** In submitting a bid, the undersigned agrees to execute the Owner-Contractor Agreement in the form included in the Contract Documents and to complete its Work as required by the Contract Documents.
- **NOTE A:** The wording of the Bid Form shall be used throughout, without change, alteration, or addition. Any change may cause it to be rejected.
- **NOTE B:** Bidder is cautioned to bid only on the Brands or Standards specified.
- **NOTE C:** If there is an inconsistency or conflict in the Bid amount, the lowest amount shall control, whether expressed in numbers or words.

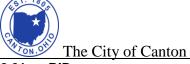


2.01 BID:

Include the cost of all labor and material for the contract listed below. Bidder is to fill in all blanks related to the Bid Package for which a bid is being submitted. If no bid is submitted for an item, leave the item blank or insert "NO BID" in the blank. For alternate items, indicate whether the amount stated is in addition to or a deduction from the base bid amount (if there is no indication whether the amount for an alternate is an addition or a deduction, the amount shall be a deduction).

2.02 Bidder will complete the Work in accordance with the Contract Documents for the prices set forth in the attached Bid Schedule.

3.01 INSTRUCTIONS FOR SIGNING

- A. The person signing for a sole proprietorship must be the sole proprietor or his authorized representative. The name of the sole proprietor must be shown below.
- B. The person signing for a partnership must be a partner or his authorized representative.
- C. The person signing for a corporation must be the president, vice president or other authorized representative; or he must show authority, by affidavit, to bind the corporation.
- D. The person signing for some other legal entity must show his authority, by affidavit, to bind the legal entity.
- **4.01 BIDDER CERTIFICATIONS.** The Bidder hereby acknowledges that the following representations in this bid are material and not mere recitals:
 - 1. The Bidder acknowledges that this is a public project involving public funds, and that the Owner expects and requires that each successful Bidder adhere to the highest ethical and performance standards. The Bidder by submitting its bid pledges and agrees that (a) it will act at all times with absolute integrity and truthfulness in its dealings with the Owner and the Design Professional, (b) it will use its best efforts to cooperate with the Owner and the Design Professional and all other Contractors on the Project and at all times will act with professionalism and dignity in its dealings with the Owner, Design Professional and other Contractors, (c) it will assign only competent supervisors and workers to the Project, each of whom is fully qualified to perform the tasks that are assigned to him/her, and (d) it has read, understands and will comply with the terms of the Contract Documents.
 - 2. The Bidder represents that it has had a competent person carefully and diligently review each part of the Contract Documents, including any Divisions of the Specifications and parts of the Drawings that are not directly applicable to the Work on which the Bidder is submitting its bid. By submitting its bid, each Bidder represents and agrees, based upon its careful and diligent review of the Contract Documents, that it is not aware of any conflicts, inconsistencies, errors or omissions in the Contract Documents for which it has not notified the Owner in writing at least ten (10) days prior to the bid opening. If there are any such conflicts, inconsistencies, errors or omissions in the Contract Documents, the Bidder (i) will provide the labor, equipment or materials of the better quality or greater quantity of Work; and/or (ii) will comply with the more stringent requirements. The Bidder will not be entitled to any additional compensation for any conflicts, inconsistencies, errors or omissions that would have been discovered by such careful and diligent review, unless it has given such prior written notice to Owner.
 - 3. The Bidder represents that it has had a competent person carefully and diligently inspect and examine the entire site for the Project and the surrounding area, including all parts of the site applicable to the Work for which it is submitting its bid, and carefully correlate the results of the inspection with the requirements of the Contract Documents. The Bidder agrees that its bid shall include all costs attributable to site and surrounding area conditions that would have been

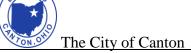

discovered by such careful and diligent inspection and examination of the site and the surrounding area, and the Bidder shall not be entitled to any Change Order, additional compensation, or additional time on account of conditions that could have been discovered by such an investigation.

- 4. The Bidder represents, understands and agrees that a) the Claim procedures in the General Conditions as modified for the Project are material terms of the Contract Documents, b) if it has a Claim, it will have its personnel provide complete and accurate information to complete and submit the Statement of Claim form on a timely basis, c) the proper completion and timely submission of a Statement of Claim form is a condition precedent to any change in the Contract Sum or the Contract Time(s), and d) the proper and timely submission of the Statement of Claim form provides the Owner with necessary information so that the Owner may investigate the Claim and mitigate its damages.
- 5. The Bidder represents that the bid contains the name of every person interested therein and is based upon the Standards specified by the Contract Documents.
- 6. The Bidder and each person signing on behalf of the Bidder certifies, and in the case of a bid by joint venture, each member thereof certifies as to such member's entity, under penalty of perjury, that to the best of the undersigned's knowledge and belief: (a) the Base Bid, any Unit Prices and any Alternate bid in the bid have been arrived at independently without collusion, consultation, communication or agreement, or for the purpose of restricting competition as to any matter relating to such Base Bid, Unit Prices or Alternate bid with any other Bidder; (b) unless otherwise required by law, the Base Bid, any Unit Prices and any Alternate bid in the bid have not been knowingly disclosed by the Bidder and will not knowingly be disclosed by the Bidder prior to the bid opening, directly or indirectly, to any other Bidder who would have any interest in the Base Bid, Unit Prices or Alternate bid; (c) no attempt has been made or will be made by the Bidder to induce any other Person to submit or not to submit a bid for the purpose of restricting competition; and (d) the statements made in this Bid Form are true and correct.
- 7. The Bidder will execute the form of Owner/Contractor Agreement in the form included with the Contract Documents, if a Contract is awarded on the basis of this bid, and if the Bidder does not execute the Contract Form for any reason, other than as authorized by law, the Bidder and the Bidder's Surety are liable to the Owner.
- 8. The Bidder certifies that the upon the award of a Contract, the Contractor will ensure that all of the Contractor's employees, while working on the Project site, will not purchase, transfer, use or possess illegal drugs or alcohol or abuse prescription drugs in any way.
- 9. The Bidder agrees to furnish any information requested by the Owner's authorized representative to evaluate that the Bidder has submitted the lowest and best bid and that the bid is responsive to the specifications.
- 10. The Bidder certifies that it has no unresolved findings for recovery issued by the Auditor of State.
- 11. The Bidder certifies that it is aware of and in compliance with the requirements of Ohio Revised Code Section 3517.13 regarding campaign contributions.

•			
LEGAL NAME OF BIDDER:			
BIDDER IS (check one): sole proprietor	partnership _	_ corporation other legal entity	
NAME & TITLE OF PERSON LEGALLY AUTHO	RIZED TO BIND BIDI	DER TO A CONTRACT:	
Name		Title	
DATE SIGNED:	SIGNATURE: _		
	ADDRESS:		
	TELEPHONE:		
	FAX:		
	FEDERAL TAX	I.D. #	
When the Bidder is a partnership or a jupartnership or participant in the joint venture		· 	
Name			
		Address	
		Address	
	<u></u>		
Name			
		Address	
	- 		
Name			
		Address	
			
Name			
		Address	
Name			
		Address	

END OF SECTION


CONTRACTOR'S QUALIFICATION STATEMENT

Large Diameter Sanitary Sewer - Cleaning & Televising - 2020 Project

SUBMITTED TO: The City of Canton

ATTN: <u>Purchasing/Bids</u> 218 Cleveland Avenue SW Canton, OH 44702

SUBM	ITTED B	Y:	
NAME:	<u>.</u>		
TW CIVIL	•		
ADDRI	ESS:		
PRINC	IPAL OF	FICE:	
	Corpor	ation	
	Partne	rship	
	Individ	ual	
	Joint V	enture	
		Critare	
	Other		
NAME	OF PRO	DJECT:	Large Diameter Sanitary Sewer - Cleaning & Televising - 2020 Project
1. OF	RGANIZA	NOITA	
	1.1		many years has your organization been in business as a Contractor in the uction industry?
	1.2	How r	nany years has your organization been in business under its present business
		1.2.1	Under what other or former names has your organization operated?
	1.3 If you		organization is a corporation, answer the following:
	1.3.		Date of incorporation:
		1.3.2	State of incorporation:
		1.3.3	President's name:
		1.3.4	Vice President's name(s):
		1.3.5	Secretary's name:
		136	Treasurer's name

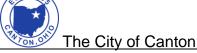

- 1.4 If your organization is a partnership, answer the following:
 - 1.4.1 Date of organization:
 - 1.4.2 Type of partnership (if applicable):
 - 1.4.3 Name(s) of general partner(s):
- 1.5 If your organization is individually owned, answer the following:
 - 1.5.1 Date of organization:
 - 1.5.2 Name of owner:
- 1.6 If the form of your organization is other than those listed above, describe it and name the principals:

2. LICENSING

- 2.1. List jurisdictions and trade categories in which your organization is legally qualified to do business, and indicate registration or license numbers, if applicable.
- 2.2. List jurisdictions in which your organization's partnership or trade name is filed.
- 2.3. List any suspension or revocations of any professional license of any director, officer, owner, or managerial employees of the Contractor, to the extent that any work to be performed on this Project is within the field of such licensed profession.


3. EXPERIENCE

- 3.1. List the categories of work that your organization normally performs with its own forces.
- 3.2. Claims and Lawsuits (If the answer to any of the questions below is yes, please attach details.)
 - 3.2.1. Has your organization ever failed to complete any work?
 - 3.2.2. Has your organization ever failed to complete any work by the substantial completion date, final completion date, or in a timely manner?
 - 3.2.3. Within the last five (5) years has your organization or any of its officers prosecuted any Claims, had any Claims prosecuted against it or them, or been involved in or is currently involved in any mediation or arbitration proceedings or lawsuits related to any construction project, or has any judgments or awards outstanding against it or them? Has your organization had any extension requests, fines and penalties imposed, or contract defaults? If the answer is yes, please attach the details for each Claim, including the names and telephone numbers of the persons who are parties, the amount of the Claim, the type of Claim and the basis for the Claim, and the outcome.

Note: As used in this document "Claim" means a Claim initiated under the Contract Documents for a project or relating to the Work for a project, including Claims made against performance bonds secured by the Contractor on other construction projects.

- 3.3. Has your organization ever failed to comply with federal, state, and local laws, rules, and regulations, including but not limited to the Occupational Safety and Health Act, the Ohio Prevailing Wage laws, and Ohio ethics laws? If the answer is yes, please attach details and reason(s) for each instance and the outcome including any fines or penalties imposed.
- 3.4. Within the last five years, has any officer or principal of your organization ever been an officer or principal of another organization when it failed to complete a construction contract? If the answer is yes, please attach details for each instance, including the

CITY OF CANTON - CONTRACTOR'S QUALIFICATION STATEMENT

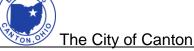

names and telephone numbers of the persons who are parties to the contract, and the reason(s) the contract was not completed.

- 3.5. On a separate sheet, list construction projects your organization has <u>in progress</u> with an original Contract Sum of more than \$10,000,000, giving the name of project, owner and its telephone number, design professional and its telephone number, contract amount, percent complete and scheduled completion date.
 - 3.5.1. State total amount of work in progress and under contract:
- 3.6. Provide the following information for each contract your organization has had during the last five (5) years, including current contracts, where the Contract Sum is fifty percent (50%) or more of the bid amount for this Project, including add alternates. Include details regarding timeliness of performance and quality of work. List the original contract price for each project, the amount of any change orders or cost overruns on each, the reasons for the change orders or cost overruns, and your organization's record for complying with and meeting completion deadlines on construction projects. If there are more than ten (10) of these contracts, only provide information on the most recent ten (10) contracts, including current contracts.

Project And Work	Contract Sum	Owner's Representative & Telephone Number	Engineer's Or Architect's Representative Name & Telephone Number	Additional Comments


3.7. Provide the following information for each project your organization has had during the last five (5) years, which your organization believes is of comparable or greater size and complexity than the Owner's project. Include details regarding how such projects demonstrate your organization's ability and capacity to perform a substantial portion of the Project with its own work force. If there are more than five (5) of these projects, only provide information on the most recent five (5) projects, including current projects.

Project And Work	Contract Sum	Owner's Representative & Telephone Number	Engineer's Or Architect's Representative Name & Telephone Number	Additional Comments

- 3.7.1. State average annual amount of construction work your organization has performed during the last five years.
- 3.7.2. If any of the following members of your organization's management -- president, chairman of the board, or any director -- operates or has operated another construction company during the last five (5) years, identify the member of management and the name of the construction company.
- 3.7.3. If your organization is operating under a trade name registration with the Secretary of State for the State of Ohio, identify the entity for which the trade name is registered. If none, state "none."
- 3.7.4. If your organization is a division or wholly-owned subsidiary of another entity or has another relationship with another entity, identify the entity of which it is a division or wholly-owned subsidiary or with which it has another relationship and also identify the nature of the relationship. If none, state "not applicable."
- 3.8. On a separate sheet, list the construction education, training, construction experience, and tenure with your organization for each person who will fill a management role on the Project, including without limitation the Project Executive, Project Engineer, Project Manager, and Project Superintendent. For each person listed, include with the other information the last three projects on which the person worked and the name and telephone number of the Design Professional and the Owner.
- 3.9. Describe the size and experience of your organization's work force and your equipment and facilities, in relation to your organization's ability to complete the Project successfully and on time.

4. REFERENCES

- 4.1. Trade References:
- 4.2. Bank References:
- 4.3. Surety:
 - 4.3.1. Name of bonding company:
 - 4.3.2. Name and address of agent:

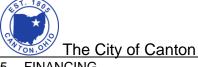

FINANCING

Financial Statement (May be required, but only post-bid. Not a 5.1 requirement to provide with bid.)

5.1.1 Attach a financial statement, preferably audited, including your organization's latest balance sheet and income statement showing the following items:

Current Assets (e.g., cash, joint venture accounts, accounts receivable, notes receivable, accrued income, deposits, materials inventory and prepaid expenses);

Net Fixed Assets:

Other Assets:

Current Liabilities (e.g., accounts payable, notes payable, accrued expenses, provision for income taxes, advances, accrued salaries and accrued payroll taxes); and


Other Liabilities (e.g., capital, capital stock, authorized and outstanding shares par values, earned surplus and retained earnings).

- 5.1.2 Name and address of firm preparing attached financial statement, and date thereof.
- 5.1.3 Is the attached financial statement for the identical organization named on page
- 5.1.4 If not, explain the relationship and financial responsibility of the organization whose financial statement is provided (e.g., parent-subsidiary).
- 5.2 Will the organization whose financial statement is attached act as guarantor of the contract for construction?
- Attach additional documentation or explanations demonstrating your organization's 5.3 financial responsibility, adequate resources and availability of credit, its means and ability to procure insurance and acceptable performance bonds required for the Project.
- 6. Does your organization participate in a drug-free workplace program? Provide your organization's record for both resolved and unresolved findings of the Auditor of the State of Ohio for recovery as defined in Section 9.24 of the Ohio Revised Code.
- 7. List any projects within the previous five years where a public entity determined that your organization was not a responsible bidder, including the name of the public entity, the reasons given by the public entity, and an explanation thereof.
- 8. Additional Criteria. Pursuant to the Codified Ordinance of the City of Canton, Chapter 105, the Owner, in its discretion, reserves the right to request additional information and documentation relating to the foregoing and related to any of the criteria listed in Paragraph I.6 of the Instructions to Bidders from Bidders after the bid opening. The Owner may consider such information and documentation in determining which bid is lowest and best. The Owner, in its discretion, may consider and give such weight to any and all criteria as it deems appropriate.

[left intentionally blank]

Certification. The undersigned certifies for the reliance of the Owner that after diligent investigation, to the best of the undersigned's belief, the information provided with this Contractor's Qualification Statement is true, accurate and not misleading.

SIGNATURE:					
	Dated this	day of	20	·	
Name of Organization:					
Ву:		Inrint nam	e]	<u>—</u>	
			6]		
Title:					
State of					
County of					
			, being duly sworn,	deposes and says	that the
information provided he				•	
Subscribed and	sworn before	me this day	of	20	
		Notary Public			
		My Commission	Expires:		
SEAL					

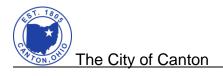

Modified General Conditions (EJCDC)

Please go to this <u>link</u> for the document or enter the following link information into a web browser:

 $\underline{\text{https://cantonohio.gov/DocumentCenter/View/596/Modified-Standard-General-Conditions-of-the-} \underline{\text{Construction-Contract---3rd-Party-Engineer}}$

City of Canton Codified Ordinances

Bidders shall take notice that they are to comply with the Codified Ordinances of the City of Canton, including but not limited to, the following:

1. Chapter 105.02 – Public Paving Time Restrictions.

All City public paving contracts shall include a provision for liquidated damages in order to provide the City reasonable compensation for actual damages due to a failure to ensure that asphalt paving take place on the City's road surfaces from May 1st to October 1st; and/or during optimal climatic conditions that are conducive to the best mix compacting and long term durability of the pavement, according to the highest and best practices of the asphalt paving industry.

(Ord. 270-2014. Passed 12-29-14.)

2. Chapter 105.03 – U.S. Steel Usage Required; Exception.

All City contracts shall stipulate or provide that all steel necessary in the construction of any work performed under such contracts shall be steel that is produced in the United States unless a specific product which is required is not produced by manufacturers in the United States in which event this prohibition does not apply. This section shall apply to only contracts awarded by the Board of Control of the City. (Ord. 224-77. Passed 6-27-77.)

3. Chapter 105.05 – Materials to be Purchased Locally.

In all future contracts for the construction of buildings, structures, or other improvements under the Capital Improvement Budget, the following clause shall be printed or typewritten on each contract:

It is the desire of the City of Canton that all materials used in the construction covered by this contract shall be purchased in the Canton area except such materials which are unavailable in the Canton area.

(Res. 49-77. Passed 2-7-77.)

4. Chapter 105.06 – Minority Contract Provision.

a. All contracts with the City shall include the following clause:

The bidder agrees to expend at least \$______ of the Contract in the event the contract is awarded to such bidder for minority/women's business enterprises. For purposes of this pledge, the term "minority/women's business enterprise" means a bona fide business established as a sole proprietorship, partnership or corporation owned, operated and controlled by one or more minority persons or women who have at least fifty-one percent (51%) ownership. "Minority" includes African Americans, Asian/Pacific Islanders, Hispanic/Latino Americans and Native American Indians. The minority or woman must have operational and managerial control, interest in capital, and earnings commensurate with the percentage of ownership. Minority/women's business enterprises may be employed as construction contractors, subcontractors, vendors or suppliers. (Ord.185-2011. Passed 10-31-11.)

5. Chapter 105.12 – Local Bidder Preference.

a. The Board of Control, in determining the lowest and best bidder in the award of contracts to which this section is applicable, is authorized to award contracts to local bidders as hereinafter defined, whose bid is not more than five percent (5%) higher, subject to a maximum amount of twenty thousand dollars (\$20,000.00), than the lowest dollar bid submitted by non-local bidders. The Board of Control's decision in making such an award shall be final.

- b. For purposes of this section, "local bidder" means an individual or business entity which at the time of the award of the contract has a headquarters, division, sales office, sales outlet, manufacturing facility, or similar significant business-related location in Stark County, Ohio.
- c. All contract specifications and/or bid documents that are distributed by Canton for the purpose of soliciting bids for goods and/or services shall contain the following notice:

Prospective bidders will take notice that the City of Canton, in determining the lowest and best bidder in the award of this contract, may award a local bidder preference to any qualified bidder pursuant to Section 105.12 of the Codified Ordinances of the City of Canton. The determination of whether a bidder qualifies for the local preference shall be made by Board of Control. The Board's decision shall be final. A copy of Section 105.12 is attached.

d. This section shall be applicable to all contracts for equipment, goods, machinery, materials, supplies, vehicles and/or services, which are purchased, leased and/or constructed at a cost in excess of fifty thousand dollars (\$50,000.00) and which require bidding pursuant to Ohio R.C. 735.05 through 735.09 and Ohio R.C. 737.03. (Ord. 115-2018. Passed 5-14-18.)

6. Chapter 105.15 – City Income Tax

- a. No person, partnership, corporation or unincorporated association may be awarded a contract with the City under Sections 105.09 or 105.10, unless the bidder is paid in full or is current and not otherwise delinquent in the payment of City income taxes, including any obligation to pay taxes withheld from employees under Section 182.05 and any payment on net profits under Section 182.06.
- b. Falsification of any information related to or any post-contractual violation of the requirement to pay City income taxes set forth in subsection (a) shall constitute cause for the rescission of the balance of the contract at the City's discretion.
- c. No partnership, corporation or unincorporated association which has as one of its partners, shareholders or owners a person who is a twenty percent (20%) or greater equity owner in such partnership, corporation or unincorporated association and who is delinquent in the payment of City income taxes as set forth in subsection (a), may be awarded a contract with the City under Sections 105.09 or 105.10.
- d. A person who is a twenty percent (20%) or greater equity owner in any partnership, corporation or unincorporated association which is delinquent in the payment of City income taxes as set forth in subsection (a) may not be awarded a contract with the City under Sections 105.09 or 105.10.
- e. A contract awarded under Sections 105.09 or 105.10 for a public improvement project, services other than personal or professional services, and personal or professional services shall not be binding or valid unless such contract contains the following provisions:

Said ______ hereby further agrees to withhold all City income taxes due or payable under Chapter 182 of the Codified Ordinances for wages, salaries, fees and commissions paid to its employees and further agrees that any of its subcontractors shall be required to agree to withhold any such City income taxes due for services performed under this contract. Furthermore, any person, firm or agency that has

a contract or agreement with the City shall be subject to City income tax whether a resident or nonresident in the City, and whether the work being done is in the City or out of the City. In addition to the tax withheld for employees, the net profits on the contract shall be subject to City income tax. (Ord. 238-2015. Passed 11-30-15.)

7. Chapter 182.30 – Contract Provisions

a. No contract on behalf of the City under Sections 105.09 or 105.10 of the Codified Ordinances of Canton for a public improvement project, services other than personal or professional services, and personal or professional services shall be binding or valid unless such contract contains the following provisions:

Said ________hereby further agrees to withhold all City income taxes due or payable under Chapter 182 of the Codified Ordinances for wages, salaries, fees and commissions paid to its employees and further agrees that any of its subcontractors shall be required to agree to withhold any such City income taxes due for services performed under this contract. Furthermore, any person, firm or agency that has a contract or agreement with the City shall be subject to City income tax whether a resident or nonresident in the City, and whether the work being done is in the City or out of the City. In addition to the tax withheld for employees, the net profits on the contract shall be subject to City income tax.

- b. By entering into contract with the City of Canton _____ agrees with the City regarding the manner of withholding of City income taxes as provided in Section 718.011(F) of the Ohio Revised Code.
 - i. Municipal income tax withholding provisions of Sections 718.011(B)(1) and 718.011(D) ORC shall not apply to qualifying wages paid to employees for work done or services performed or rendered inside the City or on City property.
 - ii. _____ agrees to withhold income tax for the City from employees' qualifying wages earned inside the City or on City property, beginning with the first day of work done or services performed or rendered inside the City.

(Ord. 238-2015. Passed 11-30-15.)

8. Chapter 507.03 – Equal Employment Opportunity Clause.

- b. During the performance of this contract, the contractor agrees as follows:
 - 1. The contractor shall not discriminate against any employee or applicant for employment because of race, age, handicap, religion, color, sex, national origin, sexual orientation or gender identity. The contractor shall take affirmative action to insure that applicants are employed and that employees are treated during employment without regard to race, religion, color, sex, national origin, military status, sexual orientation or gender identity. As used herein, the word "treated" shall mean and include without limitation the following: recruited, whether by advertising or other means; compensation, whether in the form of rates or pay or other forms of compensation; selected for training, including apprenticeship; promoted; demoted; upgraded; downgraded; transferred; laid off; and terminated. The contractor agrees to and shall post in conspicuous places available to employees and applicants for employment notices to be provided by the contracting officers setting forth the provisions of this nondiscrimination clause.
 - The contractor shall, in all solicitations or advertisements for employees placed by or on behalf of the contractor, state that all qualified applicants will receive consideration for employment without regard to race, age, handicap, religion, color, sex, national origin, military status, sexual orientation or gender identity.

(Ord. 153-2012. Passed 9-24-12.)

- 3. The contractor shall send to each labor union or representative of workers, with which he has a collective bargaining agreement or other contract or understanding, a notice advising the labor union or workers' representative of the contractor's commitments under the equal opportunity clause of the City; and he shall post copies of the notice in conspicuous places available to employees and applicants for employment.
- 4. The contractor shall submit in writing to the City his affirmative action plan, and each subcontractor and supplier of equipment or supplies shall submit to the general contractor his affirmative action plan. The responsibility for securing these affirmative action plans falls upon the general contractor and shall be on file at the office of the general contractor. The contractor shall furnish all information and reports required by the City or its representative pursuant to this chapter, and shall permit access to his books, records, and accounts by the contracting agency and by the Executive Secretary for purposes of investigation to ascertain compliance with the program.
- 5. The contractor shall take such action with respect to any subcontractor as the City may direct as a means of enforcing the provisions of this equal opportunity clause, including penalties and sanctions for noncompliance; provided, however, that in the event the contractor becomes involved in or is threatened with litigation as the result of such direction by the City, the City will enter into such litigation as is necessary to protect the interests of the City and to effectuate the City's equal opportunity program and, in the case of contracts receiving Federal assistance, the contractor or the City may request the United States to enter into such litigation to protect the interests of the United States.
- 6. The contractor shall file and shall cause his subcontractors, if any, to file compliance reports with the City in the form and to the extent prescribed by the City or its representative. Compliance reports filed at such times as directed shall contain information as to the employment practices, policies, programs and statistics of the contractor and his subcontractors.
- 7. The contractor shall include the provisions of this equal employment opportunity clause in every subcontract or purchase order, so that such provisions will be binding upon each subcontractor or vendor.
- 8. Refusal by the contractor or subcontractor to comply with any portion of this program as herein stated and described will subject the offending party to any or all of the following penalties:
 - A. Withholding of all future payments under the involved public contract to the contractor in violation, until it is determined that the contractor or subcontractor is in compliance with the provisions of this contract.
 - B. Refusal of all future bids for any public contract with the City or any of its departments or divisions, until such time as the contractor of subcontractor demonstrates that he has established and shall carry out the policies of the program as herein outlined.
 - C. Cancellation of the public contract and declaration of forfeiture of the performance bond.
 - D. In cases in which there is substantial or material violation or the threat of substantial or material violation of the compliance procedure or as may be provided by contract, appropriate proceedings may be brought to enforce these provisions, including the enjoining within applicable laws of contractors, subcontractors or other organizations, individuals or groups who prevent, directly or indirectly, or seek to prevent, directly or indirectly, compliance with the policy as herein outlined.

(Ord. 179-74. Passed 6-17-74.)



incorporated in this Form.

STATEMENT OF CLAIM FORM

Claim No. ___ for Contractor

1.	Name of Contractor:				
2.	Date written claim given:				
3.	Contractor's representative to contact regarding the claim:				
	Name: Telephone No. (office) FAX No.				
	E-mail:				
4.	General description of claim:				
Cont	Contract Documents. If the claim is based upon any part or provision in the Contract Documents and the limited to pages in the Drawings and/or paragraphs in the Specifications, intractor Agreement, General Conditions or Supplementary General Conditions, state upon which provisions the claim is based:	Owner-			
6.	Delay claims:				
	6.1 Date delay commenced:				
	6.2 Duration of the delay:6.3 Apparent cause of the delay and part of critical path affected:				
	6.4 Impact of the delay and recommendations for minimizing such impact:				
7. belie	Additional compensation. Set forth in detail all additional compensation to which the Coreves it is entitled with respect to this claim:	ntractor			
8.	Instructions for Completing the Statement of Claim Form ("Instructions"). The Instruction	ons are			

conscientious and thorough review has complied fully with the Instructional Contractor is entitled to recover to	ing this claim, the Contractor and its representative certify that after and to the best of his or her knowledge and belief a) the Contractor etions, b) the information in this State of Claim is accurate, c) the her compensation in paragraph 7, and d) the Contractor has no adulent claim. The Contractor by its authorized representative must before a notary public.
	CONTRACTOR:
	Ву:
	Name and Title:
	Date:
State of	NTRACTOR'S ACKNOWLEDGMENT
County of	
	first being sworn, states that after conscientious and de in attached Statement of Claim Form are complete and true to the lief.
Sworn to before me a notary	y public by on, 20
	Notary Public

WHEN COMPLETED, FORWARD A COPY OF THIS NOTICE AND STATEMENT OF CLAIM FORM TO THE OWNER AND ENGINEER.

INSTRUCTIONS FOR COMPLETING THE STATEMENT OF CLAIM FORM

- 1. Completing the Statement of Claim Form ("Claim Form") is a material term of the Contract. The Claim Form tells the Owner and Design Professional that the Contractor is making a Claim and that they need to act promptly to mitigate the effects of the occurrence giving rise to the Claim. The Claim Form also provides them with information so that they can mitigate such effects. The Contractor acknowledges that constructive knowledge of the conditions giving rise to the Claim through job meetings, correspondence, site observations, etc. is inadequate notice, because knowledge of these conditions does not tell the Owner and Engineer that the Contractor will be making a Claim and most often is incomplete.
- 2. If the space provided in the Claim Form is insufficient, the Contractor, as necessary to provide complete and detailed information, must attach pages to the Claim Form with the required information.
- 3. Paragraph 4. The Contractor must state what it wants, *i.e.*, time and/or compensation, and the reason why it is entitled to time and/or compensation.
- 4. Paragraph 5. The Contractor must identify the exact provisions of the Contract Documents it is relying on in making its Claim. For example, if the Claim is for a change in the scope of the Contractor's Work, the Contractor must identify the specific provisions of the Specifications, and the Plan sheets and details that provide the basis for the scope change.
- 5. Paragraph 6. This paragraph applies to delay claims, including delays that the Contractor believes result in constructive acceleration. The Contractor must identify the cause of the delay, party or parties responsible, and what the party did or did not do that caused the delay, i.e., specific work activities. The Contractor acknowledges that general statements are not sufficient, and do not provide the Owner with sufficient information to exercise the remedies available to the Owner or to mitigate the effects of the delay.

For example, if the Contractor claims a slow response time on submittals caused a delay, the Contractor must identify the specific submittals, all relevant dates, and then show on the applicable schedule, by circling or highlighting, the activities immediately affected by the delays. Also for example, if the Contractor claims it was delayed by another Contractor, the Contractor must identify the delaying Contractor, specifically what the delaying Contractor did or did not do that caused the delay, and then show the applicable schedule, by circling or highlighting, the activities immediately affected by the delays. Further by example, if the Contractor seeks an extension of time for unusually severe weather, the Contractor must submit comparative weather data along with a record of the actual weather at the job site and job site conditions.


- 6. Paragraph 6.4. Time is of the essence under the Contract Documents. If there is a delay, it is important to know what can be done to minimize the impact of the delay. It therefore is important that the Contractor provide specific recommendations on how to do so.
- 7. Paragraph 7. The Contractor must provide a specific and detailed breakdown of the additional compensation it seeks to recover. For future compensation, the Contractor shall provide its best estimate of such compensation.
- 8. Paragraph 8 and Acknowledgment. By submitting this Claim, the Contractor and its representative certify that after conscientious and thorough review and to the best of his or her knowledge and belief a) the Contractor has complied fully with the Instructions, b) the information in this Claim Form is accurate, c) the Contractor is entitled to recover the compensation in paragraph 7, and d) the Contractor has not knowingly presented a false or fraudulent claim. The Contractor by its authorized representative must acknowledge this Statement of Claim before a notary public.

End of Instructions

CONTRACTOR'S PERSONAL PROPERTY TAX AFFIDAVIT

(O.R.C. § 5719.042)

State of Ohio County of	, ss:					
	Name)	, being fire	st duly sworn, o	deposes and say	s that he is the)
(1	varie)					
(Title)	of	(Contractor)		with	offices located	at
(Title)						
	(Addra	ess of Contractor)			, and as its o	duly
	(Addre	ess of Contractor)				
authorized repre	esentative, states that e	effective this	_ day of		, 20,	
(Name of Contrac	tor)					
()	is charged with deling set forth below:	uent personal prop	perty taxes on t	the general list o	of personal prop	perty as
	County	Amount (include	es total amoun	t due, plus pena	Ities and intere	st thereon)
	Stark	\$				
()	is <u>not</u> charged with de Stark County.	linquent personal	property taxes	on the general I	ist of personal	property in
				(Affiant)		
				,		
Sworn to and su	ibscribed before me by	the above-named	d affiant this	day of	,	20
				(Notary Public)		
			My commission	on expires		
			-		20	

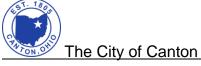

CONTRACTOR'S FINAL WAIVER & RELEASE AFFIDAVIT ("AFFIDAVIT")

Project: Large Diameter Sanitary Sewer - Cleaning & Televising - 2020

In consideration for payment received from the City of Canton (the "City") in the amount requested in Contractor's Final Application for Payment to the City, the receipt of which is hereby acknowledged, the undersigned Contractor hereby waives and releases any rights it has or may have to any and all types of claims relating to the Project, including without limitation claims of payment, Mechanic's Lien, stop notice, equitable lien, labor and material bond, breach of contract or unjust enrichment, or any other claim against the City, for any labor, materials, or equipment the undersigned may have delivered or provided to the Project, except for any Claims the undersigned has made by properly and timely submitting a Statement of Claim form. The undersigned further certifies that this Affidavit covers claims by all contractors, subcontractors, and suppliers who may have provided any labor, material, or equipment to the Project through the undersigned or at the undersigned's request. The undersigned acknowledges that all such contractors, subcontractors, sub-subcontractors and suppliers have signed an affidavit in the form of this Affidavit releasing any and all claims against the City, except for any Claims the undersigned has made by properly and timely submitting a written statement of its Claim. The undersigned hereby represents and warrants that it has paid any and all welfare, pension, vacation or other contributions required to be paid on account of the employment by the undersigned of any laborers on the Project.

This Affidavit is for the benefit of, and may be relied upon by the City. The undersigned hereby agrees to indemnify, defend and hold harmless each of the foregoing, the Project, work of improvement, and real property from any and all claims, or liens that are or should have been released in accordance with this Affidavit.

	_ State of: County of
Company Name	Subscribed and sworn to before me this
Authorized Signature (Company Officer)	day of
Tid-	Notary Public:
Title	My Commission Expires:
Date	-

CITY OF CANTON

<u>Large Diameter Sanitary Sewer - Cleaning & Televising - 2020 Project</u>

PRE-BID SUBSTITUTION FORM

- 1. Note. Certain brands of material or apparatus are specified. Each bid will be based on these brands, which may be referred to in the Contract Documents as Standards. The use of another brand (referred to as a substitution or proposed equal in the Contract Documents, when a bidder or the contractor seeks to have a different brand of material or apparatus than that specified approved by the Owner for use in the Project) may be requested as provided in the Instructions to Bidders. Substitutions, however, unless approved and issued in an Addendum, will not be considered in determining which bidder to award the contract to.
- 2. The detailed procedures for submitting substitutions are set forth in Paragraph K of the Instructions to Bidders.

Specification Section	Brand or Name Specified	Proposed Substitution

SCOPE OF BIDS

CITY OF CANTON 2020 LARGE DIAMETER SEWER CLEANING AND INSPECTION

It is understood and agreed that the CONTRACTOR has, by careful examination, satisfied himself as to the nature and location of the work; the conformation of the ground; the character, quality, and quantity of the materials to be encountered; the character or equipment and facilities needed preliminary to and during the prosecution of the work; the general and local conditions; and all other matters which can, in any way, affect the work under this Contract.

Manholes and sewers have been indicated in their approximate locations on the maps, and any reasonable variation in size and location of such shall not be cause for extra payment.

Major deviations or modifications during construction, from that shown on, or the true intent of, the maps and specifications requiring more or less labor and materials shall be authorized by Change Order.

If construction procedures and equipment being utilized by the CONTRACTOR prove to be inadequate in the performance of the Contract, the procedures and equipment shall be modified, or alternative equipment furnished and used at no additional cost to the ENGINEER.

The CONTRACTOR will be responsible for obtaining and paying all costs associated with any utility service he/she may require during the Contract period. The CONTRACTOR will be responsible for supplying, maintaining, and paying all costs associated with all temporary and permanent utility services as required for the WORK; maintaining, minimizing, plugging, and by-passing of sewer flows as necessary to perform the work. The CONTRACTOR shall be responsible for and pay for water usage.

The price Bid shall include the following:

- 1. All labor, materials, and equipment.
- 2. All field locating and access of manholes, sewers, and related appurtenances.
- 3. All coordination, sequencing, permits, and applications.
- 4. All costs associated with permits, applications, fees, and inspection.
- 5. All assistance required by the ENGINEER to verify compliance with the Contract Documents, including measuring for quantities.
- 6. All labor, materials, and equipment to perform work in accordance with the City of Canton Supplemental Specifications, Current Edition, and City of Canton Standard Construction Drawings.

All BIDDERS must Bid Items 1 through 6:

<u>Item 1 – Mobilization:</u> This item shall include compensation for mobilizing all labor, equipment, and materials necessary for work, and for obtaining any necessary permits and establishing temporary facilities. CONTRACTOR shall be paid 90% of this lump sum item upon completion of mobilization to the project site, including equipment set up, maintenance of traffic plans, setting up storage and staging

areas, and starting actual cleaning operations. The final 10% will be paid once the CONTRACTOR has cleaned 100% of the lineal footage of sewers designated to be cleaned, accepted and approved by the OWNER/ENGINEER.

Payment will be made at the lump sum price Bid for all labor, equipment, and materials mobilized, complete, and ready for continuous work.

<u>Items PRE-1 Pre-CCTV Inspection and PRE-2 Pre-CCTV and SONAR Inspection (all sizes):</u>

These items shall include all labor, equipment, materials, submittals and documentation, for the pre-CCTV inspection of the sewers (all sizes) in accordance with Specification 33 01 32, CCTV and Sonar Sewer Inspection.

This item shall include, but not be limited to: field locating and marking "Buried" manholes, pre-CCTV sewer inspection, scheduling, resident and business communication and advance notification of work as required, 24-hour emergency response, immediate response and cleaning of sewer overflows and spills, obtaining access to manholes and sewers, locating and excavating manholes, temporary access roads, maintaining/minimizing flows as necessary to facilitate pre-CCTV & sonar inspection, water usage, sediment and erosion control, daily work logs, site restoration, repair and replacement of any and all items damaged by CONTRACTOR operations, data submittals, work during weekends and evenings as necessary, coordination with other cleaning contractors/contracts, and all other related items and expenses whether specifically mentioned or not.

The CONTRACTOR is responsible for posting signs in the street treelawn at least two days in advance of the cleaning and inspection work, in addition to door hangers. This will assist in notifying the residents/business owners of the impending work and provide contact information should they have questions. The notice shall have the company logo and 24-hour phone number for questions. The CONTRACTOR will be required to post multiple signs along a block, not just signs at the intersections.

This item shall include all labor, equipment, and materials for maintenance of traffic. All related work shall be in accordance with the City of Canton standards. The CONTRACTOR is responsible to provide, install, and maintain safety measures for maintaining traffic around each individual work site.

Payment will be made on a lineal foot basis as measured from center to center of manholes, or when the survey is abandoned, along the centerline of the sewer, upon acceptance of submittals and confirmation of CCTV inspection in accordance with the specifications by the ENGINEER. Payment for completed segments will *not* be made until the ENGINEER completes a review of the CCTV inspection video and reports and approves the completed segment.

<u>Items SPC-1 through SPC-7 – Sewer Pipe Cleaning and Post Inspection (all size ranges):</u>

These items shall include all labor, equipment, materials, submittals and documentation, for cleaning of sanitary sewer pipes, manholes, and related underground structures and vaults, in accordance with Specifications 33 01 32 CCTV and Sonar Sewer Inspection and 33 01 33 Sewer Cleaning.

This item shall include, but not be limited to: sewer cleaning (as defined in Specification 33 01 33), locating, excavating, and field marking "Buried" manholes, pre-construction above ground audio-video recording, scheduling, resident and business communication and advance notification of work as required, 24-hour emergency response, immediate response and cleaning of sewer overflows and spills, obtaining access to manholes and sewers, temporary access roads, maintaining/minimizing flows as necessary to facilitate cleaning and post CCTV & sonar inspection, water usage, removal of sediment & debris material, obstruction removal, capture, and removal of all other items regardless of

size/shape/weight/material/hardness/density/chemical composition, removal and replacement of existing manhole castings/risers/cones/sections as necessary to facilitate cleaning work and/or sediment & debris material removal, sediment and erosion control, post-cleaning CCTV & sonar confirmation inspection, daily work logs, site restoration, repair and replacement of any and all items damaged by CONTRACTOR operations, pavement and walk replacement, data submittals, grading and seeding, work during weekends and evenings as necessary, coordination with other contractors/contracts, and all other related items and expenses whether specifically mentioned or not, except as covered under another item.

The CONTRACTOR is responsible for posting signs in the street treelawn at least two days in advance of the cleaning and inspection work, including door hangers. This will assist in notifying the residents/business owners of the impending work and provide contact information should they have questions. The notice shall have the company logo and 24-hour phone number for questions. The CONTRACTOR will be required to post multiple signs along a block, not just signs at the intersections.

This item shall include all labor, equipment, and materials for maintenance of traffic. All related work shall be in accordance with the City of Canton standards. The CONTRACTOR is responsible to provide, install, and maintain safety measures for maintaining traffic around each individual work site.

Payment will be made on a lineal foot basis as measured from center to center of manholes, or when the survey is abandoned, along the centerline of the sewer, upon acceptance of submittals and confirmation of cleaning and CCTV inspection in accordance with the specifications by the ENGINEER. Payment for completed segments will *not* be made until the ENGINEER completes a review of the CCTV inspection video and reports and approves the completed segment.

<u>Item 2 – Special Pipe Cleaning Tools Allowance:</u>

This item shall include all labor, equipment, and materials for additional tools (other than water jet and vacuum/pump systems, regardless of size/capacity/configuration) needed to clean the sewers to 95% clean, temporary bypass pumping, maintaining/minimizing flows, and all other related items and expenses whether specifically mentioned or not. For example, this bid item is to be used when manhole entry is required to remove unusually large or heavy materials from the pipe and manhole that cannot be removed by water jet and vacuum/pump. Special cleaning tools may include, but not be limited to root cutters; cutting heads; lumberjack; porcupines; manual removal via rope/bucket, etc. This item may be used for buried manhole investigation or if the sewers in the field are not as shown on the plan. This bid item shall only be used as approved by the ENGINEER. All costs associated with this item shall be paid for on a time & material (T&M) basis per individual/task submitted by the CONTRACTOR to the ENGINEER for approval. T&M rates shall be in accordance with rates submitted by the CONTRACTOR as part of the bid documents. All work shall be in accordance with the City of Canton Supplemental Specifications, Current Edition and City of Canton Standard Construction Drawings.

Payment will be made on force account basis by submission of invoice for T&M approved by the ENGINEER (prior to completion). At the end of the contract, all remaining allowance funds will be deducted from the final Contract price via change order. The allowance is not to be used for the correction of any errors or omissions by the CONTRACTOR, or for work items included in other Bid Items.

Item 3 – Local Off-Duty Police Assistance with Maintenance of Traffic (MOT) - Allowance:

This item shall include all coordination and costs for the CONTRACTOR to utilize local (City of Canton) off-duty police and vehicles to provide MOT as defined in Specification 01 11 00 Summary of Work, section 3.04.

The CONTRACTOR shall review the entire project and identify project areas where they propose to use this level of MOT. The ENGINEER/OWNER will review said proposed areas and determine if use of this allowance is authorized, based on applicable quotes provided by CONTRACTOR.

Payment will be made on force account basis by submission of invoice for police T&M approved by the ENGINEER (prior to completion). At the end of the contract, all remaining allowance funds will be deducted from the final Contract price via change order. The allowance is not to be used for the correction of any errors or omissions by the CONTRACTOR, or for work items included in other Bid Items.

<u>Item 4 – By-pass Pumping Allowance:</u>

This item shall include all labor, equipment, and materials to implement a temporary by-pass pumping system for the purpose of inspecting a sewer segment. The work of this item shall be completed in accordance with Specification 33 01 40, By-Pass Pumping Complete. The CONTRACTOR shall review the work and submit a full detailed temporary by-pass pumping plan for each area where the CONTRACTOR determines by-pass pumping is needed. No work shall be performed prior to obtaining approval of the submitted plan and cost for each area listed.

Payment will be made on force account basis by submission of invoice for T&M approved by the ENGINEER (prior to completion). At the end of the contract, all remaining allowance funds will be deducted from the final Contract price via change order. The allowance is not to be used for the correction of any errors or omissions by the CONTRACTOR, or for work items included in other Bid Items.

<u>Item 5 – Sediment & Debris Handling and Disposal:</u>

This item shall include all labor, equipment, materials, submittals, and documentation, for handling any and all sediment & debris material and all other items removed from sanitary sewer pipes, manholes, and related underground structures and vaults as a result of cleaning operations, in accordance with Specification 33 01 33, Sewer Cleaning.

This item shall include, but not be limited to: handling, hauling, disposal, drying, dewatering, temporary storage, construction of temporary ramps and dumping/drying pads, sediment and erosion control, grading and seeding, cleaning & maintenance of pads, pumping, water usage, analytical testing as required for disposal, tarping, covering, field documentation, truck tickets, executed/countersigned manifests, copies of all certifications/licenses/documentation for proposed disposal facilities, compliance with all federal and state rules/regulations/ordinances, fees, and all other related items and expenses whether specifically mentioned or not.

Payment will be made on a per ton basis for the dry/dewatered weight disposed and documented by the final receiving licensed disposal facility, upon acceptance of submittals and confirmation of disposal in accordance with the specifications by the ENGINEER.

<u>Item 6 – Site Restoration:</u>

This item shall include all labor, equipment, materials, submittals, and documentation, for handling any and all site restoration, in accordance with Specification 01 11 00, Summary of Work, Section 3.21.

This item shall include, but not be limited to: the repair and replacement of roads, pavement, walks, curbs, drives, culverts, ditches, swales, lawn, grass, landscaping, trees, shrubbery, bushes, mailboxes, lights, posts, signs, fences, handrails, guardrails, retaining walls, private property, utilities, parks, sports fields, and all other related items and expenses whether specifically mentioned or not.

Payment will be made on a percent completed basis in relation to the overall restoration required (100%) for the project and as documented by the ENGINEER, upon acceptance of completion in accordance with the specifications by the ENGINEER.

PROPOSED WORK PLAN

The BIDDER is required to submit a Work Plan as part of their Bidding Documents. This Work Plan will be evaluated to determine the lowest and <u>best</u> bidder.

The Work Plan should include topics described below. Additional items may be included at the BIDDER's discretion.

1. Project Management

- a. How will management of the project be done to ensure work is carried out without delays?
- b. What type of scheduling software will be used to track progress? How will this be transmitted to the ENGINEER?
- c. How is project management organized to minimize or eliminate change orders?
- d. The CONTRACTOR shall have a single point of contact available at all times to coordinate with ENGINEER. This single point of contact shall be familiar with all aspects of the project and be able to make decisions on behalf of the CONTRACTOR and be able to carry out instruction provided by the ENGINEER. How will the CONTRACTOR meet this requirement?
- e. The CONTRACTOR shall have a single point of contact available at all times when crews are mobilized that knows the location of all crews. This person shall be available and prepared to notify ENGINEER of crew locations at any time. What method will be used to track crew locations and how will this point of contact ensure availability at all times when crews are mobilized?

2. Schedule and Sequencing

- a. Discuss expectations for the project. Number of crews available and estimated number of segments to be completed per day.
- b. What is the sequencing for the project?
- c. Provide preliminary project schedule.
- d. If the CONTRACTOR falls behind schedule, what actions will be taken to get back on schedule?

3. Equipment and Crews

- a. List equipment to be available and utilized on this project. Indicate model numbers, ages, and whether the equipment is owned or will be leased to the BIDDER.
- b. With consideration of this project and the data supplied to the BIDDERS, in which types of sewer conditions will each type of equipment be used?
- c. Describe the numbers of crews and number of personnel in each crew to be utilized in your Work Plan.

4. Safety and Health Plan/Manual

- a. Documentation of confined space entry plan, safety procedures, and evidence of safety record.
- b. Overall policies and procedures.
- c. Training and certifications.
- d. Designate on-site safety leaders/personnel

- 5. Debris Removal, Hauling, and Disposal
 - a. How will large and/or unusual debris be removed?
 - b. What is the proposed process of hauling and disposal?
 - c. The City may be able to offer a staging location for debris storage in the period between removal from the sewer and hauling to a disposal location. If interested in using this site, the BIDDER will need to provide information on the area required (footprint).
 - d. What final disposal site/landfill does the BIDDER anticipate using?

6. Water Use Requirements

- a. If potable water is required, what is the estimate for potable water usage?
- b. If recycled water will be used:
 - i. Does the BIDDER expect enough wastewater to be available during dry weather conditions?
 - ii. What are the procedures if not enough wastewater is available for specific sewers?
 - iii. What is the anticipated recycled water percentage to be utilized?

7. Temporary Bypass Pumping

a. Although not anticipated, are there any areas where the CONTRACTOR anticipates that temporary bypass pumping will be required other than those areas specified under Bid Item 4? Where are these specific locations and anticipated costs?

8. Weather and Temperature

a. Provide discussion on considerations and limitations for working in varying degrees of weather and temperature conditions. How will work plans be impacted and what modifications can be made to ensure production?

9. Maintenance of Traffic (MOT)

a. Provide a detailed MOT plan, including policies, procedures, and equipment.

SECTION 01 11 00

SUMMARY OF WORK

PART 1 - GENERAL

1.01 WORK COVERED BY CONTRACT DOCUMENTS

- A. Description: Except as otherwise expressly provided herein, the CONTRACTOR shall provide each and every item of expense necessary (including but not limited to materials, equipment, labor, tools, and incidentals necessary, including travel, lodging and per diems) for providing cleaning and CCTV inspection various sizes of sanitary sewers. The work is located, throughout the City as shown on the plans/maps. Sewer Maps are attached to identify the sewers to be cleaned and inspected. Sewers may or may not be continuous and connected, and multiple mobilizations, often on a daily basis, to different areas may be required. The length of the sewers to be cleaned and inspected is approximately 72,300 feet (total project lineal footage). The sewers range in size from 18-inch to 96-inch.
- B. Scope of Work: Please refer to Specifications 33 01 32, CCTV and Sonar Sewer Inspection and 33 01 33, Sewer Cleaning for detailed description of services.
- C. Plan information for the sewers to be cleaned and inspected are part of these documents. This information includes overall project maps, the City of Canton's underground sewer maps (not necessarily as-built record documents), and sediment sampling laboratory analyses. The OWNER'S manhole and sewer segment record numbers (asset identification) are shown on these documents and shall be used as reference for all the cleaning and televising activities, submittals, and deliverables. CCTV files must be recorded and named by the segment record number.
- D. The sewer runs contain a variety of different size/shape/length/taper/construction type of bends/sweeps/wyes and other connections and junctions. It is typical to not have direct access to these items as there may or not be a manhole directly overhead, and if there is a manhole it may be offset or multiple feet away. The CONTRACTOR shall be prepared to navigate and pass through such items with cleaning and CCTV/sonar equipment.
- E. CONTRACTOR's work will be in accordance with detailed specification sections and project contract documents, including City of Canton standards and City of Canton Supplemental Specifications. In the event of conflict between the detailed specification sections and terms and conditions of the project contract, City of Canton standards and City of Canton Supplemental Specifications will govern.

1.02 JOB CONDITIONS

- A. General Requirements. It is imperative that existing facilities remain functional during the construction unless noted otherwise in the Contract Documents.
- B. Coordination. CONTRACTOR shall communicate and coordinate daily with ENGINEER and on-site resident project representative (RPR) regarding current and

future work activities. CONTRACTOR and ENGINEER shall coordinate to set up a means for "cloud" based project file sharing/transfer, the cost of which will be the responsibility of the CONTRACTOR.

- 1. Coordinate the work of all SUBCONTRACTORs, crafts, and trades engaged in the work.
- 2. The CONTRACTOR will coordinate the work of all SUBCONTRACTORs on-site.
- 3. Delays in the construction schedule due to failure of the CONTRACTOR to adequately coordinate the work with the OWNER/ENGINEER sufficiently in advance of the work shall not be considered as cause for extension of the Contract Time. It shall be the CONTRACTOR's responsibility to continuously keep the OWNER/ENGINEER informed of the construction schedule as the work progresses. Submittal of the construction schedule shall not relieve the CONTRACTOR of the responsibility to coordinate the work with the OWNER/ENGINEER nor give advance notifications as specified.
- C. Confine operations to areas along sewer alignments. Portions of the site beyond such areas are not to be disturbed.
- D. Keep driveways and entrances clear and available to the property owner at all times. Do not use these areas for parking or storage of materials. Schedule deliveries to minimize space and time requirements for storage of materials and equipment on site.
- E. Burial of Waste Materials. Waste materials shall not be buried. Waste material shall be properly disposed of at a licensed landfill.
- F. Work Hours.
 - 1. Please refer to the Modified General Conditions (EJCDC), Article 7 Contractor's Responsibilities, Section 7.02.B, for work hour requirements.
 - 2. The CONTRACTOR should expect that some high traffic urban/city locations may require weekend and/or evening work.
 - 3. CONTRACTOR shall discuss all work hours with the ENGINEER's resident project representative on a daily basis, coordinating both current and future work hours. Requests for modifications to work hours shall be communicated to the ENGINEER a minimum of 48 hours in advance.

The CONTRACTOR will be required to coordinate and modify their typical work schedule to accommodate and not disrupt all City events which include, but are not limited to: Football Hall of Fame events, downtown festivals, parades, holidays, etc. The CONTRACTOR is expected to keep themselves informed of City events.

G. Site Investigation and Existing Conditions. The CONTRACTOR shall visit the site to determine the conditions of the work and the present situation. Each BIDDER shall familiarize themselves with existing conditions prior to submitting their bid. The CONTRACTOR shall make any and all investigations necessary to include all costs required to accomplish the work described

H. Specific Requirements. The sewer must remain in operation at all times. If required, temporary bypass pumping or plugging must be approved in advance by the ENGINEER.

PART 2 - PRODUCTS (Not Used)

PART 3 - EXECUTION

3.01 SCHEDULE

- A. The CONTRACTOR shall prepare a schedule for all of their activities and submit the schedule and work plan for approval prior to commencing the work.
- B. The CONTRACTOR shall schedule sufficient manpower and equipment to conduct and complete the work by the indicated date on the schedule and work plan.
- C. Notifications to property owners, residents, and businesses will be provided by the CONTRACTOR a minimum of 48-hours in advance of sewer cleaning and inspection activities. At a minimum the CONTRACTOR will provide individual door hangers and portable/reusable signs at limits of the upcoming streets/locations which will be subject to work. The signs will remain until the specific work street/location is completed. CONTRACTOR will coordinate in advance with the ENGINEER/OWNER to approve the formats and language for said notifications.

3.02 PRECONSTRUCTION AUDIO-VISUAL RECORDING

A. Please refer to specification Section 01 32 34, Pre-construction Audio Visual Recording.

3.03 PROJECT OVERSIGHT OF WORK

- A. The CONTRACTOR shall conduct no cleaning or inspection work unless the ENGINEER, or his designated representative has been notified. The CONTRACTOR shall coordinate with the ENGINEER sufficiently in advance of any activities (a minimum of 48 hours) to ensure appropriate personnel are available.
- B. ENGINEER shall provide on-site resident project representation (RPR). The CONTRACTOR is not responsible for the cost of on-site RPR. The RPR will provide project oversight and observation, which includes the interpretation and enforcement of the project documents and specifications. The RPR is not responsible for locating manholes and/or making contacts/negotiations with property owners, traffic control, and work means/methods. The ENGINEER will be onsite and readily available during normal weekday working hours. The ENGINEER will provide spot inspection for evening and weekend work, and when CONTRACTOR works more than 40 hours. The CONTRACTOR is expected to conduct his/her operation in a professional manner and notify the ENGINEER of any issues. The ENGINEER requests 48-hour notification of request for evening and weekend work or work times/dates that is not typically allowed, so that the work can be approved on a weekly basis by the OWNER and so inspection services can be arranged.

C. The CONTRACTOR shall meet with the RPR on a weekly basis for the duration of the contract to compare field inspected footages and other bid quantities. Effort shall be made at that time to resolve discrepancies between the recorded quantities from both parties.

3.04 MAINTENANCE OF TRAFFIC (MOT)

A. Maintaining traffic.

- 1. The CONTRACTOR shall maintain traffic adjacent to and through the project as described below and in accordance with the requirements of the Ohio Department of Transportation (ODOT) Manual of Construction and Materials specifications item 614 maintaining traffic. The CONTRACTOR shall furnish, maintain, and remove all signs, flags, flagmen, watchmen, barricades, sign supports, cones, barrels, and incidentals in conformance with the most recent revisions of the current edition of the Ohio Manual of Uniform Traffic Control Devices for Streets and Highways. Interference with vehicular traffic shall be kept to a minimum at all times. All open trenches and excavations shall be protected with drums, barricades, or barriers. Access shall be maintained at all times for emergency and fire department vehicles.
- 2. Any temporary roadway closing must be approved in writing by the City traffic engineer and any other public agency having jurisdiction. The contractor shall notify the traffic engineer at least 72 hours in advance of any such closings for publication and emergency agency notification.
- 3. All trucks, equipment, and support vehicles, signs, and arrow boards used by the CONTRACTOR or SUBCONTRACTORS will utilize high visibility LED warning lights as possible.
- 4. Local off-duty police force and vehicles will be utilized by the CONTRACTOR for (MOT) at high traffic roads and intersections. The CONTRACTOR, ENGINNER, and OWNER will coordinate to determine which project areas require this MOT. An allowance amount for these costs is included in the bid form.
- 5. CONTRACTOR will be required to submit a detailed MOT plan as a section in their "Work Plan" as part of their bid submittal.
- 6. CONTRACTOR will coordinate frequently with City Engineering Department, Traffic Engineer, Nick Loukas.

B. Residential and business areas:

1. The CONTRACTOR shall maintain access to local residences and businesses during construction. In the event a drive access needs to be closed, the CONTRACTOR shall give notice of closure and duration to the property owner 24 hours in advance. CONTRACTOR shall arrange for alternate

parking and reasonable access for those property owners affected by drive closures.

- C. All open manholes shall be protected with drums, barricades, or barriers.
- D. The CONTRACTOR shall submit to the City Engineer a traffic control plan in accordance with City Supplemental Specification 01-00. Detours, if necessary, shall be approved by the City Engineer prior to plan submission.
- E. The CONTRACTOR shall maintain access to local residences and businesses during the project. In the event a drive access needs to be closed, the CONTRACTOR shall give notice of the closure and duration to the property owner 24 hours in advance. CONTRACTOR shall arrange for alternate parking and reasonable access for those property owners affected by drive closures.
- F. The following area have been identified from a preliminary review as having the potential to present challenges for MOT and therefore require prior coordination and planning. This is not a "complete list" and is provided as general information for the CONTRACTOR:
 - 1. Tuscarawas Street
 - 2. Fulton Road

3.05 EXAMINATION

A. Site Verification

- 1. Confirm all requirements, conditions, dimensions, and time intervals prior to beginning actual construction in any given area.
- 2. Confirm that the conditions have not changed since preparation and submission of the bid.
- 3. Notify the OWNER and ENGINEER if the proposed work is incompatible or incomplete.

3.06 PERMITS

A. It shall be the CONTRACTOR's responsibility to obtain any and all required permits prior to beginning work. All permit costs and fees including construction deposits shall be borne by each CONTRACTOR.

3.07 SAFETY

A. General. Safety requirements shall be in accordance with the General Conditions and the Occupational Safety and Health Act of 1970, U.S. Department of Labor. The CONTRACTOR is required to provide additional provisions for the safety of children in areas of work. These provisions require that the work area shall be fenced; and open excavations, open manholes or similar hazards shall not be left unattended. Excavations shall be secured at night and all equipment and supplies moved to a secured area.

- B. Please refer to Specification 01 31 14, Safety and Health.
- 3.08 USE OF OWNER FORCES. The CONTRACTOR shall provide all labor, services, materials, equipment, proper and necessary to complete the work required by the Contract. It is expressly understood and agreed by the CONTRACTOR as a part of this Contract that no OWNER services, materials, equipment, labor or property shall be used for this project without the express written permission of the OWNER. The CONTRACTOR shall reimburse the OWNER for any and all such services, materials, equipment, and property used. The CONTRACTOR further agrees that such unauthorized use of OWNER employees shall result in the immediate termination of this Contract.
- **3.09 PROTECTION OF FACILITIES.** The CONTRACTOR shall exercise extreme caution within and adjacent to his work areas so as not to damage existing facilities. The CONTRACTOR shall assume all responsibility for the protection of any existing facility to remain in service. Any facilities that are damaged due to the CONTRACTOR's operations shall be repaired or replaced by the CONTRACTOR to original condition at no expense to the OWNER.
- 3.10 PROTECTION OF TREES. Special attention shall be given to the trees which exist in the proximity of the proposed construction. The CONTRACTOR shall provide the labor, tools, equipment, and materials necessary to protect the integrity of each tree from damage during the performance of the contracted work. Any trees that are damaged due to the CONTRACTOR's operations shall be repaired or replaced at no expense by the CONTRACTOR to the satisfaction of the OWNER.
- 3.11 CONTROL OF HAZARD AND NUISANCE CONDITIONS. All of the CONTRACTOR's activities, equipment and materials shall be conducted and managed in a manner that will protect the environment, promote and preserve public health and safety, preclude nuisance conditions, and in accordance with the requirements of specification Sections 01 31 14, Safety and Health. The CONTRACTOR's construction activities shall be conducted to minimize all unnecessary noise, dust, and odors. The use of oil or other materials which may cause tracking shall not be permitted. The CONTRACTOR shall conform to any and all local requirements regarding dust, noise, and working hours.
- **3.12 CONSTRUCTION COORDINATION.** The CONTRACTOR shall coordinate construction scheduling and activities with the OWNER, ENGINEER, and other cleaning/construction contracts which may be ongoing at the same time.

3.13 UTILITIES

A. Water. The CONTRACTOR shall make his own arrangements to have water at the construction site for any required use. All costs for having water at the construction site shall be paid by the CONTRACTOR, the cost for which shall be included in the CONTRACTOR's bid prices for all work items requiring water.

The Canton Water Department (CWD) is able to make water available for CONTRACTOR use. All water used must pass through a meter assembly installed by the CWD at its fire hydrants and subject to its regulation and paid for at the rate of \$5.9327 per one hundred (100) cubic feet of water consumed, as established by CWD, plus the cost (\$2,250 deposit)

of meter assembly and installation of the same. Water may be obtained from the CWD fire hydrants within the distribution system as approved in advance (weekly) by the CWD. The CONTRACTOR shall record the amount of water used daily and report to the CWD the amount of water used during the performance of work. Please call the CWD Engineering Office at 330-489-3310, in order to request a Hydrant Connection Permit and to confirm applicable water rates and deposit amount. Each hydrant meter assembly will require a separate permit and deposit.

Once the project is completed, the meter assemblies must be returned to CWD, at which time the deposit amount will be refunded providing the meter assembly is in good condition. If a meter isn't returned to CWD, the cost of a replacement meter assembly and associated fittings and components will be the responsibility of the CONTRACTOR.

The CWD will install and move all meter assemblies. The CONTRACTOR will not be allowed to install/move meter assemblies. The CONTRACTOR will coordinate with the ENGINEER in advance (weekly) to identify hydrants which the CONTRACTOR is proposing to utilize for drawing water. The ENGINEER will coordinate with CWD to gain approval to utilize the proposed hydrants. CWD may recommend alternate hydrants for use, in order to minimize stress and risk to their distribution system. CONTRACTOR will close and drain each hydrant at the end of each workday and over weekends. During freezing temperatures, CONTRACTOR shall utilize insulation materials to thoroughly wrap each hydrant meter assembly and associated piping and fitting to prevent freezing and damage.

The CONTRACTOR will not be permitted to connect to and/or continue drawing water from damaged or leaking hydrants. CONTRACTOR shall immediately notify the ENGINEER of damaged or leaking hydrants. Hydrants damaged by the CONTRACTOR shall be repaired by CWD on a T&M basis, the cost of which shall be the responsibility of the CONTRACTOR.

CWD reserves the right to revoke the privilege of drawing water from their hydrants should it be their opinion the operation of drawing water for this purpose is deemed detrimental to the water distribution system.

- **3.14 SITE REPAIR.** The CONTRACTOR shall be responsible for restoring to its previous condition all site areas/items damaged during work. Such areas/items include, but are not limited to pavement and walks, roadways, drives, curbs, guardrails, landscaping, mailboxes, signs, stream banks, grass areas, fields, manholes.
- **3.15 PRESERVATION OF PROPERTY CORNERS AND SURVEY MARKERS**. The CONTRACTOR shall preserve all cornerstones, iron pins, monuments, or any other type of land monument. He shall have all land monuments in the proximity of the work referenced. He shall replace destroyed or damaged monuments and shall furnish a certification by a registered surveyor that the monuments have been restored.
- **3.16 SPILLS.** No spills can occur during the performance of work. The CONTRACTOR is responsible for immediately reporting any spills to the ENGINEER/OWNER, and any associated fees or fines.

- **3.17 CLEANUP.** All waste, spills, spoils, and debris shall be cleaned and removed from the site, roadways, and property immediately. None shall be allowed to accumulate
- **3.18 TEMPORARY BYPASS PUMPING.** Should bypassing of sewer flow be required to accomplish the work, the CONTRACTOR shall provide temporary facilities to ensure that all flows are accommodated. The CONTRACTOR shall provide the ENGINEER the bypass pumping plan in accordance with Specification 33 01 40, By-pass Pumping Complete.
- **3.19 ACCESS.** The CONTRACTOR shall be responsible for gaining access to all necessary areas. The CONTRACTOR shall coordinate with the ENGINEER for assistance in gaining access to private property and buildings.

Private Property Access. The CONTRACTOR will be responsible for all contact, discussions, negotiations, and advance notifications with property owners in order to gain permission to access and utilize property and easements and install access roads. The ENGINEER and the City may assist the CONTRACTOR with these matters should the CONTRACTOR be unsuccessful and be able to demonstrate that all options have been exhausted. Temporary roads may be left in place in some locations, only with the permission of the OWNER and only if on City property. The CONTRACTOR should anticipate the possibility of being required to work outside normal hours of operation (or seasonal operation), which includes but is not limited to nights and/or weekends and will require prior approval from the ENGINEER and OWNER.

- 1. Parks. CONTRACTOR will coordinate with Parks and Recreation Director, Doug Foltz (330-438-4690) for access and work within City Park property, or work that will impact access to park property.
- 2. The following area have been identified from a preliminary review as having the potential to present challenges for access and therefore require prior coordination and planning. This is not a "complete list" and is provided as general information for the CONTRACTOR:
 - 38th St. NW to Fulton Rd. NW WSI will require walking trail coordination which may require temporary closure. Prior coordination with Canton Parks is essential. Bridge weight limits along the walking path need confirmed with Canton City Engineering and Contractor shall obtain approval for all equipment prior to utilizing any bridges for access.
 - Fulton Rd. NW to 4th St. NW- WSI located in the Canton Park, at both Stadium and Monument. Coordination will be essential. Grass restoration and pedestrian traffic are key concerns.
 - 4th St. NW to Navarre Rd. SW
 - Just south of Tuscarawas St. W is Mother Gooseland (423 Schroyer Ave, SE 44702). Prior coordination with Canton Parks is essential.

- May require a temporary access road from the Canton City Engineer/Street Department Yard (location of one potential dewatering site) to Navarre Rd. SW. This is a very difficult area for access.
- Navarre Rd SW to 15th St. SW ODOT occupies this entire area with their bridge replacement project. Access should not be a problem, but prior coordination will be required. Canton can assist CONTRACTOR with facilitating access if CONTRACTOR provides a schedule of when they anticipate being in the work area.
- Allen Ave. SW to the Allen Avenue SW Pump Station Area (near the Railroad Tracks) - Sewer is off-road with a lower ground elevation and therefore may need a temporary access road.
- Allen Ave. SW Pump Station Area (near the Railroad Tracks) to Central Ave. SE – Many backyards and access issues. Temporary road and prior coordination with homeowners will likely be required.
- Water Reclamation Facility (3530 Central Ave SE) Canton will provide contact information at the preconstruction meeting. Prior coordination is essential for access to site.
- 3. The following events have been identified from a preliminary review as having the potential to present challenges for scheduling and therefore require prior coordination and planning. This is not a "complete list" and is provided as general information for the CONTRACTOR:
 - Pro Football Hall of Fame.
 2020 events have been cancelled at this time.
 - Miscellaneous City and County Park activities.
 - Avoid working in area of Monument Park and Stadium Park from Thanksgiving through 2nd week of January, due to Christmas light displays.

3.20 SUGGESTED CLEANING AND INSPECTION SEQUENCE.

- A. Sewer Segment Cleaning and Inspection
 - 1. Begin Pre-Inspection (PACP)
 - a. If inspection is completed for entire run and pipe is shown to be 95% clean, then work is completed.
 - b. If inspection is abandoned due to materials and obstructions or it is evident that pipe is not 95% clean, then stop survey and begin cleaning.
 - c. Identify, field mark, and locate buried manholes (if necessary).
 - 2. Clean segment.
 - 3. Post inspection (PACP)
 - a. Identify, field mark, and locate buried manholes (if necessary).

- 4. Submit estimates for addressing buried manholes (if necessary).
- 5. Coordinate manholes rebuilt work (buried manholes) with SUBCONTRACTOR if needed and authorized.

3.21 SITE RESTORATION

- A. The CONTRACTOR shall be aware of existing conditions at each site and area of work and thoroughly document said conditions via pre-construction audio-visual recording, which at a minimum will include all right-of-way, easements, and other areas the CONTRACTOR anticipates accessing and impacting. Pre-construction audio-visual recording will be completed and submitted to ENGINEER, prior to CONTRACTOR accessing and impacting said areas. This shall include but not be limited to trees, shrubbery, wetlands, drainage features, landscaping, structures, fences, mailboxes, driveways, curbs, sidewalks, pavements, roads, signs, etc. All pre-construction conditions shall be fully restored to their original condition once sewer cleaning and inspection is completed.
 - 1. Any damage to existing property, utilities, and/or facilities shall be paid at the CONTRACTOR's expense.
 - When working on private property, the CONTRACTOR shall obtain Acknowledgement-of-Completion (AOC) from the property owner that work was completed in accordance with the Right-of-Entry agreement. No payment for associated work will be made until the copy of AOC is submitted to the ENGINEER.
 - 3. Special care and attention will be required by the CONTRACTOR and their subcontractor(s) when performing restoration in City/County Park areas. Restoration of said areas will be per the requirements and to the satisfaction of the applicable park department (City of Canton; or Stark County).
 - 4. Topsoil provided for grading and reseeding shall be finely graded and free of stone, rocks, clay and soil balls, roots, sticks, and man-made debris.
 - 5. City and County, and Park requirements govern over the specification requirements stated herein.

END OF SECTION

SECTION 01 31 14

SAFETY AND HEALTH

PART 1 - GENERAL

1.01 SAFETY AND HEALTH REGULATIONS

The CONTRACTOR shall exercise precaution at all times for the protection of persons, including employees, and property. The CONTRACTOR shall comply with all applicable laws, pertaining to such protection including all Federal, State and Local occupational safety and health acts, standards and regulations promulgated there under. Development and implementation of a safety and health plan shall be the sole responsibility of the CONTRACTOR.

The CONTRACTOR shall comply with Section 107 of the Federal Contract Work Hours and Safety Standards Act, as set forth in Title 29, C.F.R.

The CONTRACTOR shall comply with the provisions of the Federal Occupational Safety and Health Act, as amended.

The CONTRACTOR shall provide and maintain in a neat, sanitary condition such accommodations for the use of the employees as may be necessary to comply with the requirements and regulations of the Washington Industrial Safety and Health Act of 1973.

The CONTRACTOR shall provide all safeguards, safety devices and protective equipment and take any other needed actions, on his own responsibility reasonably necessary to protect the life and the health of employees on the job, the safety of the public, and to protect property in connection with the performance of the work covered by this Contract.

1.02 SPECIAL CONSIDERATIONS

A. General. This section describes certain minimum precautions the CONTRACTOR shall consider in developing its safety and health program. It supplements the regulatory requirements of Section 1.01, above. Sewers and appurtenant structures are considered confined spaces and are subject to Federal, State and Local regulations governing confined space entry and safety procedures.

B. Infectious Diseases.

- The CONTRACTOR should anticipate that a wide spectrum of disease-producing organisms will be present in the sewer. In addition to the requirements set forth in the regulations described in Section 1.01 above, the CONTRACTOR shall provide the following:
 - a. Instruction in appropriate disease-prevention mechanisms and personal sanitation practices for all workers and supervisors.
 - b. A preventative inoculation program (tetanus/ diphtheria, hepatitis, etc.) available to all personnel.
 - c. Clothing to protect against infection, including rubber boots with full sole and heel steel insert-liners, safety glasses or goggles, gloves, respirator masks.

2. Potential Impacts and Delays Due to COVID-19. In an effort to anticipate the potential impacts to the PROJECT caused by the COVID-19 threat and in following direction from the Governor and other authorities, the CONTRACTOR is on notice of the need to comply with all current Federal, State and Local orders generated to prevent the spread of contagious or infectious diseases, and any orders from the Ohio Director Health. located through the following https://coronavirus.ohio.gov/wps/portal/gov/covid-19/resources/public-healthorders/public-health-orders, CONTRACTOR is on notice that the PROJECT is considered essential and that the CONTRACTOR and his employees, subcontractors and suppliers are considered essential businesses and performing essential functions as defined under current State of Ohio orders and regulations.

Notwithstanding any other provisions of the contract documents, in the event of project delay or impacts to performance due to a voluntary or mandatory COVID-19 virus Directives, Orders, quarantine or closure directed by government authorities, either party may, by providing notice to the other party in writing requesting to extend the Completion Date for a period of up to thirty (30) days. Extensions under this paragraph shall be considered an excusable, non-compensable delay. If any portion of the WORK is still not able to be performed upon the expiration of the extension, either party may provide notice to the other party requesting a termination for convenience. The termination for convenience remains at the sole discretion of the OWNER. The CONTRACTOR and OWNER will exercise best efforts to utilize remote services to perform WORK that otherwise cannot be performed in person due to a voluntary or mandatory COVID-19 virus quarantine, closure, or other agreed upon impact.

Field personnel should be following CDC, Federal, State, and Local guidance regarding strategies to limit disease spread (i.e. not sharing vehicles, wearing masks, maintaining 6 ft. separation, etc.). The ENGINEER/OWNER would request the procedures listed below be followed (not limited to only these):

- a. Additional, more frequent sanitization procedures for trucks and equipment.
- b. Wearing masks while working or maintaining recommended 6 ft. separation for social distancing.
- c. Employees should be provided PPE (masks, disposable gloves, hand sanitizer, etc.).
- d. Provide method for resident project representative (RPR) to monitor inspection and maintain recommended social distancing guidelines.
- C. Dangerous Gases and Oxygen Deficiency. The sewer, sewer manholes, and trenches are confined spaces, which means they have a limited means of egress and are subject to the accumulation of dangerous gases or oxygen deficiency and present an engulfment hazard. Volatile petroleum products and common household hazardous materials may be discharged into the sewer. Explosive gases, such as methane generated from decomposing organic material, may be accumulated. Also, toxic gases, such as hydrogen sulfide, may be present in life-threatening concentrations. Significant oxygen depletion may occur. In addition, construction procedures may require combustion engine machinery to be located in or near the work site. Therefore, gaseous combustion by-products, such as carbon monoxide, may be present.

- D. Additional Requirements. In addition to the requirements set forth in the regulations described in the paragraphs above, the CONTRACTOR shall provide: portable atmospheric monitors that measure levels of oxygen, explosive gas (methane), carbon monoxide, and toxic gas (hydrogen sulfide). Monitors shall be properly calibrated and carefully maintained throughout the construction period. Monitors shall be used continuously while personnel are in the sewer.
- E. Toxic Chemicals. Toxic chemicals may be part of the construction process. The CONTRACTOR shall abide by all handling procedures recommended by the manufacturer when dealing with toxic chemicals.
- F. Wet Weather Effect on Sewer Flow. The CONTRACTOR shall exercise caution when working in sanitary sewers during rain events. During rain events, sanitary sewers may reach capacity very quickly and/or hydraulically surcharge. Sewers outside of the rain event area, but connected to sewers within the rain event area, are also subject to these conditions.
- G. Respirator Masks. It is recommended that the CONTRACTOR consider having all confined space entrants wear respirator masks in an attempt to prevent potential illness due to exposure and contact to the sewer environment.
- H. Confined Space. All related documents, entry forms, policies, procedures, individual training certificates, and necessary equipment will be on-site with each separate crew at all times. Work and training involving confined space entry will be in accordance with OSHA and applicable state, federal, and local rules and standards.

PART 2 - MATERIALS

2.01 GENERAL

The CONTRACTOR shall develop and maintain for the duration of the Contract, a Safety and Health Plan/Manual that will effectively incorporate and implement all required health and safety precautions. At least one copy shall be located on the CONTRACTOR's work site.

- The Safety and Health Plan/Manual will be provided as a section of the "Work Plan" which is required to be submitted as part of the overall bid documents submittal.
- COVID-19 policies and procedures shall be included.

2.02 COMPLIANCE

The CONTRACTOR shall appoint an employee who is qualified and authorized to supervise and enforce compliance with the Safety and Health Plan. The CONTRACTOR is responsible for ensuring that necessary gas monitoring, protective clothing, and other supplies and equipment as necessary are available to implement this plan.

2.03 REVISIONS

In the event that regulatory agencies or jurisdictions determine the Safety and Health Plan to be inadequate to protect employees and the public:

- A. The CONTRACTOR shall stop the WORK in progress until adequate safety measures are implemented.
- B. The CONTRACTOR shall modify the plan to meet the requirements of said regulatory agencies or jurisdictions.

2.04 MINIMUM CONSIDERATIONS

The Safety and Health Plan/Manual shall, as a minimum, include the following considerations, as applicable:

- A. Objective.
- B. Key personnel and responsibilities.
- C. Hazard analysis of the work activities and environment.
- D. Training requirements, including authorized personnel and qualifications for work in confined spaces.
- E. Personal protective equipment.
- F. Confined space entry procedures, including atmospheric gas monitoring program and ventilation of work area and confined spaces.
- G. Site control measures.
- H. Work practices, decontamination procedures, and work limitations.
- I. Emergency procedures, including sewer evacuation plan, location of first aid, fire extinguishers, eyewash, drinking water, map showing route to nearest medical facility, list of key personnel who are currently certified in first aid/CPR.
- J. Job site cleanup, and spill containment and cleanup procedures.
- K. Telephone Numbers: 24-hour number to contact CONTRACTOR's Representative and Emergency services.
- L. Documentation (training, injury or illness, respirator-fit tests, hazards notification log, etc.).
- M. COVID-19 policies and procedures.

END OF SECTION

SECTION 01 32 34

PRECONSTRUCTION AUDIO-VISUAL RECORDING (ABOVE GROUND)

PART 1 - GENERAL

1.01 DESCRIPTION

Provide the labor, tools, equipment, and materials necessary to furnish the audiovisual recording in accordance with the drawings and specifications. The CONTRACTOR shall prepare a color video record of the existing surface features for any worksite locations and any special access routes that are not within the existing roadways prior to beginning the work at such locations. The purpose of this video shall be to accurately document the pre-work condition of the surface features that may be impacted during the prosecution of the work. The video record will be used to ascertain that the subsequent restoration of disturbed surface features to their original condition has been completed. The video shall be in accordance with these specifications.

It is suggested that the CONTRACTOR complete a date-stamped preconstruction audiovisual recording of the above ground areas being disturbed by construction activities. It is at the CONTRACTOR's discretion as to when said recording is performed. The ENGINEER and OWNER are not required to verify this work is completed or done in conformance with this specification, which is provided as a general guide. The CONTRACTOR may continue his/her work without the benefit of this video; however, he/she does so at his/her own risk. If no video is completed, there will be no reference document should a claim be made against the CONTRACTOR and the ENGINEER and OWNER will not be involved in dispute resolution.

1.02 **QUALITY ASSURANCE**

A. Codes and Standards. Perform all work in providing the audiovisual recording in compliance with applicable requirements of governing agencies having jurisdiction.

1.03 SUBMITTALS. Provide all submittals in accordance with this specification.

- A. Submittal Package No. 1 Sample DVD/Flash Drive
 - 1. At the start of the recording, submit a sample DVD/flash drive of a portion of this project. No taping shall occur before the sample is approved.
- B. Submittal Package No. 2 DVD/Flash Drive and Log
 - 1. DVD/Flash Drive Log. Provide a log that accurately catalogs the contents of each DVD or flash drive in an acceptable manner. Information in the log will include the following:
 - a. Street name, easement, or address.
 - b. Sheet number or numbers relative to the line entry of a particular area of coverage.
 - c. DVD numbers.

- d. Real-time code indexing for each segment of the project. Real-time code indexing will indicate hours, minutes, and seconds to cross reference with playback equipment to locate specific points of interest on the project.
- e. Direction of travel for each specific segment.
- f. Viewing side for each specific segment.
- g. Starting point for each specific segment.
- h. Ending point for each specific segment.
- i. Project information (project title, Owner, date, location).
- 2. DVD/Flash Drive. Label DVD/Flash Drive with project information in an acceptable manner. Cross reference the information on the labels with the log. Information on labels shall include the following:
 - a. DVD/Flash Drive number.
 - b. Project title.
 - c. Location of project.
 - d. Month and year of coverage.
 - e. DVD/Flash Drive must be marked as sets (Engineer set, Owner set, Contractor set).
 - f. Quick reference list of the contents.

1.04 JOB CONDITIONS

- A. Recording. Record each area and submit DVD/Flash Drive before mobilization begins. All recording shall be witnessed unless waived in writing. No work shall begin until the ENGINEER has approved the recordings.
- B. Visual Inspection. Prior to recording, investigate all areas visually with notation made of features not readily visible by recording methods which are located within the zone of influence of construction. This would include, but not be limited to, manholes known to be buried, which may require excavation and raising, and anticipated off-road access routes. Record all measurements made during the inspection.

PART 2 - MATERIALS

2.01 EQUIPMENT

- A. DVD/Flash Drive. DVD/flash drive shall be original, previously unrecorded, blank DVD/flash drives. If duplicate copies are required by the OWNER, all copies shall be limited to direct copies of the original DVD/flash drive and marked as such.
- B. Camera/Camcorder. The camera/camcorder shall have the following features:
 - 1. Color.
 - 2. High-resolution, digital recording.
 - 3. 1/4-inch, 1/3-inch, or 1/2-inch charged coupled device imaging systems.
 - 4. Optical Stabilization. No electronic stabilization.
 - 5. 20X minimum optical magnification.
 - 6. NTSC 525 lines resolution/60 fields/30 frames per second.
 - 7. Minimum illumination capabilities of at least 3 lux.

C. Wheeled Vehicles. Clearly mark vehicles used for recording purposes with company's name and telephone number. Vehicles shall incorporate signs, flaggers, and lights as needed for safety purposes.

PART 3 - EXECUTION

3.01 VIDEO INFORMATION

- A. Audio. Begin each DVD/flash drive with an audio tract that includes the current date, project name, municipality, and general location, i.e., name of the street or property owner; location of cross county line; viewing side; and direction of progress. Note the engineering stationing (where required) on the audio track. Identify houses and buildings audibly by an address when available.
- B. Date and Time. Display the month, day, year, hours, minutes, seconds, and location on all video recording.
- C. Location/Positioning reference. The identification of the location/positioning must be continuous and accurate and reflect the field of view and must coincide with roads/intersections/buildings on project plans and document the overall length of individual runs. Global positioning system (GPS) may be used. Differential GPSs are to be used where available, with updates one per second at 5-meter or less spherical accuracy. Standard GPS accuracy is as dictated by United Sates Department of Defense mandate. GPS display will be at 1-meter-longitude and 1-meter-latitude increments (4032 N 639) (08216 W 401).

3.02 COVERAGE

- A. General. Recording shall include, but not be limited to:
 - 1. Existing pavement.
 - 2. Driveways.
 - 3. Sidewalks.
 - 4. Curbs.
 - 5. Ditches (drainage patterns are of particular concern).
 - 6. Streets (including condition of paving for full width).
 - 7. Fields.
 - 8. Grass areas.
 - 9. Wetlands.
 - 10. Landscaping.
 - 11. Shrubs.
 - 12. Trees.
 - 13. Manholes.
 - 14. Culverts.
 - 15. Catch basins.
 - 16. Headwalls.
 - 17. Fences.
 - 18. Guardrails.
 - 19. Visible utilities.

- 20. All buildings (interior and exterior) located within the zone of influence of construction. Of particular concern are existing faults, fractures, defects, or other imperfections.
- 21. Cemeteries.
- 22. Golf courses.
- B. Streets. Record streets and street areas for the full width of the zone of influence for disturbance, including both sides of the street. The term "street" shall be understood to mean street, highway, avenue, boulevard, road, alley, lane, court, driveway, parking lot, etc., and all adjacent areas within the possible zone of influence for disturbance/construction.
- C. Easements. Record easements for the full width of the permanent and temporary easements and all other adjacent areas lying within the zone of influence of construction. Easement means all areas not in streets that require record coverage. Include in this coverage any areas that are intended to be used for construction access, storage, or waste disposal.

3.03 RECORDING CONDITIONS

- A. Visibility. Record during times of good visibility. Do not record outside during the following conditions unless otherwise authorized:
 - 1. Darkness.
 - 2. During periods of visible precipitation.
 - 3. When the ground area is covered with snow, leaves, or debris.
- B. Lighting. In order to produce the proper detail and perspective, use adequate auxiliary lighting to fill in shadow areas, utility poles, road signs, and other such objects, as well as other conditions requiring artificial illumination.
- C. Rate of Speed. Do not exceed an average rate of speed of 50 feet per minute during recording. Panning rates and zoom-in/zoom-out rates shall not exceed 10 percent over a 3-second interval.
- D. Distance. When conventional wheeled vehicles are used for recording, the minimum distance from the camera lens to the ground shall be 8 feet.
- E. Off-Road/easement Areas. For sewer locations which are not located within or immediately adjacent to improved roadways, the CONTRACTOR shall provide color, hand-held video recordings performed on foot. CONTRACTOR shall take care to provide hand-held video which is steady and consistent in terms of rate of travel and ease of viewing. These recordings must include audio commentary and provide references to allow for locations within the video to be determined. Submittal requirements as currently specified are required.

END OF SECTION

SECTION 33 01 32

CCTV AND SONAR SEWER INSPECTION

PART 1 – GENERAL

1.01 DESCRIPTION

- A. Scope. This section specifies the requirements for internal television and manhole inspection of sewers in accordance with NASSCO-PACP standards.
- B. Requirements. The CONTRACTOR shall perform inspection of sewers using a color closed circuit television camera (CCTV) and Sonar inspection device (if needed) and document the inspection on a digital recorder. All inspection video shall be in MPEG or WMV file format and saved on portable hard drives for submittal. Each inspected sewer reach, manhole to manhole, should have an associated MPEG or WMV file. Inspection logs, which shall include pipe segment and manhole Asset ID's, and digital photographs (.jpg files) shall accompany the video inspections for each sewer reach (manhole to manhole) inspected. All CCTV, SONAR, and inspection log files shall be named by the segment asset ID. The nature of the inspections shall be to verify the cleanliness of the sewers.

CONTRACTOR shall be responsible for modifications to equipment and/or inspection procedures to achieve report material of acceptable quality. No work shall commence prior to approval of the material by the OWNER/ENGINEER. Once accepted, the report material shall serve as a standard for the remaining work.

1.02 QUALITY ASSURANCE

CONTRACTOR's Qualifications: The CONTRACTOR shall have a minimum of five (5) years of experience in such work necessary to successfully meet this specification and provide references for five (5) sewer inspection projects involving Sonar/CCTV combined inspection in accordance with NASSCO-PACP Standards. Provide list and references for all PACP projects within the last five years. Provide sample video/Sonar and database submittal files for 3 projects for review by the ENGINEER and OWNER prior to performing such work. Provide copies of operator certificates that will be on the project. Operators must have a minimum of 3 year's PACP inspection experience.

PART 2 – MATERIALS

2.01 TELEVISION CAMERA FOR REMOTE CCTV AND MONITOR

A. The camera(s) shall be operative in 100 percent humidity/submerged conditions. The CCTV camera equipment will provide a view of the pipe ahead of the equipment and of features to the side and rear of the equipment through turning and rotation of the lens or through turning and rotation via viewing software. The camera or viewing software shall be capable of tilting at right angles along the axis of the pipe while panning through a full circle about the circumference of the pipe. The lights on the camera shall also be capable of panning 90-degrees to the axis of the pipe. If the equipment proves to be unsatisfactory, it shall be replaced with adequate equipment.

- B. The camera and crawler unit shall be able to fit into a standard size manhole opening. The unit shall also be capable of withstanding flows in excess of 12 fps for 18-inch to 96-inch diameter size sewers. If a manhole casting needs removed to fit equipment inside, the CONTRACTOR shall replace casting according to the standards of the OWNER and be paid for at the CONTRACTOR'S expense. The CONTRACTOR may not remove any manhole castings without prior permission from the OWNER.
- C. The television camera, electronic systems and monitor shall provide an image that meets the following specifications:
 - 1. With the monitor control correctly adjusted, the six colors Yellow, Cyan, Green, Magenta, Red, and Blue, plus black and white shall be clearly resolved with the primary colors in order of decreasing luminance.
 - 2. The picture shall show no convergence or divergence over the whole of the picture. The monitor shall be at least 13-inches diagonally across the picture tube.
 - 3. The live picture on the CCTV monitor shall be capable of registering a minimum of 600 lines horizontal resolution and be a clear, stable image with no interference.
- D. Lighting intensity shall be remote controlled and shall be adjusted to minimize reflective glare. Lighting and camera quality shall provide a clear, in-focus picture of the entire inside periphery of the sewers and laterals for all conditions except submergence. Under ideal conditions (no fog in the sewer) the camera lighting shall allow a clear picture up to five pipe diameter lengths away for the entire periphery of the sewer. The lighting shall provide uniform light free from shadows or hot spots.
- E. Inadequate lighting, sewer gas, fog, mist, spray, wet or submerged camera lens, high flow levels, fast flow velocities, excessive camera movement, small window of viewable area, bypassing defects and connections without stopping/panning, or poor video quality will be just cause for the OWNER to require the sewer to be re-televised by the Contractor at no additional cost to the OWNER.
 - 1. Should the CCTV lens becomes submerged during inspection, inspection may be allowed to continue if the following conditions are met:
 - a. Prior to submergence, location where camera will come out of the water is clearly visible or submergence length is less than 10-feet.
 - b. After submergence, visibility and CCTV quality has not been significantly reduced as a result of grease, debris, water or other build up on the lens.
 - c. The OWNER or the ENGINEER's on-site field representative allows the continuation of the inspection.
 - i. Should the above criteria not be able to be met, the Contractor shall discuss alternate mean to complete the inspection with the OWNER/ENGINEER, including but not limited to reverse setup; float camera unit; adjustable height camera unit; or sonar equipment.
 - ii. Videos submitted which do not meet the above criteria may be rejected by the OWNER/ENGINEER. Contractor shall remobilize and reperform inspection of the sewer segment at no additional cost.
- F. Camera focal distance shall be remotely adjustable through a range of 6-inches to infinity.

G. The monitor and software shall also be able to capture and save screen images of typical sewer details and all defects.

2.02 SONAR EQUIPMENT

- A. Sonar Equipment consists of the following basic elements: 1) Sonar Surface Equipment. 2) In sewer Sonar Scanner. The equipment must be specifically engineered to meet the challenges of extended operations in the harsh environment encountered inside sewer pipes, while always providing images of the highest definition. Also, it must be capable of inspecting pipelines whose sizes range from 18-inches to 96-inches in diameter (with 10 inches minimum of flow) with a track record in excess of 2-years or 100,000 feet in the field. The transducer and drive motor contained within the sewer sonar scanner must be totally enclosed in an oil-filled housing which is hermetically sealed from the electronics pod resulting in no exposed moving parts. The sewer sonar scanner must be streamlined in shape to minimize the collection of rags and debris inside the sewer. Sonar unit must have a minimum of 2.4-degree angular resolution with at least 150 sectors per revolution. Full revolution scans will be recorded with a density of 2 complete sonar scans per every inspection foot. Contractor will have available, sonar equipment mounted on a wheeled/crawler inspection unit for sewer with low flow levels, in which sonar equipment mounted on a float type inspection unit is not capable of operating properly.
- B. The Sonar Equipment must have a selectable full scale and must support a return range of at least 8-inches to 20-feet. The digitally generated graphics display must use a minimum of 256 shades to represent the signal amplitude for each of these cells making at least 100,000 cells per image. If the sonar system produces analog data then a half size ISA Interface card must be fitted into the PC and must have a flash A/D converter clocked by a programmable sample rate up to a maximum of 5 MHz ensuring that the finest detail can be captured. An on-board FIFO buffer must be fitted to ensure that the data remains in perfect synchronization with the transmit pulse to produce continuous smooth images. If the sonar system produces digital data then the digital data must be recorded in a manner that allows for the data to be related to pipe position during post processing.
- C. The Sonar Equipment must have at least a 600 kHz operating frequency and an acoustic beam width of less than 2.4 degrees in order to produce accurate clear cross sections of the pipe being scanned. Analog sonar equipment must have a variable velocity of sound calibration allowing the system to be calibrated such that the measurements taken with the on-screen cursors are accurate to the pixel spacing, which must be at least 0.5mm on the shortest range. The sonar surface equipment to support analog sonar must be able to provide a continuous NTSC composite video output so that the entire survey will be recorded on DVD/flash drive and remote video monitors can be connected.
- D. When using an analog sonar system the distance moved through the pipe must be able to be displayed on the monitor screen and be logged along with the saved images for accurate determination of where flaws exist in the pipe relative to the deployment manhole.
- E. The Sonar Scanner must have pitch and roll tilt sensors with 0.3-degree resolution showing the attitude of the scanner on the screen both pictorially and numerically. The tilt sensors must be able to be set-up so that an alarm is generated if a preset tilt angle is exceeded.

F. For deployment of the sonar unit, the contractor may use either a video camera crawler (typically for small diameter pipes) driven at a uniform speed along the pipe bottom or a float (typically for large diameter pipes) may be tethered to allow travel downstream at a controlled speed. The contractor shall use the method that will obtain the best image and will negotiate anticipated obstructions. Not having a sonar unit and/or a deployment method capable of inspecting the full range of pipes sizes on the contract will not be grounds for non-performing the work. The sonar unit should make 2 complete scans per foot of travel.

2.03 VIDEO RECORDINGS

- A. The video and audio recordings of the sewer inspections shall be made using digital video equipment (.mpeg, .mpg, .wmv one file for each reach inspection) for submission on DVD/flash drive/portable hard drives. A video enhancer may be used in conjunction with, but not in lieu of, the required equipment. The digital recording equipment shall capture sewer inspection, with each sewer reach inspection recorded as an individual movie file (.mpeg, .mpg, .wmv).
- B. Audio. The audio portion of the composite video shall be sufficiently free from electrical interference and background noise to provide complete intelligibility of the oral report. Audio shall be recorded by the operating technician on the inspection video as the sewer is inspected and shall include the sewer location, identification of beginning and terminating manholes including location (address or cross streets), inspection direction, length of inspection, side sewer identification, flow information, complete descriptions of the sewer line conditions as they are encountered, description of the rehabilitation work, reason for termination, and other relevant commentary to the inspections. In addition, the audio reports shall include the distance traveled on the specific run, a description of abnormal conditions in the sewer and side sewer connections as they are encountered, explanations for pausing, backing up, or stopping the survey, and the final measured center to center distances between consecutive manholes. Audio dubbing after the inspection is prohibited.
- C. The reaches shall be documented on the video in sequential order, from upstream to downstream, wherever possible. The images recorded on the CCTV video shall be the same images that are required to be displayed on the CCTV monitor.
- D. If inspection is completed with live feed, the equipment used for the inspection must provide for simultaneous monitoring of the in-sewer inspection by the OWNER's representative. If inspection is NOT completed with live feed, the inspection must be made available for inspection by the OWNER's representative within 24-hours of the time of inspection.
- E. The inspection video should be named by the OWNER's Sewer Segment Asset ID Number, as shown on the maps provided and in the master sewer segment lists.
- F. Typed labels shall be attached to the face of each DVD or portable hard drive for both the CCTV and Sonar. The typed index labels shall include the following information:
 - 1. Content (CCTV/Sonar)
 - 2. CONTRACTOR name
 - 3. Contract Area
 - 4. Survey Date Range

5. Work order number (if applicable)

PART 3 – EXECUTION

3.01 GENERAL

A. The CCTV camera shall be positioned as close to the spring line as possible while maintaining the required equipment stability.

The camera or viewing software shall pan the periphery of the manhole interior, 360 degrees, from casting to invert. The PACP inspection technician will utilize the camera to slowly and thoroughly pan the entire manhole interior in order to provide a visual representation of the condition and materials of the manhole. Camera will zoom-in to document observed defects and unusual items. Both the upstream and downstream manholes shall be inspected in this manner for every sewer segment cleaned and inspected.

At the discretion of the OWNER, if water levels prevent adequate televising of the sewer, then conducting the work during low flow periods or other methods detailed in the Contract Documents should be implemented. The inspection will be done one sewer section at a time and the section being inspected will be isolated from the remainder of the sewer system. The camera shall be moved through the sewer in either direction at a uniform slow rate by means of cable winches at each manhole. In no case will the video camera travel at a speed greater than 30 feet per minute. When sewer conditions prevent forward movement of the camera, the Contractor shall withdraw the camera and televise the line from the opposite direction.

Contractor shall only perform inspection work when the flow depth is 50% of the pipe diameter or less, when measured at the centerline of the sewer, unless otherwise directed by the ENGINEER. This is to ensure that enough of the pipe can be observed above the flow line during the CCTV inspection for the City's requirements. The City reserves the right to not accept inspection data if this criteria is not met. Flow depth is based on the centerline of the sewer. Actual depth of flow and velocity may vary depending on slope, debris accumulation, and other obstructions. Sewer line flows shall at no time exceed 50% of the pipe diameter during the television and sonar combination inspection. Televising the sewer when flows are more than 50% of the pipe diameter or televising when the camera is below the water surface shall be cause for ENGINEER to require contractor to re-televise the sewer at no additional cost to the ENGINEER. Some sewers may have normal/dry weather flow depths in excess of 50% of the pipe diameter. The CONTRACTOR may coordinate with the ENGINEER's onsite representative in order to request permission to perform inspection when flow depths exceed 50% of the pipe diameter. Such requests and granting of permission will be done onsite in the field, on a case-by-case basis.

- B. The inspection work shall be performed and documented per NASSCO-PACP.
- C. The Contractor shall not conduct inspection work unless the ENGINEER's field representative has been notified. The Contractor shall coordinate with the representative sufficiently in advance of any activities (a minimum of 24-hours) to ensure appropriate personnel have been notified.
- D. At the ENGINEER'S discretion or direction of the OWNER, the camera shall be stopped or backed up (when conditions allow) to view and analyze conditions that appear to be unusual

- or uncommon for a sound sewer. The lens and lighting shall be readjusted, if need be, in order to ensure a clear, distinct, and properly lighted feature.
- E. Temporary By-pass Pumping. See Specification 33 01 40, By-pass Pumping Complete, for by-pass pumping requirements.
- F. The ENGINEER's field representative (after consultation with the OWNER) must authorize the type of inspection (CCTV only or CCTV/sonar combination) for each sewer segment based on actual field conditions. Payment will be based upon the actual length and type of inspection completed in accordance with the contract documents and specifications. Some sewers will not have flow levels which will allow for sonar, and for these sewers only CCTV inspection will be required. For sewer pipes with adequate flow depths for sonar implementation, the contractor will be required to perform both the CCTV and sonar inspection at the same time/day, with a combination unit. The CONTRACTOR will not be permitted to perform CCTV and sonar individually at different times/days. CCTV and sonar work performed separately will not be accepted or paid for, and the CONTRACTOR will be required to remobilize and re-perform the inspections concurrently at no additional cost to the OWNER. The CONTRACTOR not having the necessary equipment on-site will not be grounds for the ENGINEER and OWNER to waive this requirement and allow separate inspections.
- G. CONTRACTOR shall expect to perform manned entry of manholes and pipes in order to deploy and operate inspection and cleaning equipment.
- H. The CCTV and/or Sonar unit shall include a locating device/sonde at all times for the purpose of field locating and marking "Buried" manholes. The CONTRACTOR shall stop in the "buried" manhole, look up to the buried casting, and perform a 360-degree inspection of the interior of the "buried" manhole.
- I. If the CONTRACTOR's CCTV or SONAR equipment becomes lodged in the sewer, it shall be removed from the sewer solely at the CONTRACTOR's expense. This shall include excavation and repair of the sewer, underground utilities, backfilling and site restoration.
- J. The CONTRACTOR shall be prepared to access manholes that are at varying heights above grade. Change orders will not be granted for such situations.

3.02 LINEAR MEASUREMENT

- A. Prior to commencing inspections, the CONTRACTOR shall demonstrate compliance with the linear measurement tolerance specified below:
 - 1. The equipment shall measure the location of the camera unit in 1-foot increments from the beginning (upstream end) of each continuous section. This footage location must be displayed on the CCTV monitor and recorded on the digital media and inspection logs.
 - 2. The accuracy of the measured location shall be within +0.5% of the actual length of the sewer reaches being surveyed, or 1 foot, whichever is greater.

3.03 CCTV AND MONITOR DISPLAY

- A. The images displayed on the CCTV monitors will be a view of the pipe above the water surface as seen by the CCTV camera as the unit is conveyed through the sewer.
- B. The camera lighting shall be fixed in intensity prior to commencing the survey and the white balance set to the color temperature emitted. In order to ensure color constancy, ideally no variation in illumination shall take place during the survey.
- C. The video equipment shall be checked using an approved test card with a color bar prior to commencing each day's survey. The camera shall be positioned centrally and parallel to the test card at a distance where the full test card just fills the monitor screen. The card shall be illuminated evenly and uniformly without any reflection.

3.04 DATA DISPLAYS

- A. The CCTV images shall include an initial data display that identifies the sewer reach being surveyed and a survey status display that provides continuously updated information on the location of the survey unit as the survey is being performed. These data displays shall be in alphanumeric form. The size and position of the data shall not interfere with the main subject of the monitor picture.
- B. The on-screen display should be white during inspections where the background behind the display is dark and, conversely, black where the background is light.
- C. At the beginning of each reach of sewer being inspected, the following information shall be electronically generated and displayed on the CCTV monitors as well as included in the audio track:
 - 1. Date of survey
 - 2. Location
 - 3. Manhole number to manhole number
 - 4. Sewer Segment Asset ID
 - 5. Direction of survey (upstream or downstream)
 - 6. Material
 - 7. Time of start of survey.
 - 8. Pre-CCTV Inspection / Post Inspection (large diameter segments)

During inspections, the following information shall be electronically generated, automatically updated, and displayed on the CCTV monitors:

- 1. Survey unit location in the sewer line in feet and tenths of feet from adjusted zero
- 2. Sewer diameter
- 3. Sewer Segment Asset ID
- 4. The CONTRACTOR may be required periodically to provide video from the truck to the RPR/CITY for immediate review if a severe defect is identified. The

CONTRACTOR must be capable of providing video with the inspection information listed above for immediate review.

Additional information required in the PACP inspection log export with regards to cleaning operations:

- 1. Number of passes
- 2. Type of cleaning (none, jetting, or heavy cleaning)
- 3. Cleaning tools used
- 4. Level of debris (none, low, medium, or heavy)
- 5. Type debris (debris, deposits, grease, rocks/gravel, roots, etc.)

3.05 PHOTOGRAPHS

A. During CCTV inspections, screen captures will be taken from the monitor images and saved electronically by the in-sewer inspection crew of all defects, manholes (plan on taking at least two pictures per manhole to be used for internal inspection), bends, and service lateral connections. The screen capture shall have the reach (identified by the sewer segment Asset ID or manhole asset ID), survey direction, footage, and date when photograph was taken. The annotation shall be clearly visible and in contrast to its background, shall have a figure size no greater than 1/4-inch, and shall be type-printed. The annotation shall be positioned on the front of the photograph so as to not interfere with the subject of the photograph.

The image of the sewer shall fill the photographic image. Photographs must clearly and accurately show what is displayed on the monitor, which shall be in proper adjustment. Where significant features exist within 6-feet of each other, one photograph shall be made to record these features. Where there is a continuous feature, photographs shall not be taken at intervals of less than 6-feet unless absolutely necessary to show a change in the feature.

Proper lighting shall be provided and ensured for different conditions (pipe interior, manhole interior, etc.). Failure to provide the proper amount of light (insufficient or excessive) which results in poor picture quality will be grounds for the CONTRACTOR to remobilize and reacquire the pictures in question at no additional cost to the OWNER/ENGINEER.

The images shall be kept electronically and submitted with the inspection videos and logs.

3.06 MANHOLE NUMBERING, LOCATING, MARKING, AND INSPECTION

- A. The CONTRACTOR will be required to use the OWNER's Asset ID manhole and sewer segment numbering system when performing the inspections for this project.
- B. The CONTRACTOR shall field locate and mark all "Buried" Manholes. The CCTV and/or Sonar unit shall include a locating device/sonde at all times for the purpose of field locating and marking "Buried" Manholes. Locating and marking shall be accurate and able to withstand severe weather.
- C. Locating and marking "Buried Manholes" shall be in a long-term manner and to a degree of accuracy so that the CONTRACTOR is able to efficiently coordinate a SUBCONTRATCOR to uncover the manhole if authorized. Manholes shall be marked with a PK nail and paint if

found to be buried in pavement. Manhole locations shall be marked with rebar (bury rebar 100%, do not leave sticking out of ground) and wooden stake if found to be buried outside pavement. The manhole asset number and date shall be written on the wooden stake with a Sharpie. Also use survey tape to tag trees around the buried manhole so that it can be easily seen and relocated by the ENGINEER/OWNER.

D. For "buried" manholes encountered during inspections for which access will not be possible until at a later date when said manholes are excavated, during the inspection the CONTRACTOR shall stop in the center of the manhole to slowly and thoroughly pan and zoom (360-degrees) in order to provide a viewable documentation, as best as possible, of the interior of the manhole. "Buried" manholes shall be designated as such on the video log.

3.07 BYPASSING PUMPING

A. Please refer to Specification 33 01 40 for bypass pumping requirements.

3.08 DELIVERABLES

- A. Video/Sonar/Database Sample Submittal(s)
 - 1. A Sample video/sonar/database submittal of all files must be received and approved by the ENGINEER/OWNER before Contractor will be permitted to perform work, in order to ensure compatibility with the OWNER's sewer database program, and reduce coordination efforts in delivering the data to the ENGINEER during the project.
 - a. The CONTRACTOR may be required to coordinate with the OWNER to ensure that submittals are in a compatible format.
 - 2. First submittal is due approximately three (3) weeks after the start of the contract.
 - a. Should the first submittal not be compatible, a subsequent (second) submittal is due within five working days from notification by the ENGINEER.
 - b. Should the second submittal not be compatible, all work by the CONTRACTOR will be stopped until a compatible submittal is received and approved by the ENGINEER/OWNER. Such a work stoppage will not be grounds for a change order and/or extension of contract time.
- B. Data Downloads/Submittals. Bi-weekly, the Contractor shall provide the onsite representative with two (2) copies of DVD/flash drive/portable hard drive with inspection data consisting of CCTV video, sonar video, database files, and inspection reports, from the previous two weeks.
 - 1. Database file with inspection event and defect records in Microsoft Access (.MDB) and CUES GraniteNet PACP 7.0 compatibility
 - 2. Video file: MPEG (.mpg) or Windows Media file (.wmv). One video file per pipe inspection.
 - 3. Inspection report: Adobe Acrobat (.pdf). One report per segment. Report shall include:

- a. Inspection header info (who, what, where, when)
- b. Defect log
- c. Photos of defects
- d. PACP Overall Pipe Index Rating; PACP Structural Quick Rating; PACP O&M Quick Rating
- 4. Defect photos: screen captures from the video (.jpg).
- 5. The "Asset ID's" provided in the plans shall be used when referencing "start manhole," "end manhole," and "pipe segment" in the inspection database and filenames. If Asset ID's are not shown on the plans, please contact the RPR prior to conducting the CCTV inspections. No additional payment will be made for additions or modifications to Asset IDs.
- 6. A maximum of three videos may be submitted for review per asset. Acceptable videos are one pre-cleaning video, one post cleaning video, and a second post cleaning video if a REVERSAL is needed to complete the segment.
- C. Final Submittal. Upon completion of the contract work, the CONTRACTOR shall provide the ENGINEER with two (2) copies of DVD/flash drive/portable hard drive with inspection data consisting of CCTV video, sonar video, database files, inspection reports, and manhole inspection files. All Asset ID's within the files, and used to identify the files, shall be updated per the instruction of the ENGINEER/OWNER.

3.09 SITE RESTORATION

A. Please refer to Specification 01 11 00, Summary of Work, section 3.21 Site Restoration.

END OF SECTION

SECTION 33 01 33

SEWER CLEANING

PART 1 - GENERAL

1.01 DESCRIPTION

- A. Scope. The CONTRACTOR shall furnish all labor, materials, equipment and incidentals required to clean sewers and manholes and properly transport and dispose of all materials removed in a lawful manner.
- B. Requirements. The CONTRACTOR shall clean the sewers, manholes, and related underground structures and vaults, in order to remove all sediment & debris material accumulations to an acceptable level. The CONTRACTOR should anticipate encountering all materials discussed in this specification. Acceptable cleaning is defined as removing all sediment & debris to restore the internal pipe opening to a minimum of 95% of the original internal cross-sectional area of the pipe in a manner such that 100% of loose material is removed and hard materials attached to the pipe walls are removed to within 1/2-inch or less of the pipe wall. All materials dislodged during cleaning shall be removed from the sewer and disposed of by the CONTRACTOR.

The CONTRACTOR is responsible for identifying sources of water (hydrant locations) and coordinating access to such with the OWNER. All associated costs shall be included in the unit price of the cleaning items. Please refer to the Utilities Section of Specification 01 00 00, General Requirements for additional information.

All sediment hauling, and disposal costs shall be inclusive of proper transport and disposal of removed debris in a lawful manner and in accordance with these specifications. The OWNER has provided representative sediment samples in the Appendix of these specifications. If the CONTRACTOR encounters hazardous materials, the ENGINEER and OWNER should be notified immediately. Pricing shall assume removed material is non-hazardous for disposal. Solids must pass the Paint Filter test for disposal at a solid waste facility. All removed material shall be quantified by a certified weigh ticket from the landfill and submitted to the ENGINEER.

Individual sewer pipe segments shall be considered clean when the ENGINEER views video confirmation which is in accordance with the previously stated percentage in the length of sewer and manholes cleaned. Acceptance of the cleaning will be verified by CCTV and/or sonar inspection (where flow depth permits) as specified in Specification 33 01 32, CCTV and Sonar Sewer Inspection. Sewers not acceptably clean shall be re-cleaned and have post video confirmation performed at no additional cost.

The CONTRACTOR shall provide all safeguards, safety devices and protective equipment and take any other needed actions, on his own responsibility, reasonably necessary to protect the life and the health of employees on the job, the safety of the public, and to protect property in connection with the performance of the work covered by this Contract.

CONTRACTOR shall submit to the City detailed procedures for confined space entry and overall safety program with a list of related equipment. This documentation shall include personnel certifications and proposed confined space permits.

1.02 SUBMITTALS

The following Submittals shall be provided:

- A. The cleaning work submittal shall include a detailed explanation of the cleaning process and a schedule of activities, references where the CONTRACTOR has used the identified cleaning method successfully in the past, and a list of the actions he plans to take to mitigate impact to the public during the cleaning operation.
- B. Daily work logs describing the WORK location (including manhole numbers), WORK times, labor and equipment used and WORK progress. The work logs shall include the names of personnel performing cleaning, description of equipment and equipment identification numbers. All transportation manifests, weigh tickets, and disposal receipts from the disposal facility for all material removed from the sewers and manholes.

PART 2 – MATERIALS

2.01 EQUIPMENT

A. GENERAL

The CONTRACTOR shall provide all equipment necessary to clean the sewers and manholes as described in this specification, and to remove sediment & debris from depths up to 35 feet.

All equipment utilized by the CONTRACTOR shall be in good working condition and manufactured or fabricated to withstand the severity of the work covered. If the equipment is found to be defective, it shall be replaced by the CONTRACTOR at the ENGINEER/OWNER'S request.

All vacuum/pump trucks and combination jet/vacuum/pump trucks shall be equipped with an inspection port or sight glass to observe water levels during cleaning.

The CONTRACTOR shall provide and operate single water jet/nozzle units capable of up to 160 gpm (minimum) for sewers that are 18-inch diameter and larger.

The CONTRACTOR shall have available, employ, and have ready on-site, a variety of equipment to clean/break-up/dislodge/cut/remove all materials, obstructions, and blockages encountered.

The CONTRACTOR shall be prepared to access manholes that are at varying heights above grade. Change orders will not be granted for such situations.

B. Special Pipe Cleaning Tool. The CONTRACTOR may be required to utilize special cleaning tools in order to clean the sewers to 95% clean. Special tools are defined as any type of tool, equipment, head, or attachment which is not of the water jet/nozzle and/or vacuum/pump type system (regardless of size/capacity/configuration). Special tools may include, but not be limited to root cutters; cutting heads; lumberjack; chain cutter; impact auger; porcupine; tap cutter. Special tools would also include manned entry required to remove unusually large or heavy materials from the pipe and manhole that cannot be removed by a water jet/nozzle and/or vacuum/pump type system. CONTRACTOR shall inform the ENGINEER of the intent to use

- special tools on a case-by-case basis prior to beginning said work. Dates, times, and durations of use shall be documented in detail.
- C. Sediment & Debris Material. The term "Sediment & Debris" shall cover and refer to all "materials", regardless of size/shape/weight/material/hardness/density/chemical composition, encountered inside sewer pipes and are required to be cleaned, dislodged, and removed. The CONTRACTOR should anticipate encountering all materials discussed herein, including, but not limited to:
 - 1. Roots. The CONTRACTOR shall employ sewer-cleaning equipment to cut all roots encountered back to the pipe surface. Procedures may include the use of mechanical equipment such as rodding machines, winches with root cutters and high velocity jet cleaners equipped with cutter heads. Chemical means for root removal is prohibited.
 - 2. Mineral Deposits, Encrustations, Fats, Oils, Grease, and Other Hard Materials. The CONTRACTOR shall expect to encounter mineral deposits, encrustations, fats, oils, grease, concrete, grout, and other hard densely packed materials. These materials shall be removed to within 1/2-inch or less of the pipe wall. Removal of these materials may require mechanical and/or manual methods.
 - The CONTRACTOR shall expect to encounter 3. Miscellaneous Materials. miscellaneous materials including, but not limited to: wood, concrete, asphalt, pavement sections, clay, bricks, stones, boulders, metal, rebar, construction debris, pipe sections, manhole lids/castings/grade rings, metal flap gates, garbage, toys, fire arms, railroad ties, dimensional lumber, tree branches, rag balls, rope, metal cables, automobile parts, bike parts, metal sewer snakes, and all other materials encountered the sewer All in systems. materials. regardless of size/shape/weight/material/hardness/density/chemical composition, encountered inside sewer pipes, whether specifically mentioned or not, are required to be cleaned, dislodged, removed, and disposed of as described herein. Materials encountered may be larger than existing manhole openings and therefore will be required to be cut and/or broken up from inside the sewer in order to be removed.
 - 4. Protruding Laterals. The CONTRACTOR shall expect to find some protruding laterals. The CONTRACTOR will only address laterals which protrude in length such that cleaning and/or CCTV/sonar equipment cannot pass. These laterals shall be neatly and smoothly removed to within 1-inch or less of the pipe wall only if the structural integrity of the pipe will not be damaged. A reverse CCTV setup to complete the inspection must be done to the protruding lateral if it cannot be removed.

PART 3 – EXECUTION

3.01 GENERAL

The CONTRACTOR shall at all times conduct the WORK so as to prevent any blockage and surcharging in the sewer manholes and connecting sewer pipelines. The CONTRACTOR shall perform all WORK during periods of weather conducive to their methods and also be able to continue WORK during differing weather and temperature conditions. No interruption to service shall be allowed unless authorized by the OWNER. Damage to existing facilities as a result of the CONTRACTOR's WORK shall be promptly repaired in kind at the CONTRACTOR's expense.

The CONTRACTOR shall also be responsible for complying with traffic control regulations and requirements, as set forth City of Canton Engineering Department.

The CONTRACTOR shall immediately stop work and notify the ENGINEER should any cleaning or inspection yield evidence of, or cause, damage to the existing sewer. It is the responsibility of the CONTRACTOR to select a cleaning method, and conduct operations in a manner, which will not cause damage to different material types and conditions of existing sewers. The ENGINEER may direct the CONTRACTOR to cease cleaning operations should there be evidence that the operation may be damaging the existing sewer. At such direction, the CONTRACTOR shall perform a television inspection of the sewer in accordance with Section 33 01 32. Such direction by the ENGINEER shall not be cause for additional payment to the CONTRACTOR, if the television inspection shows evidence of new damage caused by cleaning operations. If no evidence of new damage caused by cleaning operations is found the television inspection shall be paid. Any damage to existing sewer due to cleaning operations shall be the responsibility of the CONTRACTOR and shall be corrected at the CONTRACTOR's expense. Any corrective actions are subject to the approval and acceptance of the ENGINEER.

If there is a complaint about sewage overflow in the area served by the reaches being cleaned, the CONTRACTOR shall immediately investigate the report and immediately remedy the situation at no additional cost to the OWNER. This may include performing any cleanup work necessary or hiring professional cleaning company to assist homeowners with cleanup required.

Should the CONTRACTOR or his employees cause any damage to public or private property, the CONTRACTOR will be required to make repairs immediately. The OWNER may, however, elect to make repairs or replacements of damaged property and deduct the cost of such from monies due or to become due the CONTRACTOR under this contract with the OWNER.

The CONTRACTOR shall coordinate cleaning activities with the ENGINEER, Canton Collection Systems Department, and the City of Canton Water Reclamation Facility (WRF). The CONTRACTOR shall take all steps necessary and appropriate to prevent adverse effects on wastewater treatment plant processes during the cleaning WORK.

In the event that the WRF experiences any reduction in operating efficiency during the execution of the contract, the CONTRACTOR shall immediately suspend all applications, at the direction of the OWNER/ENGINEER. The CONTRACTOR shall continue operations only after problems at the wastewater treatment plant have been corrected, satisfactory to the WRF superintendent. The OWNER/ENGINEER reserves the right to suspend or terminate the contract at any time for any reason. The CONTRACTOR must maintain contact with OWNER/ENGINEER on a daily basis.

CONTRACTOR shall expect to perform manned entry of manholes and pipes in order to deploy and operate inspection and cleaning equipment.

The CONTRACTOR shall log cleaning data in accordance with Section 3.04 C of Specification 33 01 32, CCTV and Sonar Sewer Inspection.

3.02 CLEANING

A. Cleaning Methods. The selection of cleaning methods will be at the CONTRACTOR'S discretion, based on existing pipe and manhole conditions, being able to ensure no damage to existing pipes and manholes, the amount and type of debris at the time WORK commences, and site conditions. The CONTRACTOR's selection of cleaning methods shall also consider effectiveness, efficiency, and the ability to meet the project schedule. Sewer cleaning methods may include, but not be limited to, water jetting, rodding, pigging, bucketing, or manual removal. Flushing the pipe reaches to facilitate cleaning is not permitted. The decision to utilize confined space entry to assist with operations and/or to perform manual cleaning will be the responsibility of the CONTRACTOR.

Cleaning shall be performed from existing, accessible manholes through existing manhole openings. Materials encountered may be larger than existing manhole openings and will be required to be cut and/or broken up in order to be removed. Should the CONTRACTOR need larger openings to accommodate cleaning equipment and/or sediment & debris material removal, such manhole modifications and replacements shall be submitted to the OWNER/ENGINEER for review and approval on an individual basis. This work shall be included in the cleaning Bid Items. All work shall be in accordance with the City of Canton Supplemental Specifications, Current Edition and City of Canton Standard Construction Drawings.

Where possible, sewer cleaning shall proceed from upstream sewers to downstream sewers, specifically on pipe segments which have service connections. No cleaning shall take place in a particular sewer segment until the upstream pipe segments (included in the Contract) have been cleaned. If cleaning is done in a downstream pipe segment in order to facilitate overall cleaning operations, the downstream segment shall be re-cleaned or verified to be clean at no additional cost, after all pipes upstream of that segment have been cleaned.

During cleaning operations, the CONTRACTOR shall provide a means of catching and removing the dislodged sediment & debris material conveyed downstream with the sewer flow. The method chosen shall not allow the transport of materials to downstream sewer reaches. Passing of material from the sewer segment to be cleaned to downstream segments shall not be permitted. The CONTRACTOR shall take special precautions to be sure all debris is collected when working in the vicinity of pump stations. All debris must be collected and removed before it reaches the pump station. The CONTRACTOR will be responsible for repair of equipment at a pump station if it is affected by debris directly related to the cleaning operation. In the event that any sediment & debris from the cleaning operation are observed and/or detected by the ENGINEER or OWNER as passing to the downstream sewer segment, the CONTRACTOR shall be responsible for cleaning the affected downstream sewer segments in their entirety at no additional cost to the OWNER. Post cleaning CCTV/Sonar inspection will require the inspection of the next downstream sewer (including its manholes) from the segment of the last cleaned segment. CONTRACTOR is required to take date/time stamped photos of the inside of the manholes after cleaning to verify that manholes and pipes are not clogged. Date/time on said photos must be after the time that is on the post cleaning sewer videos.

All sediment & debris removed from the sewer shall be properly stored within watertight containers at an approved WORK site. Water shall be decanted back into the affected sanitary or combined sewer prior to transport to the licensed off-site solid waste disposal facility.

The CONTRACTOR shall take precautions to avoid damage or flooding to public or private property served by the line being cleaned. The CONTRACTOR shall be responsible for all flooding and pay for cleanup from flooding to the satisfaction of the property owner. The CONTRACTOR shall take care in cleaning older brick, segmental block and vitrified clay sewers and sewers with pre-existing damage and shall protect existing sewers from damage caused by improper use and selection of cleaning methods and equipment.

The CONTRACTOR shall at all times comply with health and safety regulations as set forth in the City of Canton Supplemental Specifications, Current Edition.

B. Cleaning Definitions. The CONTRACTOR shall log a definition to describe the cleaning used for a segment as part of the PACP database provided for the project. Procedurally, the initial flushing pass with the jet hose is used to clear cobwebs and determine if there are any obstructions in the line before inserting the CCTV camera is referred to as a "check pass". A "cleaning pass" refers to a pass that requires the jet truck operator to retrieve the hose at a rate slow enough to bring back debris and deposits within the sewer line segment. The cleaning effort used for each segment shall be identified based on the following table:

No Cleaning PACP Code N	Light Cleaning (Jetting) PACP Code L	Heavy Cleaning PACP Code H
"Check pass" only, no vacuum tube insertion required to remove debris.	Cleaning passes required after "check pass". Vac tube required to remove debris from manhole.	Step cleaning required OR Special tools required to clear line beyond standard jet nozzle OR
	Generally, less than 4 total passes (initial check pass +2 more "cleaning passes") which are used to dislodge and move debris to manhole.	OR 4 or more "cleaning passes" that return significant amounts of debris.
Generally, removal of minimal debris during a check pass does not raise cleaning to the level of light cleaning.	Removal of rocks or bricks may take multiple passes. The cleaning is considered light even if more than 3 passes are used and debris is limited to a few objects.	Removal of significant debris using multiple passes to clean the line prior to insertion of the CCTV camera. Debris concentrated in small area – sag in line.
For >18" pipe: Less than 5% of pipe diameter is filled with debris, grease or roots (at any one location).	For >18" pipe: 5% to 20% of the pipe diameter is filled with debris, grease or roots (at any one location).	For >18" pipe: >20% of the pipe diameter is filled with debris, grease or roots (at any one location).

3.03 MAJOR BLOCKAGE

If cleaning of the entire sewer section cannot be successfully performed from one manhole, equipment shall be set up on the opposite manhole and cleaning again attempted. No additional payment shall be made for the reversed set-ups or changes in equipment. If a reverse set-up, cleaning, equipment fails to traverse the entire sewer line section due to a major blockage or defect; the cleaning effort shall be temporarily halted.

The CONTRACTOR shall determine the location of the major blockage(s) by measuring the length of hose or rod inserted from manholes at each end. CONTRACTOR shall immediately report the location of blockage(s) to the ENGINEER.

The CONTRACTOR shall recognize that there are some conditions such as broken pipes and collapsed pipes that will prevent cleaning from being accomplished or where damage could result if cleaning were attempted or continued. The OWNER shall be immediately notified by the CONTRACTOR of any and all conditions that warrant termination of the cleaning activities.

If the CONTRACTOR's cleaning equipment becomes lodged in the sewer, it shall be removed from the sewer solely at the CONTRACTOR's expense. This shall include excavation and repair of the sewer, underground utilities, backfilling and surface restoration.

Subcontractors proposed by the CONTRACTOR to perform this work shall be submitted to the OWNER/ENGINEER for review and approval.

3.04 MANHOLE EXCAVATION AND REPAIR

Should the CONTRACTOR identify a buried manhole that needs exposed or a manhole that needs repair prior to sewer cleaning and inspection, the CONTRACTOR shall identify this work and immediately notify the ENGINEER. The OWNER will arrange for the manhole excavation and/or repair to be performed by a third party. CONTRACTOR will be prepared to efficiently move to the next sewer segment or work site to continue work, while allowing for the OWNER to address the manhole. Moving work set-ups and locations due to manhole access and repairs will not be grounds for change orders or contract time extensions.

3.05 RECLEANING

Where the sewer is not adequately cleaned throughout the sewer reach to 95% opening of the original internal pipe cross-sectional area as determined by the ENGINEER through measurements and CCTV or CCTV/sonar inspection review, the CONTRACTOR shall re-clean and re-televise/sonar the sewer at no additional expense to the OWNER (see Section 1.01.B).

3.06 TAG LINES

The CONTRACTOR may install tag lines in the sewer for CCTV inspection equipment connections or to assist with the cleaning. However, the tag line shall not be left in the sewer at any time that the CONTRACTOR is not on-site. Permission for this may be rescinded by the ENGINEER at any location if unacceptable procedures are used by the CONTRACTOR to secure the tag line. Damage caused by sewage backup due to the tag line shall be the responsibility of the CONTRACTOR.

3.06 SEDIMENT AND DEBRIS LEVEL DOCUMENTATION

During cleaning operations, the CONTRACTOR will coordinate with the ENGINEER's resident project representative (RPR) to document sewer segments with significant sediment and debris levels, which would be defined as a pipe with an inner diameter that is 20% or more full of sediment and debris. Documentation will consist of the sewer pipe asset ID and corresponding visual estimate of depth (inches) of sediment and debris accumulation. CONTRACTOR will also coordinate with ENGINEER's RPR to document sewer pipe run or individual areas or sub-basins which generate large quantities of sediment and debris based upon tonnage.

3.07 SEDIMENT & DEBRIS MATERIAL REMOVAL, HANDLING, AND DISPOSAL

The following definitions are provided as general reference information.

- 1. Cleaning site work areas where CONTRACTOR performs sewer cleaning activities. These sites will change and vary frequently and may be revisited multiple times.
- 2. Dewatering site work areas where CONTRACTOR stores sewer cleaning waste containers. These sites will be accessed daily by CONTRACTOR to unload sewer cleaning truck tanks once water has been decanted.
- 3. Decant the process of removing excess wastewater from the sewer cleaning truck tank and discharging it to a sanitary sewer located at or nearby the current cleaning site.
- 4. Dewater the process of removing the remaining sewer cleaning waste material from the sewer cleaning truck tank into a storage container where the material will undergo further dewatering as necessary for proper landfill disposal.

The CONTRACTOR is solely responsible for removal, storage, handling, decanting, dewatering, testing, documentation, quantifying, and disposal of materials. The CONTRACTOR shall remove and dispose of all materials daily in accordance with local, State, and Federal regulations. Stockpiling or storing removed materials at cleaning sites is prohibited.

The CONTRACTOR shall provide suitable equipment to remove all sediment & debris dislodged during cleaning operations. All material shall be promptly removed from the sewer from within the nearest manhole with excess wastewater decanted and discharged back into a sanitary sewer at or nearby the cleaning site, and then having the remaining material hauled to a dewatering site to undergo dewatering necessary prior to landfill disposal. The CONTRACTOR is required to decant water from removed materials at the cleaning site.

The CONTRACTOR shall be responsible for transporting and disposing, including all disposal fees, of all sediment & debris removed from the sewer. All haul routes shall be kept clean and the CONTRACTOR shall bear the responsibility of immediately cleaning any spills. If the CONTRACTOR does not clean up a spill, the OWNER will clean and charge the CONTRACTOR for all associated costs and fines.

All sediment & debris removed from the sewer shall be disposed of off-site in a lawful manner, at regular intervals to prevent odor nuisance, at a licensed off-site solid waste disposal facility. Materials shall be transported to a facility licensed and permitted for that purpose. All materials shall be properly manifested with the final destination documented. CONTRACTOR is responsible for all waste generator/manifest forms required for disposal, including coordination with ENGINEER and OWNER as needed to complete said forms. CONTRACTOR shall

coordinate weekly with the ENGINEER's resident project representative to confirm disposal weights (tonnage). CONTRACTOR will provide final disposal tickets.

Haul containers shall be watertight and cleaned as necessary to maintain clean haul roads and dewatering sites. All debris to be disposed of shall be decanted prior to leaving the cleaning site.

The CONTRACTOR shall be responsible for the testing and dewatering (as required by the disposal facility), handling, hauling and disposal of all materials removed from the sewer. All materials removed by the CONTRACTOR shall be disposed dry/dewatered (pass paint filter test) at a solid waste disposal facility licensed for the handling and disposal of such materials in accordance with all appropriate codes, rules and regulations for the handling and disposal of such materials.

The disposal facility(s) that the CONTRACTOR anticipates using should be named in the Work Plan or in the Proposal. The City uses "3684 Countywide Landfill," but any approved disposal facility can be used by the CONTRACTOR.

• The OWNER's current waste profile recertification for "3684 Countrywide Landfill" is provided for the CONTRACTOR's review and use.

The CONTRACTOR is responsible for obtaining all necessary permits, fees, and approval from all regulatory agencies required to perform the WORK, including transport of materials to be disposed. The CONTRACTOR is also responsible for obtaining material samples and performing any laboratory analysis required by the disposal facility. Costs for all items associated with disposal shall be included in the unit prices for disposal. If the CONTRACTOR encounters hazardous materials, the ENGINEER and OWNER should be notified immediately.

• 2018 analytical report of sewer waste is provided for the CONTRACTOR's review and use. The report is part of the OWNER's current waste profile recertification for "3684 Countrywide Landfill".

Under no circumstances shall the removed materials be dumped at unlicensed facilities or transfer stations onto streets or into ditches, catch basins, storm drains, sanitary manholes, or otherwise improperly disposed. If sewage is spilled, discharged, leaked, or otherwise deposited in the open environment, the CONTRACTOR shall be responsible for any clean-up and disinfection of the affected area. The CONTRACTOR shall comply with all local, state and federal regulatory requirements regarding spills and illegal dumping. Improper disposal of sewage or solids removed from the sewers may subject the CONTRACTOR to fines imposed by the OWNER or other regulatory entities. In addition, the CONTRACTOR may be subject to civil and/or criminal penalties for improper handling or disposal of removed materials under the law.

The OWNER has the following sites available for CONTRACTOR use for storage of sewer waste material containers. The sites have sanitary sewer access which may be able to be used for further dewatering of containers as needed. The OWNER reserves the right to designate storage locations for materials and conduct periodic inspections on the site(s). The final decision as to how these sites will be available to be used by the CONTRACTOR will need to be discussed and agreed upon by the ENGINEER and OWNER at the pre-construction meeting.

- Canton City Engineer/Street Department yard
 - o Park Drive SW, off 9th Street SW
 - o Sewer is accessible for dewatering drainage
 - o Construction of temporary ramps is permitted
- Canton Collection Systems Department
 - o 2901 Regent Avenue NE
 - o 2 sloped slabs; each 15 ft wide x 30 ft long
 - o Sewer is accessible for dewatering drainage
 - o Construction of temporary ramps is <u>not permitted</u>
 - o New asphalt and concrete pavement must be protected

3.08 TEMPORARY BY-PASS PUMPING

Please refer to Specification 33 01 40, By-pass Pumping Complete for by-pass pumping requirements.

3.09 SITE RESTORATION

Please refer to Specification 01 11 00, Summary of Work, section 3.21 Site Restoration for site restoration requirements.

END OF SECTION

SECTION 33 01 40

BY-PASS PUMPING COMPLETE

PART 1 – GENERAL

1.01 DESCRIPTION

- A. Scope. The CONTRACTOR shall provide temporary by-pass pumping for sewers with flows greater than 50% or sewers with velocities that prohibit quality CCTV inspection/ equipment operation. If flows are greater than 50%, by-pass pumping shall be performed to by-pass the volume of flow that would result in less than 50% of the capacity in the pipe.
- B. Under this item, the CONTRACTOR is required to furnish all labor, materials, maintenance, etc. to implement a temporary by-pass pumping system for the purpose of diverting the existing flow around the sewers that require CCTV inspection for the duration of the said work. The by-pass pumping system must remain operational until the work is complete.
- C. The temporary by-pass pumping system shall be sized to handle full flow pipe conditions during peak wet weather flow events. For the large sewers (greater than 30-inch diameter) it may not be practical to provide by-pass pumping for full flow pipe conditions. For large sewers the contractor may provide a contingency plan in lieu of full flow by-pass pumping. The surcharge of the sewers shall not be allowed due to insufficient pumping or nonfunctioning equipment. The CONTRACTOR should also be aware that adjacent sewers may not be available for by-pass discharge due to surcharged conditions in those sewers during heavy rains. The design, installation, and operation of the temporary by-pass pumping system shall be the CONTRACTOR'S responsibility. The CONTRACTOR shall demonstrate or employ the services of a Vendor who can demonstrate to the ENGINEER that he/she specializes in the design and operation of temporary by-pass pumping systems. The CONTRACTOR shall provide at least three (3) references for the Vendor of projects of a similar size and complexity as this project performed by the Vendor within the past three years, upon request.
- D. The CONTRACTOR shall prepare an individual temporary by-pass pumping plan for each area requiring by-pass pumping and submit three (3) copies to the ENGINEER for approval. No work shall be performed prior to obtaining approval of the submitted plans. The plans shall include but not be limited to the details of the following:
 - 1. Staging areas for pumps
 - 2. Sewer plugging method and types of plugs
 - 3. Size and location of manholes or access points for suction and discharge hose or piping
 - 4. Size of pipeline or conveyance system to be by-passed
 - 5. Number, size, material, location and method of installation of suction piping
 - 6. Number, size, material, location and method of installation and location of installation of discharge piping

- 7. By-pass pump sizes, capacity, number of each size to be onsite and power requirements, including the back-up pumps for the primary pumps.
- 8. Calculations of static lift, friction losses, and flow velocity (pump curves showing pump operating range shall be submitted)
- 9. Standby power generator size, location (if needed)
- 10. Downstream discharge plan
- 11. Method of protecting discharge manholes or structures from erosion and damage
- 12. Thrust and restraint block sizes and locations
- 13. Sections showing suction and discharge pipe depth, embedment, select fill and special backfill
- 14. Method of noise control for each pump and/or generator
- 15. Any temporary pipe supports and anchoring requirements
- 16. Design plans and computation for access to by-pass pumping locations
- 17. Calculations for selection of by-pass pumping pipe size
- 18. Recommended Sequence of Operations
- 19. Schedule for installation of and maintenance of by-pass pumping lines
- 20. Plan that shows location of by-pass pumping lines
- 21. Maintenance of traffic details for traffic crossings of by-pass piping located within roadways and driveways.
- 22. Contingency plan to provide adequate maintenance of flows in order to prevent surcharging and damage during high flows. Contingency plan shall include procedures and estimated durations to remove by-pass pumping equipment and related items in order to open the affected sewers back up to conveying flow when required to prevent damage during high flow events.
- 23. By-pass pumping plan submitted for review and approval shall be stamped by an Ohio licensed Professional Engineer.

PART 2 – MATERIALS

2.01 EQUIPMENT

- A. The CONTRACTOR is required to furnish all labor, materials, maintenance, etc. to implement a temporary by-pass pumping system for the purpose of diverting the existing flow around the sewers that require CCTV inspection for the duration of the said work. The by-pass pumping system must remain operational until the work is complete. The CONTRACTOR will not be permitted to stop or impede the main flows under any circumstances.
- B. Pumps shall be solids handling type and suitable for wastewater flow operations.

PART 3 – EXECUTION

3.01 GENERAL

A. The CONTRACTOR shall divert the flow around the work area in a manner that will not cause damage to or surcharge the City's sewer system and will protect public and private property from damage and flooding. The CONTRACTOR shall be responsible for any physical damage and/or flooding to the City's sewer system and public and private property

- caused by human or mechanical failure. The CONTRACTOR shall have a backup pump on site at all times for all pumps included in the by-pass system. The CONTRACTOR shall have a backup power system in place and operational at all times during the by-pass pumping.
- B. The CONTRACTOR may suggest alternate routing or methods of controlling the sewage, but, shall submit their recommendations to the ENGINEER in writing complete with sketches or drawings showing locations of the by-pass sewer and construction procedures for crossing streets, excavations for benching along with support methods, all required permit information, applications, fees, etc. The CONTRACTOR may request the shape file, location and flow information if available. The ENGINEER will review the proposed alterations to ensure that the receiving sewers can accept the flow and that no access or street interference is created. Neither the OWNER nor the ENGINEER will be responsible for damages due to high flows.
- C. The CONTRACTOR shall be responsible for monitoring the by-pass pumping operations and levels in tributary sewers that are plugged and/or used for diversion, in order to prevent flooding of customers and buildings upstream from the sewer sections being televised. If the CONTRACTOR'S operations cause any flooding of customers and buildings, he shall be responsible for any and all resulting claims for damage to property.
- D. The temporary by-pass pumping system shall be located within the OWNER's right-of-way and easements.
- E. The by-pass pumping system design and installation shall meet the requirements of all codes and regulatory agencies having jurisdiction. The CONTRACTOR shall protect water resources, wetlands, and other natural resources. Under no circumstances will the discharge or dumping of wastewater onto private property, into storm sewers, drainage courses, bodies of water, wetlands, or onto city streets be allowed. Raw wastewater spillage shall be cleaned and disinfected by the CONTRACTOR using means, methods, and disinfectants approved by the Ohio Environmental Protection Agency.
- F. The CONTRACTOR shall notify affected property owners surrounding the project limits of the noise associated with the by-pass pumping operation at least 72 hours prior to the start of the by-pass pumping. The notice shall clearly state the approximate time when sewage cannot be received in the existing sewer, as well as when the sewer will be available again for receiving sewage, and the purpose of the work. It shall also advise all affected customers against water usage until the sewer line is placed back in service and shall clearly state the potential consequences of the use of residential wastewater generating facilities during the time when the sewer service will be out of service (i.e. sewer back-up).
- G. Precautions shall be taken to ensure that by-pass pumping and flow control operations shall not cause flooding, overflows, basement backups or damage to public or private properties. In the event flooding, overflows, basement backups or damage occurs, the CONTRACTOR shall notify City of Canton Collection System Department immediately and make provisions to correct such damage at no additional cost to the OWNER. The CONTRACTOR shall be responsible for any damages to public or private property, flooding and overflows from the sewer system and violations resulting in fines as a result of the dewatering/by-pass operation.

H. Under no circumstances will by-pass pumping be permitted at times other than and during hours of inspection.

3.02 MAINTENANCE OF TRAFFIC

The by-pass pumping system shall not interrupt the flow of traffic in either direction and shall allow access to all driveways and side streets within the by-pass limits. Temporary by-pass lines shall be buried or conveyed via road ramps rated for local traffic where crossing private access drives or public streets and shall either have temporary pavement or be securely plated (if approved by the OWNER). The CONTRACTOR shall prepare and submit a proposed maintenance of traffic plan that will be followed during the installation of the pumping system for the ENGINEER'S approval. CONTRACTOR shall also refer to specification 01 11 00 Summary of Work, section 3.04 Maintenance of Traffic.

3.03 TEST

The CONTRACTOR shall perform leakage and pressure tests of the by-pass pumping system piping using clean water and in accordance with the requirements of the City of Canton Supplemental Specifications, Current Edition prior to bringing the by-pass system online. The ENGINEER shall be given 24 hours' notice prior to testing.

3.04 INSPECTION

The CONTRACTOR and Vendor shall inspect the by-pass pumping system on a continuous basis to ensure the system is working correctly.

3.05 MAINTENANCE OF SERVICE

The CONTRACTOR shall ensure the temporary by-pass pumping system is properly maintained and a responsible operator shall always be on site when pumps are operating. The CONTRACTOR shall monitor pump fuel levels, if required, and plan for timely refueling if necessary.

3.06 EXTRA MATERIALS

Spare parts for pumps, piping, and generators shall be kept on site, as required. Adequate equipment for hoisting for each pump and accessories shall be maintained on the site.

3.07 PRECAUTIONS

The CONTRACTOR is responsible for locating any existing utilities in the area selected for the by-pass pipelines. The CONTRACTOR shall locate the by-pass pipelines to minimize any disturbance to existing utilities and shall obtain approval of the pipeline locations from the ENGINEER. Any costs associated with relocating utilities and obtaining all approvals shall be paid by the CONTRACTOR.

During all by-pass pumping operations, the CONTRACTOR shall protect the OWNER'S sewer system (manholes, conveyance system, etc.) as applicable from damage inflicted by any equipment. The CONTRACTOR shall be responsible for any physical damage to the OWNER'S sewer system caused by human or mechanical failure.

3.08 INSTALLATION AND REMOVAL

- A. The CONTRACTOR shall remove manhole sections or make connections to the existing conveyance system and construct temporary by-pass pumping structures as specified in the temporary by-pass pumping plan approved by the ENGINEER. When required, the CONTRACTOR shall also by-pass laterals by pumping from a cleanout. If a new cleanout is required, it shall be installed per City of Canton Standard Drawings.
- B. Plugging or blocking of flows shall incorporate a primary or secondary plugging device. When plugging or blocking is no longer needed for performance and inspection work is complete, it is to be removed in a manner that permits the sewage flow to slowly return to normal without surge, to prevent surcharging or causing other major disturbances downstream.
- C. After all construction operations have been completed the CONTRACTOR shall purge the by-pass sewer system of all sewage before disconnecting the pumps and piping with water. All water used for purging the by-pass system shall either be collected and disposed of offsite or routed into the sanitary sewer. Under no circumstances will the dumping of raw sewage on private property, streets and roads be allowed due to purging the system.
- D. When working inside a manhole or sanitary sewer, the CONTRACTOR shall exercise caution and comply with OSHA requirements when working in the presence of sewer gases, combustible or oxygen-deficient atmospheres, and confined spaces.

3.09 SITE RESTORATION

Please refer to Specification 01 11 00, Summary of Work, section 3.21 Site Restoration.

Legend

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Storm Manholes

Sanitary Gravity Mains

Sanitary Inlets

Sanitary Fittings

Sanitary Tap

—— Storm Sewers

Sanitary SewerNodes

Sanitary SystemValves

—— Sanitary Force Mains

Sanitary LateralLines

Sanitary Casings

Sanitary
ServiceConnection

Sanitary Cleanouts

Sanitary ControlValves

Sanitary Net Junctions

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Sanitary Manholes

Storm Catch Basins

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SEE SHEET: 47045



2020 Sewer Cleaning and Inspection SHEET NUMBER 47044

STATUS UPDATED: 7/6/2020

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Storm Manholes

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ServiceConnection

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Sanitary Manholes

Storm Catch Basins

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2020 Sewer Cleaning and Inspection

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Storm Manholes

Sanitary Gravity Mains

Sanitary Inlets

Sanitary Fittings

Sanitary Tap

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2020 Sewer Cleaning and Inspection
SHEET NUMBER
49028

STATUS UPDATED: 7/6/2020

SEE SHEET: 49029

Sanitary Manholes Storm Manholes

⊕ Storm Catch Basins

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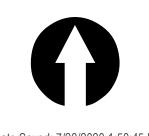
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Storm Manholes

Sanitary Gravity Mains

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BEVINGTON

2020 Sewer Cleaning and Inspection

SHEET NUMBER

50028



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Storm Manholes

Sanitary Gravity Mains

Sanitary Inlets

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2020 Sewer Cleaning and Inspection
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Sanitary Manholes

Storm Catch Basins

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SEE SHEET: 51031



2020 Sewer Cleaning and Inspection

SHEET NUMBER

51030




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Storm Manholes

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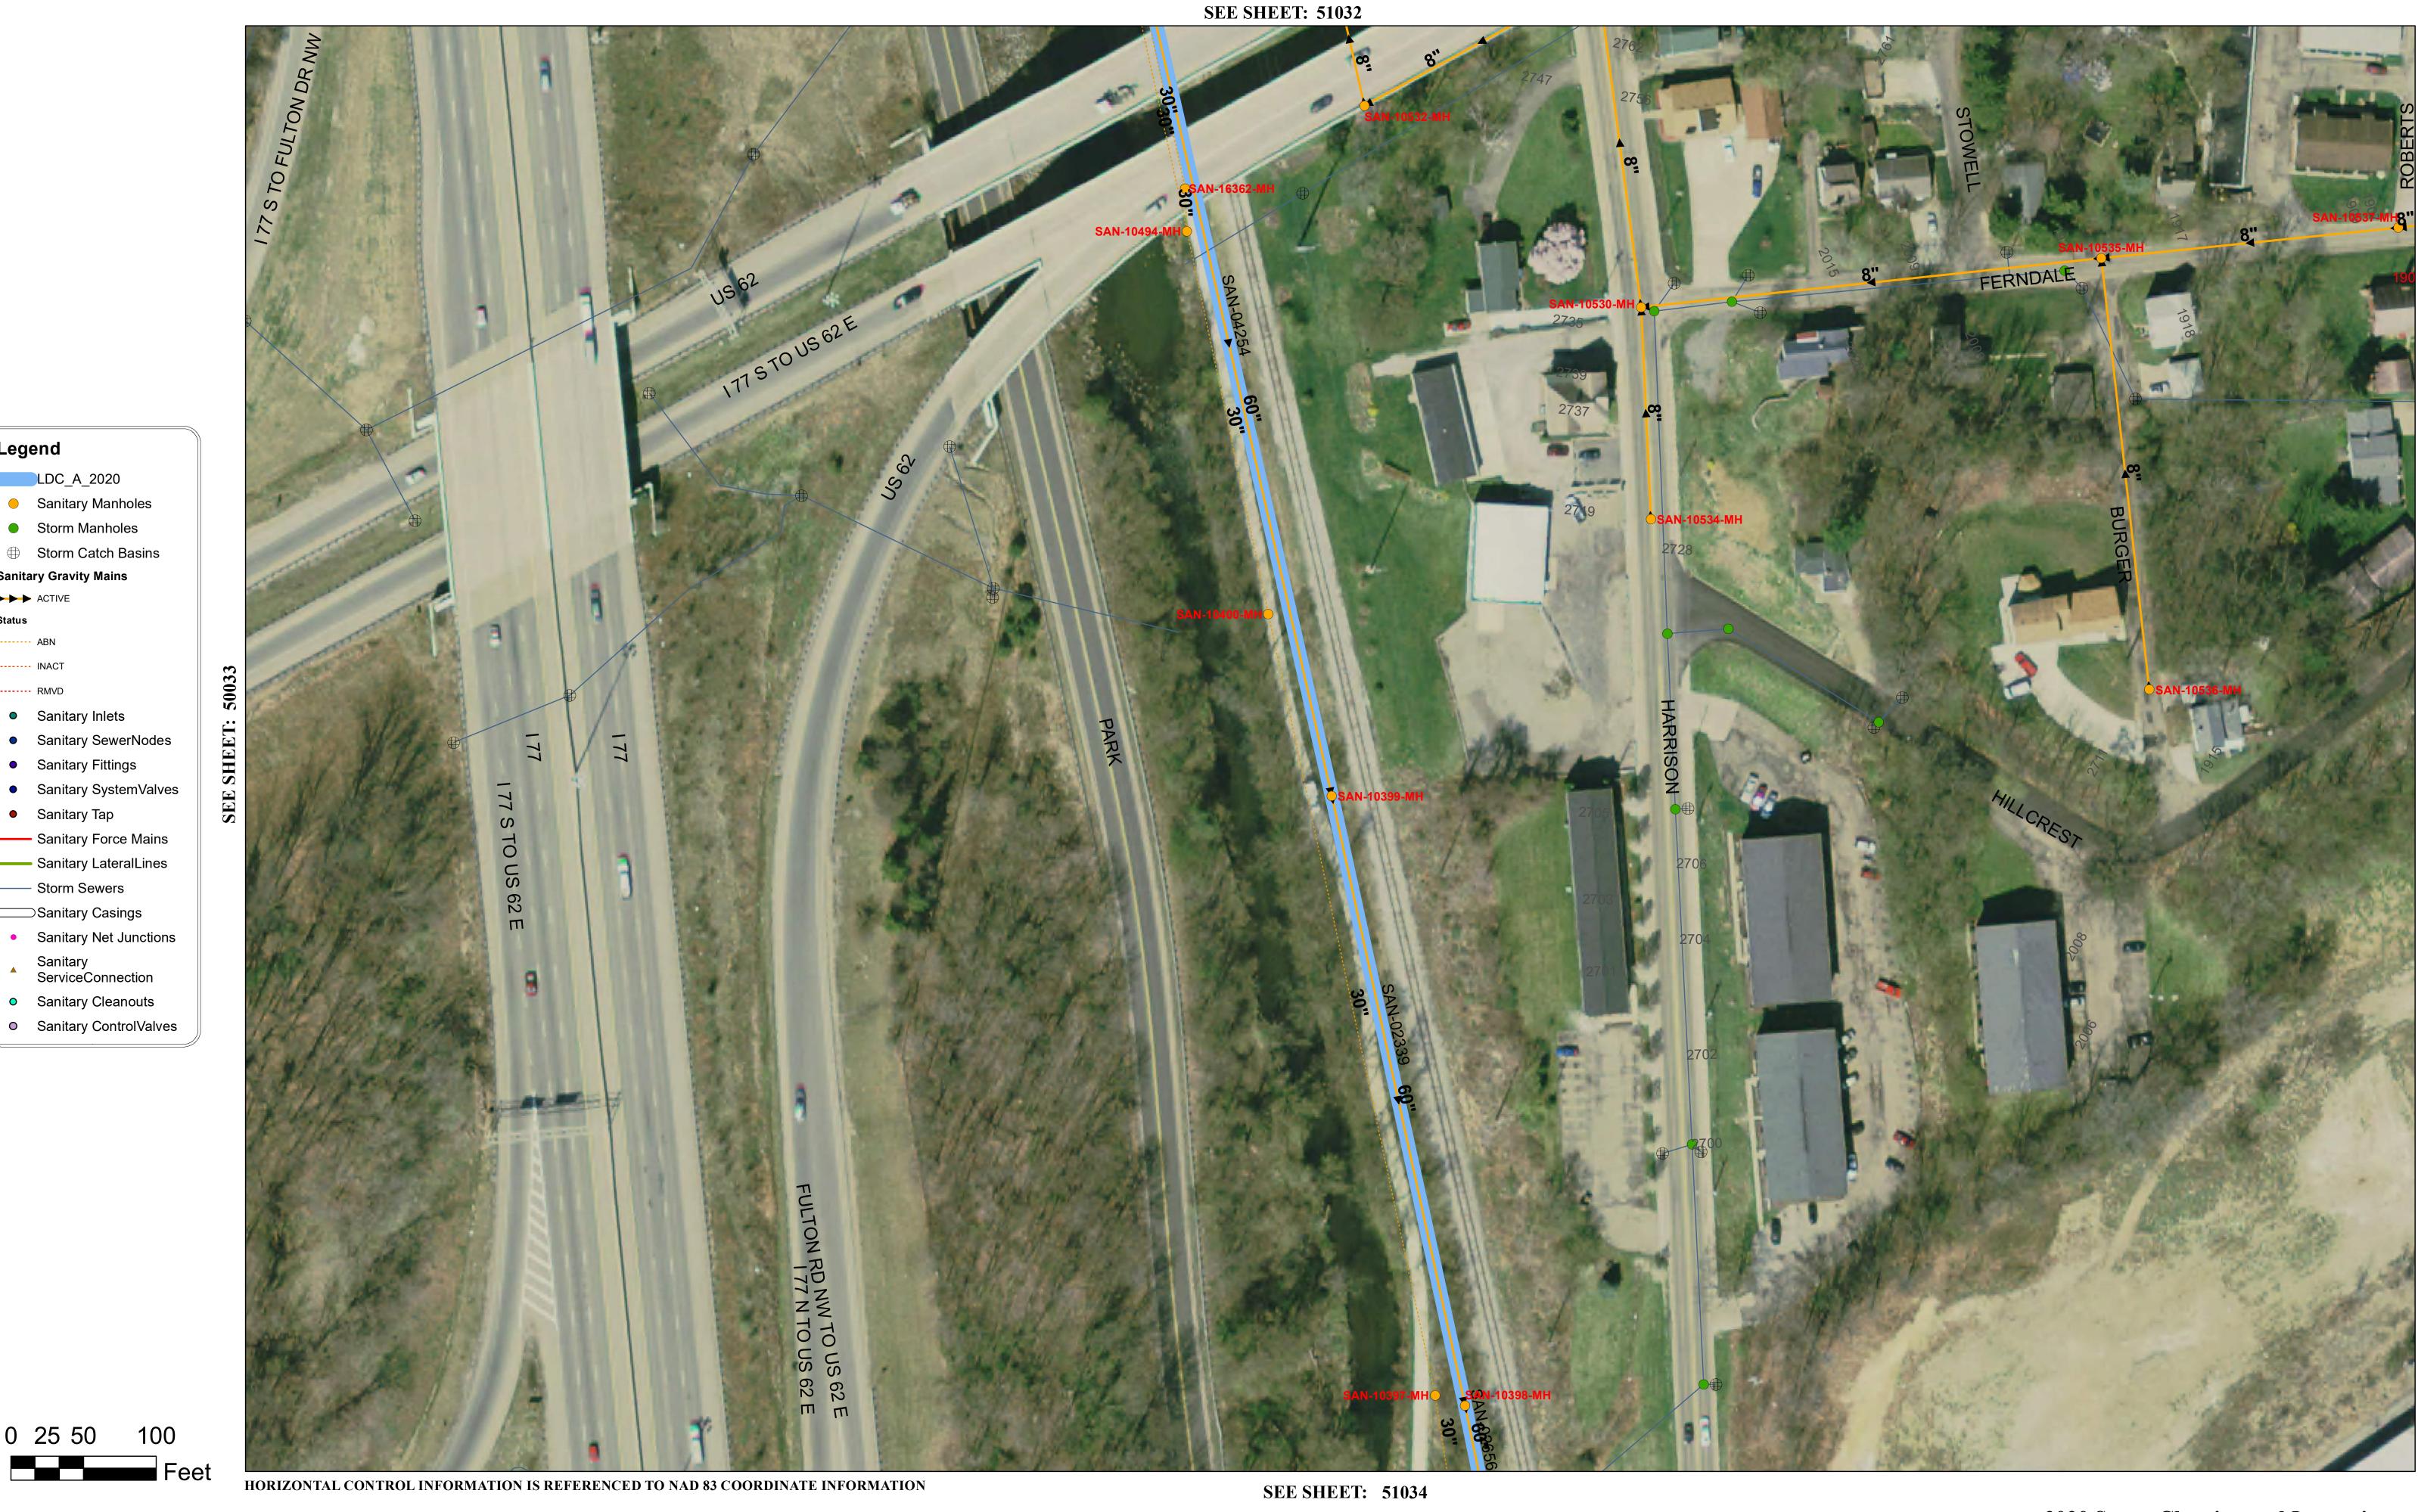
Sanitary Manholes

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2020 Sewer Cleaning and Inspection SHEET NUMBER 51032



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LDC_A_2020

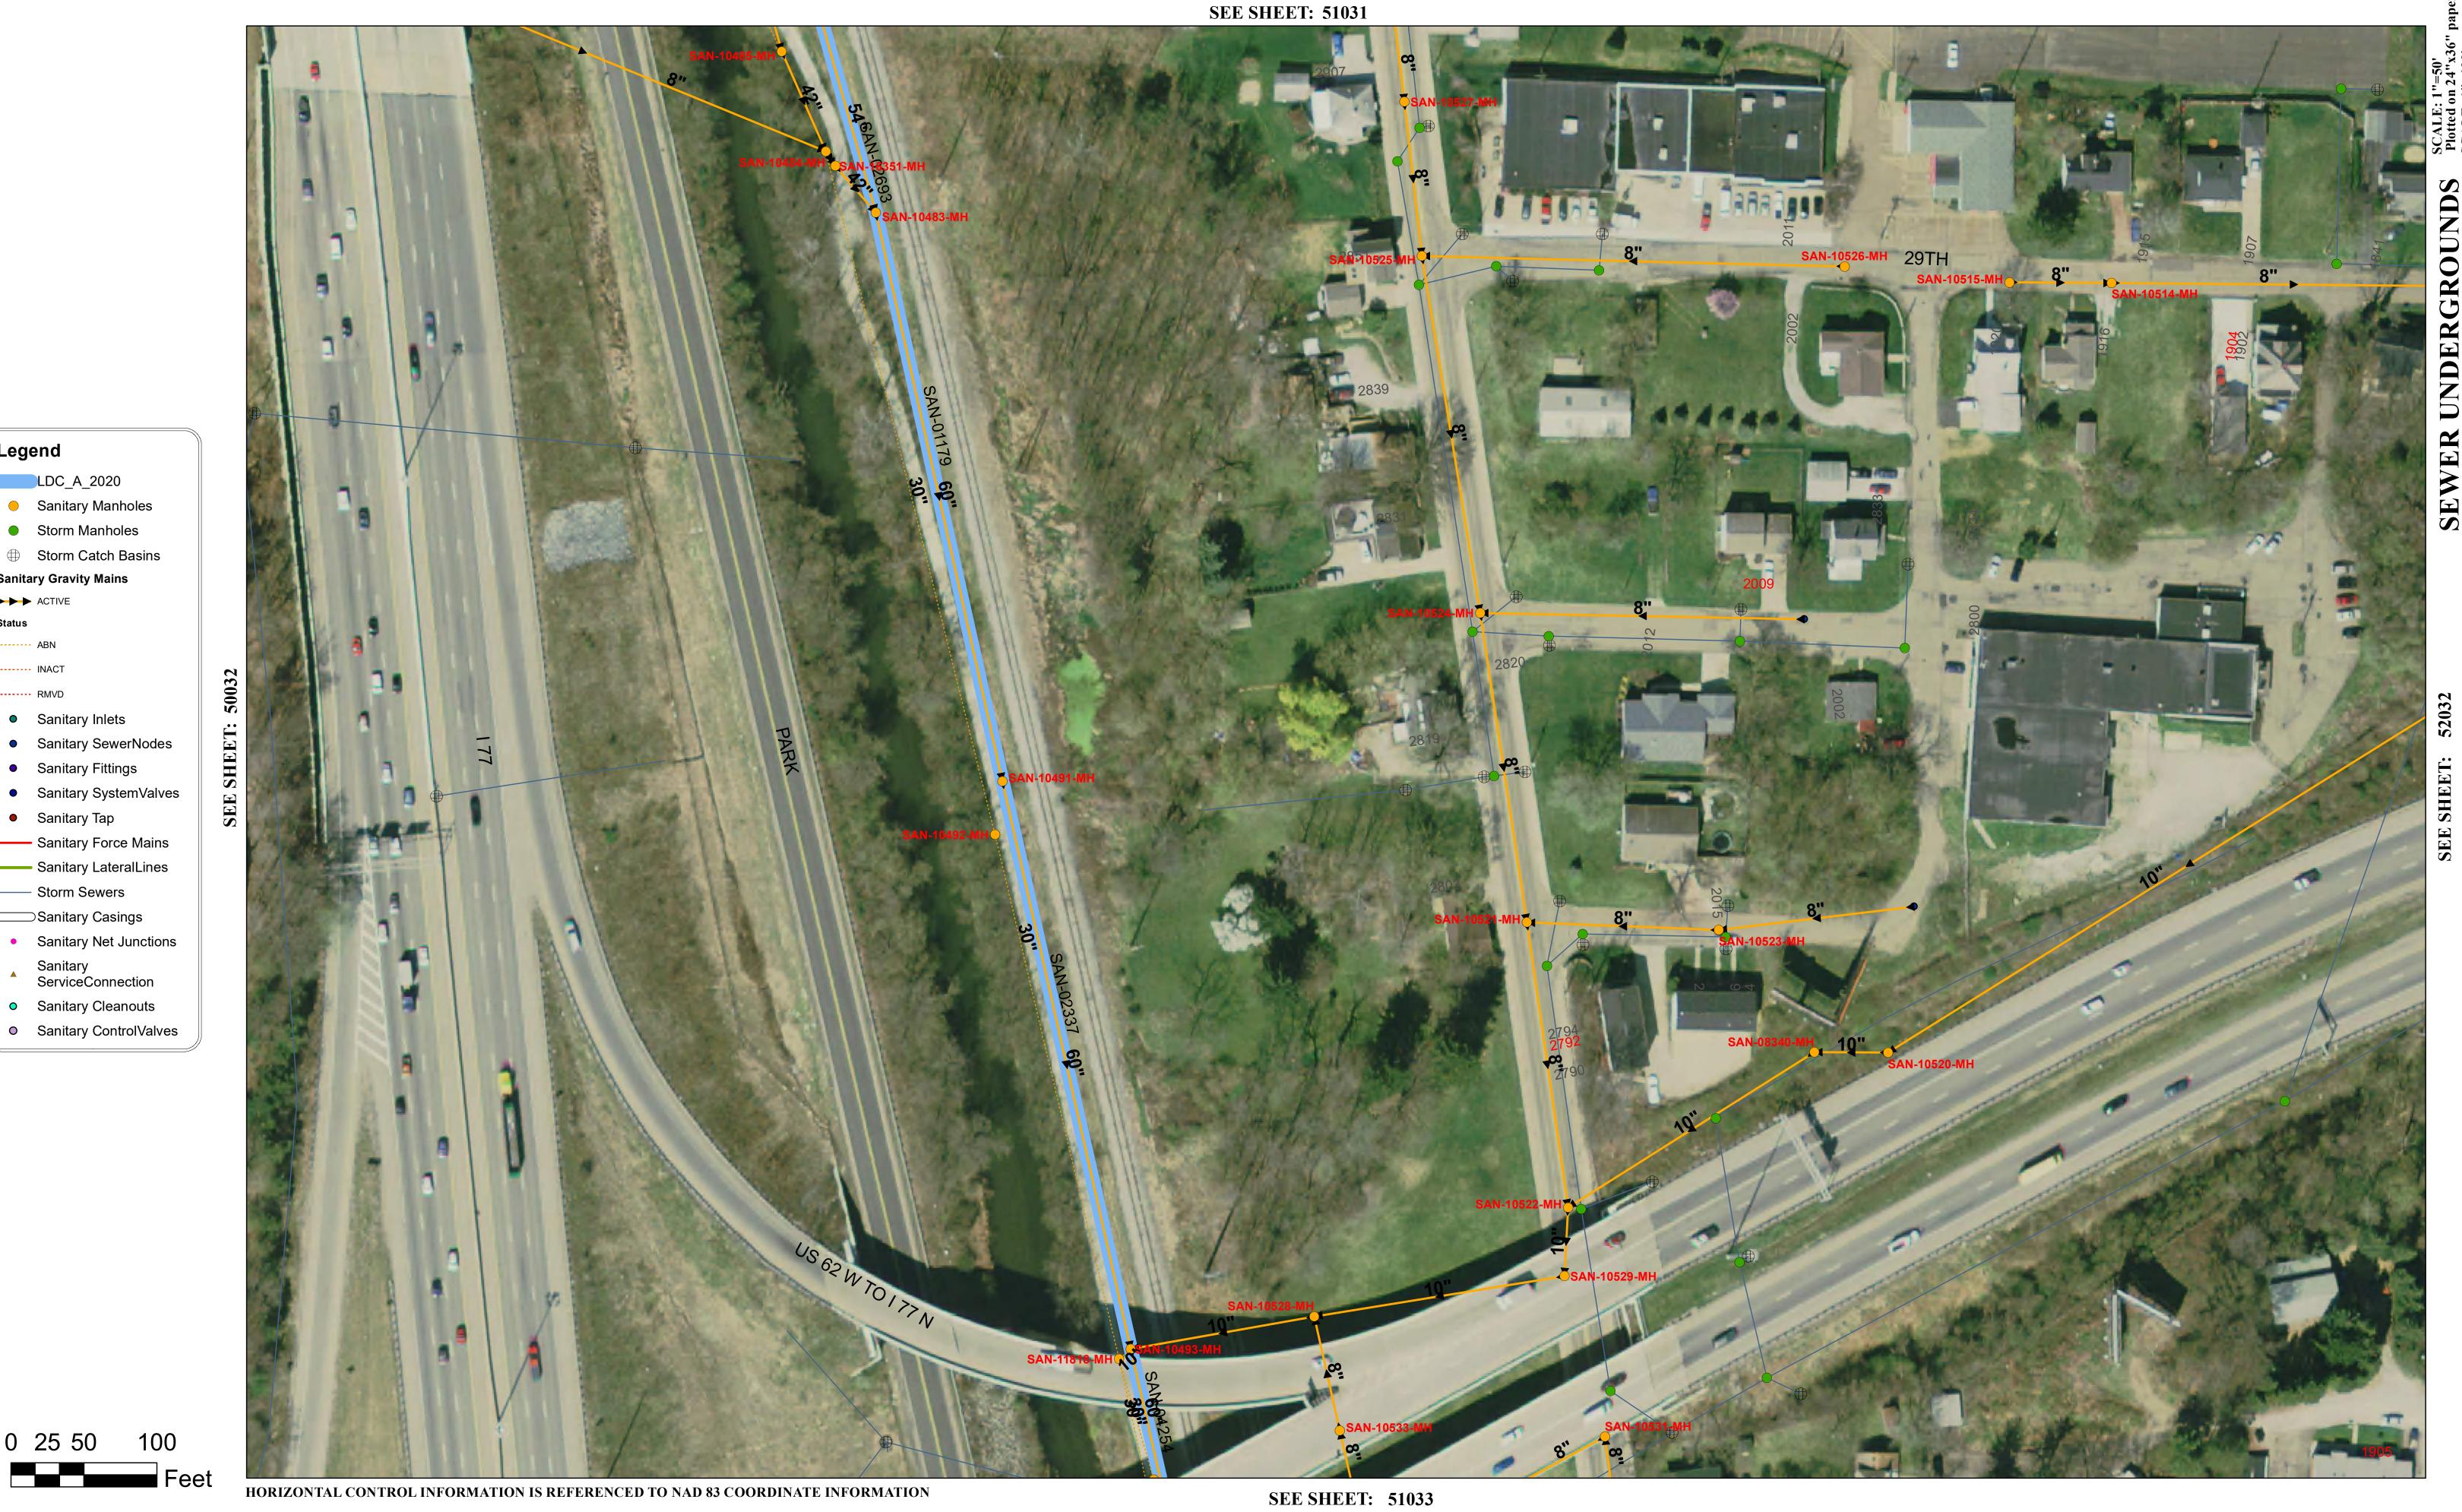Storm Manholes

Sanitary Gravity Mains

Sanitary Inlets

Sanitary Fittings

Sanitary Tap

—— Storm Sewers

Sanitary SewerNodes

—— Sanitary Force Mains

—— Sanitary LateralLines

──Sanitary Casings

Sanitary ServiceConnection

Sanitary Cleanouts

►►► ACTIVE

Sanitary Manholes

⊕ Storm Catch Basins

THE CITY OF CANTON DOES NOT GUARANTEE THE COMPLETENESS, ACCURACY OR VALIDITY OF THIS INFORMATION. **BURGESS & NIPLE**



2020 Sewer Cleaning and Inspection SHEET NUMBER 51033

0 25 50

Legend

LDC_A_2020

Storm Manholes

Sanitary Gravity Mains

Sanitary Inlets

Sanitary Fittings

Sanitary Tap

—— Storm Sewers

Sanitary SewerNodes

—— Sanitary Force Mains

—— Sanitary LateralLines

──Sanitary Casings

Sanitary ServiceConnection

Sanitary Cleanouts

►►► ACTIVE

Sanitary Manholes

⊕ Storm Catch Basins

SCALE: 1"=50' Plotted on 24"x36" paper SCALE: 1"=100' Plotted on 12"x18" paper

THE CITY OF CANTON DOES NOT GUARANTEE THE COMPLETENESS, ACCURACY OR VALIDITY OF THIS INFORMATION.





2020 Sewer Cleaning and Inspection SHEET NUMBER 51034



SCALE: 1"=50' Plotted on 24"x36" paper SCALE: 1"=100'
Plotted on 12"x18" paper

0 25 50

Legend

LDC_A_2020

Storm Manholes

Sanitary Gravity Mains

Sanitary Inlets

Sanitary Fittings

Sanitary Tap

—— Storm Sewers

Sanitary SewerNodes

Sanitary SystemValves

—— Sanitary Force Mains

—— Sanitary LateralLines

Sanitary Casings

Sanitary Net Junctions

Sanitary ServiceConnection

Sanitary ControlValves

Sanitary Cleanouts

►►► ACTIVE

Sanitary Manholes

Storm Catch Basins

THE CITY OF CANTON DOES NOT GUARANTEE THE COMPLETENESS, ACCURACY OR VALIDITY OF THIS INFORMATION. **BURGESS & NIPLE**



2020 Sewer Cleaning and Inspection SHEET NUMBER 51035

STATUS UPDATED: 7/6/2020

Date Saved: 7/20/2020 1:50:45 PM



SCALE: 1"=50'
Plotted on 24"x36" paper
SCALE: 1"=100'
Plotted on 12"x18" paper

0 25 50

Legend

LDC_A_2020

Storm Manholes

Sanitary Gravity Mains

Sanitary Inlets

Sanitary Fittings

Sanitary Tap

—— Storm Sewers

Sanitary SewerNodes

Sanitary SystemValves

—— Sanitary Force Mains

—— Sanitary LateralLines

──Sanitary Casings

Sanitary Net Junctions

Sanitary ServiceConnection

Sanitary ControlValves

Sanitary Cleanouts

►►► ACTIVE

Sanitary Manholes

Storm Catch Basins

THE CITY OF CANTON DOES NOT GUARANTEE
THE COMPLETENESS, ACCURACY OR VALIDITY
OF THIS INFORMATION.


BURGESS & NIPLE



2020 Sewer Cleaning and Inspection

SHEET NUMBER

51036

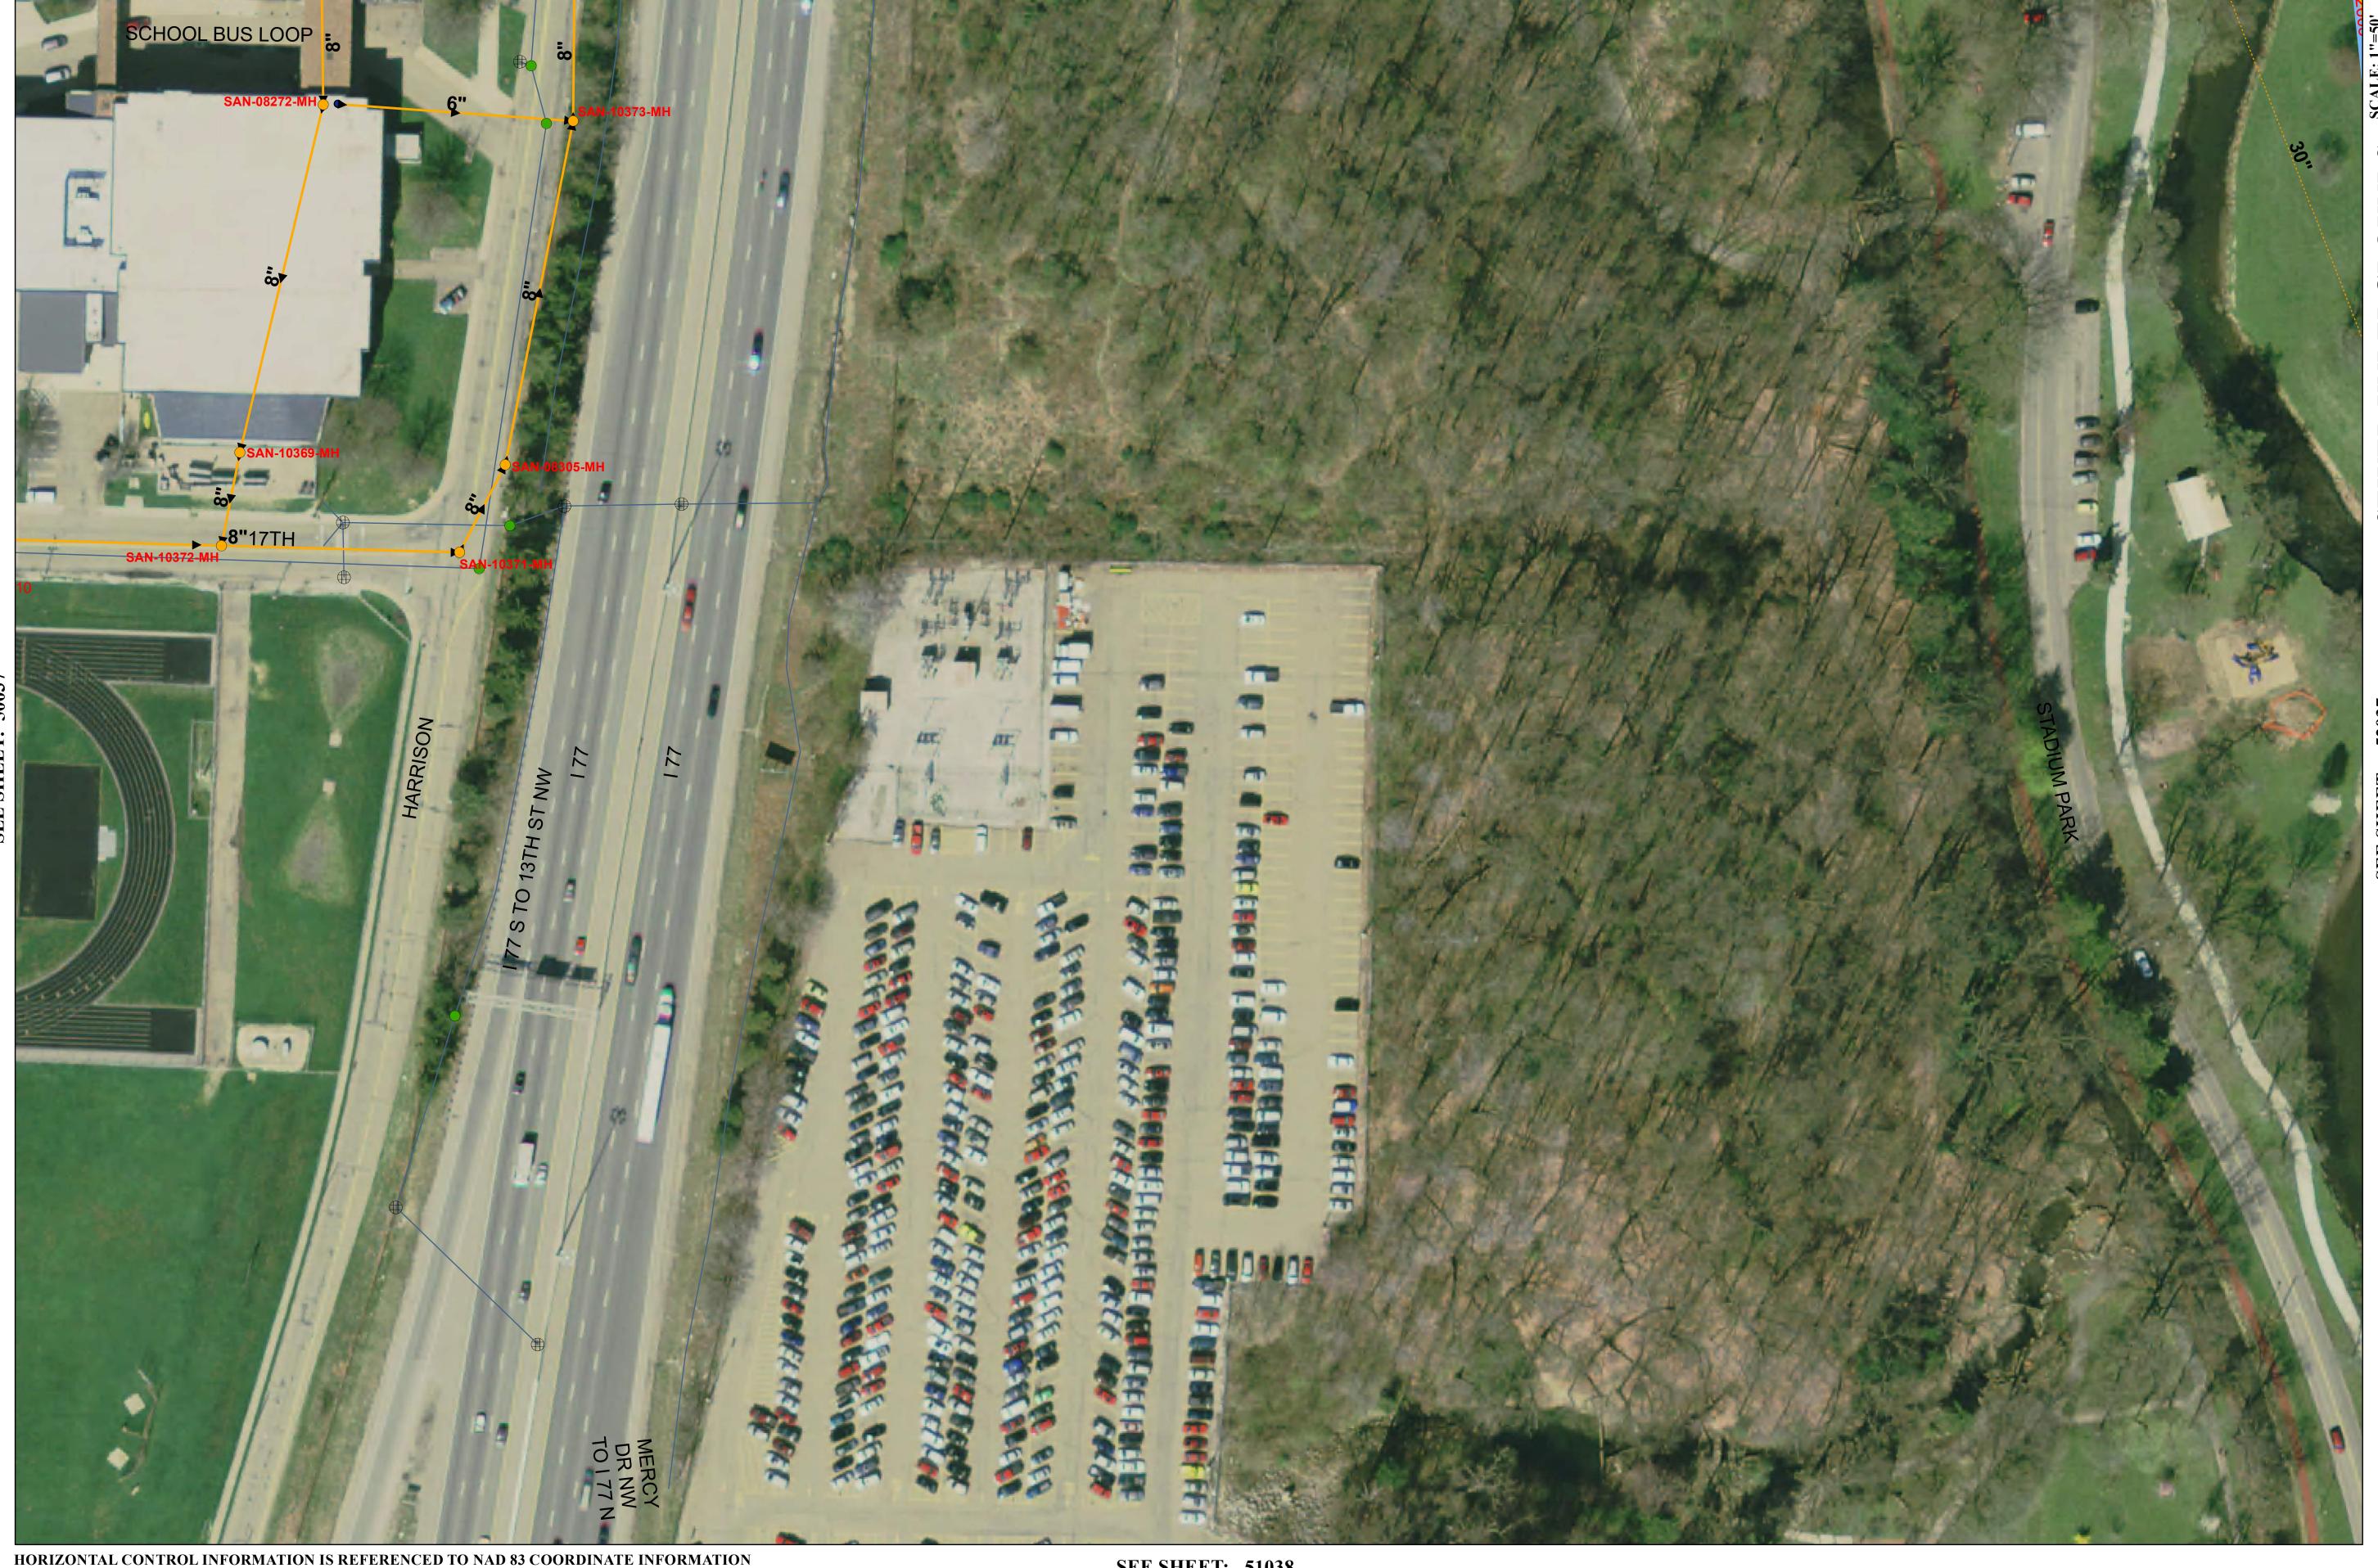

0 25 50

Legend

LDC_A_2020

Storm Manholes

Sanitary Gravity Mains

Sanitary Inlets

Sanitary Fittings

Sanitary Tap

Sanitary SewerNodes

Sanitary SystemValves

—— Sanitary Force Mains

—— Sanitary LateralLines

Sanitary Casings

Sanitary Net Junctions

Sanitary ServiceConnection

Sanitary ControlValves

Sanitary Cleanouts

— Storm Sewers

►►► ACTIVE

Sanitary Manholes

Storm Catch Basins

SCALE: 1"=50' Plotted on 24"x36" paper SCALE: 1"=100' Plotted on 12"x18" paper

THE CITY OF CANTON DOES NOT GUARANTEE THE COMPLETENESS, ACCURACY OR VALIDITY OF THIS INFORMATION. **BURGESS & NIPLE**

SEE SHEET: 51038



2020 Sewer Cleaning and Inspection SHEET NUMBER 51037



0 25 50

Legend

LDC_A_2020

Storm Manholes

Sanitary Gravity Mains

Sanitary Inlets

Sanitary Fittings

Sanitary Tap

—— Storm Sewers

Sanitary SewerNodes

Sanitary SystemValves

—— Sanitary Force Mains

—— Sanitary LateralLines

──Sanitary Casings

Sanitary Net Junctions

Sanitary ServiceConnection

Sanitary ControlValves

Sanitary Cleanouts

►►► ACTIVE

Sanitary Manholes

Storm Catch Basins

THE CITY OF CANTON DOES NOT GUARANTEE
THE COMPLETENESS, ACCURACY OR VALIDITY
OF THIS INFORMATION.


BURGESS & NIPLE



2020 Sewer Cleaning and Inspection

SHEET NUMBER

51039

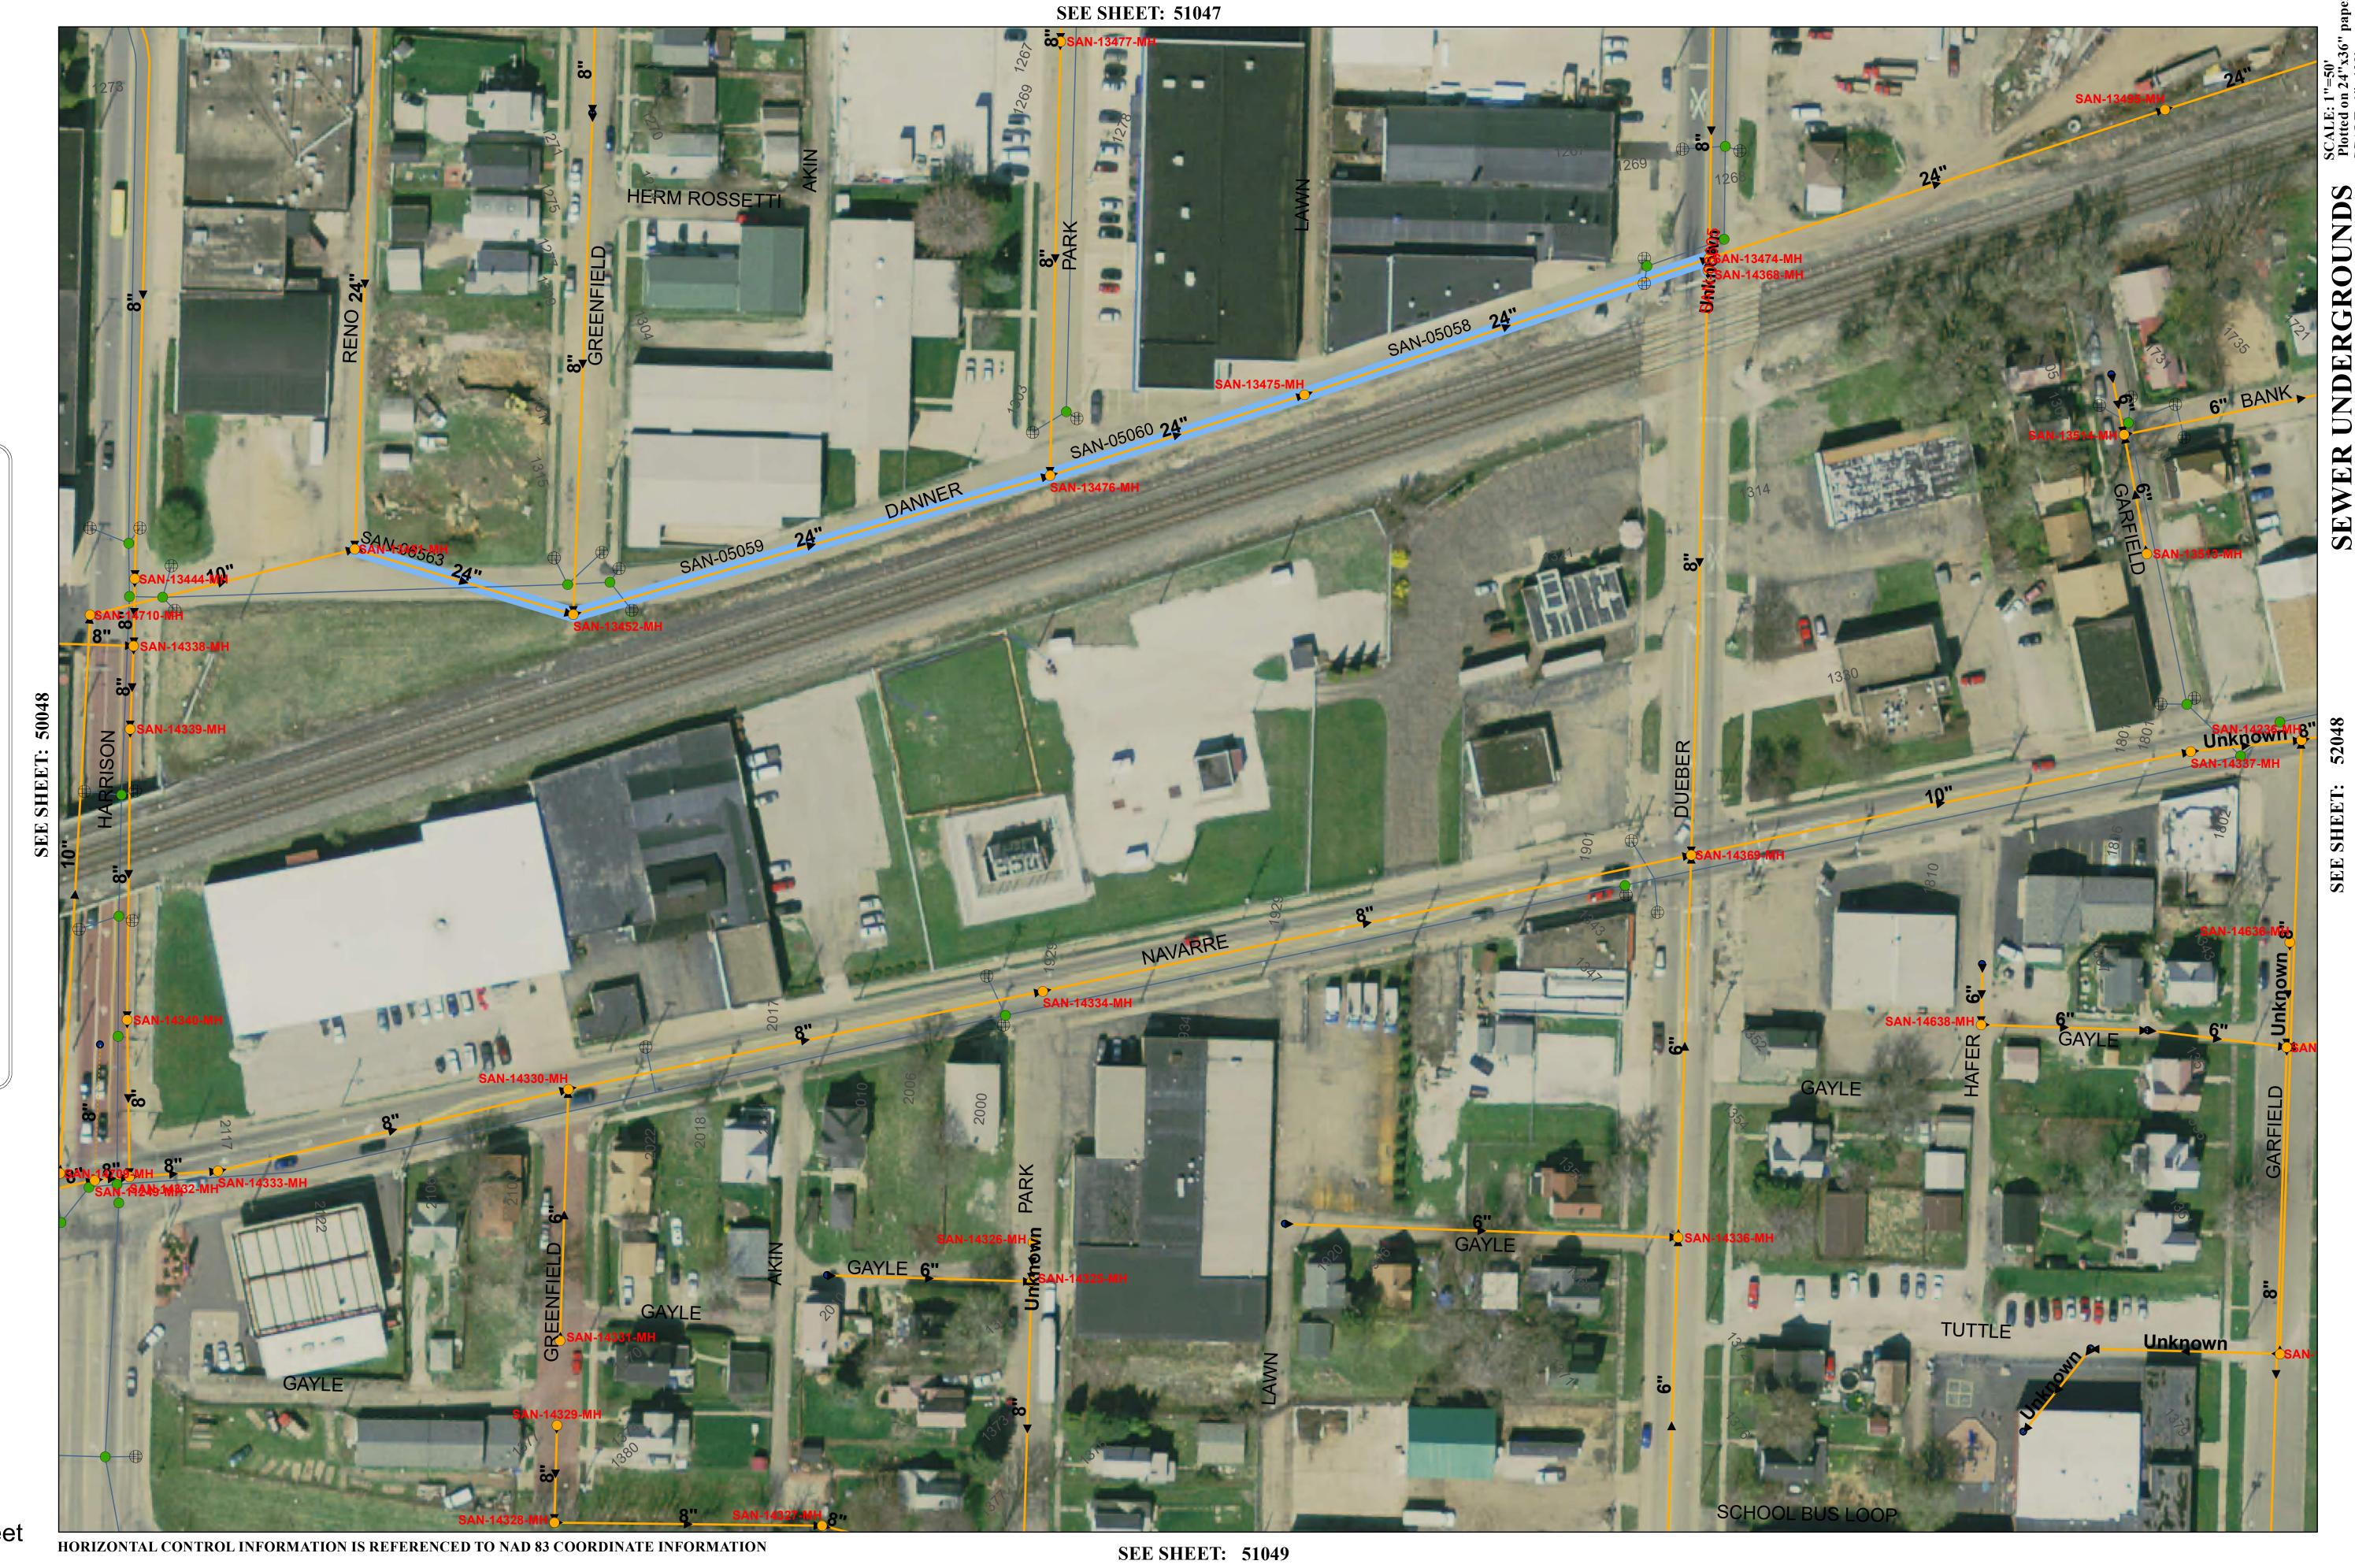

0 25 50

Legend

LDC_A_2020

Storm Manholes

Sanitary Gravity Mains

Sanitary Inlets

Sanitary Fittings

Sanitary Tap

—— Storm Sewers

Sanitary SewerNodes

Sanitary SystemValves

—— Sanitary Force Mains

Sanitary LateralLines

Sanitary Casings

Sanitary Net Junctions

Sanitary ServiceConnection

Sanitary ControlValves

Sanitary Cleanouts

►►► ACTIVE

Sanitary Manholes

Storm Catch Basins

THE CITY OF CANTON DOES NOT GUARANTEE
THE COMPLETENESS, ACCURACY OR VALIDITY
OF THIS INFORMATION.

BURGESS & NIPLE



2020 Sewer Cleaning and Inspection

SHEET NUMBER

51048

Sanitary ManholesStorm Manholes

Storm Catch Basins

Sanitary Gravity Mains

ACTIVE
Status

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Sanitary Inlets

Sanitary SewerNodes

Sanitary Fittings

Sanitary SystemValvesSanitary Tap

Sanitary Force MainsSanitary LateralLines

— Storm Sewers

Sanitary CasingsSanitary Net Junctions

Samilary Net Junction

Sanitary
ServiceConnection

Sanitary CleanoutsSanitary ControlValves

50051 **SAN-14525-MH** SAN-0789118" SAN-01753 18" 20TH 18" SAN-00732 18 AN-01759 HORIZONTAL CONTROL INFORMATION IS REFERENCED TO NAD 83 COORDINATE INFORMATION **SEE SHEET: 51052**

0 25 50 100 Feet

SCALE: 1"=50'
Plotted on 24"x36" paper
SCALE: 1"=100'
Plotted on 12"x18" paper

THE CITY OF CANTON DOES NOT GUARANTEE
THE COMPLETENESS, ACCURACY OR VALIDITY
OF THIS INFORMATION.

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2020 Sewer Cleaning and Inspection

SHEET NUMBER

51051



SCALE: 1"=50'
Plotted on 24"x36" paper
SCALE: 1"=100'
Plotted on 12"x18" paper

0 25 50

Legend

LDC_A_2020

Storm Manholes

Sanitary Gravity Mains

Sanitary Inlets

Sanitary Fittings

Sanitary Tap

—— Storm Sewers

Sanitary SewerNodes

Sanitary SystemValves

—— Sanitary Force Mains

—— Sanitary LateralLines

──Sanitary Casings

Sanitary
ServiceConnection

Sanitary Cleanouts

Sanitary ControlValves

Sanitary Net Junctions

►►► ACTIVE

Sanitary Manholes

Storm Catch Basins

THE CITY OF CANTON DOES NOT GUARANTEE
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OF THIS INFORMATION.

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2020 Sewer Cleaning and Inspection

SHEET NUMBER

52035

Date Saved: 7/20/2020 1:50:45 PM

SCALE: 1"=50'
Plotted on 24"x36" paper
SCALE: 1"=100'
Plotted on 12"x18" paper

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Legend

LDC_A_2020

Storm Manholes

Sanitary Gravity Mains

Sanitary Inlets

Sanitary Fittings

Sanitary Tap

—— Storm Sewers

Sanitary SewerNodes

Sanitary SystemValves

—— Sanitary Force Mains

—— Sanitary LateralLines

Sanitary Casings

Sanitary Net Junctions

Sanitary ServiceConnection

Sanitary ControlValves

Sanitary Cleanouts

► ► ACTIVE

Sanitary Manholes

Storm Catch Basins

THE CITY OF CANTON DOES NOT GUARANTEE
THE COMPLETENESS, ACCURACY OR VALIDITY
OF THIS INFORMATION.






2020 Sewer Cleaning and Inspection

SHEET NUMBER

52036

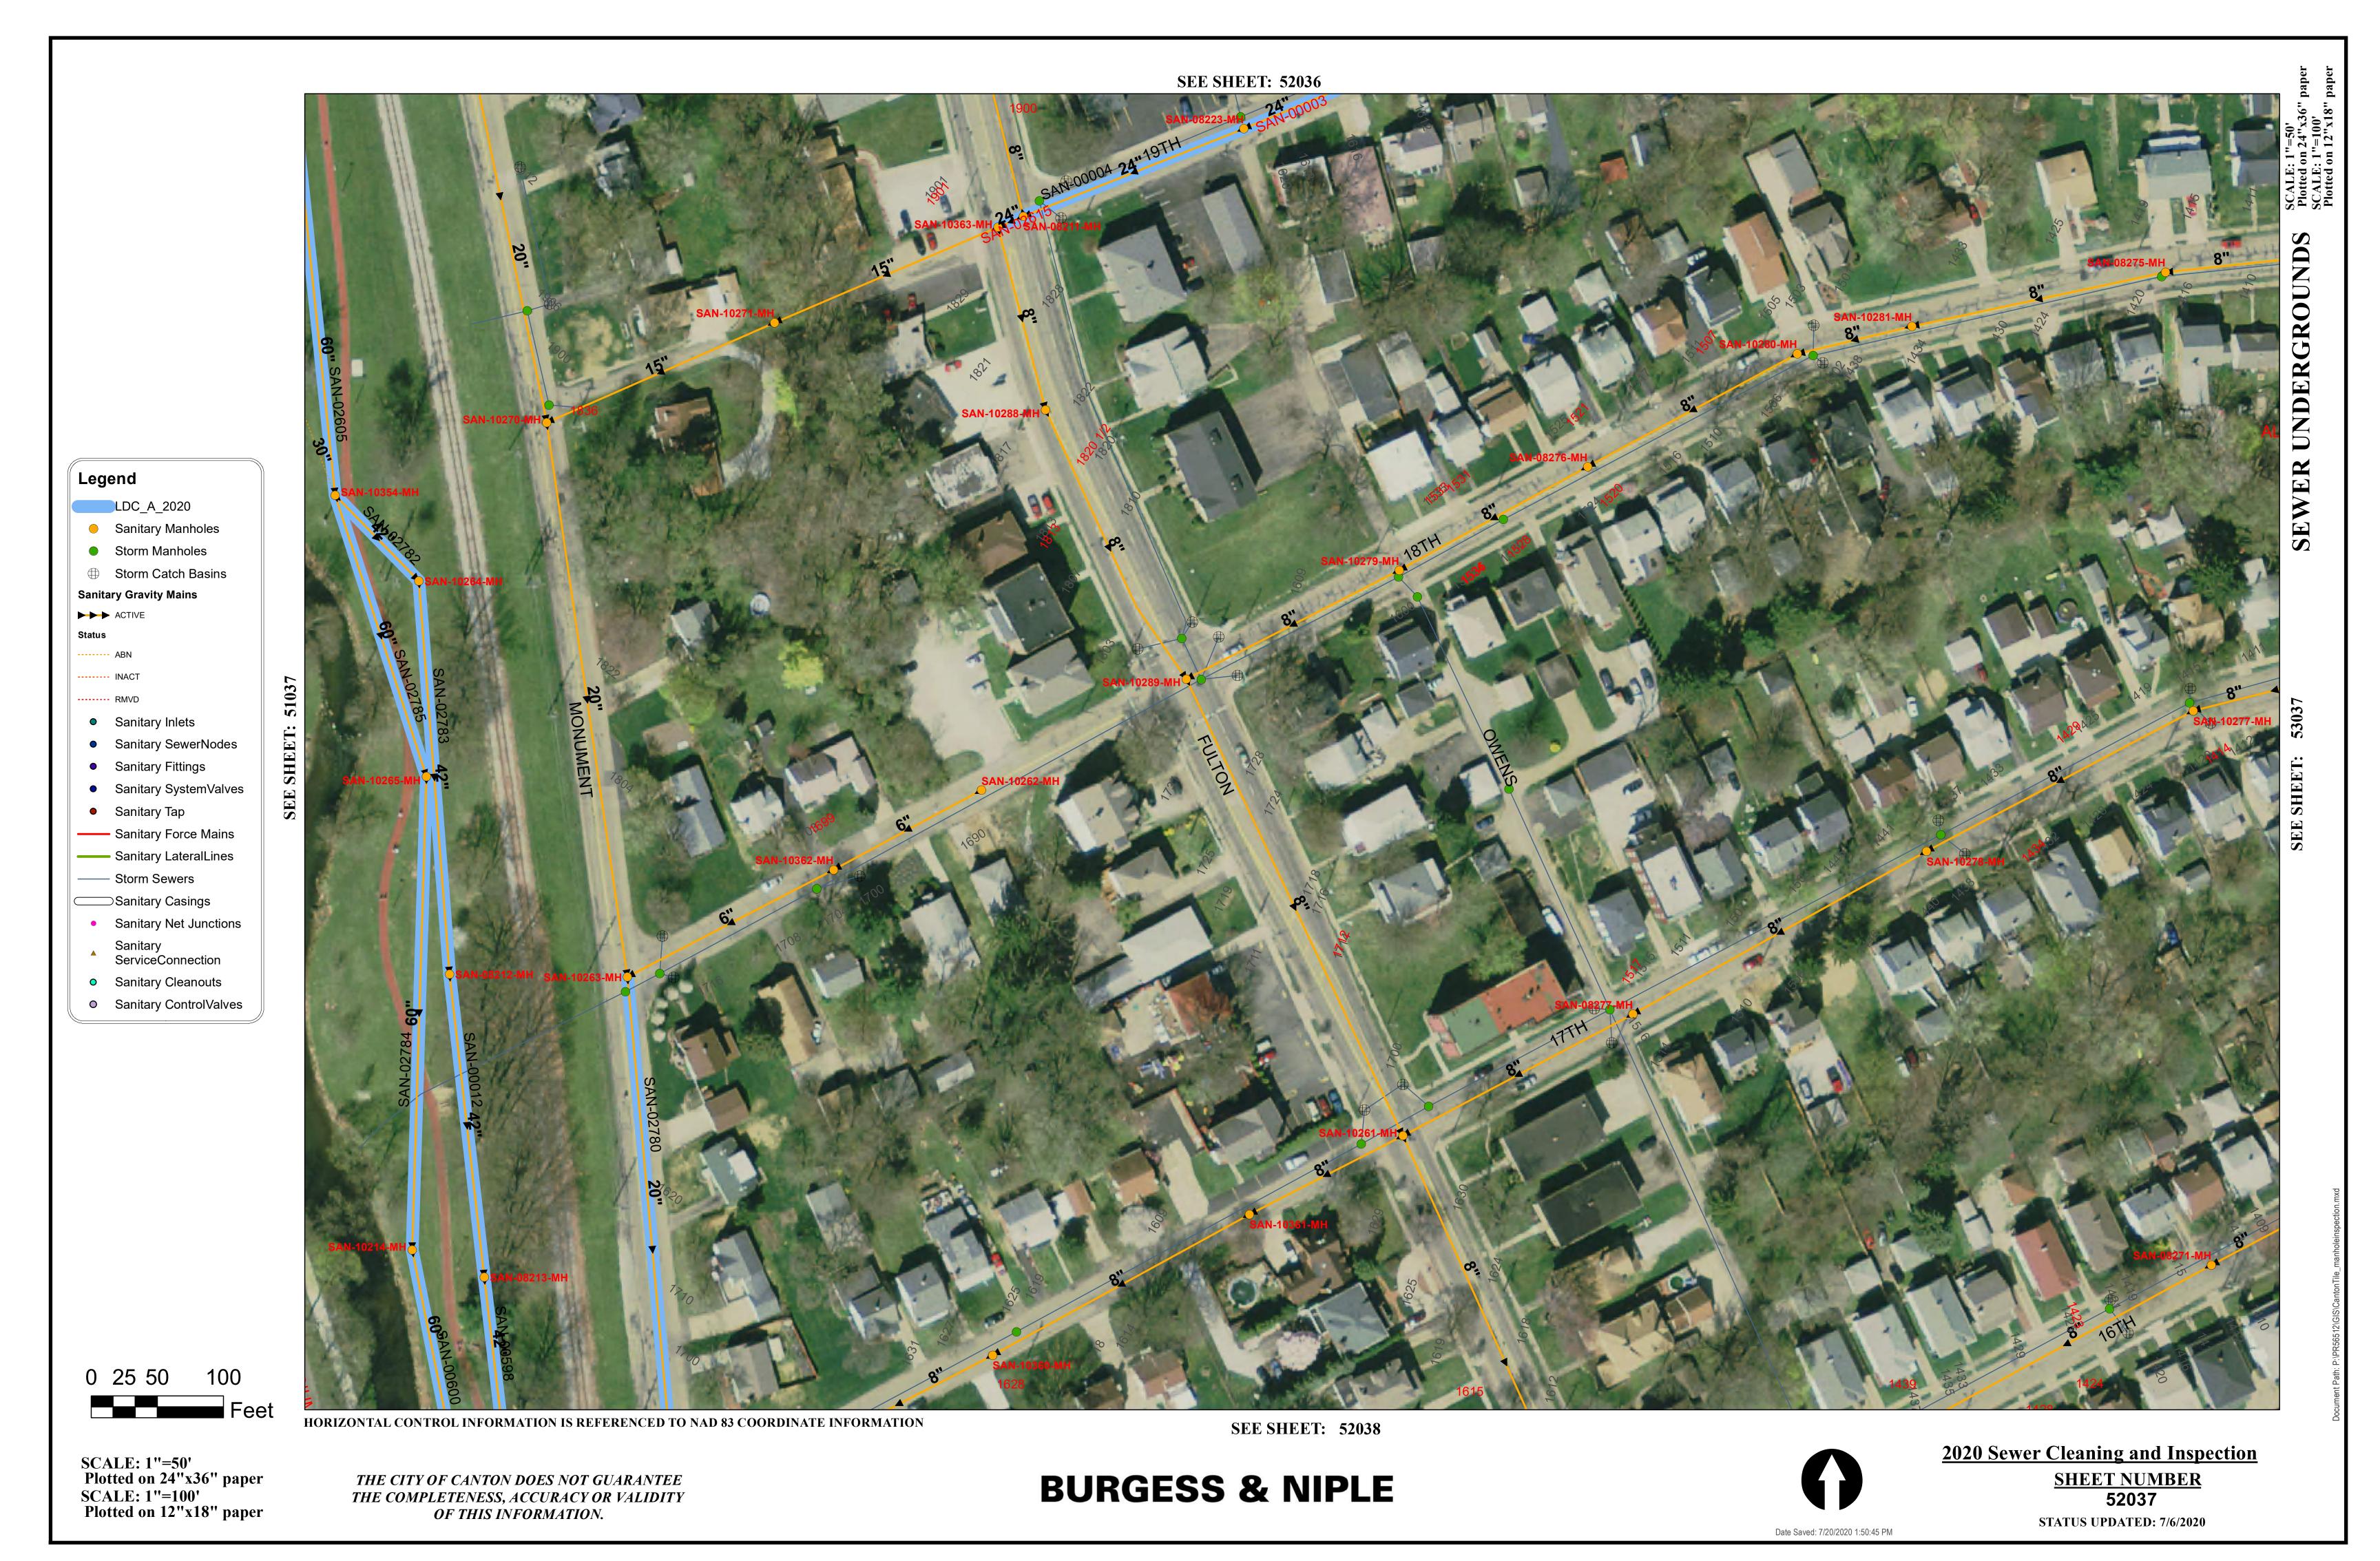



THE CITY OF CANTON DOES NOT GUARANTEE
THE COMPLETENESS, ACCURACY OR VALIDITY
OF THIS INFORMATION.

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20 Sewer Cleaning and Inspection
SHEET NUMBER
52038



THE CITY OF CANTON DOES NOT GUARANTEE THE COMPLETENESS, ACCURACY OR VALIDITY OF THIS INFORMATION. **BURGESS & NIPLE**



SHEET NUMBER 52039



SCALE: 1"=50'
Plotted on 24"x36" paper
SCALE: 1"=100'
Plotted on 12"x18" paper

0 25 50

Legend

LDC_A_2020

Storm Manholes

Sanitary Gravity Mains

Sanitary Inlets

Sanitary Fittings

Sanitary Tap

—— Storm Sewers

Sanitary SewerNodes

Sanitary SystemValves

—— Sanitary Force Mains

—— Sanitary LateralLines

Sanitary Casings

Sanitary Net Junctions

Sanitary ServiceConnection

Sanitary ControlValves

Sanitary Cleanouts

►►► ACTIVE

Sanitary Manholes

Storm Catch Basins

THE CITY OF CANTON DOES NOT GUARANTEE
THE COMPLETENESS, ACCURACY OR VALIDITY
OF THIS INFORMATION.

BURGESS & NIPLE



2020 Sewer Cleaning and Inspection

SHEET NUMBER

52040



SCALE: 1"=50'
Plotted on 24"x36" paper
SCALE: 1"=100'
Plotted on 12"x18" paper

0 25 50

Legend

LDC_A_2020

Storm Manholes

Sanitary Gravity Mains

Sanitary Inlets

Sanitary Fittings

Sanitary Tap

—— Storm Sewers

Sanitary SewerNodes

Sanitary SystemValves

—— Sanitary Force Mains

—— Sanitary LateralLines

Sanitary Casings

Sanitary Net Junctions

Sanitary ServiceConnection

Sanitary ControlValves

Sanitary Cleanouts

►►► ACTIVE

Sanitary Manholes

Storm Catch Basins

THE CITY OF CANTON DOES NOT GUARANTEE
THE COMPLETENESS, ACCURACY OR VALIDITY
OF THIS INFORMATION.

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2020 Sewer Cleaning and Inspection

SHEET NUMBER

52041

STATUS UPDATED: 7/6/2020
Date Saved: 7/20/2020 1:50:45 PM

0 25 50 100 Feet

Legend

LDC_A_2020

Storm Manholes

Sanitary Gravity Mains

Sanitary Inlets

Sanitary Fittings

Sanitary Tap

—— Storm Sewers

Sanitary SewerNodes

Sanitary SystemValves

—— Sanitary Force Mains

Sanitary LateralLines

Sanitary Casings

Sanitary Net Junctions

Sanitary ServiceConnection

Sanitary ControlValves

Sanitary Cleanouts

►►► ACTIVE

Sanitary Manholes

Storm Catch Basins

HORIZONTAL CONTROL INFORMATION IS REFERENCED TO NAD 83 COORDINATE INFORMATION

BURGESS & NIPLE

SEE SHEET: 52043



2020 Sewer Cleaning and Inspection

SHEET NUMBER

52042

STATUS UPDATED: 7/6/2020

SCALE: 1"=50'
Plotted on 24"x36" paper
SCALE: 1"=100'
Plotted on 12"x18" paper

THE CITY OF CANTON DOES NOT GUARANTEE
THE COMPLETENESS, ACCURACY OR VALIDITY
OF THIS INFORMATION.

0 25 50

Legend

LDC_A_2020

Storm Manholes

Sanitary Gravity Mains

Sanitary Inlets

Sanitary Fittings

Sanitary Tap

Sanitary SewerNodes

Sanitary SystemValves

—— Sanitary Force Mains

Sanitary LateralLines

Sanitary Casings

Sanitary Net Junctions

Sanitary ServiceConnection

Sanitary ControlValves

Sanitary Cleanouts

— Storm Sewers

►►► ACTIVE

Sanitary Manholes

⊕ Storm Catch Basins

SCALE: 1"=50' Plotted on 24"x36" paper SCALE: 1"=100'
Plotted on 12"x18" paper

THE CITY OF CANTON DOES NOT GUARANTEE THE COMPLETENESS, ACCURACY OR VALIDITY OF THIS INFORMATION. **BURGESS & NIPLE**

SEE SHEET: 52044



2020 Sewer Cleaning and Inspection SHEET NUMBER 52043

51044 HORIZONTAL CONTROL INFORMATION IS REFERENCED TO NAD 83 COORDINATE INFORMATION **SEE SHEET: 52045**

SEE SHEET: 52043

SCALE: 1"=50'
Plotted on 24"x36" paper

SCALE: 1"=100' Plotted on 12"x18" paper

0 25 50

Legend

LDC_A_2020

Storm Manholes

Sanitary Gravity Mains

Sanitary Inlets

Sanitary Fittings

Sanitary Tap

—— Storm Sewers

Sanitary SewerNodes

Sanitary SystemValves

—— Sanitary Force Mains

—— Sanitary LateralLines

Sanitary Casings

Sanitary Net Junctions

Sanitary ServiceConnection

Sanitary ControlValves

Sanitary Cleanouts


►►► ACTIVE

Sanitary Manholes

⊕ Storm Catch Basins

THE CITY OF CANTON DOES NOT GUARANTEE
THE COMPLETENESS, ACCURACY OR VALIDITY
OF THIS INFORMATION.

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2020 Sewer Cleaning and Inspection
SHEET NUMBER
52044

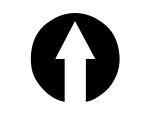STATUS UPDATED: 7/6/2020
Date Saved: 7/20/2020 1:50:45 PM

HORIZONTAL CONTROL INFORMATION IS REFERENCED TO NAD 83 COORDINATE INFORMATION **SEE SHEET: 52046**

SEE SHEET: 52044

0 25 50 100 Feet

Legend

LDC_A_2020

Storm Manholes

Sanitary Gravity Mains

Sanitary Inlets

Sanitary Fittings

Sanitary Tap

—— Storm Sewers

Sanitary SewerNodes

Sanitary SystemValves

—— Sanitary Force Mains

—— Sanitary LateralLines

Sanitary Casings

Sanitary Net Junctions

Sanitary ServiceConnection

Sanitary ControlValves

Sanitary Cleanouts

►►► ACTIVE

Sanitary Manholes

Storm Catch Basins

SCALE: 1"=50'
Plotted on 24"x36" paper
SCALE: 1"=100'
Plotted on 12"x18" paper

THE CITY OF CANTON DOES NOT GUARANTEE
THE COMPLETENESS, ACCURACY OR VALIDITY
OF THIS INFORMATION.

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2020 Sewer Cleaning and Inspection

SHEET NUMBER

52045

0 25 50 100 Feet

Legend

LDC_A_2020

Storm Manholes

Sanitary Gravity Mains

Sanitary Inlets

Sanitary Fittings

Sanitary Tap

— Storm Sewers

Sanitary SewerNodes

Sanitary SystemValves

—— Sanitary Force Mains

—— Sanitary LateralLines

Sanitary Casings

Sanitary Net Junctions

Sanitary ServiceConnection

Sanitary ControlValves

Sanitary Cleanouts

►►► ACTIVE

Sanitary Manholes

Storm Catch Basins

HORIZONTAL CONTROL INFORMATION IS REFERENCED TO NAD 83 COORDINATE INFORMATION

SCALE: 1"=50'
Plotted on 24"x36" paper
SCALE: 1"=100'
Plotted on 12"x18" paper

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THE CITY OF CANTON DOES NOT GUARANTEE
THE COMPLETENESS, ACCURACY OR VALIDITY
OF THIS INFORMATION.

BURGESS & NIPLE

SEE SHEET: 52052



2020 Sewer Cleaning and Inspection
SHEET NUMBER
52051



SCALE: 1"=50' Plotted on 24"x36" paper SCALE: 1"=100'
Plotted on 12"x18" paper

0 25 50

Legend

LDC_A_2020

Storm Manholes

Sanitary Gravity Mains

Sanitary Inlets

Sanitary Fittings

Sanitary Tap

—— Storm Sewers

Sanitary SewerNodes

—— Sanitary Force Mains

Sanitary LateralLines

Sanitary Casings

Sanitary ServiceConnection

Sanitary Cleanouts

►►► ACTIVE

Sanitary Manholes

⊕ Storm Catch Basins

THE CITY OF CANTON DOES NOT GUARANTEE THE COMPLETENESS, ACCURACY OR VALIDITY OF THIS INFORMATION. **BURGESS & NIPLE**



2020 Sewer Cleaning and Inspection SHEET NUMBER 52052



THE CITY OF CANTON DOES NOT GUARANTEE THE COMPLETENESS, ACCURACY OR VALIDITY OF THIS INFORMATION.

SCALE: 1"=100'
Plotted on 12"x18" paper

BURGESS & NIPLE



SHEET NUMBER 52053

0 25 50

Legend

LDC_A_2020

Storm Manholes

Sanitary Gravity Mains

Sanitary Inlets

Sanitary Fittings

Sanitary Tap

—— Storm Sewers

Sanitary SewerNodes

Sanitary SystemValves

—— Sanitary Force Mains

Sanitary LateralLines

Sanitary Casings

Sanitary
ServiceConnection

Sanitary Cleanouts


Sanitary ControlValves

Sanitary Net Junctions

► ► ACTIVE

Sanitary Manholes

Storm Catch Basins

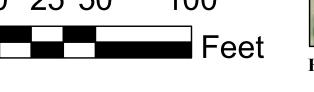

SCALE: 1"=50' Plotted on 24"x36" paper SCALE: 1"=100' Plotted on 12"x18" paper OF THIS INFORMATION.

THE CITY OF CANTON DOES NOT GUARANTEE THE COMPLETENESS, ACCURACY OR VALIDITY



2020 Sewer Cleaning and Inspection SHEET NUMBER 53036

STATUS UPDATED: 7/6/2020

SEE SHEET: 53037

SAN-01566 24"

HORIZONTAL CONTROL INFORMATION IS REFERENCED TO NAD 83 COORDINATE INFORMATION

BURGESS & NIPLE

0 25 50

Legend

▶ ► ACTIVE

LDC_A_2020

Storm Manholes

Sanitary Gravity Mains

Sanitary Inlets

Sanitary Fittings

Sanitary Tap

—— Storm Sewers

Sanitary SewerNodes

Sanitary SystemValves

—— Sanitary Force Mains

—— Sanitary LateralLines

Sanitary Casings

Sanitary Net Junctions

Sanitary ServiceConnection

Sanitary ControlValves

Sanitary Cleanouts

Sanitary Manholes

Storm Catch Basins

HORIZONTAL CONTROL INFORMATION IS REFERENCED TO NAD 83 COORDINATE INFORMATION

BURGESS & NIPLE

SEE SHEET: 53044



2020 Sewer Cleaning and Inspection SHEET NUMBER 53043

STATUS UPDATED: 7/6/2020

SCALE: 1"=50' Plotted on 24"x36" paper SCALE: 1"=100' Plotted on 12"x18" paper

THE CITY OF CANTON DOES NOT GUARANTEE THE COMPLETENESS, ACCURACY OR VALIDITY OF THIS INFORMATION.

0 25 50

Legend

LDC_A_2020

Storm Manholes

Sanitary Gravity Mains

Sanitary Inlets

Sanitary Fittings

Sanitary Tap

—— Storm Sewers

Sanitary SewerNodes

Sanitary SystemValves

—— Sanitary Force Mains

—— Sanitary LateralLines

Sanitary Casings

Sanitary Net Junctions

Sanitary ServiceConnection

Sanitary ControlValves

Sanitary Cleanouts

►►► ACTIVE

Sanitary Manholes

Storm Catch Basins

SCALE: 1"=50' Plotted on 24"x36" paper SCALE: 1"=100' Plotted on 12"x18" paper

THE CITY OF CANTON DOES NOT GUARANTEE THE COMPLETENESS, ACCURACY OR VALIDITY OF THIS INFORMATION. **BURGESS & NIPLE**

SEE SHEET: 53046



2020 Sewer Cleaning and Inspection SHEET NUMBER 53045

SCALE: 1"=50'
Plotted on 24"x36" paper
SCALE: 1"=100'
Plotted on 12"x18" paper

0 25 50 100

Legend

LDC_A_2020

Storm Manholes

Sanitary Gravity Mains

Sanitary Inlets

Sanitary Fittings

Sanitary Tap

— Storm Sewers

Sanitary SewerNodes

Sanitary SystemValves

—— Sanitary Force Mains

—— Sanitary LateralLines

⊃Sanitary Casings

Sanitary Net Junctions

Sanitary ServiceConnection

Sanitary ControlValves

Sanitary Cleanouts

►►► ACTIVE

Sanitary Manholes

Storm Catch Basins

THE CITY OF CANTON DOES NOT GUARANTEE
THE COMPLETENESS, ACCURACY OR VALIDITY
OF THIS INFORMATION.

HORIZONTAL CONTROL INFORMATION IS REFERENCED TO NAD 83 COORDINATE INFORMATION

BURGESS & NIPLE

SEE SHEET: 53047



2020 Sewer Cleaning and Inspection

SHEET NUMBER

53046



SCALE: 1"=50' Plotted on 24"x36" paper SCALE: 1"=100'
Plotted on 12"x18" paper

Legend

►►► ACTIVE

THE CITY OF CANTON DOES NOT GUARANTEE THE COMPLETENESS, ACCURACY OR VALIDITY OF THIS INFORMATION. **BURGESS & NIPLE**



2020 Sewer Cleaning and Inspection SHEET NUMBER 53047

STATUS UPDATED: 7/6/2020

Date Saved: 7/20/2020 1:50:45 PM



0 25 50 100 Feet

Legend

LDC_A_2020

Storm Manholes

Sanitary Gravity Mains

Sanitary Inlets

Sanitary Fittings

Sanitary Tap

Sanitary SewerNodes

Sanitary SystemValves

—— Sanitary Force Mains

—— Sanitary LateralLines

Sanitary Casings

Sanitary Net Junctions

Sanitary ServiceConnection

Sanitary ControlValves

Sanitary Cleanouts

— Storm Sewers

►►► ACTIVE

Sanitary Manholes

⊕ Storm Catch Basins


SCALE: 1"=50'
Plotted on 24"x36" paper
SCALE: 1"=100'
Plotted on 12"x18" paper

THE CITY OF CANTON DOES NOT GUARANTEE
THE COMPLETENESS, ACCURACY OR VALIDITY
OF THIS INFORMATION.

BURGESS & NIPLE



2020 Sewer Cleaning and Inspection
SHEET NUMBER
53048

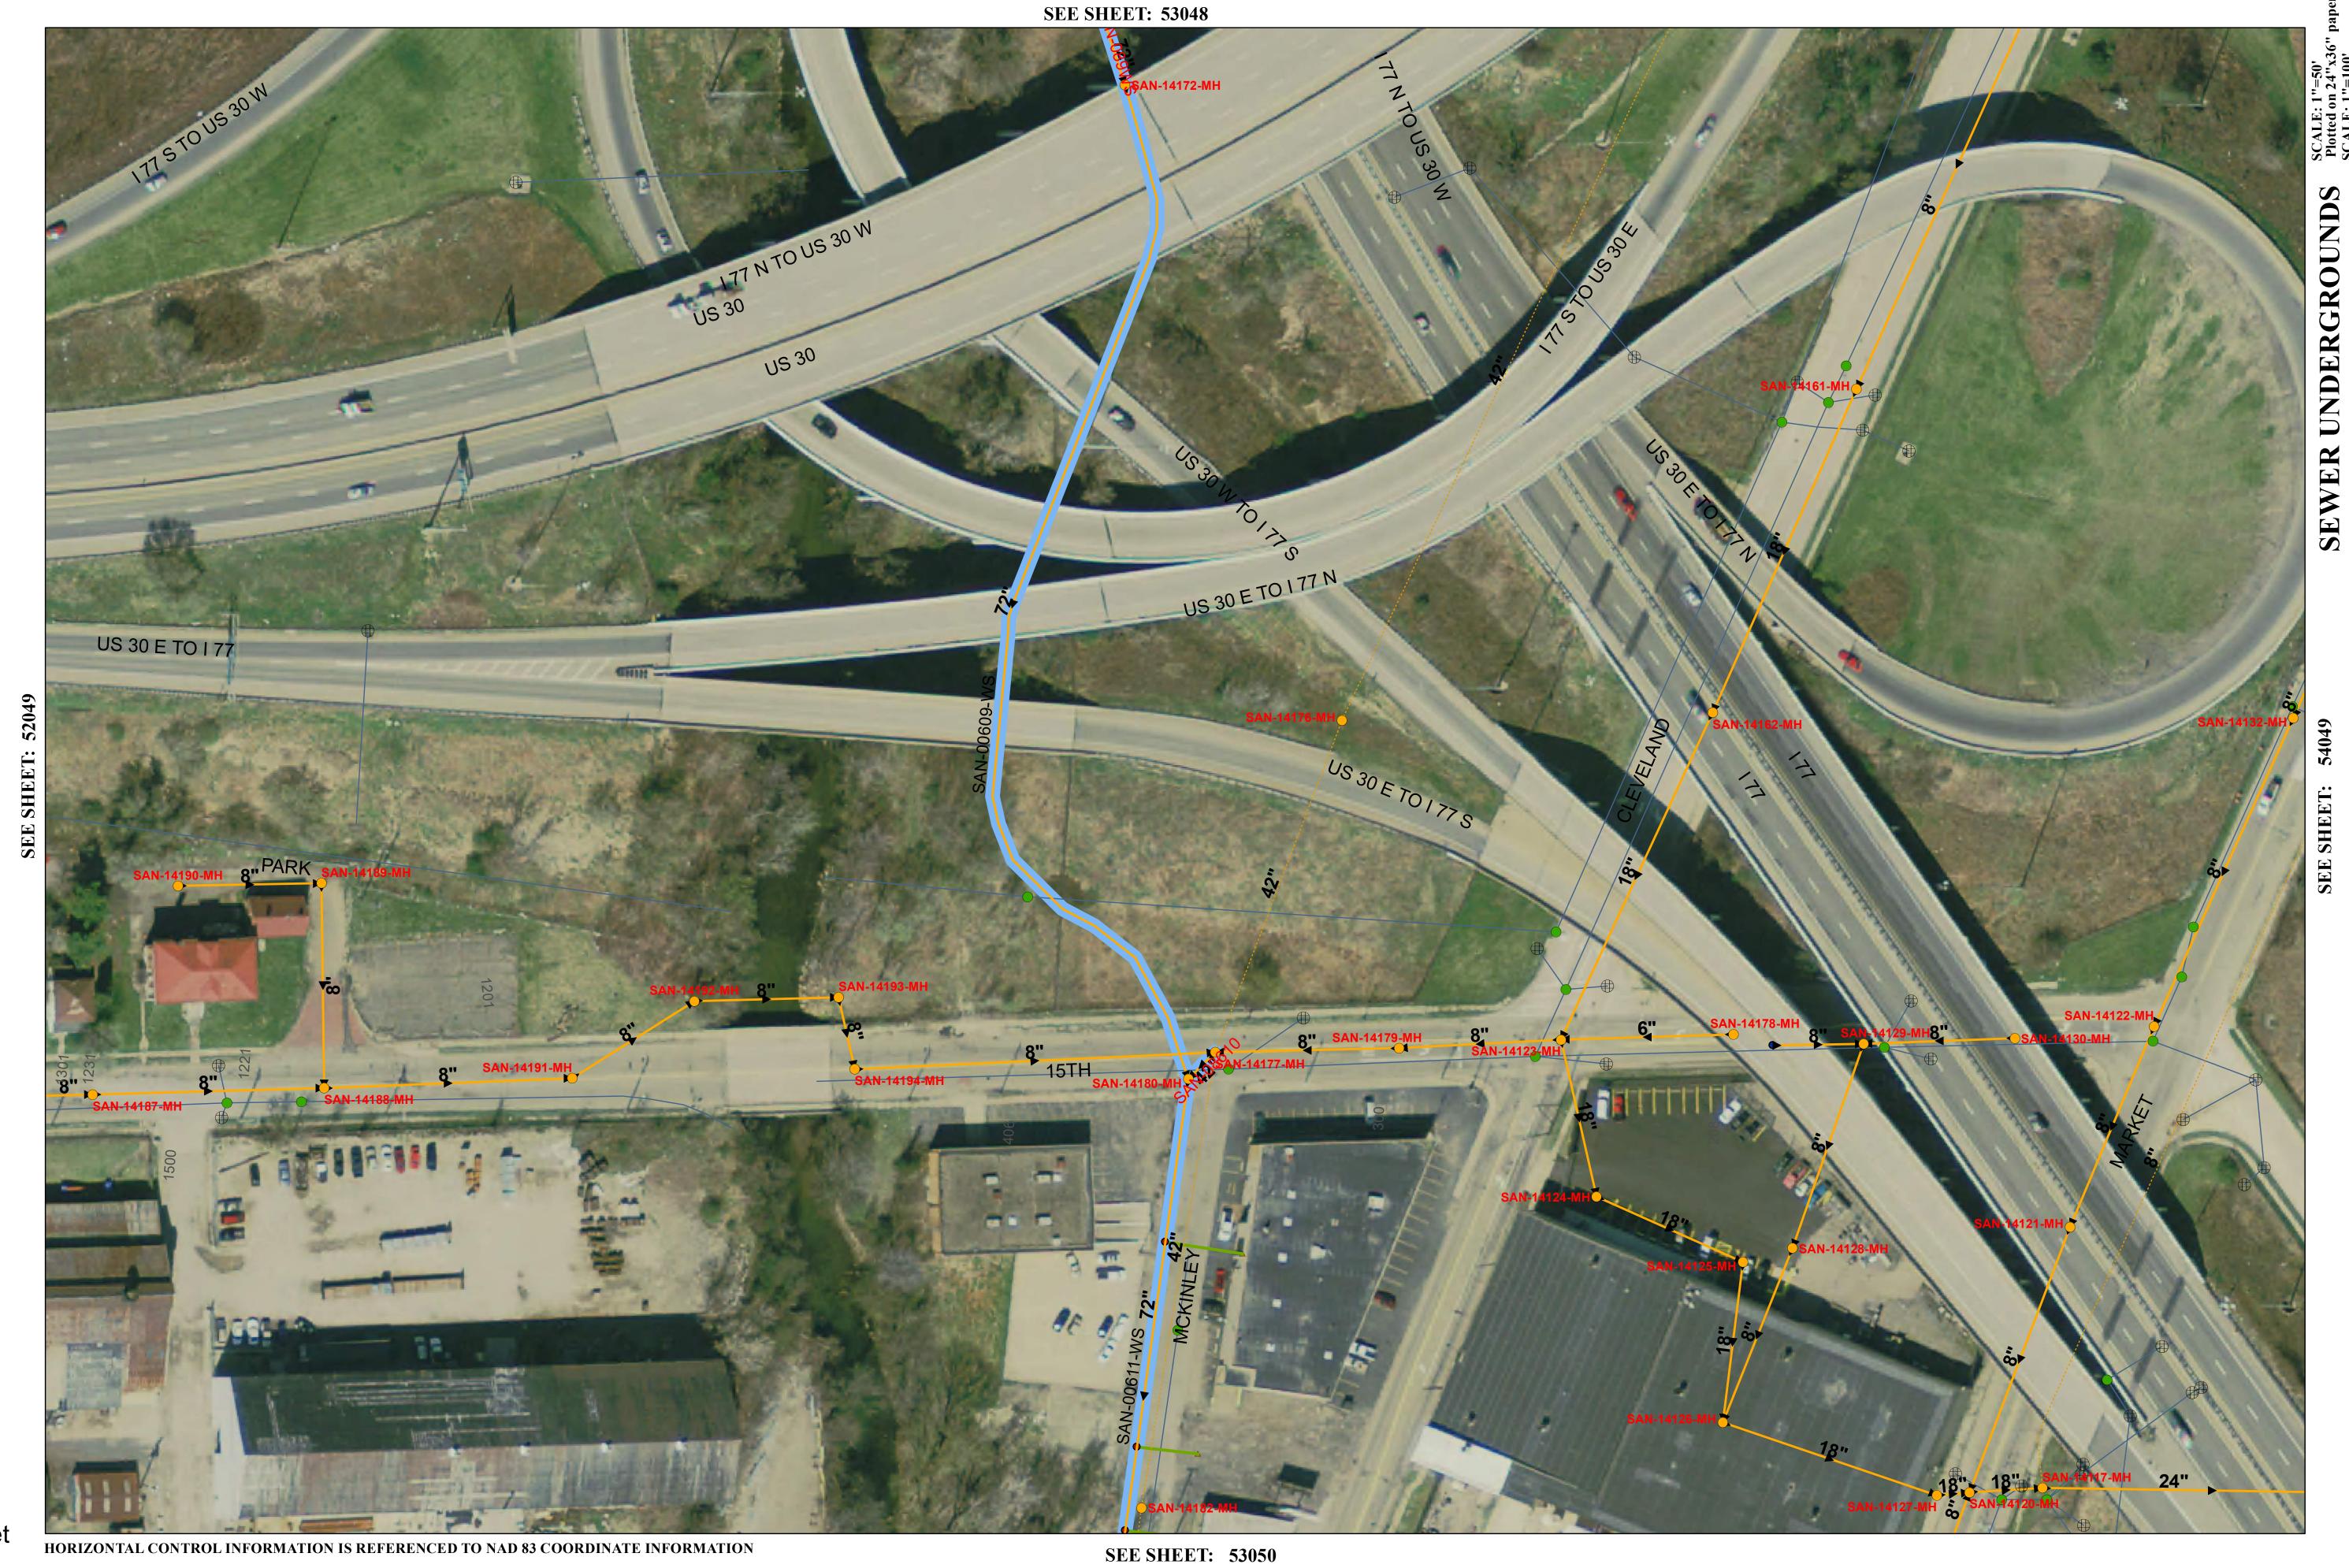

0 25 50 100 Feet

Legend

LDC_A_2020

Storm Manholes

Sanitary Gravity Mains

Sanitary Inlets

Sanitary Fittings

Sanitary Tap

—— Storm Sewers

Sanitary SewerNodes

Sanitary SystemValves

—— Sanitary Force Mains

Sanitary LateralLines

Sanitary Casings

Sanitary Net Junctions

Sanitary ServiceConnection

Sanitary ControlValves

Sanitary Cleanouts

►►► ACTIVE

Sanitary Manholes

Storm Catch Basins

SCALE: 1"=50'
Plotted on 24"x36" paper
SCALE: 1"=100'
Plotted on 12"x18" paper

THE CITY OF CANTON DOES NOT GUARANTEE
THE COMPLETENESS, ACCURACY OR VALIDITY
OF THIS INFORMATION.

BURGESS & NIPLE



2020 Sewer Cleaning and Inspection
SHEET NUMBER
53049



0 25 50

Legend

LDC_A_2020

Storm Manholes

Sanitary Gravity Mains

Sanitary Inlets

Sanitary Fittings

Sanitary Tap

—— Storm Sewers

Sanitary SewerNodes

Sanitary SystemValves

—— Sanitary Force Mains

—— Sanitary LateralLines

Sanitary Casings

Sanitary Net Junctions

Sanitary ServiceConnection

Sanitary ControlValves

Sanitary Cleanouts

►►► ACTIVE

Sanitary Manholes

Storm Catch Basins

SCALE: 1"=50' Plotted on 24"x36" paper SCALE: 1"=100' Plotted on 12"x18" paper

THE CITY OF CANTON DOES NOT GUARANTEE THE COMPLETENESS, ACCURACY OR VALIDITY OF THIS INFORMATION.

HORIZONTAL CONTROL INFORMATION IS REFERENCED TO NAD 83 COORDINATE INFORMATION

BURGESS & NIPLE


SEE SHEET: 53051



2020 Sewer Cleaning and Inspection SHEET NUMBER 53050

STATUS UPDATED: 7/6/2020

Date Saved: 7/20/2020 1:50:45 PM

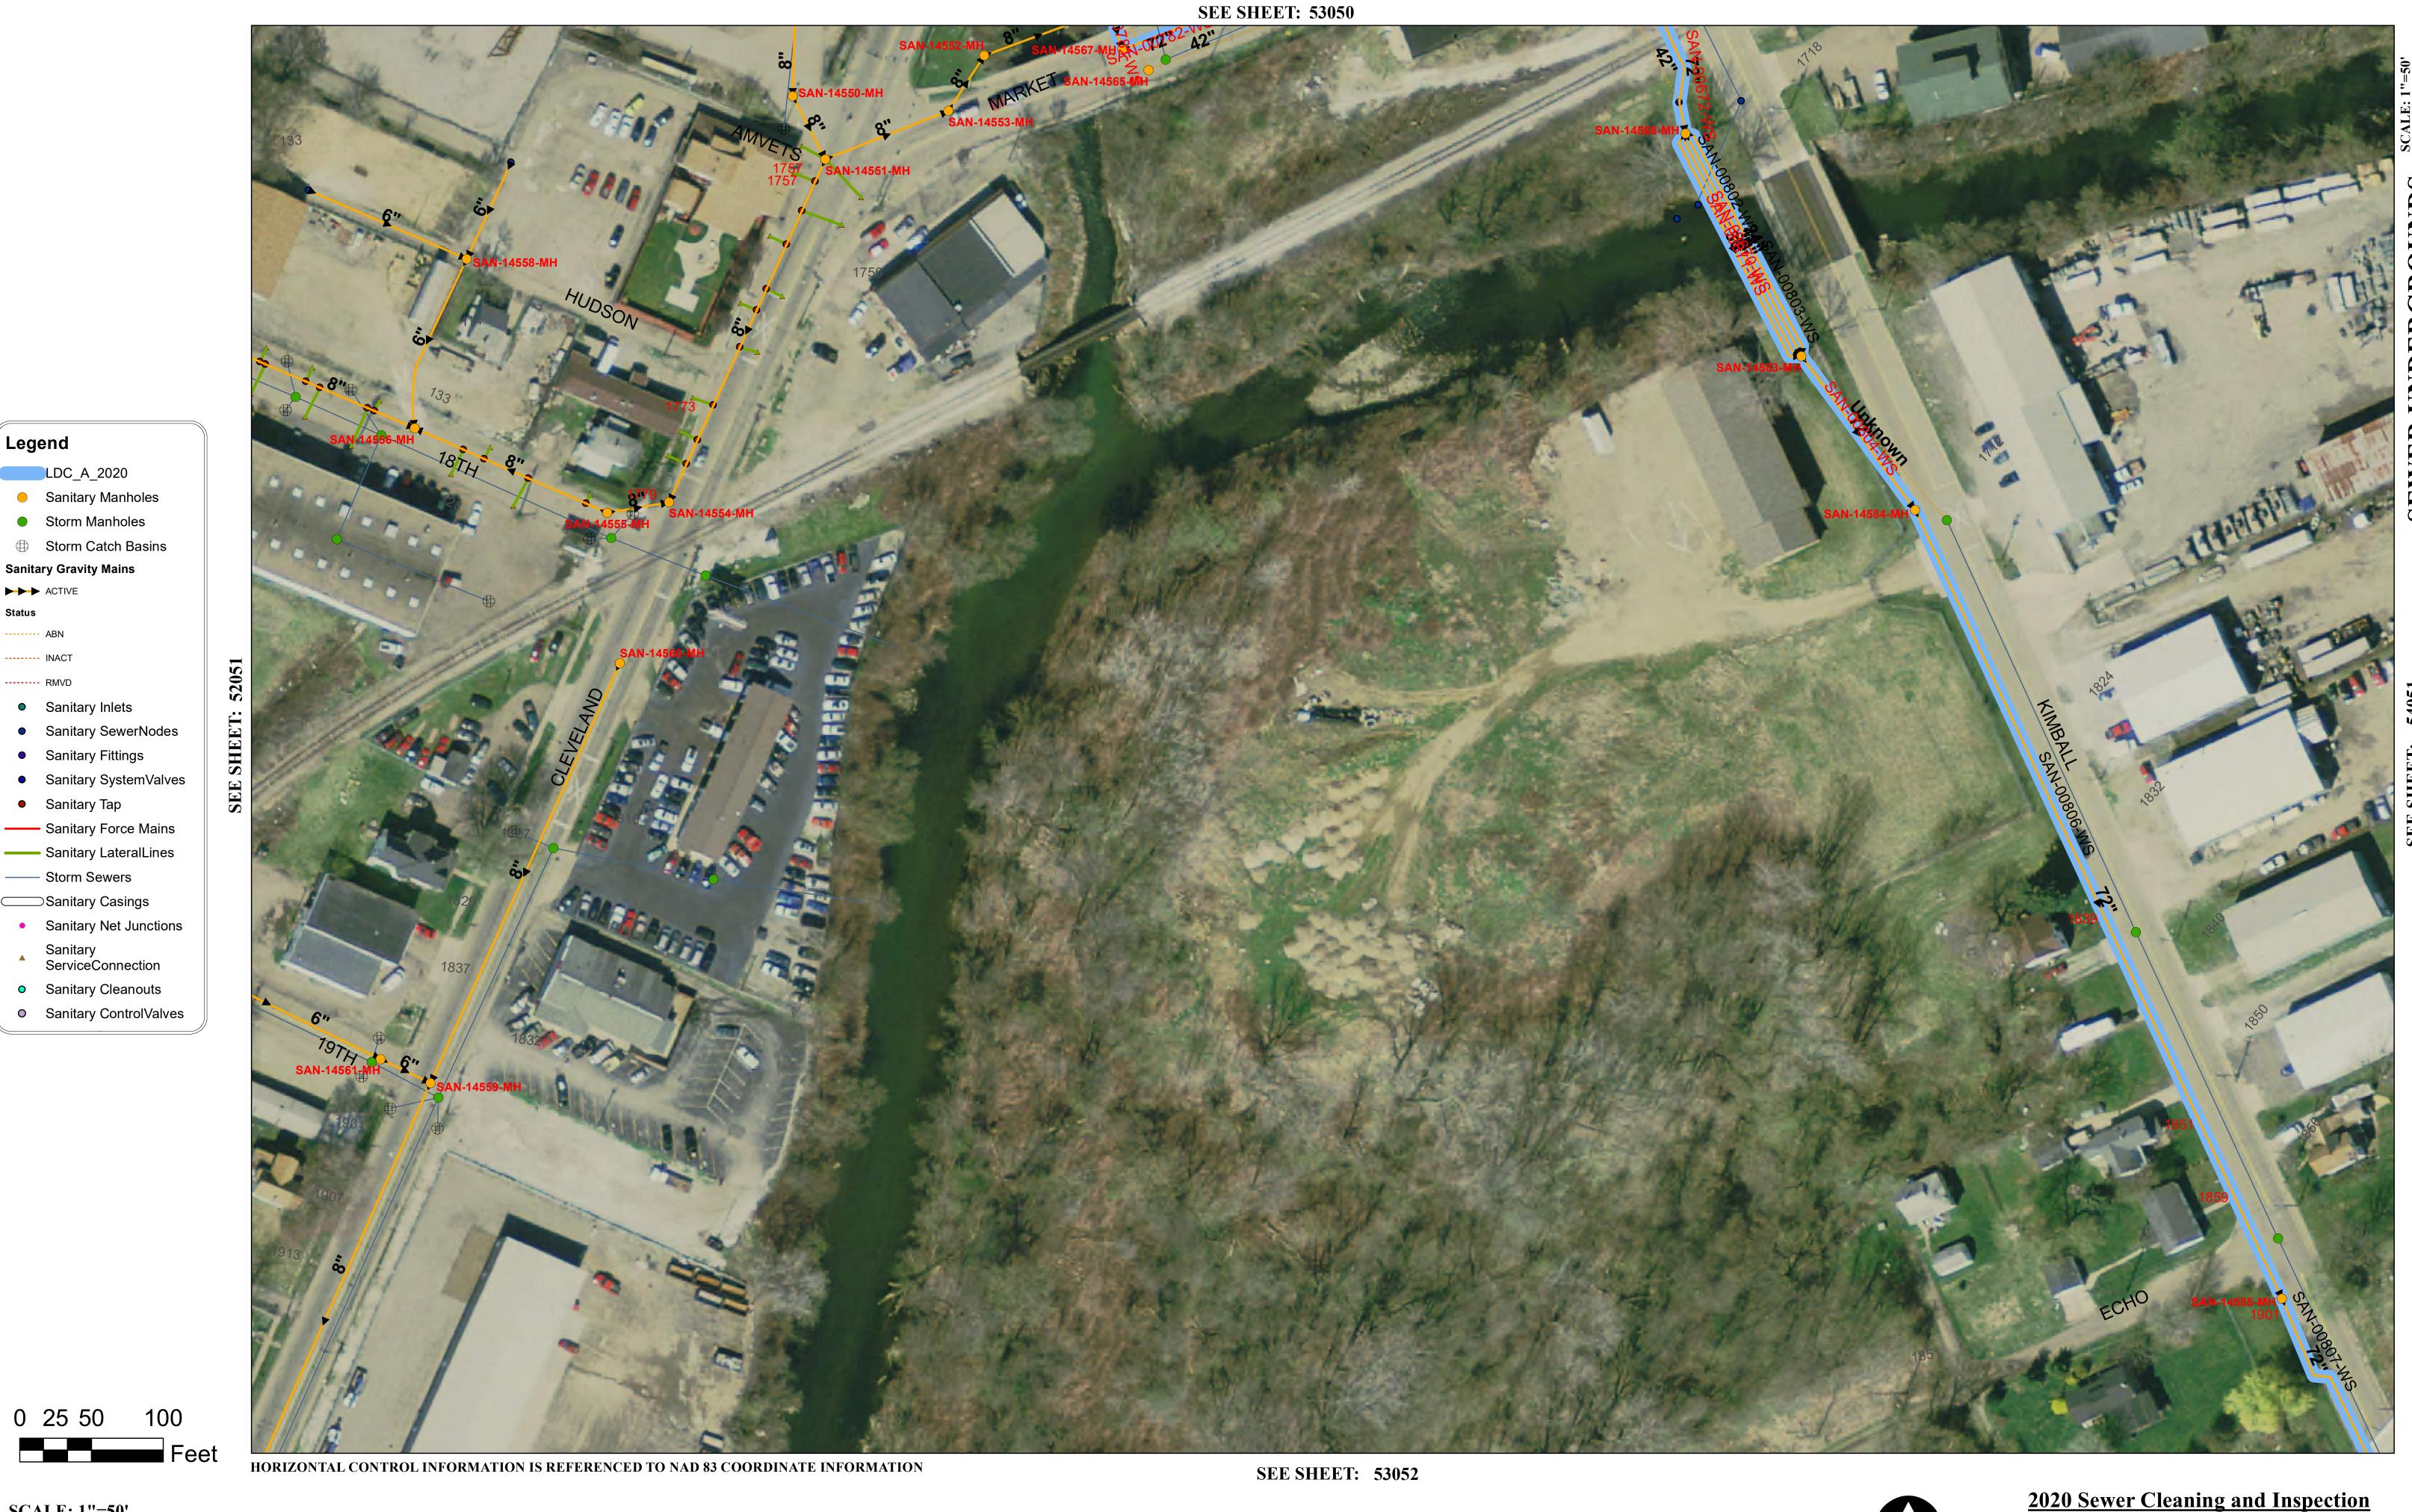

SCALE: 1"=50'
Plotted on 24"x36" paper
SCALE: 1"=100'
Plotted on 12"x18" paper

Legend

►►► ACTIVE

THE CITY OF CANTON DOES NOT GUARANTEE THE COMPLETENESS, ACCURACY OR VALIDITY OF THIS INFORMATION. **BURGESS & NIPLE**



SHEET NUMBER 53051

SEE SHEET: 53051 HORIZONTAL CONTROL INFORMATION IS REFERENCED TO NAD 83 COORDINATE INFORMATION

0 25 50 100

Legend

LDC_A_2020

Storm Manholes

Sanitary Gravity Mains

Sanitary Inlets

Sanitary Fittings

Sanitary Tap

— Storm Sewers

Sanitary SewerNodes

Sanitary SystemValves

—— Sanitary Force Mains

—— Sanitary LateralLines

──Sanitary Casings

Sanitary Net Junctions

Sanitary ServiceConnection

Sanitary ControlValves

Sanitary Cleanouts

►►► ACTIVE

Sanitary Manholes

⊕ Storm Catch Basins

SCALE: 1"=50'
Plotted on 24"x36" paper
SCALE: 1"=100'
Plotted on 12"x18" paper

THE CITY OF CANTON DOES NOT GUARANTEE THE COMPLETENESS, ACCURACY OR VALIDITY OF THIS INFORMATION. **BURGESS & NIPLE**

SEE SHEET: 53053



2020 Sewer Cleaning and Inspection SHEET NUMBER 53052

SCALE: 1"=50' Plotted on 24"x36" paper SCALE: 1"=100' Plotted on 12"x18" paper

0 25 50

Legend

LDC_A_2020

Storm Manholes

Sanitary Gravity Mains

Sanitary Inlets

Sanitary Fittings

Sanitary Tap

—— Storm Sewers

Sanitary SewerNodes

Sanitary SystemValves

—— Sanitary Force Mains

—— Sanitary LateralLines

Sanitary Casings

Sanitary
ServiceConnection

Sanitary Cleanouts

Sanitary ControlValves

Sanitary Net Junctions

►►► ACTIVE

Sanitary Manholes

Storm Catch Basins

THE CITY OF CANTON DOES NOT GUARANTEE THE COMPLETENESS, ACCURACY OR VALIDITY OF THIS INFORMATION.

HORIZONTAL CONTROL INFORMATION IS REFERENCED TO NAD 83 COORDINATE INFORMATION

BURGESS & NIPLE

SEE SHEET: 54037



2020 Sewer Cleaning and Inspection SHEET NUMBER 54036

STATUS UPDATED: 7/6/2020

Date Saved: 7/20/2020 1:50:45 PM

0 25 50 100 Feet

Legend

LDC_A_2020

Storm Manholes

Sanitary Gravity Mains

Sanitary Inlets

Sanitary Fittings

Sanitary Tap

—— Storm Sewers

Sanitary SewerNodes

Sanitary SystemValves

—— Sanitary Force Mains

—— Sanitary LateralLines

Sanitary Casings

Sanitary Net Junctions

Sanitary ServiceConnection

Sanitary ControlValves

Sanitary Cleanouts

►►► ACTIVE


Sanitary Manholes

⊕ Storm Catch Basins

HORIZONTAL CONTROL INFORMATION IS REFERENCED TO NAD 83 COORDINATE INFORMATION

BURGESS & NIPLE

SEE SHEET: 54053

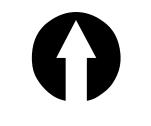

2020 Sewer Cleaning and Inspection

SHEET NUMBER

54052

STATUS UPDATED: 7/6/2020

SCALE: 1"=50'
Plotted on 24"x36" paper
SCALE: 1"=100'
Plotted on 12"x18" paper

THE CITY OF CANTON DOES NOT GUARANTEE
THE COMPLETENESS, ACCURACY OR VALIDITY
OF THIS INFORMATION.



0 25 50 100 Feet

Legend

▶ ► ACTIVE

LDC_A_2020

Storm Manholes

Sanitary Gravity Mains

Sanitary Inlets

Sanitary Fittings

Sanitary Tap

—— Storm Sewers

Sanitary SewerNodes

Sanitary SystemValves

—— Sanitary Force Mains

Sanitary LateralLines

Sanitary Casings

Sanitary Net Junctions

Sanitary ServiceConnection

Sanitary ControlValves

Sanitary Cleanouts

Sanitary Manholes

Storm Catch Basins

SCALE: 1"=50'
Plotted on 24"x36" paper
SCALE: 1"=100'
Plotted on 12"x18" paper

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OF THIS INFORMATION.

HORIZONTAL CONTROL INFORMATION IS REFERENCED TO NAD 83 COORDINATE INFORMATION

BURGESS & NIPLE

SEE SHEET: 54054



2020 Sewer Cleaning and Inspection
SHEET NUMBER
54053



SCALE: 1"=50'
Plotted on 24"x36" paper
SCALE: 1"=100'
Plotted on 12"x18" paper

0 25 50 100

Legend

LDC_A_2020

Storm Manholes

Sanitary Gravity Mains

Sanitary Inlets

Sanitary Fittings

Sanitary Tap

— Storm Sewers

Sanitary SewerNodes

Sanitary SystemValves

—— Sanitary Force Mains

—— Sanitary LateralLines

──Sanitary Casings

Sanitary Net Junctions

Sanitary ServiceConnection

Sanitary ControlValves

Sanitary Cleanouts

►►► ACTIVE

Sanitary Manholes

⊕ Storm Catch Basins

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OF THIS INFORMATION.

BURGESS & NIPLE



2020 Sewer Cleaning and Inspection

SHEET NUMBER

54054



SCALE: 1"=50'
Plotted on 24"x36" paper
SCALE: 1"=100'
Plotted on 12"x18" paper

0 25 50

Legend

LDC_A_2020

Storm Manholes

Sanitary Gravity Mains

Sanitary Inlets

Sanitary Fittings

Sanitary Tap

—— Storm Sewers

Sanitary SewerNodes

Sanitary SystemValves

—— Sanitary Force Mains

—— Sanitary LateralLines

──Sanitary Casings

Sanitary Net Junctions

Sanitary ServiceConnection

Sanitary ControlValves

Sanitary Cleanouts

►►► ACTIVE

Sanitary Manholes

⊕ Storm Catch Basins

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OF THIS INFORMATION.

BURGESS & NIPLE



2020 Sewer Cleaning and Inspection

SHEET NUMBER

54055



SCALE: 1"=50'
Plotted on 24"x36" paper
SCALE: 1"=100'
Plotted on 12"x18" paper

0 25 50

Legend

LDC_A_2020

Storm Manholes

Sanitary Gravity Mains

Sanitary Inlets

Sanitary Fittings

Sanitary Tap

— Storm Sewers

Sanitary SewerNodes

Sanitary SystemValves

—— Sanitary Force Mains

—— Sanitary LateralLines

──Sanitary Casings

Sanitary Net Junctions

Sanitary ServiceConnection

Sanitary ControlValves

Sanitary Cleanouts

►►► ACTIVE

Sanitary Manholes

⊕ Storm Catch Basins

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THE COMPLETENESS, ACCURACY OR VALIDITY
OF THIS INFORMATION.

BURGESS & NIPLE



2020 Sewer Cleaning and Inspection

SHEET NUMBER

55055

Legend LDC_A_2020 Sanitary Manholes Storm Manholes Storm Catch Basins **Sanitary Gravity Mains** ►►► ACTIVE Sanitary Inlets Sanitary SewerNodes Sanitary Fittings Sanitary SystemValves Sanitary Tap —— Sanitary Force Mains —— Sanitary LateralLines —— Storm Sewers ──Sanitary Casings Sanitary Net Junctions Sanitary ServiceConnection Sanitary Cleanouts

Sanitary ControlValves

SAN-00349-ES 60"

0 25 50

SCALE: 1"=50' Plotted on 24"x36" paper

SCALE: 1"=100'
Plotted on 12"x18" paper

HORIZONTAL CONTROL INFORMATION IS REFERENCED TO NAD 83 COORDINATE INFORMATION

THE CITY OF CANTON DOES NOT GUARANTEE THE COMPLETENESS, ACCURACY OR VALIDITY OF THIS INFORMATION.



SEE SHEET: 55057



2020 Sewer Cleaning and Inspection SHEET NUMBER 55056



SCALE: 1"=50'
Plotted on 24"x36" paper
SCALE: 1"=100'
Plotted on 12"x18" paper

0 25 50

Legend

LDC_A_2020

Storm Manholes

Sanitary Gravity Mains

Sanitary Inlets

Sanitary Fittings

Sanitary Tap

—— Storm Sewers

Sanitary SewerNodes

Sanitary SystemValves

—— Sanitary Force Mains

—— Sanitary LateralLines

Sanitary Casings

Sanitary Net Junctions

Sanitary ServiceConnection

Sanitary ControlValves

Sanitary Cleanouts

►►► ACTIVE

Sanitary Manholes

Storm Catch Basins

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OF THIS INFORMATION.

BURGESS & NIPLE



2020 Sewer Cleaning and Inspection

SHEET NUMBER

55057

Sanitary Force Mains
Sanitary LateralLines
Storm Sewers
Sanitary Casings
Sanitary Net Junctions
Sanitary
ServiceConnection
Sanitary Cleanouts
Sanitary ControlValves

Legend

LDC_A_2020

Storm Manholes

Sanitary Gravity Mains

Sanitary Inlets

Sanitary Fittings

Sanitary Tap

Sanitary SewerNodes

Sanitary SystemValves

►►► ACTIVE

Sanitary Manholes

Storm Catch Basins

0 25 50 100 Feet

SCALE: 1"=50'
Plotted on 24"x36" paper
SCALE: 1"=100'
Plotted on 12"x18" paper

THE CITY OF CANTON DOES NOT GUARANTEE
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OF THIS INFORMATION.

BURGESS & NIPLE



2020 Sewer Cleaning and Inspection
SHEET NUMBER
55058

0 25 50

Legend

LDC_A_2020

Storm Manholes

Sanitary Gravity Mains

Sanitary Inlets

Sanitary Fittings

Sanitary Tap

—— Storm Sewers

Sanitary SewerNodes

Sanitary SystemValves

—— Sanitary Force Mains

—— Sanitary LateralLines

──Sanitary Casings

Sanitary Net Junctions

Sanitary ServiceConnection

Sanitary ControlValves

Sanitary Cleanouts

►►► ACTIVE

Sanitary Manholes

Storm Catch Basins

SCALE: 1"=50' Plotted on 24"x36" paper SCALE: 1"=100'
Plotted on 12"x18" paper

THE CITY OF CANTON DOES NOT GUARANTEE THE COMPLETENESS, ACCURACY OR VALIDITY OF THIS INFORMATION.

HORIZONTAL CONTROL INFORMATION IS REFERENCED TO NAD 83 COORDINATE INFORMATION

BURGESS & NIPLE

SEE SHEET: 56058



2020 Sewer Cleaning and Inspection SHEET NUMBER 56057

0 25 50

Legend

LDC_A_2020

Storm Manholes

Sanitary Gravity Mains

Sanitary Inlets

Sanitary Fittings

Sanitary Tap

—— Storm Sewers

Sanitary SewerNodes

Sanitary SystemValves

—— Sanitary Force Mains

—— Sanitary LateralLines

Sanitary Casings

Sanitary Net Junctions

Sanitary ServiceConnection

Sanitary ControlValves

Sanitary Cleanouts

►►► ACTIVE

Sanitary Manholes

Storm Catch Basins

SCALE: 1"=50' Plotted on 24"x36" paper SCALE: 1"=100'
Plotted on 12"x18" paper

THE CITY OF CANTON DOES NOT GUARANTEE THE COMPLETENESS, ACCURACY OR VALIDITY OF THIS INFORMATION. **BURGESS & NIPLE**



2020 Sewer Cleaning and Inspection SHEET NUMBER 56058

LDC_A_2020

Sanitary Manholes Storm Manholes

Storm Catch Basins

Sanitary Gravity Mains

►►► ACTIVE

Sanitary Inlets

Sanitary SewerNodes

Sanitary Fittings

Sanitary SystemValves Sanitary Tap

—— Sanitary Force Mains Sanitary LateralLines

—— Storm Sewers

Sanitary Casings

Sanitary Net Junctions

Sanitary ServiceConnection

 Sanitary Cleanouts Sanitary ControlValves



0 25 50

SCALE: 1"=50' Plotted on 24"x36" paper SCALE: 1"=100' Plotted on 12"x18" paper

THE CITY OF CANTON DOES NOT GUARANTEE THE COMPLETENESS, ACCURACY OR VALIDITY OF THIS INFORMATION. **BURGESS & NIPLE**



2020 Sewer Cleaning and Inspection SHEET NUMBER 56059

SCALE: 1"=50'
Plotted on 24"x36" paper
SCALE: 1"=100'
Plotted on 12"x18" paper

0 25 50

Legend

LDC_A_2020

Storm Manholes

Sanitary Gravity Mains

Sanitary Inlets

Sanitary Fittings

Sanitary Tap

— Storm Sewers

Sanitary SewerNodes

Sanitary SystemValves

—— Sanitary Force Mains

—— Sanitary LateralLines

Sanitary Casings

Sanitary Net Junctions

Sanitary ServiceConnection

Sanitary ControlValves

Sanitary Cleanouts

►►► ACTIVE

Sanitary Manholes

⊕ Storm Catch Basins

THE CITY OF CANTON DOES NOT GUARANTEE
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BURGESS & NIPLE



2020 Sewer Cleaning and Inspection

SHEET NUMBER

56060

BID FORM

CITY OF CANTON – 2020 LARGE DIAMETER SEWER CLEANING AND INSPECTION

BIDDER agrees to perform all the work described in the Contract Documents for the following unit prices:

				Unit Pri	ces in Figures		
(1)	(2)	(3)	(4)	(5)	(6)	(7 = 5 + 6)	$(8 = 3 \times 7)$
						Total (Sum of	Total Extended
Item	Description	Oventity	Unit	Labor	Material	Labor and Material)	Informal Price in
Item	Description	Quantity		Labor	Material	(Viaterial)	Figures
1	Mobilization	1	LS				
PRE-1	Pre-CCTV Inspection (all sizes)	39,000	LF				
PRE-2	Pre-CCTV and SONAR Inspection (all sizes)	1,000	LF				
SPC-1	Sewer Pipe Cleaning and Post Inspection (18")	11,550	LF				
SPC-2	Sewer Pipe Cleaning and Post Inspection (20"-24")	4,575	LF				
SPC-3	Sewer Pipe Cleaning and Post Inspection (25"-36")	1,575	LF				
SPC-4	Sewer Pipe Cleaning and Post Inspection (37"-48")	5,175	LF				
SPC-5	Sewer Pipe Cleaning and Post Inspection (49"-60")	19,425	LF				
SPC-6	Sewer Pipe Cleaning and Post Inspection (61"-72")	11,250	LF				
SPC-7	Sewer Pipe Cleaning and Post Inspection (73"-96")	1,250	LF				

56512*GS*07/20/2020

MAD:tma

BID FORM

CITY OF CANTON - 2020 LARGE DIAMETER SEWER CLEANING AND INSPECTION

				Unit Prices in Figures			
(1)	(2)	(3)	(4)	(5)	(6)	(7 = 5 + 6) Total (Sum of Labor and	(8 = 3 x 7) Total Extended Informal Price in
Item	Description	Quantity	Unit	Labor	Material	Material)	Figures
2	Special Pipe Cleaning Tools Allowance (Time & Materials)	1	Allowance	-	-	\$ 70,000	\$ 70,000
3	Local Off-Duty Police Assistance with MOT Allowance	1	Allowance	-	-	\$ 25,000	\$ 25,000
4	By-Pass Pumping Allowance	1	Allowance	-	-	\$ 75,000	\$ 75,000
5	Sediment and Debris Handling and Disposal	1,200	Ton				
6	Site Restoration	1	LS				

Quantities are not guaranteed. Final payment will be based on actual quantities completed/used.

Informal Total	of Bid Items \$		
	Respectfully su		
		Name of Contractor	Address
		Signature	Date
(Seal - if Bid is by a cor	poration)	Title	Phone Number
Attest			
56512*GS*07/20/2020 MAD:tma			

Signature and Proposal Pages

Signature Page Large Diameter Sanitary Sewer - Cleaning & Televising - 2020

To the Director of Public Service of the City of Canton:

The undersigned, having carefully examined the complete invitation to bid, herewith proposes to furnish all the labor and materials required to complete the **Large Diameter Sanitary Sewer - Cleaning & Televising – 2020 Project** in accordance with the specifications on file, including any and all work and materials that may be necessary to complete the project in a proper and workmanlike manner, and in accordance with the instructions in the bid packet and under the direction of and to the satisfaction of the Director of Public Service of said City.

The bidder hereby agrees that the Director of Public Service has the right to reject any and all bids and to accept the bid(s) deemed most beneficial to the City of Canton. The bidder hereby certifies that the undersigned is the only person interested in the bid and the bidder herewith certifies that no officer or employee of the City of Canton is in any manner interested therein. The bidder herewith encloses a (BID BOND, CERTIFIED/CASHIER'S CHECK) in the sum of \$ ______ dollars made payable to the CITY OF CANTON as a guaranty that if awarded the contract for the work included in the proposal, _____ will enter into contract therefore, with sureties satisfactory to the Director of Public Service, within the prescribed time of ten (10) days from the date of service of notice of award, otherwise such bond or checks shall become the property of said City, as liquidated damages of the failure on the bidder's part to do said contract within the specified time. The bidder acknowledges receipt of Addenda Numbers: _____. SIGNATURE OF BIDDER:

NOTE: If bidder is a corporation, set forth the legal name of the corporation, together with the signature of the officer or officers authorized to sign contracts on behalf of the corporation. If bidder is a partnership, set forth the name of the firm, together with the signature of the partner or partners authorized to sign contracts on behalf of the partnership.

Title VI Requirements

The City of Canton, in accordance with the provisions of Title VI of the Civil Rights Act of 1964 (78 Stat.252, 42 U.S.C. §§ 2000d to 2000d-4) and the Regulations, hereby notifies all bidders that it will affirmatively ensure that any contract entered into pursuant to this advertisement, disadvantaged business enterprises will be afforded full and fair opportunity to submit bids in response to this invitation and will not be discriminated against on the grounds of race, color, or national origin in consideration for an award.

No person in the United States shall, on the grounds of race, color, or national origin, be excluded from participation in, be denied the benefits of, or be otherwise subjected to discrimination under any program or activity, for which the Recipient receives Federal financial assistance from DOT, including the City of Canton.

Please also review Appendix A, Appendix C, Appendix D and Appendix E of the Standard Assurances which are included in the following pages.

APPENDIX A

During the performance of this contract, the contractor, for itself, its assignees, and successors in interest (hereinafter referred to as the "contractor") agrees as follows:

- 1. **Compliance with Regulations:** The contractor (hereinafter includes consultants) will comply with the Acts and the Regulations relative to Non-discrimination in Federally-assisted programs of the U.S. Department of Transportation, *The City of Canton*, as they may be amended from time to time, which are herein incorporated by reference and made a part of this contract.
- Non-discrimination: The contractor, with regard to the work performed by it during the contract, will not discriminate on the grounds of race, color, or national origin in the selection and retention of subcontractors, including procurements of materials and leases of equipment. The contractor will not participate directly or indirectly in the discrimination prohibited by the Acts and the Regulations, including employment practices when the contract covers any activity, project, or program set forth in Appendix B of 49 CFR Part21. [Include City of Canton specific program requirements.]
- 3. Solicitations for Subcontracts, Including Procurements of Materials and Equipment: In all solicitations, either by competitive bidding, or negotiation made by the contractor for work to be performed under a subcontract, including procurements of materials, or leases of equipment, each potential subcontractor or supplier will be notified by the contractor of the contractor's obligations under this contract and the Acts and the Regulations relative to Non-discrimination on the grounds of race, color, or national origin. [Include City of Canton specific program requirements.]
 - 4. **Information and Reports:** The contractor will provide all information and reports required by the Acts, the Regulations, and directives issued pursuant thereto and will permit access to its books, records, accounts, other sources of information, and its facilities as may be determined by the Recipient or *The City of Canton*) to be pertinent to ascertain compliance with such Acts, Regulations, and instructions. Where any information required of a contractor is in the exclusive possession of another who fails or refuses to furnish the information, the contractor will so certify to the Recipient or *The City of Canton*), as appropriate, and will set forth what efforts it has made to obtain the information.
- 5. **Sanctions for Noncompliance:** In the event of a contractor's noncompliance with the Non• discrimination provisions of this contract, the Recipient will impose such contract sanctions as it or <u>The City of Canton</u> may determine to be appropriate, including, but not limited to:
 - a. withholding payments to the contractor under the contract until the contractor complies; and/or
 - b. cancelling, terminating, or suspending a contract, in whole or in part.
- 6. **Incorporation of Provisions:** The contractor will include the provisions of paragraphs one through six in every subcontract, including procurements of materials and leases of equipment, unless exempt by the Acts, the Regulations and directives issued pursuant thereto. The contractor will take action with respect to any subcontract or procurement as the Recipient or *The City of Canton* may direct as a means of enforcing such provisions including sanctions for noncompliance. Provided, that if the contractor becomes involved in, or is threatened with litigation by a subcontractor, or supplier because of such direction, the contractor may request the Recipient to enter into any litigation to protect the interests of the Recipient. In addition, the contractor may request the United States to enter into the litigation to protect the interests of the United States.

APPENDIX C

CLAUSES FOR TRANSFER OF REAL PROPERTY ACQUIRED OR IMPROVED UNDER THE ACTIVITY, FACILITY, OR PROGRAM

The following clauses will be included in deeds, licenses, leases, permits, or similar instruments entered into by the (*Title of Recipient*) pursuant to the provisions of Assurance 7(a):

- A. The (grantee, lessee, permittee, etc. as appropriate) for himself/herself, his/her heirs, personal representatives, successors in interest, and assigns, as a part of the consideration hereof, does hereby covenant and agree [in the case of deeds and leases add "as a covenant running with the land"] that:
 - 1. In the event facilities are constructed, maintained, or otherwise operated on the property described in this (deed, license, lease, permit, etc.) for a purpose for which a U.S. Department of Transportation activity, facility, or program is extended or for another purpose involving the provision of similar services or benefits, the (grantee, licensee, lessee, permittee, etc.) will maintain and operate such facilities and services in compliance with all requirements imposed by the Acts and Regulations (as may be amended) such that no person on the grounds of race, color, or national origin, will be excluded from participation in, denied the benefits of, or be otherwise subjected to discrimination in the use of said facilities.
- B. With respect to licenses, leases, permits, etc., in the event of breach of any of the above Non-discrimination covenants, (*Title of Recipient*) will have the right to terminate the (lease, license, permit, etc.) and to enter, re-enter, and repossess said lands and facilities thereon, and hold the same as if the (lease, license, permit, etc.) had never been made or issued.*
- C. With respect to a deed, in the event of breach of any of the above Non-discrimination covenants, the (*Title of Recipient*) will have the right to enter or re-enter the lands and facilities thereon, and the above described lands and facilities will there upon revert to and vest in and become the absolute property of the (*Title of Recipient*) and its assigns.*

(*Reverter clause and related language to be used only when it is determined that such a clause is necessary to make clear the purpose of Title VI.)

APPENDIX D

CLAUSES FOR CONSTRUCTION/USE/ACCESS TO REAL PROPERTY ACQUIRED UNDER THE ACTIVITY, FACILITY OR PROGRAM

The following clauses will be included in deeds, licenses, permits, or similar instruments/agreements entered into by (*Title of Recipient*) pursuant to the provisions of Assurance 7(b):

- A. The (grantee, licensee, permittee, etc., as appropriate) for himself/herself, his/her heirs, personal representatives, successors in interest, and assigns, as a part of the consideration hereof, does hereby covenant and agree (in the case of deeds and leases add, "as a covenant running with the land") that (1) no person on the ground of race, color, or national origin, will be excluded from participation in, denied the benefits of, or be otherwise subjected to discrimination in the use of said facilities, (2) that in the construction of any improvements on, over, or under such land, and the furnishing of services thereon, no person on the ground of race, color, or national origin, will be excluded from participation in, denied the benefits of, or otherwise be subjected to discrimination, (3) that the (grantee, licensee, lessee, permittee, etc.) will use the premises in compliance with all other requirements imposed by or pursuant to the Acts and Regulations, as amended, set forth in this Assurance.
- B. With respect to (licenses, leases, permits, etc.), in the event of breach of any of the above Non- discrimination covenants, (*Title of Recipient*) will have the right to terminate the (license, permit, etc., as appropriate) and to enter or re-enter and repossess said land and the facilities thereon, and hold the same as if said (license, permit, etc., as appropriate) had never been made or issued.*
- C. With respect to deeds, in the event of breach of any of the above Non-discrimination covenants, (*Title of Recipient*) will there upon revert to and vest in and become the absolute property of (*Title of Recipient*) and its assigns.*

(*Reverter clause and related language to be used only when it is determined that such a clause is necessary to make clear the purpose of Title VI.)

APPENDIX E

During the performance of this contract, the contractor, for itself, its assignees, and successors in interest (hereinafter referred to as the "contractor") agrees to comply with the following non-discrimination statutes and authorities; including but not limited to:

Pertinent Non-Discrimination Authorities:

- Title VI of the Civil Rights Act of 1964 (42 U.S.C. § 2000d *et seq.*, 78 stat. 252), (prohibits discrimination on the basis of race, color, national origin); and 49 CFR Part 21.
- The Uniform Relocation Assistance and Real Property Acquisition Policies Act of 1970, (42 U.S.C. § 4601), (prohibits unfair treatment of persons displaced or whose property has been acquired because of Federal or Federal-aid programs and projects);
- Federal-Aid Highway Act of 1973, (23 U.S.C. § 324 *et seq.*), (prohibits discrimination on the basis of sex);
- Section 504 of the Rehabilitation Act of 1973, (29 U.S.C. §794 *et seq.*), as amended, (prohibits discrimination on the basis of disability); and 49 CFR Part 27:
- The Age Discrimination Act of 1975, as amended, (42 U.S.C. § 6101 *et seq.*), (prohibits discrimination on the basis of age);
- Airport and Airway Improvement Act of 1982, (49 USC § 471, Section 47123), as amended, (prohibits discrimination based on race, creed, color, national origin, or sex);
- The Civil Rights Restoration Act of 1987, (PL 100-209), (Broadened the scope, coverage and applicability of Title VI of the Civil Rights Act of 1964, The Age Discrimination Act of 1975 and Section 504 of the Rehabilitation Act of 1973, by expanding the definition of the terms "programs or activities" to include all of the programs or activities of the Federal-aid recipients, sub-recipients and contractors, whether such programs or activities are Federally funded or not);
- Titles II and III of the Americans with Disabilities Act, which prohibit discrimination on the basis of disability in the operation of public entities, public and private transportation systems, places of public accommodation, and certain testing entities (42 U.S.C. §§ 12131 12189) as implemented by Department of Transportation regulations at 49 C.F.R. parts 37 and 38;
- The Federal Aviation Administration's Non-discrimination statute (49 U.S.C. § 47123) (prohibits discrimination on the basis of race, color, national origin, and sex):
- Executive Order 12898, Federal Actions to Address Environmental Justice in Minority
 Populations and Low-Income Populations, which ensures discrimination against minority
 populations by discouraging programs, policies, and activities with disproportionately high
 and adverse human health or environmental effects on minority and low-income populations;
- Executive Order 13166, Improving Access to Services for Persons with Limited English Proficiency, and resulting agency guidance, national origin discrimination includes discrimination because of limited English proficiency (LEP). To ensure compliance with Title VI, you must take reasonable steps to ensure that LEP persons have meaningful access to your programs (70 Fed. Reg. at 74087 to 74100);
- Title IX of the Education Amendments of 1972, as amended, which prohibits you from discriminating because of sex in education programs or activities (20 U.S.C. 1681 etseq).

CANTON TITLE VI COMPLAINT PROCEDURE

I. FILING A COMPLAINT

Complaint Procedure - Any person who believes that he or she as a member of a protected class, has been discriminated against based on race, color, national origin, gender, age, disability, religion, low income status, or Limited English Proficiency (LEP) in violation of Title VI of the Civil Rights Act of 1964, as amended and its related statutes, regulations and directives, Section 504 of the Vocational Rehabilitation Act of 1973, Americans with Disabilities Act of 1990, as amended, the Civil Rights Restoration Act of 1987, as amended, and any other Federal nondiscrimination statute may submit a complaint. A complaint may also be submitted by a representative on behalf of such a person.

It is the policy of the City to conduct a prompt and impartial investigation of all allegations of discrimination and to take prompt effective corrective action when a claim of discrimination is substantiated.

No one may intimidate, threaten, coerce or engage in other discriminatory conduct against anyone because they have taken action or participated in an action to secure rights protected by the civil rights laws. Any individual alleging such harassment or intimidation may submit a complaint by following the procedure printed below.

Any individual who feels that he or she has been discriminated against may submit a written or verbal complaint to the designated Title VI Coordinator. A complaint must include the name, address and telephone number of the individual making the complaint (complainant) and a brief description of the alleged discriminatory conduct including the date of harm. An individual submitting a complaint alleging discrimination may include any relevant evidence, including the names of witnesses and supporting documentation.

Complaints should be directed to the Title VI Coordinator:

Fonda Williams
Deputy Mayor
218 Cleveland Ave S.W., 8th floor
Canton, Ohio 44702
Phone - 330-438-4302
Email – fonda.williams@cantonohio.gov

Within 60 days of the receipt of the complaint the City will conduct an investigation of the allegation based on the information provided and issue a written report of its findings to the complainant. The City will try to obtain an informal voluntary resolution to all complaints at the lowest level possible.

A complainant's identity shall be kept confidential except to the extent necessary to conduct an investigation. All complaints shall be kept confidential.

These procedures do not deny the right of any individual to file a formal complaint with any government agency or affect an individual's right to seek private counsel for any complaint alleging discrimination.

Complaints may also be filed with the following government agencies:

Ohio Department of Transportation Office of Equal Opportunity 1980 West Broad Street MS: 3270 Columbus, OH 43223

The U.S. Department of Transportation 1200 New Jersey Avenue, SE Washington, DC 20590

Ohio Civil Rights Commission Central Office Rhodes State Office Tower 30 East Broad Street, 5th floor Columbus, OH 43215 614-466-2785

Ohio Civil Rights Commission Akron Regional Office Bradley S. S. Dunn, Regional Director Akron Government Bldg. 161 S. High Street, Suite 205 Akron, OH 44308 (330) 643-3100

Link to filing a complaint online with the Ohio Civil Rights Commission:

https://crc.ohio.gov/FilingaCharge/ChargeFilingProcedure.aspx

II. COMPLAINT PROCESSING

The Title VI Coordinator will review the complaint upon receipt to ensure that all required information is provided, the complaint meets the filing deadline date which is 180 days from the date the alleged discriminatory act occurred, and falls within the jurisdiction of the City.

The Title VI Coordinator will then investigate the complaint. If the complaint is against the City then the Mayor's office or their designee will investigate the complaint. Additionally, a copy of the complaint will be forwarded to the City Law Director.

If the complaint warrants a full investigation, the Complainant will be notified in writing by certified mail. This notice will name the investigator and/or investigating agency.

The party alleged to have acted in a discriminatory manner will also be notified by certified mail as of the complaint. This letter will also include the investigator's name and will request that this party be available for an interview.

Any comments or recommendations from legal counsel will be reviewed by the Title VI Coordinator, Director of Public Service and Mayor's office.

Once the City has investigated the report findings, the City will adopt a final resolution. All parties associated with the complaint will be properly notified of the outcome of the City's investigative report.

If the complainant is not satisfied with the results of the investigation of the alleged discriminatory practice(s), she/he shall be advised of their right to appeal the City's decision.

Appeals must be filed within 180 days after the City's final resolution. Unless new facts not previously considered come to light, reconsideration of the City's determination will not be available.

The foregoing complaint resolution procedure will be implemented in accordance with the Department of Justice guidance manual entitled "Investigation Procedures Manual for the Investigation and Resolution of Complaints Alleging Violations of Title VI and Other Nondiscrimination Statues," available online at:

http://www.justice.gov/crt/about/cor/Pubs/manuals/complain.pdf

Title VI Complaint Filing

Complaints filed with the City of Canton, Ohio based on violations of Title VI of the Civil Rights Act of 1964, must include the following information:

- · Name of Complainant
- · Date of Complaint
- · Address of Complainant
- · Name of Agency / Department Accused of Discriminatory Practices
- · Address of Agency
- · Description of Alleged Discrimination (see below)
- · Telephone Number of Complainant
- · Name of Individual Accused of Discriminatory Practices
- · Date of Alleged Discrimination
- **11. Alleged Discrimination -** If your complaint is in regard to discrimination in the delivery of services or discrimination that involved the treatment of you by others by the agency or department indicated above, please indicate below the basis on which you believe these discriminatory actions were taken.
- · Race / Color / Religion
- · National Origin
- · Age · Sex, Gender
- · Disability · Income Status
- \cdot Explanation of Alleged Discrimination Please explain as clearly aspossible what happened.

Provide the name(s) of witness(s) and others involved in the alleged discrimination. (Attach additional sheets if necessary and provide a copy of written material pertaining to your case.)

· Signature of Complainant · Date of Complaint

III. ENVIRONMENTAL JUSTICE

In accordance with Title VI of the Civil Rights Act of 1964, each Federal agency shall ensure that all programs or activities receiving Federal financial assistance that affect human health or the environment do not directly, or through other arrangements, use criteria, methods, or practices that discriminate on the basis of race, color, or national origin. Part of Title VI reads, "No person in the United States shall, on the ground of race, color, or national origin be excluded

from participation in, be denied the benefits of, or be subject to discrimination under any program or activity receiving Federal financial assistance."

The three fundamental environmental justice (EJ) principles are:

- · To avoid, minimize, or mitigate disproportionately high and adverse human health and environmental effects, including social and economic effects, on minority populations andlowincome populations;
- \cdot To ensure the full and fair participation by all potentially affected communities in the transportation decision-making process; and
- · To prevent the denial of, reduction in, or significant delay in the receipt of benefits by minority populations and low-income populations.

The City of Canton is committed to these three environmental justice principles in all work that the City performs.

IV. ADMINISTRATION – WORK PLAN

Pursuant to 23 CFR 200, the City of Canton has designated a Title VI Coordinator who is responsible for initiating, monitoring, and ensuring the City's compliance with Title VI requirements for the following work plan:

- · Administer, coordinate and Implement the Title VI Program plan and distribute internally and externally via website and update annually as required.
- · Ensure that Assurances are being used in contracts for federal projects.
- · Attend Title VI training.
- · Collect public involvement data.
- · Review written Title VI complaints and ensure every effort is made to resolve complaints informally at the local or regional level and review and update the City's Title VI plan and procedures as required.
- · Implement a plan that provides training to City Staff on the basic requirements of the Title VI implementation plan.

Title VI Coordinator:	
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Fonda Williams Deputy Mayor 218 Cleveland Avenue, S.W., 8th floor Canton, Ohio 44702 Phone – 330-438-4302

Email - fonda.williams@cantonohio.gov

V. LIMITED ENGLISH PROFICIENCY (LEP) POLICY

On August 11, 2000, the President signed an executive order, *Executive Order 13166: Improving Access to Service for Persons with Limited English Proficiency (LEP)*, to clarify Title VI of the Civil Rights Act of 1964. It has as its purpose, to ensure meaningful access to programs and services to otherwise eligible persons who are not proficient in the English language. In addition, The US Department of Transportation published *Policy Guidance Concerning Recipients' responsibilities to Limited English Proficient Person* in the December 14, 2005 Federal Register.

This guidance outlines the following four factors that the City uses to access the LEP populations in Canton.

- 1. The number and proportion of LEP persons eligible to be served or likely to be encountered by the City.
- 2. The frequency with which LEP individuals come into contact with the program, activity or service
- 3. The nature and importance of the program, activity, or service provided by the program.
- 4. The resources available to the City and costs.

Summary of the four factor analysis

<u>Factor 1</u>- The number and proportion of LEP persons eligible to be served or likely to be encountered by the City can only be estimated until the actual number of persons who can speak English less than "very well" are documented as needing assistance by City Staff. With this Title VI Plan being in early development stages and considered a document that may need regular updates, US Census Bureau information is being used at this time. The total population is provided below to shown general distribution of race and ethnicity in the community. The estimated number of persons that may not speak English "very well" is following in the US Census Bureau 2006-2010 American Community Survey.

The U.S. Census Bureau provides statistics from 2010 for the City of Canton as follows:

Total population = 74,451

Population by Ethnicity:

Hispanic or Latino = 1,805 Non Hispanic or Latino = 72,646

Population by Race:

White = 53,150 African American = 16,854, Asian = 193, American Indiana or Alaska Native = 372,

Native Hawaiian and Pacific Islander = 0, Other = 431, Identified by two or more = 3,451.

The US Census Bureau 2006-2010 American Community Survey 5-Year Estimates under SELECTED SOCIAL CHARACTERISTICS estimates the number of people in Canton who speak a language other than English to be 2,945 with those speaking English less than "very well" estimated at 1.0% or approximately 983 individuals who may be considered limited in English proficiency.

Factor 1(continued)-

According to the census numbers above there may be up to 983 individuals who live in the City of Canton that *may* be considered as LEP. Based on actual contact between City Staff and the community there have been very few requests from anyone in the service area asking the City to provide language translation services. Therefore, the LEP population is probably even less than the estimate shown above.

<u>Factor 2</u>- The frequency with which LEP individuals come into contact with the program, activity or service:

Due to the infrequent requests for translation services, there appears to be a minimal need for translation services from the City. This may be attributed to the high percentage of younger people (87.6% for ages up to 17) who are available as family members for translation services.

<u>Factor 3</u>. The nature and importance of the program, activity, or service provided by the program:

If at any time a LEP individual requests translation services that are considered important such that denial or delay of access or services or information could have serious or even lifethreatening implications, the City will provide, upon request, services to assist the LEP population including translation of vital City documents and interpretation services.

<u>Factor 4</u>. The resources available to the City and costs:

The City of Canton currently has several staff members who are bilingual in English and Spanish and are available to translate requests from the Hispanic population on a day to day basis. The City also provides many of their outreach services in the predominate languages of the community, English and Spanish. In addition, certified translation services are available through LanguageLine Solutions, a telephone translation service that is accessible for phone line translations services 24 hours a day. These are services the City provides upon request as discussed in factor 3 above. Page | 12

Summary of LEP Accommodation Plan

- · The City of Canton strives to serve its population to the best of its ability and will provide upon request, services to assist the LEP population including translation of vital documents and interpretation services deemed necessary to provide meaningful access to City services.
- · A U.S. Census Bureau ISpeak card is available as part of this document and on the City's webpage and is also available at City Hall located at 414 Main Street. This card allows LEP individuals to communicate their preferred language to City Staff whereas City Staff may then access a translation service called LanguageLine, phone number 1-800-752-6096 is available to City Staff or other translation services may be used as determined by the City.
- · For language translation requests from the Hispanic or Latino community the City has several staff member who are bilingual and are available to provide translation services on a day to day basis.
- · The City of Canton utilizes a voluntary public involvement survey to collect information regarding persons affected by proposed projects. The survey permits respondents to remain

anonymous, while voluntarily answering questions regarding their gender, ethnicity, race, age, sex, disability status, and household income. This voluntary public involvement survey is available at all public hearings and meetings. Once the survey data has been collected, it will be reviewed and then the survey will be placed in a file for future reference. In the case enough surveys are collected over time to show a significant increase in LEP populations, the City may consider changes to their LEP policy. Completed surveys shall be retained for a period of three years from the date of the meeting and/or completion of the related project, if applicable. See Appendix G for a sample of this Survey.

- · The City reviews written Title VI complaints and ensures every effort is made to resolve complaints informally at the local or regional level and review and update the City's TitleVI plan and procedures as required.
- · Staff for the City will be provided training on the requirements for providing meaningful access to services for LEP persons. Considering the relatively small size of the City of Canton and limited financial resources, current training may be limited to web access to this document and it's attachments by all City Staff, a log showing the names of all Staff that have been made aware of this document (sign off that they have read the document) and require that all new employees receive the same training.