



PROJECT NAME  
**FIRE STATION ADD/ALTER, B3321**

PROJECT NO.  
**PROJECT NO. 1039839**

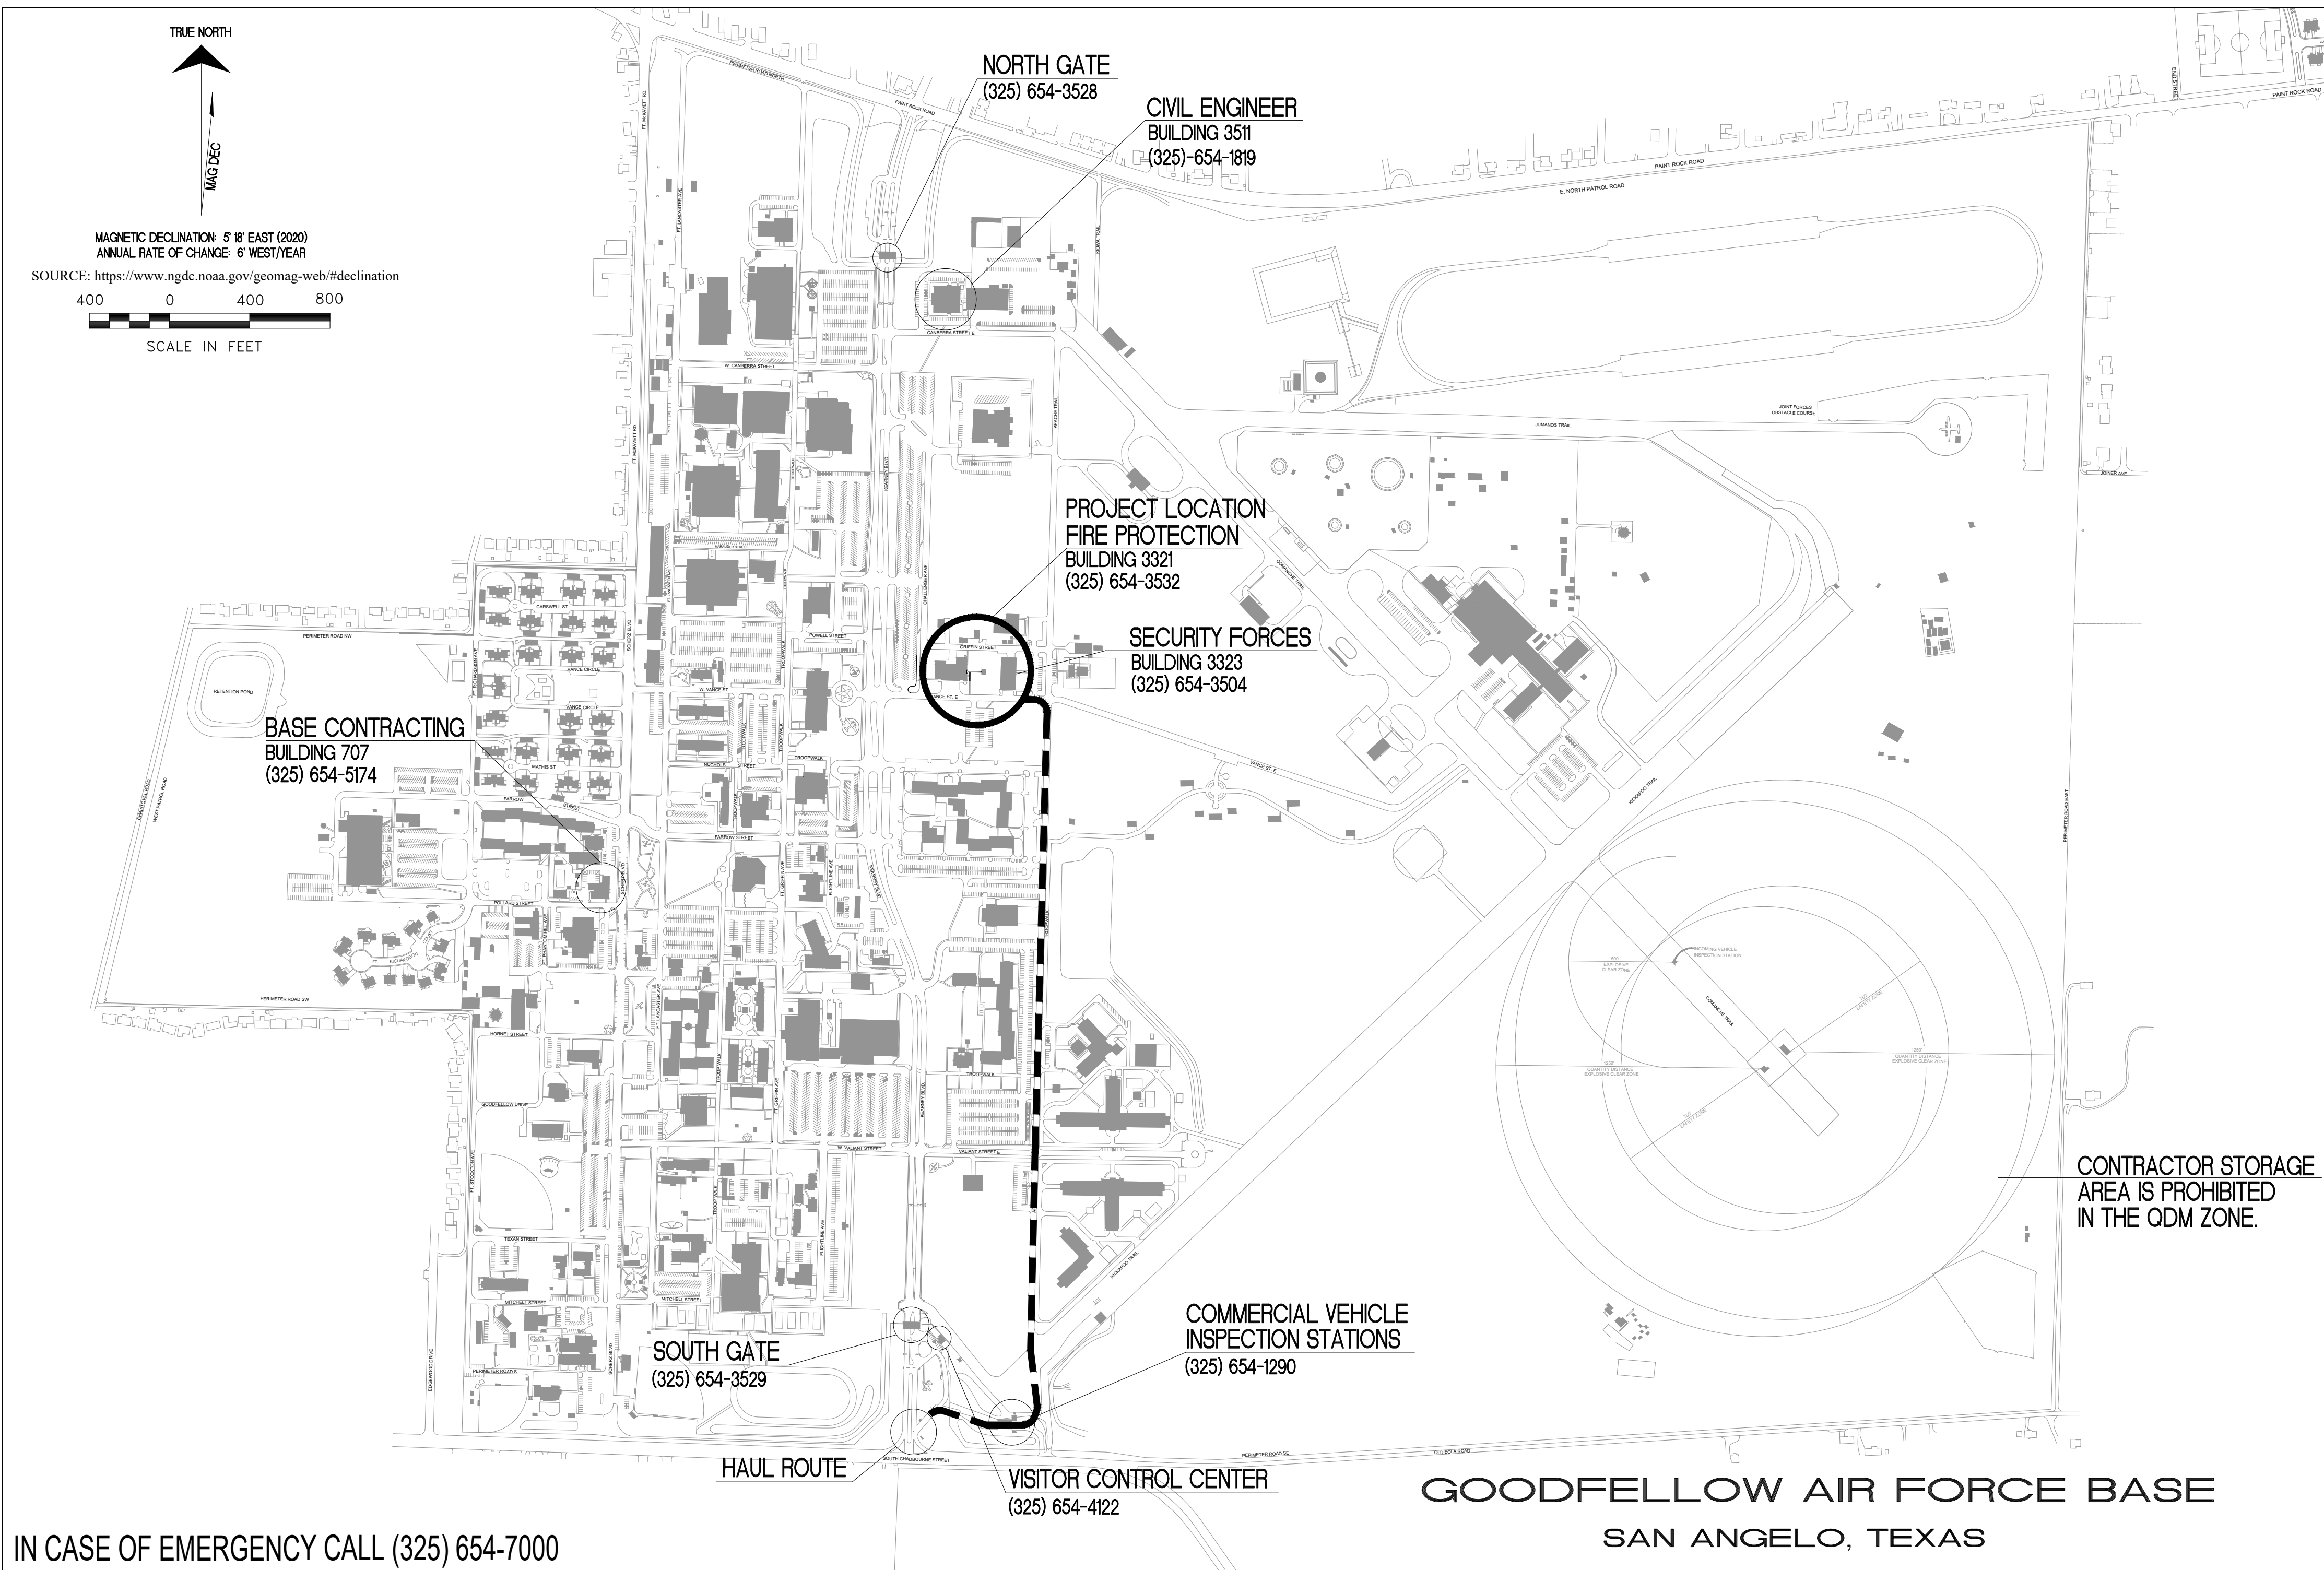


DATE	SIGNATURE
	RECOMMENDED (BCE)
	SUBMITTED (PROGRAMS CHIEF)
	FIRE CHIEF
	SAFETY
	ASSET MANAGEMENT
	BIO-ENVIRONMENTAL OFFICER
	SECURITY FORCES
	COMMUNICATIONS
	CHIEF OF OPERATIONS
	PROGRAM DEVELOPMENT
	PROGRAM MANAGEMENT
	PROJECT MANAGER
	USING AGENCY
	USING AGENCY

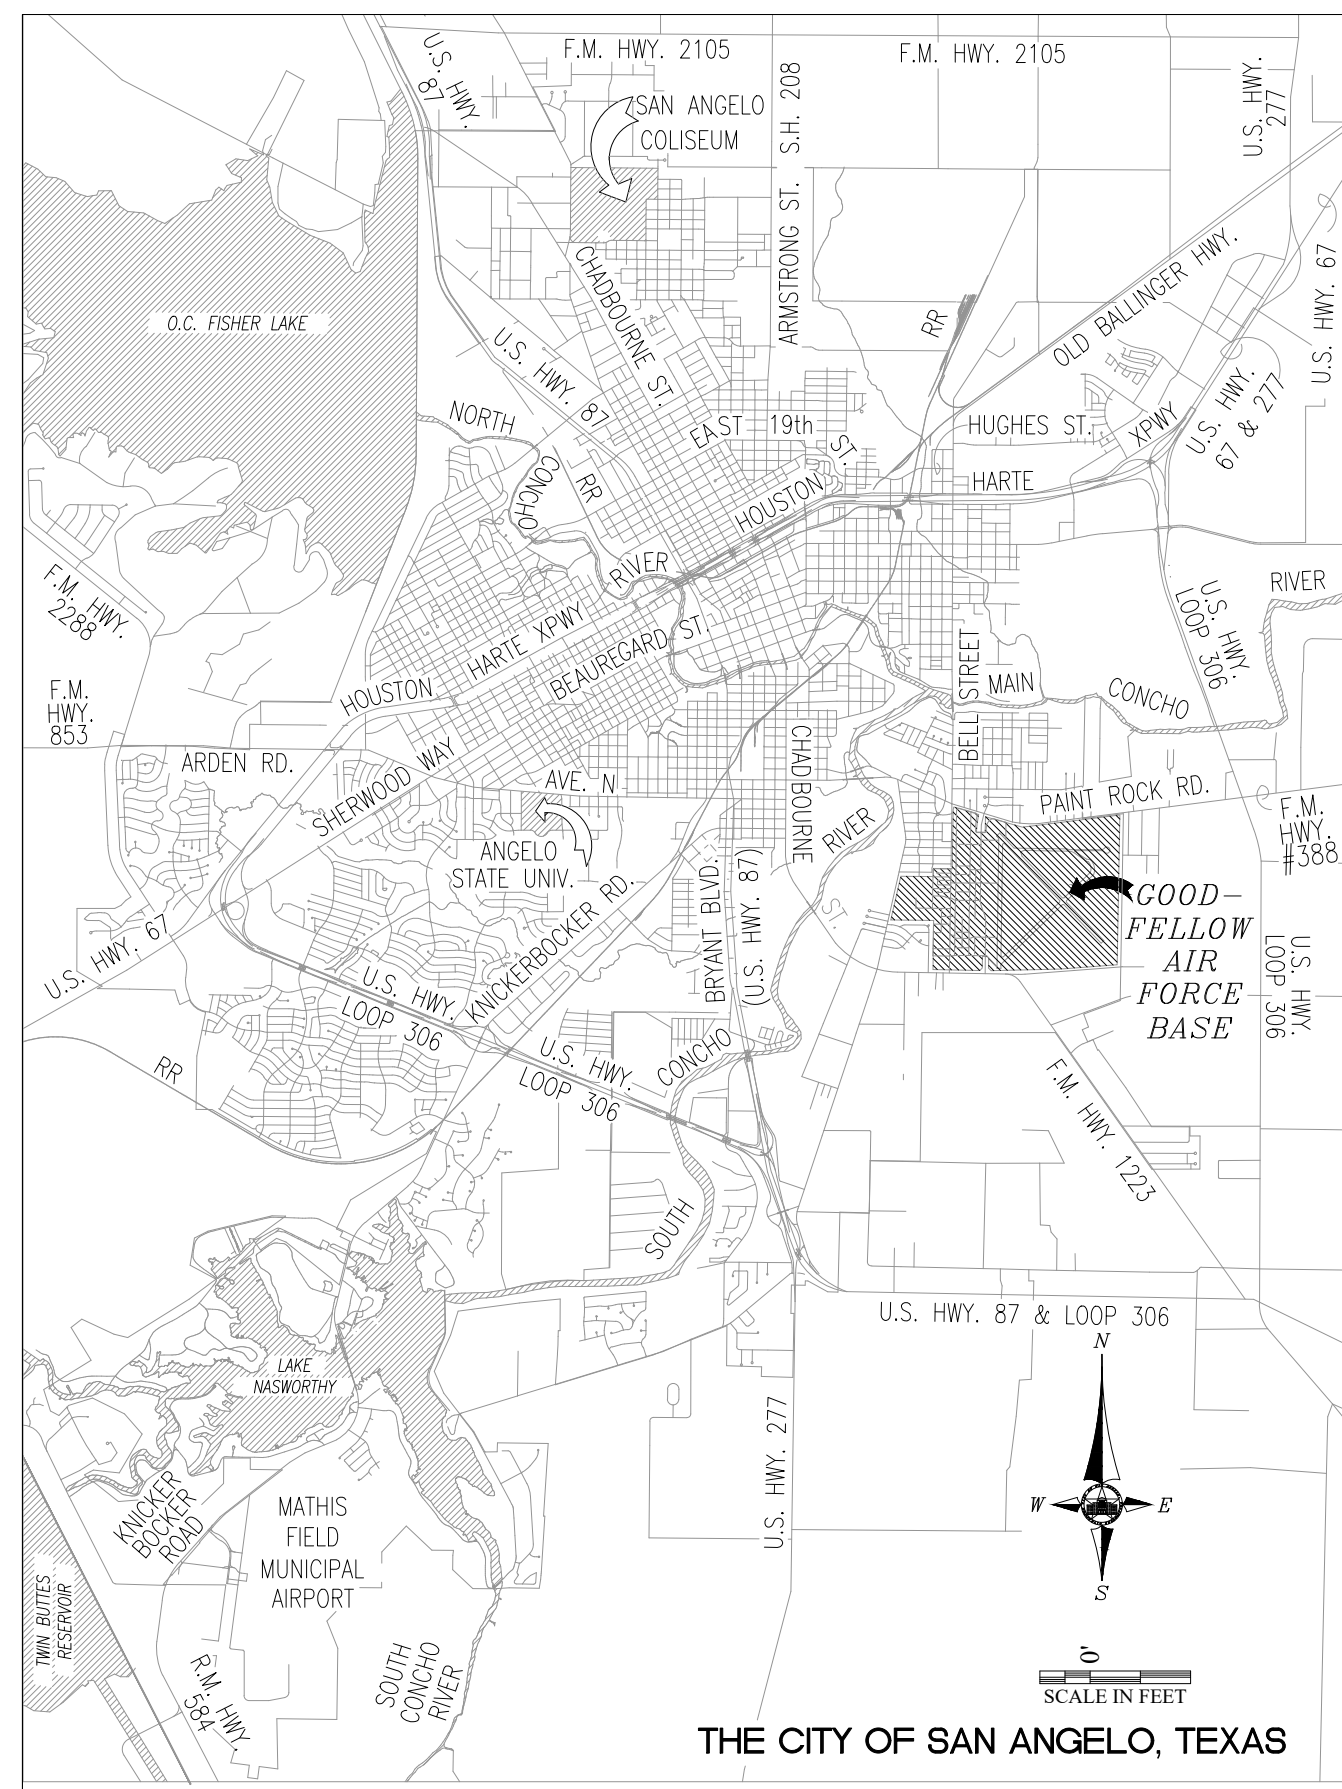

IN CASE OF EMERGENCY CALL (325) 654-7000

- GENERAL NOTES**
- PROSPECTIVE OFFERERS SHALL ONLY CONTACT THE TEXAS GRANT ADMINISTRATOR/PROJECT MANAGER, TOM GREEN COUNTY, 113 WEST BEAUREGARD AVE. SAN ANGELO, TX, 76903, (325)-657-8060 FOR ANY AND ALL INFORMATION WITH REGARDS TO THIS SOLICITATION.
  - ALL WORK SHALL BE NEW, UNUSED, AND OF INDUSTRY-WIDE QUALITY OR AS INDICATED HEREIN, WHICHEVER IS OF THE HIGHEST QUALITY. THE CONTRACTOR SHALL BE RESPONSIBLE FOR FIELD VERIFYING ALL EXISTING DIMENSIONS, CONDITION, AND EQUIPMENT PRIOR TO START OF WORK.
  - THE CONTRACTOR SHALL INITIATE AND PROCESS FOR APPROVAL AF FORM #103 "WORK CLEARANCE REQUEST" FOR THE CONTRACTING OFFICER PRIOR TO PERFORMANCE OF ON-SITE WORK.
  - LOCATIONS OF EXISTING UTILITIES ARE APPROXIMATE. THE CONTRACTOR SHALL FIELD VERIFY EXACT LOCATIONS PRIOR TO EXCAVATION OR TRENCHING. IT SHALL BE THE RESPONSIBILITY OF THE CONTRACTOR TO LOCATE SERVICE LINES AS REQUIRED FOR CONSTRUCTION FOR THIS PROJECT.
  - THE CONTRACTOR SHALL HAND DIG WITHIN (2) FEET EITHER SIDE OF UTILITY CROSSING UNTIL THE UTILITY IS PHYSICALLY EXPOSED, PRIOR TO PERFORMING MECHANICAL TRENCHING OR EXCAVATING. CONTRACTOR SHALL PROVIDE NEW TOPSOIL AND HYDROMULCHING IN ALL AREAS WHERE DISTURBED OR DAMAGED BY CONSTRUCTION ACTIVITIES.
  - PROSPECTIVE OFFERERS ARE HIGHLY ENCOURAGED TO ATTEND THE SCHEDULED PRE-PROPOSAL SITE VISIT TO THOROUGHLY FAMILIARIZE THEMSELVES WITH ANY AND ALL EXISTING SITE AND PROJECT LOCATION CONDITIONS WHICH MAY AFFECT THE WORK UNDER THIS CONTRACT. THE GOVERNMENT SHALL NOT BE RESPONSIBLE FOR CONTRACTOR ERRORS OR OMISSIONS WHICH COULD BE MADE KNOWN BY ATTENDING A SCHEDULED SITE VISIT.
  - THE CONTRACTOR SHALL COORDINATE ALL COMMUNICATIONS WORK WITH THE ENGINEERING SECTION MANAGER AT FRONTIER COMMUNICATIONS AT 1-800-921-8102; WITH THE INSTALLATION OFFICE, SUDENLINK CABLE AT 1-877-794-2724 AND THE GOODFELLOW AFB COMMUNICATIONS SQUADRON AT 325-654-3010.
  - THE CONTRACTOR SHALL INITIATE AND PROCESS FOR APPROVAL AF FORM #103 "WORK CLEARANCE REQUEST" TO THE GOODFELLOW AFB ASSIGNED PROJECT MANAGER PRIOR TO PERFORMANCE OF ON-SITE WORK. SITE UTILITIES THAT ARE LOCATED AND MARKED BY THE GOVERNMENT SHALL BE MAINTAINED BY THE CONTRACTOR.

- PROJECT NOTES**
- THE CONTRACTOR SHALL MAINTAIN A CONSTRUCTION SITE NEAT AND CLEAN OF DEBRIS AS DIRECTED BY THE CONTRACTING OFFICER. THE CONTRACTOR'S WASTE DUMPSTERS SHALL BE EMPTIED ON A REGULAR BASIS. ROADWAYS SHALL BE CLEAR OF DIRT AND DEBRIS. THE CONTRACTOR SHALL WATER-DOWN AREA FOR DUST CONTROL.
  - THE CONTRACTOR SHALL PROVIDE AND MAINTAIN SILT FENCING AROUND THE LIMITS OF CONSTRUCTION SITE. SILT FENCING SHALL ALSO BE PROVIDED AROUND AREA STORM DRAINAGE SURFACE INLETS. AT THE POST CONSTRUCTION PHASE, THE CONTRACTOR SHALL BE RESPONSIBLE FOR THE REMOVAL OF ALL MATERIALS RELATED TO THE PROJECT SILT FENCING TO INCLUDE ACCUMULATED DEBRIS. THE CONTRACTOR SHALL BE RESPONSIBLE FOR BRINGING THE AREA AROUND ALL SILT FENCING BACK TO THEIR ORIGINAL CONDITION PRIOR TO THE INSTALLATION OF SAID FENCING AND PROJECT CONSTRUCTION. THE CONTRACTOR SHALL MAINTAIN RECORDS OF THE ORIGINAL CONDITION OF THE SITE. SUCH RECORDS SHALL BE IN THE FORM OF COLOR PHOTOGRAPHS THAT SHALL BE KEPT ON FILE AS WELL AS TRANSMITTED TO THE GOVERNMENT FOR SAFE KEEPING.
  - THE CONTRACTOR SHALL INSTALL AND MAINTAIN A 6'-0" TALL TEMPORARY CONSTRUCTION CHAIN-LINK FENCE AROUND THE LIMITS OF WORK, NOT INCLUDING THE CONSTRUCTION ACCESS ROAD. COORDINATE CHAINS AND PADLOCKS ON GATES WITH GOODFELLOW FIRE DEPARTMENT. EACH GATE SHALL BE NUMBERED FOR EMERGENCY ACCESS AND SHALL HAVE INGRESS/EGRESS SIGNAGE AND AREA LIGHTING. THE CONTRACTOR SHALL MAINTAIN FIRE ACCESS THROUGH EACH INDIVIDUAL CONSTRUCTION SITE AT ALL TIMES.
  - TRUCK WASHOUT AREA SHALL BE CONSTRUCTED, MAINTAINED, AND CLEANED IN ACCORDANCE WITH TCEQ REGULATIONS. PROVIDE DETAILS AND MAINTENANCE PLAN AS PART OF THE STORMWATER POLLUTION PREVENTION PLAN. STORMWATER PERMITS SHALL BE REQUIRED PRIOR TO THE START OF CONSTRUCTION.
  - ALL CONTRACTORS SHALL STOCKPILE REQUIRED MATERIALS AND EQUIPMENT WITHIN THE LIMITS OF RESPECTIVE PROJECT AREAS OR STAGING AREA AS INDICATED ON THE DRAWINGS.
  - ALL HAUL ROADS SHALL BE MAINTAINED SUCH THAT UNOBSTRUCTED ACCESS SHALL BE PROVIDED AT ALL TIMES FROM THE ROAD TO THE STAGING AREA AND FROM THE STAGING AREA TO THE WORK SITE AND FACILITATE GOVERNMENT ACCESS TO THE BASE AT ALL TIMES. THE MAINTENANCE OF HAUL ROADS SHALL BE THE RESPONSIBILITY OF THE CONTRACTOR AT NO ADDITIONAL COST TO THE GOVERNMENT. THE HAUL ROAD LOCATIONS SHALL BE AS INDICATED ON THE STAGING/LAYDOWN AND ACCESS PLAN, OR BY THE CONTRACTING OFFICER.
  - THE CONTRACTOR SHALL COORDINATE ACTIVITIES THROUGHOUT THE PROJECT IN A MANNER THAT ALLOWS EMERGENCY ACCESS TO ALL EXISTING ROADWAYS AT ALL TIMES WITHOUT DELAYS TO EMERGENCY VEHICLES RESPONSE TIME.
  - WHILE WITHIN GOODFELLOW AFB, THE CONTRACTOR SHALL COMPLY WITH BASE REGULATIONS PERTAINING TO "NO FIREARMS" AND "NO ILLEGAL DRUGS."
  - ONLY RUBBER-TIRED VEHICLES SHALL BE ALLOWED ON EXISTING PAVEMENT THAT IS TO REMAIN IN PLACE.
  - ALL CONTRACTOR OPERATIONS SHALL BE CONDUCTED AND PERFORMED WITHIN ACCORDANCE OF DEPARTMENT OF LABOR OSHA REQUIREMENTS FOUND IN 29 CFR 1910.146 AND 1910.147 AND 29 CFR 1926, AND AIR FORCE OCCUPATIONAL SAFETY AND HEALTH [AFOSH] AND AIR FORCE INSTRUCTION [AFI] STANDARDS INCLUDING AFI 91-203, AIR FORCE CONSOLIDATED OCCUPATIONAL SAFETY INSTRUCTION. THE CONTRACTOR SHALL ALSO ENSURE THAT ALL WORK IS PERFORMED IN ACCORDANCE WITH PROJECT IDENTIFIED NATIONAL STANDARDS, MILITARY MANUALS, PAMPHLETS, INSTRUCTIONS, STANDARDS, HANDBOOKS AND WITH THE CORPS OF ENGINEERS [COE] SAFETY MANUAL 385-1-1 [EDITION IN EFFECT ON THE DATE OF THIS SOLICITATION]. ALL PROJECT SITES SHALL BE SUBJECT TO INSPECTION BY THE DEPARTMENT OF LABOR. IN THE EVENT OF CONFLICT BETWEEN THE OSHA STANDARDS AND THESE REQUIREMENTS, THE MOST STRINGENT SHALL APPLY.
  - AT ALL TIMES, THE CONTRACTOR SHALL MAINTAIN ONE FIRE LANE FREE OF OBSTRUCTION AND MAINTAIN ACCESS TO THE SITE AND ALL SURROUNDING ROADS AND STREETS.
  - GRASS AND WEEDY VEGETATION WITHIN THE AREAS UTILIZED BY THE CONTRACTOR, INCLUDING WORK AREAS, ADMINISTRATIVE AREAS AND STORAGE AREAS SHALL BE MOWED WHEN THE GRASS AND WEEDY VEGETATION IS AT A HEIGHT OF 6 INCHES, MOWING SHALL BE TO A HEIGHT OF 3 INCHES. MOWING SHALL BE ACCOMPLISHED WITH A ROTARY MOWER THAT LEAVES THE CLIPPINGS EVENLY DISTRIBUTED ON THE SOIL SURFACE. MOWING SHALL BE ACCOMPLISHED DURING PERIODS AND IN SUCH A MANNER THAT THE SOIL AND GRASS SHALL NOT BE DAMAGED. TOWED OR SELF-PROPELLED RIDING MOWERS SHALL NOT BE OPERATED WITHIN 3 FEET OF TREES OR SHRUBS. AREAS ADJACENT TO TREES AND SHRUBS SHALL BE MOWED WITH HAND-PROPELLED MOWERS.
  - EROSION CONTROL DEVICES SHALL BE USED FOR STAGING AREAS AND MATERIAL STOCKPILES WHEN NECESSARY TO CONTROL EROSION AND STORMWATER RUNOFF IN ACCORDANCE WITH FEDERAL, STATE AND LOCAL REGULATIONS. A SWPPP SHALL BE SUBMITTED PRIOR TO MOBILIZING.

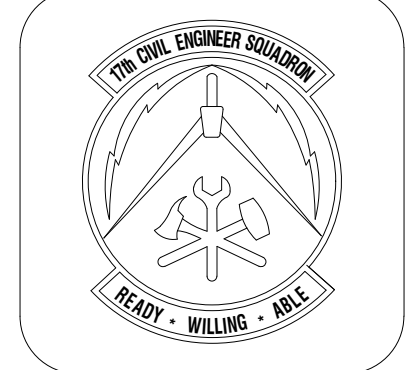

DATE	REVISIONS

Designed by  
JH/RA/LLA

Drawn by  
JH/RA/LLA

Reviewed by  
RT/JH

Submitted by  
PCES

**FIRE STATION ADD/ALTER, B3321**  
**PROJECT NO. 1039839**  
**17th TRAINING WING**  
**GOODFELLOW AIR FORCE BASE, TEXAS**

Project Number:  
1039839

SHEET TITLE  
COVER SHEET

Date:  
JAN 2024

SEQ. SHEET OF  
01 G-001 50

# TYPICAL ABBREVIATIONS [WHERE APPLICABLE]

ACCORD.	ACCORDANCE	DEMO	DEMOLITION
ACOUS. INSUL.	ACOUSTIC INSULATION	DET	DETAIL
ADDTN.	ADDITION	DIM	DIMENSION
ADJ.	ADJUSTABLE	DIST	DISTANCE
AFF	ABOVE FINISH FLOOR	DWG	DRAWING
ALUM.	ALUMINUM	EA	EACH
ATTEN.	ATTENUATING	ELEC	ELECTRIC(AL)
BITUM	BITUMINOUS	E.W.C.	ELECTRIC WATER COOLER
BLK	BLOCK	EXIST.	EXISTING
BLKG	BLOCKING	EXP. JT.	EXPANSION JOINT
BM	BENCH MARK	EQ	EQUAL
BOT	BOTTOM	E.W.	EACH WAY
CAB	CABINET	EXT.	EXTERIOR
CEM. BD.	CEMENTITIOUS BOARD	EXT. CAB.	EXTINGUISHER CABINET
CER TILE	CERAMIC TILE	F.D.	FLOOR DRAIN
CLG	CEILING	FEC	FIRE EXTINGUISHER CABINET
CONC.	CONCRETE	FIN	FINISH
CMU	CONC. MASONRY UNIT	FIN FLR	FINISH FLOOR
COL.	COLUMN	FLOUR.	FLOURESCENT
CONF.	CONFERENCE	FLR.	FLOOR
CONT.	CONTINUOUS	FLR. E.J.	FLOOR EXPANSION JOINT
COORD	COORDINATE	FURR'G	FURRING
CORR	CORRIDOR	GA.	GAUGE

GALV	GALVANIZED	PLY'WD	PLYWOOD
GFE	GOVERNMENT FURNISH EQUIPMENT	PLBG.	PLUMBING
GYP BD.	GYP SUM BOARD	PROJ. MNT.	PROJECTOR MOUNT
H.C.	HANDICAPPED	PROT.	PROTECTION
HDWD.	HARDWOOD	PSI	POUNDS PER SQUARE INCH
H.M.	HOLLOW METAL	RCP	REFLECTED CLG. PLAN
HORIZ.	HORIZONTAL	REF.	REFERENCE
INSUL	INSULATION	RESIL.	RESILIENT
LAV	LAVATORY	RM.	ROOM
MAINT	MAINTENANCE	SCHED.	SCHEDULE
MAX.	MAXIMUM	SCTN.	SECTION
MECH.	MECHANICAL	SCW	SOLID CORE WOOD
MFR.	MANUFACTURER	SPEC.	SPECIFICATION
MIN.	MINIMUM	S.S.	STAINLESS STEEL
MISC.	MISCELLANEOUS	STL.	STEEL
MPE	MECHANICAL-PLUMBING-ELECTRICAL	STRUCT.	STRUCTURE
MTD.	MOUNTED	SUSP. GRID	ELECTRICAL
MTL.	METAL	CLG. SYS.	SUSPENDED GRID CEILING SYSTEM
O.C.	ON CENTER	THK.	THICK
O.C.E.W.	ON CENTER EACH WAY	TYP.	TYPICAL
OPNG.	OPENING	TYP. MRKR./	TYPICAL MARKER/TACK
ORIG. BLDG.	ORIGINAL BUILDING	TACK BD.	BOARD
P	PLATE	UNC.	UNCASED

U.S.G.	UNITED STATES GYPSUM
V.C.T.	VINYL COMPOSITION TILE
VERT.	VERTICAL
V.W.C.	VINYL WALL COVERING
WD.	WOOD
WDW.	WINDOW
W/	WITH
W/MFR'S	WITH MANUFACTURER'S
W.W.F.	WELDED WIRE FABRIC
∅	DIAMETER

DRAWING INDEX	
Sheet Number	Sheet Title
<b>GENERAL</b>	
G-001	COVER SHEET
G-002	GENERAL INFORMATION 1
G-003	GENERAL INFORMATION 2
G-004	BID SCHEDULE
<b>LIFE SAFETY</b>	
LS-101	LIFE SAFETY PLAN
<b>STRUCTURAL</b>	
S-001	STRUCTURAL NOTES, SYMBOLS, & ABBREVIATIONS
S-101	FOUNDATION & FRAMING PLAN
S-501	DETAILS
S-502	DETAILS
<b>CIVIL</b>	
C-001	CIVIL SYMBOLS NOTES & ABBREVIATIONS
CU-101	EXISTING SITE UTILITIES
CG-101	SITE CONTOURS
CD-101	SITE DEMO
C-101	SITE NEW
C-501	SITE DETAILS
C-502	SITE DETAILS
<b>ARCHITECTURAL</b>	
AD-101	DEMO PLAN
A-101	FLOORPLAN NEW - OVERALL FLOORPLAN
A-102	FLOORPLAN NEW - NEW ADDITION
A-103	FLOORPLAN NEW - BID OPTIONS
A-201	REFLECTED CEILING PLAN
A-301	ROOF PLAN
A-401	BUILDING SECTIONS
A-501	EXTERIOR ELEVATIONS
A-601	ENLARGED PLANS
A-701	INTERIOR ELEVATIONS
A-801	FINISHES AND SCHEDULES
A-802	DOORS, WINDOWS, AND PARTITION TYPES
A-901	WALL SECTIONS AND DETAILS
A-1001	DETAILS
<b>MECHANICAL</b>	
M-001	MECHANICAL SYMBOLS NOTES & ABBREVIATIONS
MD-101	HVAC DEMO - BID OPTIONS
M-101	HVAC PLAN - NEW ADDITION
M-102	HVAC PLAN - BID OPTIONS
M-501	HVAC DETAILS
M-601	HVAC SCHEDULES
M-701	HVAC CONTROLS
<b>ELECTRICAL</b>	
E-001	ELECTRICAL SYMBOLS NOTES & ABBREVIATIONS
ED-101	ELECTRICAL DEMOLITION PLAN
E-101	ELECTRICAL POWER SUPPLY
E-201	LIGHTING PLAN
E-301	POWER PLAN
E-401	PA SYSTEM PLAN
E-601	EXISTING FIRE STATION PANELS
<b>PLUMBING</b>	
P-001	PLUMBING NOTES SYMBOLS & ABBREVIATIONS
P-101	SANITARY SEWER PLAN
P-102	DOMESTIC WATER PLAN
P-501	PLUMBING DETAILS 1
P-601	PLUMBING SCHEDULES
<b>FIRE ALARM</b>	
FA-001	FIRE PROTECTION PLAN, NOTES, & SYMBOLS

### PRIVATIZED ELECTRICAL UTILITY SYSTEMS:

AEP TEXAS NORTH COMPANY IS THE UTILITY OWNER AND SOLE PROVIDER OF THE ELECTRICAL PRIMARY DISTRIBUTION UTILITY SYSTEM AT GOODFELLOW AIR FORCE BASE, TEXAS.

NEWLY PROVIDED SYSTEM INFRASTRUCTURE AND/OR MODIFICATIONS OF OR CONNECTIONS TO THE EXISTING SYSTEM INFRASTRUCTURE IDENTIFIED IN THE SPECIFICATIONS AND/OR DRAWINGS MUST BE COORDINATED WITH THE UTILITY OWNER PRIOR TO THE CONTRACT START DATE. TO CONNECT FACILITIES, THE CONSTRUCTION CONTRACTOR SHALL REQUEST THAT THE UTILITY OWNER PROVIDE THE REQUIRED CONNECTING FACILITIES, UP TO A POINT OF DEMARCATION WHICH INCLUDES ALL TERMINATIONS AT THE TRANSFORMER.

ALL WORK ON THE SYSTEM OR FACILITIES EXPECTED TO CONNECT TO THE SYSTEM SHALL COMPLY WITH THE UTILITY OWNER'S SPECIFICATIONS AND CONSTRUCTION STANDARDS. IN NO EVENT SHALL THE CONSTRUCTION CONTRACTOR CONNECT TO, OR OTHERWISE TOUCH THE UTILITY OWNER'S INFRASTRUCTURE WITHOUT THE UTILITY OWNER'S EXPRESS WRITTEN PERMISSION.

THE UTILITY OWNER: CONTACT VIA:  
 AEP TEXAS NORTH COMPANY  
 930 West 19th Street  
 San Angelo, Texas 76903  
 PHONE: 325-657-2800

### ARCHITECT / ENGINEER RESPONSIBILITIES:

- SITE PLAN WITH ADJACENT STREETS OR LANDMARKS IDENTIFIED.
- BUILDING PLAN SHEETS WITH THE FOLLOWING INFORMATION:
  - LOCATION OF SERVICE ENTRANCE
  - REQUESTED TRANSFORMER LOCATION, IF A PREFERENCE IS KNOWN.
  - SQUARE FOOTAGE OF BUILDING SPACE WITH THE TYPE OF LOAD TO BE SERVED.
  - ELECTRICAL PANEL SCHEDULE
  - NUMBER AND SIZE OF SECONDARY CONDUCTORS TO BE TERMINATED AT THE TRANSFORMER
  - PROPOSED LOCATION OF OTHER UTILITY ROUTES AND ENTRANCES.
- LOAD DEMAND INFORMATION FROM EXISTING SIMILAR BUILDINGS.
- SCHEDULE OF WORK.

### CONTRACTOR / BUILDER RESPONSIBILITIES:


- CONTACT NAMES AND NUMBERS UPON ARRIVAL AT THE SITE.
- LOCATION OF TRANSFORMER PAD.
- INSTALL SECONDARY CONDUITS INTO THE APPROPRIATE WELL LOCATION BEFORE PAD INSTALLATION. THIS INCLUDES ANY REQUIRED METERING CABLE CONDUITS.
- PROVIDE FINAL GRADE IN TRANSFORMER PAD AREA PRIOR TO PAD CONSTRUCTION.
- INSTALLATION OF ANY REQUIRED INSTRUMENT RATED METERING EQUIPMENT.
- PROVIDE SECONDARY CABLE TERMINALS.
- PRIMARY CONDUIT DITCH COMPACTION IF REQUIRED.
- ASPHALT AND/OR CONCRETE CUT AND REPAIR IF REQUIRED.
- LOCATION OF OTHER UTILITY LINES INSTALLED DURING THIS CONSTRUCTION.
- TEMPORARY POWER POLE, IF REQUIRED. LOCATION TO BE APPROVED BY AEP TEXAS. NOTE: ANY LINE EXTENSION REQUIRED FOR THE PURPOSE OF TEMPORARY SERVICE WILL REQUIRE A CIAC TO COVER THE COST OF INSTALLATION AND REMOVAL OF TEMPORARY FACILITIES AND ANY MATERIAL WHICH CANNOT BE REUSED.

### AEP TEXAS RESPONSIBILITIES:

- SIZING AND INSTALLATION OF ALL PRIMARY CONDUCTORS INCLUDING DITCH AND CONDUIT.
- SIZING AND INSTALLATION OF DISTRIBUTION TRANSFORMERS.
- CONSTRUCTION OF TRANSFORMER PAD.
- INSTALLATION OF SECONDARY CABLE TERMINALS.

### CONSTRUCTION NOTES:

- THE EDGE OF THE TRANSFORMER PAD SHALL NOT BE CLOSER THAN TWO FEET FROM A WALL, OR FIVE FEET FROM A DOOR OR WINDOW, OR TWENTY FEET FROM A STAIRWELL OR FIRE ESCAPE.
- TRANSFORMERS SHALL NOT BE COMPLETELY ENCLOSED BY WALLS, FENCES, OR LANDSCAPING WITHOUT VENTILATION WHICH IS APPROVED BY AEP TEXAS. THE ENTIRE WIDTH OF THE FRONT OF THE TRANSFORMER AND SECONDARY CABINET SHALL BE ACCESSIBLE. IF A FENCE IS INSTALLED, IT WILL HAVE SUFFICIENT GATES NECESSARY TO PROVIDE THIS ACCESS.
- TRANSFORMERS WILL BE LOCATED IN THE AREAS WITH ALL WEATHER ACCESS BY SERVICE TRUCKS. IN ADDITION, THERE WILL BE NO STRUCTURES CONSTRUCTED ABOVE TRANSFORMERS WHICH WOULD INHIBIT CRANE OPERATIONS.
- NO OTHER UTILITY LINES WILL BE INSTALLED WITHIN TWO FEET OF THE TRANSFORMER PAD.
- NO CUSTOMER EQUIPMENT, EXCEPT INSTRUMENT RATED METERING EQUIPMENT WHICH IS PLACED ON THE SECONDARY BUSHINGS, SHALL BE ATTACHED TO AEP TEXAS TRANSFORMERS; NOR WILL THERE BE ANY HOLES DRILLED INTO THE TRANSFORMER CABINET FOR CONDUITS, CONDUCTORS OR METERS.
- THE NUMBER AND SIZE OF THE SECONDARY CONDUCTORS WHICH ARE ALLOWED TO BE ATTACHED TO THE TRANSFORMER SECONDARY BUSHINGS WILL BE CONTROLLED BY AEP TEXAS. IF THE DESIGN REQUIRES MORE OR LARGER CONDUCTORS THAN ALLOWED FOR A PARTICULAR TRANSFORMER SIZE, AEP TEXAS WILL INSTALL A SECONDARY CABINET WITH BUS BARS ADJACENT TO THE TRANSFORMER. AEP TEXAS WILL SUPPLY AND INSTALL THE SECONDARY CONDUCTORS FROM THE TRANSFORMER TO THE SECONDARY CABINET. THE POINT OF INTERCONNECTION WILL BE THE BUS BARS WITHIN THE SECONDARY CABINET. THIS CABINET WILL REQUIRE A LARGER TRANSFORMER PAD.
- TRANSFORMERS LARGER THAN 1000 KVA WILL REQUIRE A LARGER PAD.
- TEMPORARY CONSTRUCTION POWER WILL BE SUPPLIED TO CUSTOMER SUPPLIED POWER POLES LOCATED WITHIN FIVE FEET OF AN EXISTING PAD MOUNTED TRANSFORMER OR WITHIN FIFTY FEET OF A PRIMARY POWER POLE.


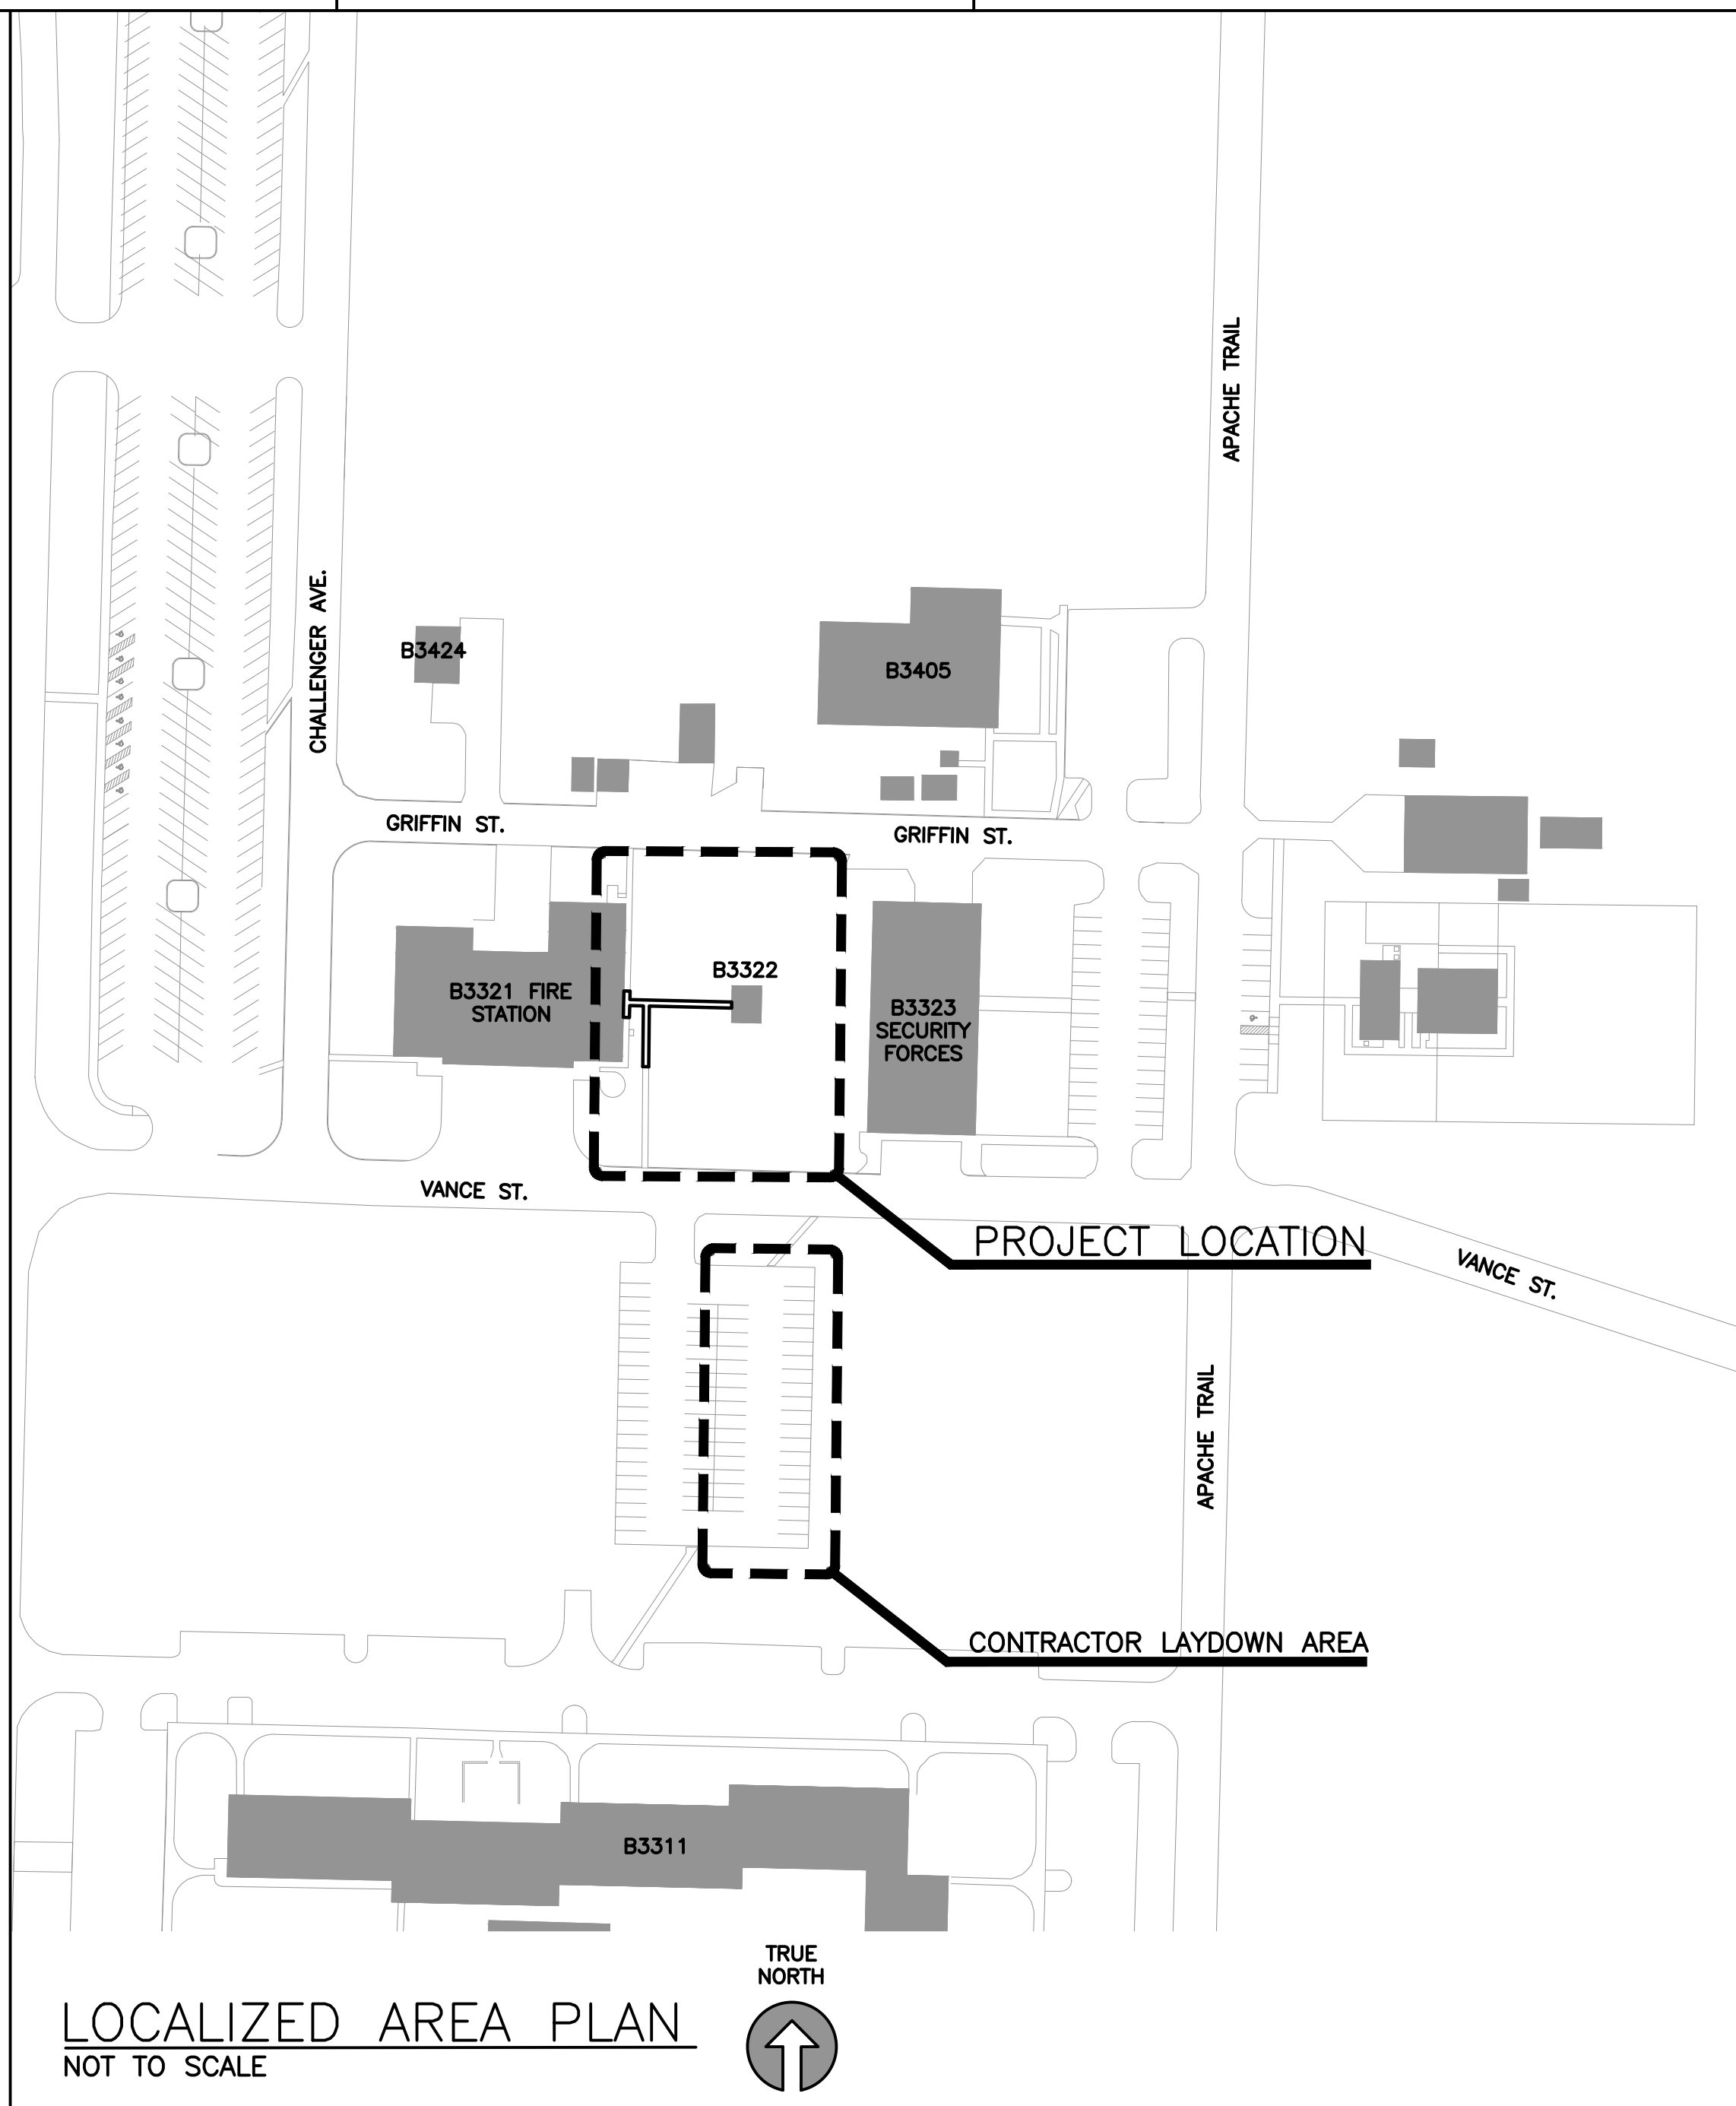


### LOCALIZED AREA PLAN

NOT TO SCALE



LEGEND:

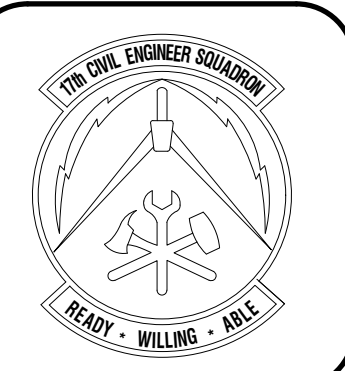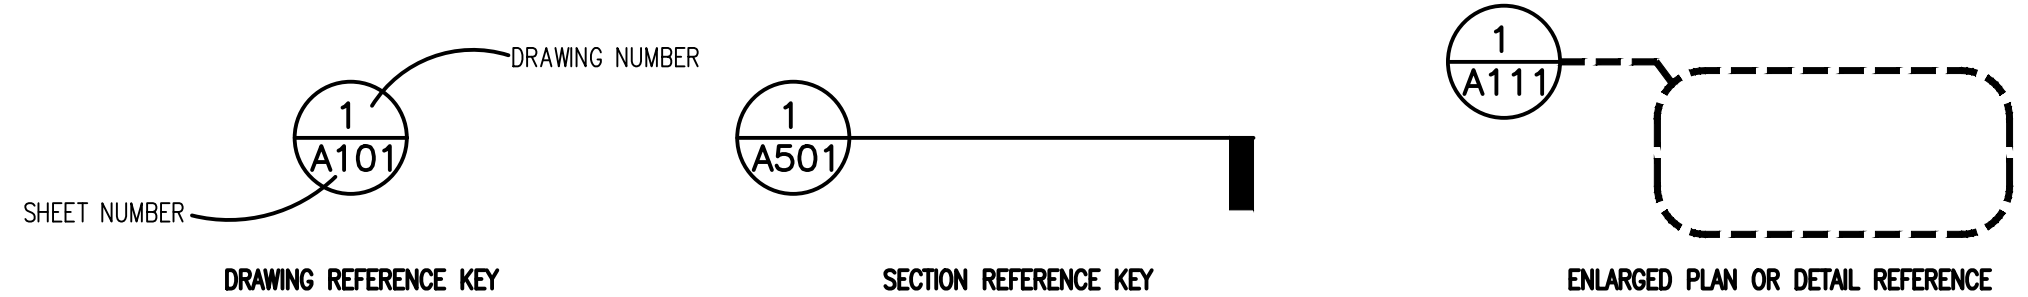

DATE	
REVISIONS	

Designed by	JR/MLA
Drawn by	JR/MLA
Reviewed by	RT/JAH
Submitted by	PC/ES

PROJECT TITLE  
**FIRE STATION ADD/ALTER, B3321**  
**PROJECT NO. 1039839**  
**17th TRAINING WING**  
**GOODFELLOW AIR FORCE BASE, TEXAS**

Project Number:	1039839
SHEET TITLE	GENERAL INFORMATION 1
Date:	JAN 2024

SEQ.	SHEET	OF
02	<b>G-002</b>	50



**A. GENERAL NOTES**

- CONSTRUCTION ACCESS TO THE SITE SHALL BE THROUGH THE EXISTING SOUTH GATE LOCATED ON SOUTH CHADBOURNE STREET. ALL CONSTRUCTION TRAFFIC ENTERING THE BASE IS REQUIRED TO PASS THROUGH THE COMMERCIAL VEHICLE SEARCH AREA LOCATED TO THE EAST OF KEARNEY BOULEVARD. HOURS OF OPERATION ARE FROM 6:00 A.M. TO 2:00 P.M. MONDAY THROUGH FRIDAY, PHONE 325-654-1290.
- CONTRACTORS SHALL KEEP ALL PUBLIC ROADS AND STREETS CLEAN OF CONSTRUCTION DEBRIS, MUD, ETC. AT ALL TIMES. CONTRACTOR SHALL PROVIDE EQUIPMENT AND PERSONNEL TO CLEAN ANY STREETS AS REQUESTED BY THE CONTRACTING OFFICER. THE CONTRACTOR IS RESPONSIBLE FOR ALL REPAIRS TO STREETS, PARKING AREAS AND BASE OR GOVERNMENT PROPERTY DAMAGED FROM THEIR CONSTRUCTION ACTIVITIES.
- CONTRACTORS SHALL MAINTAIN A CONSTRUCTION SITE NEAT AND CLEAN OF DEBRIS AS DIRECTED BY CONTRACTING OFFICER. CONTRACTOR WASTE DUMPSTERS SHALL BE EMPTIED ON A REGULAR BASIS.
- THE CONTRACTOR AND CONTRACTOR PERSONNEL WILL NOT BE REQUIRED TO PARTICIPATE IN BASEWIDE ACTIVE SHOOTER DRILLS, EMERGENCY RESPONSE DRILLS, AND OTHER INCIDENT RESPONSE DRILLS. THE GOVERNMENT WILL COORDINATE THE OCCURRENCE OF THESE DRILLS WITH THE CONTRACTOR IN THE EVENT THAT DRILLS WILL AFFECT CONTRACTOR ACCESS TO GOODFELLOW AFB.

**B. STAGING NOTES**

- CONTRACTOR SHALL PROVIDE AND MAINTAIN A TEMPORARY CONSTRUCTION CHAIN LINK FENCE, 6 FEET HIGH, AROUND THE LIMITS OF WORK NOT INCLUDING THE CONSTRUCTION ACCESS ROAD, COORDINATE CHAIN AND PADLOCKS ON GATES WITH GOODFELLOW FIRE DEPARTMENT. EACH GATE SHALL BE NUMBERED FOR EMERGENCY ACCESS, SHALL HAVE ENTRY/EGRESS SIGNAGE AND AREA LIGHTING. CONTRACTORS SHALL MAINTAIN FIRE ACCESS THROUGH EACH INDIVIDUAL CONSTRUCTION SITE AT ALL TIMES.
- TRUCK WASHOUT AREA SHALL BE CONSTRUCTED, MAINTAINED AND CLEANED IN ACCORDANCE WITH TCEQ REGULATIONS. PROVIDE DETAILS AND MAINTENANCE PLAN AS PART OF THE STORMWATER POLLUTION PREVENTION PLAN. STORMWATER PERMITS ARE REQUIRED PRIOR TO THE START OF CONSTRUCTION.
- ALL CONTRACTORS SHALL STOCKPILE REQUIRED MATERIALS AND EQUIPMENT WITHIN LIMITS OF RESPECTIVE PROJECT AREAS OR STAGING AREA AS INDICATED ON THE DRAWINGS.
- CONTRACTOR SHALL CONNECT TO EXISTING OR NEW FIRE HYDRANTS FOR TEMPORARY CONSTRUCTION WATER. INSTALL QUICK DISCONNECT, BACK FLOW PREVENTER AND SHUT-OFF VALVE ON 2 1/2" HOSE CONNECTION ONLY. PRIOR TO MAKING ANY CONNECTIONS TO BASE WATER SYSTEMS, THE CONTRACTOR MUST NOTIFY AND COORDINATE WITH 17CES. A FIRE PLUG USAGE PERMIT IS REQUIRED AND USAGE SHALL BE METERED AT ALL TIMES.
- ALL TEMPORARY ELECTRIC POWER FACILITIES SHALL MEET OR EXCEED NESC AND NEC REQUIREMENTS AS APPLICABLE FOR PRIMARY AND SECONDARY FACILITIES.

**C. ACCESS AND VEHICLE PARKING**

- ACCESS TO THE PROJECT FOR ALL CONSTRUCTION PERSONNEL, VEHICLES AND EQUIPMENT IS ILLUSTRATED ON THE LOCALIZED AREA PLAN SHOWN ON SHEET G-002. ACCESS ROUTES MAY BE SUBJECT TO CHANGE BASED ON OPERATIONAL REQUIREMENTS. POTENTIAL SCHEDULE IMPACTS SHALL BE COORDINATED WITH 17CES.
- LOCATION OF ACCESS/ HAUL ROADS ARE AS INDICATED ON G-001 AND G-002.
- ALL HAUL ROADS SHALL BE MAINTAINED SUCH THAT UNOBSTRUCTED ACCESS WILL BE PROVIDED AT ALL TIMES FROM THE ROAD TO THE STAGING AREA AND FROM THE STAGING AREA TO THE WORK SITE AND FACILITATE GOVERNMENT ACCESS TO THE BASE AT ALL TIMES. THE MAINTENANCE OF HAUL ROADS SHALL BE THE RESPONSIBILITY OF THE CONTRACTOR AT NO ADDITIONAL COST TO THE GOVERNMENT. THE HAUL ROAD LOCATIONS SHALL BE AS INDICATED ON G-000 AND G-001.
- CONTRACTOR SHALL COORDINATE ACTIVITIES THROUGHOUT THE PROJECT IN A MANNER THAT ALLOWS EMERGENCY ACCESS TO ALL EXISTING ROADWAYS AT ALL TIMES WITHOUT DELAYS TO EMERGENCY VEHICLES RESPONSE TIME.
- ALL CONTRACTOR VEHICLES AND PERSONNEL MAY BE SEARCHED BY SECURITY FORCES WHEN ENTERING THE BASE AND MAY EXPERIENCE DELAYS. ALL PERSONNEL ENTERING GOODFELLOW A.F.B. MUST HAVE A VALID PHOTO ID PER BASE SECURITY REQUIREMENTS. ALL VEHICLES ENTERING THE BASE MUST HAVE CURRENT/ VALID REGISTRATION, CURRENT/ VALID INSURANCE AND CURRENT/ VALID DRIVERS LICENSE FOR THE OPERATOR. ALL DRIVERS MUST COMPLY WITH ALL GOODFELLOW AFB DRIVING REQUIREMENTS (SPEED LIMITS, SEATBELTS, ETC.) PERSONNEL ATTEMPTING TO GAIN ACCESS TO GOODFELLOW AFB NOT IN COMPLIANCE WITH BASE SECURITY REQUIREMENTS MAY BE REJECTED ACCESS TO THE BASE..
- WHEN NOT ENGAGED IN CONSTRUCTION ACTIVITIES, THE CONTRACTOR'S CONSTRUCTION EQUIPMENT AND VEHICLES SHALL BE PARKED WITHIN THE WORK AREA OR STAGING AREA.

**D. COORDINATION AND COMMUNICATION DURING CONSTRUCTION**

- PRIOR TO CONSTRUCTION, THE CONTRACTOR SHALL CORDON OFF THE WORK AREAS AND STREET CROSSINGS BY USING APPROVED BARRICADES.

**E. TRAFFIC CONTROL**

- ONLY RUBBER-TIRED VEHICLES SHALL BE ALLOWED ON EXISTING PAVEMENT THAT IS TO REMAIN.
- ANY DAMAGE TO ROADS AND PAVEMENT DUE TO CONSTRUCTION EQUIPMENT, CONSTRUCTION TRAFFIC OR CONSTRUCTION ACTIVITY SHALL BE REPAIRED TO THEIR ORIGINAL CONDITION BY THE CONTRACTOR AT HIS/ HER OWN EXPENSE.

**F. EQUIPMENT AND STOCKPILE HEIGHT**

- STOCKPILE ALL CONSTRUCTION MATERIALS WITHIN STAGING AREA. MAXIMUM HEIGHT 15.00' WITH 5:1 SIDE SLOPES. PROVIDE EROSION CONTROL PROTECTION AROUND THE STOCKPILE LIMITS. ANY MATERIALS THAT ARE TO BE STOCKPILED FOR USE FOR OTHER PROJECTS ON THE BASE SHALL BE COORDINATED WITH 17CES. ALL MATERIAL NOT REQUIRED SHALL BE HAULED OFF GOVERNMENT PROPERTY.

**G. EXCAVATION AND TRENCHES**

- OPEN TRENCHES AND EXCAVATIONS AT THE CONSTRUCTION SITE SHALL BE PROMINENTLY MARKED WITH ORANGE AND WHITE TYPE III BARRICADES AND WITH FLASHING TYPE A-LOW INTENSITY WARNING LIGHTS FROM DUSK TILL DAWN.

**H. OTHER SAFETY REQUIREMENTS**

- CONTRACTOR SHALL MAINTAIN SAFETY PRACTICES THAT CONFORM TO OCCUPATIONAL SAFETY AND HEALTH ADMINISTRATION (OSHA) REGULATIONS.
- CONTRACTOR SHALL MAINTAIN AT ALL TIMES ONE FIRE LANE FREE FROM OBSTRUCTION AND MAINTAIN ACCESS TO THE SITE AND ALL SURROUNDING ROADS AND STREETS.

**I. CONTRACTOR SAFETY PLAN SUBMITTALS**

- CONTRACTOR SHALL FURNISH A CONSTRUCTION SAFETY PLAN IN ACCORDANCE WITH THE SPECIFICATIONS WITH THE PROJECT SCHEDULE. THE SAFETY PLAN SHALL IDENTIFY THE FOLLOWING ITEMS:
  - PROPOSED ACCESS POINTS, STAGING AREA AND HAUL ROUTES.
  - TEMPORARY MARKINGS TO BE USED, IF ANY.
  - LOCATIONS AND TYPE OF BARRICADES OR OTHER TRAFFIC CONTROL DEVICES.
  - METHODS BY WHICH THE CONTRACTOR WILL COMMUNICATE WITH 17CES.

**J. MAINTENANCE OF STORAGE AREA**


- THE CONTRACTOR SHALL AT ALL TIMES KEEP THE CONSTRUCTION SITE, CONSTRUCTION TRAILER(S)/BUILDING(S), AND STORAGE AREA(S) IN A CLEAN, NEAT, WORKMAN LIKE CONDITION, FREE FROM ACCUMULATION OF WASTE, RUBBISH, WEEDS, OVERGROWN GRASS, OR CONSTRUCTION DEBRIS, TO THE SATISFACTION OF THE CONTRACTING OFFICER. ALL LOOSE OR LIGHT WEIGHT MATERIALS SHALL BE SECURED TO PREVENT BLOWING OR SCATTERING. THE BURNING OF TRASH OR CONSTRUCTION DEBRIS IS STRICTLY PROHIBITED ON GOODFELLOW AFB. PRIOR TO FINAL INSPECTION, THE CONTRACTOR SHALL REMOVE ALL CONSTRUCTION DEBRIS, TOOLS, EQUIPMENT, AND MATERIALS NOT THE PROPERTY OF THE GOVERNMENT. UPON COMPLETION OF THE WORK, THE CONTRACTOR SHALL LEAVE THE WORK SITE AND STORAGE AREA(S) IN A CLEAN, NEAT, AND WORKMANLIKE CONDITION SATISFACTORY TO THE CONTRACTING OFFICER. REFER TO STATEMENT OF WORK.
- THE CONTRACTOR SHALL KEEP FENCING IN A STATE OF GOOD REPAIR AND PROPER ALIGNMENT. GRASSED OR UNPAVED AREAS, WHICH ARE NOT ESTABLISHED ROADWAYS, WILL BE COVERED WITH A LAYER OF GRAVEL AS NECESSARY TO PREVENT RUTTING AND THE TRACKING OF MUD ONTO PAVED OR ESTABLISHED ROADWAYS. SHOULD THE CONTRACTOR ELECT TO TRAVERSE THEM WITH CONSTRUCTION EQUIPMENT OR OTHER VEHICLES; GRAVEL GRADATION WILL BE AT THE CONTRACTOR'S DISCRETION. MOW AND MAINTAIN GRASS LOCATED WITHIN THE BOUNDARIES OF THE CONSTRUCTION SITE FOR THE DURATION OF THE PROJECT. GRASS AND VEGETATION ALONG FENCES, BUILDINGS, UNDER TRAILERS, AND IN AREAS NOT ACCESSIBLE TO MOWERS WILL BE EDGED OR TRIMMED NEATLY.
- GRASS AND WEEDY VEGETATION WITHIN THE AREAS UTILIZED BY THE CONTRACTOR, INCLUDING WORK AREAS, ADMINISTRATIVE AREAS, AND STORAGE AREAS, SHALL BE KEPT MOWED TO CONTROL VEGETATIVE GROWTH. VEGETATION SHALL BE MOWED WHEN IT REACHES A HEIGHT OF 6 INCHES. MOWING SHALL BE TO A HEIGHT OF 3 INCHES. MOWING SHALL BE ACCOMPLISHED WITH A ROTARY MOWER THAT LEAVES THE CLIPPINGS EVENLY DISTRIBUTED ON THE SOIL SURFACE. MOWING SHALL BE ACCOMPLISHED DURING PERIODS AND IN SUCH MANNER THAT THE SOIL AND GRASS WILL NOT BE DAMAGED. TOWED OR SELF-PROPELLED RIDING MOWERS SHALL NOT BE OPERATED WITHIN 3 FEET OF TREES OR SHRUBS. AREAS ADJACENT TO TREES AND SHRUBS SHALL BE MOWED WITH HAND-PROPELLED MOWERS.
- EROSION CONTROL DEVICES SHALL BE USED FOR THE STAGING AREA AND ANY MATERIAL STOCK PILES WHEN NECESSARY TO CONTROL EROSION AND STORM WATER RUNOFF IN ACCORDANCE WITH FEDERAL, STATE, AND LOCAL REGULATIONS.
- AREAS NOT MOWED: GOVERNMENT MAY IMMEDIATELY AFTER NOTICE TO THE CONTRACTOR AND AT THE DISCRETION OF THE CONTRACTING OFFICER MOW THE CONTRACTOR'S AREAS AT ANY TIME THE VEGETATION HEIGHT EXCEEDS 6 INCHES.

**K. WATERING**

- THE CONTRACTOR SHALL COMPLY WITH THE CURRENT CITY OF SAN ANGELO, TEXAS WATER CONSERVATION AND DROUGHT CONTINGENCY PLAN FOR ALL ON BASE WATER USAGE.

**PROJECT NOTES**

- THESE PROJECT NOTES SHALL APPLY THROUGHOUT THE CONTENTS OF THESE CONSTRUCTION DOCUMENTS AND ALL WORK FOR THIS PROJECT.
- THE CONTRACTOR SHALL VERIFY ALL EXISTING AND NEW DIMENSIONS AND CONDITIONS PRIOR TO COMMENCEMENT OF ANY AND ALL WORK FOR THIS PROJECT.
- THE CONTRACTOR SHALL PROVIDE ALL MATERIALS, LABOR, TOOLS, EQUIPMENT, AND ASSOCIATED WORK REQUIRED TO COMPLETELY EXECUTE THE PROJECT.
- THE CONTRACTOR SHALL PROVIDE ALL WORK COMPLETE, IN TEH QUICKEST TIME PRACTICAL, AND IN A NEAT WORKMANLIKE MANNER.
- THE CONTRACTOR SHALL PROVIDE ITEMS OF WORK NOT SPECIFICALLY INDICATED, BUT OBVIOUSLY AND/OR NORMALLY REQUIRED TO COMPLETELY AND PROPERLY EXECUTE THE WORK.
- THE CONTRACTOR SHALL COMPLY WITH ALL LAWS GOVERNING SAFETY, SPECIFICALLY THE "OCCUPATIONAL SAFETY AND HEALTH" STANDARDS (OSHA)
- THE CONTRACTOR SHALL COMPLY WITH REQUIREMENTS OF THE FEDERAL "AMERICANS WITH DISABILITIES ACT" AND THE "TEXAS ACCESSIBILITIES STANDARDS/TEXAS "ELIMINATIONS OF ARCHITECTURAL BARRIERS ACT" [LATEST EDITIONS]
- THE CONTRACTOR SHALL BE RESPONSIBLE FOR PROTECTION OF THE EXISTING ON-SITE BUILDINGS AND OTHER INSTALLATIONS THAT ARE TO REMAIN INTACT DURING AND AFTER WORK FOR THIS PROJECT.
- THE CONTRACTOR SHALL TAKE ALL MEASURES NECESSARY TO PROTECT THE PROJECT DURING CONSTRUCTION, INCLUDING BUT NOT LIMITED TO, BRACING AND SHORING OF DEAD LOADS, CONSTRUCTION LOADS, AND WIND LOADS.
- THE CONTRACTOR SHALL PROVIDE AND MAINTAIN FIRE EXTINGUISHERS ON SITE DURING CONSTRUCTION FOR THIS PROJECT.
- THE CONTRACTOR SHALL PROVIDE AND MAINTAIN A CLEAN, SECURE, WEATHERTIGHT, TEMPORARY FIELD OFFICE WITH ALL REQUIRED SERVICES DURING THE COURSE OF THE PROJECT. THE FIELD OFFICE SHALL BE A PORTABLE FACILITY PLACED ON SITE AT A LOCATION MUTUALLY AGREEABLE TO BOTH CONTRACTOR AND CONTRACTING OFFICER OR CONTRACTING OFFICER REPRESENTATIVE.
- THE CONTRACTOR SHALL MAINTAIN A COMPLETE, CURRENT SET OF THE CONSTRUCTION DOCUMENTS AND DAILY PROJECT LOG IN THE FIELD OFFICE AT ALL TIMES. DAILY REPORTS INDICATING NUMBER OF EMPLOYEES WORKING, WORK PERFORMED, EQUIPMENT USED, AND PROGRESS PICTURES SHALL BE SUBMITTED VIA EMAIL TO THE CONTRACTING OFFICER OR CONTRACTING OFFICER REPRESENTATIVE ON A WEEKLY OR DAILY BASIS UNTIL PROJECT COMPLETION.
- THROUGHOUT THE ENTIRE COURSE OF THE WORK, THE CONTRACTOR SHALL MAINTAIN A QUALIFIED SUPERINTENDENT ON SITE AT ALL TIMES MONDAY-FRIDAY DURING DESIGNATED WORK TIMES. CONTRACTOR SHALL PROVIDE AN ASSIGNED ALTERNATE ON SITE SUPERINTENDENT DURING THE PRIMARY SUPERINTENDENTS ABSENCE. BOTH SHALL HAVE FULL AUTHORITY TO ACT ON BEHALF OF THE CONTRACTOR.
- THE CONTRACTOR SHALL COORDINATE ALL WORK FOR THIS PROJECT WITH WORK OF OTHER TRADES.
- THE CONTRACTOR SHALL PROVIDE AND PROPERLY MAINTAIN PORTABLE TOILET(S) ON SITE FOR USE BY CONTRACTOR EMPLOYEES OR SUBCONTRACTORS. USE OF EXISTING FIRE STATION RESTROOMS WILL NOT BE ALLOWED.
- THE CONTRACTOR SHALL BE RESPONSIBLE FOR THE REMOVAL OF ALL CONSTRUCTION DEBRIS FROM PROJECT SITE AND SHALL PROVIDE AND MAINTAIN DUMPSTERS, INCLUDING ALL ASSOCIATED DUMPING FEES, HAULING OF DEBRIS FROM SITE, AND REMOVAL FEES.
- THE CONTRACTOR SHALL KEEP THE PROJECT FACILITY AND SITE FREE OF ALL DEBRIS ON A DAILY BASIS AND PROVIDE FINAL CLEANUP IN ACCORDANCE WITH THE SPECIFICATIONS AND TO THE CONTRACTING OFFICER'S SATISFACTION.
- THE CONTRACTING OFFICER SHALL BE THE FINAL AUTHORITY IN MATTERS REGARDING INTERPRETATION OF THE INSTRUCTIONS AND INTENT OF THE CONSTRUCTION DOCUMENTS.
- IN THE EVENT OF DISCREPANCIES, SPECIFICATIONS SHALL TAKE PRECEDENT OVER THE DRAWINGS,
- UNLESS INDICATED OTHERWISE, ALL EXTERIOR AND INTERIOR FINISHES SHALL BE CODE COMPLIANT AND AS DIRECTED BY THE PROJECT MANAGER.
- THE CONTRACTOR SHALL PROVIDE THE CONTRACTING OFFICER OR CONTRACTING OFFICER REPRESENTATIVE WITH ALL MATERIAL AND/OR PRODUCT SAMPLES AND COLORS FOR PROPER SELECTION AND FINAL APPROVAL PRIOR TO INSTALLATION.
- THE CONTRACTOR SHALL PROVIDE SUBMITTALS FOR ALL PRODUCTS AND/OR MATERIALS LISTED IN THE SPECIFICATIONS FOR APPROVAL PRIOR TO INSTALLATION.
- ALL CHANGES, MODIFICATIONS, AND/OR ALTERATIONS TO THE WORK INCLUSIVE OF THESE CONTRACT DOCUMENTS SHALL REQUIRE THE STANDARD CHANGE ORDER PROCESS AND THE ISSUANCE OF A SIGNED CHANGE ORDER (AIA G701) PRIOR TO PERFORMANCE WORK FOR SAID CHANGES, MODIFICATIONS AND/OR ALTERATIONS.
- ALL PRODUCTS AND/OR MATERIALS SHALL NOT BE INSTALLED UNTIL APPROVED BY THE CONTRACTING OFFICER.
- ALL PRODUCTS AND/OR MATERIALS SHALL BE PROVIDED, STORED, AND INSTALLED PER THE RESPECTIVE MANUFACTURER'S RECOMMENDATIONS, MINIMUM.
- THE CONTRACTOR SHALL WARRANT ALL EQUIPMENT, MATERIALS, AND WORKMANSHIP FOR A PERIOD OF ONE (1) YEAR AFTER PROJECT COMPLETION. ANY MANUFACTURER AND/OR SPECIFIED WARRANTY THAT IS FOR PERIOD LONGER THAN THE ONE (1) YEAR WARRANTY SHALL BE SO WARRANTED.
- THE CONTRACTOR SHALL ENSURE THAT ALL EXTERIOR GRADES AT NEW CONSTRUCTION PROVIDE FOR POSITIVE DRAINAGE AWAY FROM THE BUILDING.
- ALL WELDERS SHALL BE CURRENTLY A.W.S. CERTIFIED AND WELDING SHALL COMPLY WITH CURRENT A.W.S. STANDARDS.
- GYPSUM WALL AND CEILING BOARDS SHALL BE TEXTURED ORANGE PEEL THROUGHOUT AND/OR WHERE REQUIRED.
- THE CONTRACTOR SHALL PROVIDE OWNER WITH A SINGLE "AS-BUILT" SET OF DRAWINGS COMPRISED OF RED-LINE MARKUPS OF ALL PROJECT ALTERATIONS AND/OR CHANGES.
- ALL COMPACTION FOR FILL SHALL BE 95% STANDARD PROCTOR DENSITY, MINIMUM.
- THE CONTRACTOR SHALL NOT SCALE DRAWINGS HEREIN.

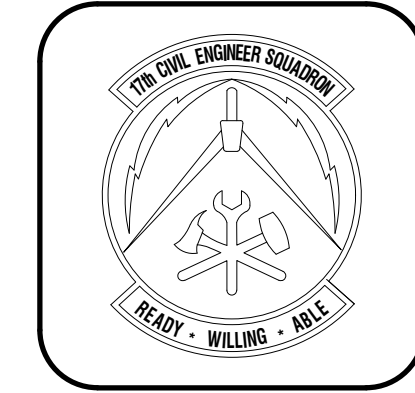


DATE				
REVISIONS				

Designed by JH/ML/A	Drawn by JH/ML/A	Reviewed by RT/JAH	Submitted by PCES
------------------------	---------------------	-----------------------	----------------------

PROJECT TITLE  
**FIRE STATION ADD/ALTER, B3321**  
**PROJECT NO. 1039839**  
**17th TRAINING WING**  
**GOODFELLOW AIR FORCE BASE, TEXAS**

Project Number: 1039839
SHEET TITLE GENERAL INFORMATION 2
Date: JAN 2024

SEQ.	SHEET	OF
03	<b>G-003</b>	50

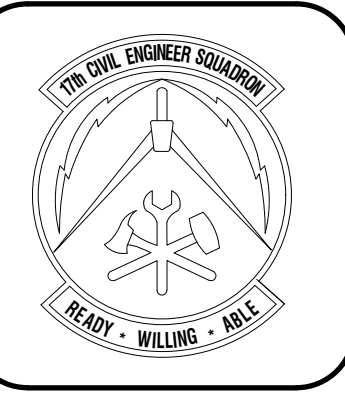


REVISIONS	DATE

Designed by JH/MLLA	Drawn by JH/MLLA	Reviewed by RT/JAH	Submitted by PC/BS
------------------------	---------------------	-----------------------	-----------------------


PROJECT TITLE  
**FIRE STATION ADD/ALTER, B3321**  
**PROJECT NO. 1039839**  
**17th TRAINING WING**  
**GOODFELLOW AIR FORCE BASE, TEXAS**

Project Number: 1039839
SHEET TITLE <b>BID SCHEDULE</b>
Date: JAN 2024

SEQ.	SHEET	OF
04	<b>G-004</b>	50

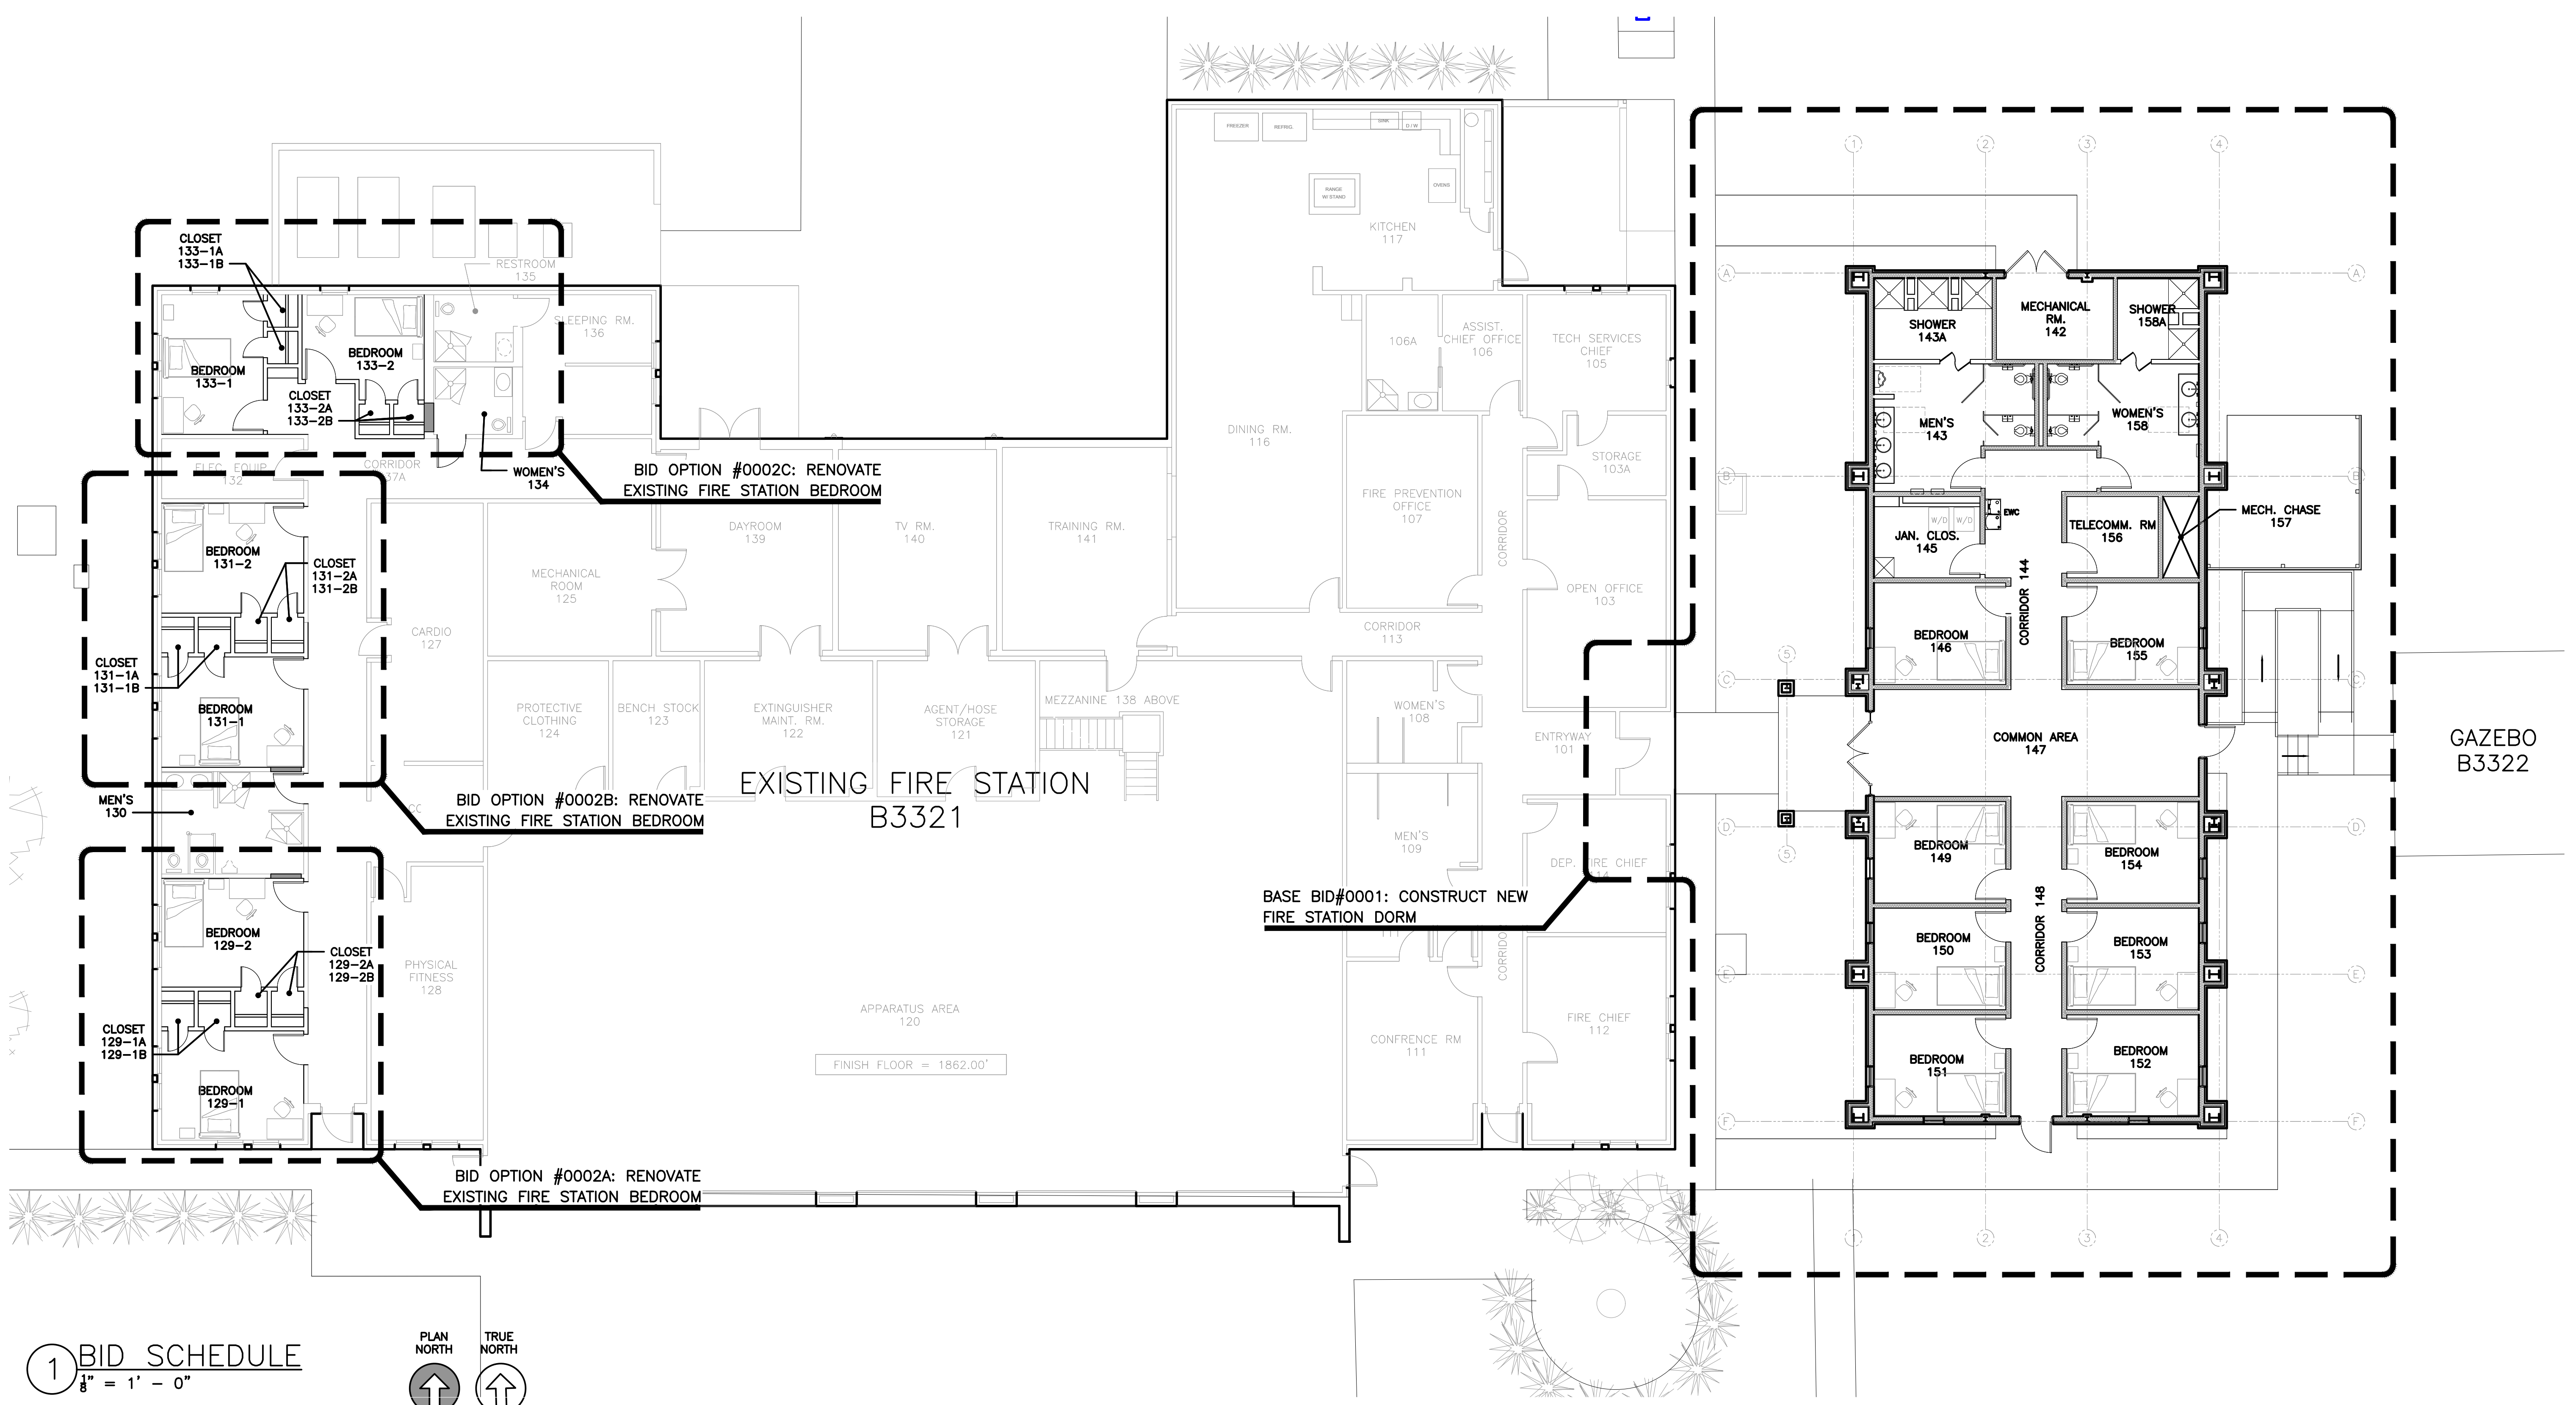

**1** BID SCHEDULE  
 $\frac{1}{8}'' = 1' - 0''$

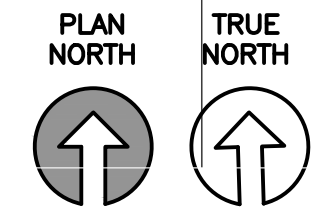

**BID SCHEDULE**

BASE BID #0001 - CONSTRUCT NEW FIRE STATION DORM:  
 CONSTRUCT NEW 8-BEDROOM DORMITORY COMPLETE WITH MEN/WOMEN'S RESTROOMS, TELECOMMUNICATIONS ROOM, JANITOR'S CLOSET, AND MECHANICAL ROOM.

BID OPTION #0002A/#0002B/#0002C - RENOVATE EXISTING FIRE STATION BEDROOMS:  
 DEMO EXISTING INTERIOR PARTITIONS, FIXTURES, HVAC AND FINISHES AND PROVIDE NEW.



**FIRE STATION ADD/ALTER, B3321**  
**LIFE SAFETY ANALYSIS**

**APPLICABLE CODES & STANDARDS**

**UNITED FACILITIES CRITERIA (UFC):**

- UFC 1-200-01 GENERAL BUILDING REQUIREMENTS (2023)
- UFC 3-580-01 TELECOMMUNICATIONS INTERIOR INFRASTRUCTURE PLANNING AND DESIGN (2016)
- UFC 3-600-01 FIRE PROTECTION ENGINEERING FOR FACILITIES (2021)
- UFC 4-730-10 FIRE STATIONS (2021)

**INTERNATIONAL BUILDING CODE IBC (2021)**

**INTERNATIONAL PLUMBING CODE IBC (2021)**

**NATIONAL FIRE PROTECTION ASSOCIATION (NFPA)**

- NFPA 10 STANDARD FOR PORTABLE EXTINGUISHERS
- NFPA 13 INSTALLATION OF SPRINKLER SYSTEMS
- NFPA 14 INSTALLATION OF STANDPIPE AND HOSE SYSTEMS
- NFPA 70 NATIONAL ELECTRIC CODE (NEC) (2020)
- NFPA 72 NATIONAL FIRE ALARM CODE (2019)
- NFPA 90A STANDARD FOR INSTALLATION OF AIR-CONDITIONING AND VENTILATION SYSTEMS (2018)
- NFPA 101 LIFE SAFETY CODE (2018)
- ARCHITECTURAL BARRIERS ACT (ABA) 2015

**IBC CHAPTER 3: OCCUPANCY TYPE**

OCCUPANCY TYPE: R-2 DORMITORIES  
OCCUPANCY CLASSIFICATION: RESIDENTIAL, CHAPTER 28: NEW HOTEL AND DORMITORIES

**IBC CHAPTER 5: ALLOWABLE HEIGHTS/AREAS**

ALLOWABLE BUILDING HEIGHT: PER TABLE 504.3

ALLOWED: 75' (SPRINKLERED)  
ACTUAL: 15'-7"

ALLOWABLE NUMBER OF STORIES: PER TABLE 504.4

ALLOWED: 5 STORIES  
ACTUAL: 1 STORY

ACTUAL BUILDING FOOTPRINT: 2,890 SQ.FT.

FIRE PROTECTION: FULLY SPRINKLERED IN ACCORDANCE WITH IBC 903.2.8

FIRE DETECTION: HEAT/SMOKE DETECTION, DUCT DETECTION, MANUAL PULL STATIONS, VISUAL STROBE AND AUDIBLE HORN ANNUNCIATION VIA ADDRESSABLE FIRE ALARM PANEL WITH POINT-TO-POINT DETECTION.

**IBC CHAPTER 6: CONSTRUCTION TYPE**







FIRE RESISTANCE REQUIREMENTS (TYPE 2B) CONSTRUCTION REQUIREMENTS: PER TABLE 601

- PRIMARY STRUCTURE: 0
- BEARING WALLS: 0
- NON BEARING WALLS: 0
- FLOOR CONSTRUCTION: 0
- ROOF CONSTRUCTION: 0

**IBC CHAPTER 7: FIRE AND SMOKE RESISTANT FEATURES**

- FIRE PROTECTION AREAS: (PER NFPA 28.3.2.2.2)
- BOILER AND FUEL FIRED HEATER ROOMS: 1 HOUR AND SPRINKLERS
- GUEST LAUNDRY: 1 HOUR OR SPRINKLERS
- STORAGE ROOMS: 1 HOUR OR SPRINKLERS
- FIRE BARRIERS (FB) - PER NFPA SEC. 8.3
- SMOKE PARTITIONS - PER NFPA SEC. 8.3

**LEGEND**

-  RESIDENTIAL OCCUPANCY (200 SQFT / OCC.)
-  STORAGE / MECH. ROOM OCCUPANCY (500 SQFT. / OCC.)
-  1/2 HOUR RATED FIRE PARTITION
-  1 HOUR RATED FIRE PARTITION
-  SMOKE PARTITION
-  RECESSED FIRE EXTINGUISHER AND CABINET PER NFPA 10. BRACKET AND CABINET SHALL ACCOMMODATE 10LB A/B/C CHEMICAL TYPES. CABINETS TO HAVE FLAT PARTIAL GLASS FRONT WITH HINGED LATCHING DOOR. MOUNT PER NFPA 10 REQ'S

**IBC CHAPTER 7 CONT'D:**

**OPENING PROTECTION**

- FIRE BARRIERS - PER NFPA SEC. 8.6
- SMOKE PARTITIONS - PER NFPA SEC 8.6
- PROTECTION OF VERTICAL OPENINGS PER NFPA 8.6

**DOOR RATINGS:**

1 HOUR FIRE BARRIERS: 45 MINUTE DOOR

SMOKE PARTITION: NO FIRE RATING REQUIRED

FIRE DOORS: PROVIDE SELF OR AUTOMATIC CLOSING FIRE DOORS WITH POSITIVE LATCHING HARDWARE PER NFPA 8.3.3.3

SMOKE PARTITIONS: PROVIDE SELF OR AUTOMATIC CLOSING FIRE DOORS WITH POSITIVE LATCHING HARDWARE. NO FIRE RATING REQUIRED. LOUVRES ARE NOT PERMITTED.

DOORS OPENING ONTO EXIT ACCESS CORRIDORS SHALL HAVE NOT LESS THAN 20-MINUTE FIRE PROTECTION RATING IN ACCORDANCE WITH NFPA 8.3 (PER NFPA 28.3.6.2)

DOORS THAT OPEN ONTO EXIST ACCESS CORRIDORS SHALL BE SELF-CLOSING AND SELF-LATCHING PER NFPA 28.3.6.2.3

**HVAC:**

FIRE DAMPERS SHALL BE PROVIDED IN ALL AIR TRANSFER OPENINGS IN PARTITIONS THAT ARE REQUIRED TO HAVE A FIRE RESISTANCE RATING.

**CORRIDORS:**

IN BUILDINGS PROTECTED BY AN APPROVED AUTOMATIC SPRINKLER SYSTEM, CORRIDORS SHALL HAVE 1/2 FIRE RESISTANCE RATING PER NFPA 28.3.6.1.3

**IBC CHAPTER 10: MEANS OF EGRESS**

**OCCUPANT LOAD FACTOR:**

ACCESSORY STORAGE AREAS, MECH. EQUIPMENT ROOMS: 500 (PER NFPA 101 TABLE 7.3.1.2)

280 SQFT. / (500) = .56 OCCUPANTS

DORMITORIES : 200 (PER NFPA 101 TABLE 7.3.1.2)

2400 SQFT. / (200) = 12 OCCUPANTS

**CALCULATED OCCUPANT LOAD: 12.56 (13) \* .2 OCC.**

EGRESS WIDTH REQUIREMENTS: 2.5"

ACTUAL PROVIDED: 144"

**NUMBER OF EGRESS EXITS (NOT INCLUDING PRIMARY/SECONDARY MEANS OF ESCAPE REQUIRED BY NFPA 28.2.1.2)**

MINIMUM NUMBER OF EXITS: 2

ACTUAL EXITS PROVIDED: 3

**MAXIMUM TRAVEL DISTANCES TO EXITS (PER NFPA 28.2.6)**

GUEST ROOM TO CORRIDOR DOOR MAXIMUM: 125' (NFPA 28.2.6.2)

CORRIDOR DOOR TO EXIT: 200' (NFPA 28.2.6.3.2)

**MAXIMUM COMMON TRAVEL PATHS (PER NFPA 28.2.5.4): 50'**

DEAD END CORRIDOR MAX (PER NFPA 28.2.5.6): 50'

**IBC CHAPTER 29: PLUMBING SYSTEMS**

**RESIDENTIAL OCCUPANCY: DORMITORIES**

13 OCC 7 MALE / 6 FEMALE

WATER CLOSETS: 1 PER 10 (.7 MALE AND .6 FEMALE)

LAVATORIES: 1 PER 10 (.7 MALE AND .6 FEMALE)

SHOWERS: 1 PER 8 (.8 MALE AND .7 FEMALE)

DRINKING FOUNTAIN: 1 PER 100 (.13 REQ'D)

1 SERVICE SINK

**TOTAL FIXTURE REQUIREMENTS**

**MALE:**

WATER CLOSETS: .7 REQ'D / 2 PROVIDED (+ 1 URINAL)

LAVATORIES: .7 REQ'D / 3 PROVIDED

SHOWERS: .8 REQ'D / 3 PROVIDED

**FEMALE:**


WATER CLOSETS: .6 REQ'D / 2 PROVIDED

LAVATORIES: .6 REQ'D / 2 PROVIDED



SHOWERS: .7 REQ'D / 2 PROVIDED

DRINKING FOUNTAIN: .13 REQ'D / 2 PROVIDED

SERVICE SINK: 1 REQ'D / 1 PROVIDED

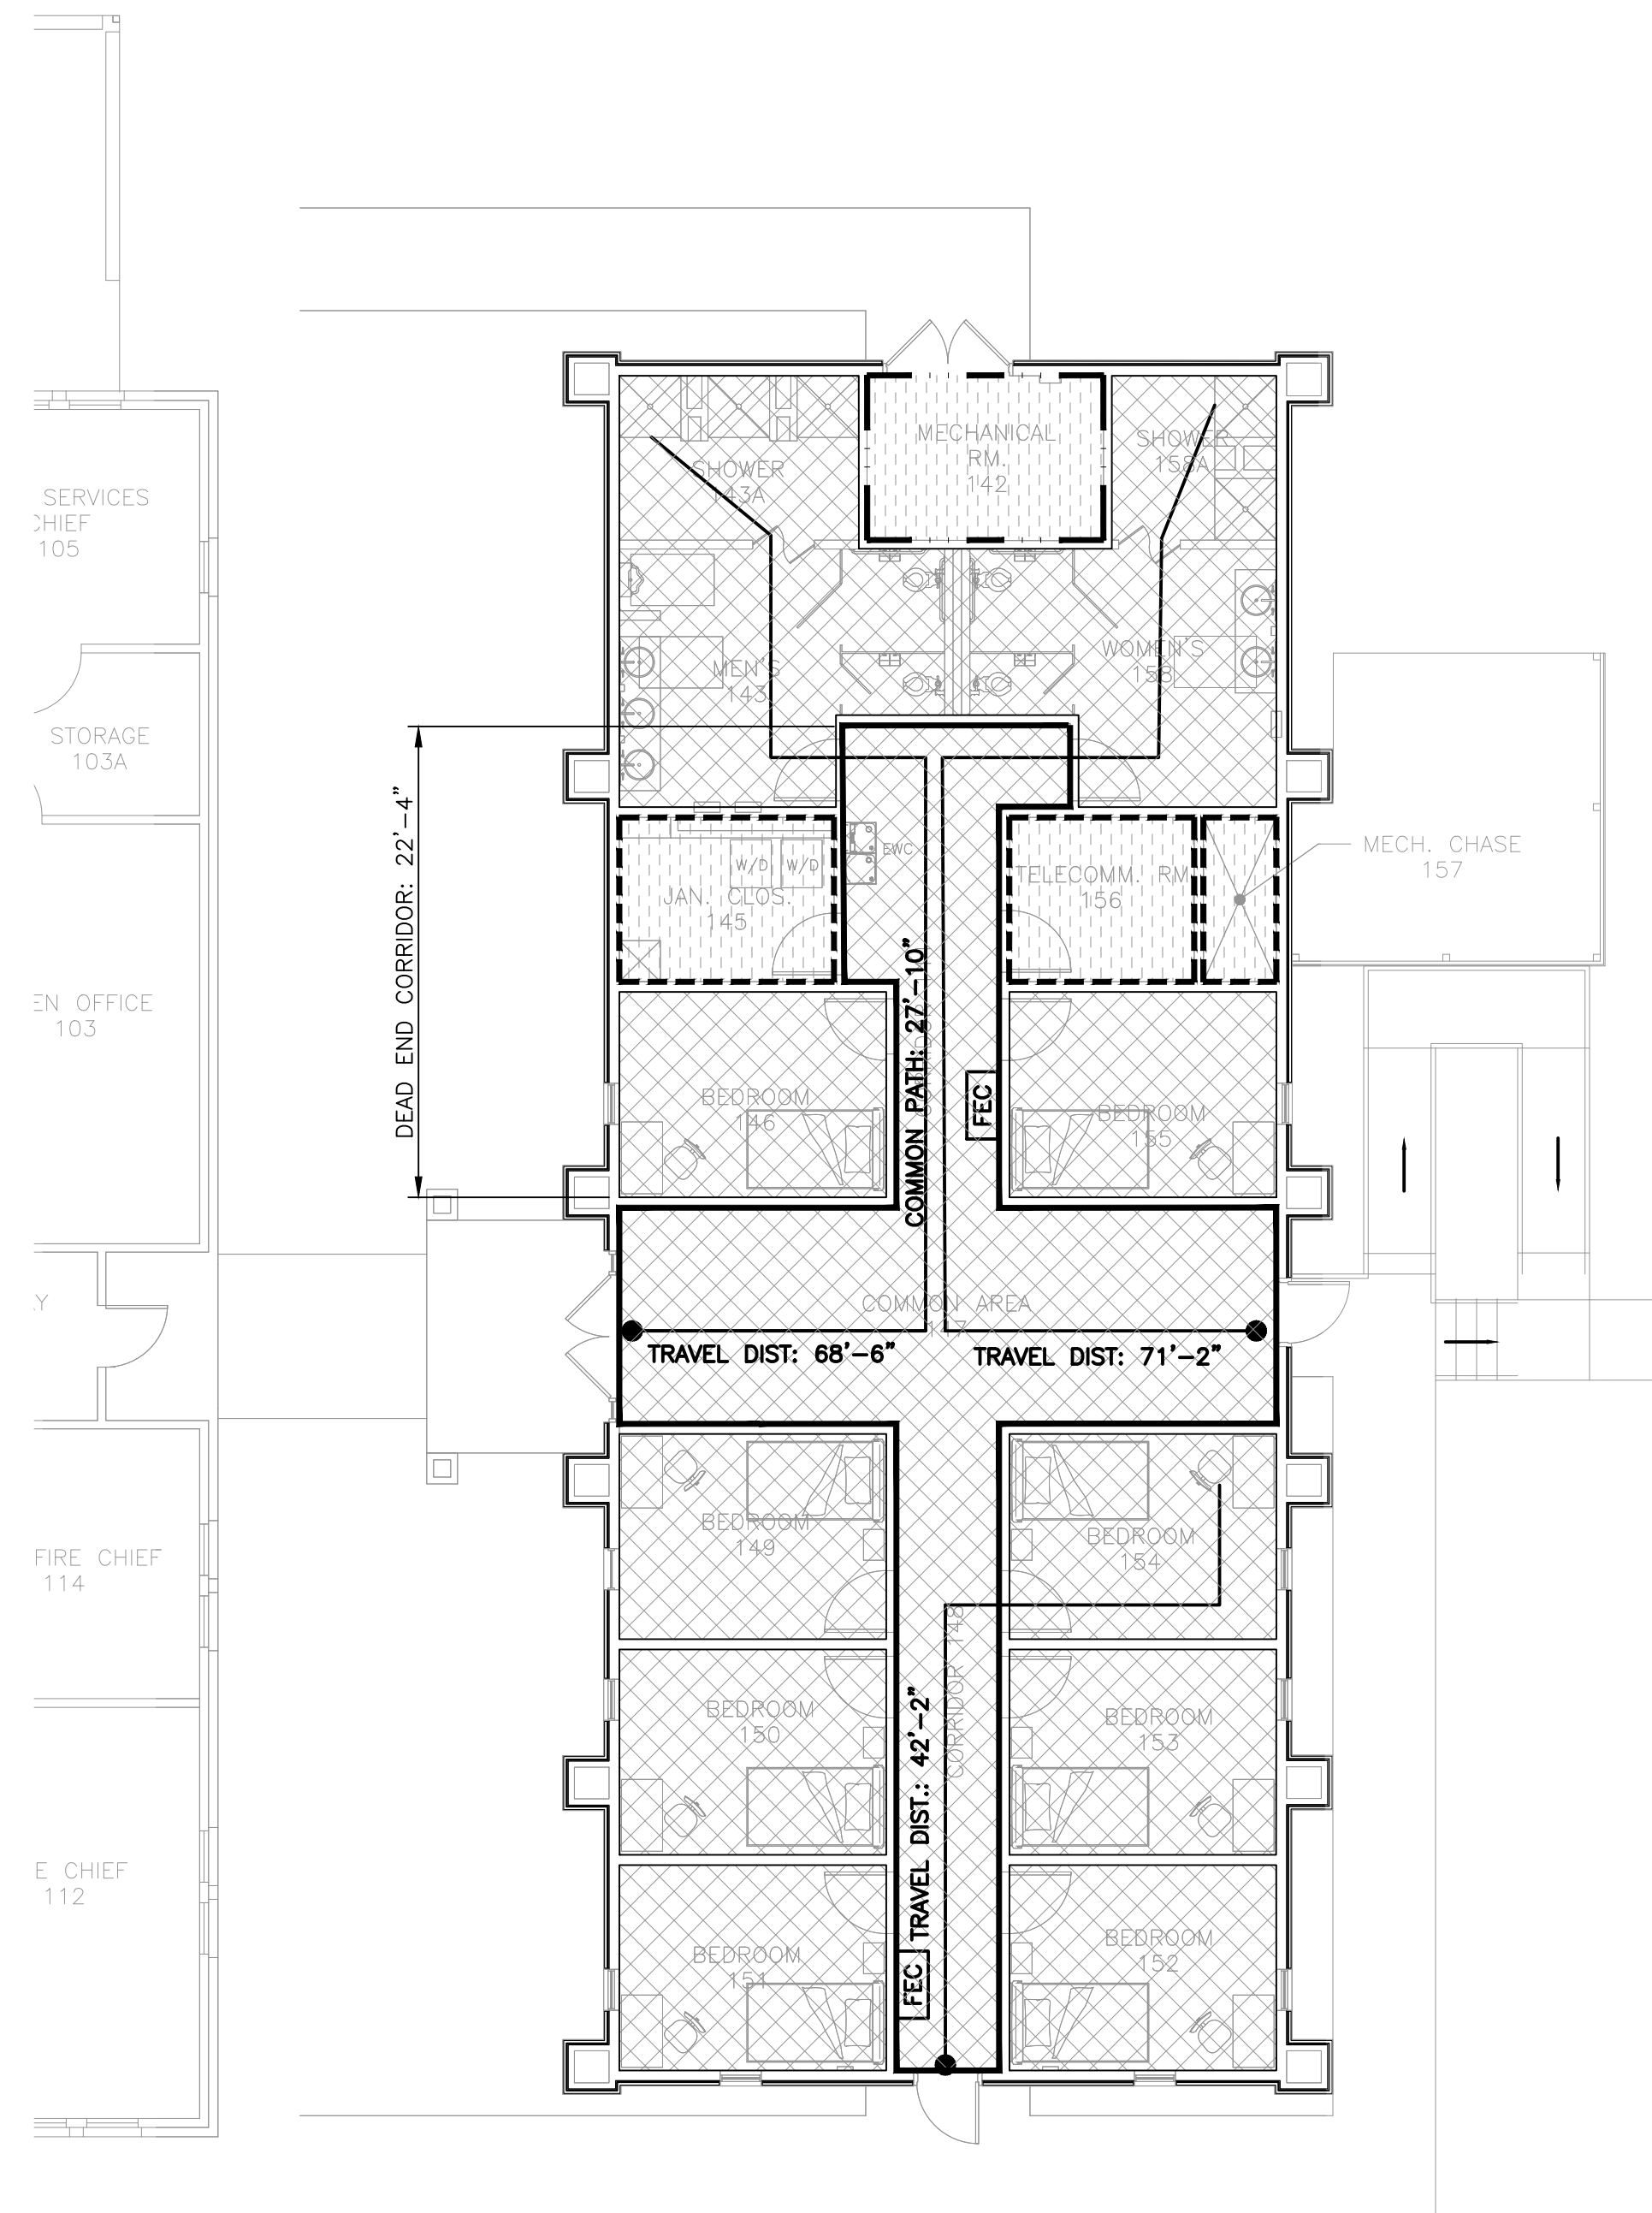

1 LIFE SAFETY PLAN  
1/8" = 1' - 0"

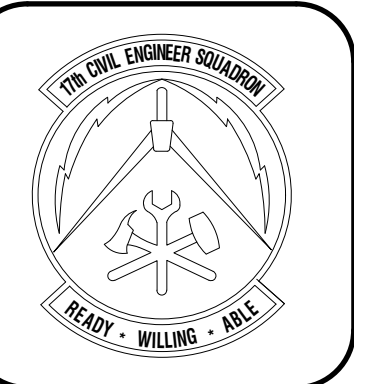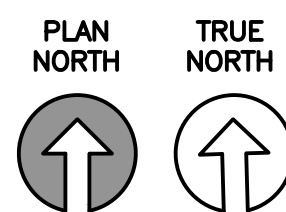

REVISIONS	DATE

Designed by JH/MLLA	Drawn by JH/MLLA	Reviewed by RT/JH	Submitted by PCBS
------------------------	---------------------	----------------------	----------------------

**FIRE STATION ADD/ALTER, B3321**  
**PROJECT NO. 1039839**  
**17th TRAINING WING**  
**GOODFELLOW AIR FORCE BASE, TEXAS**

Project Number: 1039839
SHEET TITLE LIFE SAFETY PLAN
Date: JAN 2024

SEQ. 05	SHEET LS-101	OF 50
------------	-----------------	----------

GENERAL NOTES:

BUILDING CODES:

ALL STRUCTURAL FRAMING SYSTEMS PROVIDED BY THE CONTRACTOR SHALL BE DESIGNED IN GENERAL ACCORDANCE WITH THE FOLLOWING CODE REFERENCES:

- 1.UNIFIED FACILITIES CRITERIA (UFC) 1-200-01 GENERAL BUILDING REQUIREMENTS WITH CHANGE 1.
- 2.UNIFIED FACILITIES CRITERIA (UFC) 1-301-01 STRUCTURAL ENGINEERING, WITH CHANGE 1 REVISED.
- 3.INTERNATIONAL BUILDING CODE (IBC), 2012.
- 4.AMERICAN SOCIETY OF CIVIL ENGINEERS (ASCE) 7-10, MINIMUM DESIGN LOADS FOR BUILDINGS AND OTHER STRUCTURES.
- 5.AMERICAN INSTITUTE OF STEEL CONSTRUCTION SPECIFICATION (AISC) 360-10.
- 6.STEEL JOIST INSTITUTE (SJI) SPECIFICATIONS AND LOAD TABLES, 75 YEAR STEEL JOIST MANUAL.

DIVISION 1 – GENERAL REQUIREMENTS

CONTRACTOR SHALL PROVIDE NECESSARY EQUIPMENT, MATERIALS, AND LABOR REQUIRED TO PROVIDE NEW REINFORCED CONCRETE FOUNDATIONS AND SLABS, NEW PRE-ENGINEERED (PEB) METAL BUILDING, AND CONNECTED METAL CANOPIES AND BREEZEWAYS AS INDICATED IN THE FOLLOWING DRAWINGS.

THE CONTRACTOR SHALL BE RESPONSIBLE FOR REMOVING EXISTING VEGETATION AND TOPSOIL TO A DEPTH OF 30" BELOW GRADE. THE CONTRACTOR SHALL GRADE AND COMPACT THE SUB-BASE IN PREPARATION FOR NEW CONCRETE PADS AND SLABS AS INDICATED. LIFTS SHALL BE COMPACTED IN 6" BASE MATERIAL LIFTS AS SPECIFIED AND COMPACTED TO A MINIMUM 95% PROCTOR DENSITY UNLESS NOTED OTHERWISE.

THE CONTRACTOR SHALL PROVIDE ALL TESTING REPORTS FROM A CERTIFIED GEOTECHNICAL ENGINEER AS SPECIFIED.

CONTRACT DOCUMENTS INCLUDE, BUT ARE NOT LIMITED TO, THE STRUCTURAL DOCUMENTS (DRAWINGS AND SPECIFICATIONS), BUT DO NOT INCLUDE SHOP DRAWINGS, VENDOR DRAWINGS, OR MATERIAL PREPARED AND SUBMITTED BY THE CONTRACTOR. THE NOTES PRESENTED HEREIN ARE NOT INTENDED TO REPLACE THE SPECIFICATIONS. SEE THE SPECIFICATIONS FOR REQUIREMENTS IN ADDITION TO THE GENERAL NOTES.

REFERENCE TO STANDARD SPECIFICATIONS OF ANY TECHNICAL SOCIETY, ORGANIZATION OR ASSOCIATION OR TO CODES OF LOCAL OR STATE AUTHORITIES, SHALL MEAN THE LATEST STANDARD, CODE, SPECIFICATION OR TENTATIVE SPECIFICATION ADOPTED AT THE DATE OF TAKING BIDS, UNLESS SPECIFICALLY STATED OTHERWISE.

CONTRACT DOCUMENTS SHALL GOVERN IN THE EVENT OF A CONFLICT WITH THE CODE OF PRACTICE OR SPECIFICATIONS OF AISC, ASTM, AWC, SJI, AF&PA OR OTHER STANDARDS. WHERE A CONFLICT OCCURS WITHIN THE CONTRACT DOCUMENTS, THE MORE STRINGENT REQUIREMENT SHALL GOVERN.

CONTRACTOR HAS SOLE RESPONSIBILITY FOR MEANS, METHODS, SAFETY, TECHNIQUES, SEQUENCES, AND PROCEDURES OF CONSTRUCTION.

CONTRACTOR SHALL COORDINATE THE RELOCATION OF UTILITIES, IF REQUIRED BY THE REPAIRS. THE CONTRACTOR SHALL FOLLOW THE APPLICABLE CODES AND INDUSTRY STANDARDS WHEN MOVING EXISTING ELECTRICAL, MECHANICAL, COMMUNICATIONS, PLUMBING, WATER, AND SPRINKLER LINES, ETC. AS REQUIRED FOR THE PERFORMANCE OF THE STRUCTURAL REPAIRS.

THE CONTRACTOR SHALL HAVE ALL TEMPORARY SHORING DESIGNED AND CERTIFIED BY A QUALIFIED PROFESSIONAL ENGINEER LICENSED IN THE STATE OF TEXAS AS PART OF HIS WORK. THE CONTRACTOR SHALL SUBMIT ONE COPY OF THE ALL CERTIFIED TEMPORARY SHORING DOCUMENTS FOR REVIEW AND RECORD PURPOSES. DESIGN DOCUMENTS SHALL INCLUDE BUT NOT LIMITED TO: PLANS, SECTIONS, DETAILS, AND STRUCTURAL CALCULATIONS.

WORK SPECIFIED HEREIN SHALL BE INSPECTED IN ACCORDANCE WITH THE APPLICABLE BUILDING CODE, LOCAL ORDINANCES, AND THE CONTRACT DOCUMENTS. THE CONTRACTOR SHALL COORDINATE REQUIRED INSPECTIONS WITH THE GOVERNMENT'S INSPECTOR(S).

THE CONTRACTOR SHALL TAKE NECESSARY STEPS TO MINIMIZE INTERFERENCE WITH THE OPERATIONS AND BASE MISSION. PRIOR TO COMMENCING WORK, THE CONTRACTOR SHALL SUBMIT A DETAILED, WRITTEN WORK PLAN TO THE CONTRACTING OFFICER FOR REVIEW AND APPROVAL.

WHERE APPLICABLE THE CONTRACTOR SHALL COORDINATE ALL WORK ON ROOFS WITH THE CONTRACTING OFFICER SO THAT THE ROOF WARRANTIES ARE NOT VOIDED. THE CONTRACTOR SHALL PROPERLY REINSTALL OR REPLACE ANY ROOF OR FACADE COMPONENTS THAT WERE REMOVED OR DAMAGED DURING THE COURSE OF THE WORK PRIOR TO DEPARTURE FROM THE WORK SITE EACH DAY. ANY ROOF OR FACADE COMPONENTS THAT ARE REINSTALLED OR REPLACED SHALL BE WATER TIGHT. ALL REPAIRS SHALL BE APPROVED BY THE CONTRACTING OFFICIAL PRIOR TO THE COMMENCEMENT OF REPAIR ACTIVITIES.

WHERE SUSPECT BUILDING MATERIALS ARE ENCOUNTERED DURING SELECTIVE DEMOLITION OR REPAIRS OPERATIONS, THE CONTRACTOR SHALL IMMEDIATELY NOTIFY THE CONTRACTING OFFICER PRIOR TO PERFORMING ANY SAMPLING, TESTING, ABATEMENT, HANDLING, AND DISPOSAL OF ANY SUSPECT BUILDING MATERIAL(S) AND SHALL ADHERE TO THE STANDARDS, PRACTICES AND PROTOCOLS OF BASE COMMAND.

DIVISION 2 – SITE WORK

THE CONTRACTOR SHALL BE RESPONSIBLE FOR LOCATING ALL BURIED UTILITIES IN THE CONSTRUCTION AREA PRIOR TO BEGINNING WORK.

THE CONTRACTOR SHALL BE RESPONSIBLE FOR THE STORAGE, HAULING AND DISPOSAL OF ALL ITEMS SPECIFIED IN THE CONSTRUCTION DOCUMENT TO BE SELECTIVE DEMOLISHED.

THE CONTRACTOR SHALL BE RESPONSIBLE FOR THE INSTALLATION OF AND DESIGN OF THE SLAB ON GRADE FOUNDATION AND CONCRETE PIERS FOR PEB COLUMNS. THE CONTRACTOR SHALL SUBMIT DESIGN CALCULATIONS AND SHOP DRAWINGS SIGNED AND SEALED BY A REGISTERED ENGINEER IN THE STATE OF TEXAS TO THE CONTRACTING OFFICIAL PRIOR TO INSTALLATION.

DIVISION 3 – CONCRETE

ALL CONCRETE SHALL HAVE A MINIMUM 28 DAY COMPRESSIVE STRENGTH (f'c) OF 3,000 PSI.

ALL CONCRETE SHALL BE AIR ENTRAINED AND SHALL HAVE AN ENTRAINED AIR CONTENT RANGING BETWEEN 5 TO 7 PERCENT.

ALL CONCRETE REINFORCING STEEL SHALL BE ASTM A615 GRADE 60.

FOR HOT WEATHER CONCRETE, THE CONTRACTOR SHALL ADHERE TO THE REQUIREMENTS OF ACI 305.

FOR COLD WEATHER CONCRETE, THE CONTRACTOR SHALL ADHERE TO THE REQUIREMENTS OF ACI 306.

THE CONTRACTOR SHALL BE SUBMIT ALL CONCRETE MIX DESIGNS SHOP DRAWINGS TO THE CONTRACTING OFFICIAL FOR APPROVAL PRIOR TO BEGINNING WORK.

THE CONTRACTOR SHALL SUBMIT ALL CONCRETE SHOP DRAWINGS PRIOR TO CASTING CONCRETE.

THE CONTRACTOR SHALL BE RESPONSIBLE FOR THE DESIGN OF ALL CONCRETE FORM WORKS TO BE USED ON THIS PROJECT. THE CONTRACTOR SHALL SUBMIT ALL FORM WORK CALCULATIONS AND SHOP DRAWINGS TO THE CONTRACTING OFFICIAL PRIOR TO BEGINNING CONCRETE WORK. ALL FORM WORK CALCULATIONS AND SHOP DRAWINGS SHALL BE DESIGNED, SIGNED AND SEALED BY A REGISTERED ENGINEER IN THE STATE OF TEXAS.

DIVISION 4 – MASONRY

PROVIDE BRICK WAINSCOT AND STUCCO EXTERIOR WALL FINISH AS INDICATED AND AS SPECIFIED.

NEW BRICK VENEER TO MATCH EXISTING FIRE STATION FINISH AS MUCH AS POSSIBLE. CONTRACTOR SHALL SUBMIT SAMPLES OF BRICK TO THE GOVERNMENT FOR APPROVAL PRIOR TO INSTALLATION.

DIVISION 5 – STRUCTURAL STEEL

THE CONTRACTOR SHALL FIELD VERIFY ALL QUANTITIES AND RELEVANT DIMENSIONS OF STRUCTURAL STEEL AND MISCELLANEOUS STEEL MEMBERS USED IN THIS PROJECT PRIOR TO FABRICATION.

STEEL ANGLES SHALL MEET THE REQUIREMENTS OF ASTM A 36 AND SHALL BE PAINTED. SURFACES SHALL BE PREPARED IN ACCORDANCE WITH STEEL STRUCTURES PAINTING COUNCIL SPECIFICATION SSPC-SP7.

ALL STEEL SHALL BE DETAILED, FABRICATED, AND ERECTED IN ACCORDANCE WITH THE AISC MANUAL, AISC SPECIFICATION, AND AISC CODE OF STANDARD PRACTICE.

BOLTS, NUTS, AND WASHERS SHALL CONFORM TO THE REQUIREMENTS OF ASTM A 325. STRUCTURAL BOLTS SHALL BE 3/4 INCH DIAMETER MINIMUM.

ALL CHEMICAL EPOXY ANCHORS SHALL BE HILTI HIT-HY 150 ADHESIVE ANCHORING SYSTEM OR APPROVED EQUIVALENT. ANCHORS SHALL CONSIST OF 3/4" DIAMETER HILTI HAS RODS WITH A MINIMUM EMBEDMENT OF 6". IN THE EVENT THAT DAMAGE TO THE EXISTING CONCRETE WALL IS FOUND IN THE SPECIFIED CONNECTION AREA, THE CONTRACTING OFFICER SHALL BE IMMEDIATELY NOTIFIED AND ADHESION ANCHORS SHALL NOT BE INSTALLED UNTIL SUCH A TIME AS THE CONCRETE WALLS CAN BE EVALUATED.

EXTERIOR BREEZEWAY AND CANOPY ARE TO BE COMPRISED OF HOLLOW STRUCTURAL STEEL (HSS) MEMBERS UNLESS NOTED OTHERWISE. ALL EXPOSED MEMBERS WILL BE MED. BRONZE FINISH UNLESS NOTED OTHERWISE.

DIVISION 6 – WOOD AND PLASTIC

UNLESS STATED OTHERWISE, WOOD CONSTRUCTION SHALL BE DETAILED, FABRICATED, AND INSTALLED IN ACCORDANCE WITH THE APPLICABLE SECTIONS OF THE 2012 EDITION OF THE NATIONAL DESIGN SPECIFICATION (NDS) FOR WOOD CONSTRUCTION AS PUBLISHED BY THE AMERICAN FOREST AND PAPER ASSOCIATION (AF&PA) AND THE AMERICAN WOOD COUNCIL (AWC).

THE CONTRACTOR SHALL FIELD VERIFY DIMENSIONS PRIOR TO FABRICATION OF WOOD STRUCTURAL SHORING.

UNLESS OTHERWISE SPECIFIED, EACH PIECE OF LUMBER SHALL BEAR GRADE MARKS, STAMPS, OR OTHER IDENTIFYING MARKING INDICATING THE GRADES OF MATERIAL AND RULES OR STANDARDS UNDER WHICH PRODUCED.

MATERIAL FOR CRIBBING AND SHORING BEAMS SHALL BE SOUTHERN PINE No. 2 AND SHALL HAVE THE MINIMUM PROPERTIES LISTED BELOW. ALL LUMBER SHALL HAVE A MOISTURE CONTENT NOT EXCEEDING 19 PERCENT.

- FB = 1,050 PSI
- FT = 650 PSI
- FV = 175 PSI
- FC (PERP) = 565 PSI
- FC = 1,100 PSI
- E = 1,400,000 PSI


TEMPORARY SHORING

SCREW JACKS CAPABLE OF RESISTING A MINIMUM LOAD OF 1,300 LBS SHALL BE INSTALLED ON TIMBER CRIBBING. EACH JACK SHALL BE TIGHTENED UNTIL SHORING BEAM IS FULLY ENGAGED AGAINST THE BOTTOM OF THE EXISTING METAL FLOOR DECKING.

JACKS SHALL BE PERIODICALLY MONITORED AT LEAST ONCE A MONTH OR AFTER EACH SIGNIFICANT WEATHER EVENT. EACH JACK SHALL BE CHECKED TO VERIFY THAT IT IS ADEQUATELY TIGHT AND FULLY ENGAGED. WHERE JACKS ARE FOUND TO BE LOOSE, JACKS SHALL BE RE-TIGHTENED.

CRIBBING SHALL CONSIST OF 6X6 TIMBERS PLACE IN TWO LAYERS PERPENDICULAR TO EACH OTHER.

THE CONTRACTOR SHALL EXCAVATE THE TOP LAYER OF SOIL TO STIFF, DRY MATERIAL PRIOR TO THE INSTALLATION OF TIMBER CRIBBING. PROVISIONS SHALL BE MADE TO KEEP THE SHORING AREA AS DRY AS POSSIBLE TO AVOID IN ADVERTENT CRIBBING SETTLEMENT DUE TO THE SOFTENING OF THE BASE MATERIALS DUE TO EXCESSIVE MOISTURE EXPOSURE. TIMBER CRIBBING SHALL NOT BE PLACED ON LOOSE OR WET SOIL.

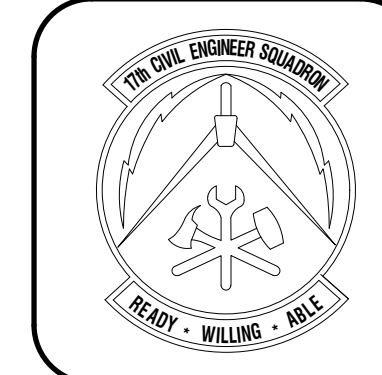

REVISIONS	DATE	
	NO.	DATE

Designed by JH/RML/A	Drawn by JH/RML/A	Reviewed by RT/JH	Submitted by PCBS
-------------------------	----------------------	----------------------	----------------------

PROJECT TITLE  
**FIRE STATION ADD/ALTER, B3321**  
**PROJECT NO. 1039839**  
**17th TRAINING WING**  
**GOODFELLOW AIR FORCE BASE, TEXAS**


Project Number:  
1039839

SHEET TITLE  
STRUCTURAL NOTES,  
SYMBOLS, & ABBREVIATIONS

Date:  
JAN 2024

SEQ.	SHEET	OF
06	<b>S-001</b>	50



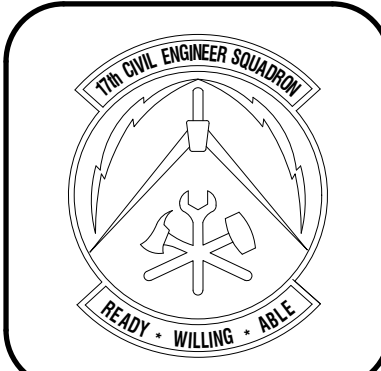


REVISIONS	DATE

Designed by JH/MLLA	Drawn by JH/MLLA	Reviewed by RT/JAH	Submitted by PCBS
------------------------	---------------------	-----------------------	----------------------


PROJECT TITLE  
**FIRE STATION ADD/ALTER, B3321**  
**PROJECT NO. 1039839**  
**17th TRAINING WING**  
**GOODFELLOW AIR FORCE BASE, TEXAS**

Project Number: 1039839
SHEET TITLE FOUNDATION & FRAMING PLAN
Date: JAN 2024

SEQ.	SHEET	OF
07	S-101	50

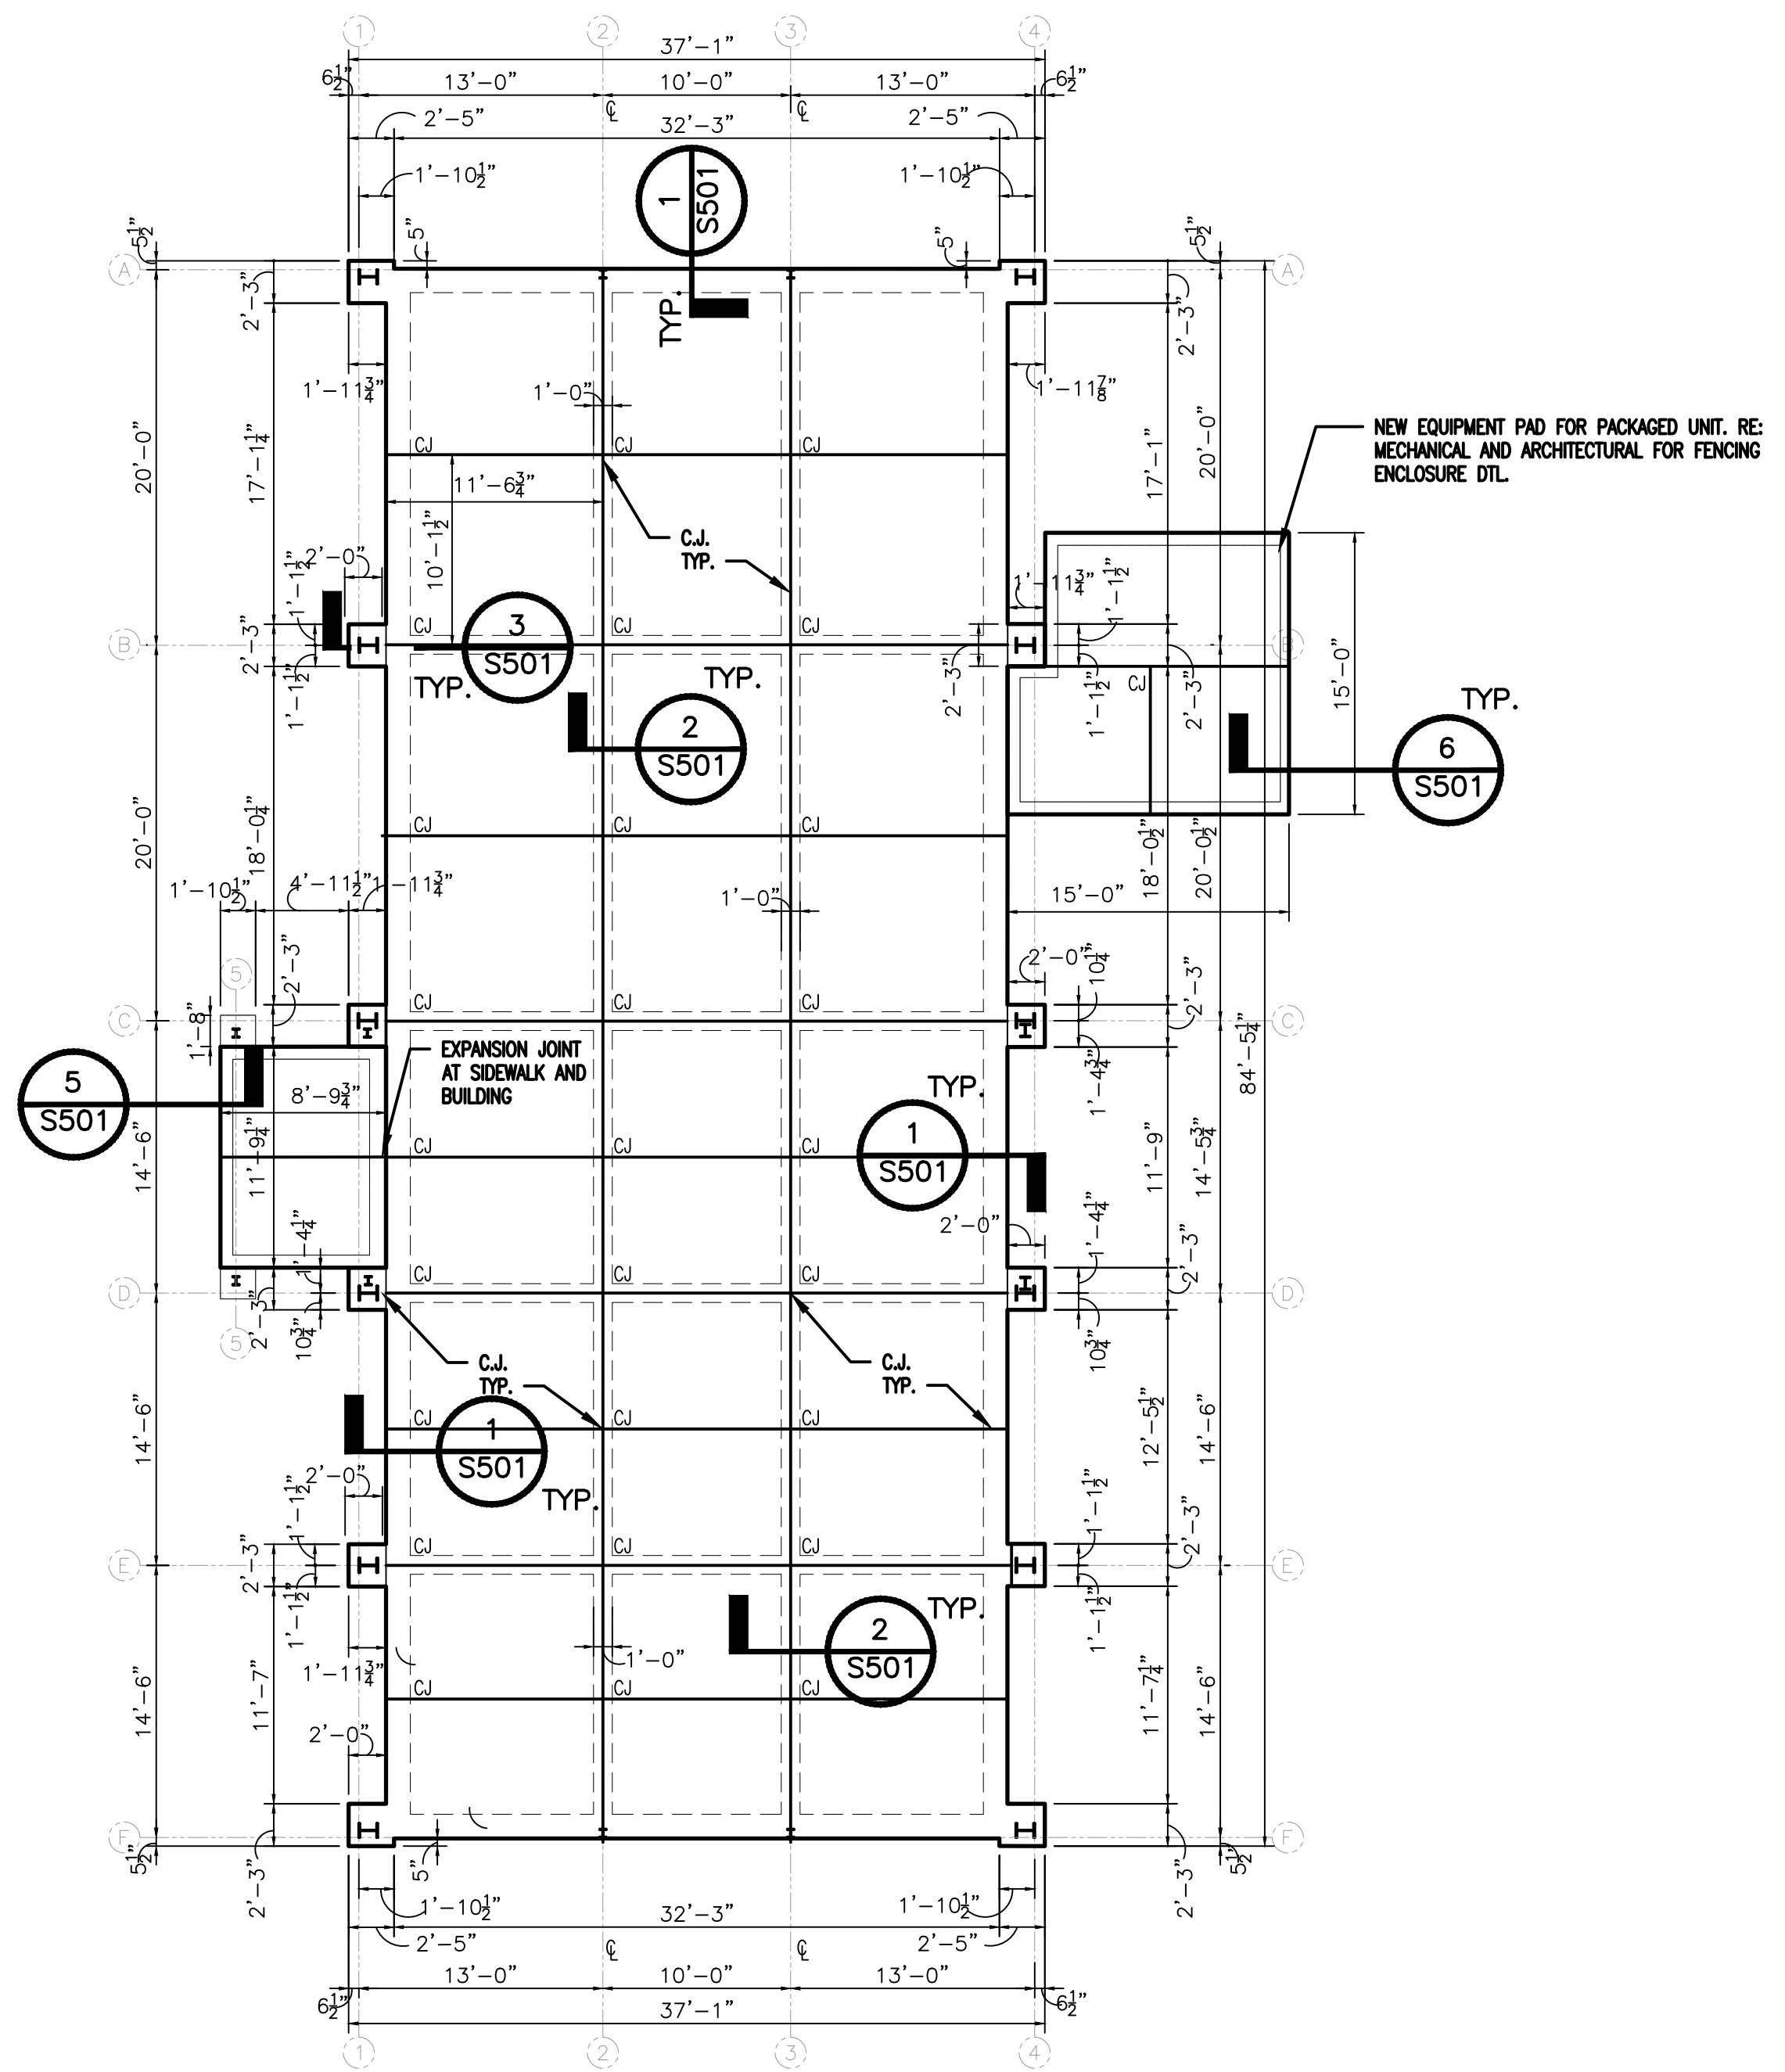



**1 NEW ADDITION FRAMING PLAN**  
 $\frac{1}{8}'' = 1' - 0''$   
 PLAN NORTH ↑ TRUE NORTH ↑

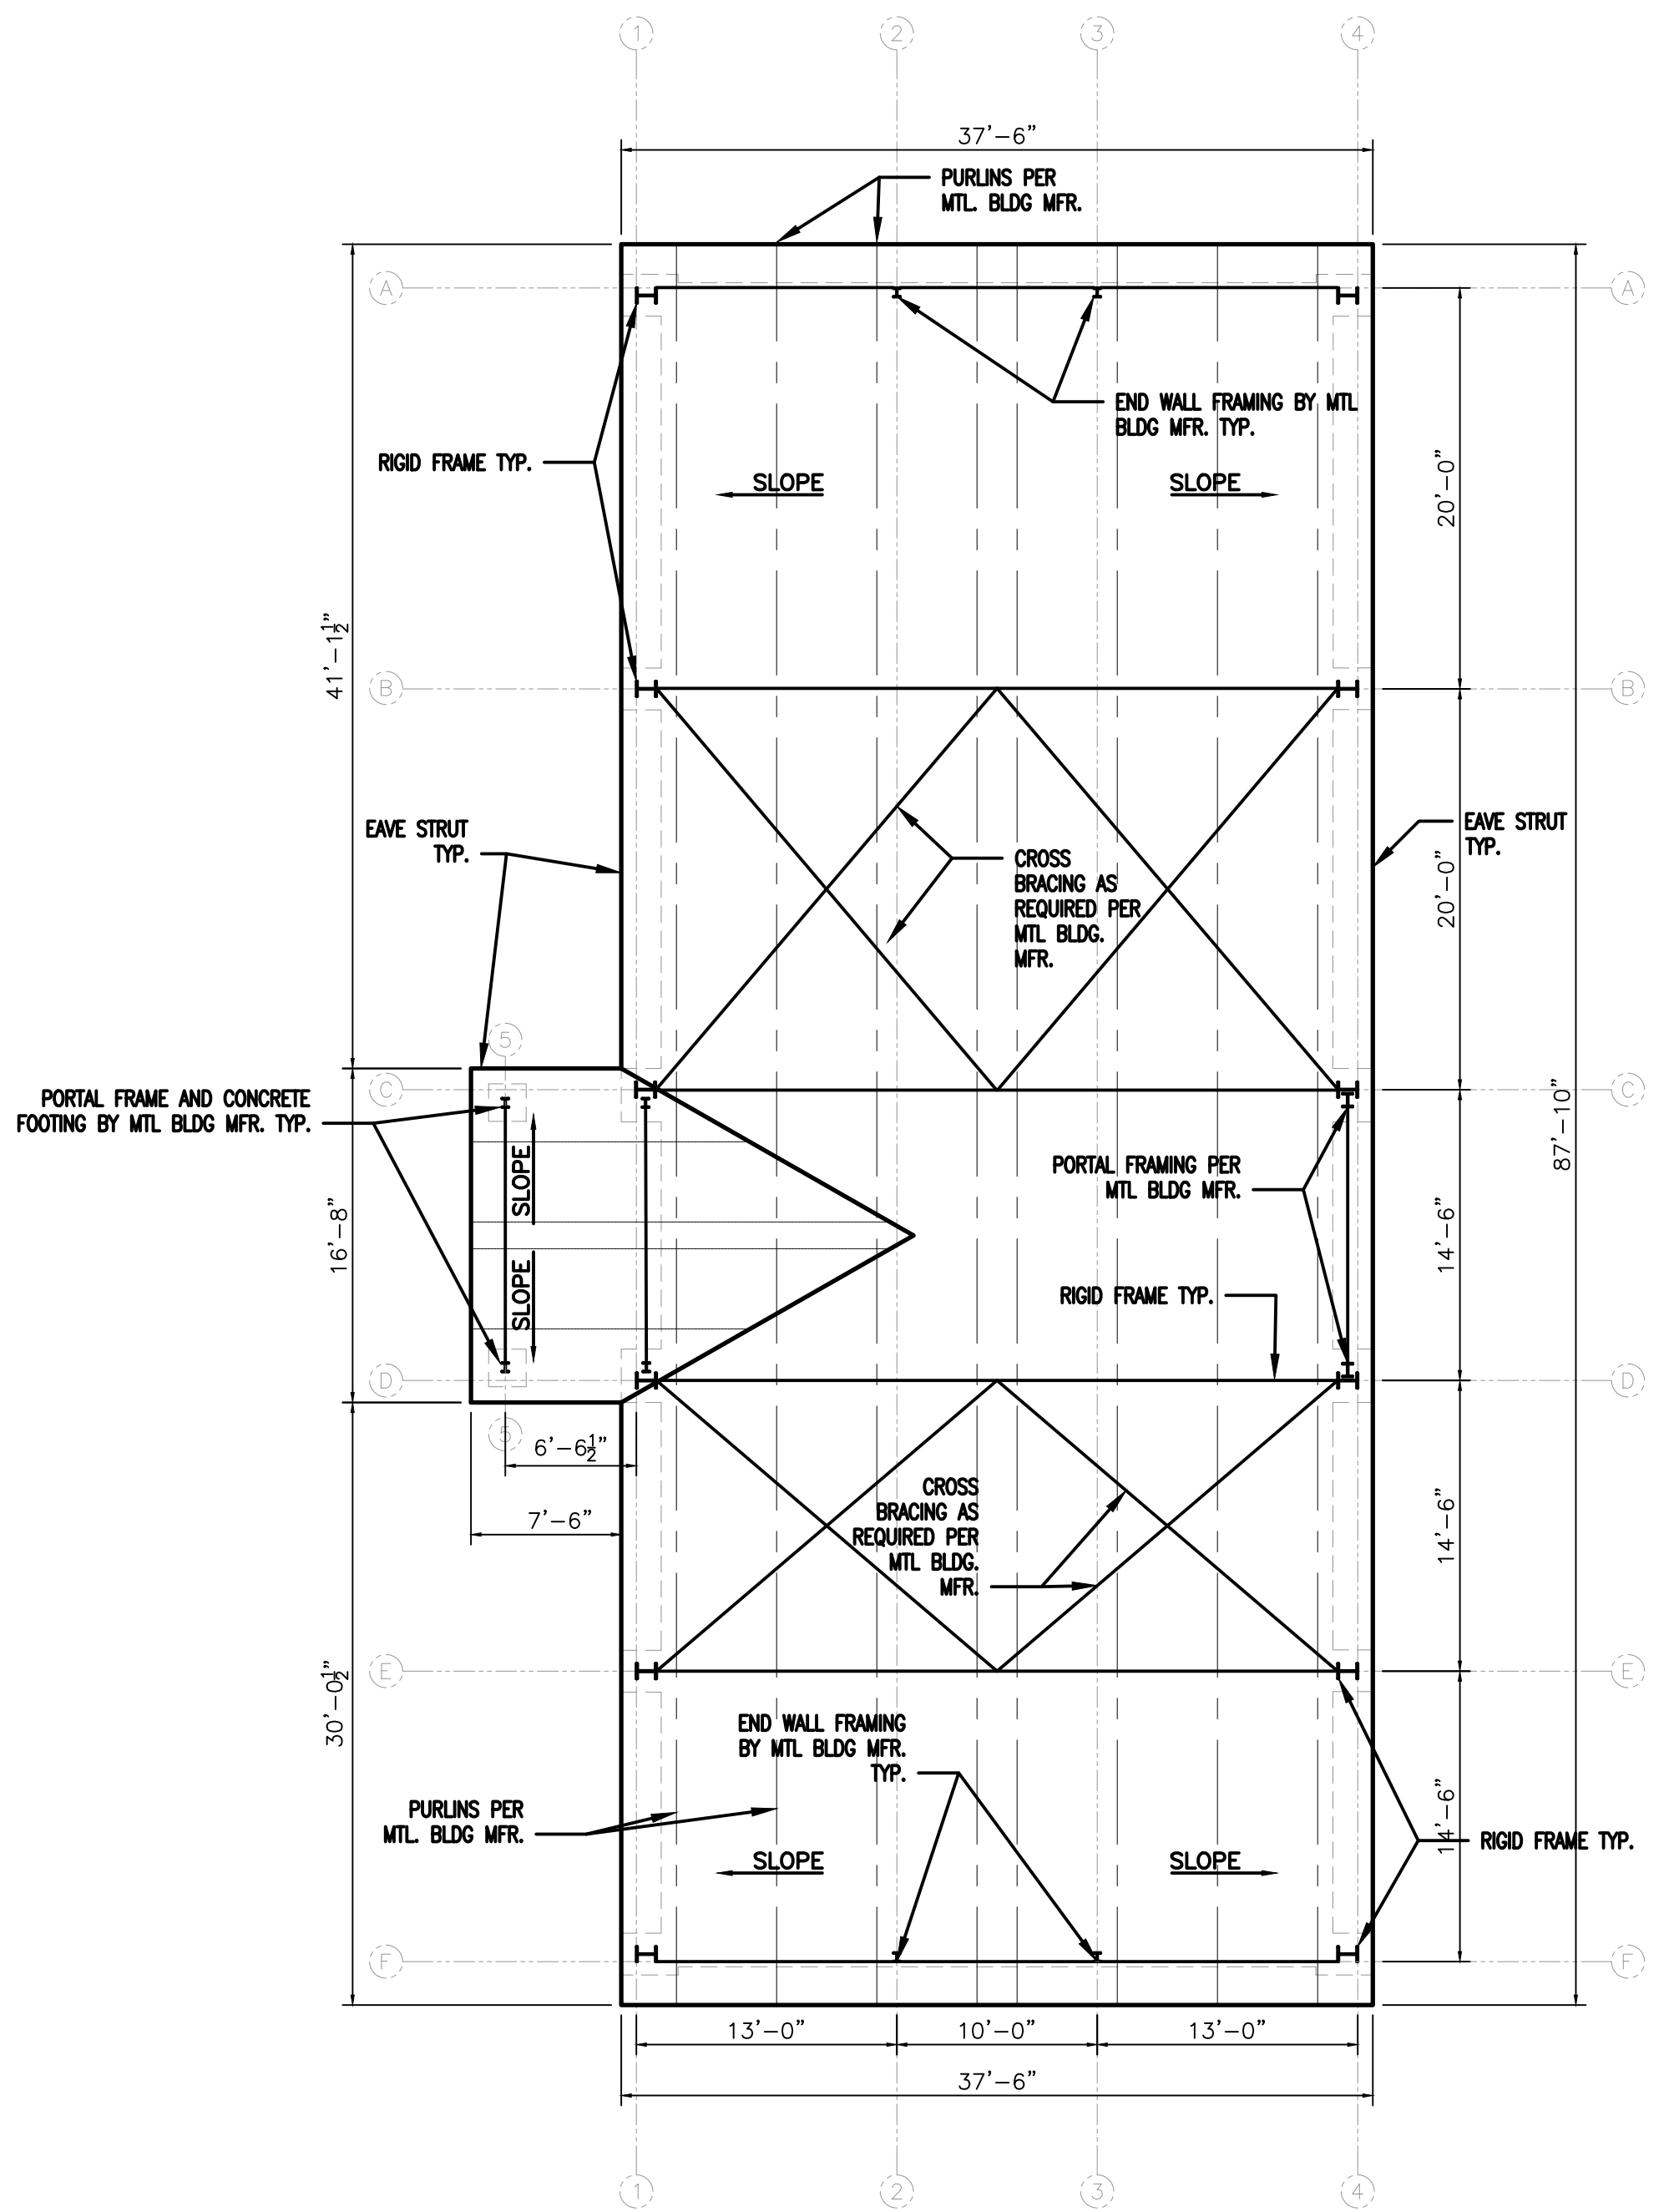

**2 NEW ADDITION ROOFING PLAN**  
 $\frac{1}{8}'' = 1' - 0''$   
 PLAN NORTH ↑ TRUE NORTH ↑


- CONCRETE FINISHES**
- CONCRETE SLABS TO RECEIVE "TROWEL" FINISH. RE: ARCHITECTURAL FOR ROOMS TO RECEIVE FLOOR HARDENER.
  - CONCRETE SURFACES EXPOSED TO PUBLIC SHALL RECEIVE LIGHT BROOM FINISH UNLESS NOTED OTHERWISE.
- NOTES: UNLESS NOTED OTHERWISE ON PLAN OR SECTION**
- DESIGN FOUNDATION BEARING PRESSURE (NET) 2 KSF.
  - PLACE 6" CAPILLARY WATER BARRIER AND VAPOR BARRIER UNDER ALL SLABS, U.N.O
  - CONSTRUCTION JOINTS (C.J.) SHALL BE PLACED AS SHOWN ON FOUNDATION PLANS THROUGH SLABS AND BEAMS
  - SEE GENERAL NOTES FOR CONCRETE PROTECTION FOR REINFORCING
  - FILL:
    - REMOVE 2'-0" OF EXISTING MATERIAL AND REPLACE WITH NON-EXPANSIVE FILL UNDER THE 6" CAPILLARY BARRIER.
    - ALL FILL PLACED UNDER BUILDING SLABS SHALL BE NON-EXPANSIVE AND SHALL BE COMPACTED TO NO LESS THAN 95% MAX. PROCTOR DENSITY ACCORDING TO ASTM D1557, METHOD D.
  - THE CONTRACTOR SHALL MAINTAIN POSITIVE DRAINAGE OF THE SITE DURING CONSTRUCTION. THE SITE SHALL BE MAINTAINED IN A DEWATERED CONDITION DURING THE ENTIRE CONSTRUCTION PERIOD. PONDING OF WATER IN AND AROUND THE CONSTRUCTION SITE WILL NOT BE PERMITTED. ANY WATER, EITHER GROUND OR SURFACE MUST BE CONTINUALLY REMOVED.
  - FLOOR ELEVATION OF NEW ADDITION SHALL MATCH EXISTING FIRE STATION.

- GENERAL NOTES**
- THESE DRAWINGS ARE FOR CONTRACTOR REFERENCE AND BIDDING PURPOSES ONLY. CONTRACTOR SHALL BE RESPONSIBLE FOR PROVIDING A PREFABRICATED, PRE-ENGINEERED METAL BUILDING AND CONCRETE FOUNDATION USING THE BASIS OF DESIGN PROVIDED ABOVE. CONTRACTOR SHALL PROVIDE NECESSARY SHOP DRAWINGS OF FOUNDATION AND FRAMING COMPONENTS WITH APPROPRIATE DETAILS SIGNED AND APPROVED BY A PROFESSIONAL ENGINEER.
  - CONTRACTOR SHALL VERIFY EXISTING DIMENSIONS, EQUIPMENT, AND CONDITIONS PRIOR TO START OF WORK.
  - ALL CONCRETE WORK SHALL BE PERFORMED BY THE CONTRACTOR IN ACCORDANCE WITH THE LATEST ACI STANDARD SPECIFICATIONS FOR CONCRETE AND REINFORCED CONCRETE 301-20.
  - CONTRACTOR SHALL ENSURE ALL CONCRETE SHALL BE STANDARD WEIGHT AND SHALL TEST AT 3000 PSI @ 28 DAYS.
  - ALL REINFORCING STEEL SHALL BE ASTM DESIGNATION A-615, GRADE 60, EXCEPT THAT GRADE 40 SHALL BE USED FOR BEAM STIRRUPS. DETAIL REINFORCING AND PROVIDE ACCESSORIES IN ACCORDANCE WITH THE LATEST ACI MANUAL OF STANDARD PRACTICE FOR DETAILING REINFORCED CONCRETE STRUCTURES.
  - UNLESS NOTED OTHERWISE, WHERE REINFORCING CONTINUOUS REINFORCING IS DESIGNATED, LAP TOP AND BOTTOM BARS AT 12" MIN. STAGGER LAPS. AT NON-CONTINUOUS ENDS OF ALL BEAMS AND SLABS PROVIDE ACI RECOMMENDED 90 HOOK FOR TOP BARS, EXCEPT AT CORNERS OMIT HOOK ON EXTERIOR TOP BARS AND PROVIDE "L" BARS (EXTERIOR HORIZONTAL TOP, BOTTOM AND ALL INTERMEDIATE BARS) LAPPING 12" MIN. IN EA. DIRECTION. CONTRACTOR SHALL BE RESPONSIBLE FOR INSTALLING PIPE AND DUCT SLEEVES IN GRADE BEAMS AS INDICATED ON MECHANICAL, ELECTRICAL, AND PLUMBING DRAWINGS. THESE SLEEVES SHALL BE STEEL AND SHALL NOT INTERFERE WITH THE STRUCTURAL FRAMING NOR SHALL THEY IMPAIR THE STRENGTH OF THE STRUCTURE.

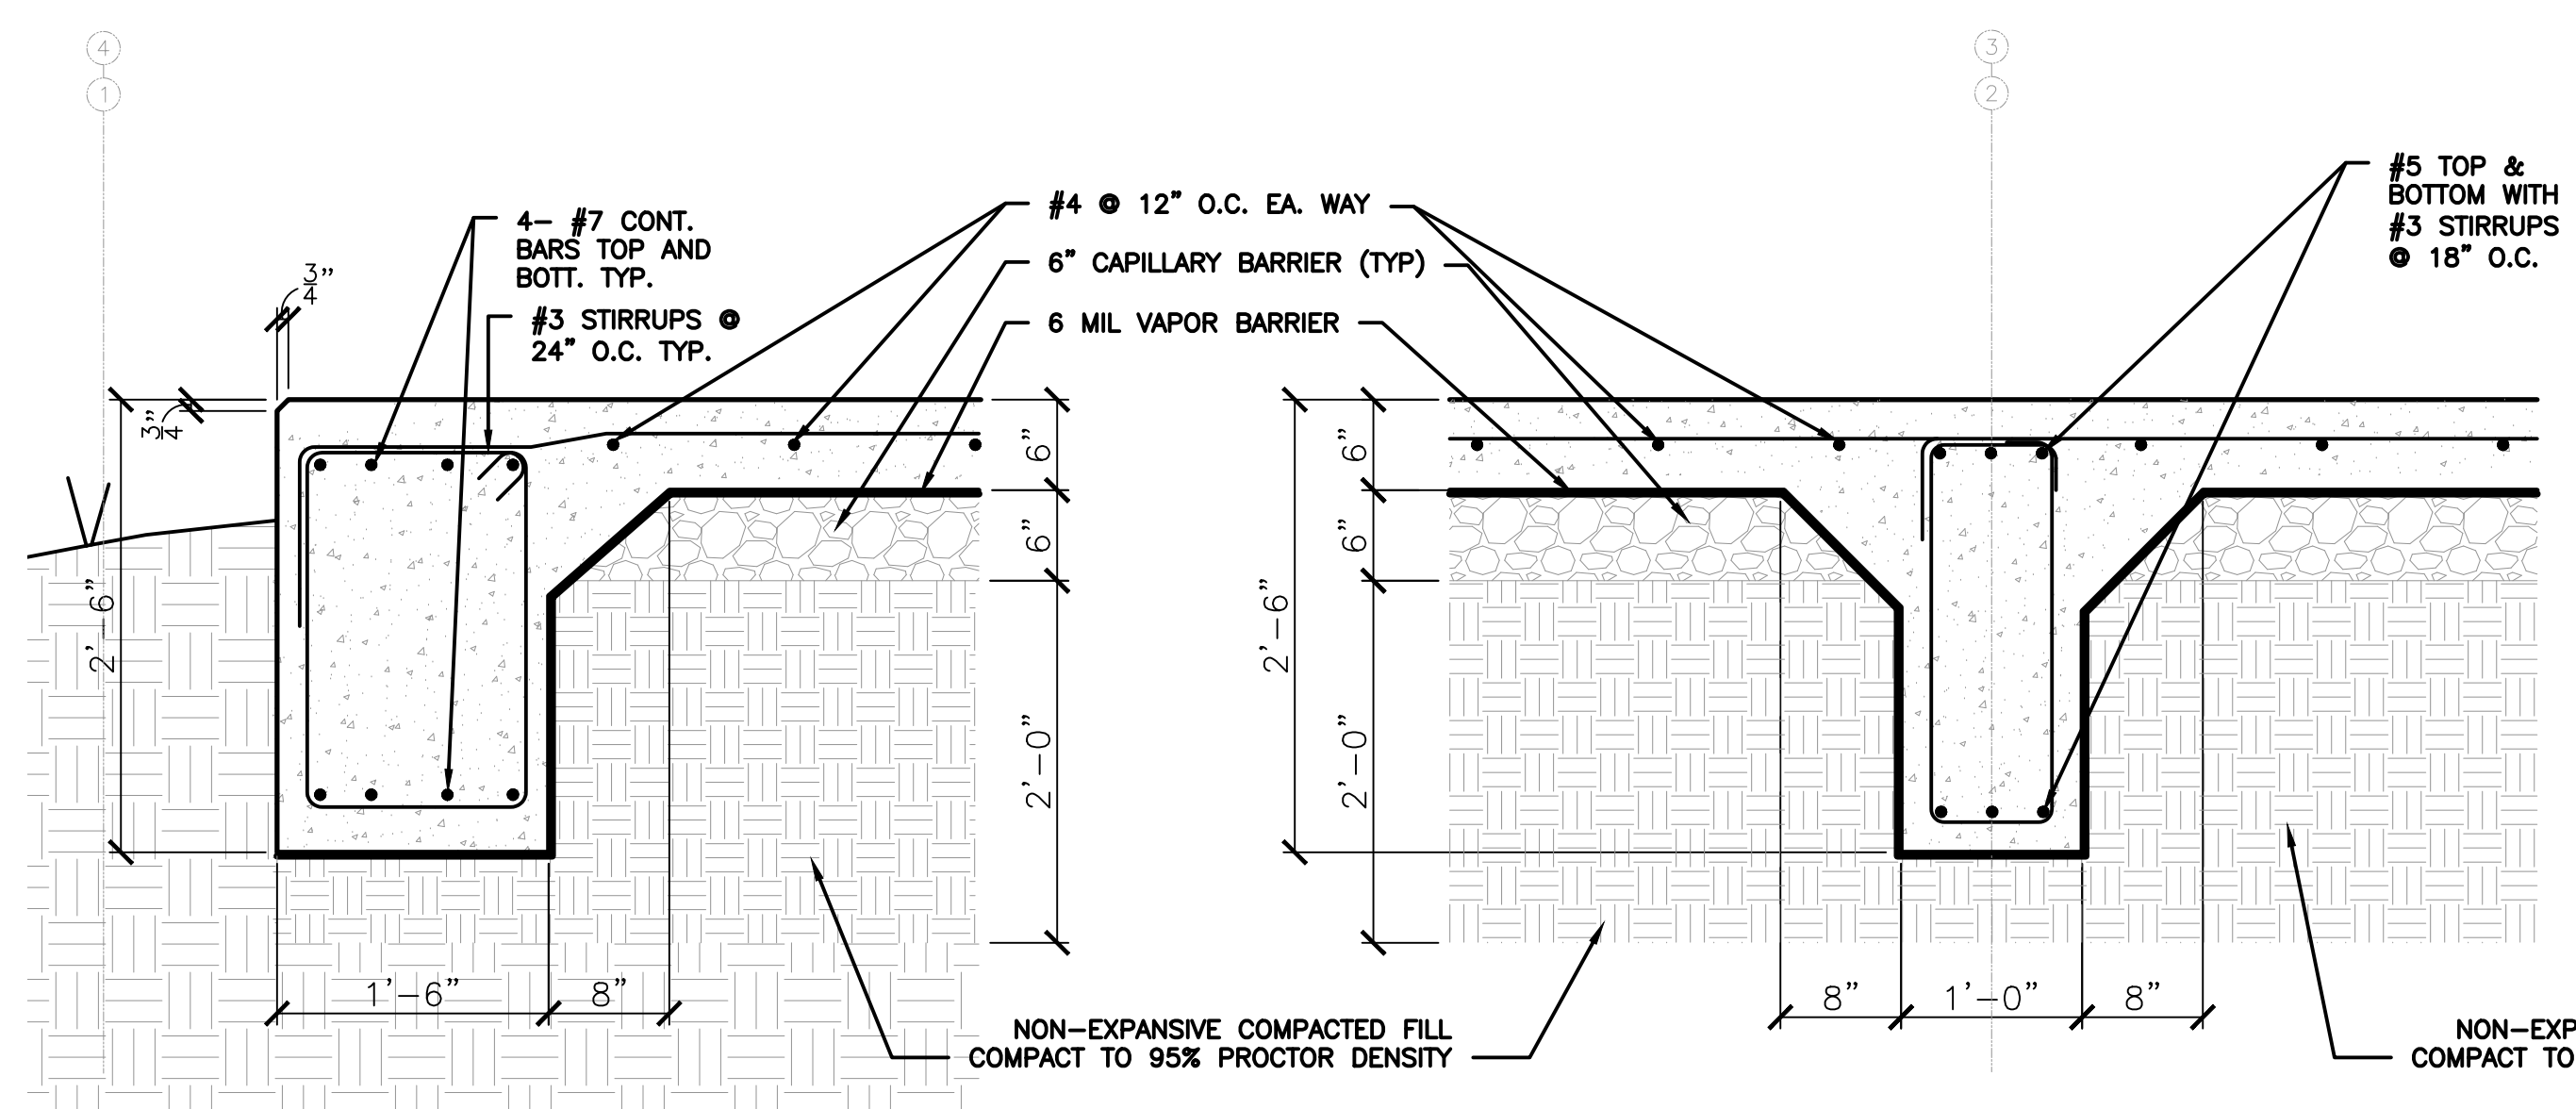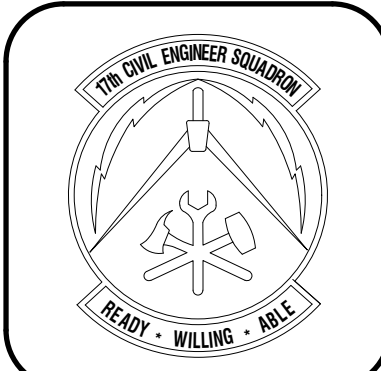


1 TYP. EXT. EDGE BEAM DTL.  
1" = 1' - 0"


2 TYP. INT. GRADE BEAM DTL.  
1" = 1' - 0"

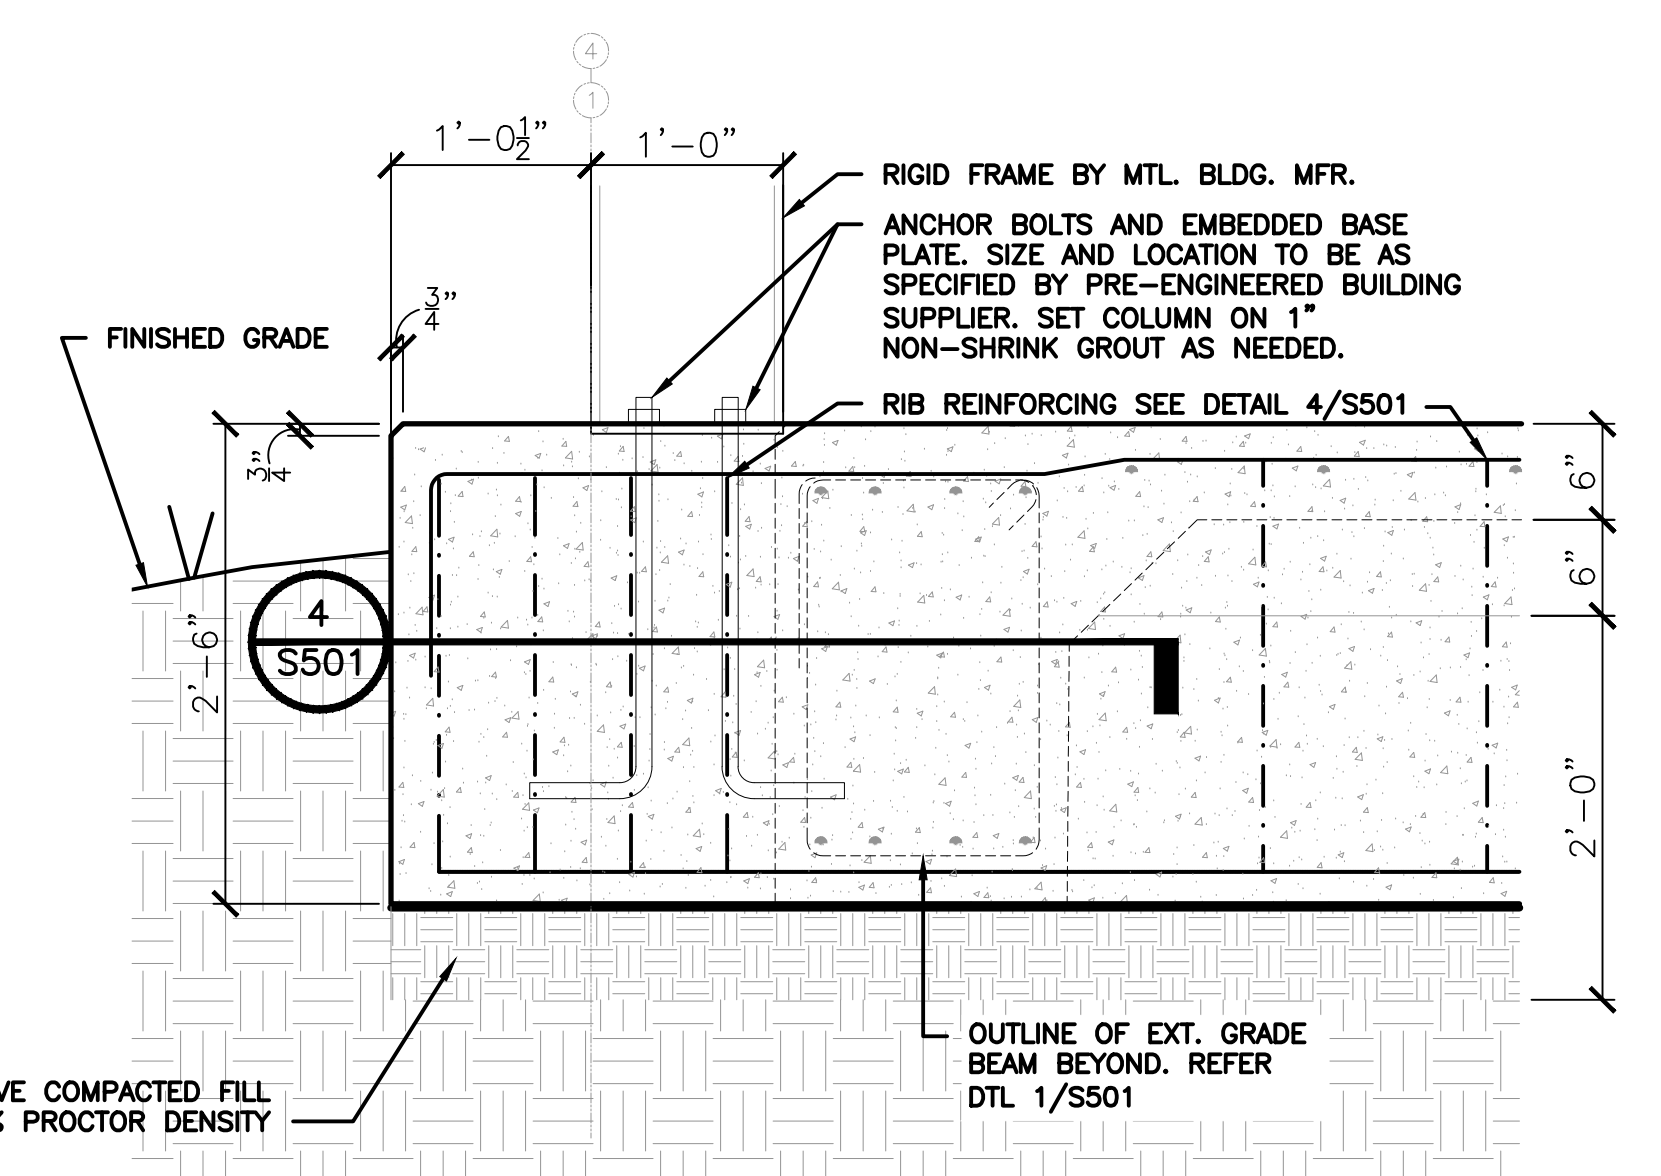


3 TYP. COL. FOOTING DTL.  
1" = 1' - 0"

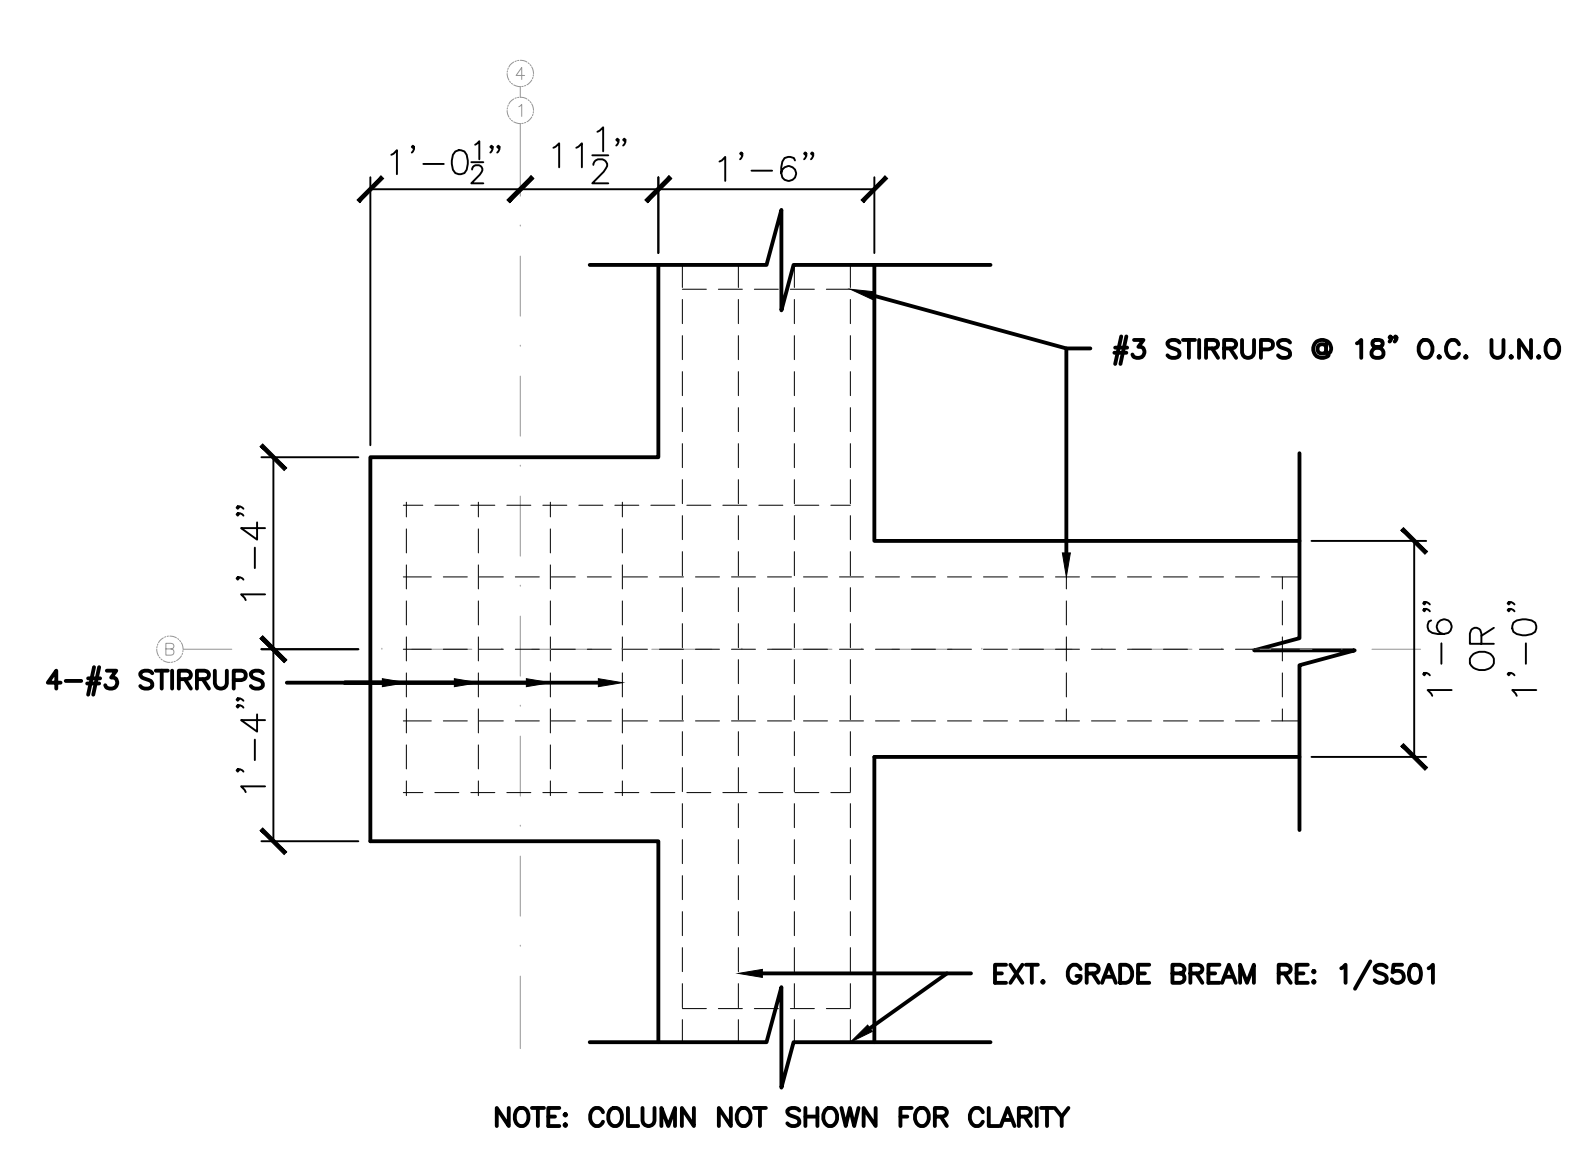

4 SECTION - GRADE BEAM  
3/4" = 1' - 0"

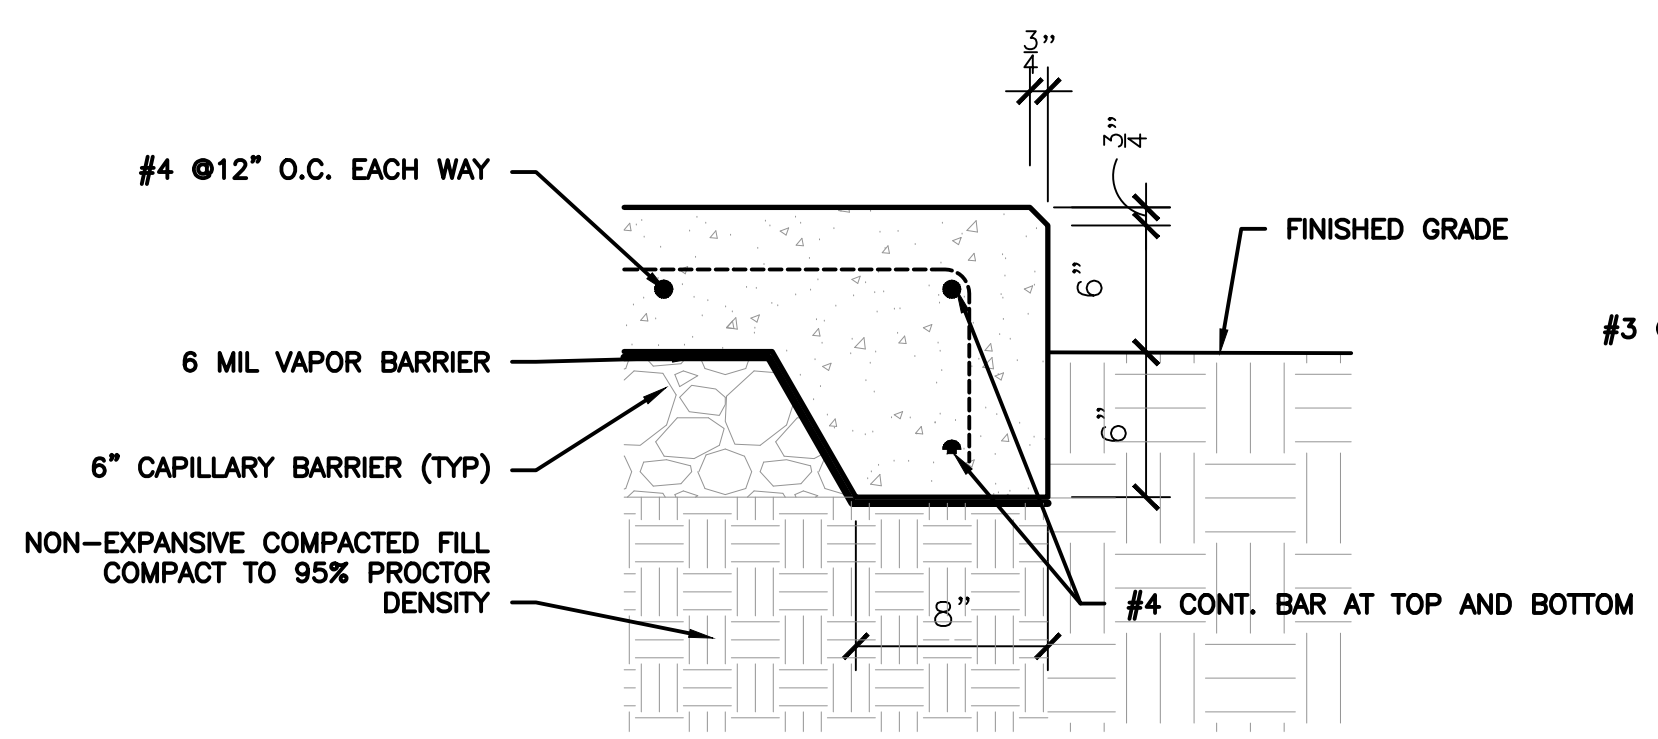

5 THICKENED SLAB EDGE DTL.  
1-1/2" = 1' - 0"

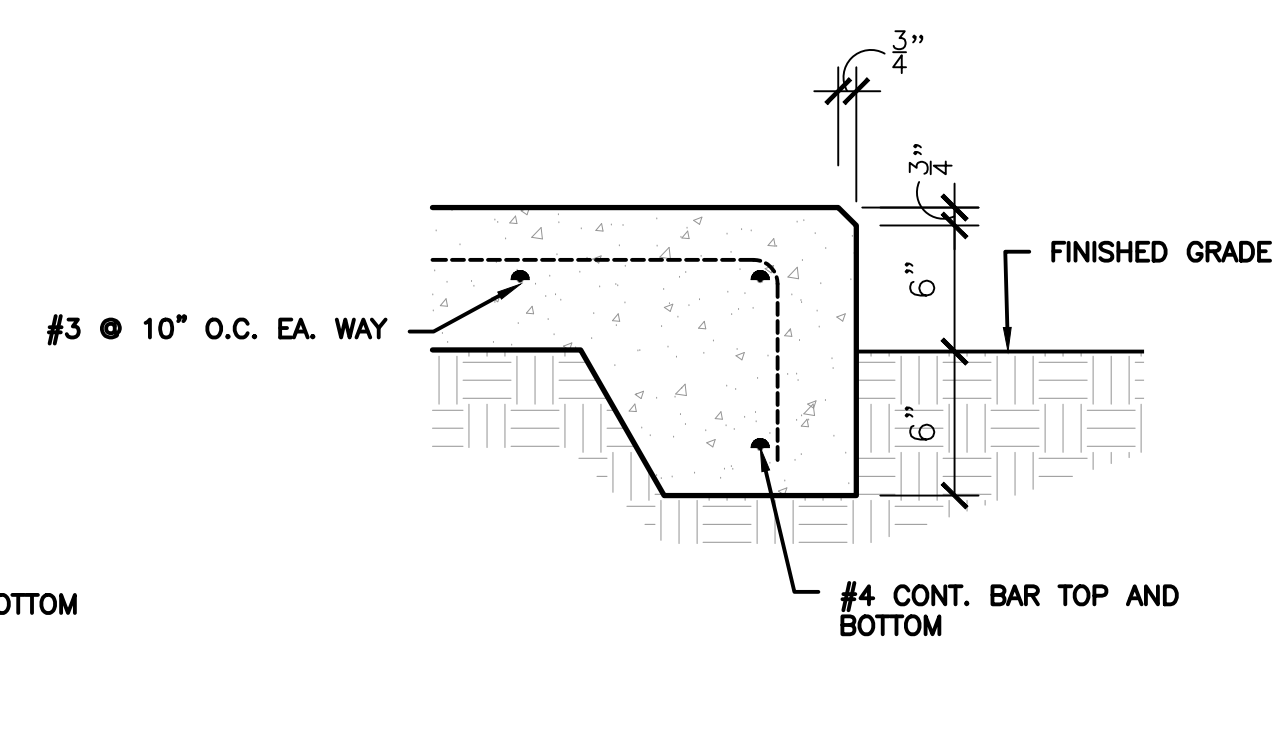


6 PACKAGED UNIT PAD DTL.  
1-1/2" = 1' - 0"


STEEL STUD WALL HEADER AND JAMB SCHEDULE							
MAX SPAN	LOCATION	HEADER TYPE	HEADER SECTIONS	JAMB SECTIONS	HEADER CONNECTION TO JAMB		
					CONNECTION TYPE	F3 SCREWS	F2 SCREWS
6'-0"	EXTERIOR WALL	A	2 - 2-600S200-54	2 - 2-600S200-54	STIFFCLIP HE-43	8-#10	4-#10

7 TYP. HEADER AND JAMB SCHEDULE  
3" = 1' - 0"

8 TYP. EXT. WALL MTL. STUD BASE MOUNTING DTL.  
NTS

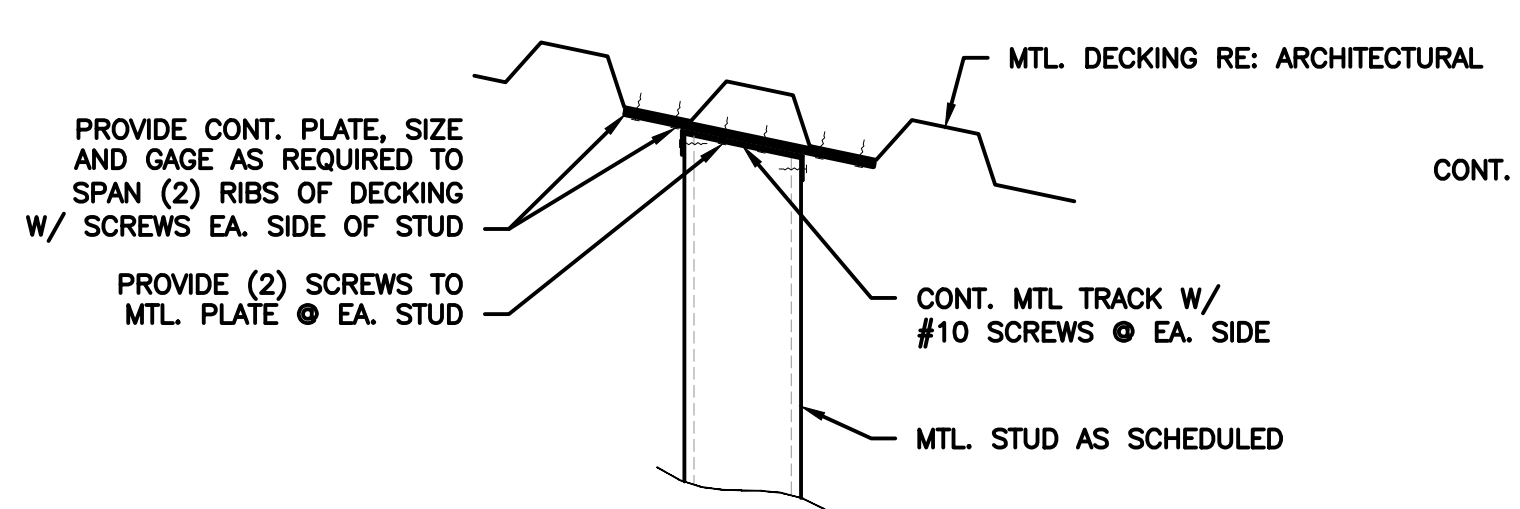


9 TYP. FRAMING DTL. - STUD @ MTL. DECKING  
NTS

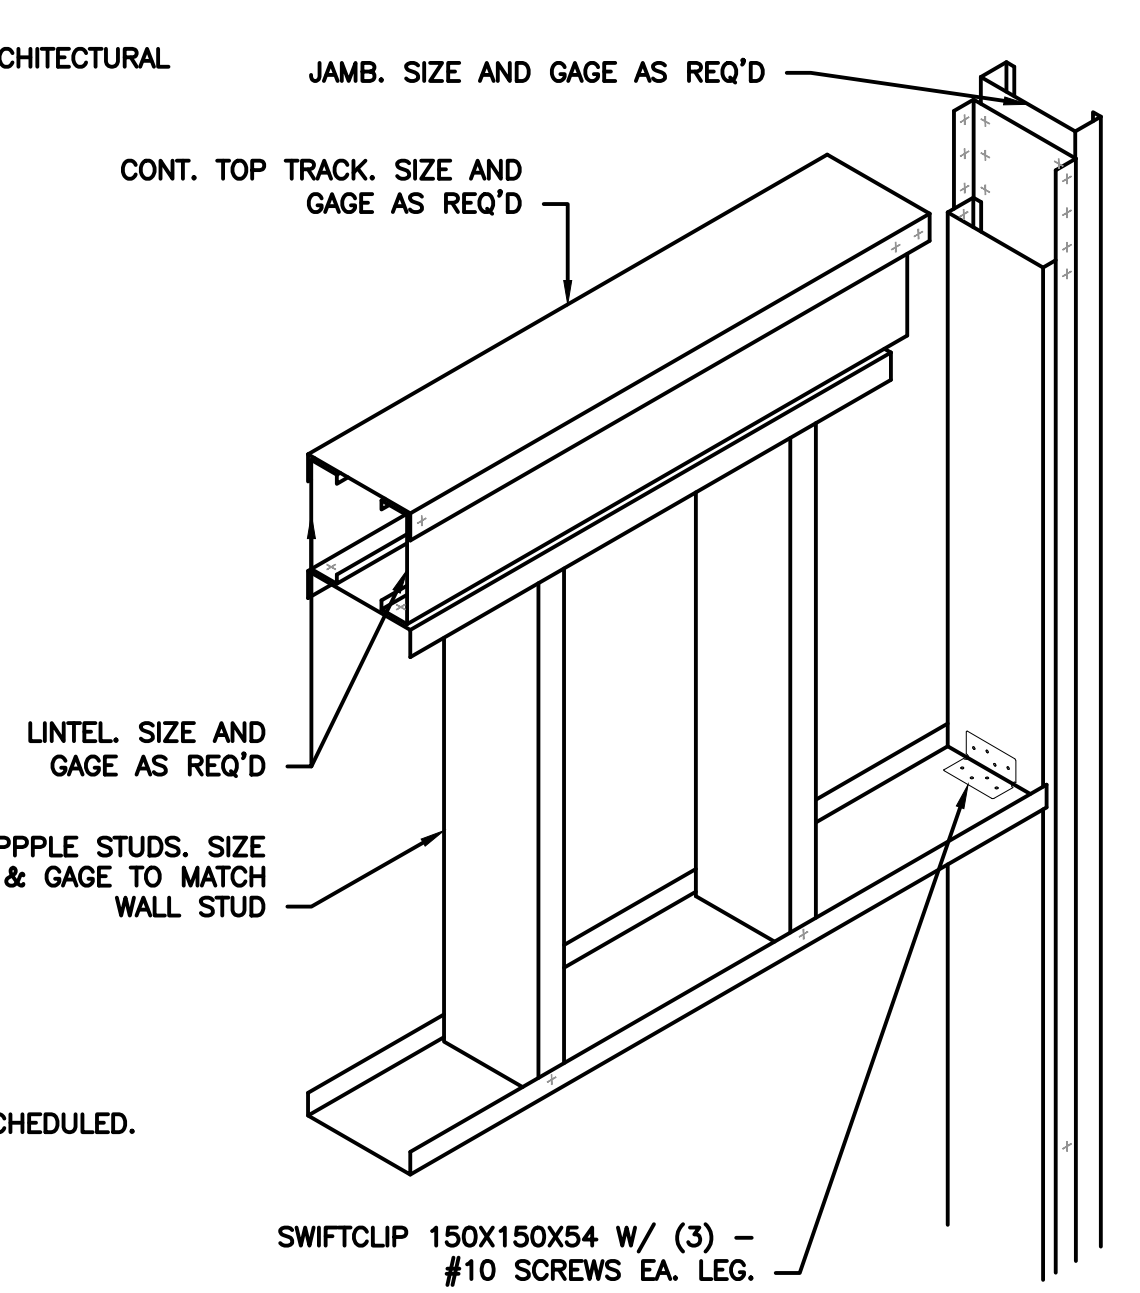

11 TYP. LOAD BEARING JAMB & HEADER DTL.  
NTS

GENERAL NOTES

- THESE DRAWINGS ARE FOR CONTRACTOR REFERENCE AND BIDDING PURPOSES ONLY. CONTRACTOR SHALL BE RESPONSIBLE FOR PROVIDING A PREFABRICATED, PRE-ENGINEERED METAL BUILDING AND CONCRETE FOUNDATION USING THE BASIS OF DESIGN PROVIDED ABOVE. CONTRACTOR SHALL SUBMIT FOR APPROVAL NECESSARY SHOP DRAWINGS OF FOUNDATION AND FRAMING COMPONENTS WITH APPROPRIATE DETAILS STAMPED BY A PROFESSIONAL ENGINEER.
- CONTRACTOR SHALL VERIFY EXISTING DIMENSIONS, EQUIPMENT, AND CONDITIONS PRIOR TO START OF WORK.
- ALL CONCRETE WORK SHALL BE PERFORMED BY THE CONTRACTOR IN ACCORDANCE WITH THE LATEST ACI STANDARD SPECIFICATIONS FOR CONCRETE AND REINFORCED CONCRETE 301-20.
- CONTRACTOR SHALL ENSURE ALL CONCRETE SHALL BE STANDARD WEIGHT AND SHALL TEST AT 3000 PSI @ 28 DAYS.
- ALL REINFORCING STEEL SHALL BE ASTM DESIGNATION A-615, GRADE 60, EXCEPT THAT GRADE 40 SHALL BE USED FOR BEAM STIRRUPS. DETAIL REINFORCING AND PROVIDE ACCESSORIES IN ACCORDANCE WITH THE LATEST ACI MANUAL OF STANDARD PRACTICE FOR DETAILING REINFORCED CONCRETE STRUCTURES.
- UNLESS NOTED OTHERWISE, WHERE REINFORCING CONTINUOUS REINFORCING IS DESIGNATED, LAP TOP AND BOTTOM BARS AT 12" MIN. STAGGER LAPS. AT NON-CONTINUOUS ENDS OF ALL BEAMS AND SLABS PROVIDE ACI RECOMMENDED 90 HOOK FOR TOP BARS, EXCEPT AT CORNERS OMIT HOOK ON EXTERIOR TOP BARS AND PROVIDE "L" BARS (EXTERIOR HORIZONTAL TOP, BOTTOM AND ALL INTERMEDIATE BARS) LAPPING 12" MIN. IN EA. DIRECTION.
- CONTRACTOR SHALL BE RESPONSIBLE FOR INSTALLING PIPE AND DUCT SLEEVES IN GRADE BEAMS AS INDICATED ON MECHANICAL, ELECTRICAL, AND PLUMBING DRAWINGS. THESE SLEEVES SHALL BE STEEL AND SHALL NOT INTERFERE WITH THE STRUCTURAL FRAMING NOR SHALL THEY IMPAIR THE STRENGTH OF THE STRUCTURE.

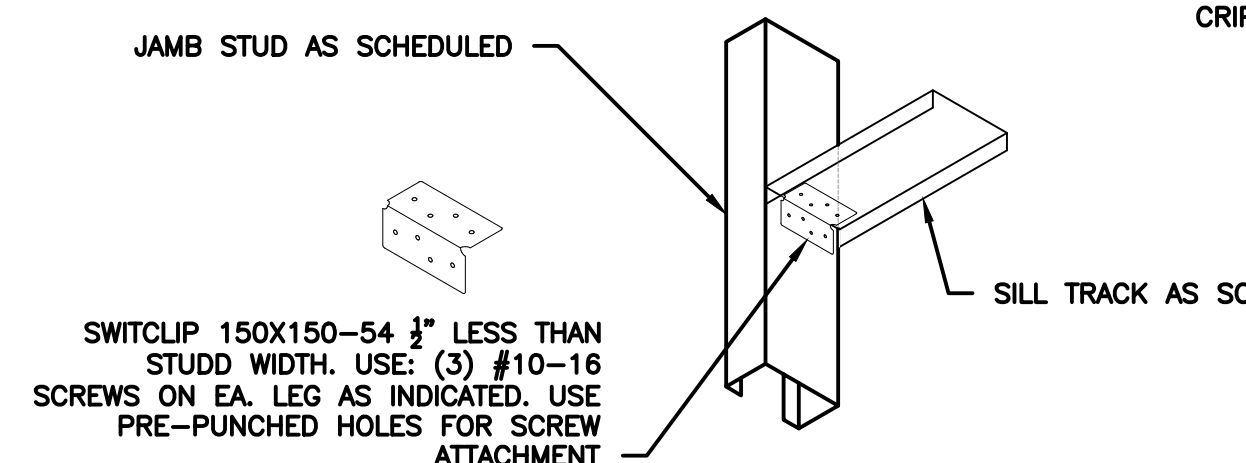

10 TYP. FRAMING DTL. - STUD @ MTL. DECKING  
NTS

DATE

REVISIONS


Designed by: JRR/MLA  
 Drawn by: JRR/MLA  
 Reviewed by: RTI/JH  
 Submitted by: PCES

PROJECT TITLE  
 FIRE STATION ADD/ALTER, B3321  
 PROJECT NO. 1039839  
 17th TRAINING WING  
 GOODFELLOW AIR FORCE BASE, TEXAS


Project Number:  
 1039839  
 SHEET TITLE  
 DETAILS  
 Date:  
 JAN 2024

SEQ. SHEET OF  
 08 S-501 50




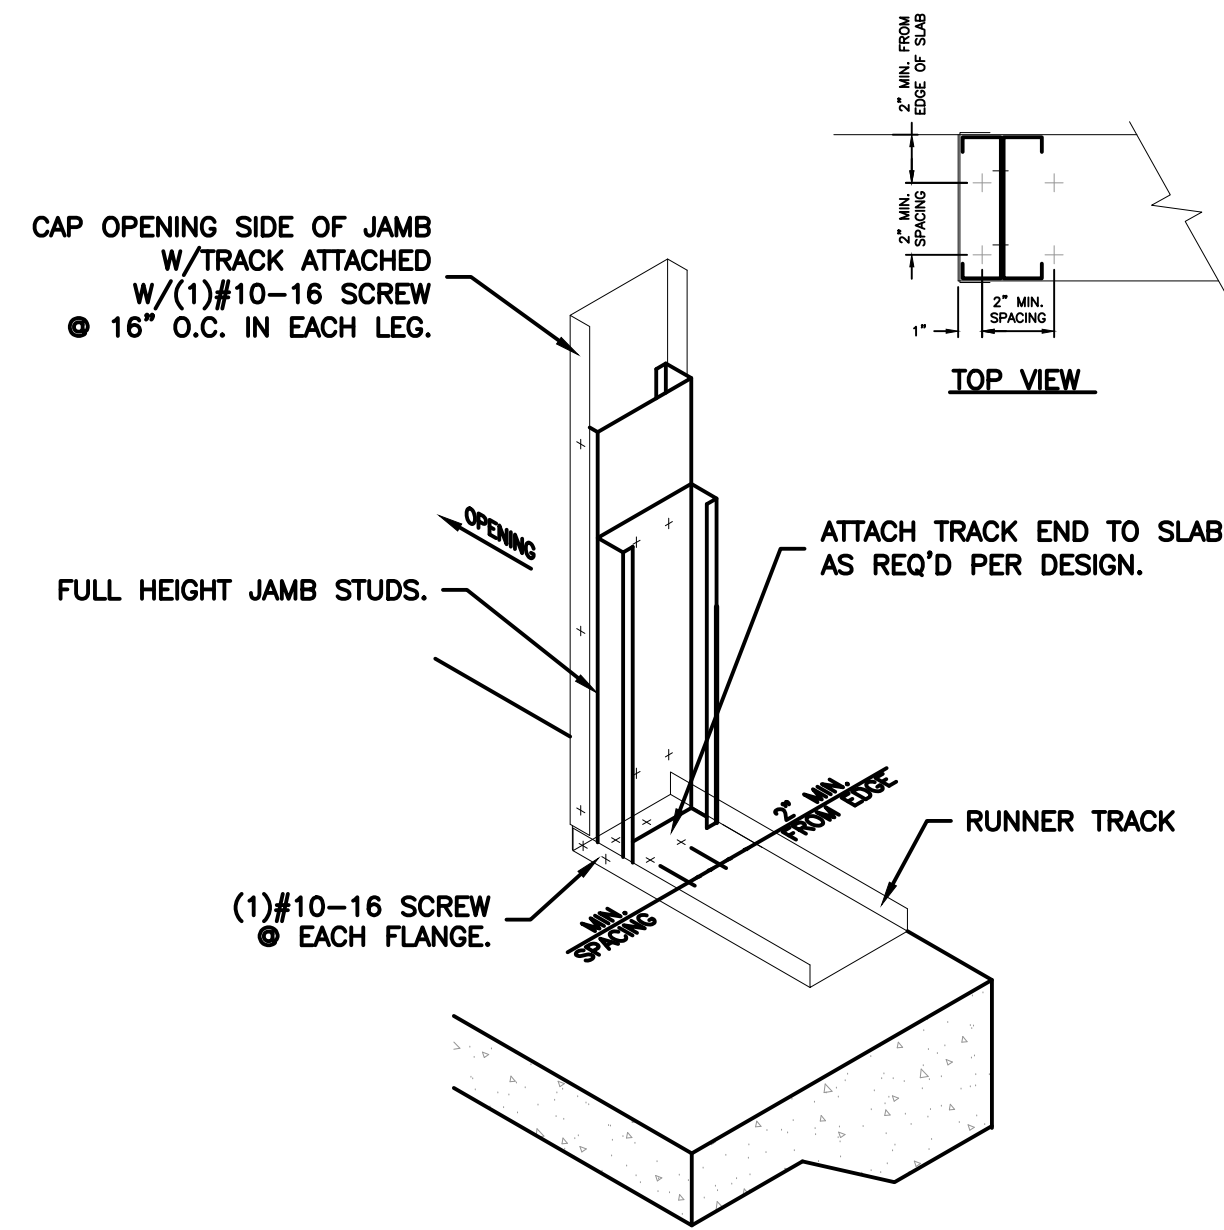


1 DOOR JAMB ANCHORAGE DTL. NTS

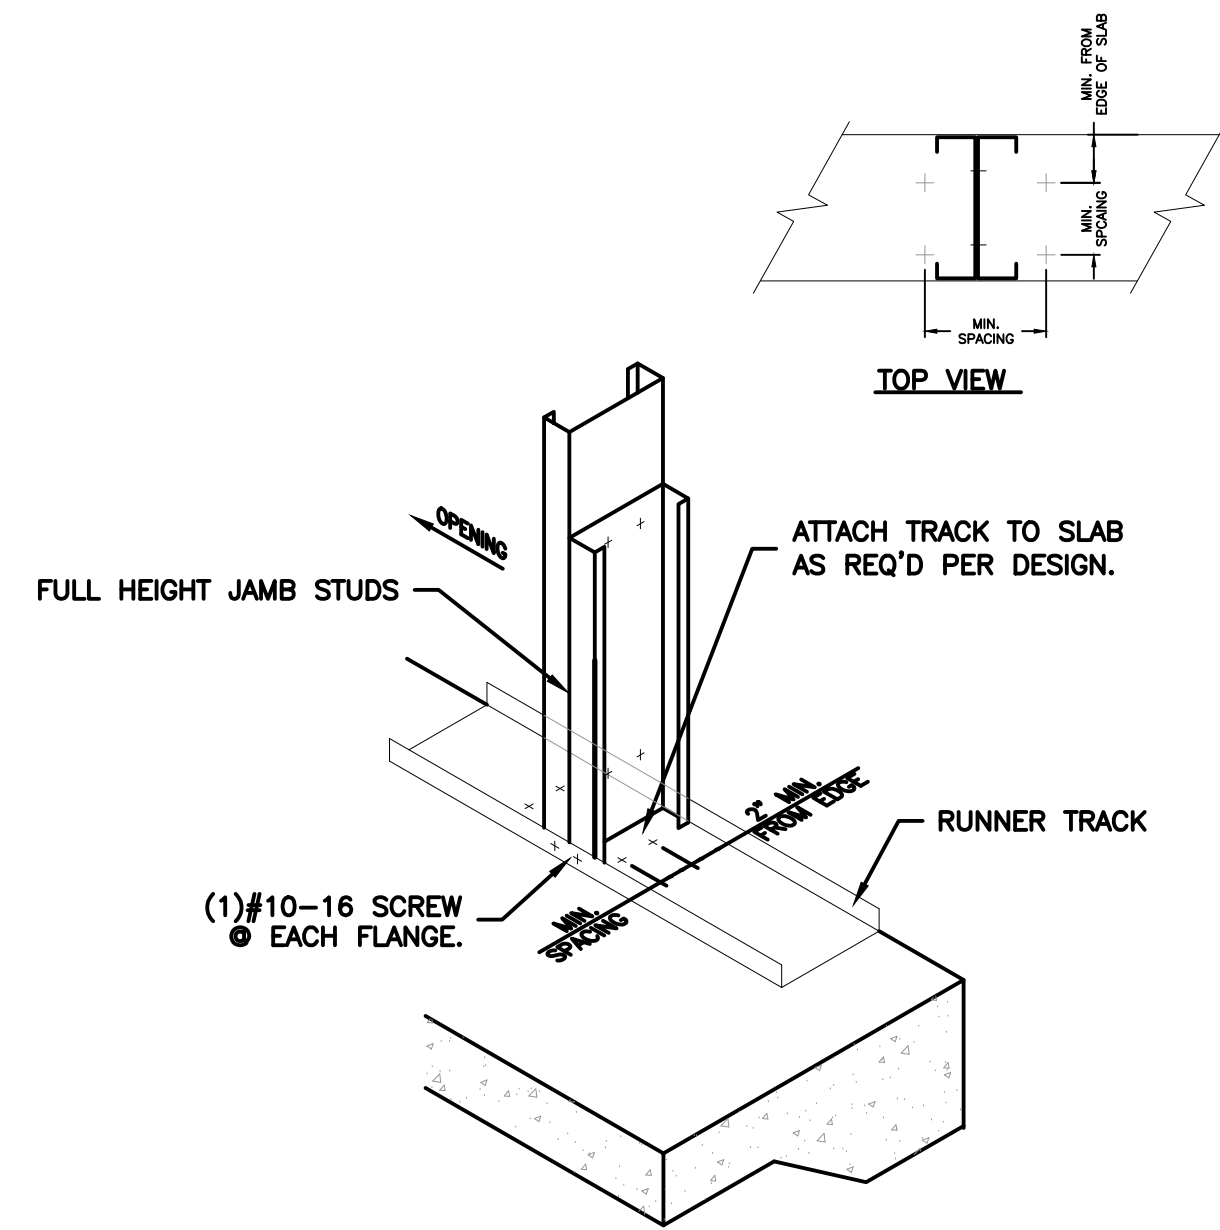


2 WINDOW JAMB ANCHORAGE DTL. NTS

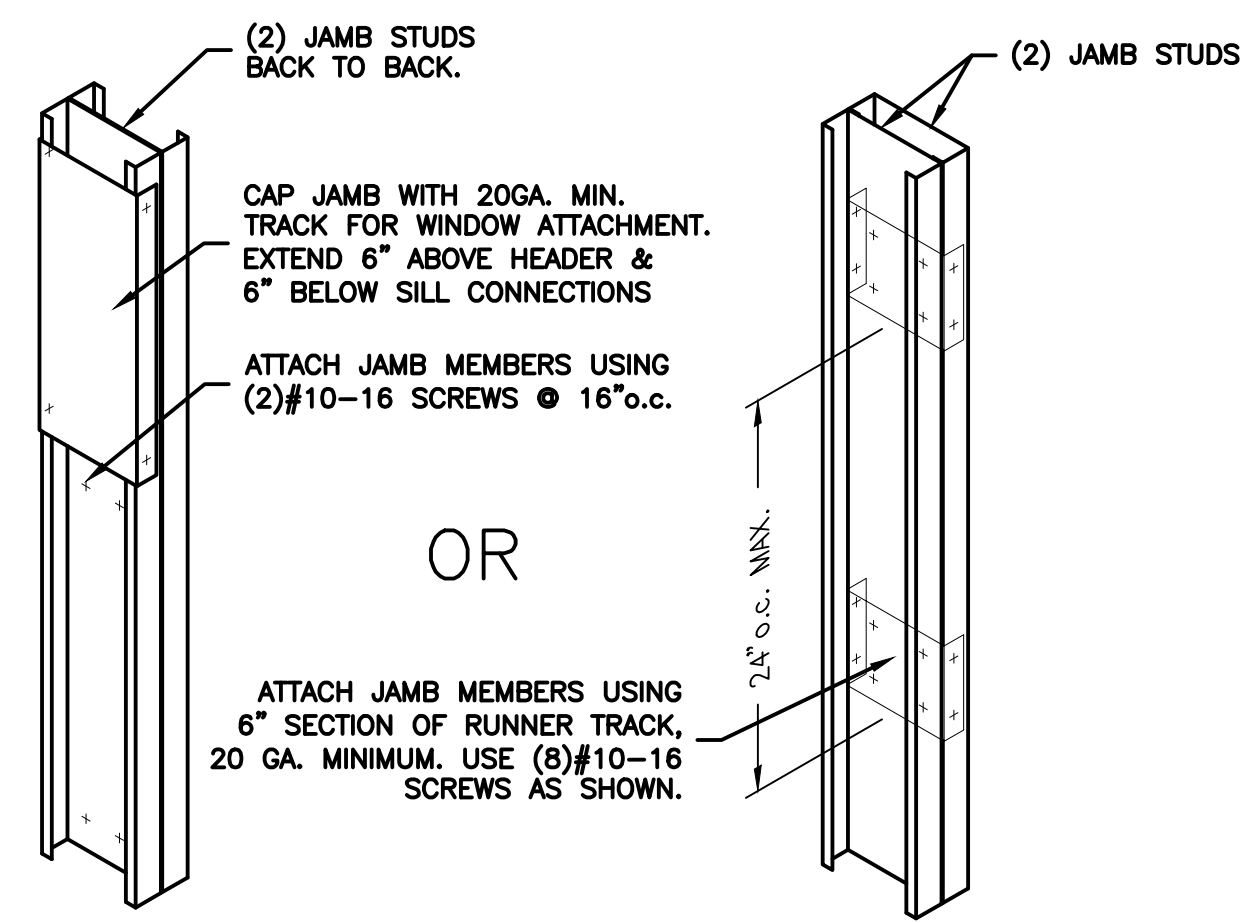


3 TYP. TIED JAMB STUD DTL. NTS

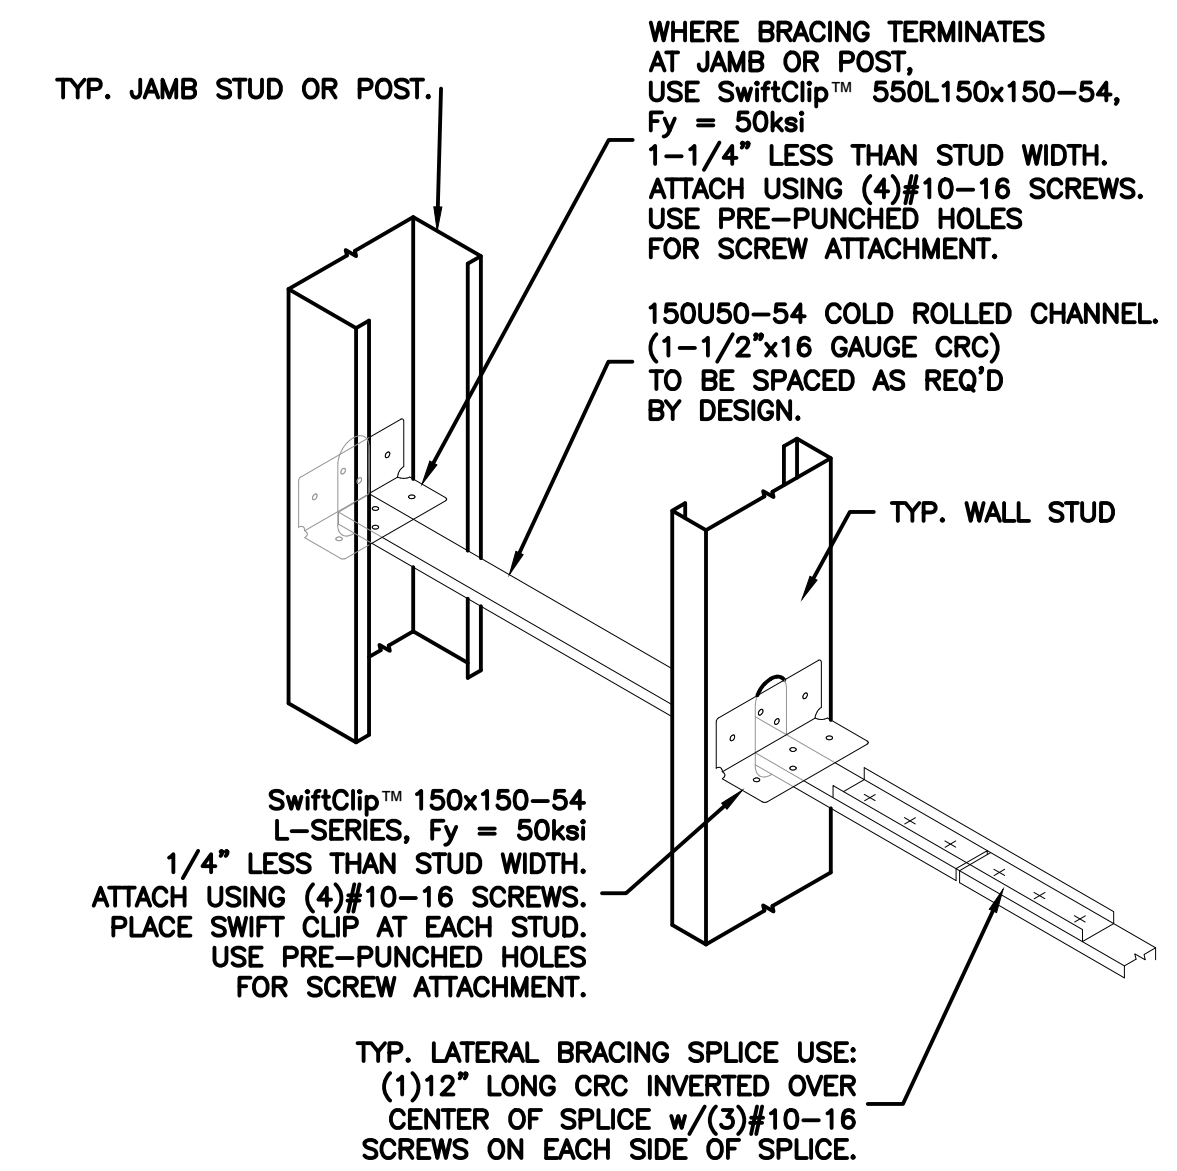


4 TYP. LATERAL BRACING DTL. NTS

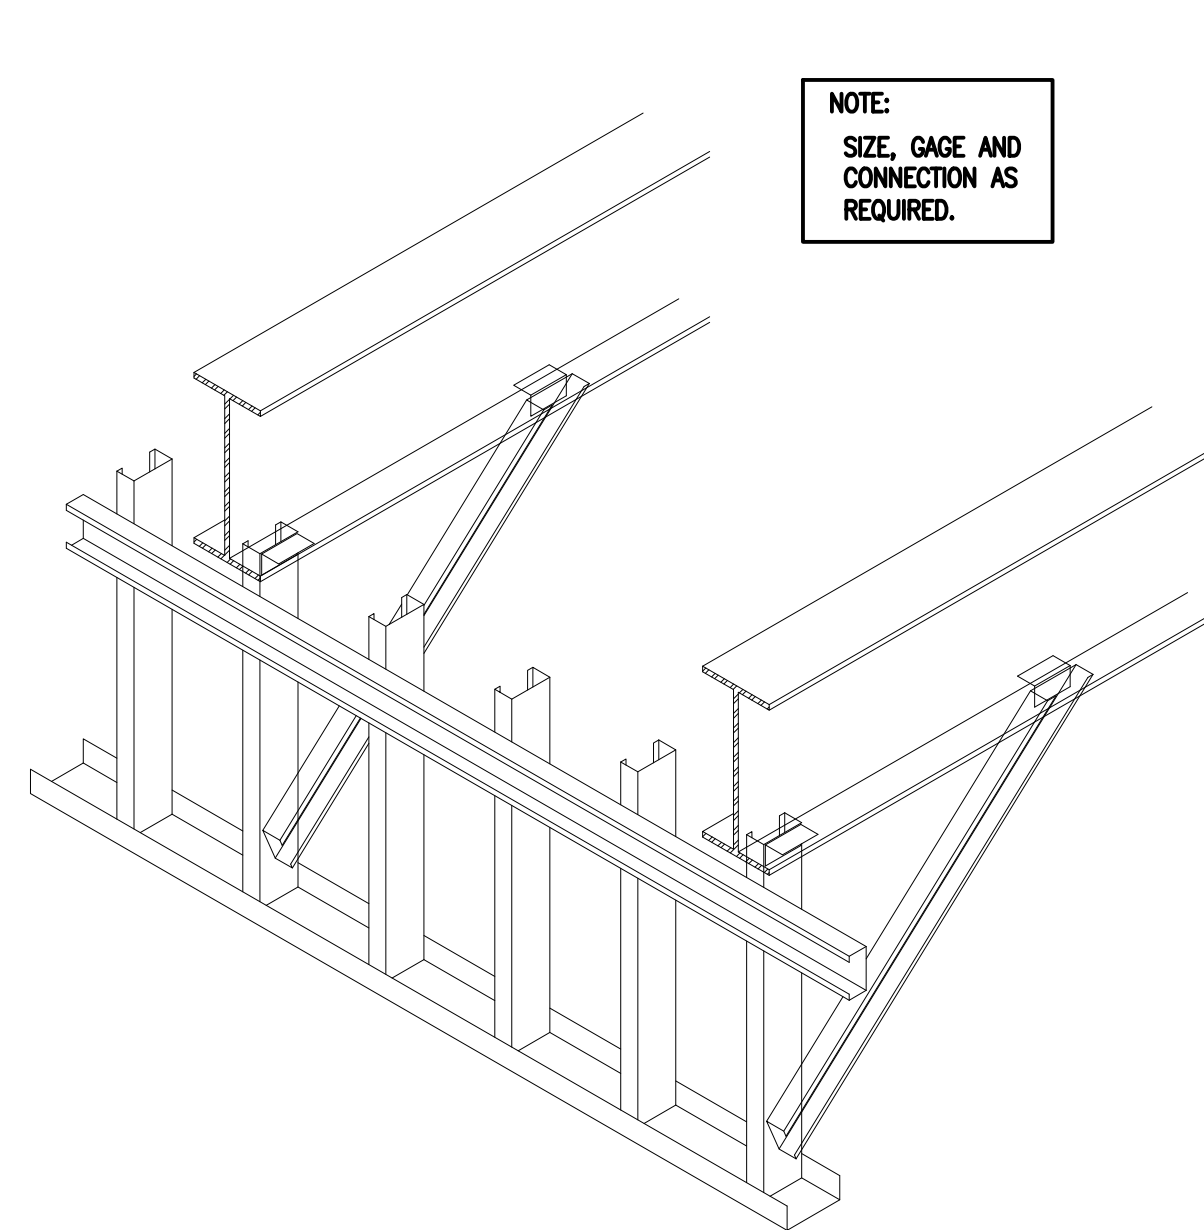


5 FASCIA DTL AT KICKED WALL NTS

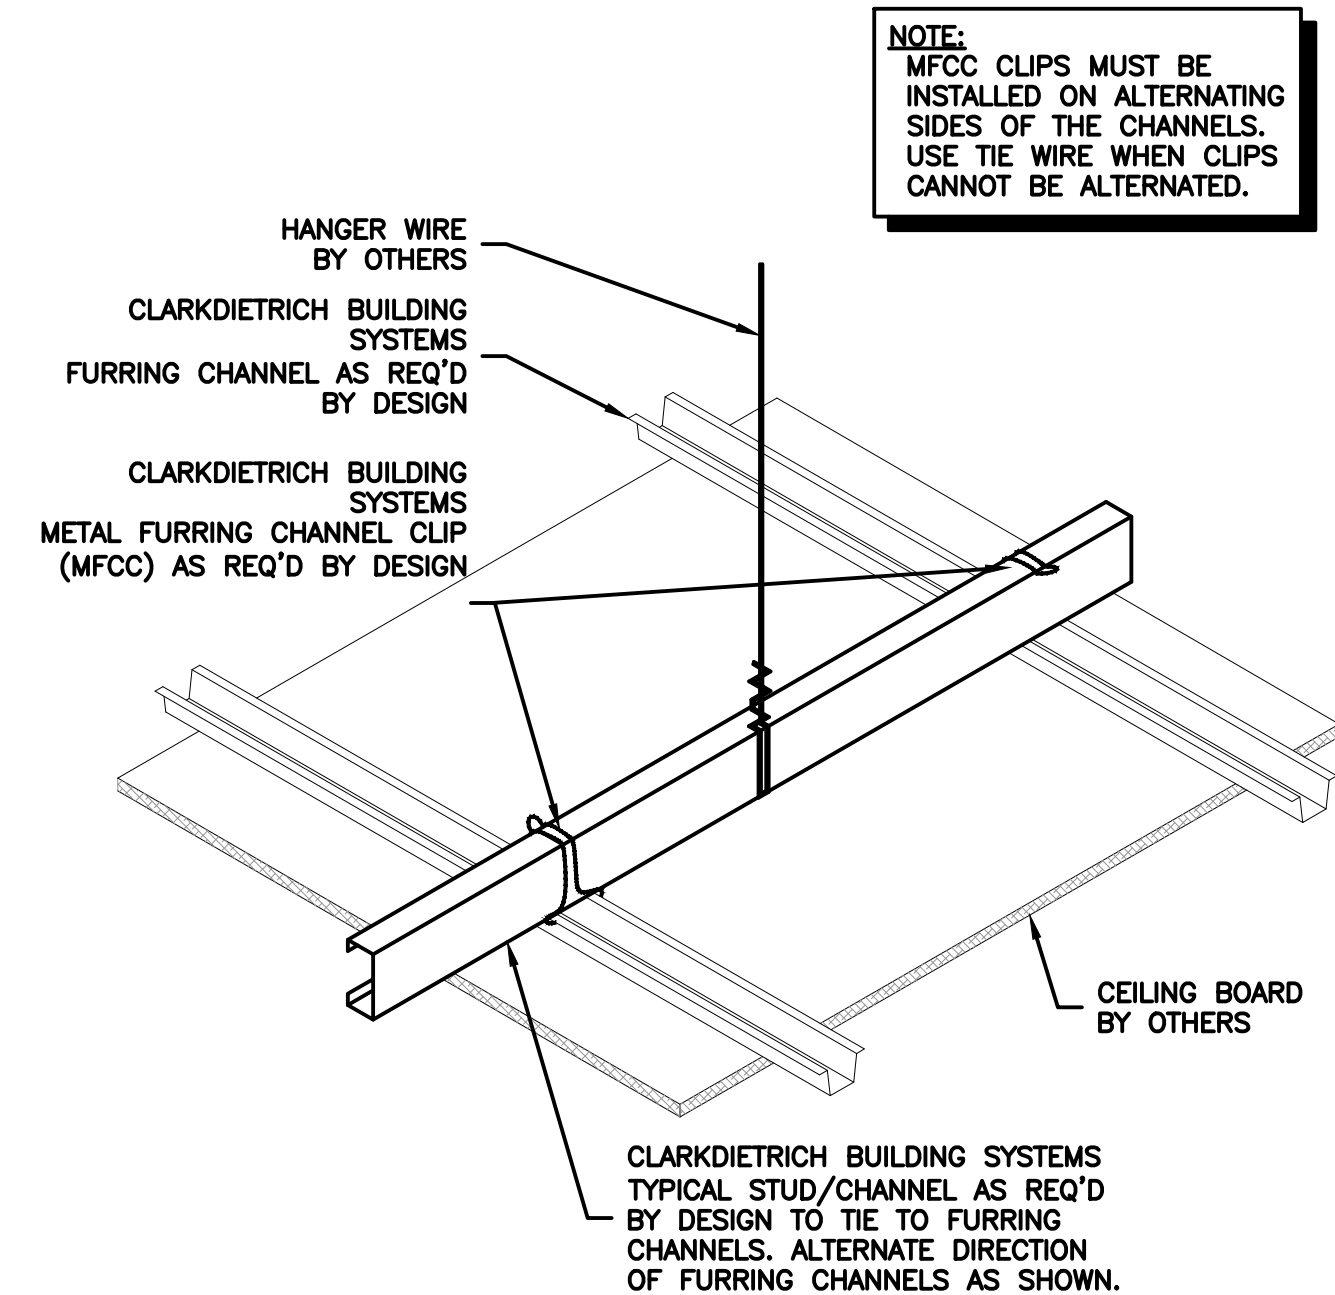


6 SUSP. CLG. FRAMING DTL - MTL FURRING CHANNELS NTS

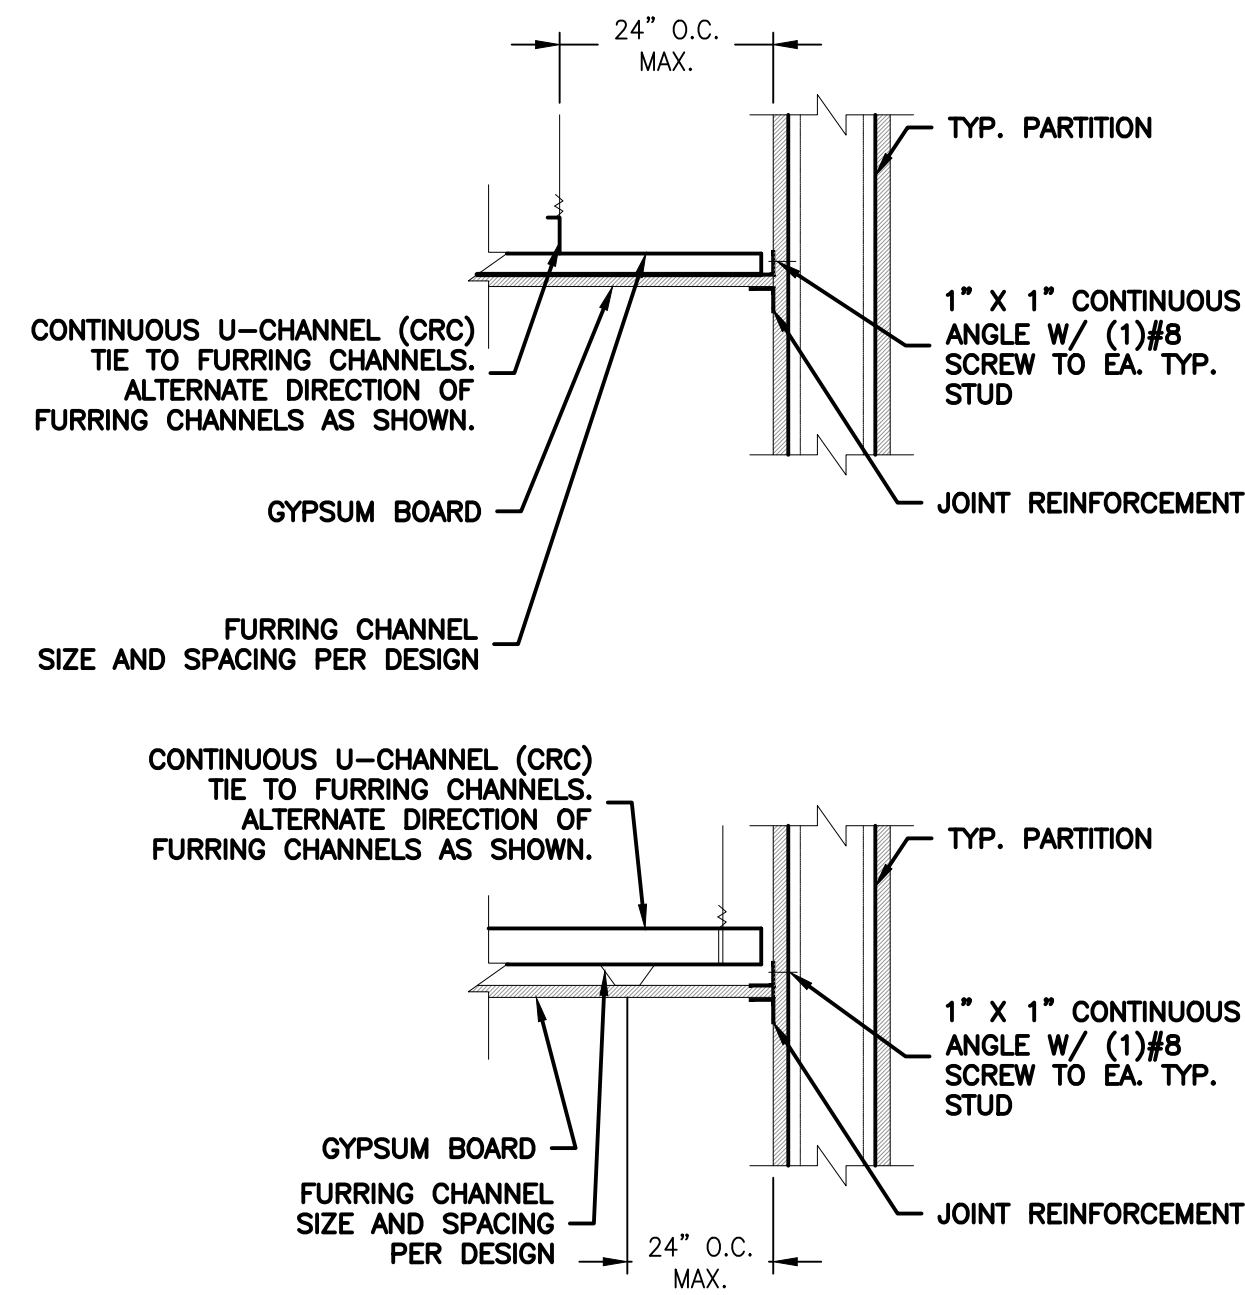


7 SUSP. CLG. FRAMING DTL - CEILING SECTION NTS

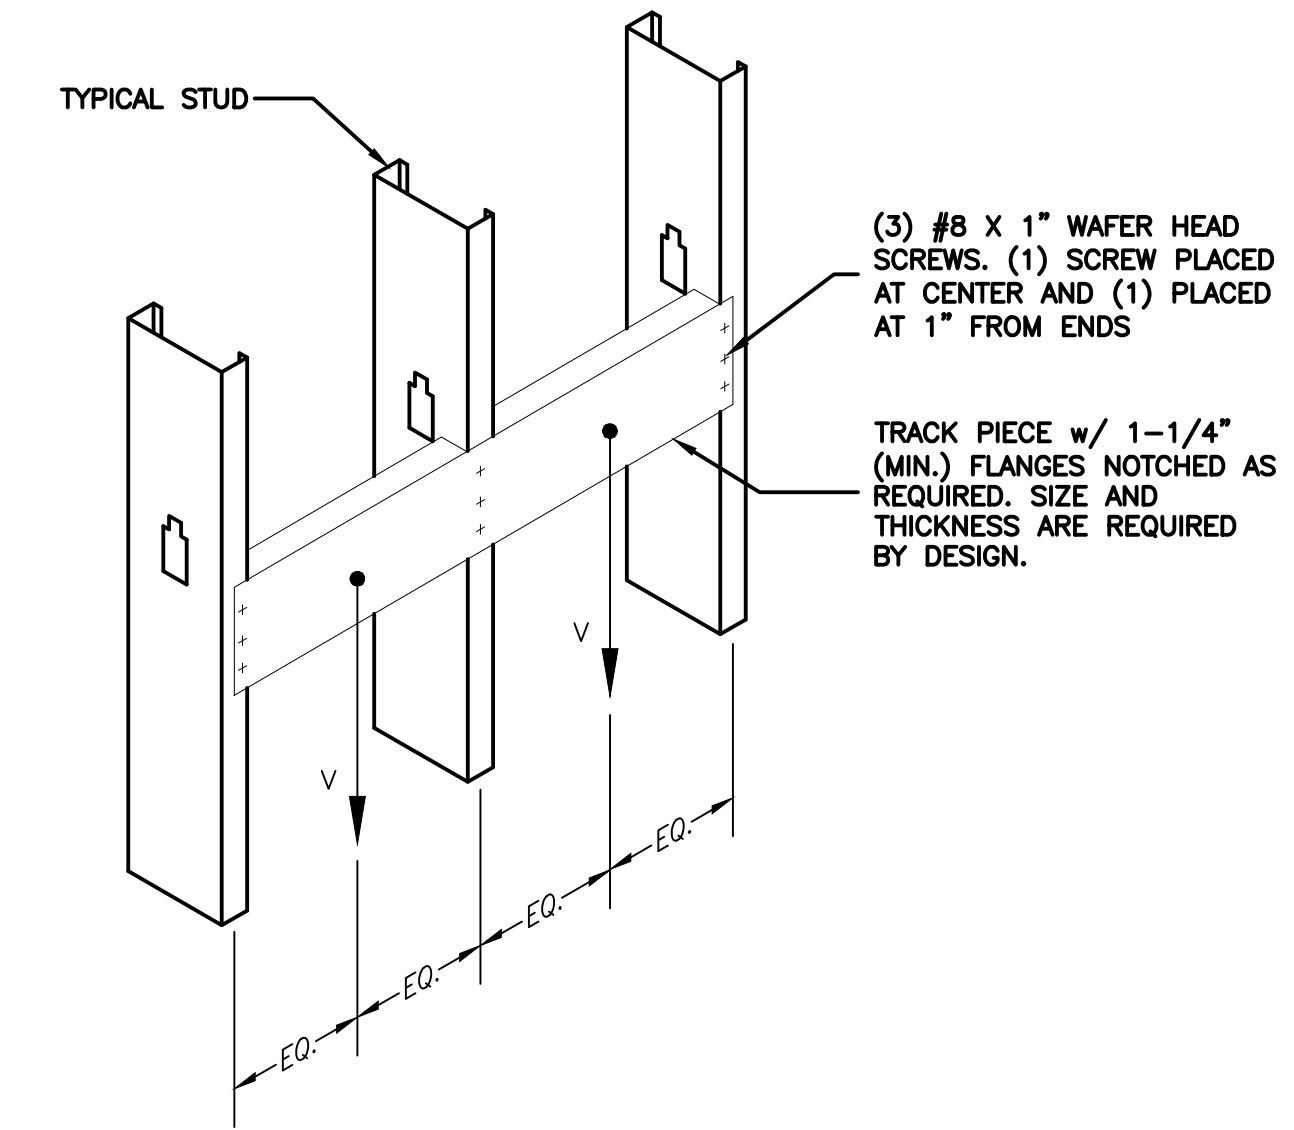

8 BACKING PLATE DTL. NTS

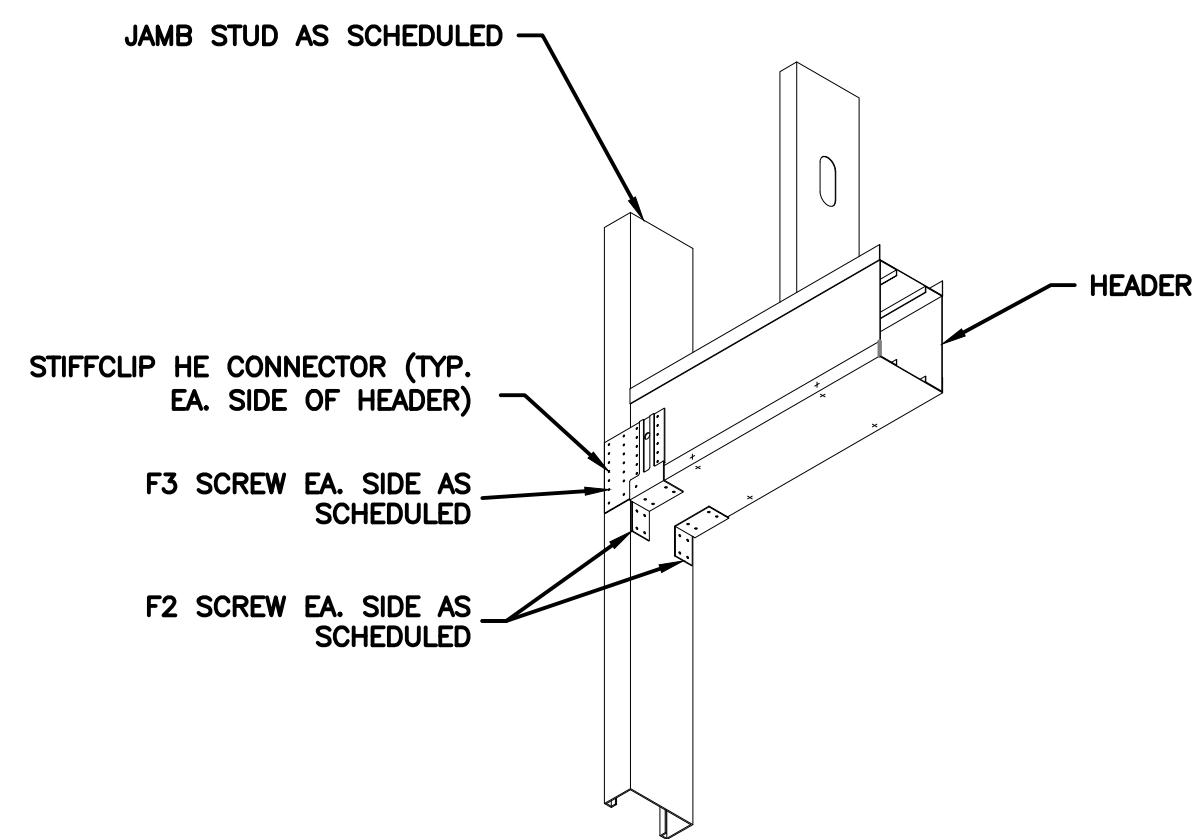

9 BOXED HEADER CONNECTION DTL. NTS

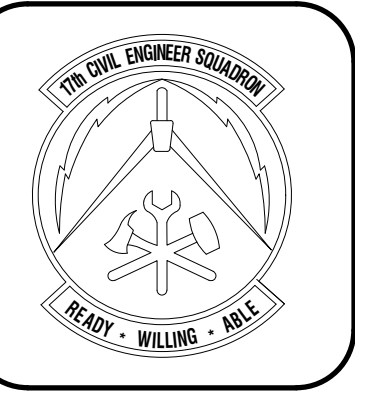

DATE	
REVISIONS	

Designed by	J.H.R.L.A.
Drawn by	J.H.R.L.A.
Reviewed by	RTI/JH
Submitted by	PCBS

PROJECT TITLE  
**FIRE STATION ADD/ALTER, B3321**  
**PROJECT NO. 1039839**  
**17th TRAINING WING**  
**GOODFELLOW AIR FORCE BASE, TEXAS**

Project Number	1039839
SHEET TITLE	DETAILS
Date	JAN 2024

SEQ.	SHEET	OF
09	S-502	50

**GENERAL NOTES:**

GENERAL NOTES:

1. CONSTRUCTION ACCESS TO THE BASE SHALL BE THROUGH THE EXISTING GATE LOCATED ON SOUTH CHADBOURNE STREET. ALL CONSTRUCTION TRAFFIC ENTERING THE BASE IS REQUIRED TO PASS THROUGH THE COMMERCIAL VEHICLE SEARCH AREA LOCATED TO THE EAST OF KEARNEY BOULEVARD. HOURS OF OPERATION ARE FROM 6:00 A.M. TO 2:00 P.M. MONDAY THROUGH FRIDAY, PHONE 325-654-1290.
2. CONTRACTORS SHALL KEEP ALL PUBLIC ROADS AND STREETS CLEAN OF CONSTRUCTION DEBRIS, MUD, ETC. AT ALL TIMES. CONTRACTOR SHALL PROVIDE EQUIPMENT AND PERSONNEL TO CLEAN ANY STREETS AS REQUESTED BY 17CES. CONTRACTOR IS RESPONSIBLE FOR ALL REPAIRS TO STREETS, PARKING AREAS AND BASE OR GOVERNMENT PROPERTY DAMAGED FROM THEIR CONSTRUCTION ACTIVITIES.
3. CONTRACTORS SHALL MAINTAIN A CONSTRUCTION SITE NEAT AND CLEAN OF DEBRIS AS DIRECTED BY CONTRACTING OFFICER. CONTRACTOR WASTE DUMPSTERS SHALL BE EMPTIED ON A REGULAR BASIS.

STAGING NOTES:

1. CONTRACTOR SHALL INSTALL AND MAINTAIN A TEMPORARY CONSTRUCTION CHAIN LINK FENCE, 6 FEET HIGH, AROUND THE LIMITS OF WORK NOT INCLUDING THE CONSTRUCTION ACCESS ROAD. COORDINATE CHAIN AND PADLOCKS ON GATES WITH GOODFELLOW FIRE DEPARTMENT. EACH GATE SHALL BE NUMBERED FOR EMERGENCY ACCESS. SHALL HAVE ENTRY/EGRESS SIGNAGE AND AREA LIGHTING. CONTRACTORS SHALL MAINTAIN FIRE ACCESS THROUGH EACH INDIVIDUAL CONSTRUCTION SITE AT ALL TIMES. CONTRACTOR SHALL MAINTAIN FIRE ACCESS TO EXISTING FIRE HYDRANTS ON SITE.
2. TRUCK WASHOUT AREA SHALL BE CONSTRUCTED, MAINTAINED AND CLEANED IN ACCORDANCE WITH TEXAS TCEQ REGULATIONS. PROVIDE DETAILS AND MAINTENANCE PLAN AS PART OF THE STORMWATER POLLUTION PREVENTION PLAN. STORMWATER PERMITS ARE REQUIRED PRIOR TO THE START OF CONSTRUCTION.
3. ALL CONTRACTORS SHALL STOCKPILE REQUIRED MATERIALS AND EQUIPMENT WITHIN LIMITS OF RESPECTIVE PROJECT AREAS OR STAGING AREA AS INDICATED ON THE DRAWINGS.
4. CONTRACTOR SHALL CONNECT TO EXISTING OR NEW FIRE HYDRANTS FOR TEMPORARY CONSTRUCTION WATER. INSTALL QUICK DISCONNECT, BACK FLOW PREVENTER AND SHUT-OFF VALVE ON 1 1/2" HOSE CONNECTION ONLY, PRIOR TO MAKING ANY CONNECTIONS TO BASE WATER SYSTEMS, THE CONTRACTOR MUST NOTIFY AND COORDINATE WITH 17CES. A FIRE PLUG USAGE PERMIT IS REQUIRED AND USAGE SHALL BE METERED AT ALL TIMES.
5. ALL TEMPORARY ELECTRIC POWER FACILITIES SHALL MEET OR EXCEED NESC AND NEC REQUIREMENTS AS APPLICABLE FOR PRIMARY AND SECONDARY FACILITIES.

ACCESS AND VEHICLE PARKING:

1. ACCESS TO THE PROJECT FOR ALL CONSTRUCTION PERSONNEL, VEHICLES AND EQUIPMENT IS ILLUSTRATED ON THE STAGING/LAYDOWN AND ACCESS PLAN. ACCESS ROUTES MAY BE SUBJECT TO CHANGE BASED ON OPERATIONAL REQUIREMENTS. POTENTIAL SCHEDULE IMPACTS SHALL BE COORDINATED WITH 17CES.
2. LOCATION OF ACCESS/HAUL ROADS ARE AS INDICATED ON SHEET G-001 AND G-002.
3. ALL HAUL ROADS SHALL BE MAINTAINED SUCH THAT UNOBSTRUCTED ACCESS WILL BE PROVIDED AT ALL TIMES FROM THE ROAD TO THE STAGING AREA TO THE WORK SITE AND FACILITATE GOVERNMENT ACCESS TO THE BASE AT ALL TIMES. THE MAINTENANCE OF HAUL ROADS SHALL BE THE RESPONSIBILITY OF THE CONTRACTOR AT NO ADDITIONAL COST TO THE GOVERNMENT. THE HAUL ROAD LOCATIONS SHALL BE AS INDICATED ON SHEET G-001 AND G-002.
4. CONTRACTOR SHALL COORDINATE ACTIVITIES THROUGHOUT THE PROJECT IN A MANNER THAT ALLOWS EMERGENCY ACCESS TO ALL EXISTING ROADWAYS AT ALL TIMES WITHOUT DELAYS TO EMERGENCY VEHICLES RESPONSE TIME.
5. ALL CONTRACTOR VEHICLES AND PERSONNEL MAY BE SEARCHED BY SECURITY FORCES WHEN ENTERING THE BASE AND MAY EXPERIENCE DELAYS. ALL PERSONNEL ENTERING GOODFELLOW AFB. MUST HAVE A VALID PHOTO ID PER BASE SECURITY REQUIREMENTS. ALL VEHICLES ENTERING THE BASE MUST HAVE CURRENT/VALID REGISTRATION, CURRENT/VALID INSURANCE AND CURRENT/VALID INSURANCE AND CURRENT/VALID DRIVERS LICENSE FOR THE OPERATOR. ALL DRIVERS MUST COMPLY WITH ALL GOODFELLOW AFB DRIVING REQUIREMENTS (SPEED LIMITS, SEATBELTS, ETC.)
6. WHEN NOT ENGAGED IN CONSTRUCTION ACTIVITIES, THE CONTRACTOR'S CONSTRUCTION EQUIPMENT AND VEHICLES SHALL BE PARKED WITHIN THE WORK AREA OR STAGING AREA.
7. THE CONTRACTOR SHALL ENSURE 24 HOUR ACCESS TO VANCE ST. TO AVOID DISRUPTION TO EMERGENCY SERVICES. VANCE ST. SHALL MAINTAIN OPERABILITY THROUGHOUT THE LIFE OF THE CONTRACT.

COORDINATION AND COMMUNICATION DURING CONSTRUCTION:

1. PRIOR TO CONSTRUCTION, THE CONTRACTOR SHALL CORDON OFF THE WORK AREAS AND STREET CROSSINGS BY USING APPROVED BARRICADES.

TRAFFIC CONTROL:

1. ONLY RUBBER-TIRED VEHICLES SHALL BE ALLOWED ON EXISTING PAVEMENT THAT IS TO REMAIN.
2. ANY DAMAGE TO ROADS AND PAVEMENT DUE TO CONSTRUCTION EQUIPMENT, CONSTRUCTION TRAFFIC OR CONSTRUCTION ACTIVITY SHALL BE REPAIRED TO THEIR ORIGINAL CONDITION BY THE CONTRACTOR AT HIS/HER OWN EXPENSE.

EQUIPMENT AND STOCKPILE HEIGHT:

1. STOCKPILE ALL CONSTRUCTION MATERIALS WITHIN STAGING AREA. MAXIMUM HEIGHT 15.00' WITH 5:1 SIDE SLOPES. PROVIDE EROSION CONTROL PROTECTION AROUND THE STOCKPILE LIMITS. ANY MATERIALS THAT ARE TO BE STOCKPILED FOR USE FOR OTHER PROJECTS ON THE BASE SHALL BE COORDINATED WITH 17CES. ALL MATERIAL NOT REQUIRED SHALL BE HAULED OFF GOVERNMENT PROPERTY.

EXCAVATION AND TRENCHES:

1. OPEN TRENCHES AND EXCAVATIONS AT THE CONSTRUCTION SITE SHALL BE PROMINENTLY MARKED WITH ORANGE AND WHITE TYPE III BARRICADES AND WITH FLASHING TYPE A-LOW INTENSITY WARNING LIGHTS FROM DUSK TILL DAWN.

OTHER SAFETY REQUIREMENTS:

1. CONTRACTOR SHALL MAINTAIN SAFETY PRACTICES THAT CONFORM TO OCCUPATIONAL SAFETY AND HEALTH ADMINISTRATION (OSHA) REGULATIONS.
2. CONTRACTOR SHALL MAINTAIN AT ALL TIMES ONE FIRE LANE FREE FROM OBSTRUCTION AND MAINTAIN ACCESS TO THE SITE AND ALL SURROUNDING ROADS AND STREETS.

CONTRACTOR SAFETY PLAN SUBMITTALS

1. CONTRACTOR SHALL FURNISH A CONSTRUCTION SAFETY PLAN IN ACCORDANCE WITH THE SPECIFICATIONS WITH THE PROJECT SCHEDULE. THE SAFETY PLAN SHALL IDENTIFY THE FOLLOWING ITEMS:
  - 1.1. PROPOSED ACCESS POINTS, STAGING AREA AND HAUL ROUTES.
  - 1.2. TEMPORARY MARKINGS TO BE USED, IF ANY.
  - 1.3. LOCATIONS AND TYPE OF BARRICADES OR OTHER TRAFFIC CONTROL DEVICES.
  - 1.4. METHODS BY WHICH THE CONTRACTOR WILL COMMUNICATE WITH 17 CES.

MAINTENANCE OF STORAGE AREA

1. THE CONTRACTOR SHALL AT ALL TIMES KEEP THE CONSTRUCTION SITE, CONSTRUCTION TRAILER(S)/BUILDING(S), AND STORAGE AREA(S) IN A CLEAN, NEAT, WORKMAN LIKE CONDITION, FREE FROM ACCUMULATION OF WASTE, RUBBISH, WEEDS, OVERGROWN GRASS, OR CONSTRUCTION DEBRIS, TO THE SATISFACTION OF THE CONTRACTING OFFICER. ALL LOOSE OR LIGHT WEIGHT MATERIALS SHALL BE SECURED

TO PREVENT BLOWING OR SCATTERING. THE BURNING OF TRASH OR CONSTRUCTION DEBRIS IS STRICTLY PROHIBITED ON GOODFELLOW AFB. PRIOR TO FINAL INSPECTION, THE CONTRACTOR SHALL REMOVE ALL CONSTRUCTION DEBRIS, TOOLS, EQUIPMENT, AND MATERIALS NOT THE PROPERTY OF THE GOVERNMENT. UPON COMPLETION OF THE WORK, THE CONTRACTOR SHALL LEAVE THE WORK SITE AND STORAGE AREA(S) IN A CLEAN, NEAT, AND WORKMANLIKE CONDITION SATISFACTORY TO THE CONTRACTING OFFICER. REFER TO STATEMENT OF WORK.

2. THE CONTRACTOR SHALL KEEP FENCING IN A STATE OF GOOD REPAIR AND PROPER ALIGNMENT. GRASSED OR UNPAVED AREAS, WHICH ARE NOT ESTABLISHED ROADWAYS, WILL BE COVERED WITH A LAYER OF GRAVEL AS NECESSARY TO PREVENT RUTTING AND THE TRACKING OG MUD ONTO PAVED OR ESTABLISHED ROADWAYS. SHOULD THE CONTRACTOR ELECT TO TRAVERSE THEM WITH CONSTRUCTION EQUIPMENT OR OTHER VEHICLES; GRAVEL GRADATION WILL BE AT THE CONTRACTOR'S DISCRETION. MOW AND MAINTAIN GRASS LOCATION WITHIN THE BOUNDARIES OF THE CONSTRUCTION SITE FOR THE DURATION OF THE PROJECT. GRASS AND VEGETATION ALONG FENCES, BUILDINGS, UNDER TRAILERS, AND IN AREAS NOT ACCESSIBLE TO MOWERS WILL BE EDGED OR TRIMMED NEATLY.
3. GRASS AND WEEDY VEGETATION WITHIN THE AREAS UTILIZED BY THE CONTRACTOR, INCLUDING WORK AREAS, ADMINISTRATIVE AREAS, AND STORAGE AREAS, SHALL BE KEPT MOWED TO CONTROL VEGETATION GROWTH. VEGETATION SHALL BE MOWED WHEN IT REACHES A HEIGHT OF 6 INCHES. MOWING SHALL BE TO A HEIGHT OF 3 INCHES. MOVING SHALL BE ACCOMPLISHED WITH A ROTARY MOWER THAT LEAVES THE CLIPPINGS EVENLY DISTRIBUTED ON THE SOIL SURFACE. MOWING SHALL BE ACCOMPLISHED DURING PERIODS AND IN SUCH A MANNER THAT THE SOIL AND GRASS WILL NOT BE DAMAGED. TOWED OR SELF-PROPELLED RIDING MOWERS SHALL NOT BE OPERATED WITHIN 3 FEET OF TREES OR SHRUBS. AREAS ADJACENT TO TREES AND SHRUBS SHALL BE MOWED WITH HAND-PROPELLED MOWERS.
4. EROSION CONTROL DEVICES SHALL BE USED FOR THE STAGING AREA AND ANY MATERIAL STOCK PILES WHEN NECESSARY TO CONTROL EROSION AND STORM WATER RUNOFF IN ACCORDANCE WITH FEDERAL, STATE, AND LOCAL REGULATIONS.
5. AREAS NOT MOWED: GOVERNMENT MAY IMMEDIATELY AFTER NOTICE TO THE CONTRACTOR AND THE DISCRETION OF THE CONTRACTING OFFICER MOW THE CONTRACTOR'S AREAS AT ANY TIME THE VEGETATION HEIGHT EXCEEDS 6 INCHES.

WATERING

1. THE CONTRACTOR SHALL COMPLY WITH THE CURRENT CITY OF SAN ANGELO, TEXAS WATER CONSERVATION AND DROUGHT CONTINGENCY PLAN FOR ALL ON BASE WATER USAGE.
2. EXISTING INFORMATION SHOWN WAS TAKEN FROM AS BUILT DRAWINGS PROVIDED BY GOODFELLOW AIR FOR BASE (GAFB) AND A WALK-THRU OF THE FACILITY. THE CONTRACTOR SHALL FIELD VERIFY THE EXISTING CONDITIONS PRIOR TO BID AND NOTIFY THE CONTRACTING OFFICER OF ANY SUBSTANTIAL DISCREPANCIES WHICH WOULD IMPACT BASIS OF DESIGN AND CONSTRUCTION.
3. CONTRACTOR SHALL VISIT THE JOB SITE TO FAMILIARIZE THEMSELVES WITH EXISTING CONDITIONS AND TO VERIFY LOCATIONS, SIZE AND QUANTITIES OF EXISTING UTILITIES, MECHANICAL SYSTEMS, PLUMBING SYSTEMS, ETC. SUBMITTAL OF A BID SHALL SIGNIFY WILLINGNESS TO COMPLY WITH THE CONSTRUCTION DOCUMENTS AND ACCEPTANCE OF ON-SITE CONDITIONS AS THEY EXIST.



REVISIONS	DATE

Designed by JH/RA/LLA	Drawn by JH/RA/LLA	Reviewed by RT/JH	Submitted by PCBS
--------------------------	-----------------------	----------------------	----------------------


PROJECT TITLE

**FIRE STATION ADD/ALTER, B3321  
PROJECT NO. 1039839  
17th TRAINING WING  
GOODFELLOW AIR FORCE BASE, TEXAS**


Project Number: 1039839
SHEET TITLE CIVIL SYMBOLS, NOTES & ABBREVIATIONS
Date: JAN 2024

SEQ.	SHEET	OF
10	<b>C-001</b>	50



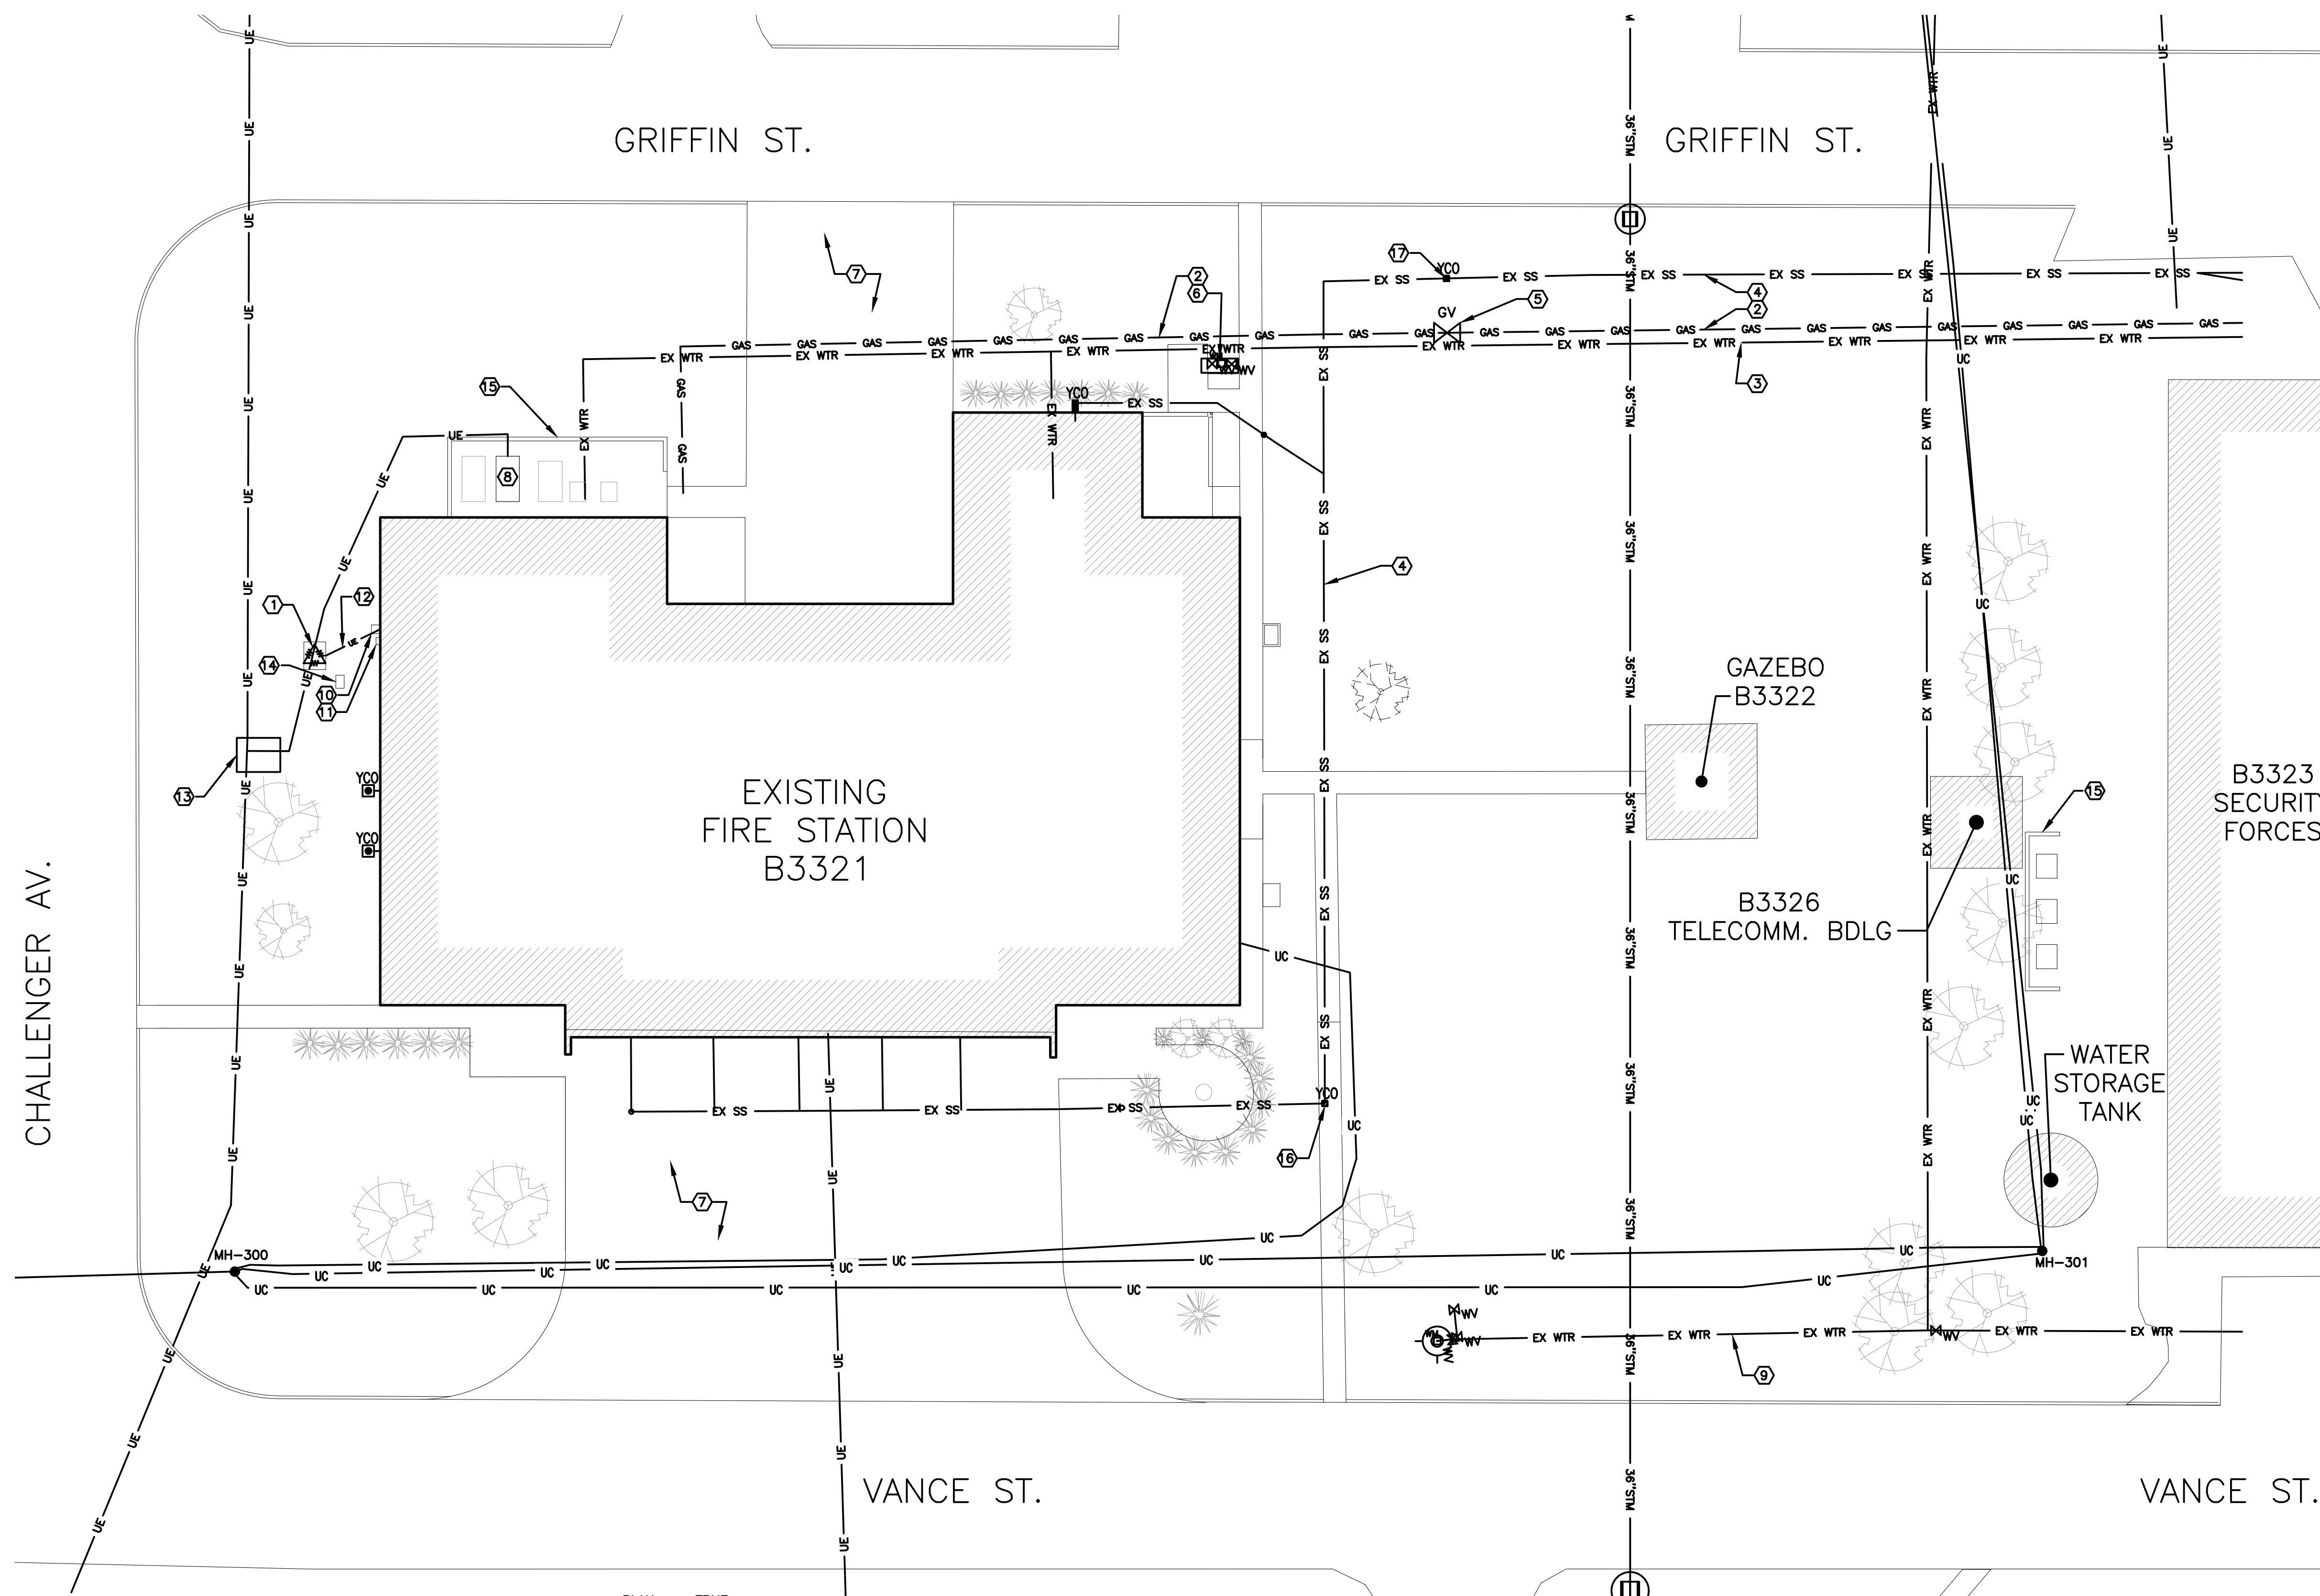

LEGEND	
SYMBOL	DESCRIPTION
— EX SS —	EXIST. SANITARY SEWER LINE
(MH)	SANITARY SEWER MANHOLE
— 36" STM —	EXIST. STORMWATER LINE
(II)	STORMWATER INLET
— EX WTR —	EXIST. DOMESTIC WATER LINE
⊗ <sub>WV</sub>	WATER VALVE
⊙	FIRE HYDRANT
— UE — UE — UE —	UNDERGROUND ELECTRIC LINE
— OE — OE — OE —	OVERHEAD ELECTRIC LINE
⊕	TRANSFORMER
— G — G — G —	GAS LINE
GV	GAS VALVE
M	METER
YCO	YARD CLEANOUT
— UC — UC —	UNDERGROUND TELECOMM.

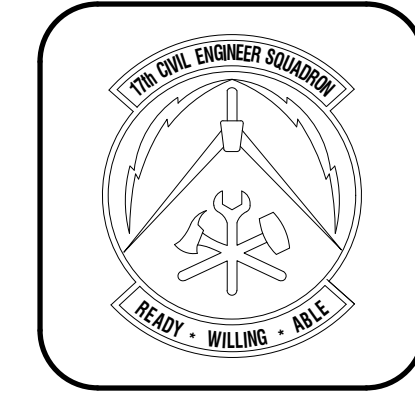


DATE

REVISIONS

Designed by: JH/MLLA  
 Drawn by: JH/MLLA  
 Reviewed by: RT/JAH  
 Submitted by: PCES

**FIRE STATION ADD/ALTER, B3321**  
**PROJECT NO. 1039839**  
**17th TRAINING WING**  
**GOODFELLOW AIR FORCE BASE, TEXAS**

**1 EXISTING BUILDING UTILITIES**  
 1/8" = 1' - 0"

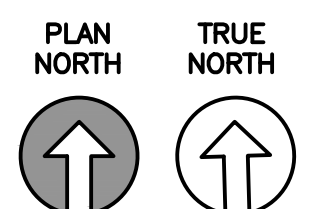

**GENERAL NOTES**

- ALL LABOR, MATERIALS, AND METHODS OF CONSTRUCTION SHALL BE IN STRICT ACCORDANCE WITH THE UNIFIED FACILITIES CRITERIA (UFCs) AND OTHER APPLICABLE CODES AND STANDARDS.
- THE CONTRACTOR SHALL BE RESPONSIBLE FOR ACQUIRING AND SUBMITTING ALL REQUIRED PERMITS, INCLUDING AN AF FORM 103 "DIG REQUEST PERMIT", PRIOR TO POTHOLES, DIGGING, AND EXCAVATING THE SITE. NO CONSTRUCTION SHALL BEGIN UNTIL THE CONTRACTOR HAS RECEIVED ALL PLANS AND ANY OTHER DOCUMENTATION FROM ALL OF THE PERMITTING AND ANY OTHER REGULATORY AUTHORITIES. ANY PENALTIES, STOP WORK ORDERS OR ADDITIONAL WORK RESULTING FROM THE CONTRACTOR BEING IN VIOLATION OF THE REQUIREMENTS ABOVE, SHALL BE FULLY BORNE BY THE CONTRACTOR.
- UTILITIES SHOWN ARE BASED OFF MOST RECENT INFORMATION, AND ONLY MEANT TO ASSIST THE CONTRACTOR. THE CONTRACTOR SHALL BE RESPONSIBLE FOR VERIFYING THE EXACT LOCATION OF UTILITIES PRIOR TO START OF CONSTRUCTION. ANY DAMAGE TO EXISTING UTILITIES NOT INCLUDED IN THIS SCOPE OF WORK, REQUIRING REPAIR OR REPLACEMENT SHALL BE CORRECTED BY THE CONTRACTOR AT NO ADDITIONAL COST TO THE GOVERNMENT.
- CONTRACTOR SHALL COORDINATE LIMITS OF WORK AND LAYDOWN AREA WITH THE CONTRACTING OFFICER PRIOR TO START OF WORK.
- UTILITY OUTAGES AND DISRUPTIONS SHALL BE COORDINATED WITH THE GOV'T AND SHALL BE PERFORMED AS SPECIFIED.


- SITE WORK AREAS SHALL BE KEPT IN A CLEAN, SAFE, AND WORKMANLIKE CONDITION. DEBRIS SHALL BE CLEANED UP ON A DAILY BASIS, AND SITE SHALL BE MAINTAINED AS SPECIFIED.
- WHEN EXCAVATING, THE CONTRACTOR SHALL HAND DIG AROUND AREAS WHERE EXISTING UTILITIES ARE SUSPECTED OR INDICATED ON THESE DRAWINGS.
- REFER TO FIRE STATION AS BUILTS FOR ADDITIONAL UTILITY AND POWER INFORMATION.

**KEYNOTES**

- EXISTING 300 kVA PAD MOUNTED TRANSFORMER.
- EXISTING 1" - 10PSI GAS SERVICE LINE
- EXISTING 2 1/2" WATER SERVICE LINE
- EXISTING 6" SANITARY SEWER LINE
- EXISTING 1094 CFH GAS METER
- EXISTING FIRE STATION WATER METER AND SERVICE BOX
- CONCRETE APRON AND DRIVEWAY
- EXISTING FIRE STATION EMERGENCY GENERATOR
- EXISTING 6" WATER SERVICE LINE TO FIRE HYDRANT
- EXISTING MAIN DISCONNECT
- EXISTING ELECTRIC METER
- PRIMARY SERVICE LINE. 3-#4/0 CU 15 KV IN 4" C & 4" C SPARE, CONCRETE ENCASED.
- EXISTING ELECTRICAL MANHOLE AND ENCLOSURE MH-DB
- EXISTING C-TV BOX
- EXISTING EXTERIOR MECHANICAL ENCLOSURE
- EXISTING YARD CLEANOUT, FL = 1858.67'
- EXISTING YARD CLEANOUT, FL = 1856.56'

Project Number:	1039839
SHEET TITLE	EXISTING SITE UTILITIES
Date:	JAN 2024

SEQ.	SHEET	OF
11	CU-101	50

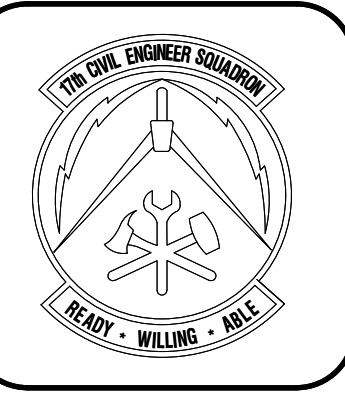

**LEGEND:**

- 1859.12' EXISTING SPOT ELEVATIONS
- - - 1860.00' - - - EXISTING CONTOURS
- 1860.00' — NEW CONTOURS
- NEW BUILDING
- ▨ EXISTING BUILDING
- ▨ NEW CONCRETE SURFACE


REVISIONS	DATE

Designed by JH/MLA	Drawn by JH/MLA	Reviewed by RT/JH	Submitted by PC/ES
-----------------------	--------------------	----------------------	-----------------------


PROJECT TITLE  
**FIRE STATION ADD/ALTER, B3321**  
**PROJECT NO. 1039839**  
**17th TRAINING WING**  
**GOODFELLOW AIR FORCE BASE, TEXAS**

Project Number: 1039839
SHEET TITLE SITE CONTOURS
Date: JAN 2024

SEQ.	SHEET	OF
12	CG-101	50

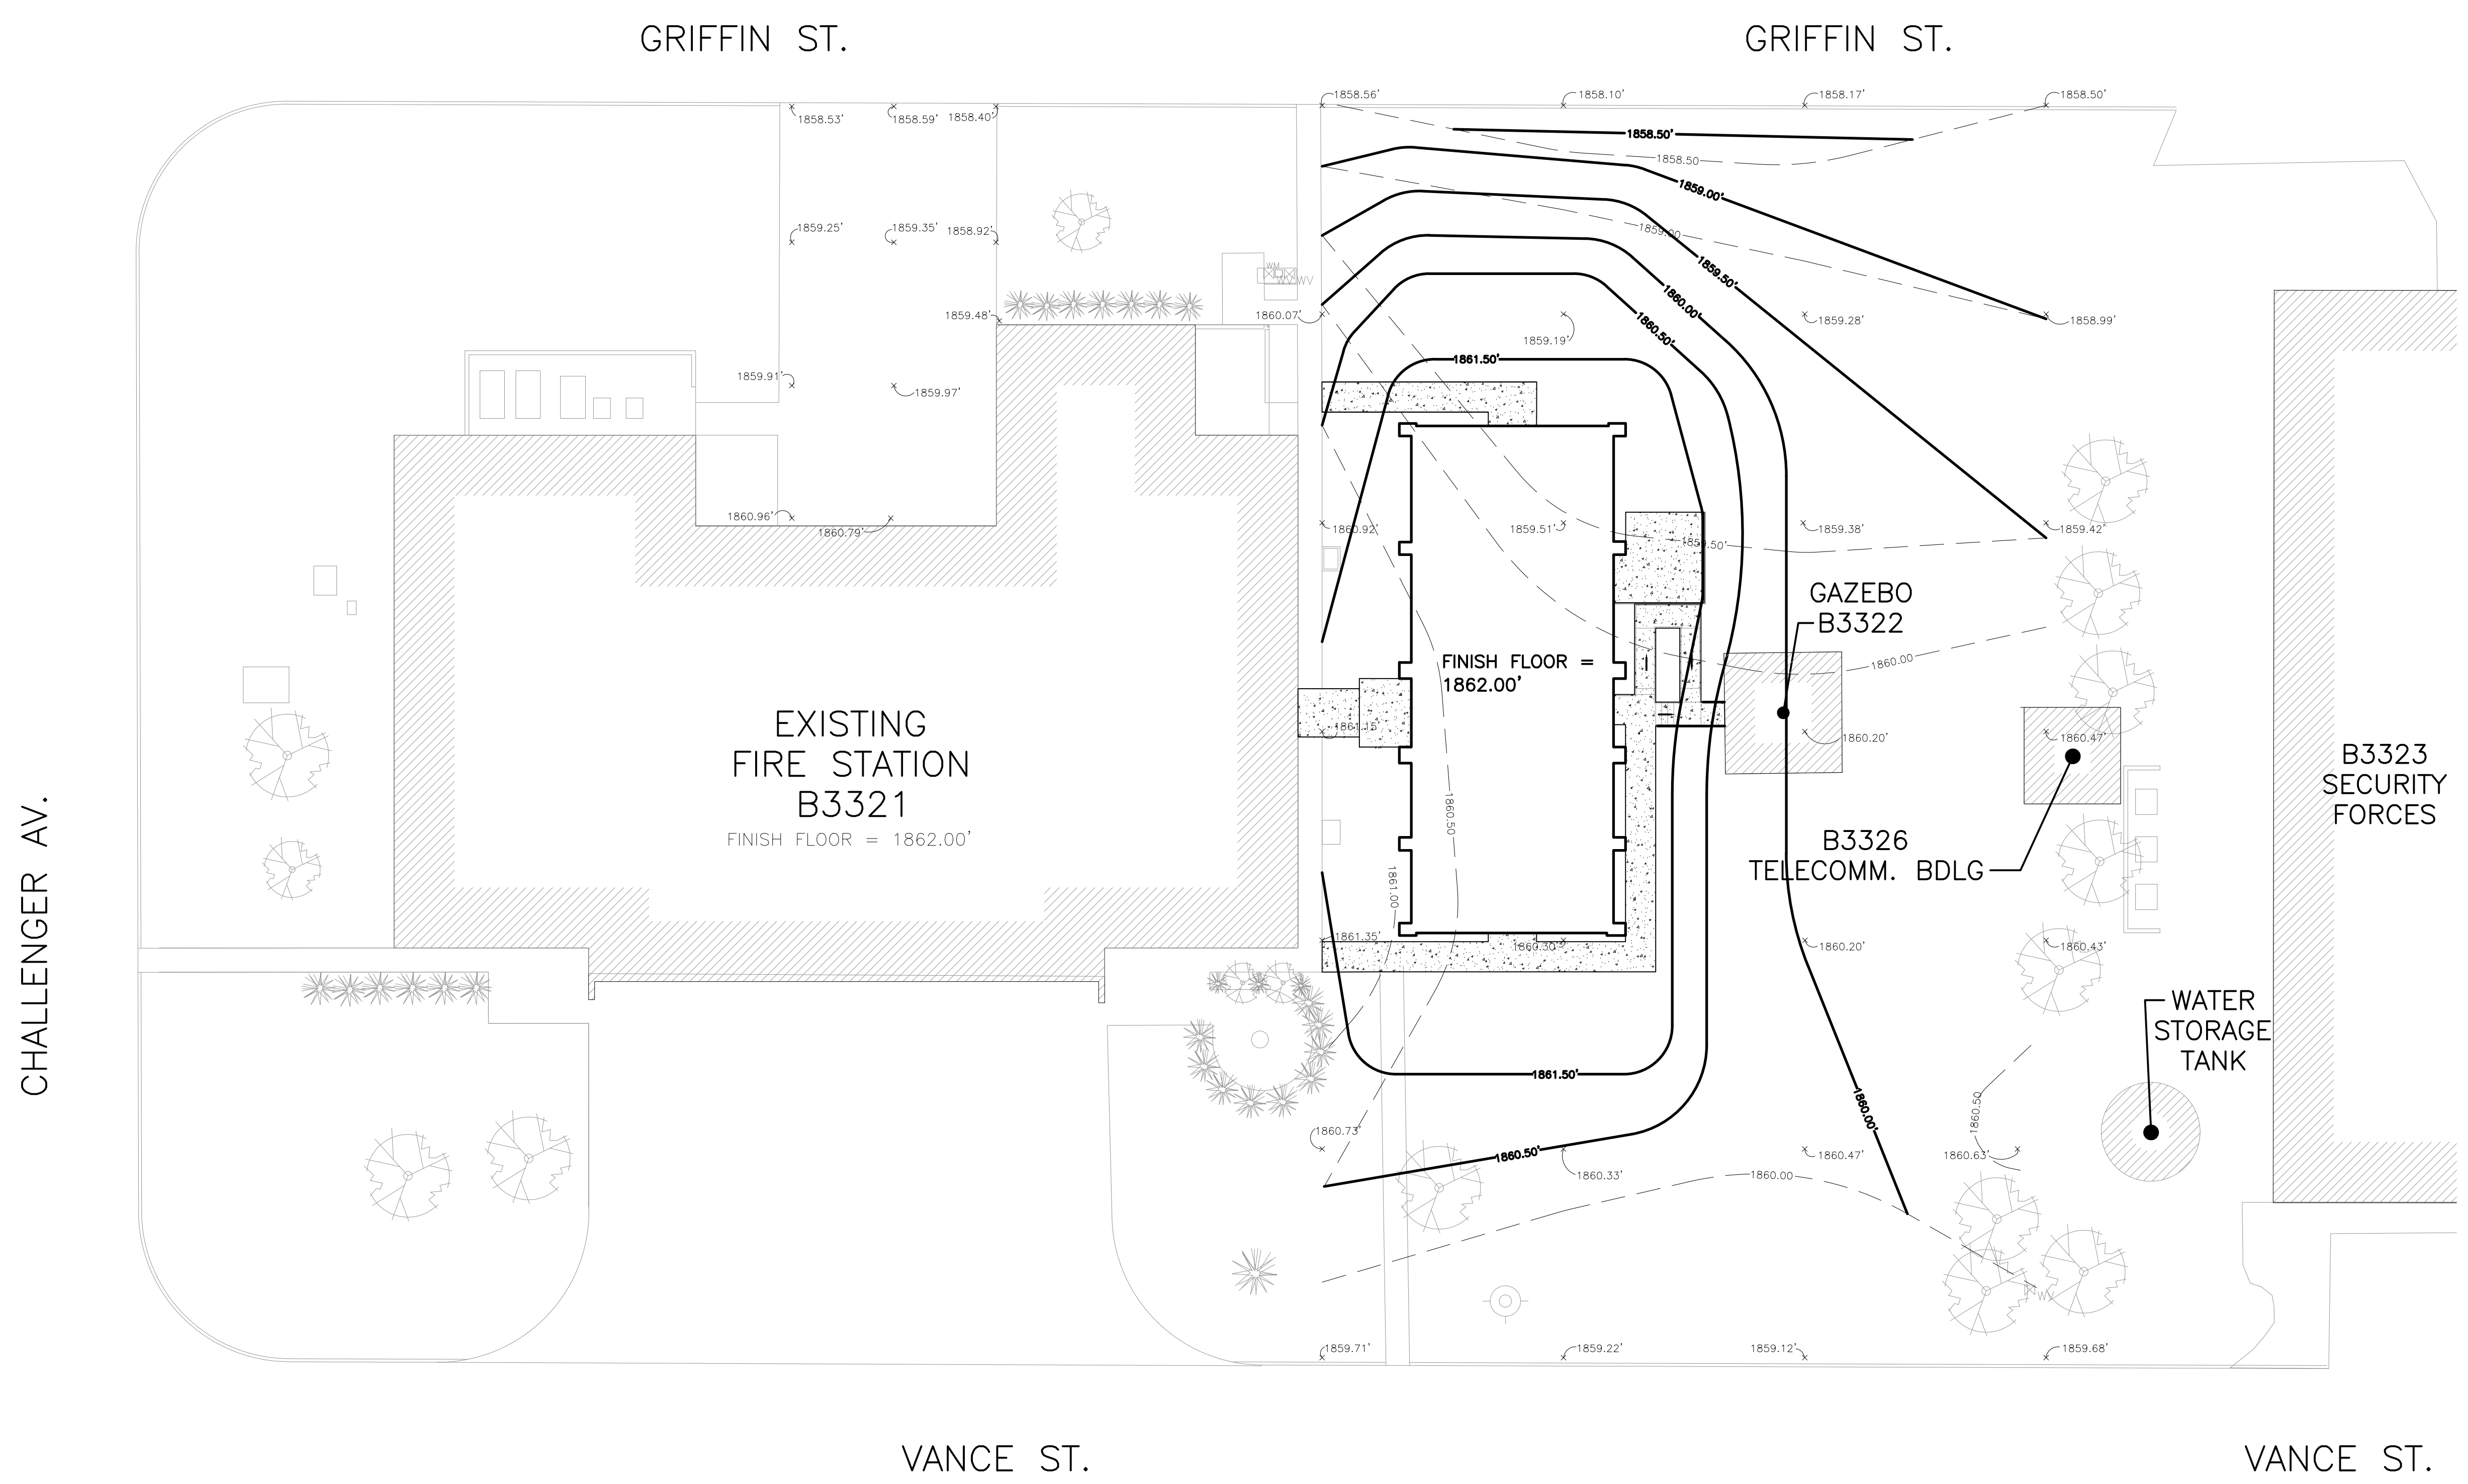

**1 SITE GRADING PLAN**  
 $\frac{1}{16}'' = 1' - 0''$

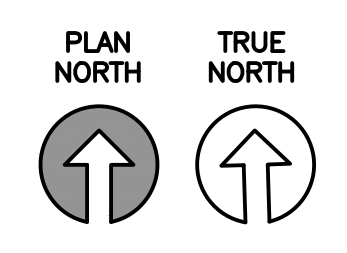

**GENERAL SITE NOTES:**

1. CONTRACTOR SHALL VERIFY NEW GRADES WITH THE PROJECT MANAGER TO ENSURE POSITIVE DRAINAGE AWAY FROM THE NEW BUILDING AND ADJACENT BLDGS.
  2. CONTRACTOR SHALL COORDINATE WORK WITH ALL OTHER TRADES FOR EXTERIOR AND INTERIOR CONTINUATIONS.
  3. PROVIDE TOPSOIL AND HYDROMULCH AS INDICATED ON C101 AND AS SPECIFIED. CONTRACTOR SHALL BE RESPONSIBLE FOR WATERING AS SPECIFIED.
- DUST:**
1. CONTRACTOR SHALL BE RESPONSIBLE FOR WATERING/SPRAYING AS NEEDED TO PREVENT DUST NUISANCE, BOTH ON-SITE AND ADJACENT BUILDINGS.
- EROSION CONTROL:**
1. CONTRACTOR SHALL TAKE PRECAUTIONS NECESSARY TO PREVENT EROSION AND TRANSPORTATION OF SOIL DOWNSTREAM, TO ADJACENT PROPERTIES AND INTO ON-SITE AND OFF-SITE DRAINAGE SYSTEMS. REFER TO STANDARD EROSION CONTROL DTLS ON 4/C501
- SPILLAGE:**
1. CONTRACTOR SHALL AVOID SPILLAGE BY COVERING AND SECURING LOADS WHEN HAULING ON OR ADJACENT TO PUBLIC STREETS OR HIGHWAYS. REMOVE SPILLAGE AND SWEEP, WASH OR OTHERWISE CLEAN PROJECT, STREET AND HIGHWAYS. CONTRACTOR SHALL PROVIDE ROCK ENTRY OR RIPRAP ENTRY TO TRAP SEDIMENT WHEN LEAVING/ENTERING SITE. PROVIDE MINIMUM 3"-5" ROCK. REFER TO 4/C501
- EXISTING PLANTS AND FEATURES:**
1. CONTRACTOR SHALL REMOVE ALL INDICATED TREES, SHRUBS, ROOTS AS INDICATED BY THESE DRAWINGS. DO NOT DAMAGE TOPS, TRUNKS AND ROOTS OF EXISTING TREES AND/OR SHRUBS THAT ARE INTENDED TO REMAIN. DO NOT USE HEAVY EQUIPMENT WITHIN BRANCH SPREAD. INTERFERING BRANCHES MAY BE REMOVED ONLY WITH THE PERMISSION OF THE PROJECT MANAGER. DO NOT DAMAGE PLANTS AND FEATURES THAT ARE TO REMAIN.
- DIG TESS:**
1. CONTRACT DIG TESS TO ARRANGE FOR UTILITY LOCATIONS WHERE REQUIRED.



CF

GRIFFIN ST.

GRIFFIN ST.

CHALLENGER AV.

VANCE ST.

VANCE

EXISTING FIRE STATION B3321

NEW DORM ADDITION

GAZEBO B3322

B3326 TELECOMM. BDLG

B3323 SECURITY FORCES

WATER STORAGE TANK


LEGEND

DEMO/EXCAVATION AREAS

TEMPORARY FENCING

EXISTING FACILITY

EXISTING CONCRETE SIDEWALK DEMO

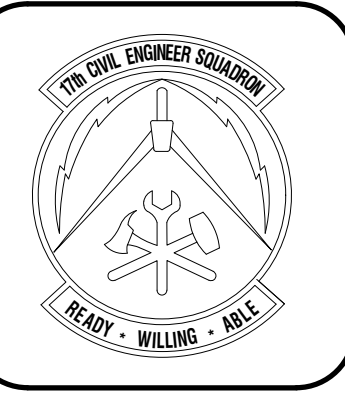

REVISIONS	DATE


Designed by JRM/MLA	Drawn by JRM/MLA	Reviewed by RTI/JH	Submitted by PCBS
------------------------	---------------------	-----------------------	----------------------

PROJECT TITLE  
**FIRE STATION ADD/ALTER, B3321**  
**PROJECT NO. 1039839**  
**17th TRAINING WING**  
**GOODFELLOW AIR FORCE BASE, TEXAS**

Project Number: 1039839
SHEET TITLE SITE DEMO
Date: JAN 2024

SEQ.	SHEET	OF
13	CD-101	50

1 SITE GRADING PLAN  
1/8" = 1' - 0"

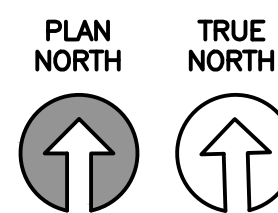


KEYNOTES AS INDICATED BY (X)

- EXISTING A/C UNITS AND PAD TO REMAIN. CONTRACTOR SHALL PROTECT FROM DAMAGE.
- NEW BUILDING FOOTPRINT. CONTRACTOR SHALL EXCAVATE EARTHWORK AND FILL AS SPECIFIED.
- PROPOSED CONTRACTOR ENTRY/EXIT. CONTRACTOR SHALL SAW CUT AND REPLACE CURB AS NEEDED FOR MATERIAL AND EQUIPMENT SHIPMENTS. CONTRACTOR SHALL PROVIDE TEMPORARY ROCK STABILIZED CONSTRUCTION ENTRANCE OR CONTROL MATS. CONTRACTOR SHALL ENSURE CONSTRUCTION DEBRIS ON VANCE ST. OR GRIFFIN ST. IS CLEANED DAILY AS SPECIFIED OR AS DIRECTED BY CO.
- CONTRACTOR SHALL PROVIDE TEMPORARY FENCING AROUND WORKSITE AS INDICATED. DUE TO HIGH WINDS EXPERIENCED IN WORK AREA, THE CONTRACTOR SHALL PROVIDE SAND BAGS OR WEIGHTS ON ALL POSTS. CONTRACTOR SHALL PROVIDE GOVERNMENT ACCESS TO FIRE HYDRANTS AT ALL TIMES.
- CONTRACTOR SHALL TRENCH AND REMOVE FILL FOR NEW ELECTRICAL WIRING AND CONDUIT. CONTRACTOR SHALL HORIZONTALLY BORE UNDERNEATH EXISTING CONCRETE DRIVEWAY. CONTRACTOR SHALL PROVIDE HIGH VISIBILITY SIGNAGE AS SPECIFIED. CONTRACTOR SHALL BE RESPONSIBLE FOR RESTORING DISTURBED AREAS UPON COMPLETION OF WORK.
- EXISTING GAZEBO TO REMAIN. CONTRACTOR SHALL PROTECT.
- CONTRACTOR SHALL DEMO EXISTING TREE.
- CONTRACTOR SHALL TRENCH AND EXCAVATE EARTHWORK FOR NEW SANITARY SEWER CONNECTION. CONTRACTOR SHALL TIE INTO EXISTING 6" SANITARY SEWER LINE ONCE NEW SEWER LINE IS READY TO CONNECT.
- CONTRACTOR SHALL TRENCH AND EXCAVATE EARTHWORK FOR NEW DOMESTIC WATER/GAS SERVICE LINES. CONTRACTOR SHALL TIE INTO EXISTING WATER/GAS LINES ONCE NEW SERVICE IS READY TO CONNECT. CONTRACTOR SHALL DEMO EXISTING GAS METER AND PROVIDE NEW AS INDICATED.
- CONTRACTOR SHALL TRENCH EARTHWORK FOR NEW FIBER AND TELECOMMUNICATIONS CONNECTIONS. REFER TO ELECTRICAL.

GENERAL NOTES:

- THE CONTRACTOR SHALL BE RESPONSIBLE FOR VERIFYING EXISTING CONDITIONS, EQUIPMENT, AND DIMENSIONS PRIOR TO START OF WORK.
- CONTRACTOR SHALL ENSURE TO PROTECT ITEMS INDICATED AS "EXISTING TO REMAIN". ANY DAMAGE TO ITEMS OR BUILDING ELEMENTS OUTSIDE THE SCOPE OF WORK REQUIRING REPAIR OR REPLACEMENT SHALL BE PERFORMED BY THE CONTRACTOR AT NO ADDITIONAL COST TO THE GOVERNMENT.
- THE CONTRACTOR SHALL COORDINATE WORK WITH ALL OTHER TRADES.
- CONTRACTOR SHALL PROVIDE EROSION AND SEDIMENT CONTROL DEVICES FOR ALL STORM DRAINAGE INLETS AND SILT FENCES AS SPECIFIED AND INDICATED IN GENERAL 001, 002, AND G003. REFER TO C-501 FOR EROSION CONTROL DETAILS.
- REFER TO CU-101 FOR SITE UTILITIES LEGEND.
- CONTRACTOR SHALL COORDINATE ALL UTILITY OUTAGES WITH THE GOVERNMENT AS SPECIFIED. CONTRACTOR SHALL ENSURE ALL NEW UTILITY WORK IS COMPLETED PRIOR TO DEMOLISHING OR CONNECTING TO EXISTING LINES.

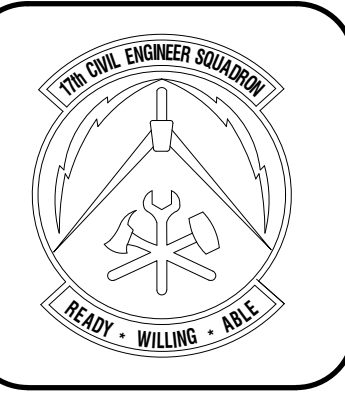

LEGEND


- SEEDED AREAS
- TEMPORARY FENCING
- EXISTING FACILITY
- NEW CONCRETE SURFACES

DATE


REVISIONS

Designed by: JH/MLLA  
 Drawn by: JH/MLLA  
 Reviewed by: RT/JAH  
 Submitted by: PC/BS

**FIRE STATION ADD/ALTER, B3321**  
**PROJECT NO. 1039839**  
**17th TRAINING WING**  
**GOODFELLOW AIR FORCE BASE, TEXAS**

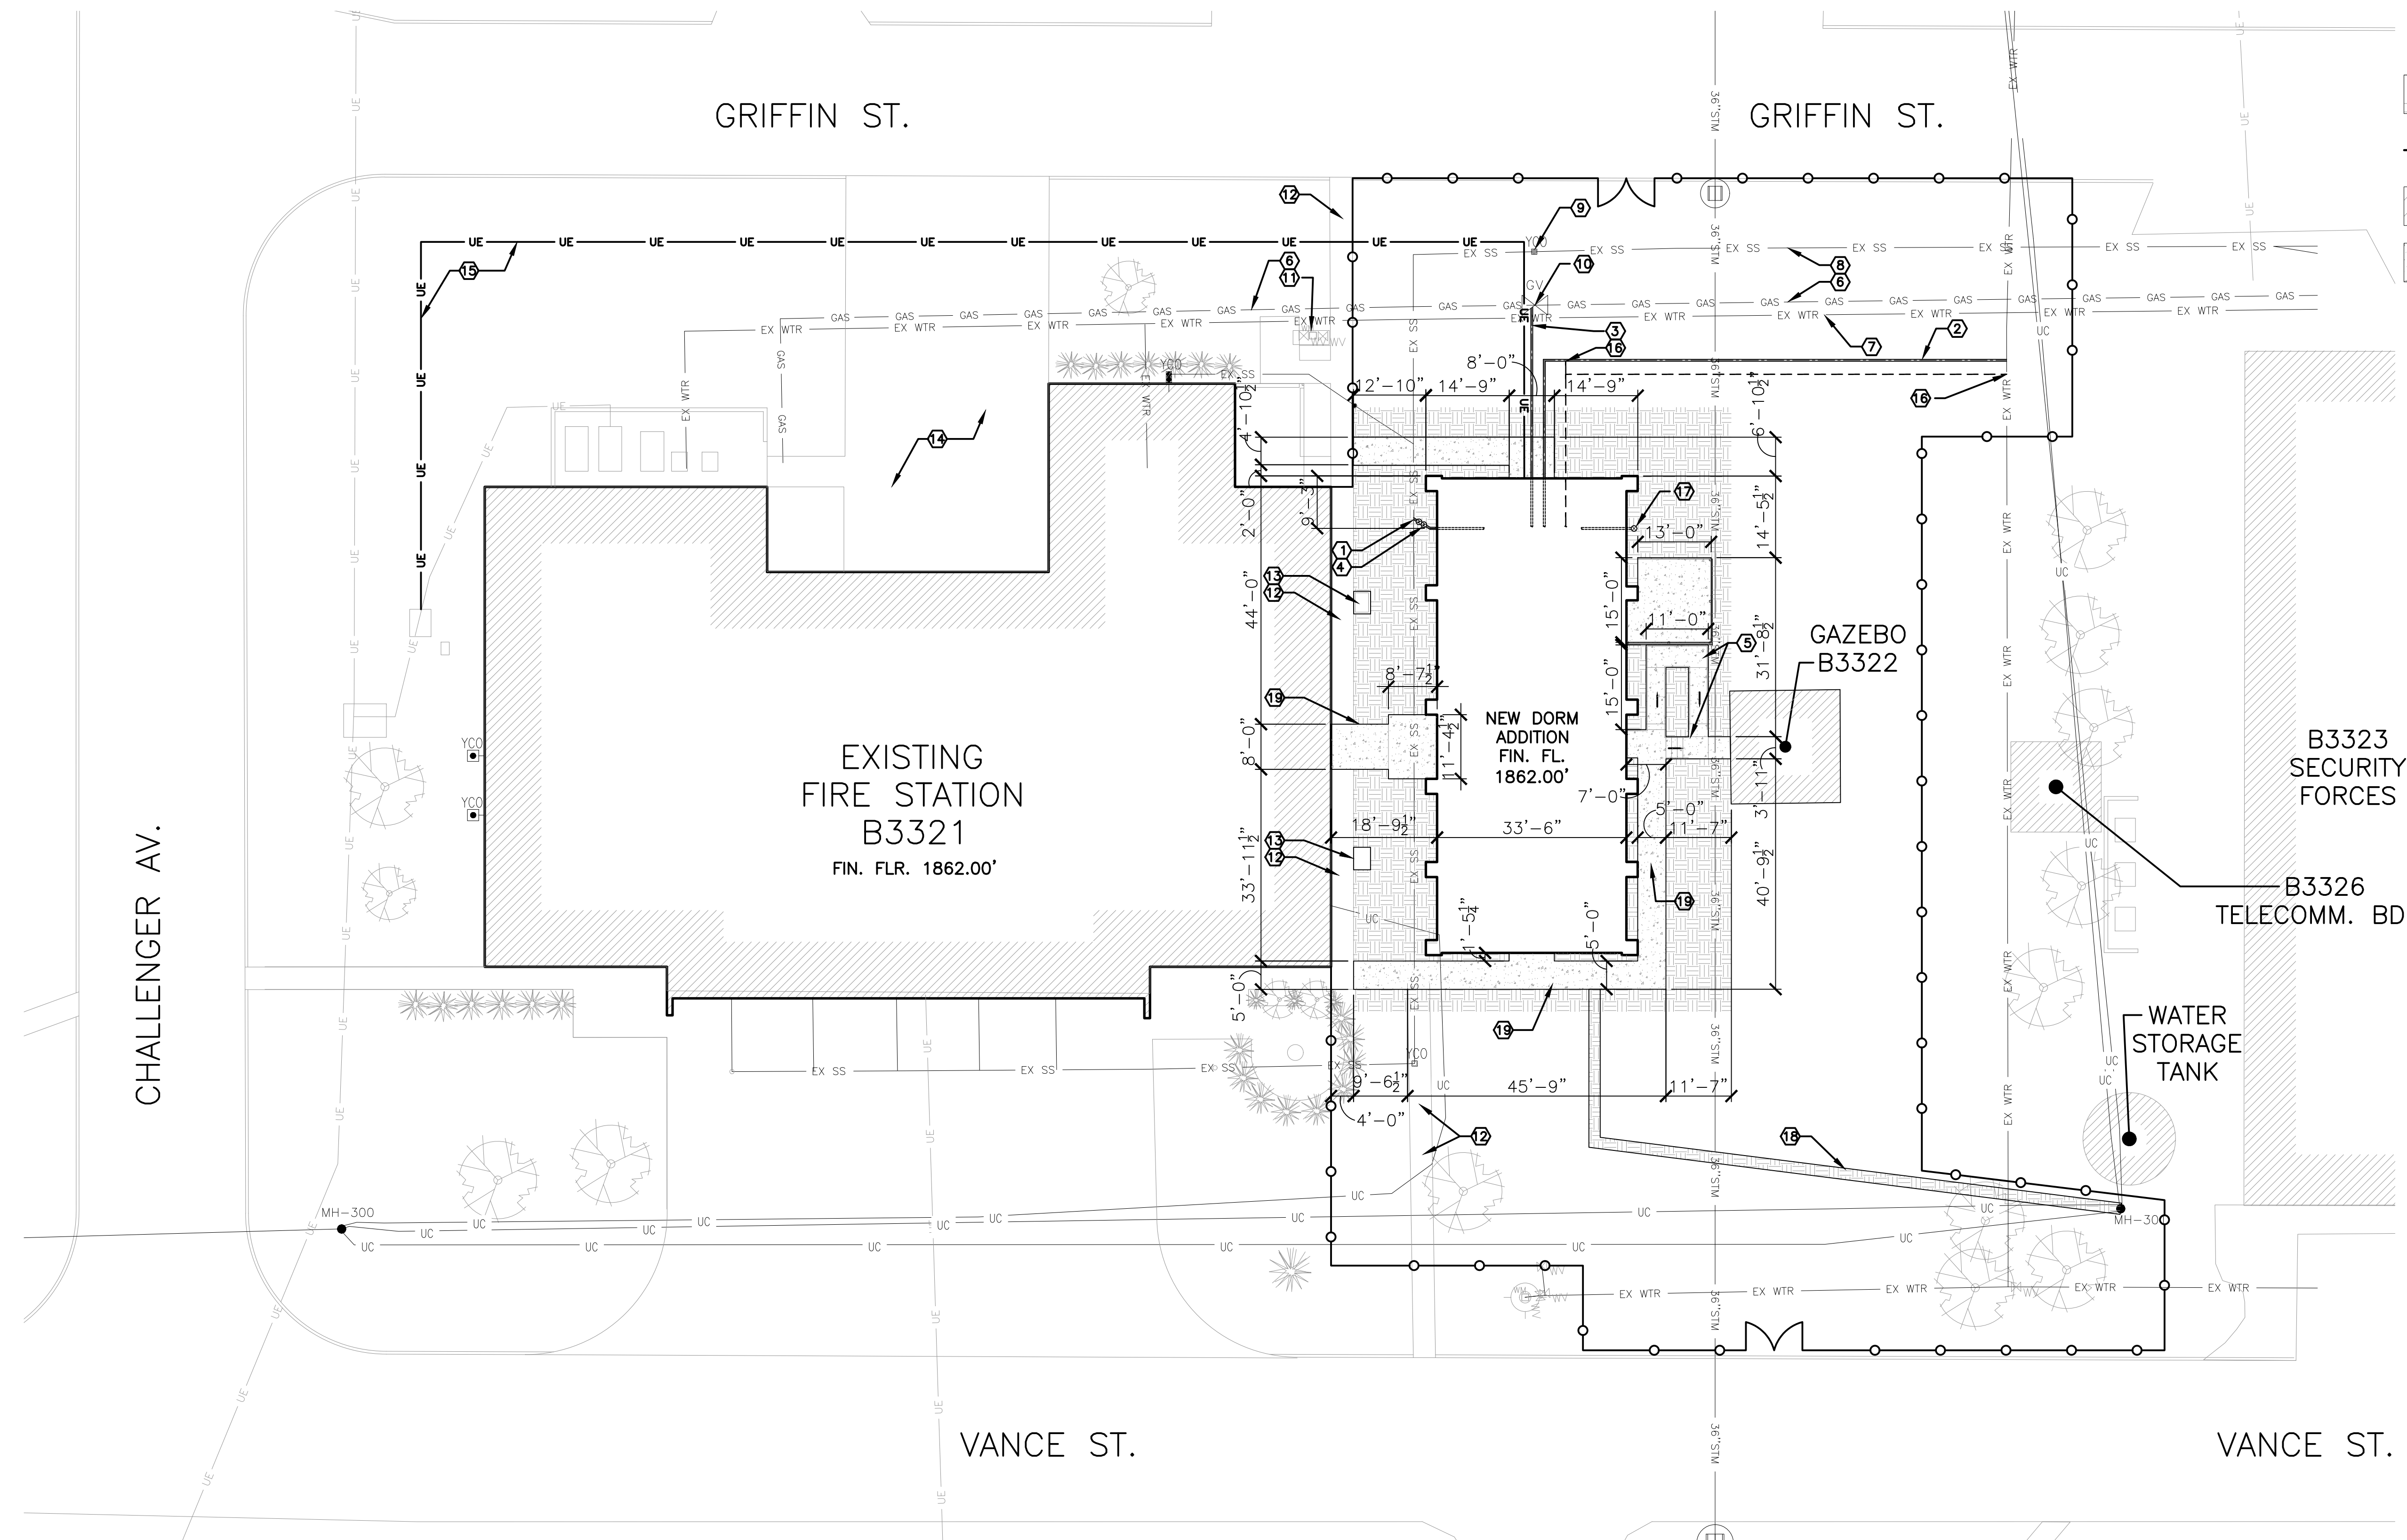

1 NEW SITE PLAN  
 1/8" = 1' - 0"

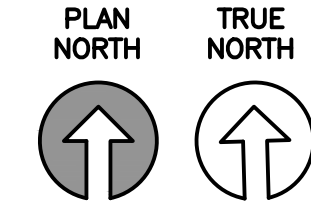

KEYNOTES AS INDICATED BY (X)

1. CONTRACTOR SHALL PROVIDE NEW 4" SANITARY SEWER LATERAL OUTSIDE OF BUILDING TO CONNECT TO EXISTING 6" SANITARY SEWER LINE. REFER TO PLUMBING FOR ADDITIONAL INFORMATION
2. CONTRACTOR SHALL TAP INTO EXISTING 8" WATER MAIN. PROVIDE NEW 1 1/2" DOMESTIC WATER SERVICE LINE. PROVIDE NEW SERVICE CONNECTION AND ACCESS BOX AT CONNECTION POINT.
3. NEW 1" GAS SERVICE LINE. PROVIDE NEW GAS METER ASSEMBLY, REGULATOR, AND CUTOFF VALVE. FOR EXTERIOR NATURAL GAS SERVICE, PROVIDE POLYETHYLENE PIPING AS SPECIFIED.
4. NEW TWO-WAY CLEANOUT RE:1/C501
5. NEW CONCRETE ADA COMPLIANT RAMP AND STAIRCASE. PROVIDE NEW ANODIZED ALUMINUM HANDRAILS WITH DK. BRONZE FINISH. RE: ARCHITECTURAL
6. EXISTING 1" -10PSI GAS LINE
7. EXISTING 2 1/2" WATER SERVICE LINE
8. EXISTING 6" SANITARY SEWER LINE
9. EXISTING GROUND CLEANOUT FL = 1865.56
10. EXISTING 1094 CFH GAS METER
11. EXISTING FIRE STATION WATER METER AND SERVICE BOX
12. EXISTING CONCRETE SIDEWALK TO REMAIN.
13. EXISTING A/C UNITS AND PAD TO REMAIN. CONTRACTOR SHALL PROTECT.
14. EXISTING FIRE STATION DRIVEWAYS

15. NEW ELECTRIC SERVICE LINE AND CONDUIT
16. CONTRACTOR SHALL PROVIDE NEW DEDICATED WATER SERVICE FOR FIRE SUPPRESSION SYSTEM. SERVICE MAY BE TAPPED SEPARATELY FROM DOMESTIC WATER AS DETERMINED BY QFPE. REFER TO FA-101. REFER TO GAFB BASE STANDARDS FOR TYP. PIPE MATERIAL REQUIREMENTS.
17. CONTRACTOR TO PROVIDE NEW YARD CLEANOUT.
18. CONTRACTOR TO PROVIDE NEW PVC CONDUIT AND FIBER RUNS AS INDICATED IN ELECTRICAL. REFILL, COMPACT, AND RESTORE DISTURBED AREAS AFTER COMPLETING WORK.
19. CONCRETE SURFACES CONNECTING TO EXISTING FIRE STATION DORMITORY SHALL RECEIVE ROUGH BROOM FINISH UNLESS NOTED OTHERWISE.

GENERAL NOTES:

1. THE CONTRACTOR SHALL BE RESPONSIBLE FOR VERIFYING EXISTING CONDITION, EQUIPMENT, ELEVATIONS, AND DIMENSIONS PRIOR TO START OF WORK.
2. CONTRACTOR SHALL ENSURE TO PROTECT ITEMS INDICATED AS "EXISTING TO REMAIN". ANY DAMAGE TO ITEMS OR BUILDING ELEMENTS OUTSIDE THE SCOPE OF WORK WILL BE REPLACED OR REPAIRED BY THE CONTRACTOR AT NO ADDITIONAL COST TO THE GOVERNMENT.
3. THE CONTRACTOR SHALL COORDINATE WORK WITH ALL OTHER TRADES.
4. REFER TO CU-101 FOR SITE UTILITIES.
5. CONTRACTOR SHALL TAKE NECESSARY PRECAUTIONS TO PREVENT EROSION AND TRANSPORTATION OF


SOIL DOWNSTREAM, TO ADJACENT PROPERTIES AND INTO ON-SITE OR OFF-SITE DRAINAGE SYSTEMS. THE CONTRACTOR AND SUBCONTRACTORS SHALL BE RESPONSIBLE FOR MEETING THE REQUIREMENTS OF THE TPDES GENERAL PERMIT #TXR150000 AND SHALL PREP ARE A "STORM WATER POLLUTION PREVENTION PLAN" WHERE REQUIRED AND ADHERE TO THE REQUIREMENTS SET FORTH THEREIN. THE CONTRACTOR SHALL PROVIDE THE PROJECT MANAGER AND GOVT. WITH COPIES OF ALL DOCUMENTS ASSOCIATED WITH THE PLAN.

6. FOR SANITARY SEWER LATERALS OUTSIDE OF FACILITY CONTRACTOR SHALL PROVIDE PVC AS SPECIFIED.
7. FOR WATER SERVICE LINES 3" IN DIAMETER AND SMALLER, CONTRACTOR SHALL PROVIDE PVC RATED PIPING FOR DOMESTIC WATER USE AS SPECIFIED.

Project Number:	1039839
SHEET TITLE	SITE NEW
Date:	JAN 2024

SEQ.	SHEET	OF
14	C-101	50



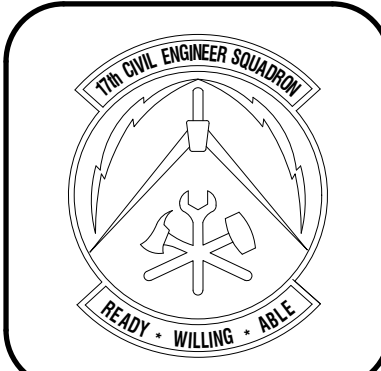

DATE
REVISIONS

Designed by JHR/LA
Drawn by JHR/LA
Reviewed by RTJ/AH
Submitted by PCES


**PROJECT TITLE**  
FIRE STATION ADD/ALTER, B3321  
PROJECT NO. 1039839  
17th TRAINING WING  
GOODFELLOW AIR FORCE BASE, TEXAS

Project Number 1039839
SHEET TITLE SITE DETAILS
Date JAN 2024

SEQ. 15
SHEET C-501
OF 50

**GENERAL NOTES:**

- EROSION CONTROL LOGS SHALL BE INSTALLED IN ACCORDANCE WITH MANUFACTURER'S RECOMMENDATIONS, OR AS DIRECTED BY THE ENGINEER.
- LENGTHS OF EROSION CONTROL LOGS SHALL BE IN ACCORDANCE WITH MANUFACTURER'S RECOMMENDATIONS AND AS REQUIRED FOR THE PURPOSE INTENDED.
- UNLESS OTHERWISE DIRECTED, USE BIODEGRADABLE OR PHOTODEGRADABLE CONTAINMENT MESH ONLY WHERE LOG WILL REMAIN IN PLACE AS PART OF A VEGETATIVE SYSTEM. FOR TEMPORARY INSTALLATIONS, USE RECYCLABLE CONTAINMENT MESH. FILL LOGS WITH SUFFICIENT FILTER MATERIAL TO ACHIEVE THE MINIMUM COMPACTED DIAMETER SPECIFIED IN THE PLANS WITHOUT EXCESSIVE DEFORMATION.
- STAKES SHALL BE 2" x 2" WOOD OR #3 REBAR, 2'-4" LONG, EMBEDDED SUCH THAT 2" PROTRUDES ABOVE LOG, OR AS DIRECTED BY THE ENGINEER.
- DO NOT PLACE STAKES THROUGH CONTAINMENT MESH.
- COMPOST CRADLE MATERIAL IS INCIDENTAL & WILL NOT BE PAID FOR SEPARATELY.
- SANDBAGS USED AS ANCHORS SHALL BE PLACED ON TOP OF LOGS & SHALL BE OF SUFFICIENT SIZE TO HOLD LOGS IN PLACE.
- TURN THE ENDS OF EACH ROW OF LOGS UPSLOPE TO PREVENT RUNOFF FROM FLOWING AROUND THE LOG.
- FOR HEAVY RUNOFF EVENTS, ADDITIONAL UPSTREAM STAKES MAY BE NECESSARY TO KEEP LOG FROM FOLDING IN ON ITSELF.

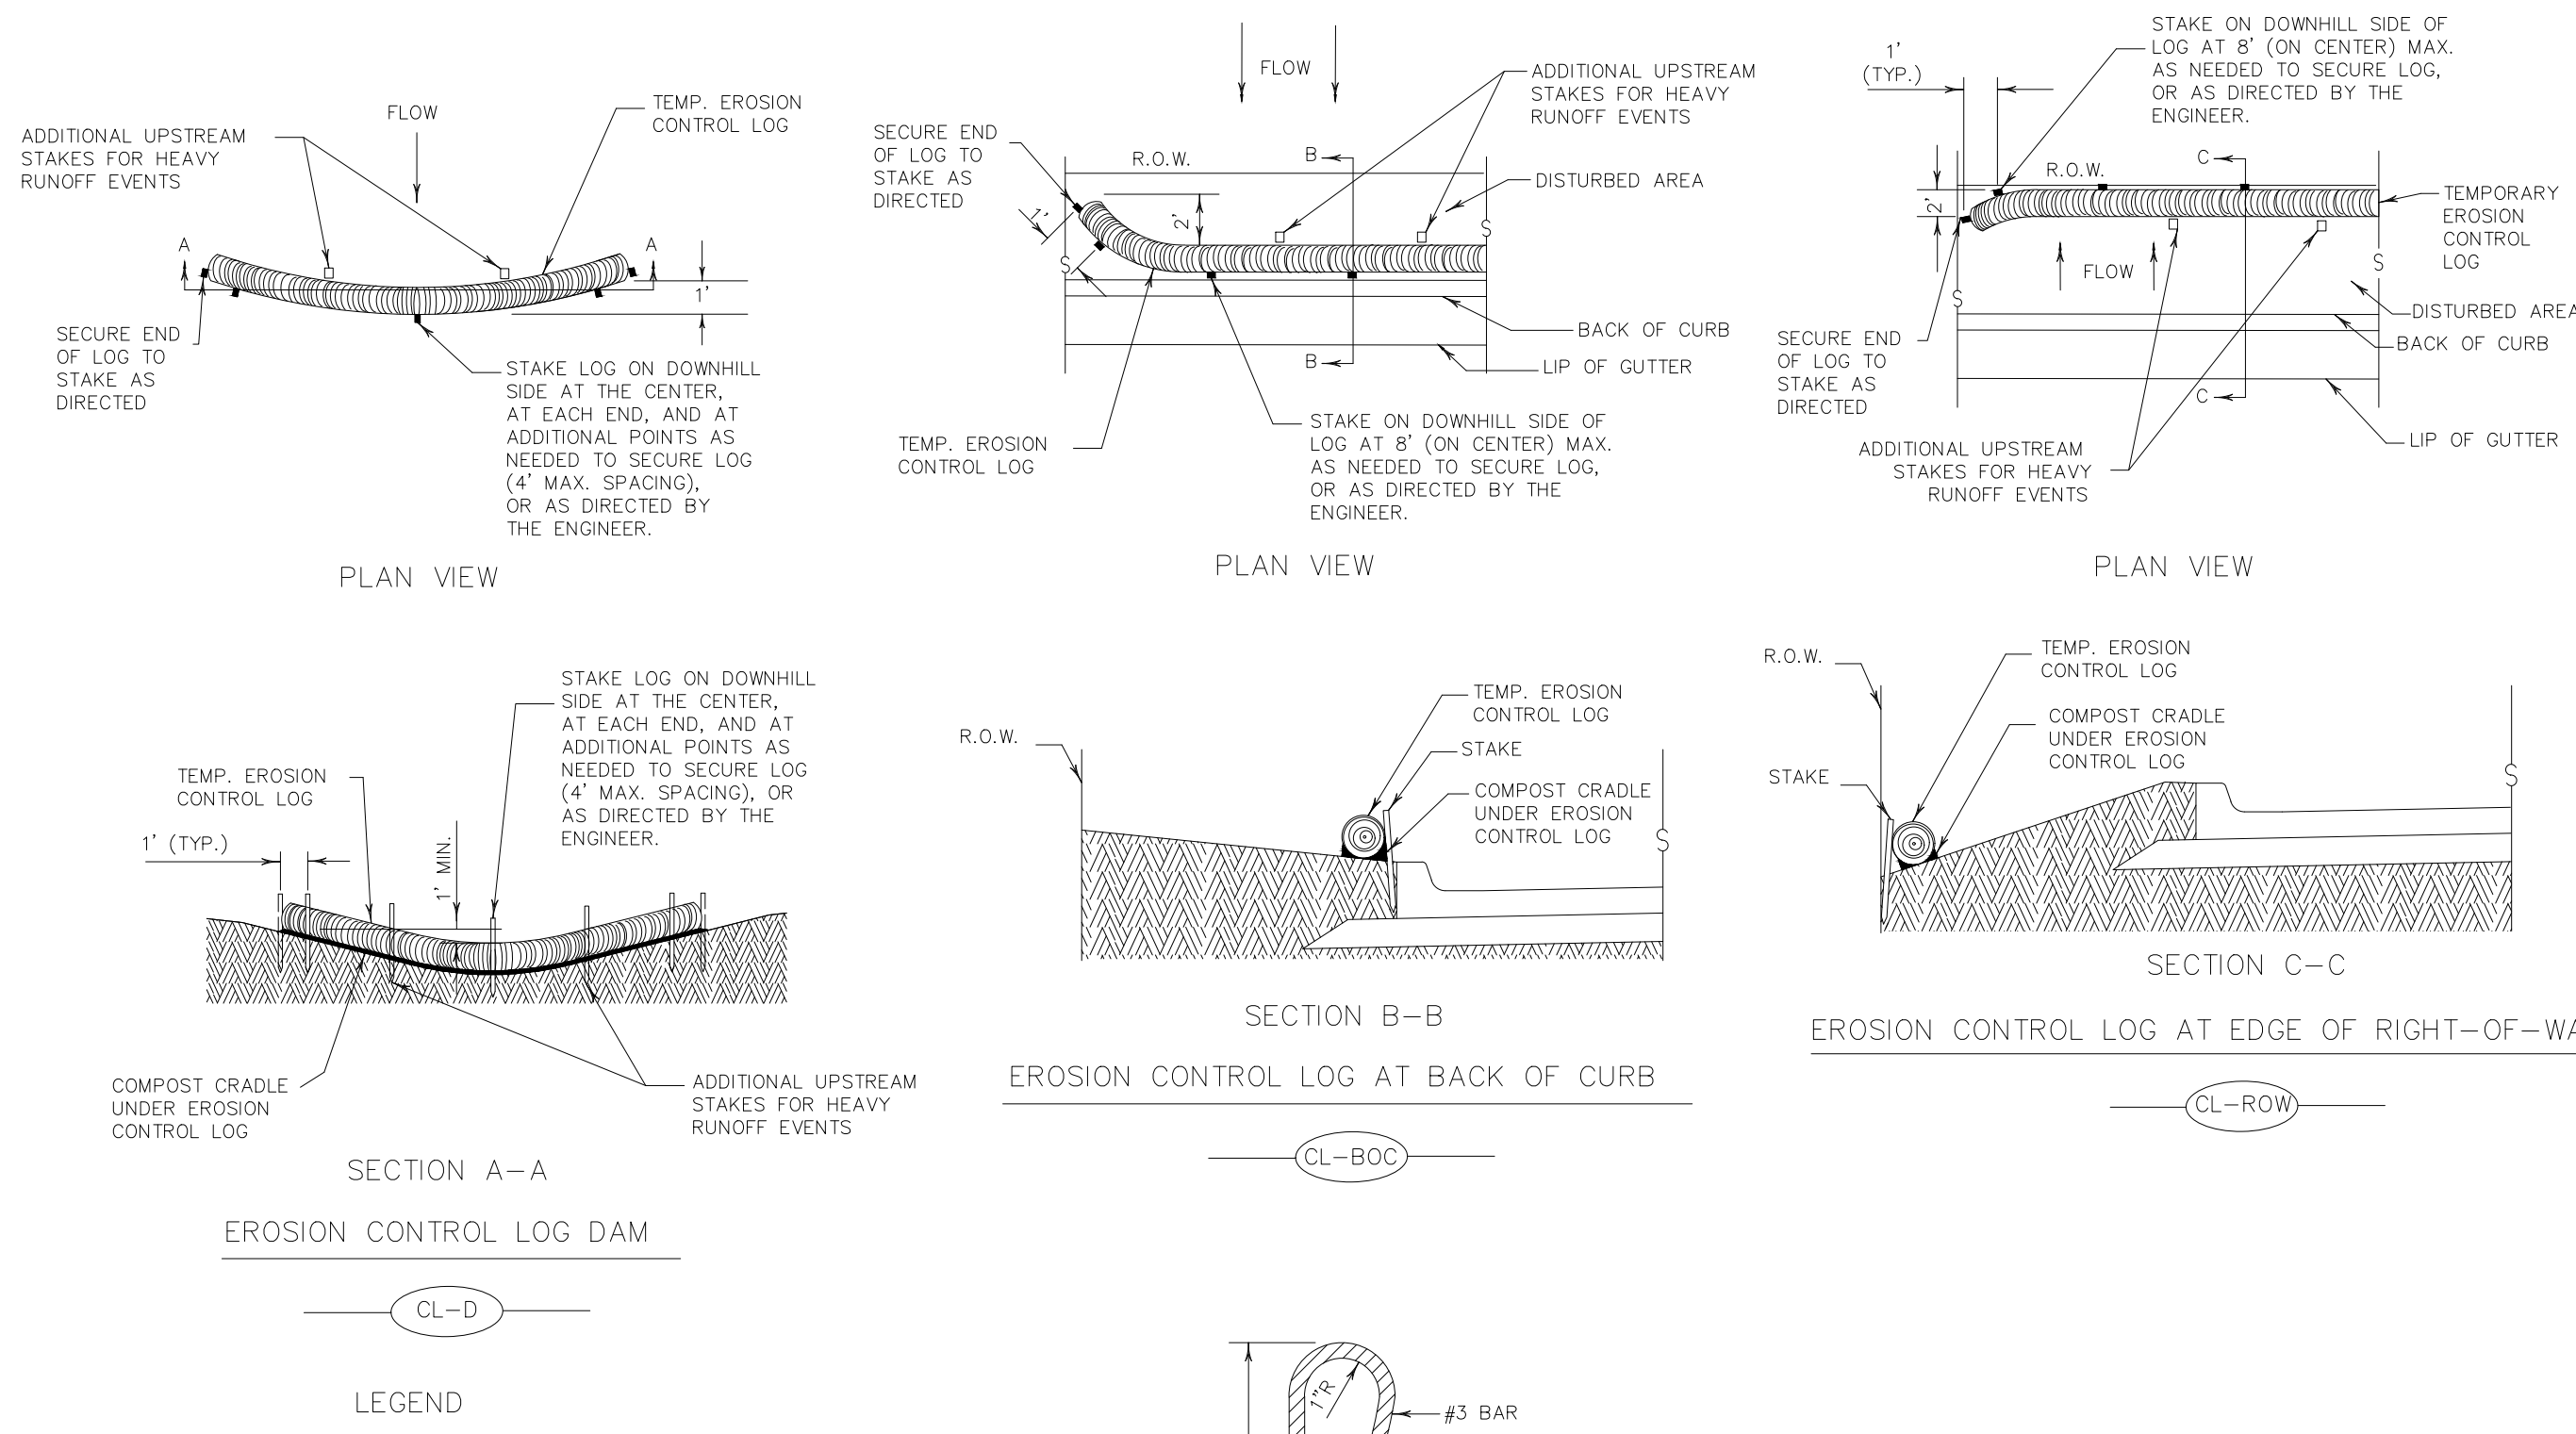

- LEGEND**
- CL-D EROSION CONTROL LOG DAM
  - CL-BOC EROSION CONTROL LOG AT BACK OF CURB
  - CL-ROW EROSION CONTROL LOG AT EDGE OF RIGHT-OF-WAY
  - CL-SST EROSION CONTROL LOGS ON SLOPES STAKE AND TRENCHING ANCHORING
  - CL-SSL EROSION CONTROL LOGS ON SLOPES STAKE AND LASHING ANCHORING
  - CL-DI EROSION CONTROL LOG AT DROP INLET
  - CL-CI EROSION CONTROL LOG AT CURB INLET
  - CL-GI EROSION CONTROL LOG AT CURB & GRATE INLET

**SEDIMENT BASIN & TRAP USAGE GUIDELINES**

An erosion control log sediment trap may be used to filter sediment out of runoff draining from an unstabilized area.



**Log Traps:** The drainage area for a sediment trap should not exceed 5 acres. The trap capacity should be 1800 CF/Acre (0.5" over the drainage area).

Control logs should be placed in the following locations:


- Within drainage ditches spaced as needed or min. 500' on center
- Immediately preceding ditch inlets or drain inlets
- Just before the drainage enters a water course
- Just before the drainage leaves the right of way
- Just before the drainage leaves the construction limits where drainage flows away from the project.

The logs should be cleaned when the sediment has accumulated to a depth of 1/2 the log diameter.


Cleaning and removal of accumulated sediment deposits is incidental and will not be paid for separately.

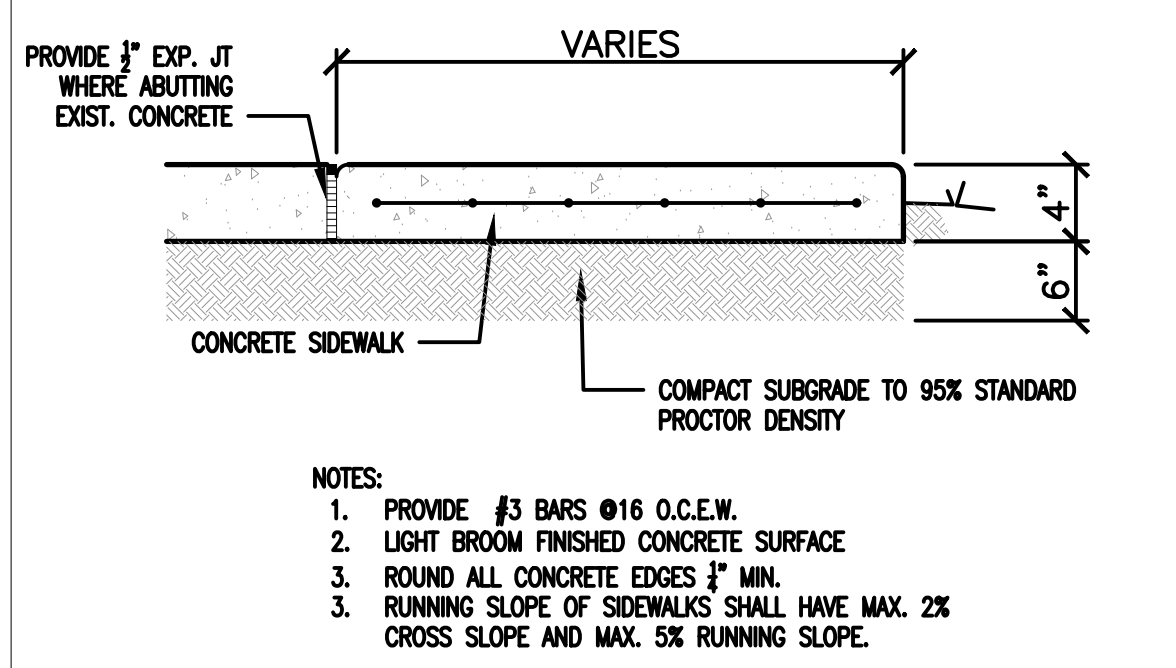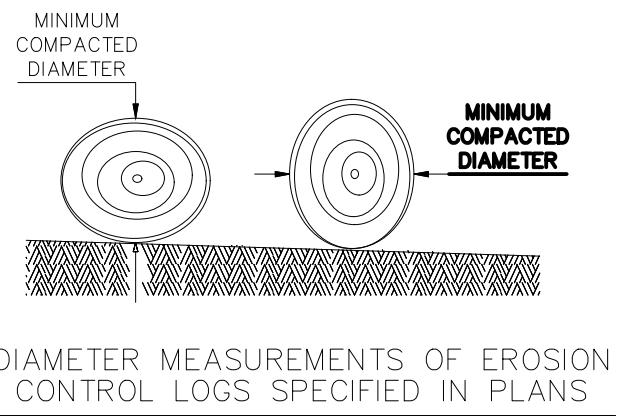



**1 CONCR. SIDEWALK DTL. NTS**

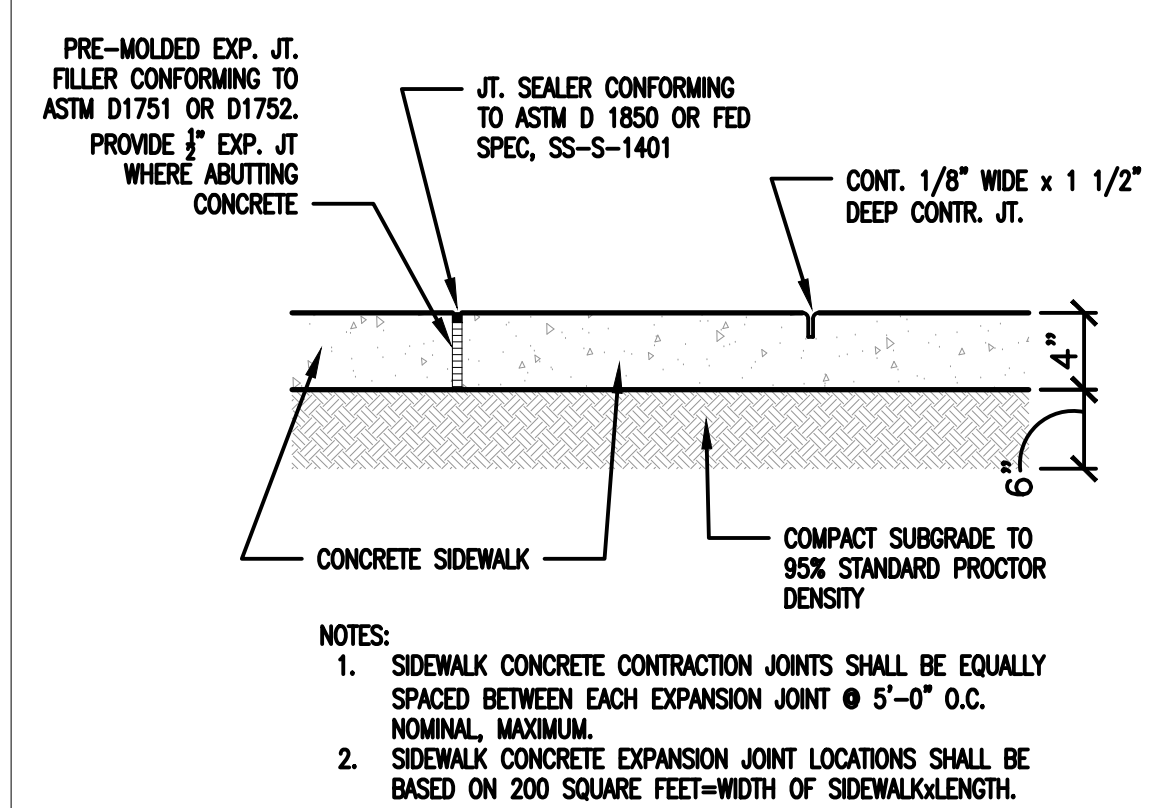



**2 EXPANSION JOINT DTL. NTS**

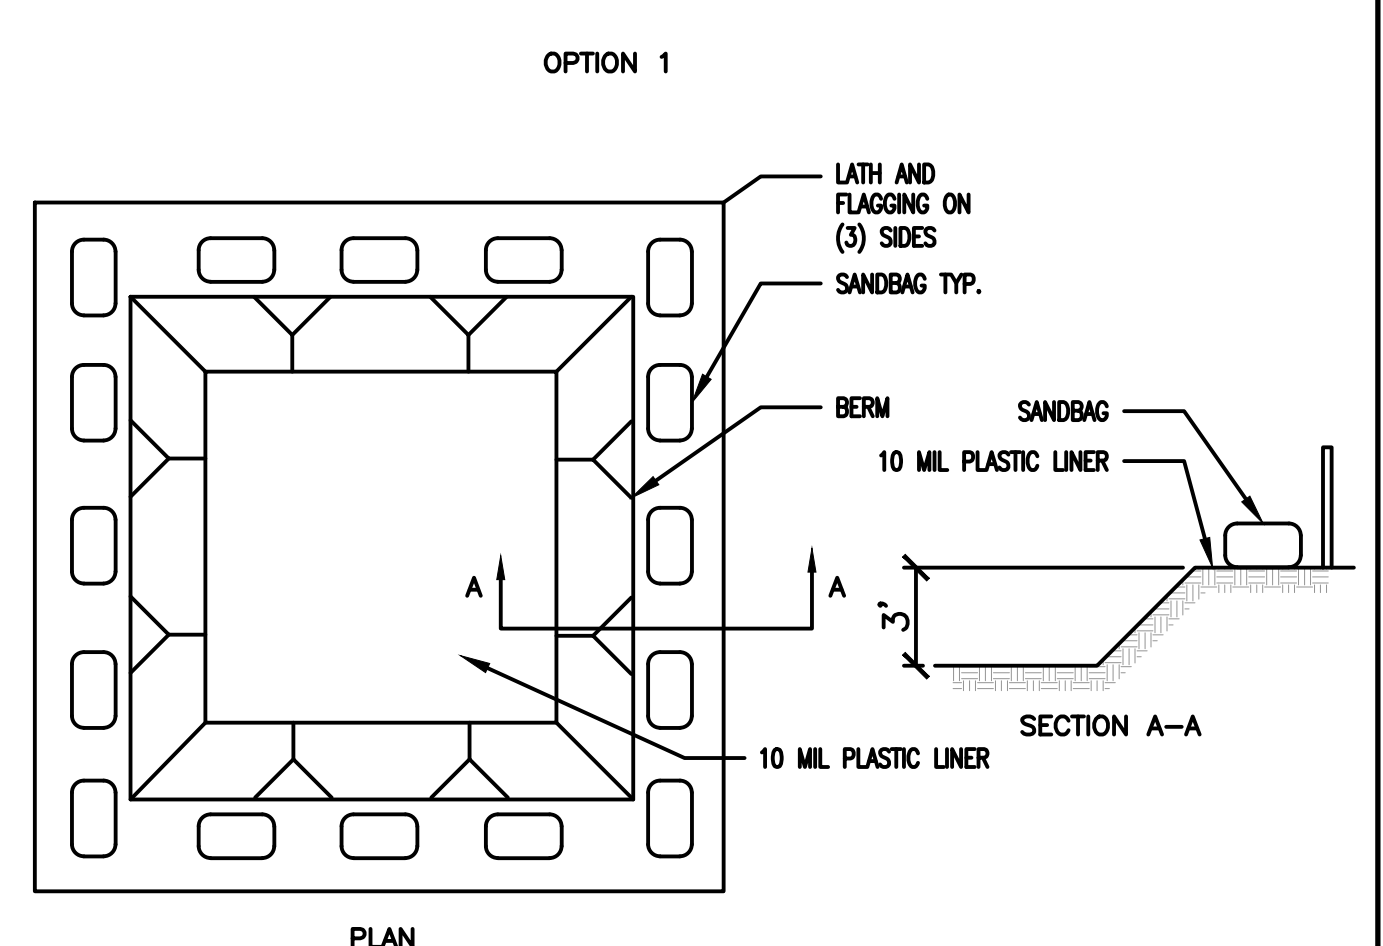

**3 CONCR. WASHOUT DTL. NTS**

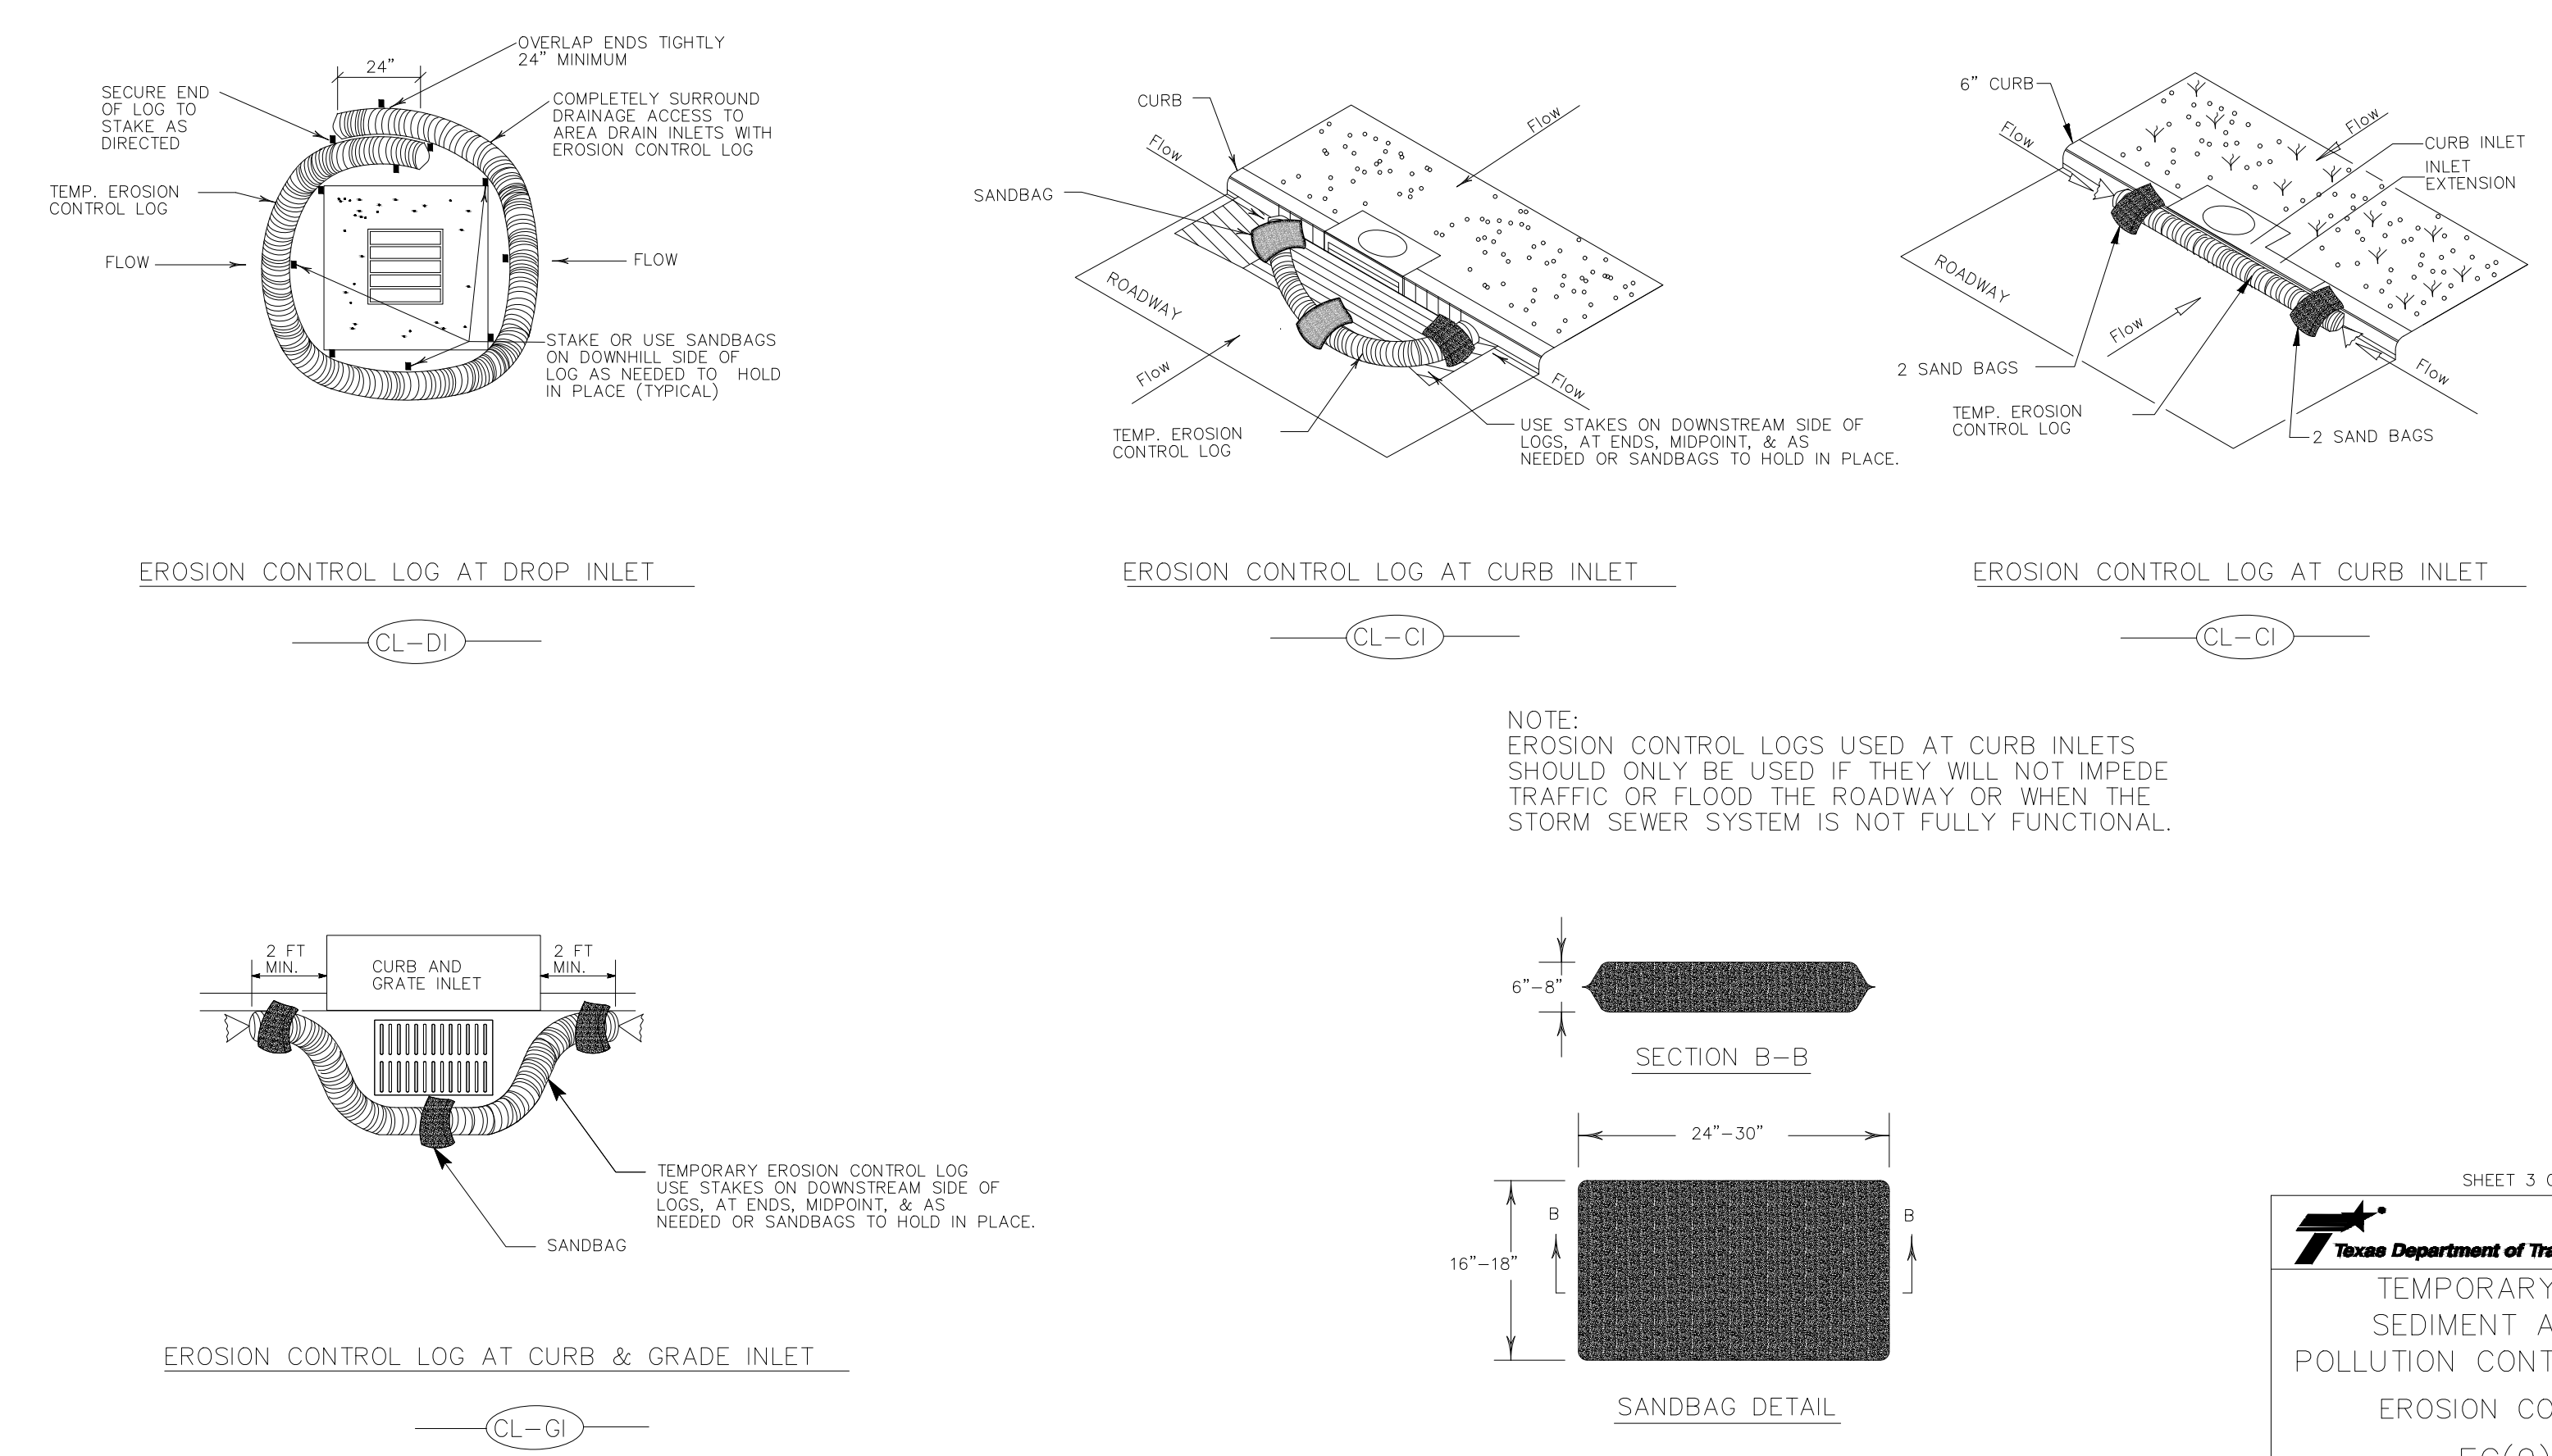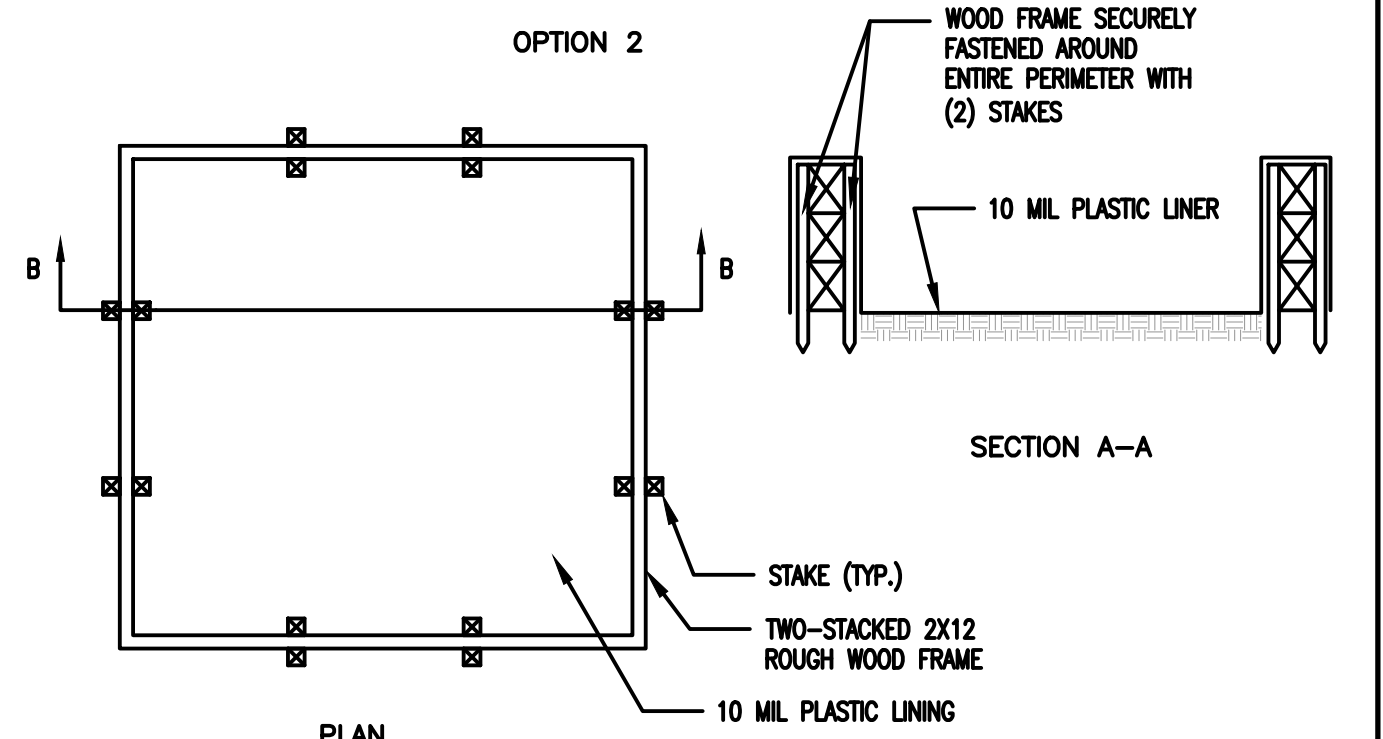

**4 EROSION CONTROL DTLs. SCALE: NTS**

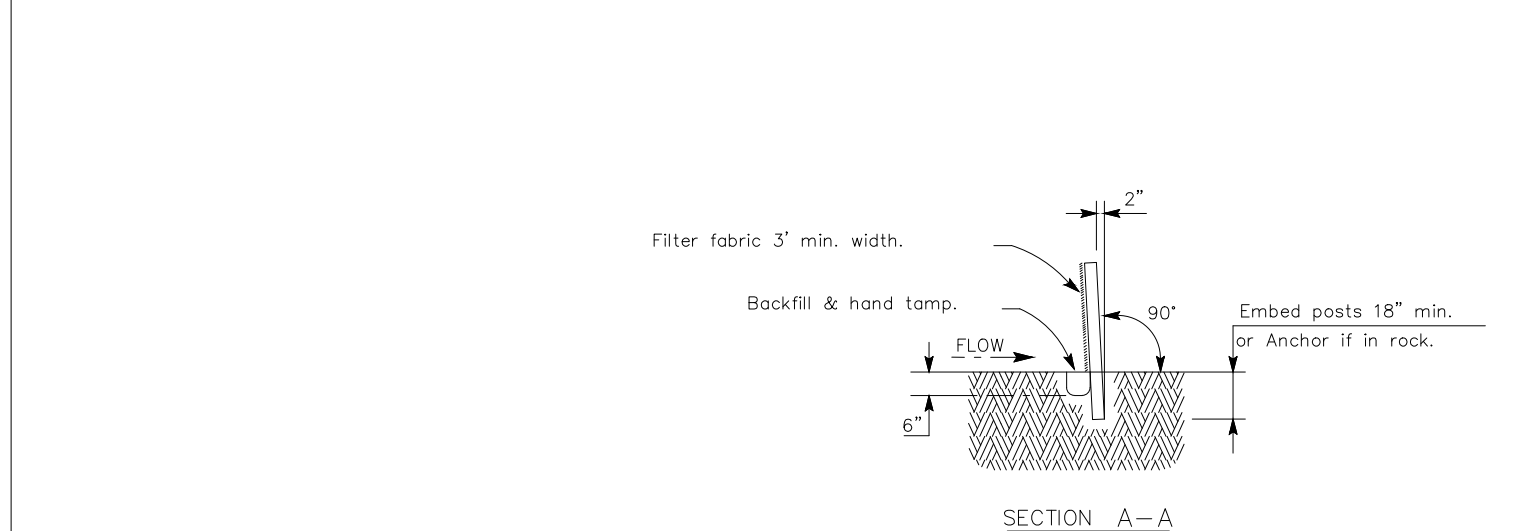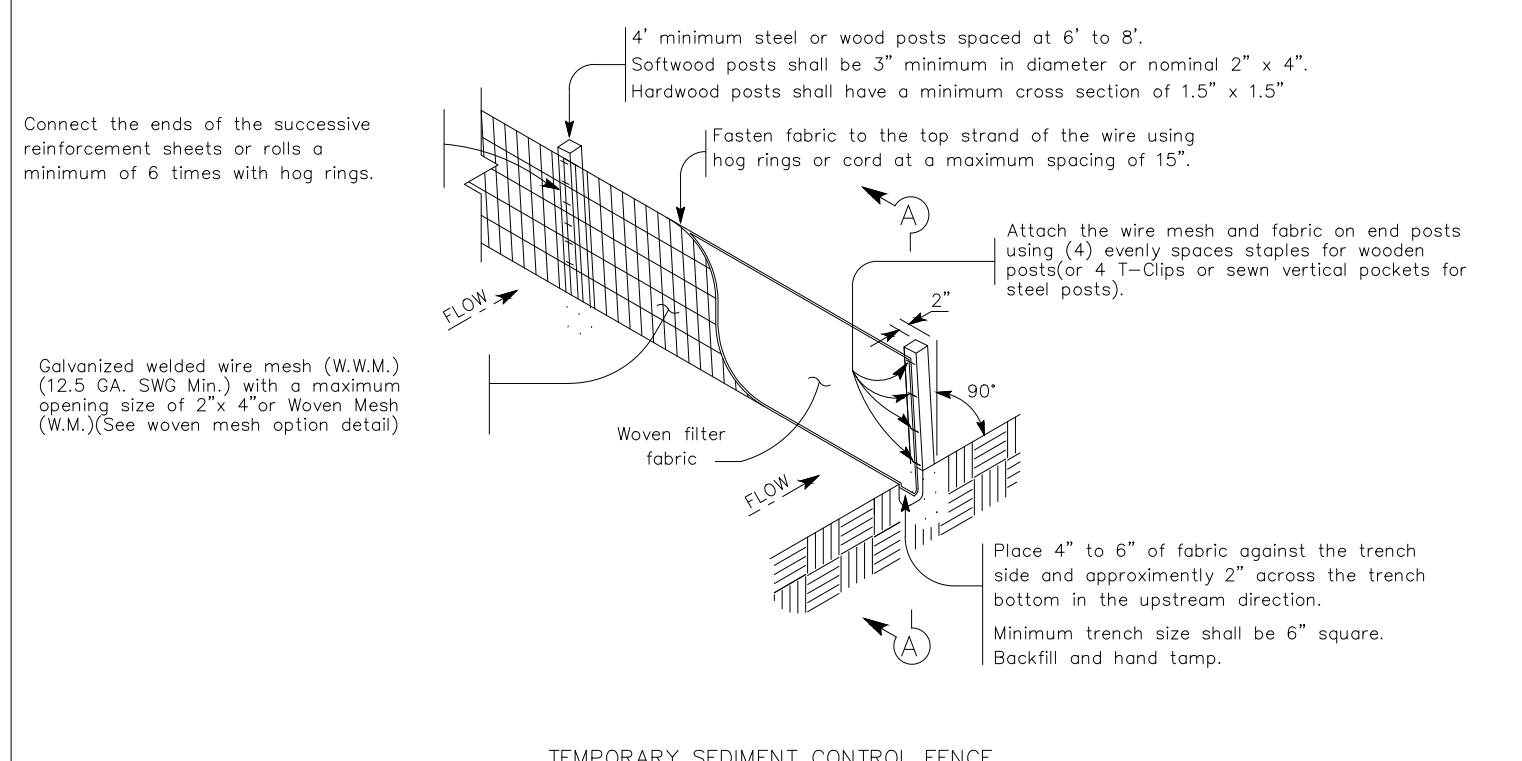

**SEDIMENT CONTROL FENCE USAGE GUIDELINES**

A sediment control fence may be constructed near the downstream perimeter of a disturbed area along a contour to intercept sediment from overland runoff. A 2 year storm frequency may be used to calculate the flow rate to be filtered.

Sediment control fence should be sized to filter a maximum flow through rate of 100 GPM/FT. Sediment control fence is not recommended to control erosion from a drainage area larger than 2 acres.


- LEGEND**
- Sediment Control Fence (SCF)

SHEET 3 OF 3


**Texas Department of Transportation**  
Design Division Standard

TEMPORARY EROSION, SEDIMENT AND WATER POLLUTION CONTROL MEASURES  
EROSION CONTROL LOG  
EC(9)-16


FILE: ec916	DR: T2007	DR: RW	DR: LS/PT	DR: LS
DATE: JULY 2016	DATE: 2017	DATE: 2017	DATE: 2017	DATE: 2017
REVISED	REVISED	REVISED	REVISED	REVISED
DIST	COUNTY	CITY	SHEET NO.	

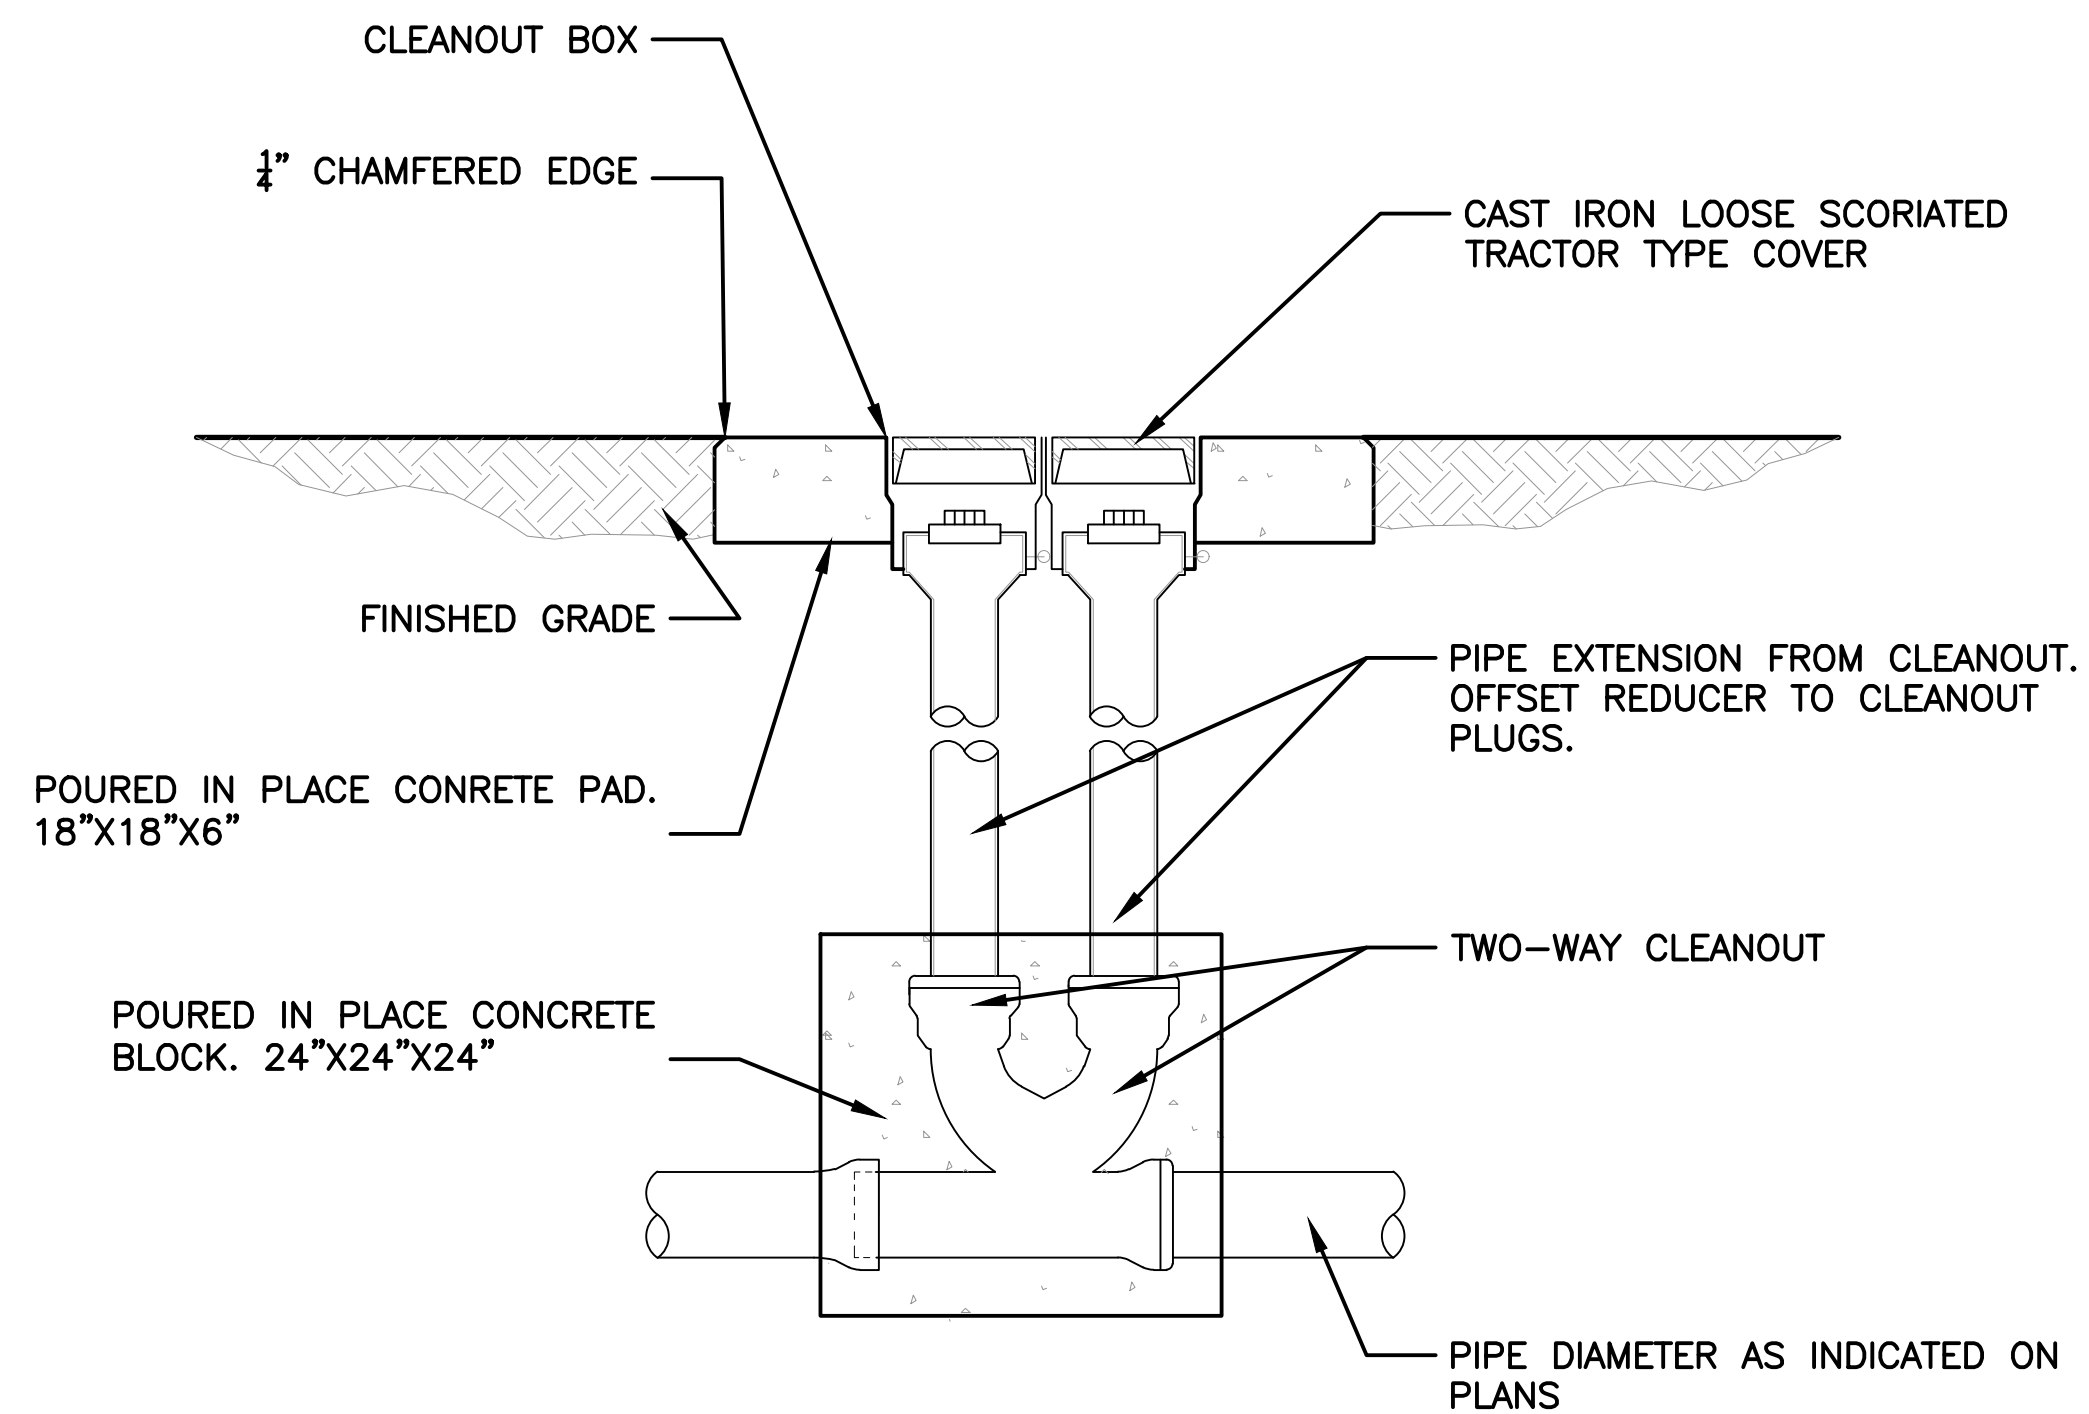


① TWO-WAY CLEANOUT DTL. (TYP.)  
N.T.S

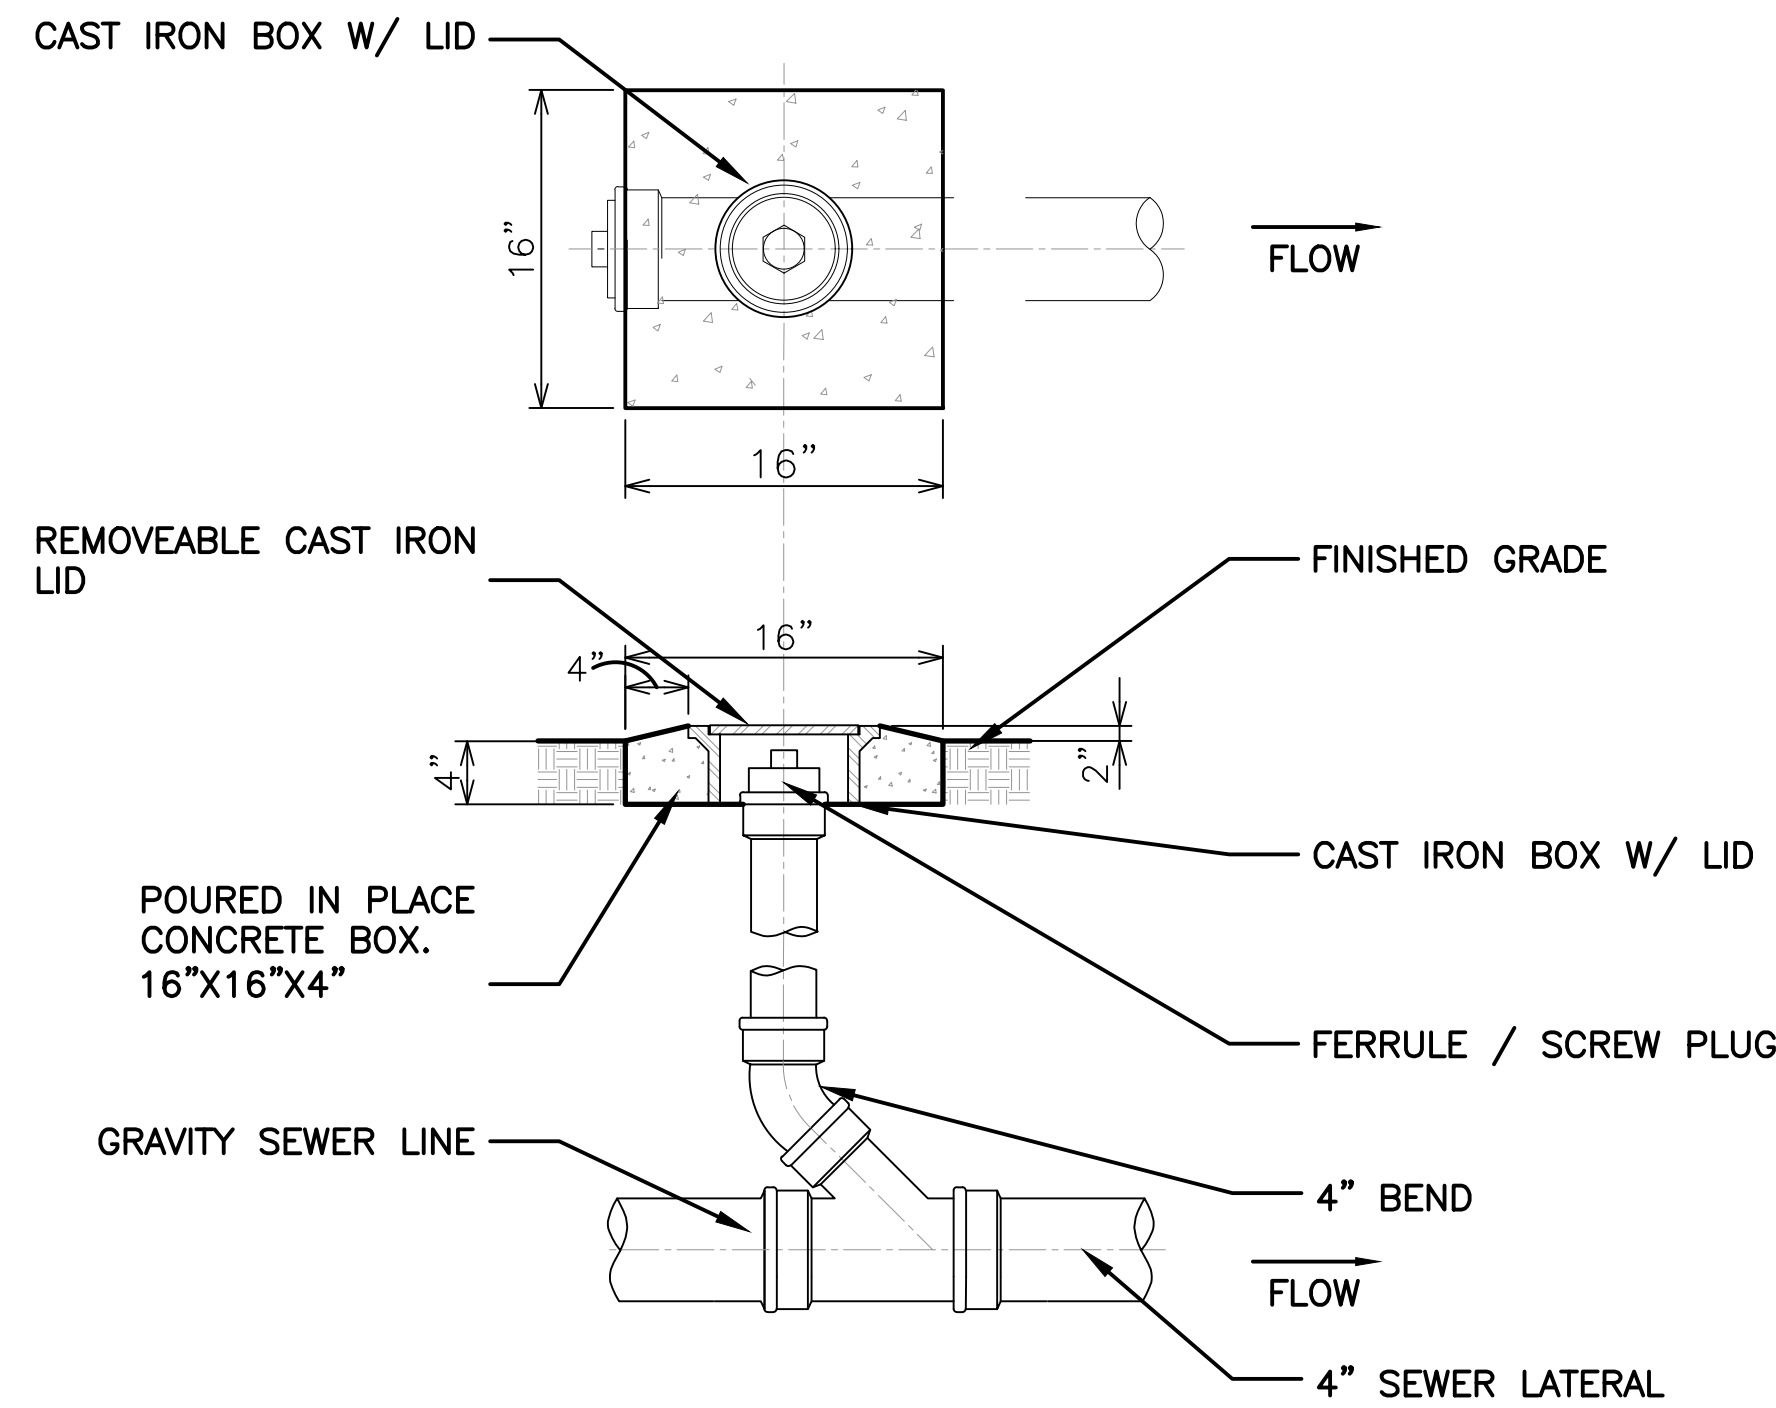

② YARD CLEANOUT DTL. (TYP.)  
N.T.S

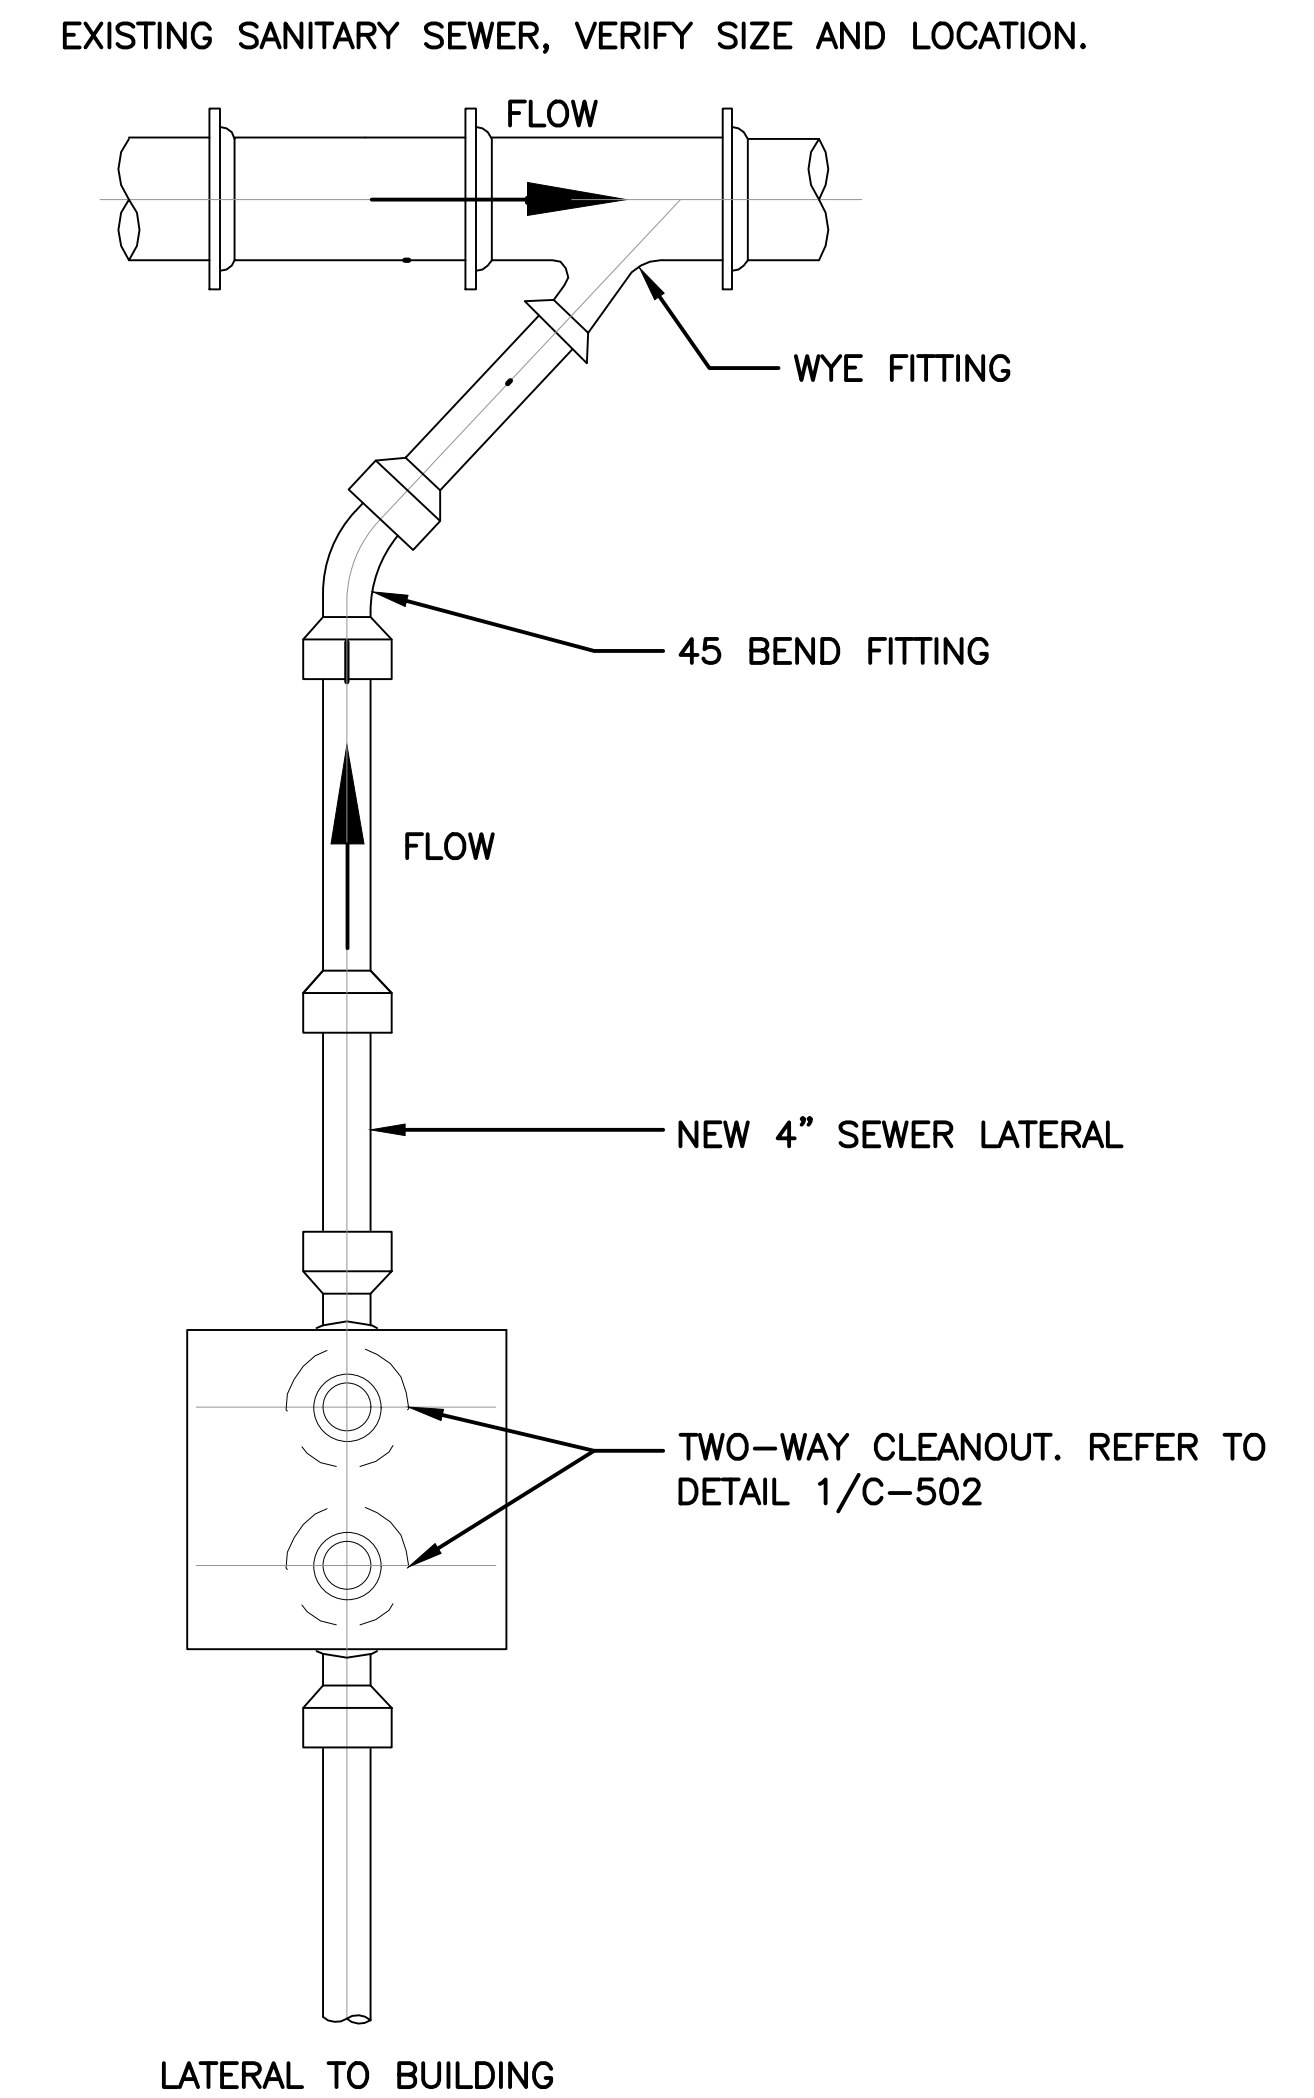


③ TYPICAL SEWER CONNECTION DETAIL  
N.T.S

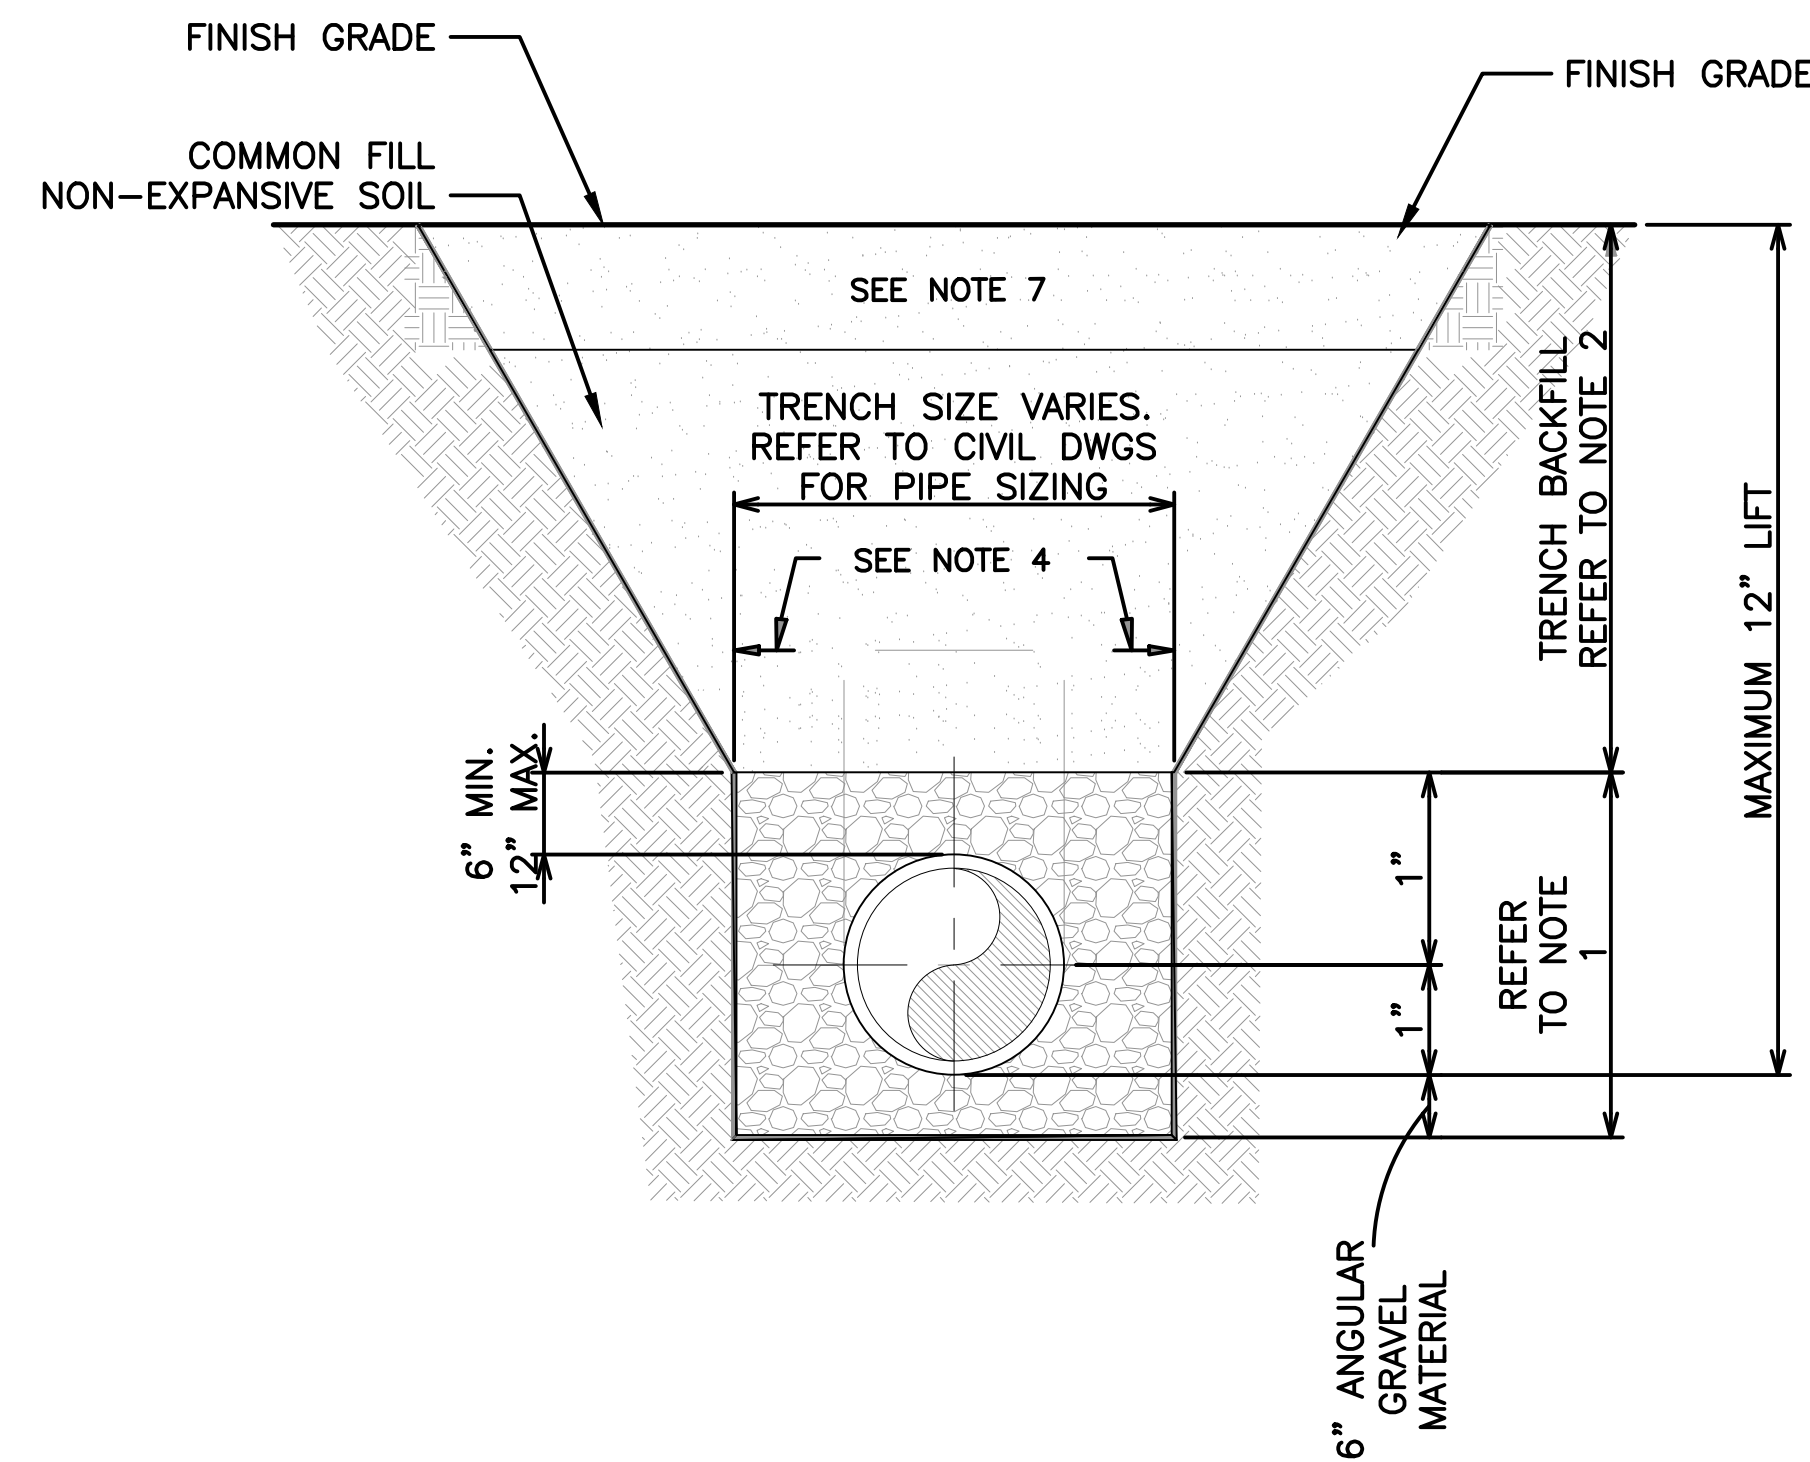


④ TRENCHING AND BEDDING DTL.  
N.T.S

NOTES:

- INITIAL BACKFILL AND HAUNCHING: ANGULAR GRAVEL MATERIAL COMPACTED TO 95% OF THE MAXIMUM DENSITY.
- TRENCH BACKFILL—COMMON FILL COMPACTED TO 95% OF THE MAXIMUM DENSITY. SITE EXCAVATED MATERIALS ARE NOT SUITABLE BACKFILL FOR COMMON FILL. COMMON FILL SHALL BE NON-EXPANSIVE SOIL.
- 12" MAX. (6" MIN.) FOR PIPE DIAMETER LESS THAN 24" AND 24" MAX (12" MIN) FOR PIPE DIAMETER 24" AND LARGER.
- WATER SHALL NOT BE PERMITTED IN THE TRENCH DURING CONSTRUCTION.
- ALL PIPE TO BE INSTALLED WITH BELL FACING UPSTREAM TO THE DIRECTION OF THE FLOW.
- FINAL RESTORATION IN IMPROVED AREAS SHALL BE IN COMPLIANCE WITH STATEMENT OF WORK AND TO THE SATISFACTION OF THE CONTRACTING OFFICER.
- IN GREEN AREAS THE TOP 1/4 OF THE EXCAVATION THE USE OF EXCAVATED MATERIALS FOR FINAL BACKFILL OF TRENCHES. EXISTING MATERIAL MUST BE FREE OF LARGE STONES, CLODS AND ORGANIC MATTER. COMPACTED TO 95% OF STANDARD PROCTOR IN PAVED AREAS.

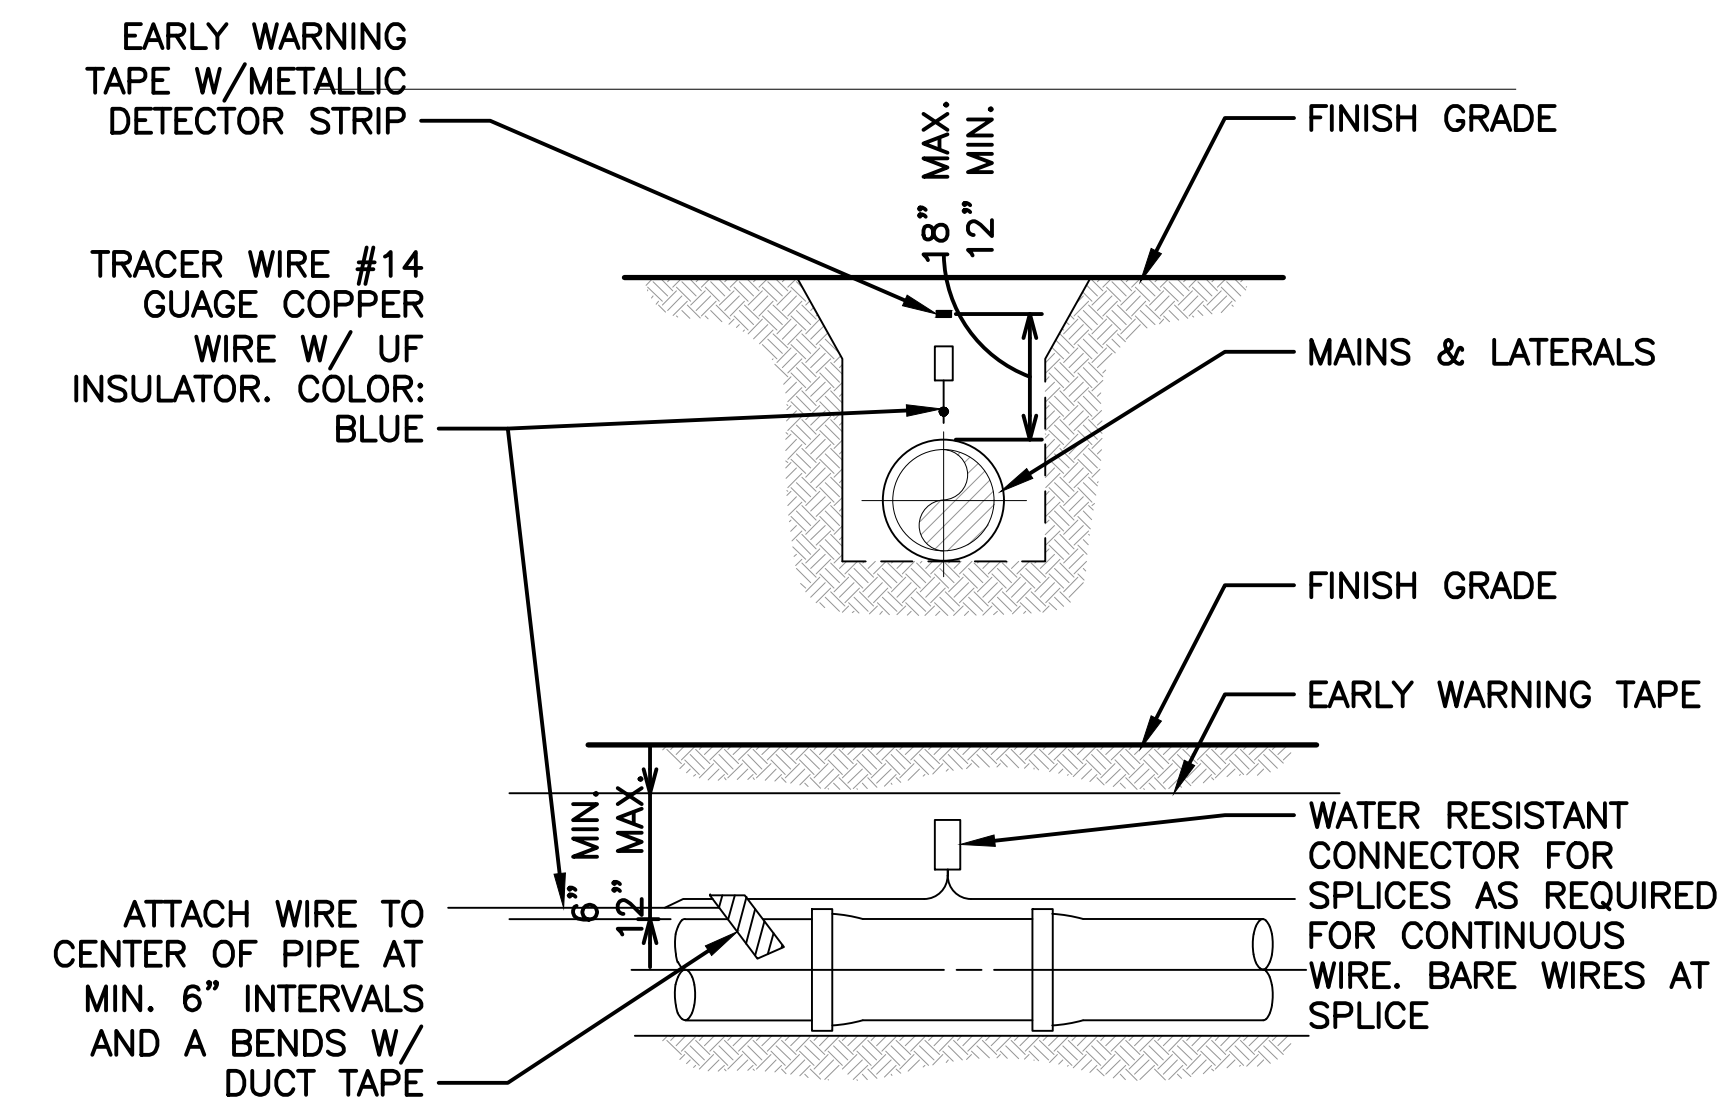

⑤ PIPE LOCATING DTL.  
N.T.S

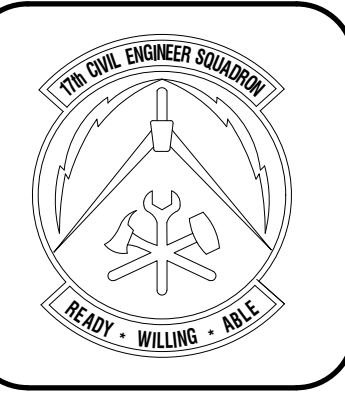

DATE	REVISIONS


Designed by JH/MLLA	Drawn by JH/MLLA	Reviewed by RT/JH	Submitted by PC/BS
------------------------	---------------------	----------------------	-----------------------

PROJECT TITLE  
FIRE STATION ADD/ALTER, B3321  
PROJECT NO. 1039839  
17th TRAINING WING  
GOODFELLOW AIR FORCE BASE, TEXAS

Project Number 1039839
SHEET TITLE SITE DETAILS
Date JAN 2024

SEQ. 16	SHEET C-502	OF 50
------------	----------------	----------



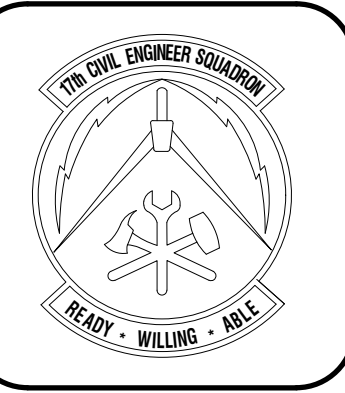

KEYNOTES AS INDICATED BY (X)


1. CONTRACTOR SHALL DEMO EXISTING HALF WALL INCLUDING FRAMING, GYP. BD., TRIM, AND MOLDING.
2. CONTRACTOR SHALL DEMO EXISTING CARPET FLOORING AND RUBBER BASE. CONTRACTOR SHALL SCRAPE AND PREPARE SURFACE FOR NEW FLOORING AND FLOOR BASE.
3. CONTRACTOR SHALL DEMO EXISTING CEILING SYSTEM AND LIGHT FIXTURES.
4. CONTRACTOR SHALL DEMO RESTROOM DOOR AND FRAME. CONTRACTOR SHALL DEMO EXISTING FLOOR BASE TO NEAREST JOINT.
5. CONTRACTOR SHALL CUT OPENING TO RESTROOM. PROVIDE NEW FRAMING AS NEEDED FOR NEW DOORWAY.
6. CONTRACTOR SHALL REMOVE EXISTING WALL BASE MATERIAL. CONTRACTOR SHALL PROTECT EXISTING FIXTURES AND PARTITIONS.
7. CONTRACTOR SHALL DEMO EXISTING METAL GUTTER AND DOWNSPOUT.
8. CONTRACTOR SHALL DEMO EXISTING STANDING SEAM METAL PANELS FOR NEW BREEZEWAY AND ADDITION. REMOVE ENTIRE PANEL TO RIDGE.
9. CONTRACTOR SHALL DEMO EXISTING WALL AND INSULATION TO STUD. EXISTING ELECTRICAL CONDUIT, WIRING, BOXES, AND CIRCUITS MAY BE REUSED WHERE APPLICABLE. HOWEVER, CONTRACTOR SHALL PROVIDE ALL NEW RECEPTACLES, COVERS, AND SWITCHES THROUGHOUT. REFER TO ELECTRICAL.

GENERAL NOTES



1. CONTRACTOR SHALL BE RESPONSIBLE FOR VERIFYING EXISTING DIMENSIONS, EQUIPMENT, AND CONDITIONS PRIOR TO START OF WORK.
2. CONTRACTOR SHALL ENSURE WORK AREAS SHALL BE KEPT CLEAN, SAFE, AND IN A WORKMANLIKE CONDITION. DEBRIS SHALL BE CLEANED ON A DAILY BASIS AND SITE SHALL BE MAINTAINED IN ACCORDANCE WITH THE SPECIFICATIONS.
3. THE CONTRACTOR SHALL TAKE APPROPRIATE STEPS TO PROTECT BUILDING ELEMENTS OUTSIDE THE SCOPE OF WORK AND LABELED AS "EXISTING TO REMAIN". DAMAGE TO THESE ITEMS REQUIRING REPAIR OR REPLACEMENT SHALL BE PERFORMED BY THE CONTRACTOR AT NO ADDITIONAL COST TO THE GOVERNMENT.
4. CONTRACTOR SHALL COORDINATE WITH ALL OTHER TRADES.
5. FOR UNDER-SLAB DEMO, CONTRACTOR SHALL DEMO THE MINIMUM NECESSARY CONCRETE TO PROVIDE FOR NEW PLUMBING INSTALLATION.

LEGEND

- EXISTING TO REMAIN
- DEMO

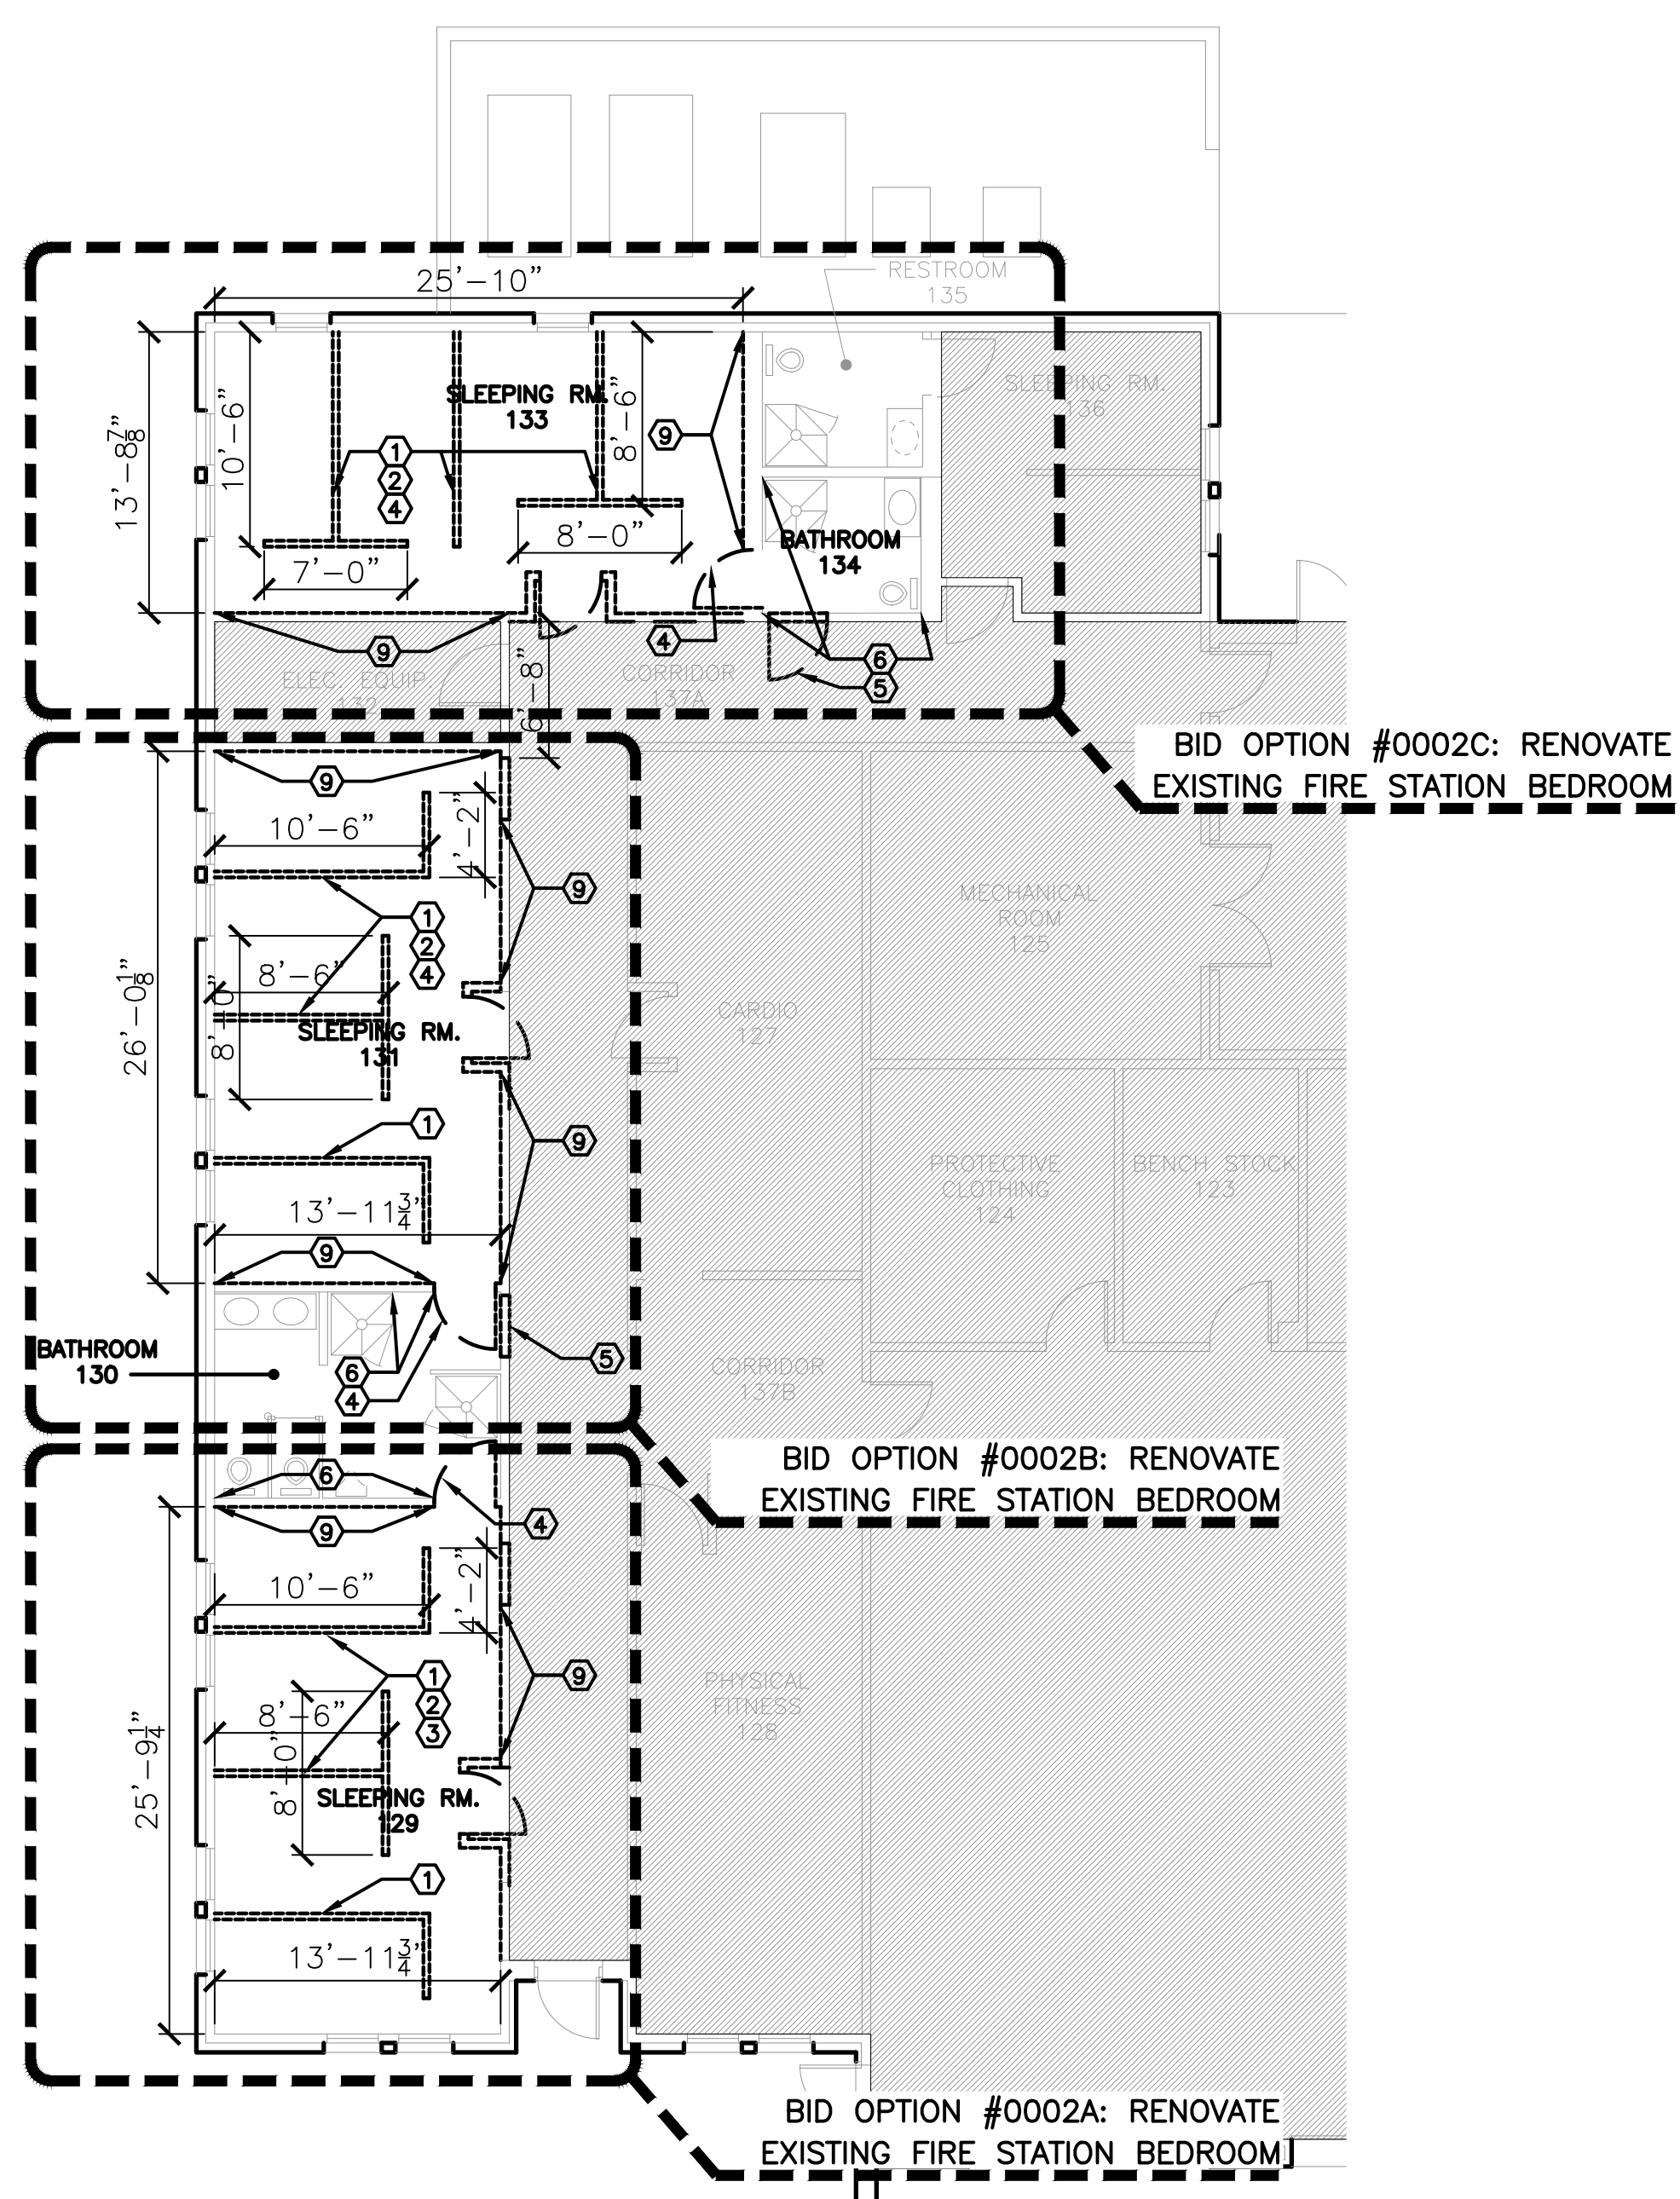

2 DEMO PLAN-BID OPTION  
 $\frac{1}{8}'' = 1' - 0''$

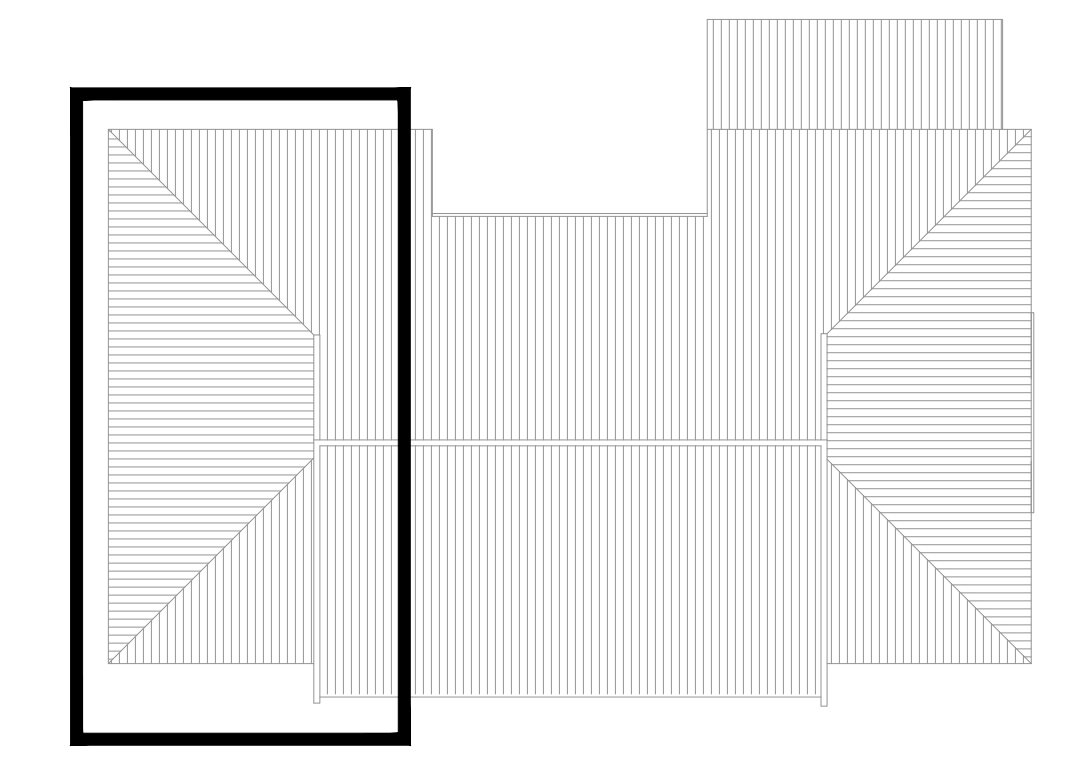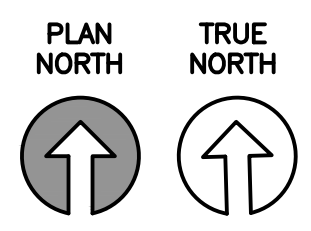

KEY PLAN


REVISIONS	DATE

Designed by JH/RM/LLA	Drawn by JH/RM/LLA	Reviewed by RT/JH	Submitted by PC/BS
--------------------------	-----------------------	----------------------	-----------------------

PROJECT TITLE  
**FIRE STATION ADD/ALTER, B3321**  
**PROJECT NO. 1039839**  
**17th TRAINING WING**  
**GOODFELLOW AIR FORCE BASE, TEXAS**

Project Number: 1039839
SHEET TITLE DEMO PLAN
Date: JAN 2024

SEQ. 17	SHEET AD-101	OF 50
------------	-----------------	----------

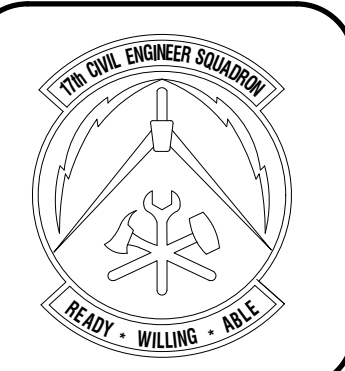


REVISIONS	DATE

Designed by JH/ML/LA	Drawn by JH/ML/LA	Reviewed by RT/JH	Submitted by PC/ES
-------------------------	----------------------	----------------------	-----------------------

PROJECT TITLE  
**FIRE STATION ADD/ALTER, B3321  
PROJECT NO. 1039839  
17th TRAINING WING  
GOODFELLOW AIR FORCE BASE, TEXAS**

Project Number: 1039839
SHEET TITLE FLOORPLAN NEW - OVERALL FLOORPLAN
Date: JAN 2024

SEQ.	SHEET	OF
18	<b>A-101</b>	50

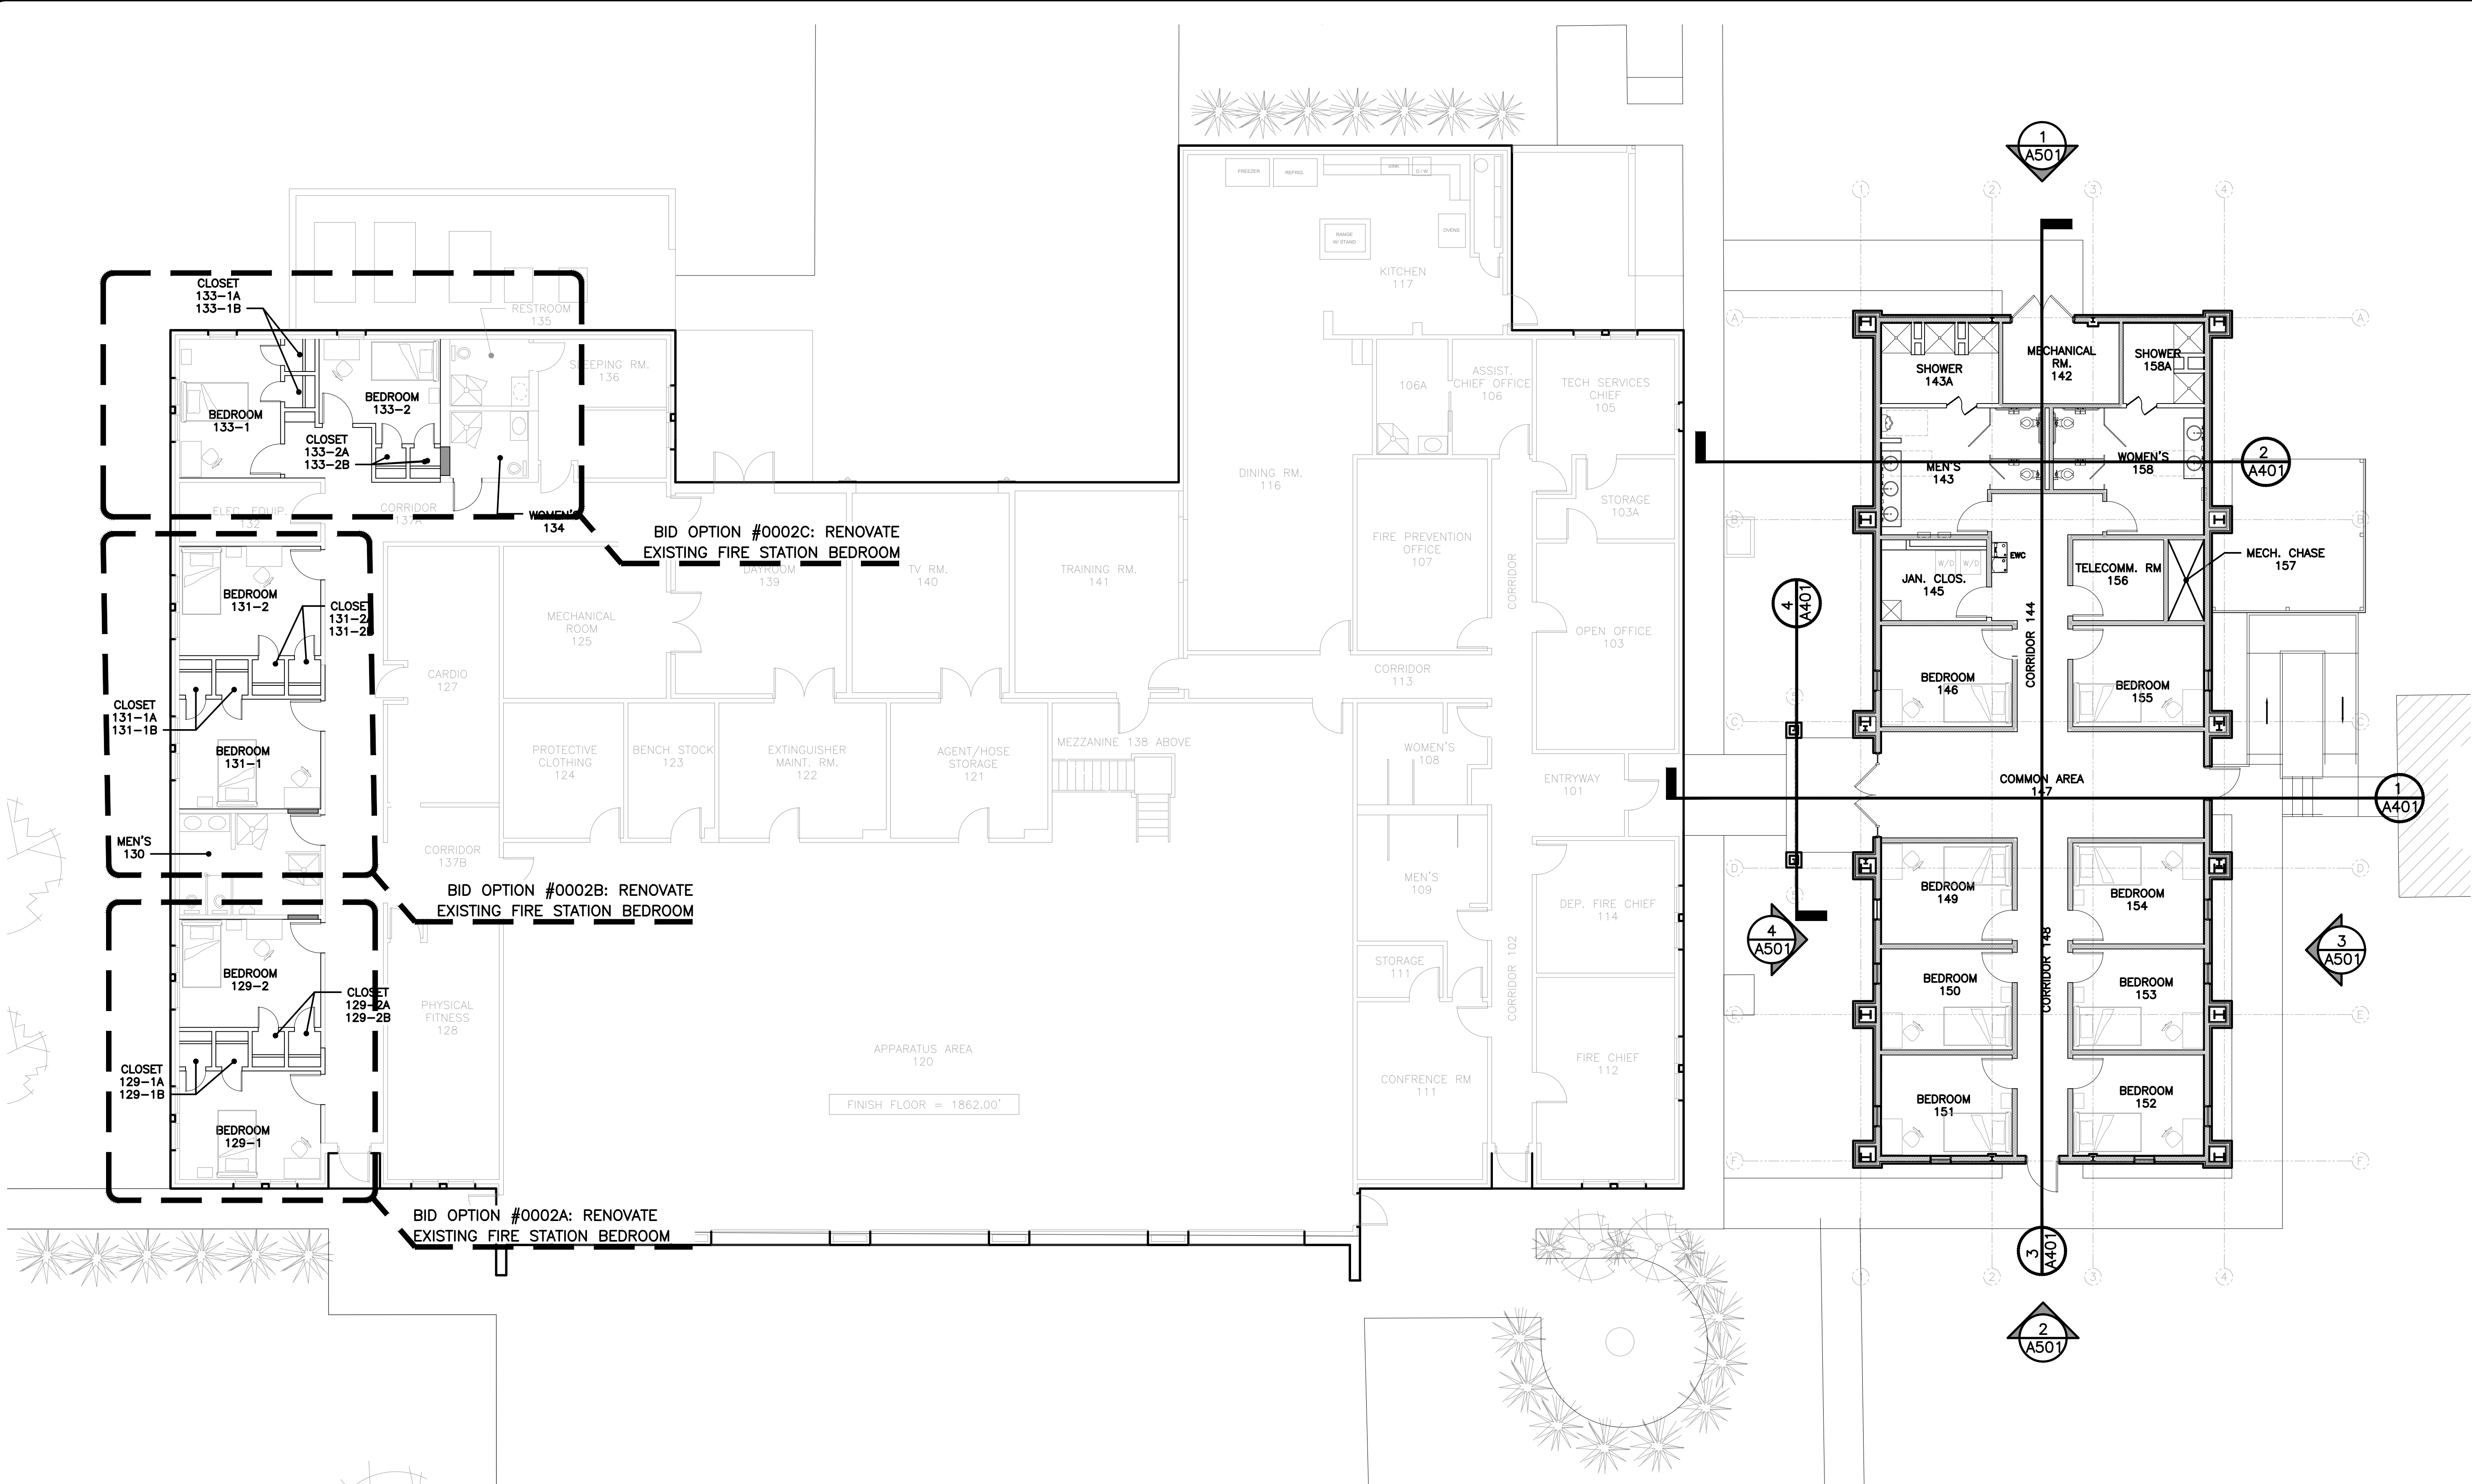

**1 OVERALL FLOORPLAN NEW**  
 $\frac{1}{8}'' = 1' - 0''$   
 PLAN NORTH TRUE NORTH


**GENERAL NOTES**

- CONTRACTOR SHALL BE RESPONSIBLE FOR VERIFYING EXISTING DIMENSIONS, EQUIPMENT, AND CONDITIONS PRIOR TO START OF WORK.
- CONTRACTOR SHALL ENSURE WORK AREAS SHALL BE KEPT CLEAN, SAFE, AND IN A WORKMANLIKE CONDITION. DEBRIS SHALL BE CLEANED ON A DAILY BASIS AND SITE SHALL BE MAINTAINED IN ACCORDANCE WITH THE SPECIFICATIONS.
- THE CONTRACTOR SHALL TAKE APPROPRIATE STEPS TO PROTECT BUILDING ELEMENTS OUTSIDE THE SCOPE OF WORK AND LABELED AS "EXISTING TO REMAIN". DAMAGE TO THESE ITEMS REQUIRING REPAIR OR REPLACEMENT SHALL BE PERFORMED BY THE CONTRACTOR AT NO ADDITIONAL COST TO THE GOVERNMENT.
- CONTRACTOR SHALL COORDINATE WITH ALL OTHER TRADES.

**LEGEND**

- SECTION TAG  
RE: A/401
- EXTERIOR TAG  
RE: A/501



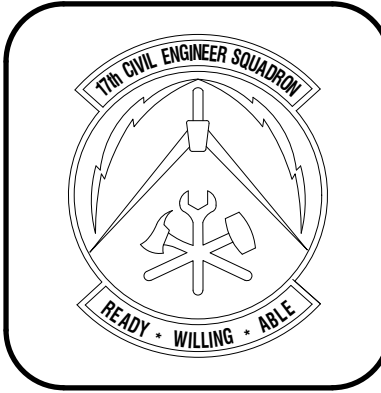


**GENERAL NOTES**


1. FURNITURE IS SHOWN FOR CLARITY. FURNITURE TO BE PROVIDED BY OTHERS.
2. CONTRACTOR SHALL BE RESPONSIBLE FOR VERIFYING EXISTING DIMENSIONS, EQUIPMENT, AND CONDITIONS PRIOR TO START OF WORK.
3. CONTRACTOR SHALL ENSURE WORK AREAS SHALL BE KEPT CLEAN, SAFE, AND IN A WORKMANLIKE CONDITION. DEBRIS SHALL BE CLEANED ON A DAILY BASIS AND SITE SHALL BE MAINTAINED IN ACCORDANCE WITH THE SPECIFICATIONS.
4. THE CONTRACTOR SHALL TAKE APPROPRIATE STEPS TO PROTECT BUILDING ELEMENTS OUTSIDE THE SCOPE OF WORK AND LABELED AS "EXISTING TO REMAIN". DAMAGE TO THESE ITEMS REQUIRING REPAIR OR REPLACEMENT SHALL BE PERFORMED BY THE CONTRACTOR AT NO ADDITIONAL COST TO THE GOVERNMENT.
5. CONTRACTOR SHALL COORDINATE WITH ALL OTHER TRADES.
6. IN ALL BID OPTIONS THE CONTRACTOR SHALL BE RESPONSIBLE FOR PATCHING, REPAIRING, TAPING, FLOATING, AND TEXTURING EXPOSED OR DAMAGED SURFACES FROM DEMO'D AREAS.
7. DIMENSIONS ARE SHOWN TO FINISH FACE OF WALL UNLESS NOTED OTHERWISE.

**LEGEND**

- INTERIOR ELEVATION TAG RE: A701
- DOOR TAG RE: A802
- WINDOW TAG RE: A-802
- PARTITION TYPE RE: A-601
- BATT INSULATION

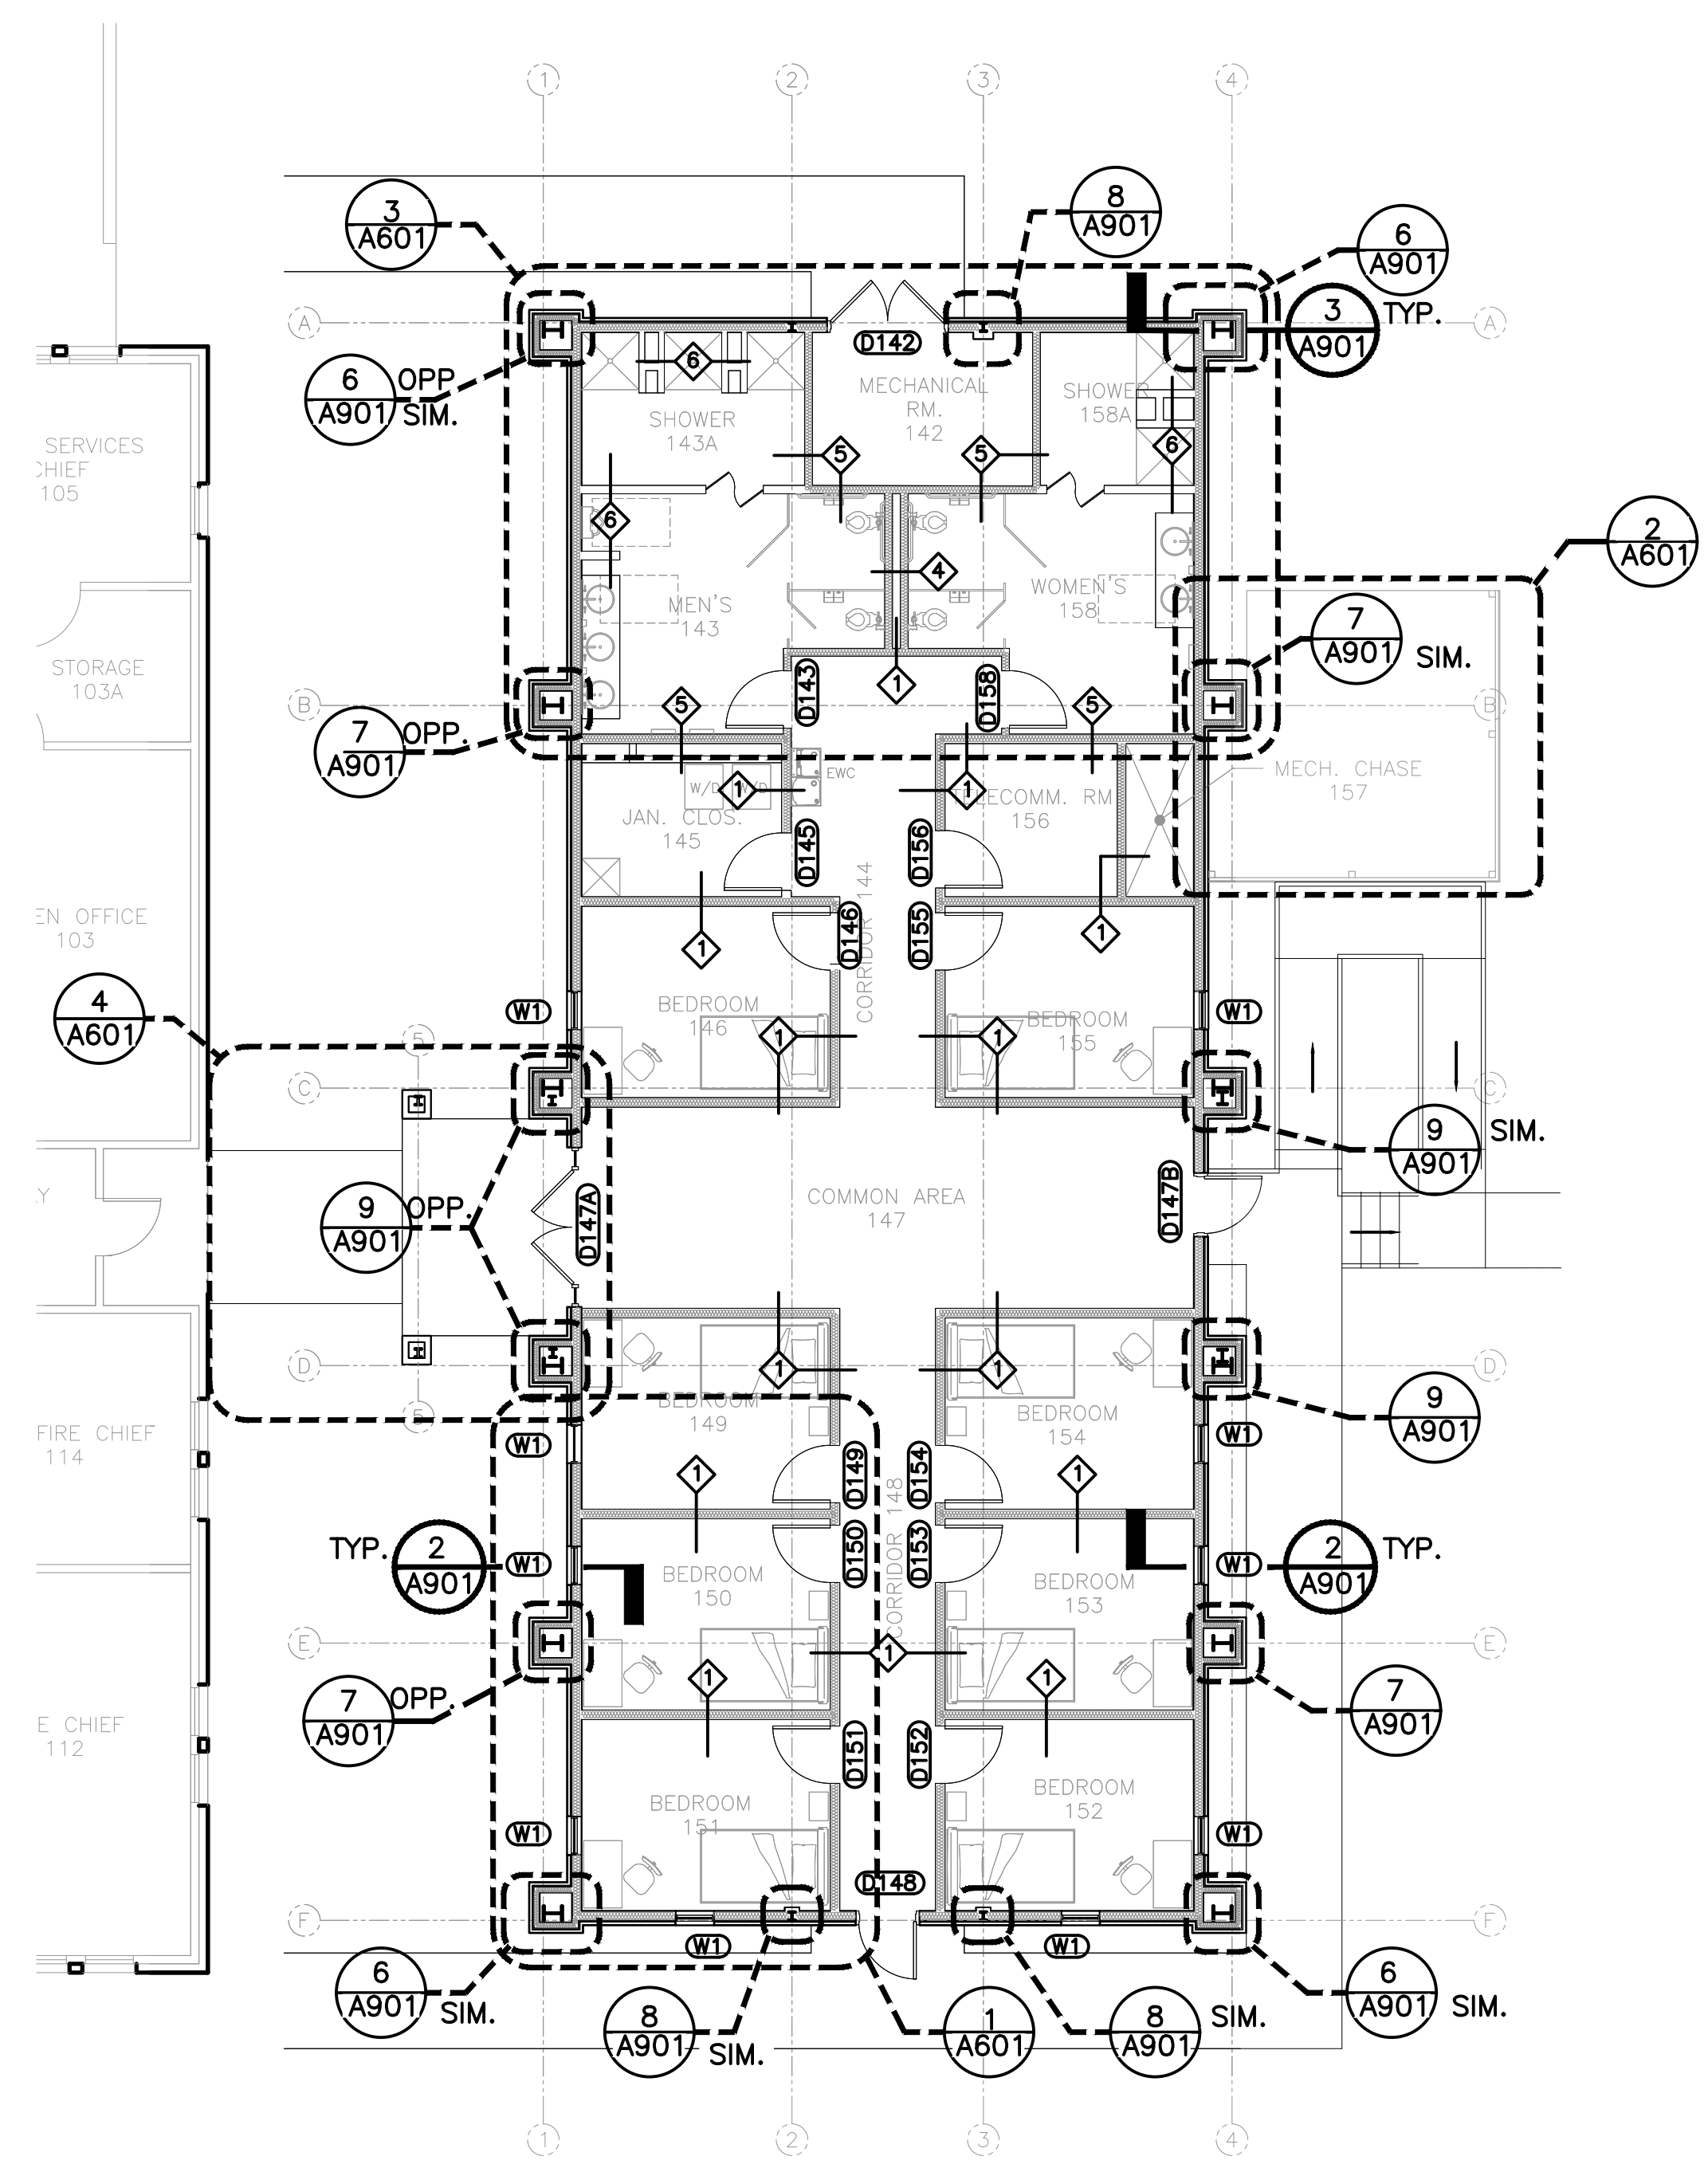

① NEW FLOORPLAN - ANNOTATED PLAN  
 $\frac{1}{8}'' = 1' - 0''$

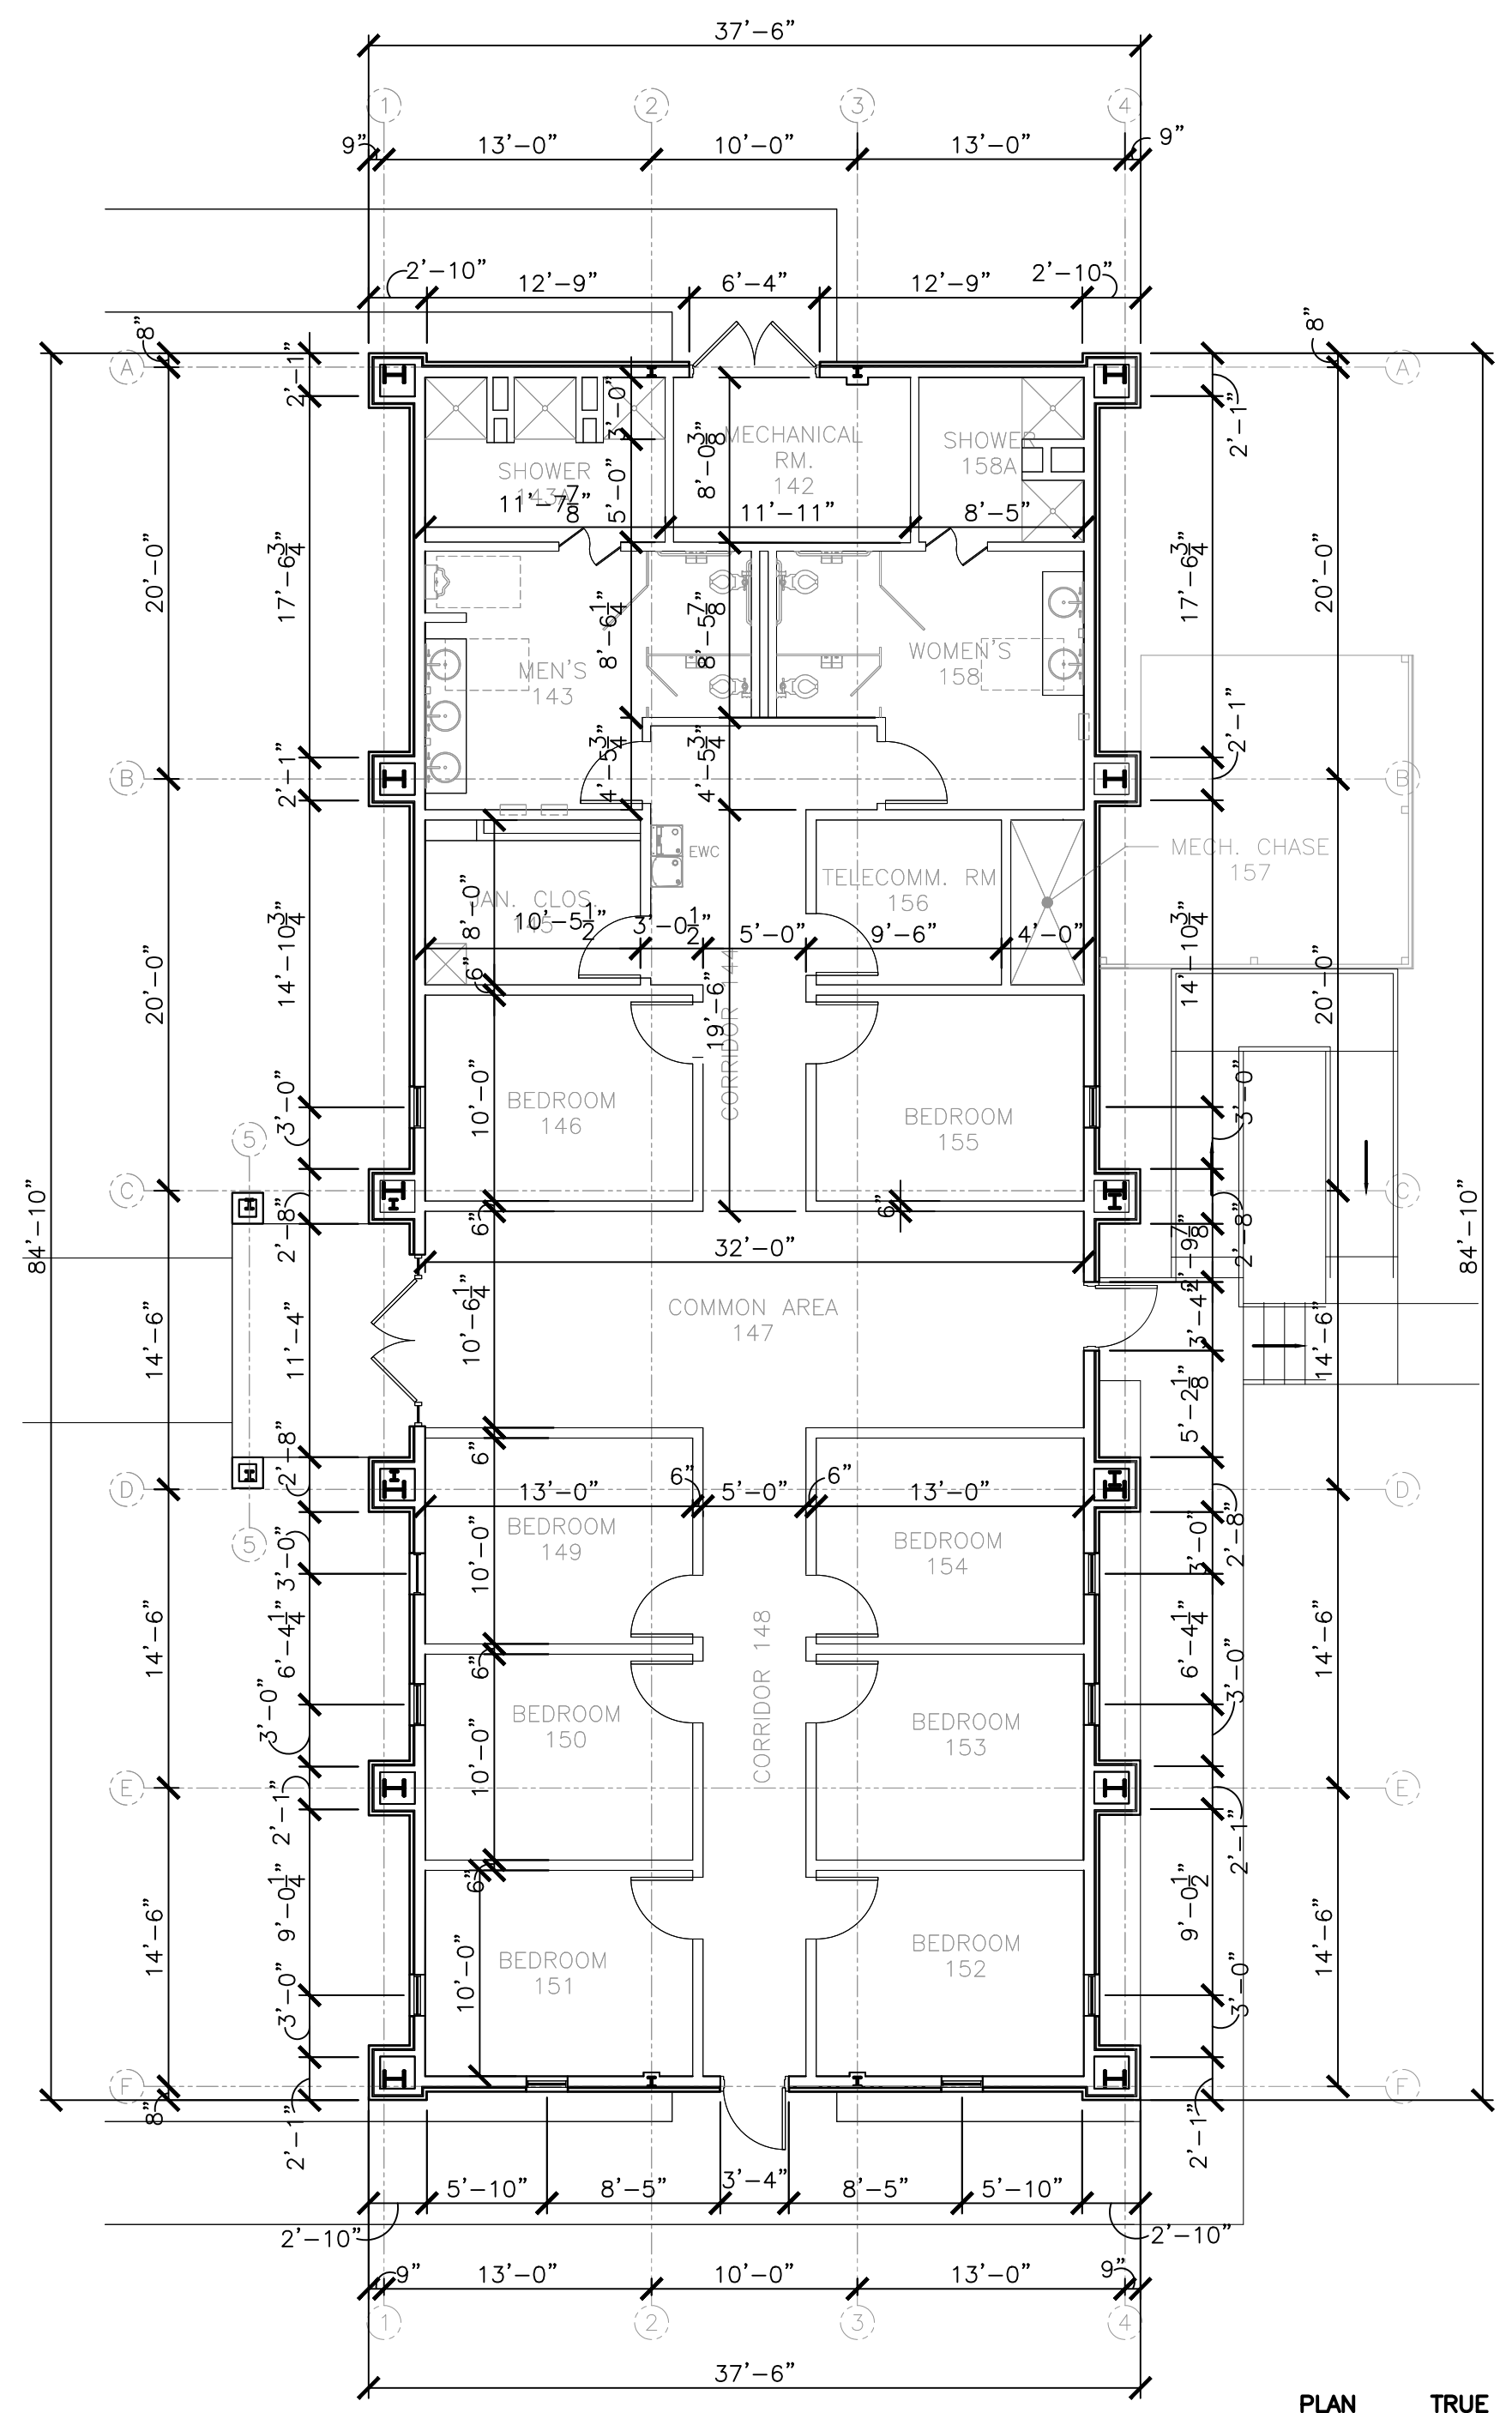

② NEW FLOORPLAN - DIMENSION PLAN  
 $\frac{1}{8}'' = 1' - 0''$


REVISIONS	DATE

Designed by JH/MLLA	Drawn by JH/MLLA	Reviewed by RT/JAH	Submitted by PCES
------------------------	---------------------	-----------------------	----------------------

PROJECT TITLE  
**FIRE STATION ADD/ALTER, B3321**  
**PROJECT NO. 1039839**  
**17th TRAINING WING**  
**GOODFELLOW AIR FORCE BASE, TEXAS**

Project Number: 1039839
SHEET TITLE FLOORPLAN NEW - NEW ADDITION
Date: JAN 2024

SEQ.	SHEET	OF
19	A-102	50

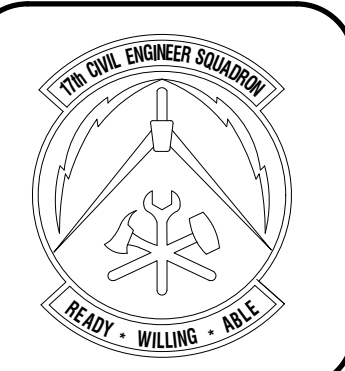

REVISIONS	DATE

Designed by JH/MLLA	Drawn by JH/MLLA	Reviewed by RT/JH	Submitted by PC/ES
------------------------	---------------------	----------------------	-----------------------

PROJECT TITLE  
**FIRE STATION ADD/ALTER, B3321**  
**PROJECT NO. 1039839**  
**17th TRAINING WING**  
**GOODFELLOW AIR FORCE BASE, TEXAS**

Project Number: 1039839
SHEET TITLE FLOORPLAN NEW - BID OPTIONS
Date: JAN 2024



SEQ.	SHEET	OF
20	<b>A-103</b>	50

### GENERAL NOTES


- FURNITURE IS SHOWN FOR CLARITY. FURNITURE TO BE PROVIDED BY OTHERS.
- CONTRACTOR SHALL BE RESPONSIBLE FOR VERIFYING EXISTING DIMENSIONS, EQUIPMENT, AND CONDITIONS PRIOR TO START OF WORK.
- CONTRACTOR SHALL ENSURE WORK AREAS SHALL BE KEPT CLEAN, SAFE, AND IN A WORKMANLIKE CONDITION. DEBRIS SHALL BE CLEANED ON A DAILY BASIS AND SITE SHALL BE MAINTAINED IN ACCORDANCE WITH THE SPECIFICATIONS.
- THE CONTRACTOR SHALL TAKE APPROPRIATE STEPS TO PROTECT BUILDING ELEMENTS OUTSIDE THE SCOPE OF WORK AND LABELED AS "EXISTING TO REMAIN". DAMAGE TO THESE ITEMS REQUIRING REPAIR OR REPLACEMENT SHALL BE PERFORMED BY THE CONTRACTOR AT NO ADDITIONAL COST TO THE GOVERNMENT.
- CONTRACTOR SHALL COORDINATE WITH ALL OTHER TRADES.
- WHERE BID OPTIONS REQUIRE THE DEMO OF RESTROOM DOORS. CONTRACTOR SHALL BE RESPONSIBLE FOR DEMOLISHING EXISTING DOORS AS INDICATED ON THE DEMO PLAN. CONTRACTOR SHALL PATCH AND REPAIR SURROUNDING SURFACES, TAPE, FLOAT, TEXTURE TO MATCH, PRIME AND PAINT TO EXISTING WALL. CONTRACTOR SHALL PAINT THE ENTIRE WALL AND PROVIDE NEW FLOOR BASE SIMILAR TO EXISTING. CONTRACTOR SHALL TAPE OFF AND PROTECT EXISTING PARTITIONS, FLOORING, AND FIXTURES FROM DAMAGE.
- IN ALL BID OPTION AREAS: THE CONTRACTOR SHALL BE RESPONSIBLE FOR PATCHING, REPAIRING, TAPING, FLOATING, AND TEXTURING EXPOSED OR DAMAGED SURFACES FROM DEMO'D AREAS.
- IN ALL BID OPTION AREAS: WHERE EXISTING RESTROOM, CORRIDOR, OR ELECTRICAL CLOSET WALLS ARE TO REMAIN. CONTRACTOR SHALL PROVIDE NEW BATT INSULATION AND (2) LAYERS OF FC GYP. BD. ON THE BEDROOM SIDE. PROVIDE INSULATION TO TOP OF PARTITION.
- CONTRACTOR SHALL BE RESPONSIBLE FOR PROVIDING TEMPORARY WALL CONSTRUCTION AND DUST/SOUND PROTECTION FOR AREAS UNDER CONSTRUCTION IN ACCORDANCE WITH THE SPECIFICATIONS. CONTRACTOR ENTRANCE DURING CONSTRUCTION SHALL BE ADJACENT TO ROOM 129-1 UNLESS NOTED OTHERWISE.

### LEGEND


- EXISTING TO REMAIN
- DOOR INFILL
- ELEVATION TAG
- BATT INSULATION
- PARTITION TYPE RE: A801/A802
- DOOR TAG RE: A801/A802

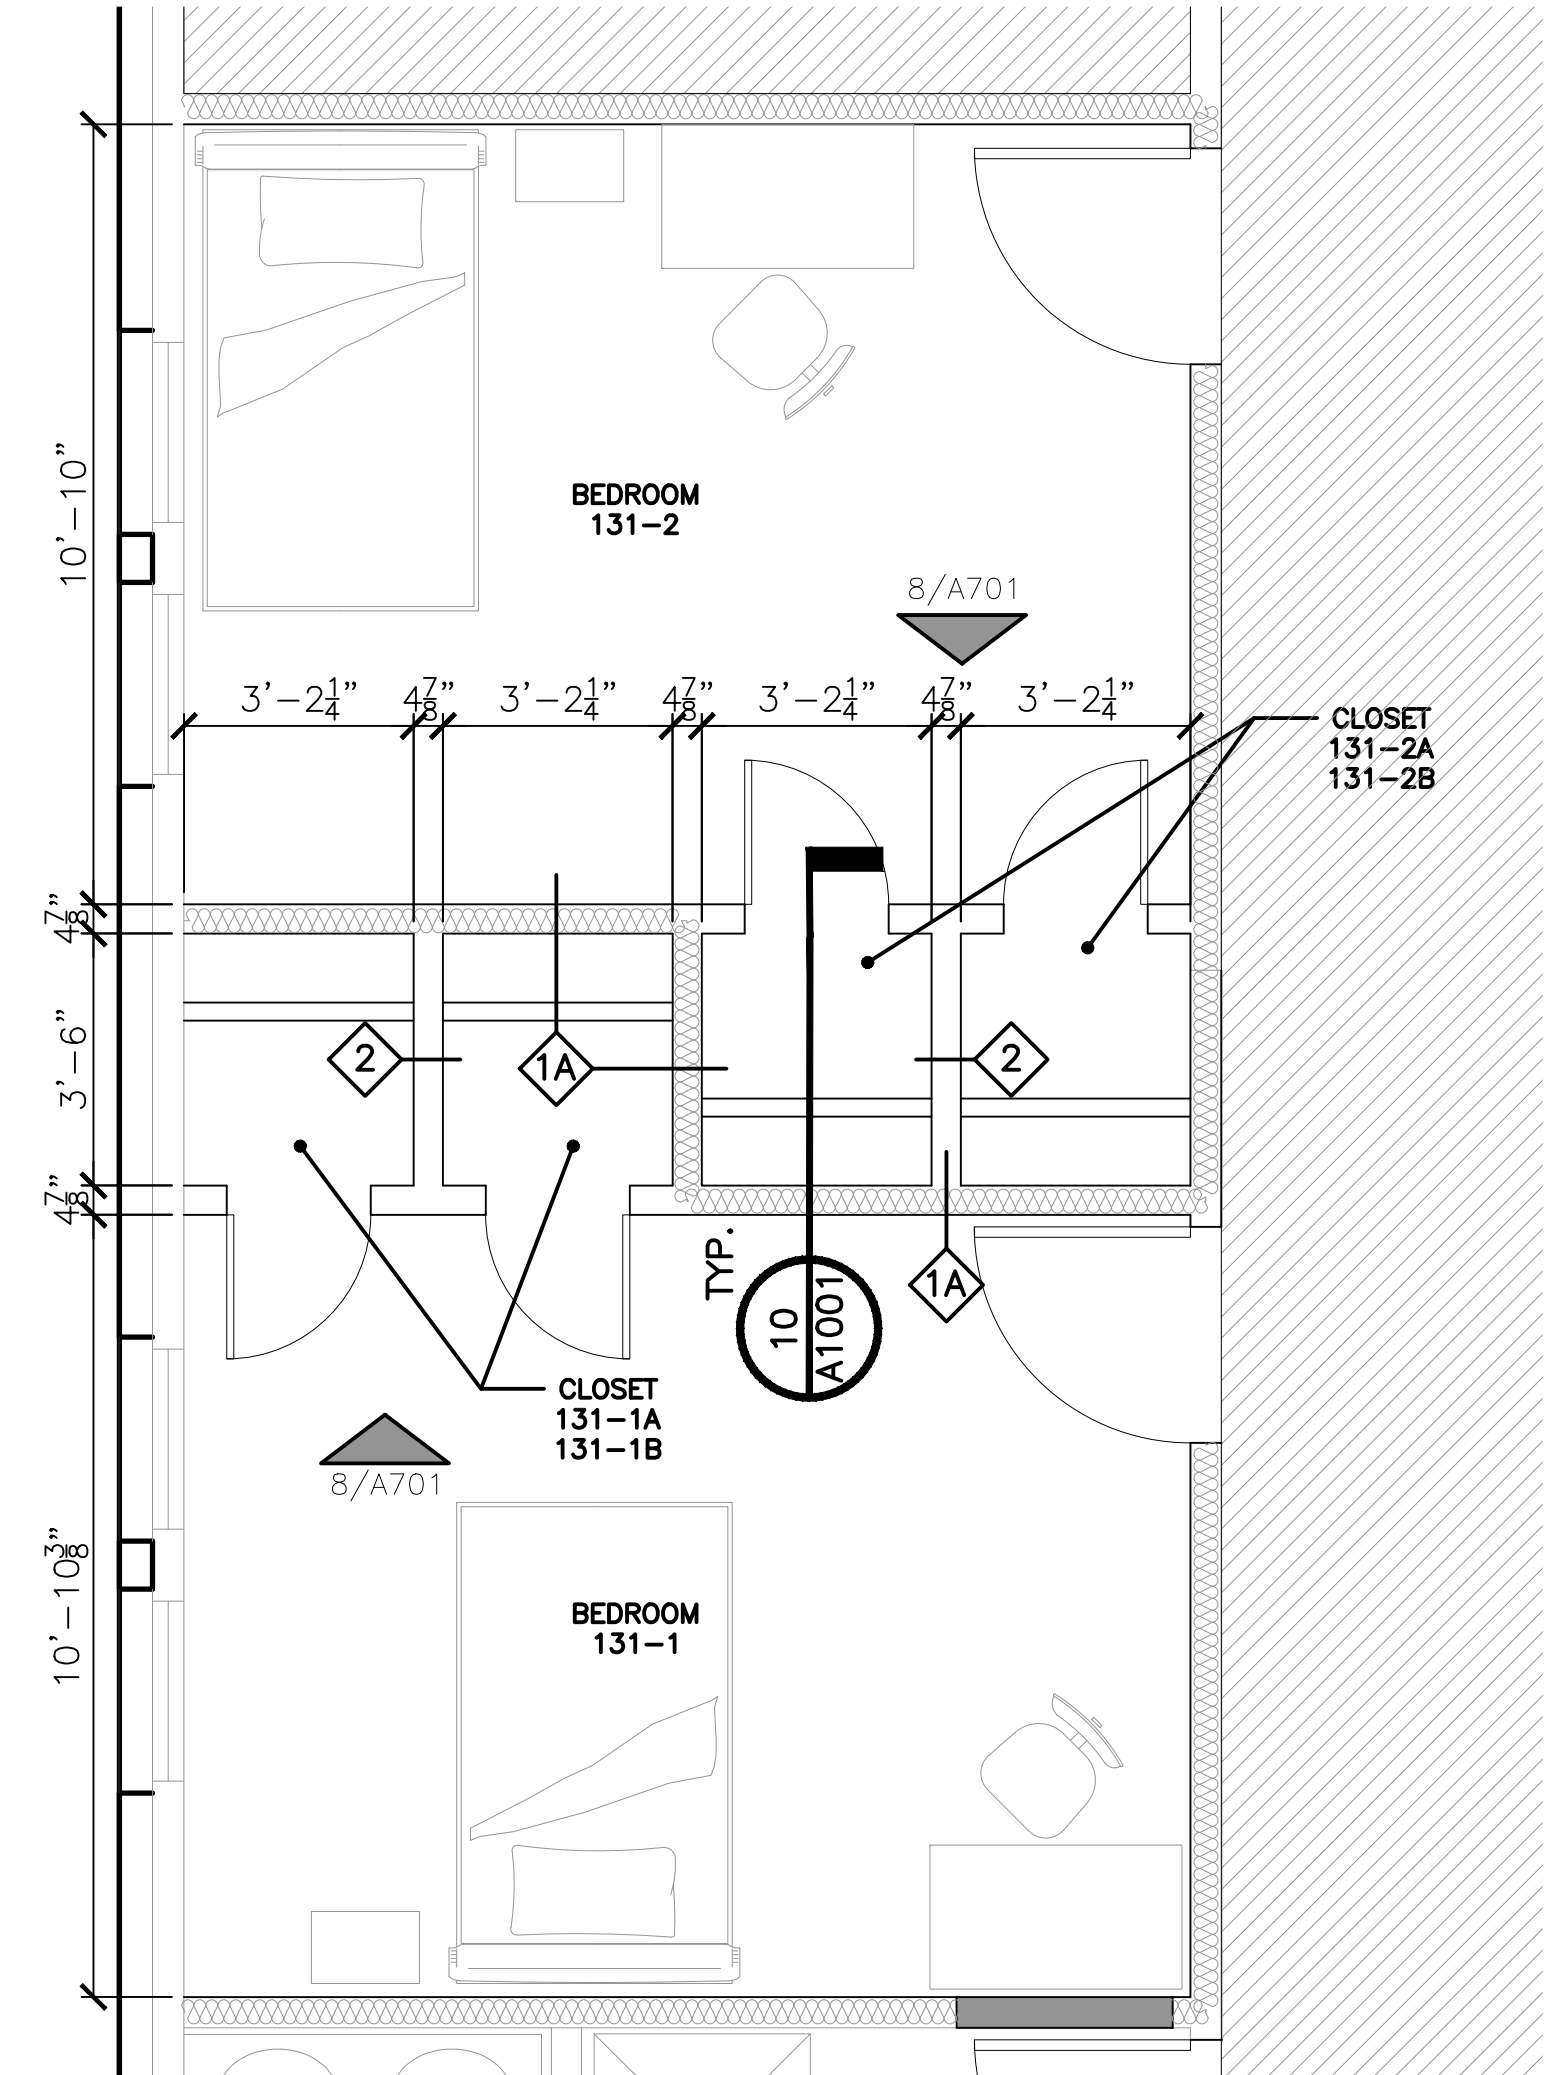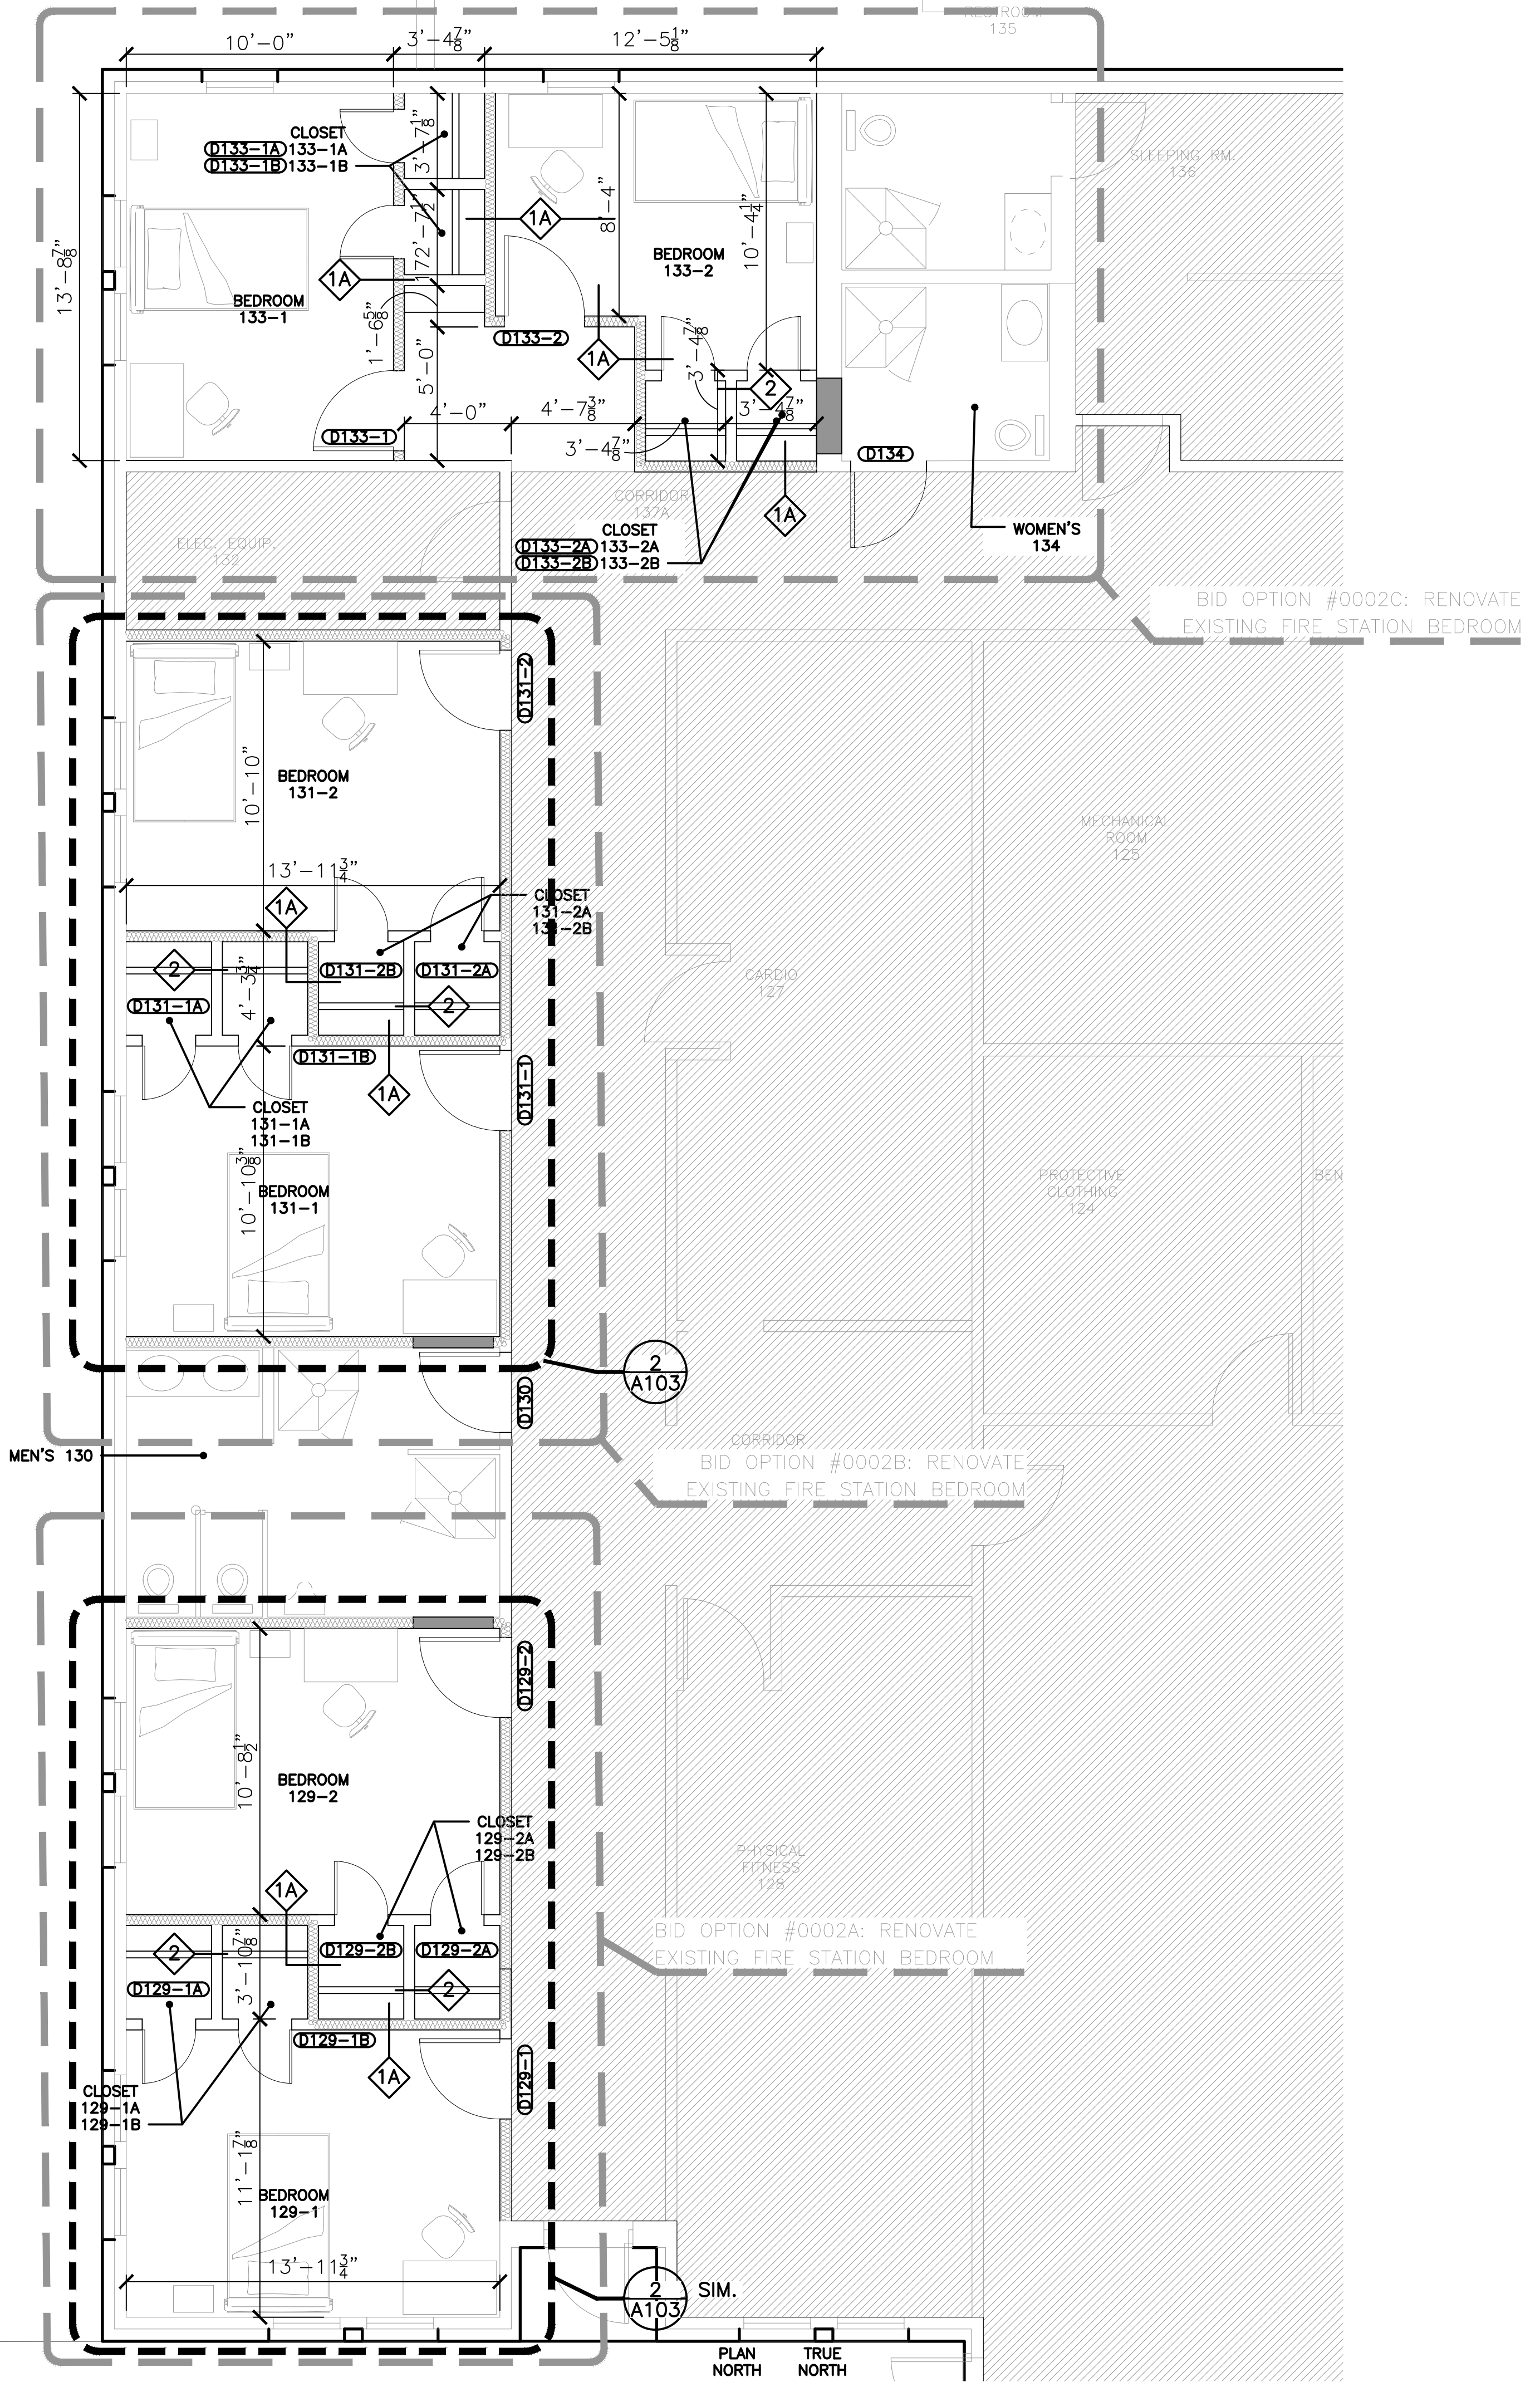


1 FLOORPLAN NEW - BID OPTIONS  
 1/4" = 1' - 0"

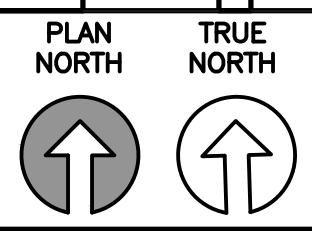

1 TYP. DORM FLOORPLAN - BID OPTIONS  
 1/4" = 1' - 0"

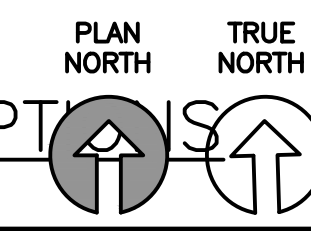



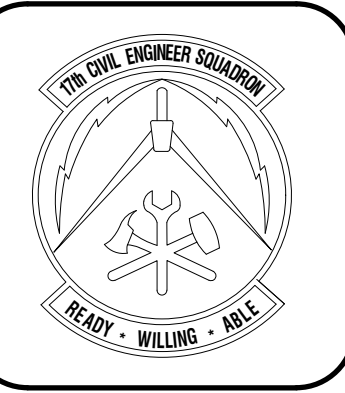

REVISIONS	DATE

Designed by J. RAMIREZ	Drawn by J. RAMIREZ	Reviewed by RTI/JH	Submitted by PCBS
---------------------------	------------------------	-----------------------	----------------------

PROJECT TITLE  
**FIRE STATION ADD/ALTER, B3321**  
**PROJECT NO. 1039839**  
**17th TRAINING WING**  
**GOODFELLOW AIR FORCE BASE, TEXAS**

Project Number: 1039839
SHEET TITLE REFLECTED CEILING PLAN
Date: JAN 2024

SEQ.	SHEET	OF
21	A-201	50

**KEYNOTES** AS INDICATED BY (X)


1. NEW PUBLIC ANNOUNCING (PA) SOFT START AUDIO OUTPUT SPEAKERS. TYP. ALL SLEEPING ROOMS. RE: ELECTRICAL
2. NEW FIRE DEVICES AS REQ'D BY NEW QPPE DESIGN. TYP. ALL SLEEPING ROOMS. REFER TO FIRE ALARM.
3. MECHANICAL CHASE, NO CEILING REQ'D.
4. FURR DOWN BETWEEN NEW AND EXISTING CEILING GRIDS.

**GENERAL NOTES**



1. CONTRACTOR SHALL BE RESPONSIBLE FOR VERIFYING EXISTING DIMENSIONS, EQUIPMENT, AND CONDITIONS PRIOR TO START OF WORK.
2. CONTRACTOR SHALL ENSURE WORK AREAS SHALL BE KEPT CLEAN, SAFE, AND IN A WORKMANLIKE CONDITION. DEBRIS SHALL BE CLEANED ON A DAILY BASIS AND SITE SHALL BE MAINTAINED IN ACCORDANCE WITH THE SPECIFICATIONS.
3. THE CONTRACTOR SHALL TAKE APPROPRIATE STEPS TO PROTECT BUILDING ELEMENTS OUTSIDE THE SCOPE OF WORK AND LABELED AS "EXISTING TO REMAIN". DAMAGE TO THESE ITEMS REQUIRING REPAIR OR REPLACEMENT SHALL BE PERFORMED BY THE CONTRACTOR AT NO ADDITIONAL COST TO THE GOVERNMENT.
4. CONTRACTOR SHALL COORDINATE WITH ALL OTHER TRADES.
5. CONTRACTOR SHALL CENTER FIXTURES, SPRINKLER HEADS, DEVICES, AND ACCESSORIES BETWEEN CEILING TILES AS MUCH AS POSSIBLE.
6. IN BID OPTION AREAS, CONTRACTOR SHALL VERIFY CEILING HEIGHTS PRIOR TO DEMOLITION, AND PROVIDE NEW CEILINGS WITH SIMILAR HEIGHTS.

**LEGEND**


- EXISTING TO REMAIN
- CEILING HEIGHT
- 2'-0" X 2'-0" X 7/8" SUSP. GRID CLG SYSTEM. RE: 2/A201
- SUSP. 5/8" FC GYP BD CLG SYSTEM
- 2'4" LED RECESSED TROFFER LIGHT FIXTURE
- 6" LED ROUND RECESSED LIGHT FIXTURE
- SURFACE MOUNTED LED WALL PACK
- SURFACE MOUNTED LED UP/DN WALL SCENCE
- EXIT LIGHTING

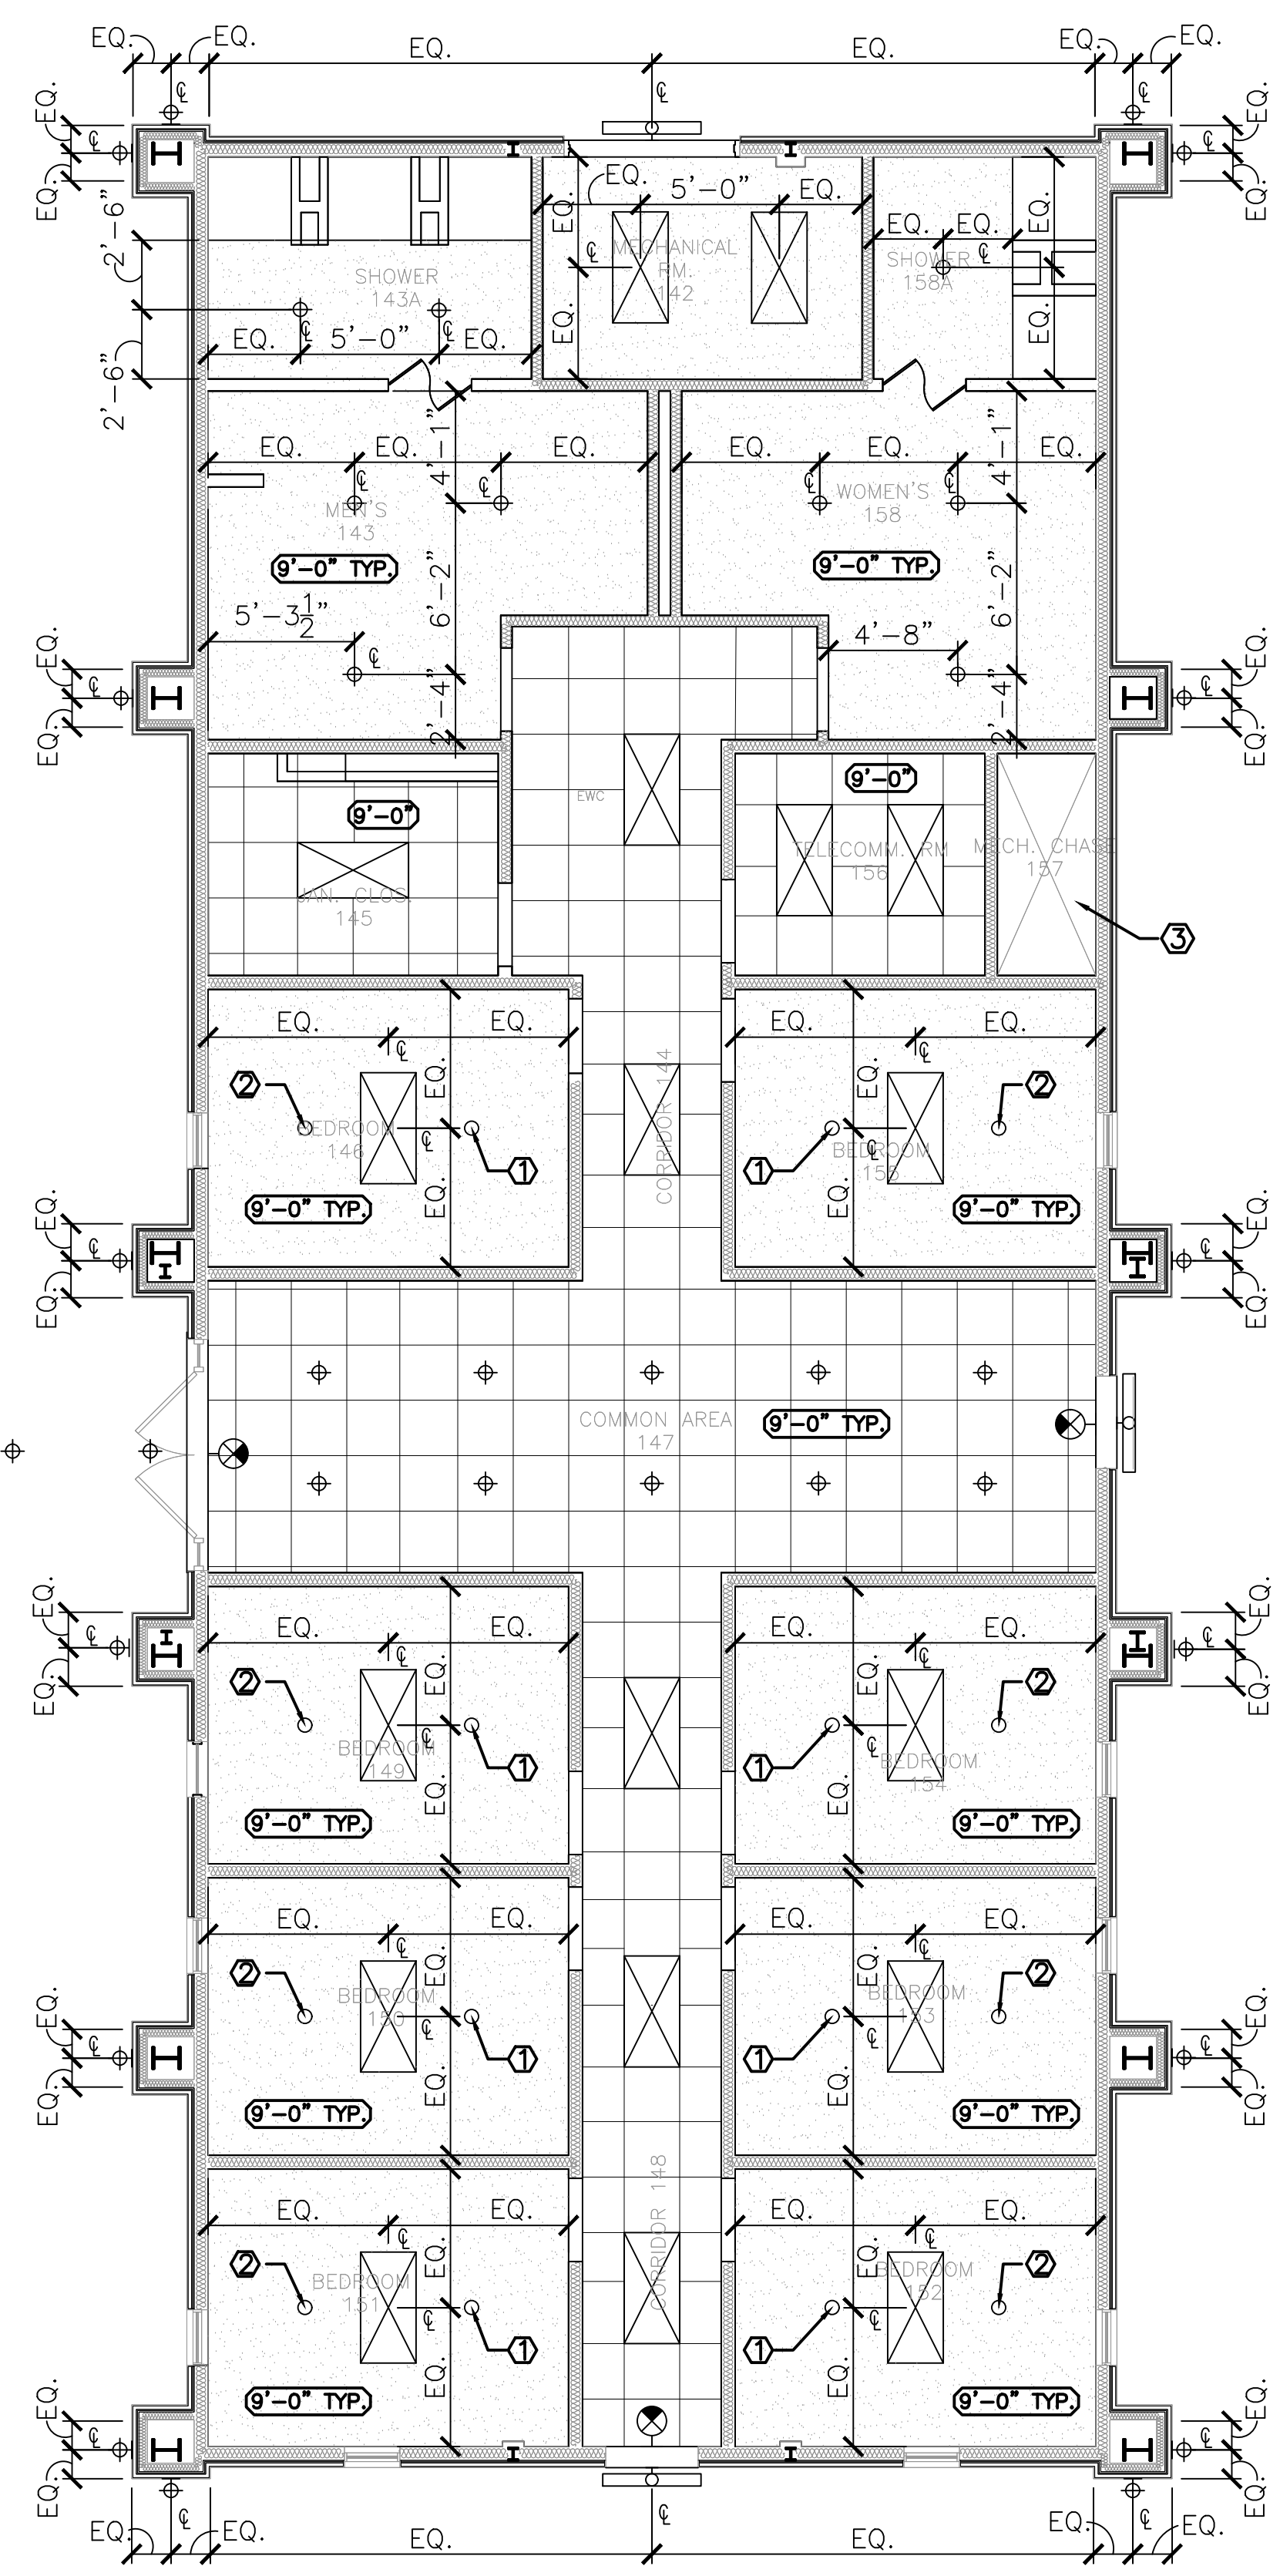


① REFLECTED CEILING PLAN – NEW ADDITION  
 1/8" = 1' - 0"

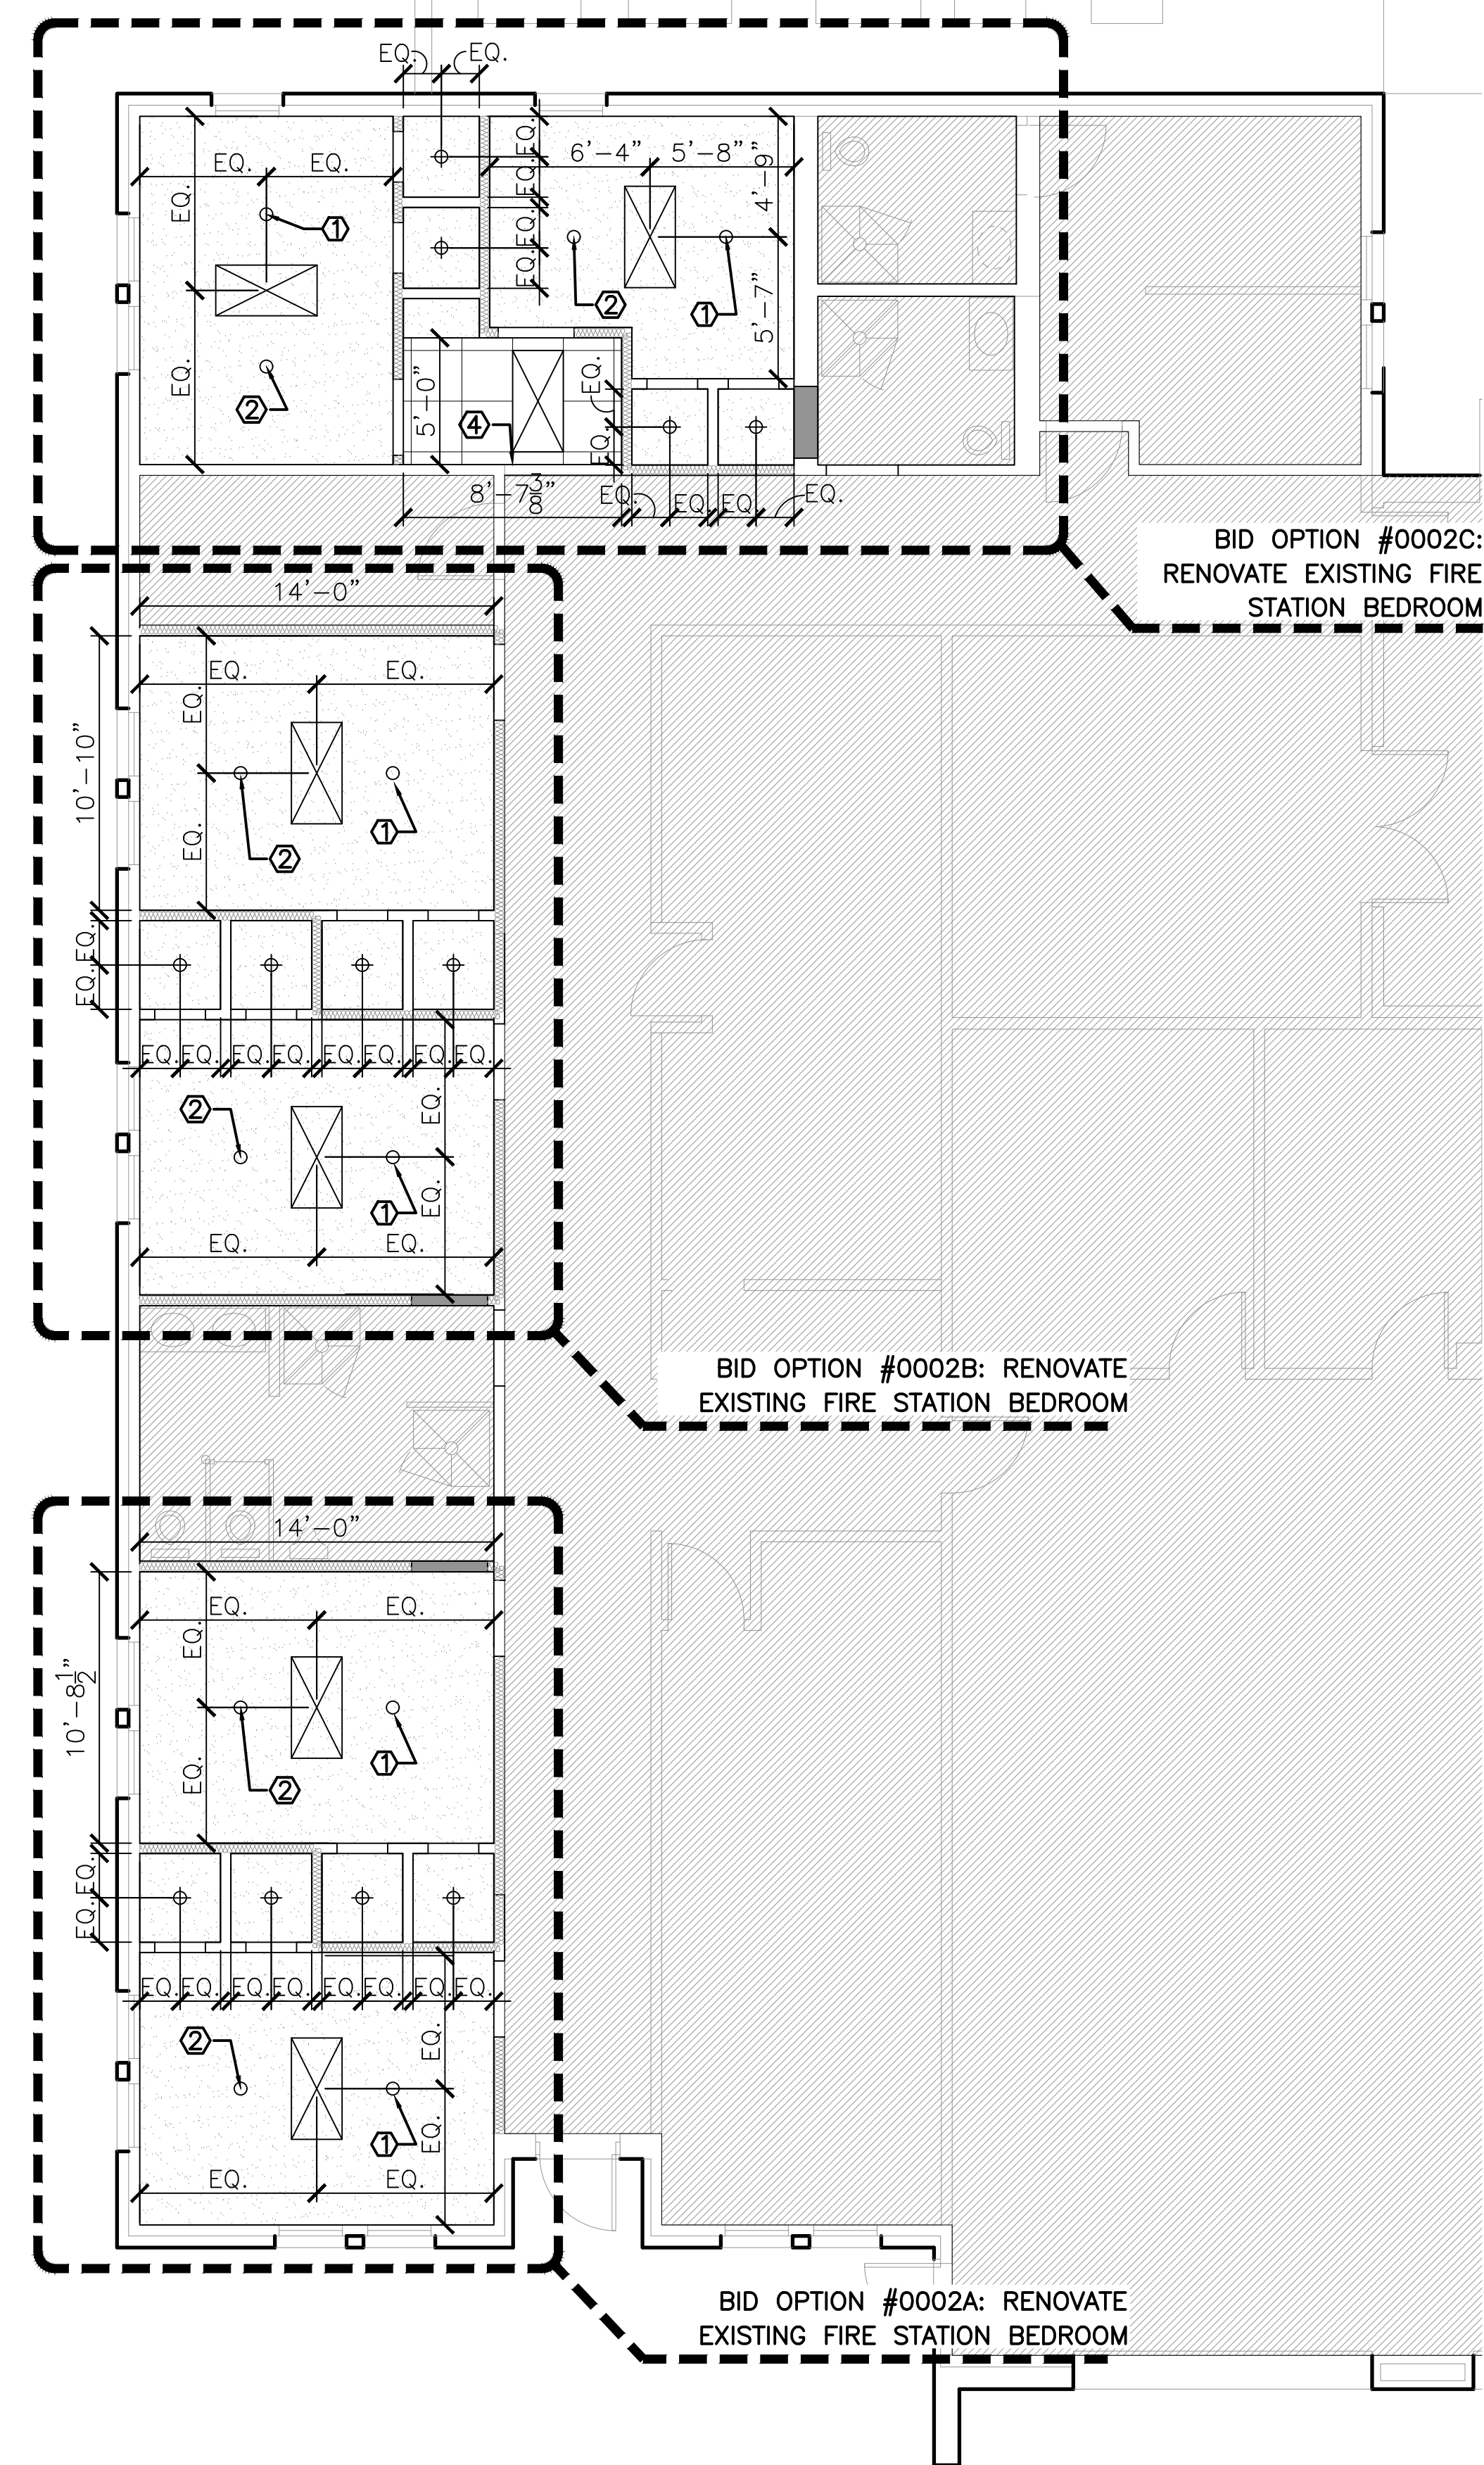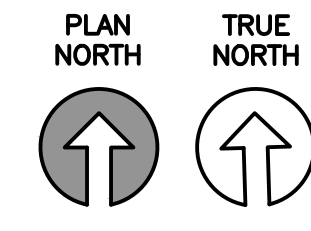

② REFLECTED CEILING PLAN – BID OPTIONS  
 1/8" = 1' - 0"

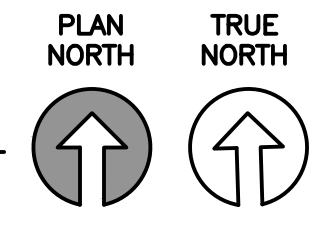

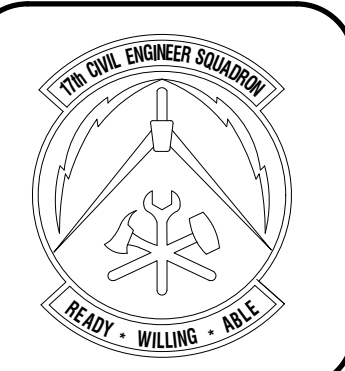


REVISIONS	DATE

Designed by J. RAMIREZ	Checked by J. RAMIREZ	Reviewed by RTI/JH	Submitted by PCBS
---------------------------	--------------------------	-----------------------	----------------------


PROJECT TITLE  
**FIRE STATION ADD/ALTER, B3321**  
**PROJECT NO. 1039839**  
**17th TRAINING WING**  
**GOODFELLOW AIR FORCE BASE, TEXAS**

Project Number: 1039839
SHEET TITLE ROOF PLAN
Date: JAN 2024

SEQ.	SHEET	OF
22	A-301	50

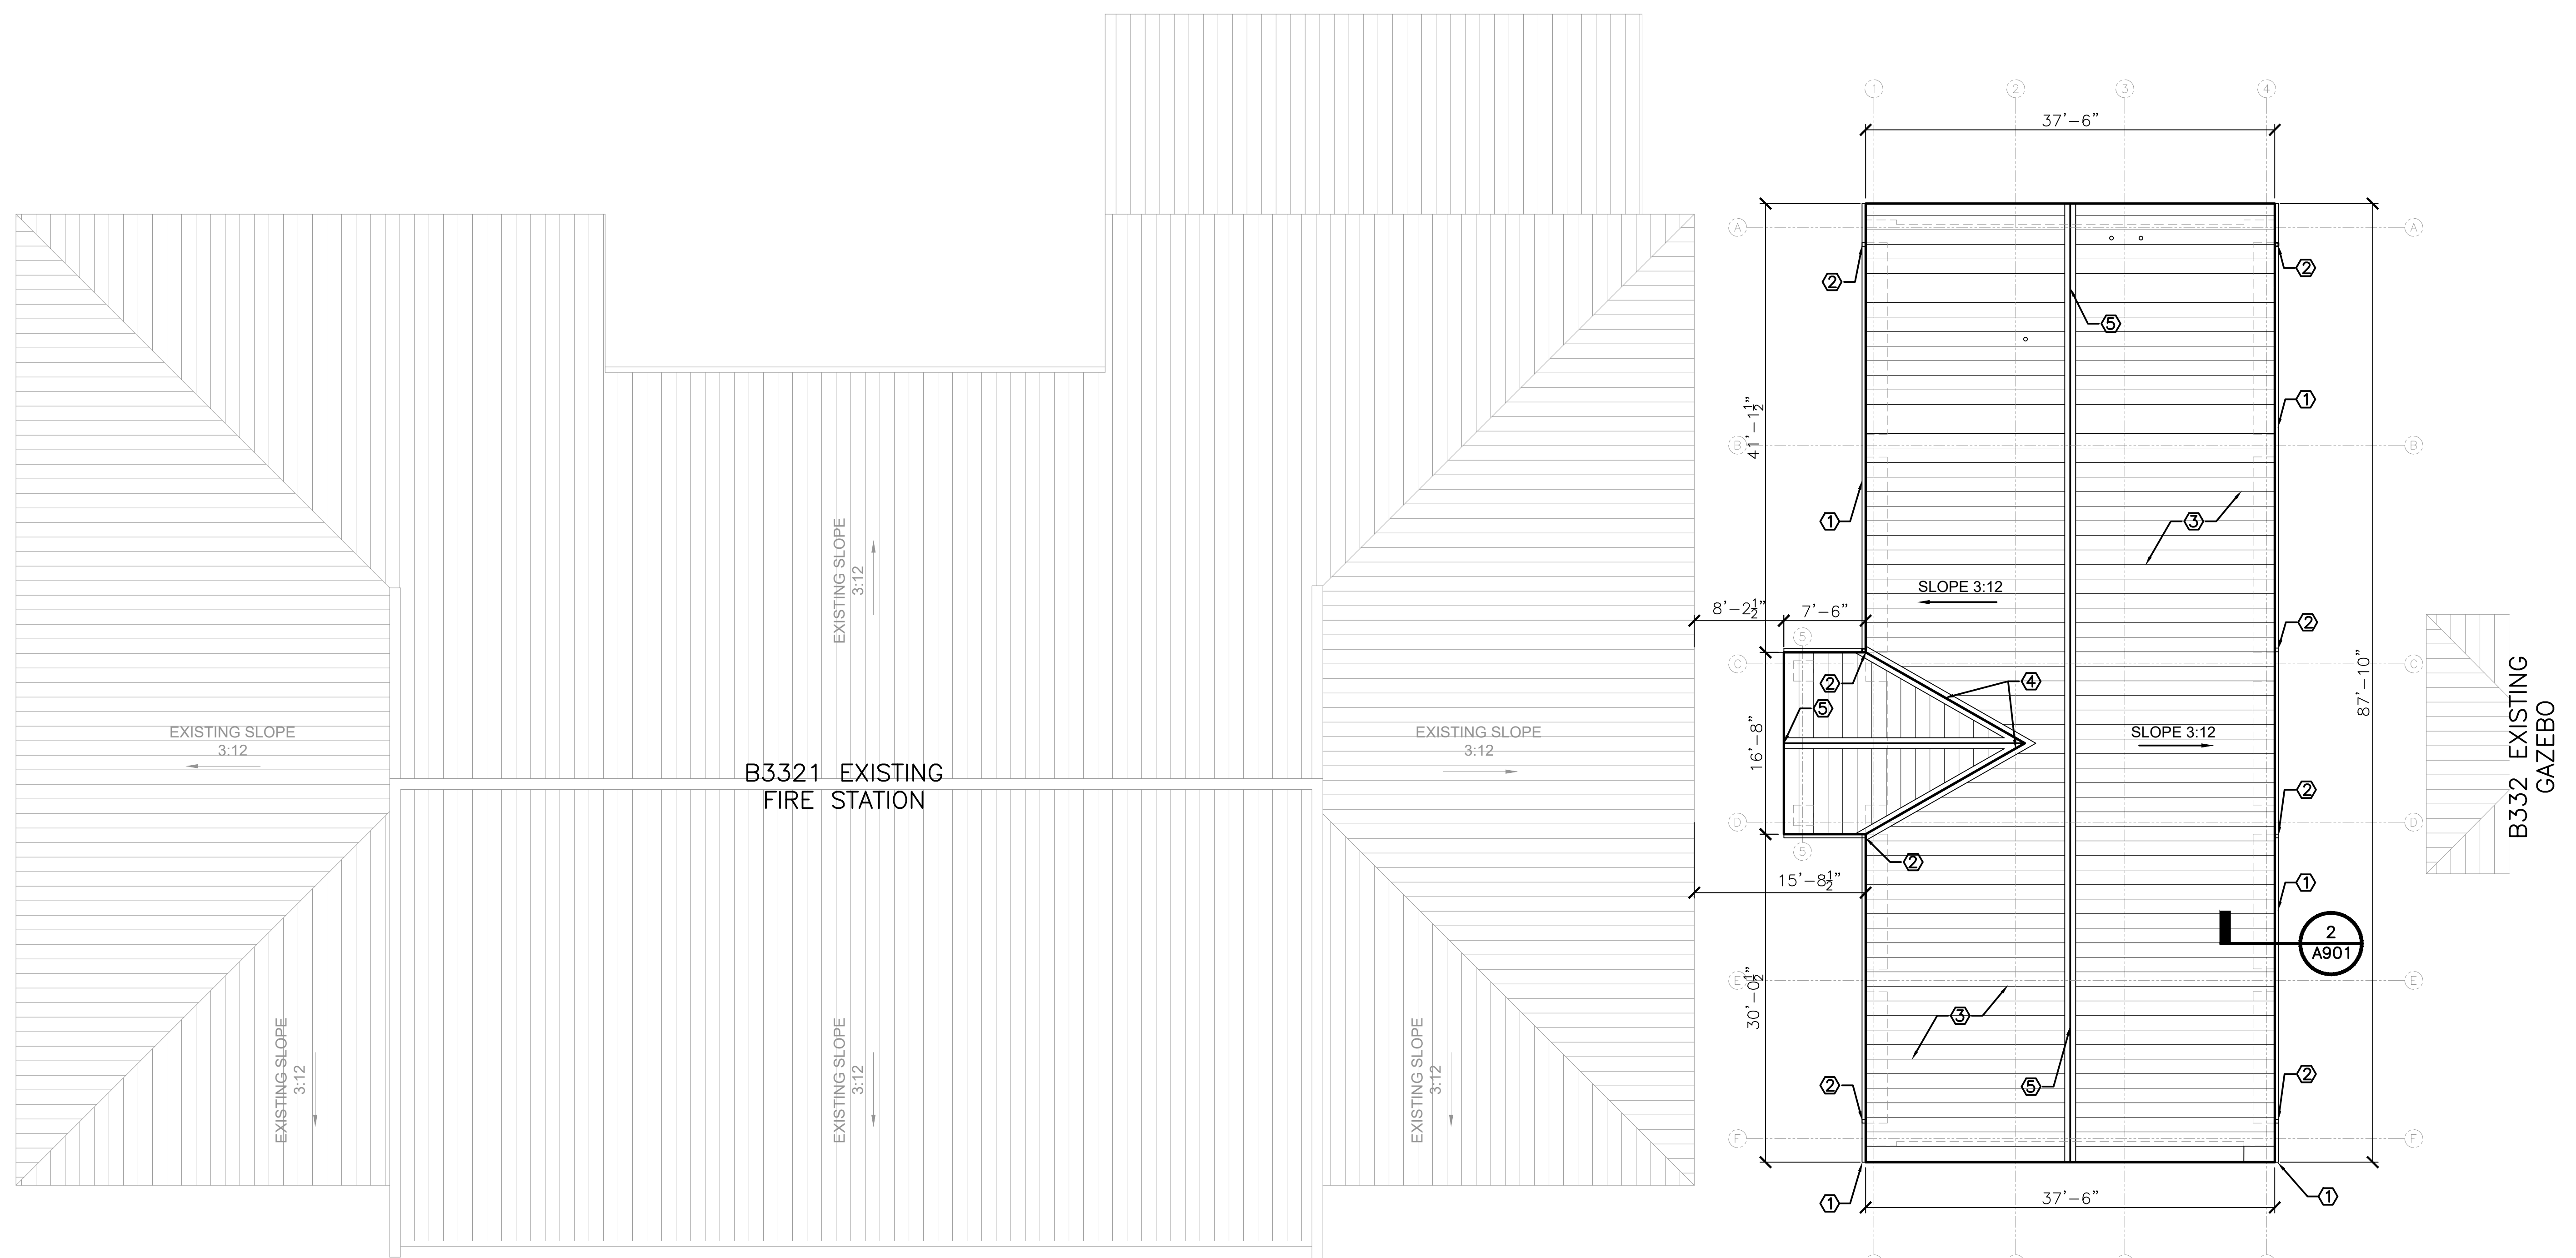

① ROOF PLAN  
1/8" = 1' - 0"

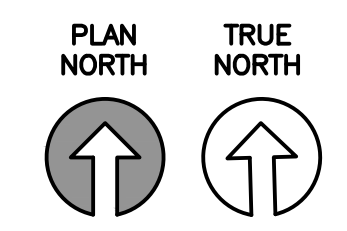

**KEYNOTES**




- CONTRACTOR SHALL PROVIDE NEW 4" GUTTER. REFER TO MTL ROOF MFR FOR MOUNTING AND INSTALLATION INSTRUCTIONS. TRIM FINISH TO MATCH NEW MTL ROOF.
- CONTRACTOR SHALL PROVIDE NEW 3"x4" MTL. DOWNSPOUTS. INSTALL PER MTL ROOF MFR MOUNTING AND INSTALLATION INSTRUCTIONS.
- CONTRACTOR SHALL PROVIDE NEW STANDING SEAM METAL ROOF. PANEL RIBS AND METAL ROOF FINISH TO MATCH EXISTING ROOF AS MUCH AS POSSIBLE. CONTRACTOR SHALL SEAL PENETRATIONS RE: 2/A301. REFER TO PLUMBING AND MECHANICAL FOR OPENINGS.
- CONTRACTOR SHALL PROVIDE NEW ROOF VALLEY TRIM.
- CONTRACTOR SHALL PROVIDE NEW RIDGE CAP.

**GENERAL NOTES**


- CONTRACTOR SHALL BE RESPONSIBLE FOR VERIFYING EXISTING DIMENSIONS, EQUIPMENT, AND CONDITIONS PRIOR TO START OF WORK.
- THE CONTRACTOR SHALL TAKE APPROPRIATE STEPS TO PROTECT BUILDING ELEMENTS OUTSIDE THE SCOPE OF WORK AND LABELED AS "EXISTING TO REMAIN". DAMAGE TO THESE ITEMS REQUIRING REPAIR OR REPLACEMENT SHALL BE PERFORMED BY THE CONTRACTOR AT NO ADDITIONAL COST TO THE

- GOVERNMENT.
- CONTRACTOR SHALL COORDINATE WITH ALL OTHER TRADES.
  - CONTRACTOR SHALL ENSURE ALL SEAMS AND PENETRATIONS ARE PROPERLY WEATHERPROOFED AND SEALED IAW MFR INSTRUCTIONS.
  - CONTRACTOR SHALL PROVIDE CLOSURE STRIPS AND BUTYL TAPE PER MFR. RECOMMENDATIONS
  - CONTRACTOR SHALL PROVIDE FLASHING/SEALANT FOR THROUGH-ROOF PENETRATIONS PER MTL. BLDG. ROOF MFR RECOMMENDATIONS.
  - NEW STANDING SEAM MTL. ROOF TO MATCH EXISTING. SLOPE = 3 : 12 (2.7 : 12 @ BREEZEWAY).
  - CONTRACTOR SHALL PROVIDE RIDGE VENT W/COR-A-VENT LOW PROFILE FLOATING RIDGE VENT EQ. TO THAT BY RIGID GLOBAL BUILDINGS
  - CONTRACTOR SHALL PROVIDE THERMAL BLOCKS @ EA. PURLIN.
  - VENT THRU ROOF. PROVIDE BOOT, WEATHERPROOF AND SEAL RE:2/301 RE: PLUMBING
  - GAS WATER HEATER INTAKE AND EXHUAST. RE: PLUMBING

**LEGEND**

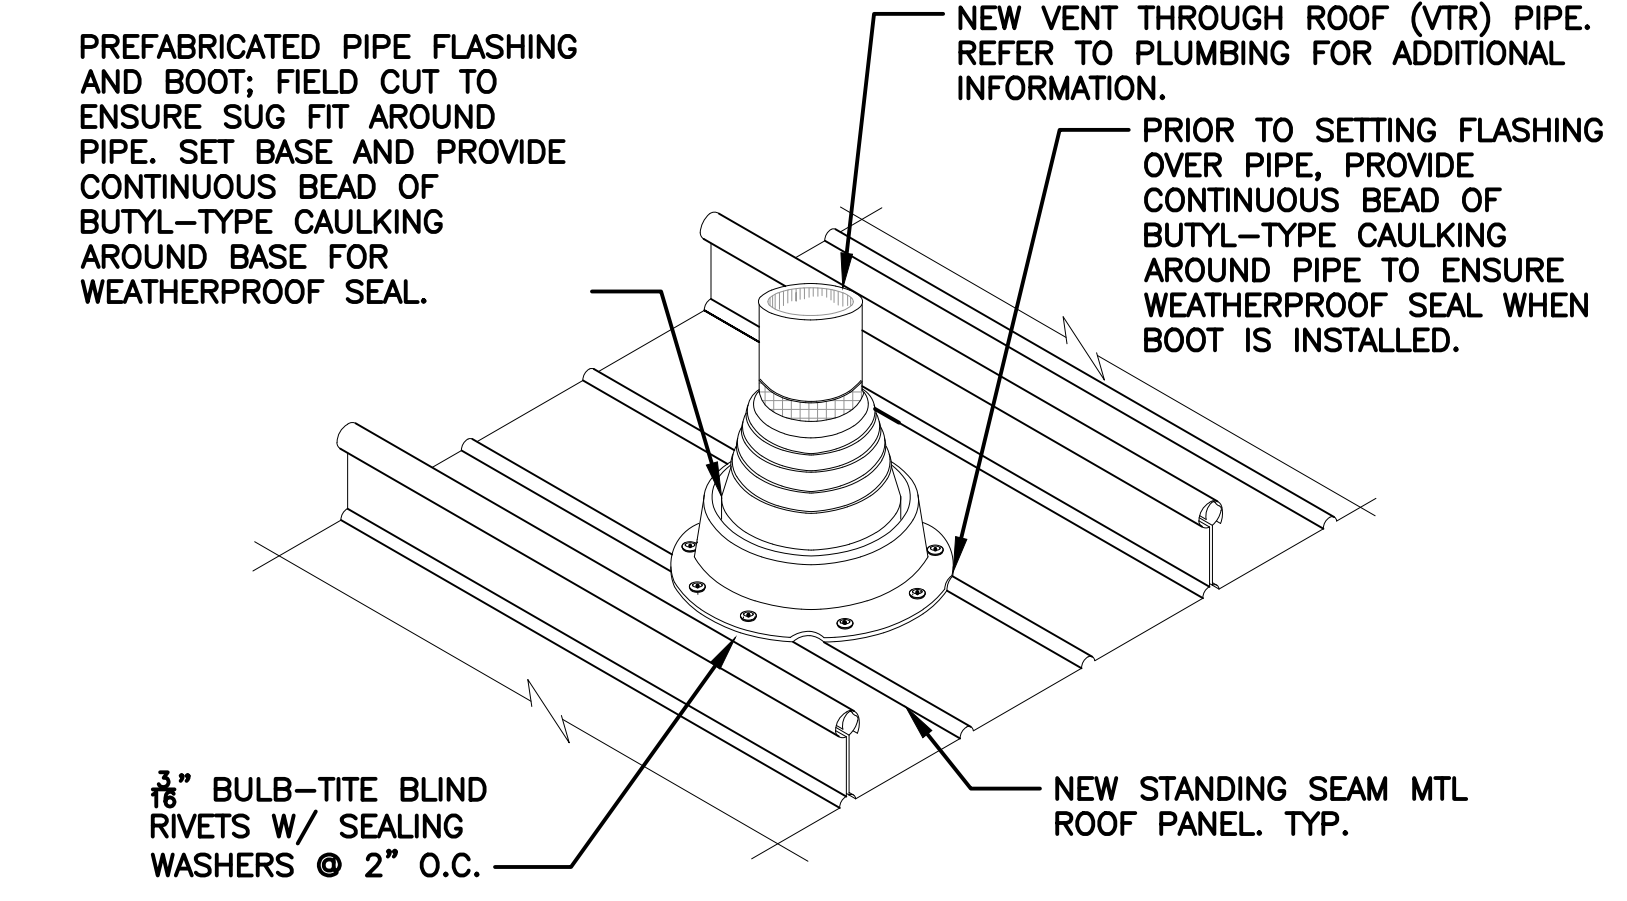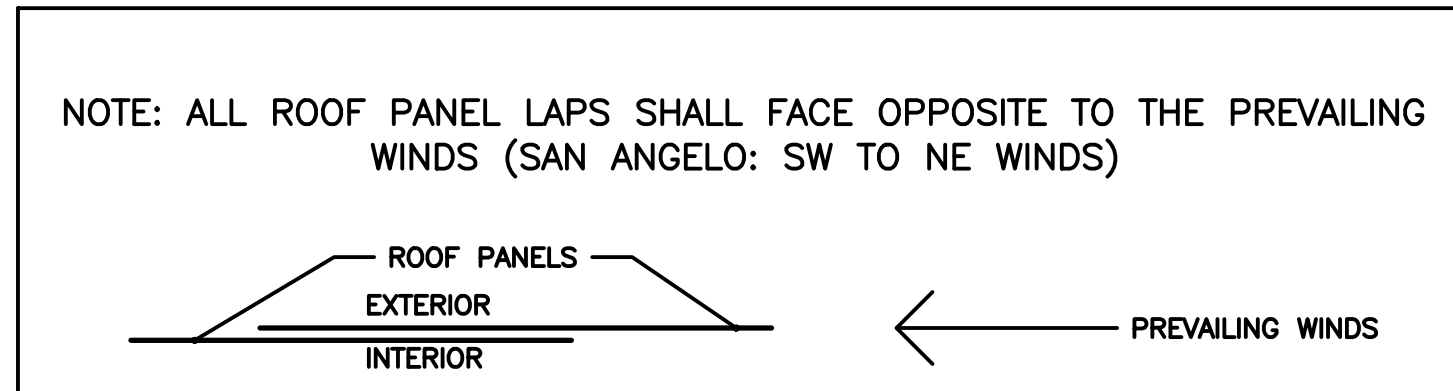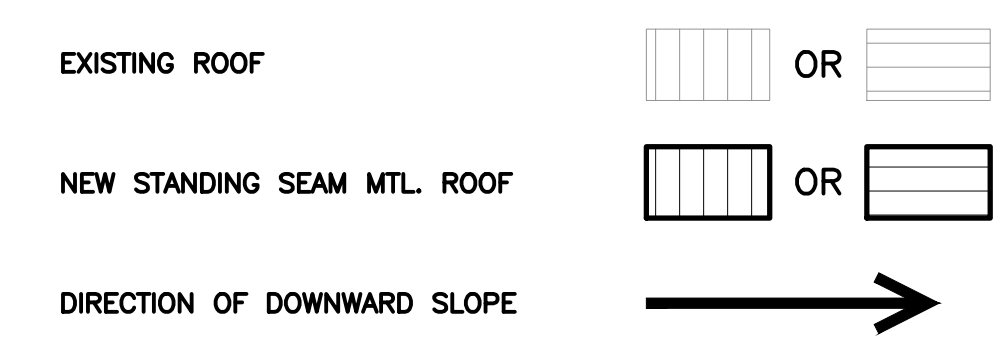

② TUBULAR PENETRATION FLASHING DTL.  
N.T.S

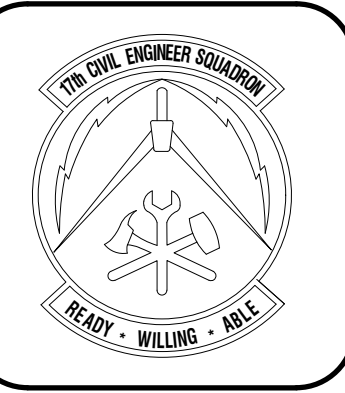

DATE

REVISIONS

Designed by: J.H.R.M.L.A.  
 Drawn by: J.H.R.M.L.A.  
 Reviewed by: RTI/JH  
 Submitted by: PCES


PROJECT TITLE  
**FIRE STATION ADD/ALTER, B3321**  
**PROJECT NO. 1039839**  
**17th TRAINING WING**  
**GOODFELLOW AIR FORCE BASE, TEXAS**

Project Number:  
1039839


SHEET TITLE  
**BUILDING SECTIONS**

Date:  
JAN 2024


SEQ.	SHEET	OF
18	<b>A-401</b>	50

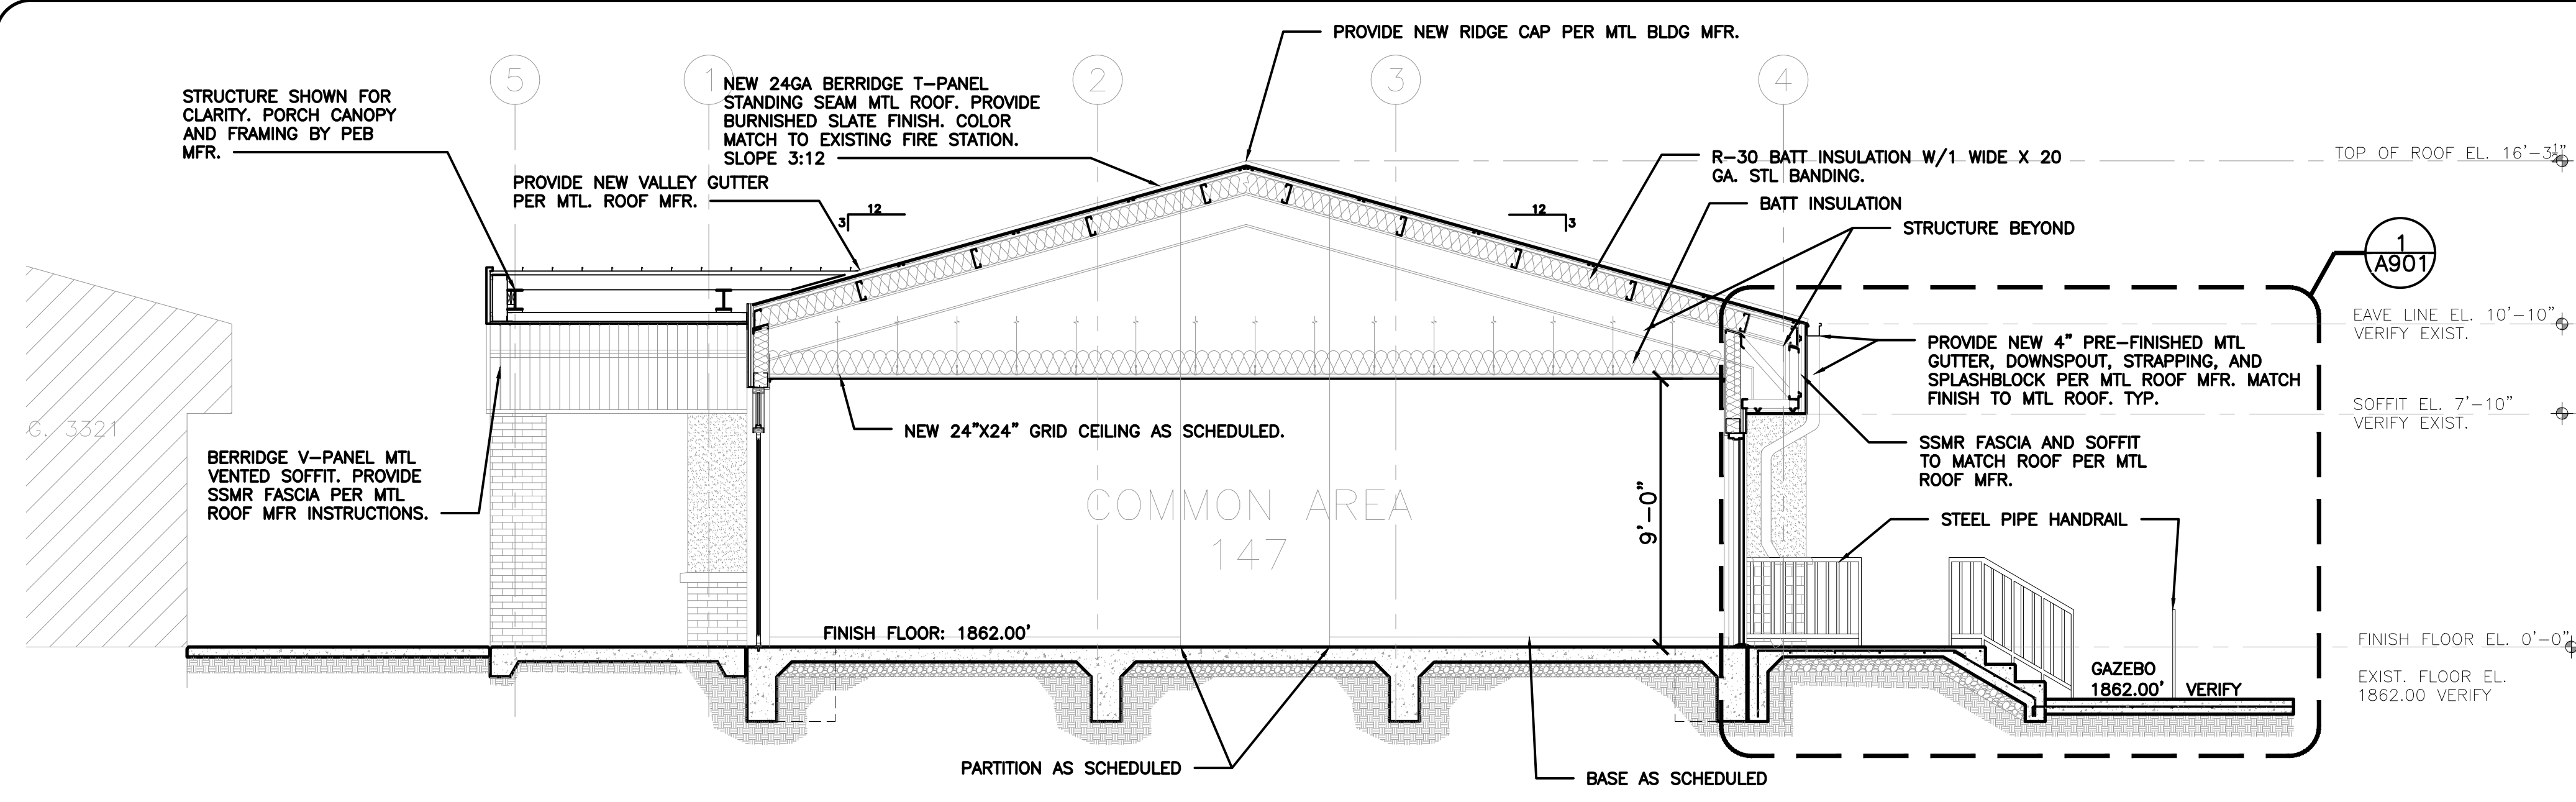

**1 SECTION - THROUGH BREEZEWAY**  
 $\frac{1}{4}'' = 1' - 0''$

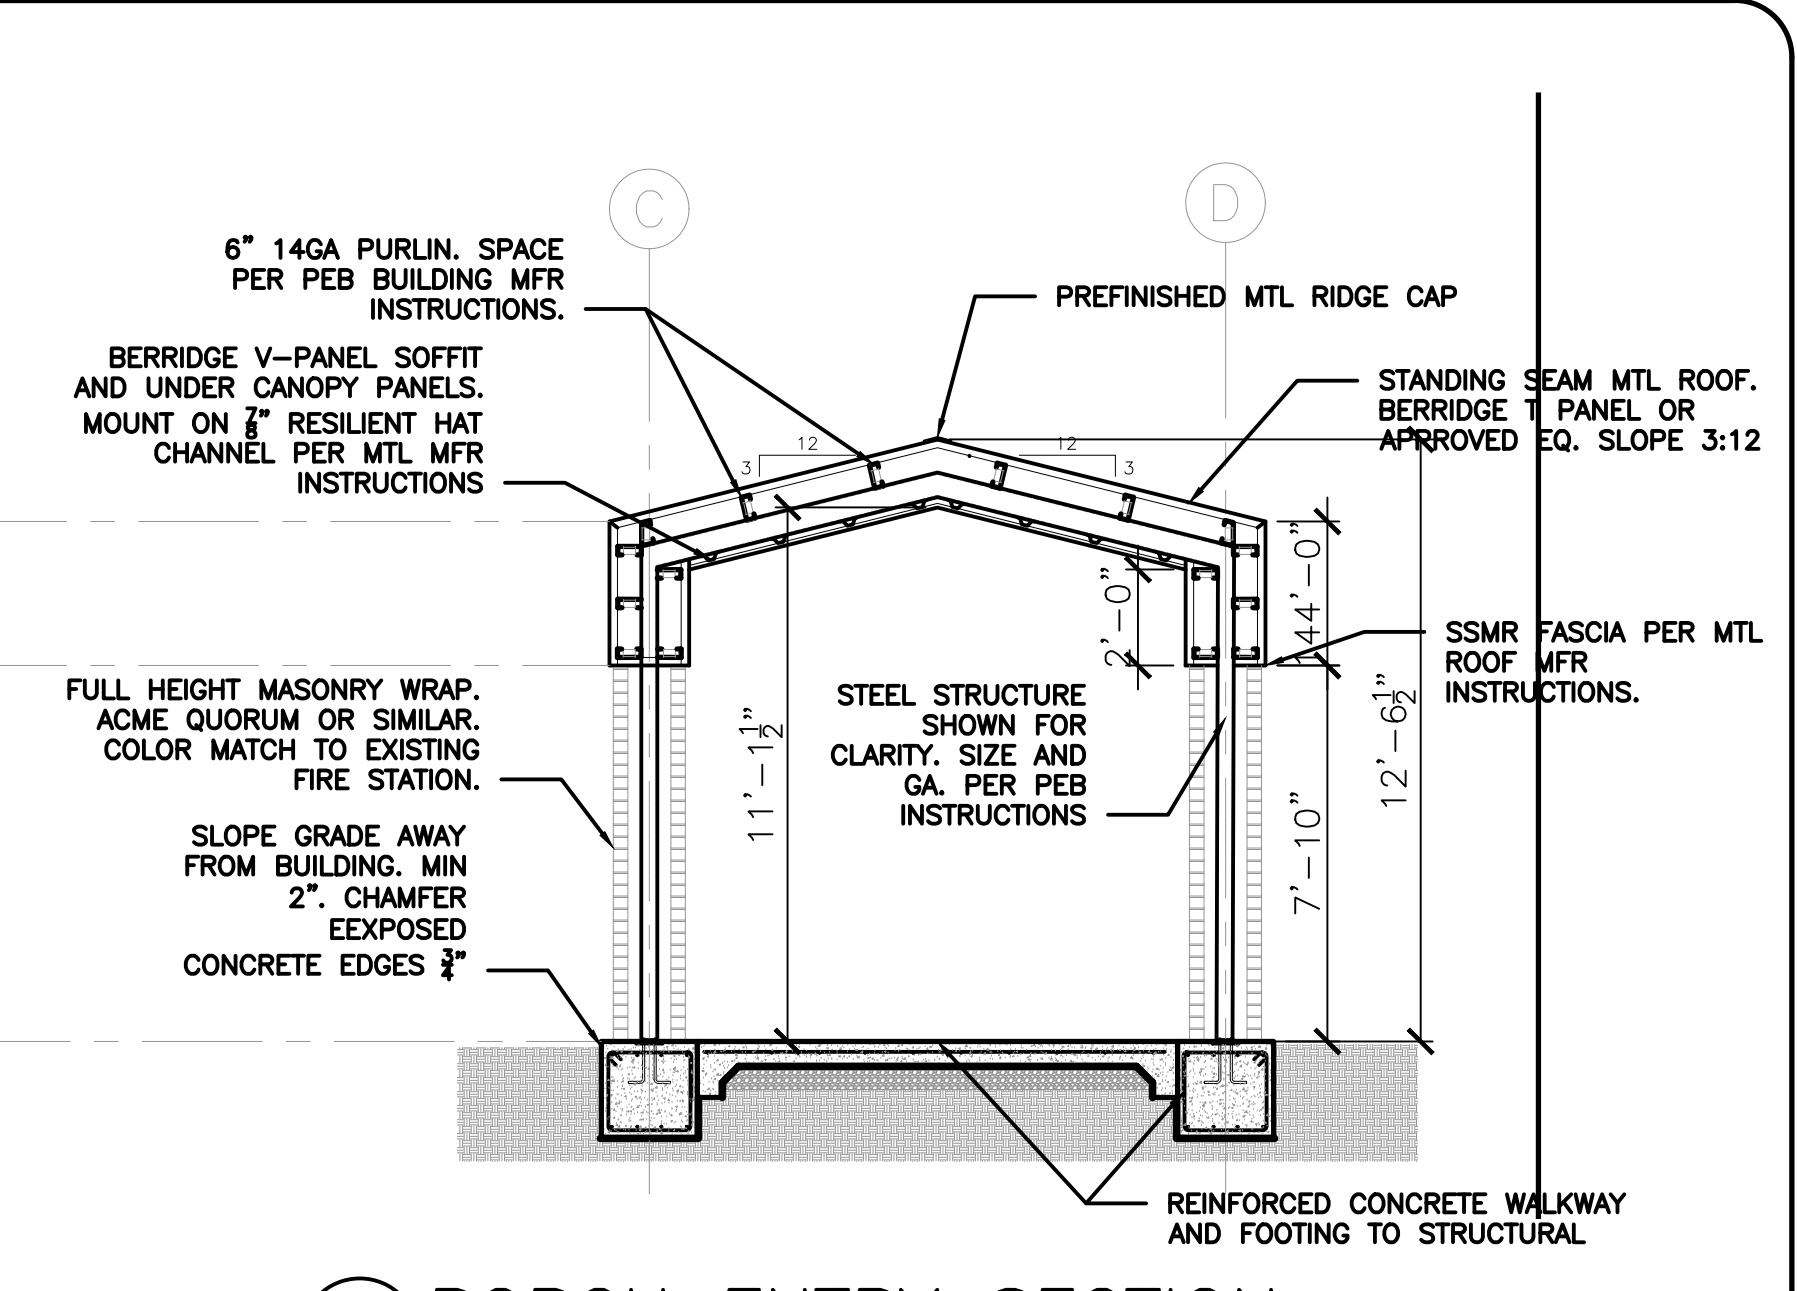

**4 PORCH ENTRY SECTION**  
 $\frac{1}{2}'' = 1' - 0''$

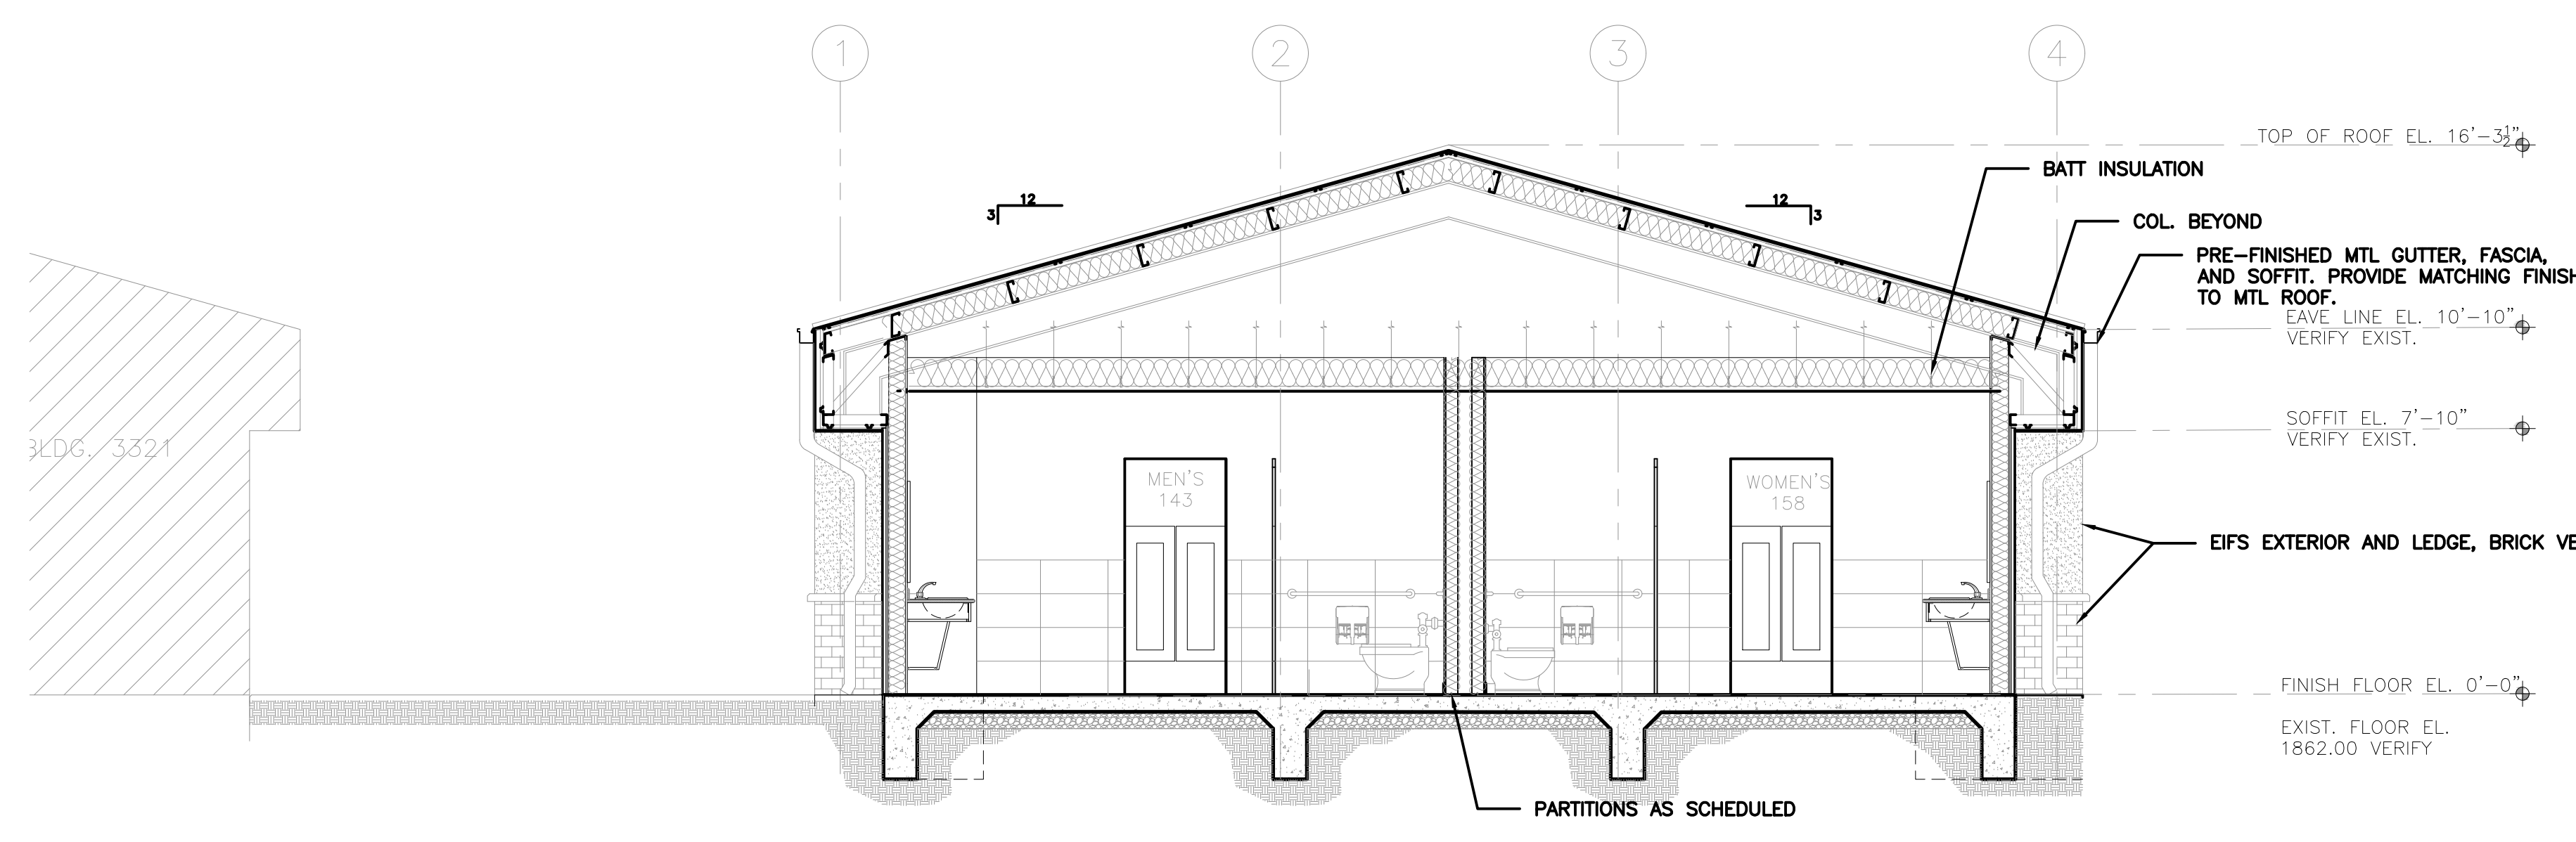


**2 SECTION - THROUGH RESTROOMS**  
 $\frac{1}{4}'' = 1' - 0''$

**GENERAL NOTES:**

1. VERIFY ROOF AND STRUCTURE DIMENSIONS WITH PEB MFR
2. CONTRACTOR SHALL VERIFY ALL DIMENSIONS AND SITE CONDITIONS PRIOR TO CONSTRUCTIONS.
3. CONTRACTOR SHALL ENSURE ALL PENETRATIONS, INCLUDING VENT PIPING THRU ROOF/EXHAUST FANS/INTAKE FANS ARE WEATHERPROOFED, FLASHED, AND SEALED. AL ROOF VALLEYS AND INTERSECTIONS SHALL BE SEALED AND WEATHERPROOFED IAW WITH MFR INSTRUCTIONS.

- REFER TO STRUCTURAL FOR PEB REQ'S.
- 8" R-30 FSK BATT INSULATION W/ 1" WIDE X 20GA STL BANDING.
- MTL RIDGE CAP, FLASHING, AND DRIP EDGE PER MTL ROOF MFR INSTRUCTIONS
- STANDING SEAM MTL ROOF EQ. TO BERRIDGE T-PANEL. BURNISHED SLATE FINISH SIMILAR TO EXISTING FIRE STATION
- 7" 18GA. GALV. MTL FURRING CHANNELS @ 4'-0" O.C. MAX. ICE AND WATER SHIELD OVER 1 1/2" TYPE B-20 GALV. MTL DECKING
- BLOCKING AS NEEDED.
- PRE-FINISHED MTL FASCIA SIMILAR TO STANDING SEAM MTL ROOF. SECURE OVER 3/4" 18GA. GALV. MTL FURRING CHANNELS PER MFR. INSTRUCTION.
- V-PANEL SOFFIT BERRIDGE OR EQ. SECURE TO 3/4" 18GA. GALV. MTL FURRING CHANNELS AND 3-8" MTL STUD FRAMING @ 16" O.C.
- EXTERIOR INSULATION FINISHING SYSTEM EQ. TO SIKA SENERGY CHANNELED ADHESIVE CI. PROVIDE SHEATHING, JOINT REINFORCEMENT, ADHESIVE, BASE COAT, REINFORCING MESH, AND FINISH COAT AS SPECIFIED AND IAW W/ MFR INSTRUCTIONS
- SOFFIT BEYOND
- DOUBLE HEADER. PROVIDE 6" 18 GA. GALV. MTL STUD 16" O.C. AND R19 BATT INSULATION.
- DOOR AND FRAME AS SCHEDULED

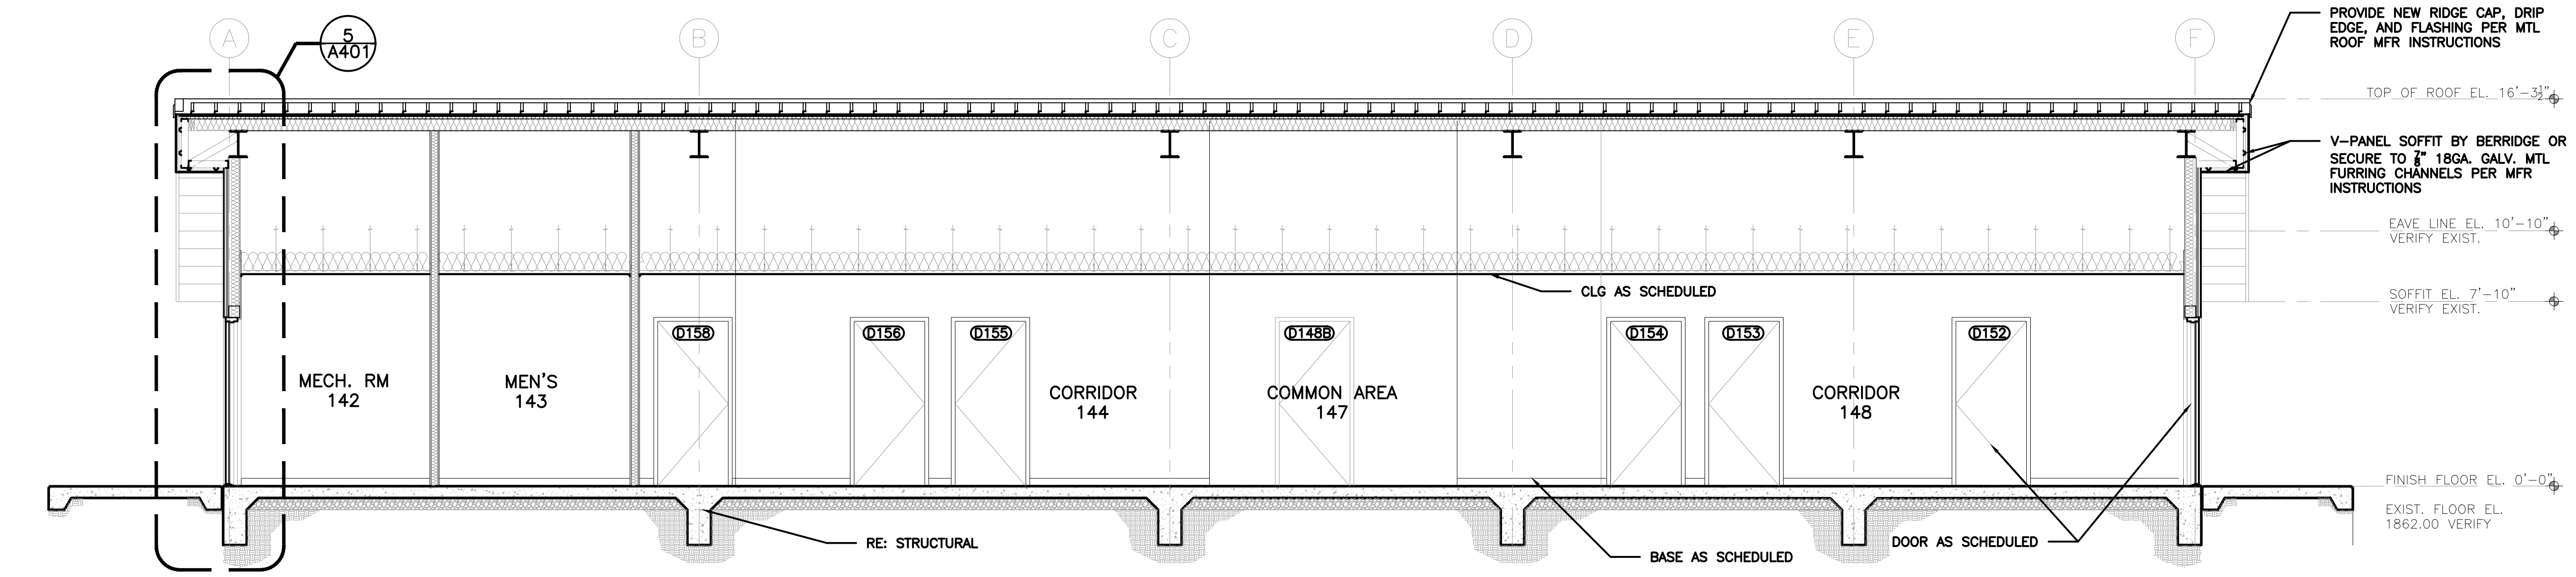


**3 SECTION - LONGITUDINAL**  
 $\frac{1}{4}'' = 1' - 0''$

- PROVIDE NEW RIDGE CAP, DRIP EDGE, AND FLASHING PER MTL ROOF MFR INSTRUCTIONS
- TOP OF ROOF EL. 16'-3 1/2"
- V-PANEL SOFFIT BY BERRIDGE OR EQ. SECURE TO 3/4" 18GA. GALV. MTL FURRING CHANNELS PER MFR INSTRUCTIONS
- EAVE LINE EL. 10'-10" VERIFY EXIST.
- SOFFIT EL. 7'-10" VERIFY EXIST.
- FINISH FLOOR EL. 0'-0"
- EXIST. FLOOR EL. 1862.00 VERIFY

**5 WALL SECTION**  
 $\frac{1}{2}'' = 1' - 0''$



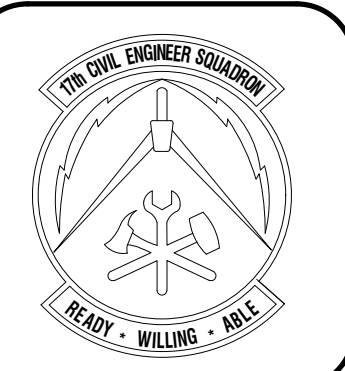

DATE


REVISIONS

Designed by: JH/MLLA  
 Drawn by: JH/MLLA  
 Reviewed by: RT/JH  
 Submitted by: PCBS

PROJECT TITLE  
**FIRE STATION ADD/ALTER, B3321**  
**PROJECT NO. 1039839**  
**17th TRAINING WING**  
**GOODFELLOW AIR FORCE BASE, TEXAS**


Project Number:	1039839
SHEET TITLE	EXTERIOR ELEVATIONS
Date:	JAN 2024

SEQ.	SHEET	OF
24	A-501	50

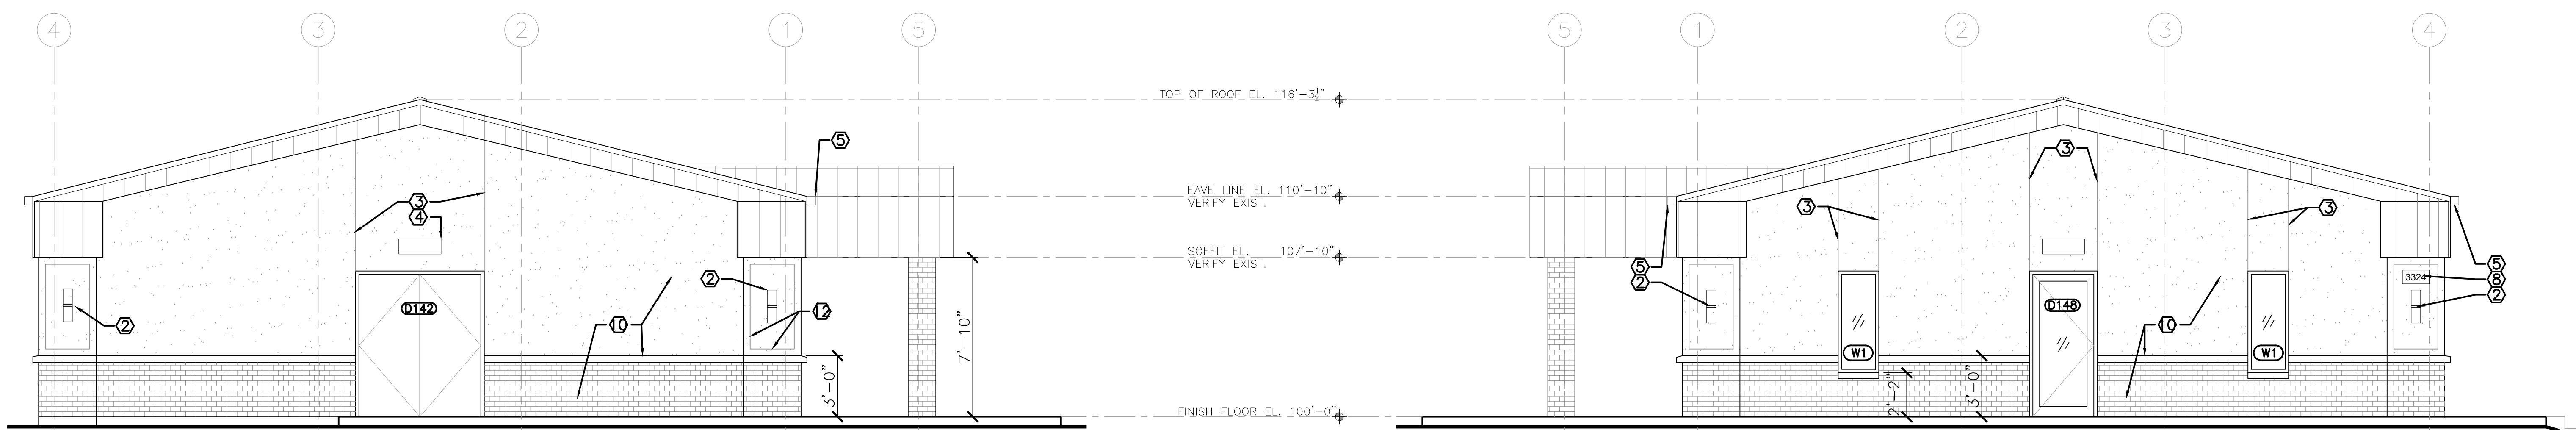

**1 NORTH ELEVATION**  
 $\frac{1}{8}" = 1' - 0"$

**2 SOUTH ELEVATION**  
 $\frac{1}{8}" = 1' - 0"$

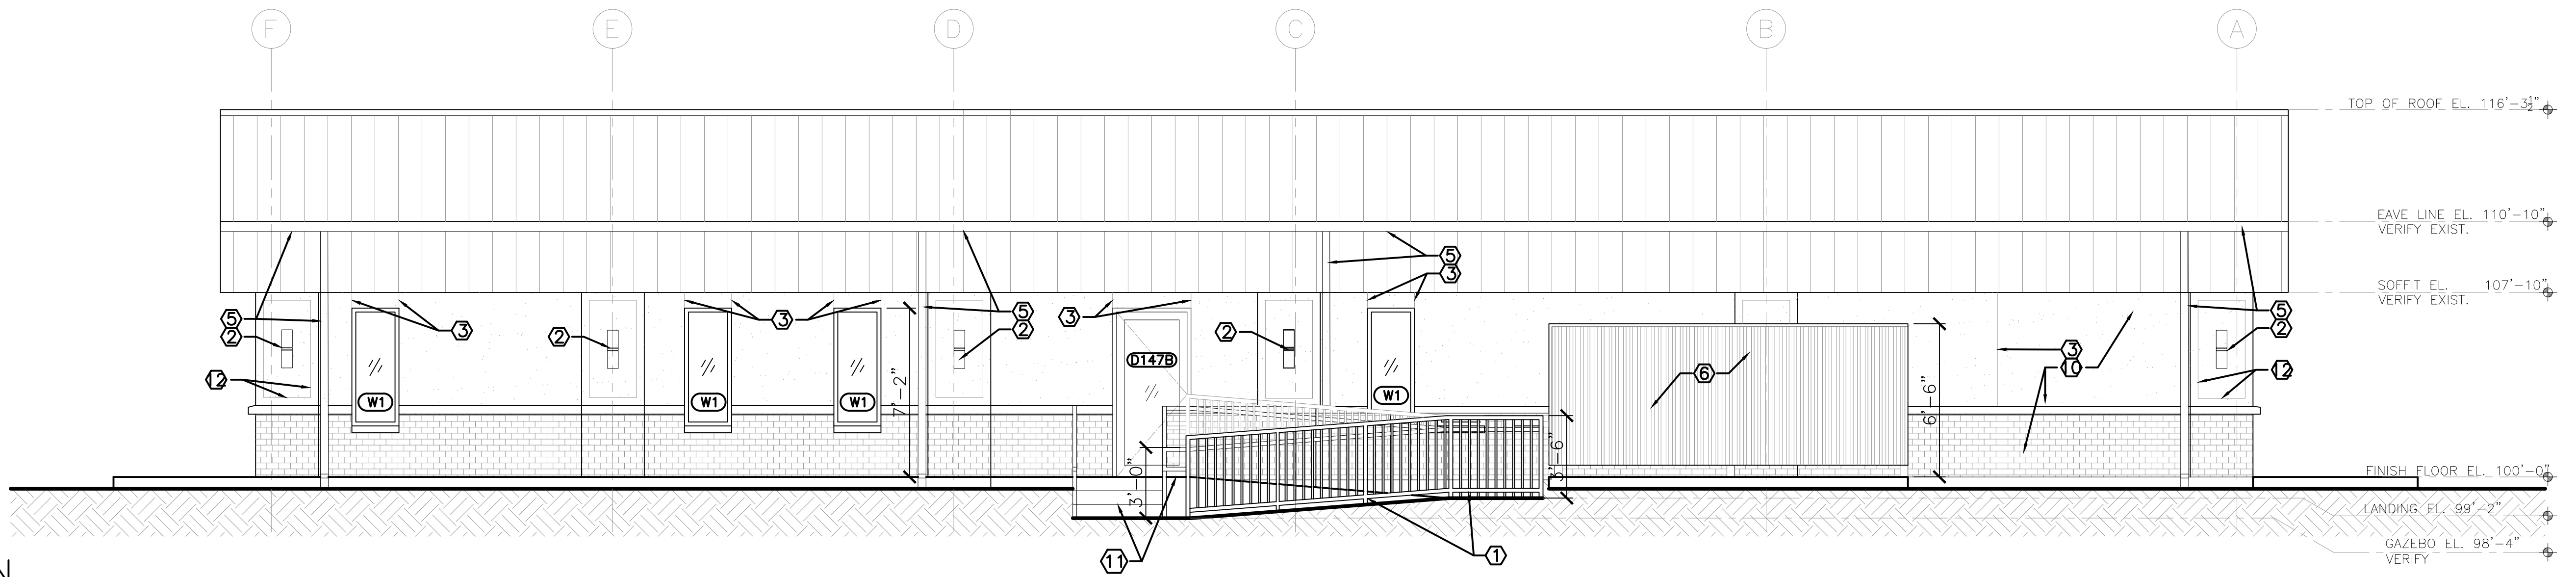

**3 EAST ELEVATION**  
 $\frac{1}{8}" = 1' - 0"$



**4 WEST ELEVATION**  
 $\frac{1}{8}" = 1' - 0"$

**KEYNOTES** AS NOTATED BY


- CONTRACTOR SHALL PROVIDE STEEL PIPE HANDRAIL AND INSTALL PER ADA REQUIREMENTS. DK. BRONZE FINISH. RE: A901
- CONTRACTOR SHALL PROVIDE NEW EXTERIOR SURFACE MOUNTED LED UP/DN WALL SCONCE. TYP. DK. BRONZE FINISH. CENTER BETWEEN EDGE OF SOFFIT AND LEDGE. REFER TO ELECTRICAL FOR SCHEDULE
- NEW CONTROL JOINT. TYP
- CONTRACTOR SHALL PROVIDE NEW EXTERIOR SURFACE MOUNTED LED WALL PACK. REFER TO ELECTRICAL.
- CONTRACTOR SHALL PROVIDE 4" MTL GUTTER AND 3"x4" DOWNSPOUT. PROVIDE STRAPPING AND SPLASH BOCK IAW MFR INSTRUCTIONS. MEDIUM BRONZE FINISH TO MATCH METAL ROOF.
- CONTRACTOR SHALL PROVIDE NEW MECHANICAL ENCLOSURE AND PAD. PROVIDE

- NEW METAL "R" PANEL ENCLOSURE WITH DK BRONZE FINISH. PROVIDE EDGE TRIM FOR EXPOSED EDGES. REFER A/601 FOR ADDITIONAL INFORMATION.
- CONTRACTOR SHALL PROVIDE NEW 6" EXT. BUILDING ENTRANCE SIGNAGE WITH RAISED ALUMINUM LETTERING IN ACCORDANCE WITH GAFB BASE STANDARDS AND, DK. BRONZE FINISH. CENTER ABOVE BUILDING ENTRY.
- CONTRACTOR SHALL PROVIDE NEW EXTERIOR BUILDING SIGNAGE. PROVIDED  $\frac{3}{8}$ " ACRYLIC OR PAINTED ALUMINUM LETTERING WITH DK. BRONZE BACKGROUND AND WHITE LETTERING. REFER TO GAFB BASE STANDARDS.
- CONTRACTOR SHALL PROVIDE FROSTED VINYL BUILDING ID NUMBER AND FIRE DEPT. EMBLEM ON GLASS STOREFRONT. FD EMBLEM AVAILABLE UPON REQUEST.
- EIFs EXTERIOR FINISH, 4" DRIP LEDGE, AND BRICK VENEER. ACME QUORUM BRICK OR SIMILAR TO MATCH EXISTING FIRE STATION AS MUCH AS POSSIBLE. TYP.

- NEW CONCRETE STAIRS AND RAMP. REFER TO A401 FOR ADDITIONAL INFORMATION.
  - 12.4" EIFs FRAME AROUND WALL SCONCE. PROVIDE  $\frac{1}{2}$ " DEPTH REVEAL. TYP EA. COLUMN.
- GENERAL NOTES:**
- CONTRACTOR SHALL VERIFY ALL DIMENSIONS AND JOB CONDITIONS PRIOR TO START OF WORK.
  - CONTRACTOR SHALL PROVIDE ALL WEATHERPROOFING, FLASHING, AND SEALANTS AT ALL ROOF VALLEYS, AND INTERSECTIONS OF NEW CONSTRUCTION AND EXISTING CONNECTIONS.
  - ALL METAL ROOF PANEL LAPS SHALL FACE OPPOSITE TO PREVAILING WINDS (SAN ANGELO: SW TO NE WINDS)

**EXTERIOR FINISH SCHEDULE**

- D100** DOOR TAG
- W1** WINDOW TAG

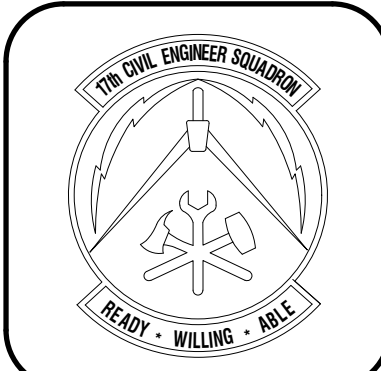


REVISIONS	DATE

Designed by JH/MLLA	Drawn by JH/MLLA	Reviewed by RT/JAH	Submitted by PC/ES
------------------------	---------------------	-----------------------	-----------------------


PROJECT TITLE  
**FIRE STATION ADD/ALTER, B3321  
 PROJECT NO. 1039839  
 17th TRAINING WING  
 GOODFELLOW AIR FORCE BASE, TEXAS**

Project Number: 1039839
SHEET TITLE <b>ENLARGED PLANS</b>
Date: JAN 2024


SEQ. 25	SHEET <b>A-601</b>	OF 50
------------	-----------------------	----------

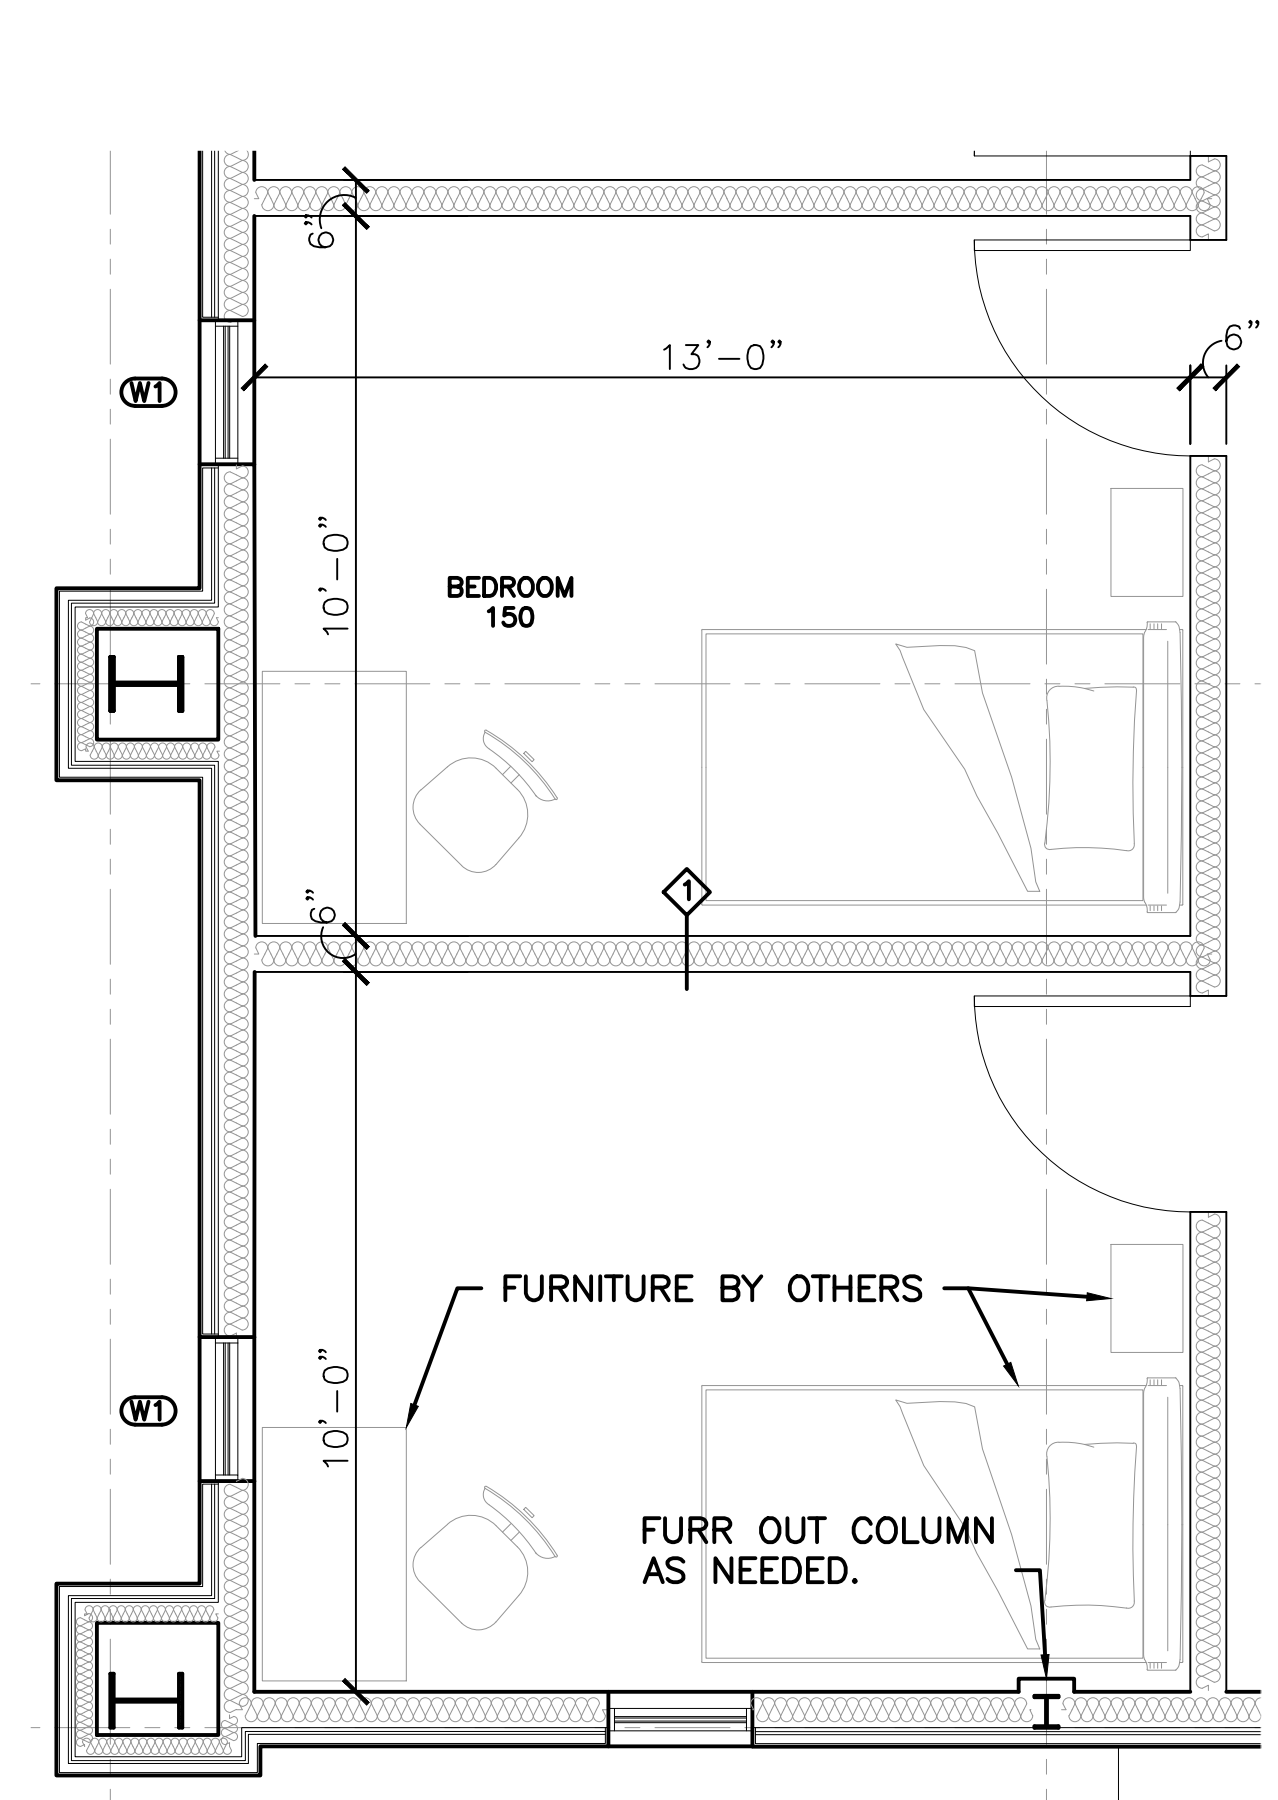


② ENLARGED PLAN - TYP. DORM  
 $\frac{3}{8}'' = 1' - 0''$

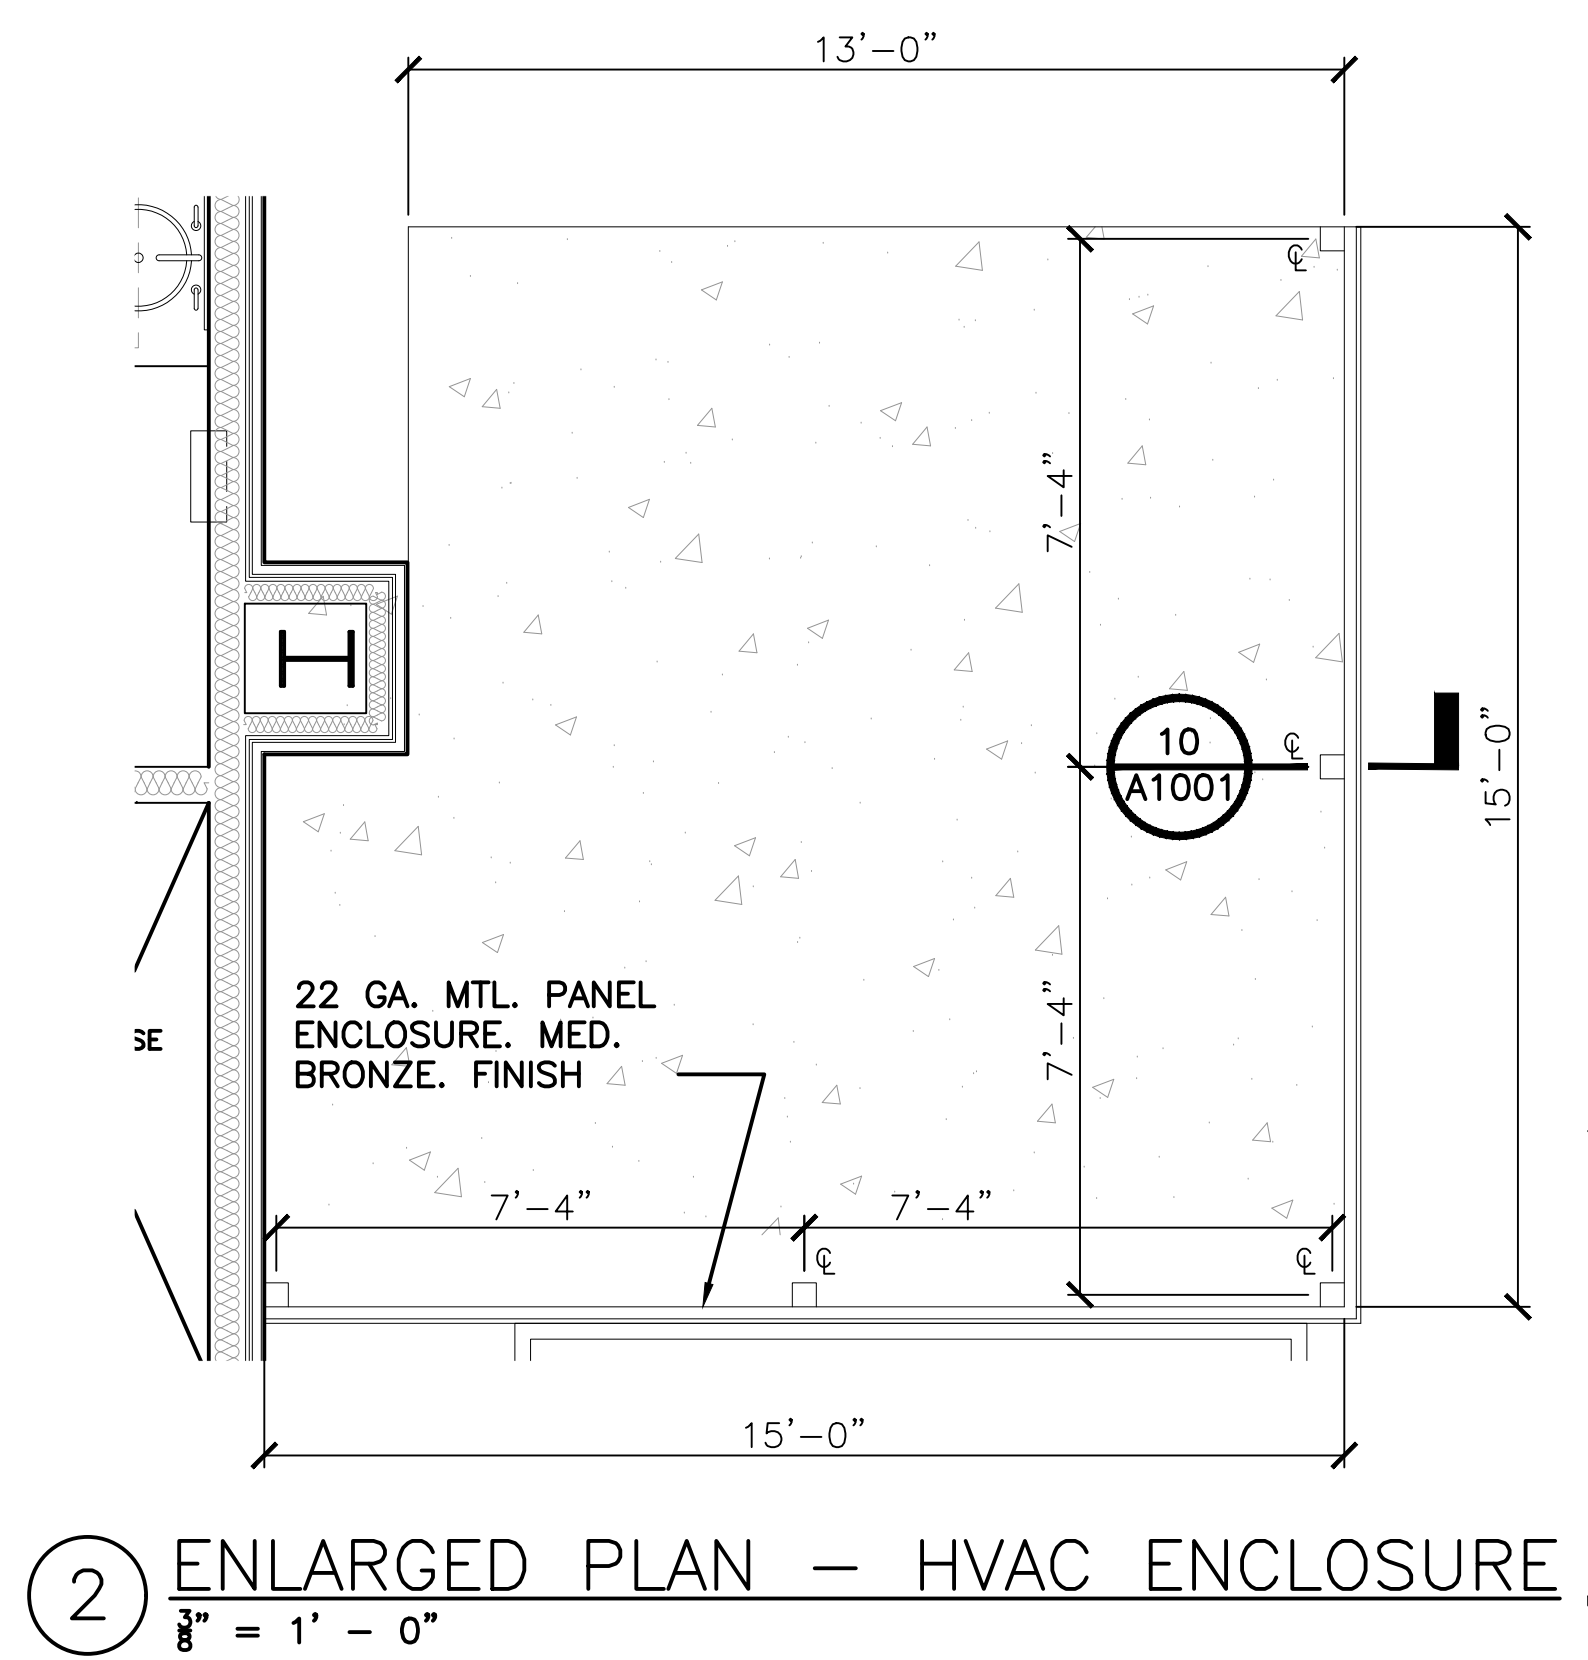

② ENLARGED PLAN - HVAC ENCLOSURE  
 $\frac{3}{8}'' = 1' - 0''$

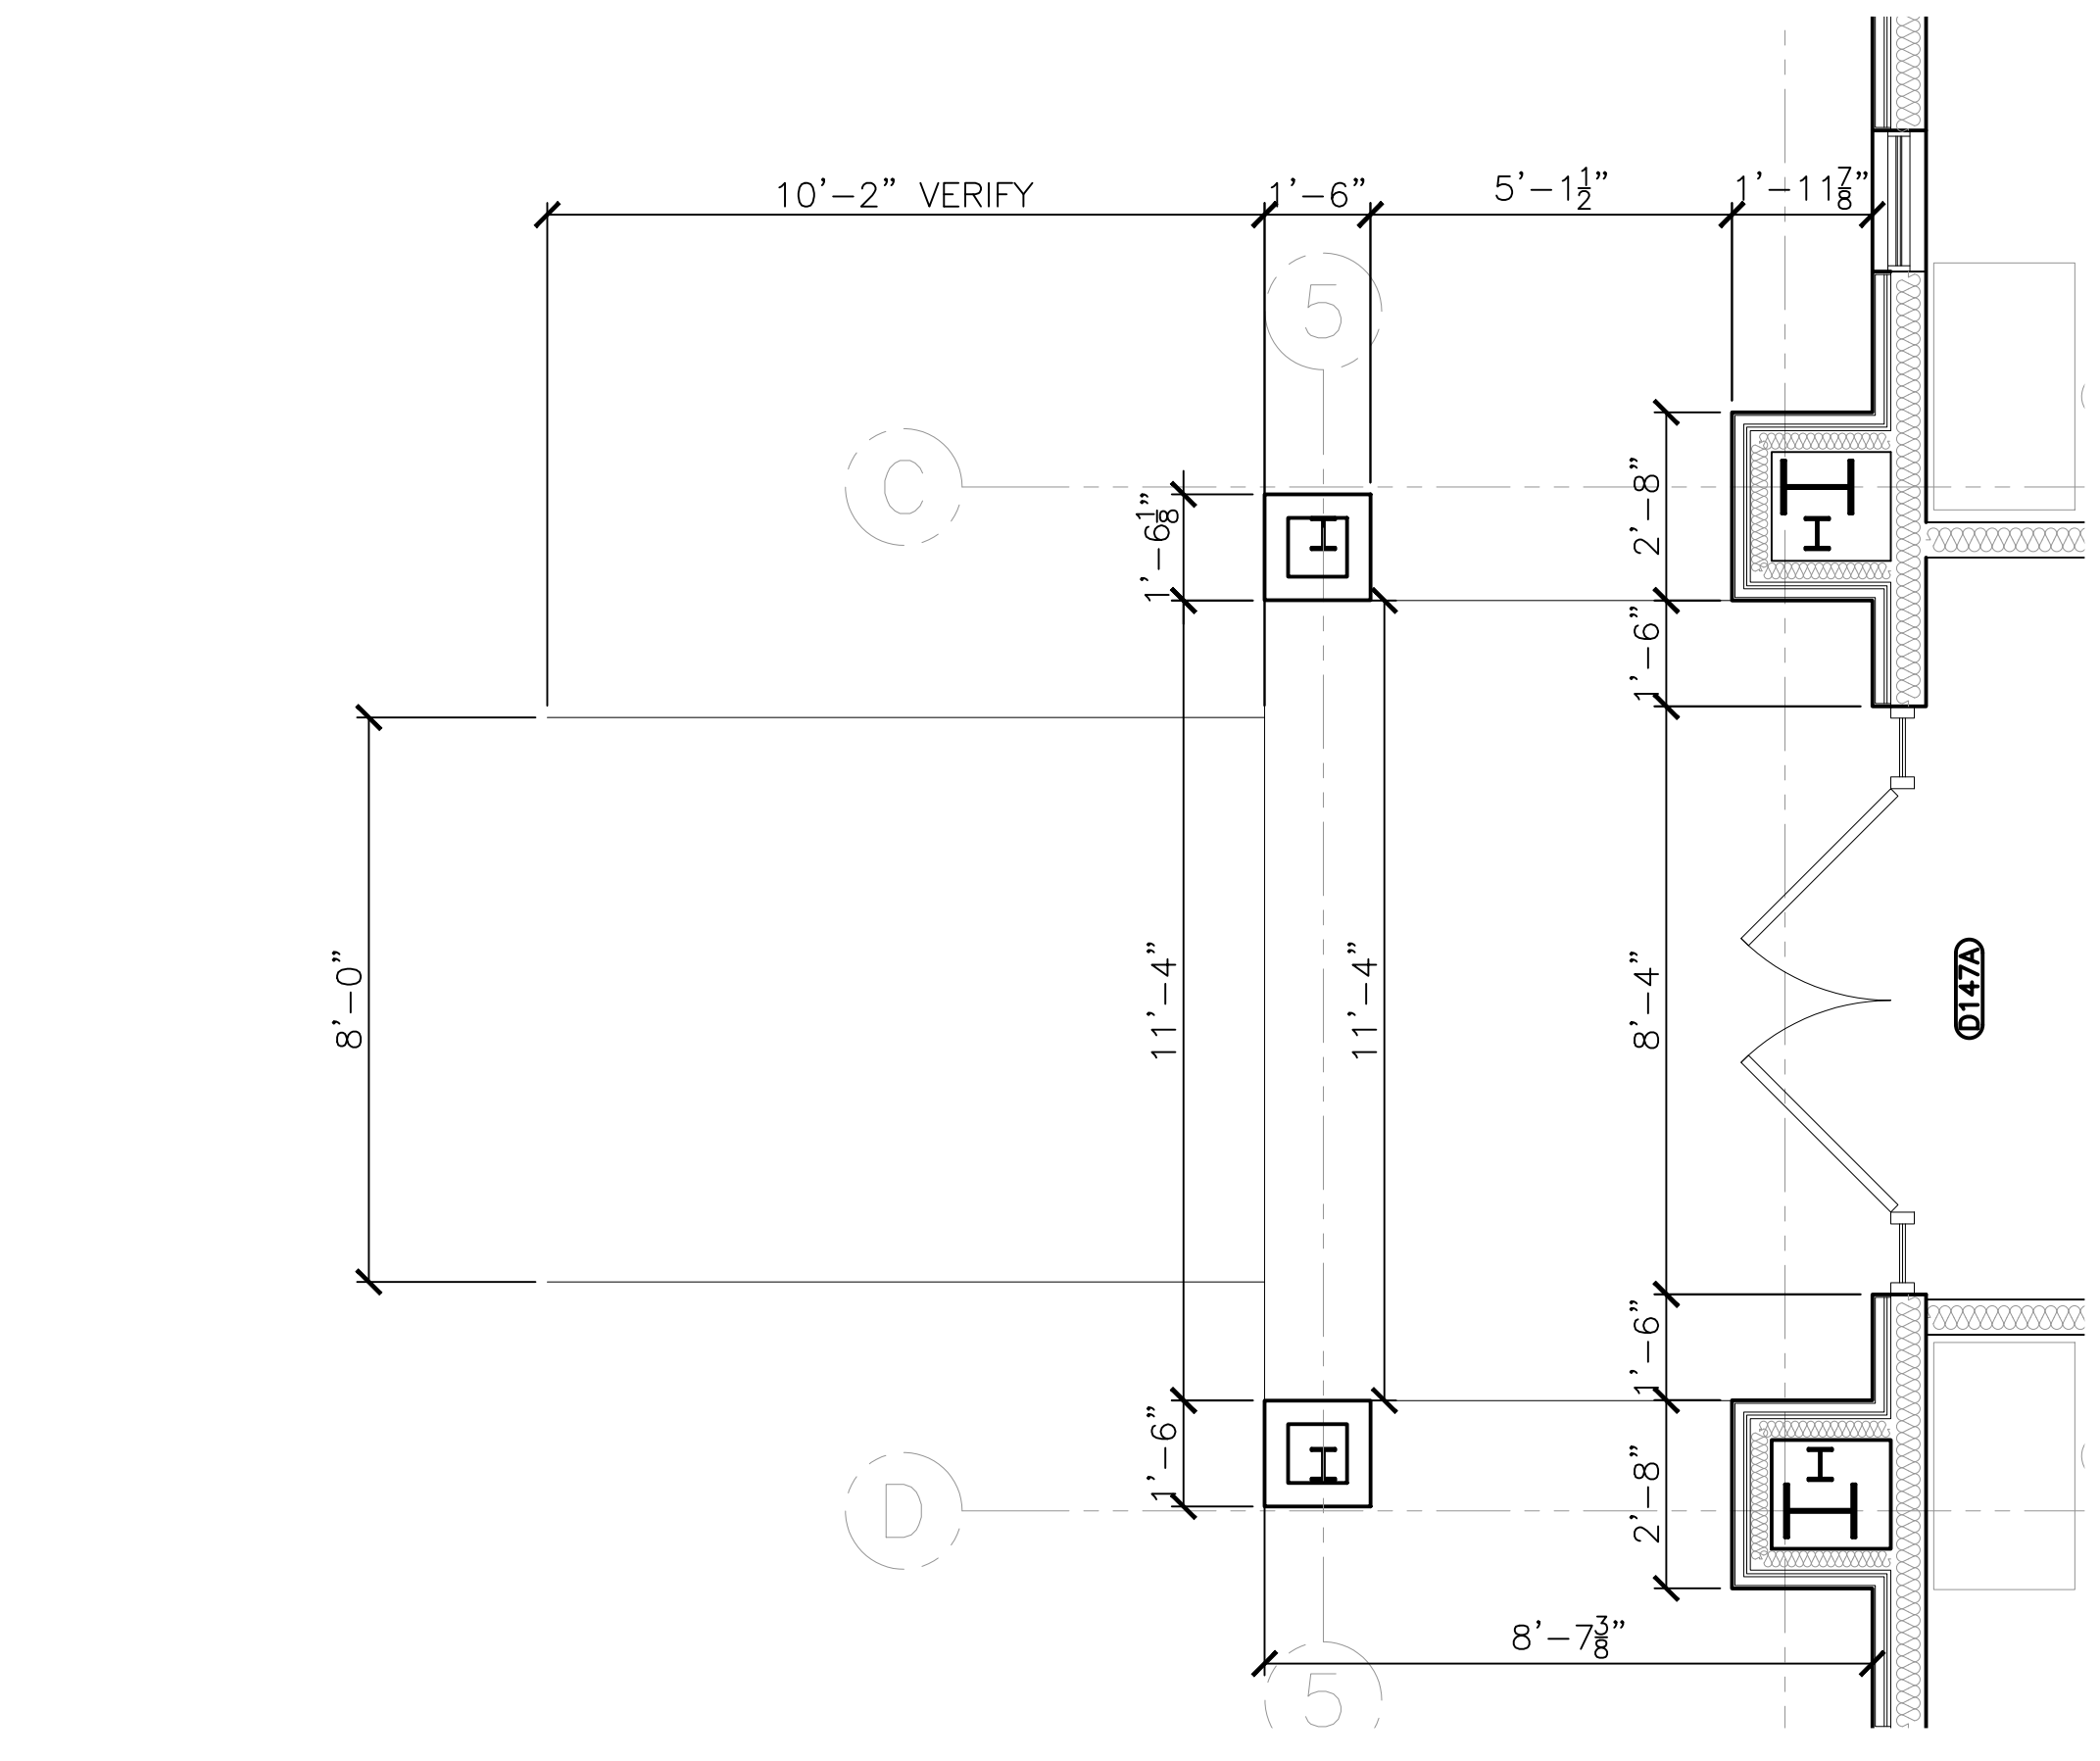


④ ENL. PLAN - BREEZEWAY  
 $\frac{3}{8}'' = 1' - 0''$

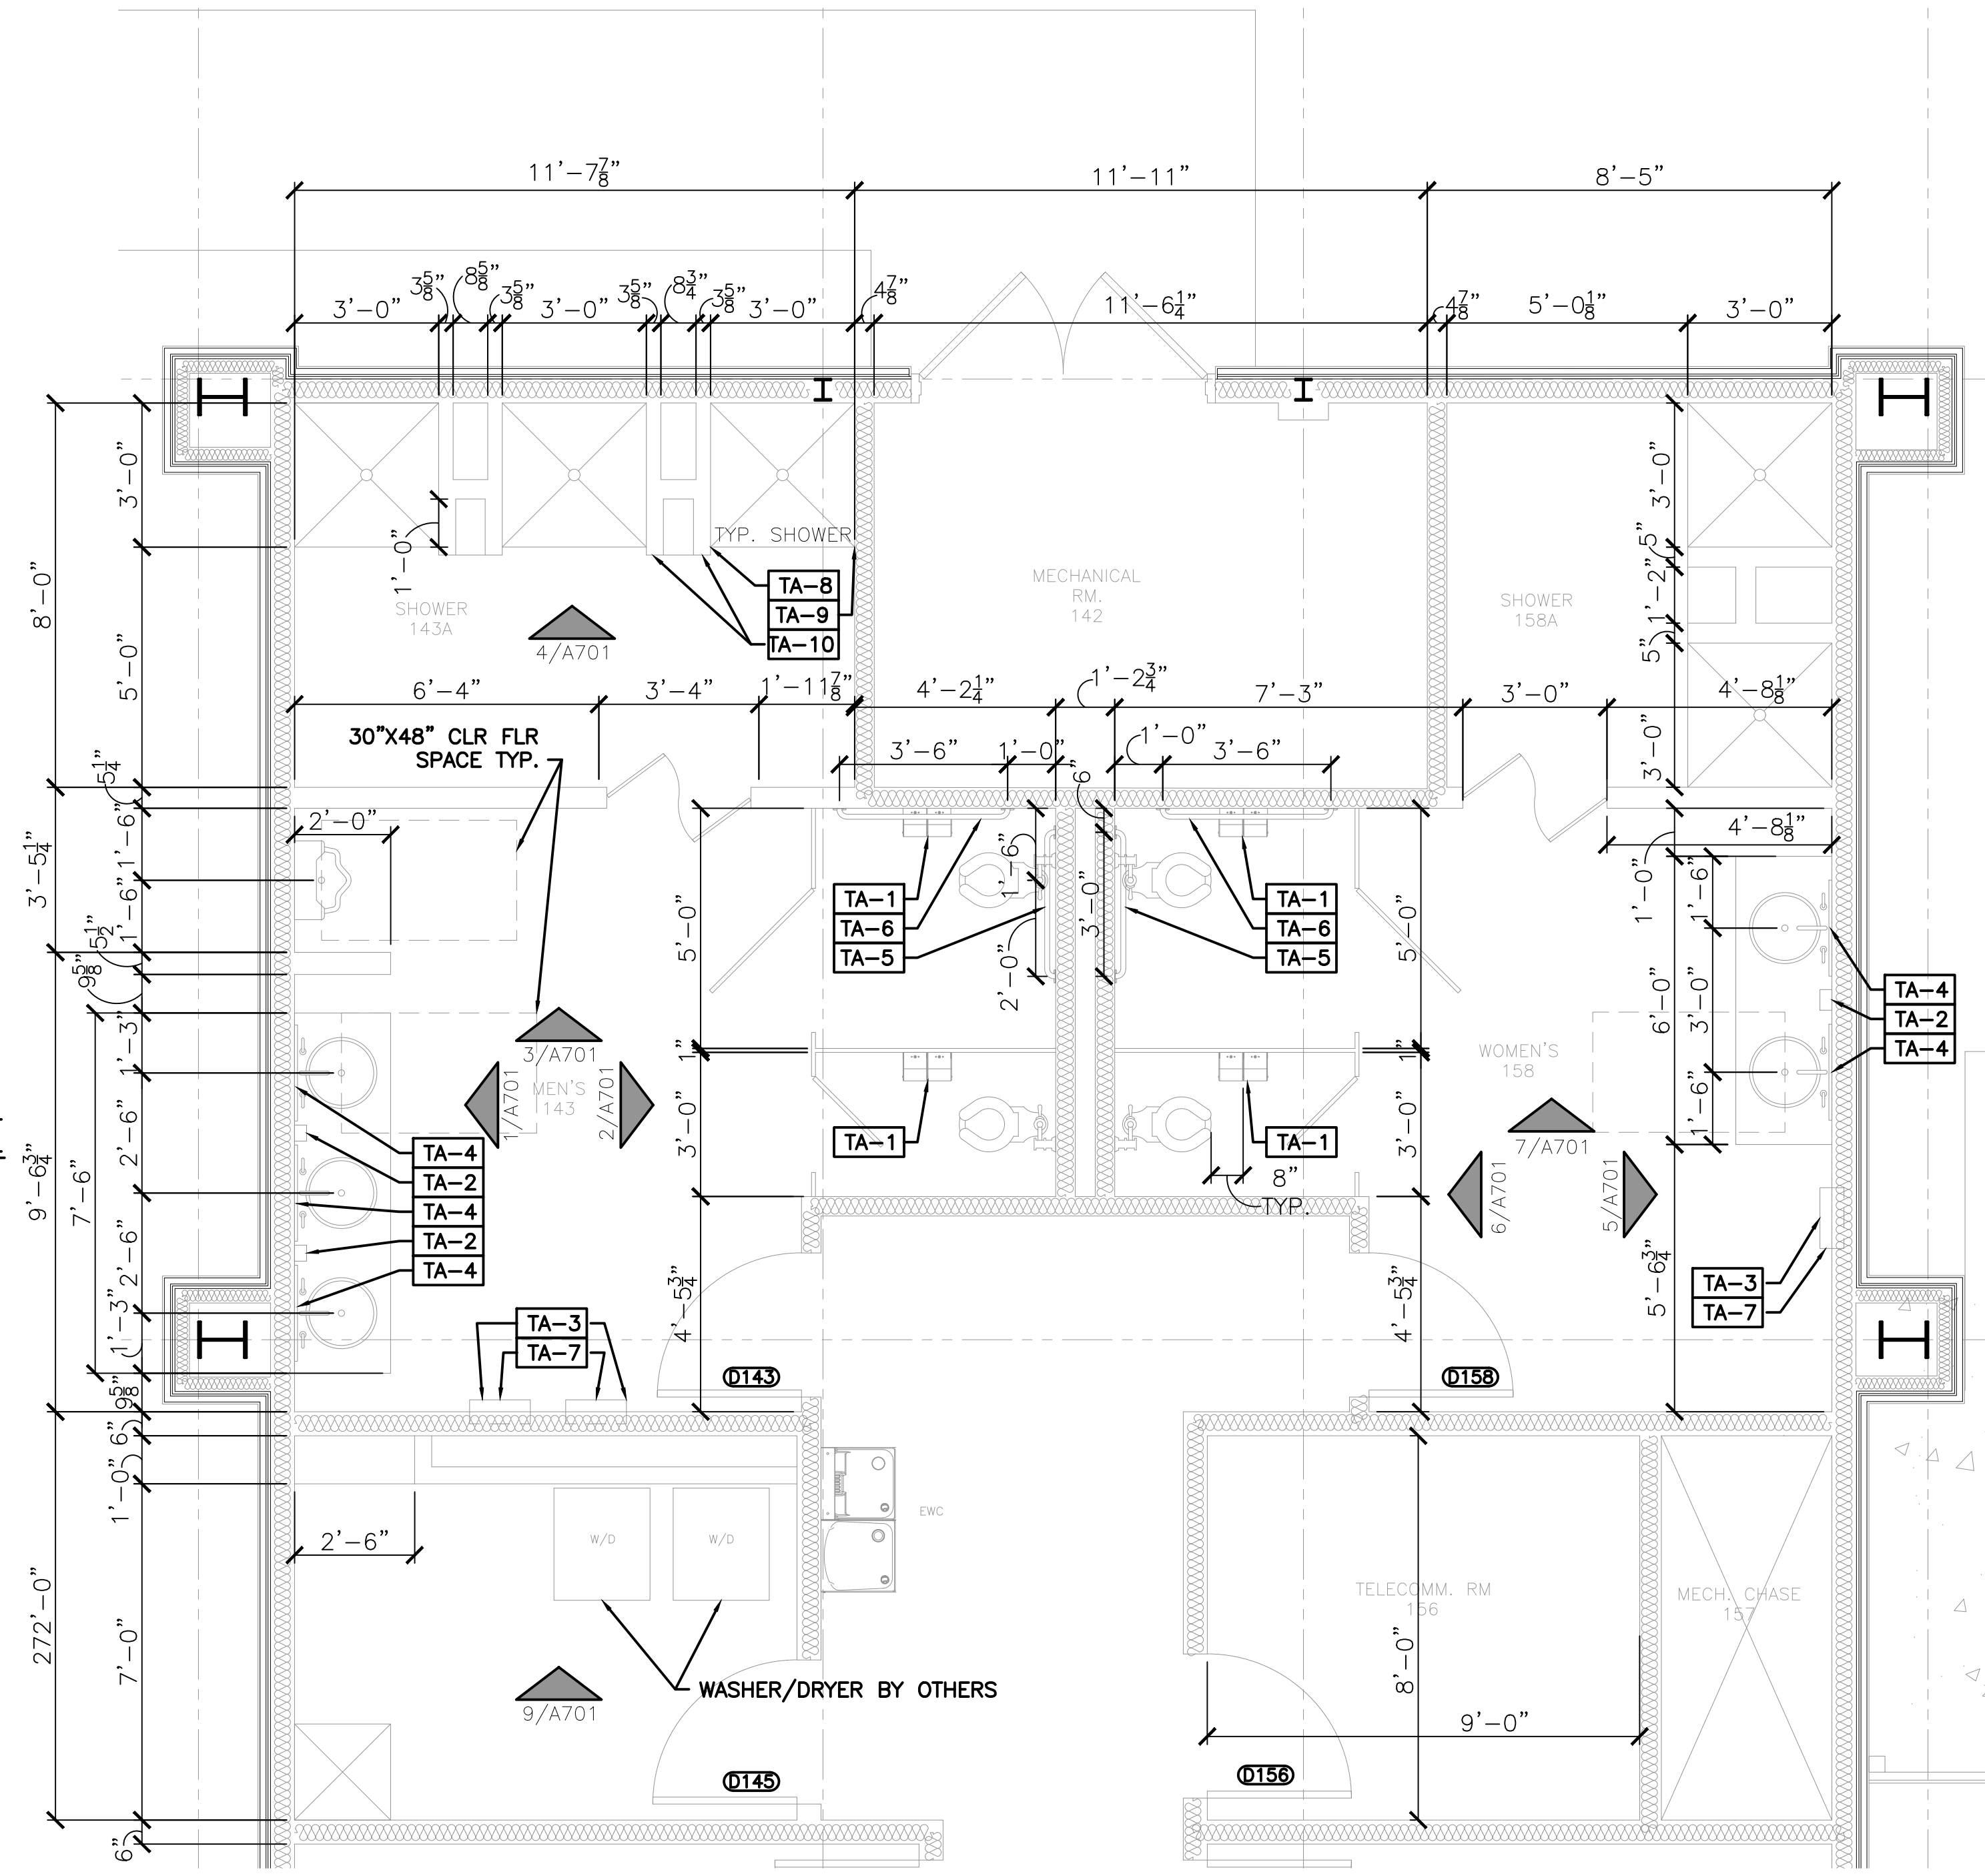

③ ENLARGED PLAN - RESTROOMS  
 $\frac{3}{8}'' = 1' - 0''$

**LEGEND**

- KEYNOTES**
- INTERIOR ELEVATION RE: A701
  - DOOR TAG RE: A802

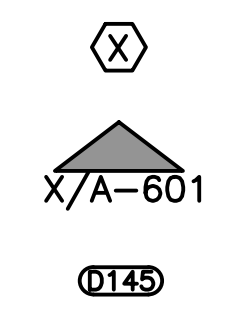


**GENERAL NOTES**


- CONTRACTOR SHALL BE RESPONSIBLE FOR VERIFYING EXISTING DIMENSIONS, EQUIPMENT, AND CONDITIONS PRIOR TO START OF WORK.
- CONTRACTOR SHALL ENSURE WORK AREAS SHALL BE KEPT CLEAN, SAFE, AND IN A WORKMANLIKE CONDITION. DEBRIS SHALL BE CLEANED ON A DAILY BASIS AND SITE SHALL BE MAINTAINED IN ACCORDANCE WITH THE SPECIFICATIONS.
- THE CONTRACTOR SHALL TAKE APPROPRIATE STEPS TO PROTECT BUILDING ELEMENTS OUTSIDE THE SCOPE OF WORK AND LABELED AS "EXISTING TO REMAIN". DAMAGE TO THESE ITEMS REQUIRING REPAIR OR REPLACEMENT SHALL BE PERFORMED BY THE CONTRACTOR AT NO ADDITIONAL COST TO THE GOVERNMENT.
- CONTRACTOR SHALL COORDINATE WITH ALL OTHER TRADES.
- CONTRACTOR SHALL DEMOLISH ALL ITEMS NOT SPECIFICALLY INDICATED, BUT OBVIOUSLY AND/OR NORMALLY REQUIRED TO COMPLETELY AND PROPERLY EXECUTE THE DEMOLITION WORK.
- FOR UNDER-SLAB DEMO, CONTRACTOR SHALL DEMO THE MINIMUM NECESSARY CONCRETE TO PROVIDE FOR NEW PLUMBING INSTALLATION.

TOILET ACCESSORY SCHEDULE (OR APPROVED EQUAL)				
TAG #	NAME	MANUFACTURER	MODEL	NOTES
TA-1	TOILET PAPER DISPENSER	GEORGIA PACIFIC	COMPACT, MFG #56744A	CFCI - CONTRACTOR FURNISHED & INSTALLED
TA-2	SOAP DISPENSER	SC JOHNSON	PROLINE CURVE, #BLK2LDP	CFCI - CONTRACTOR FURNISHED & INSTALLED
TA-3	PAPER TOWEL DISPENSER	TORK	PEAKSERVE MINI CONTINUOUS, #552538	CFCI - CONTRACTOR FURNISHED & INSTALLED
TA-4	24" X 36" GLASS MIRROR	BOBRICK	#B-3942	CFCI - CONTRACTOR FURNISHED & INSTALLED
TA-5	GRAB BAR, 36"	BOBRICK	#B-5806 X 36	CFCI - CONTRACTOR FURNISHED & INSTALLED
TA-6	GRAB BAR, 42"	BOBRICK	#B-5806 X 42	CFCI - CONTRACTOR FURNISHED & INSTALLED
TA-7	WASTE RECEPTACLE	BOBRICK	#B-2400	CFCI - CONTRACTOR FURNISHED & INSTALLED
TA-8	SHOWER ROD & FLANGE	ASI	#1204-36/1204-1	CFCI - CONTRACTOR FURNISHED & INSTALLED
TA-9	SHOWER CURTAIN & HOOKS	ASI	#1200-V36/1200-SHU	CFCI - CONTRACTOR FURNISHED & INSTALLED
TA-10	HEAVY DUTY ROBE HOOKS	MOCKETT	#CH23 1-3/8" BUTTON COAT HOOK	CFCI - CONTRACTOR FURNISHED & INSTALLED




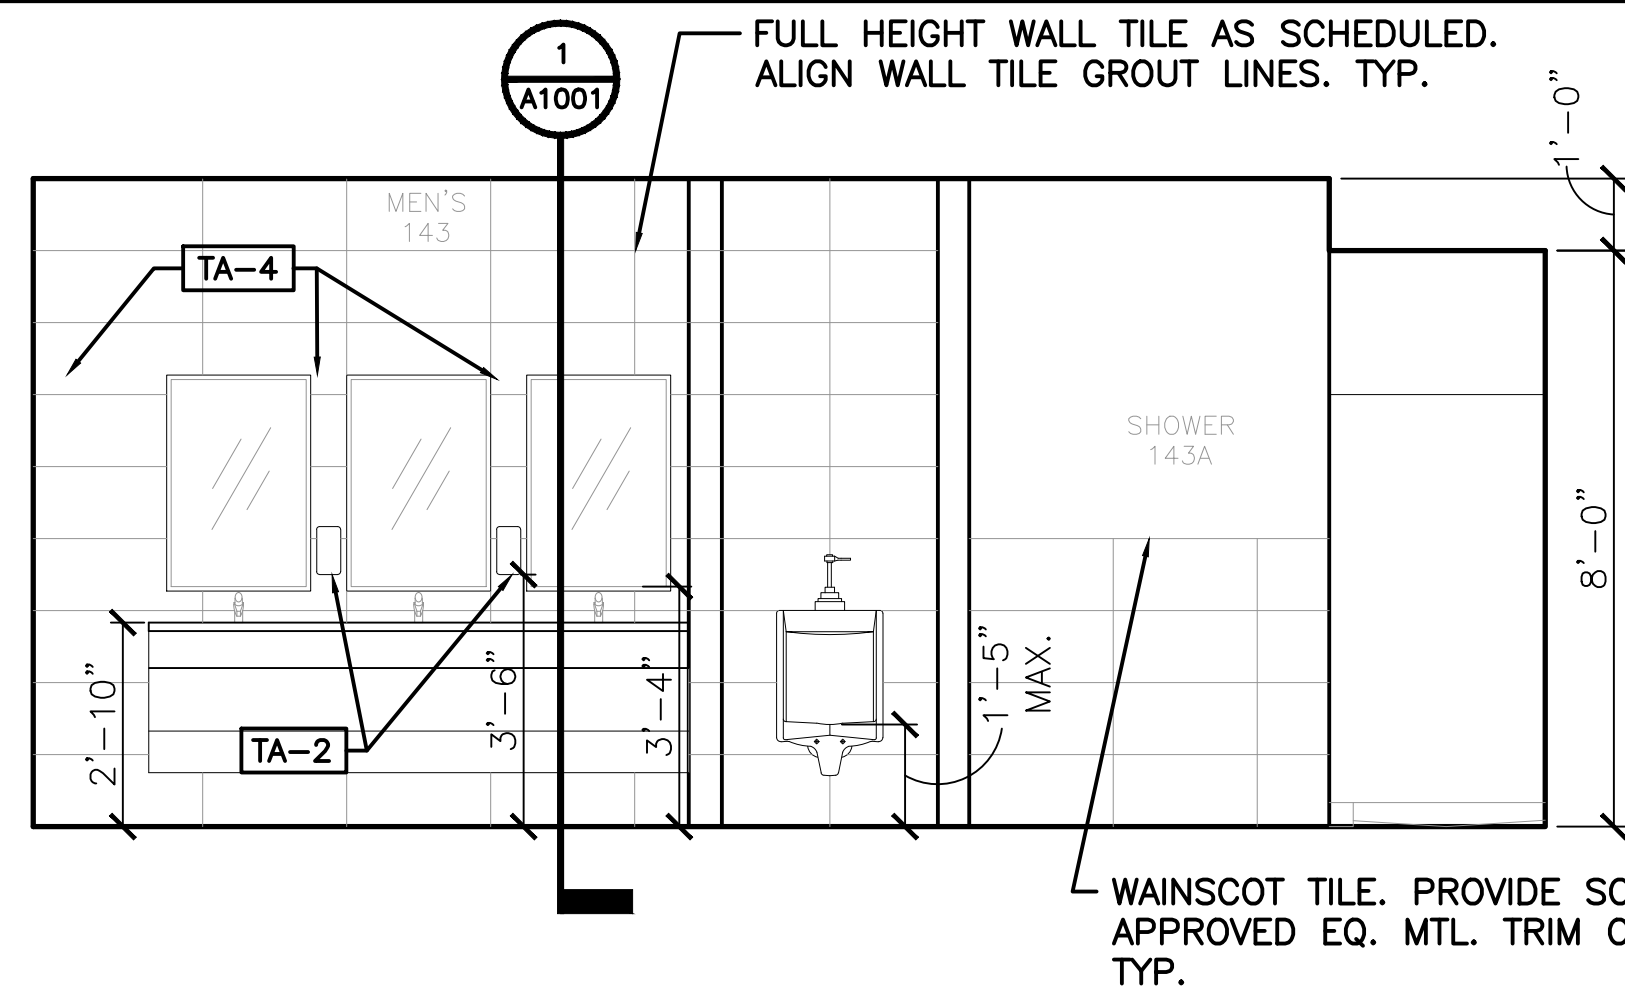


1 INT. ELEVATION-MEN'S RR  
 $\frac{3}{8}'' = 1'-0''$

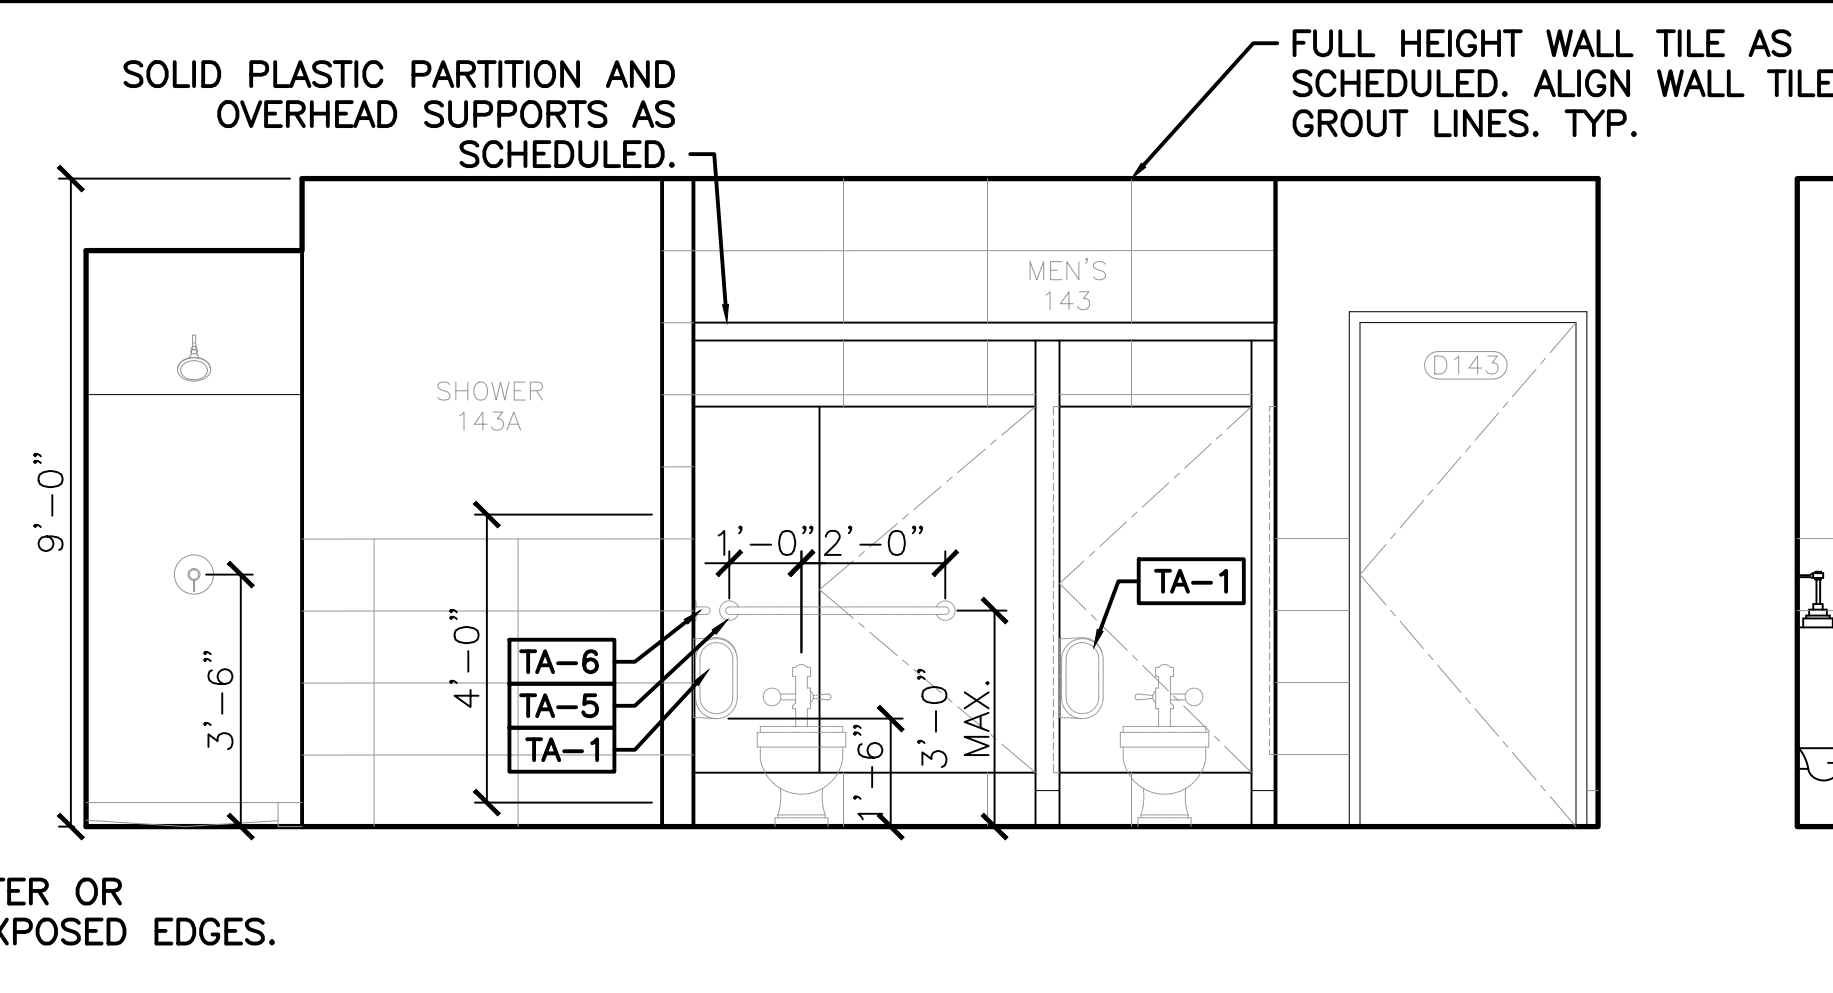


2 INT. ELEVATION-MEN'S RR  
 $\frac{3}{8}'' = 1'-0''$

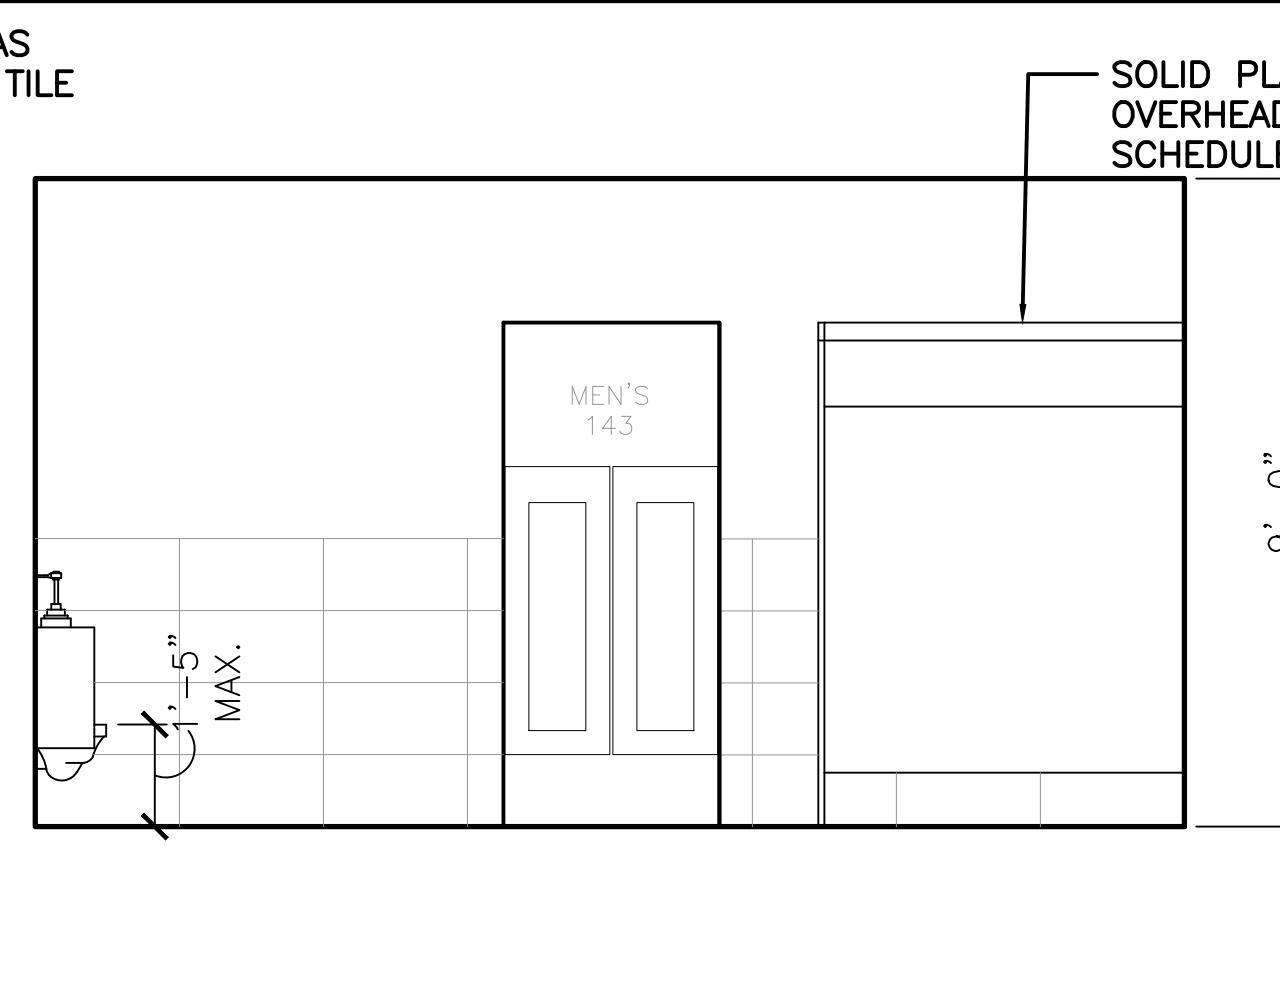


3 INT. ELEVATION-MEN'S RR  
 $\frac{3}{8}'' = 1'-0''$

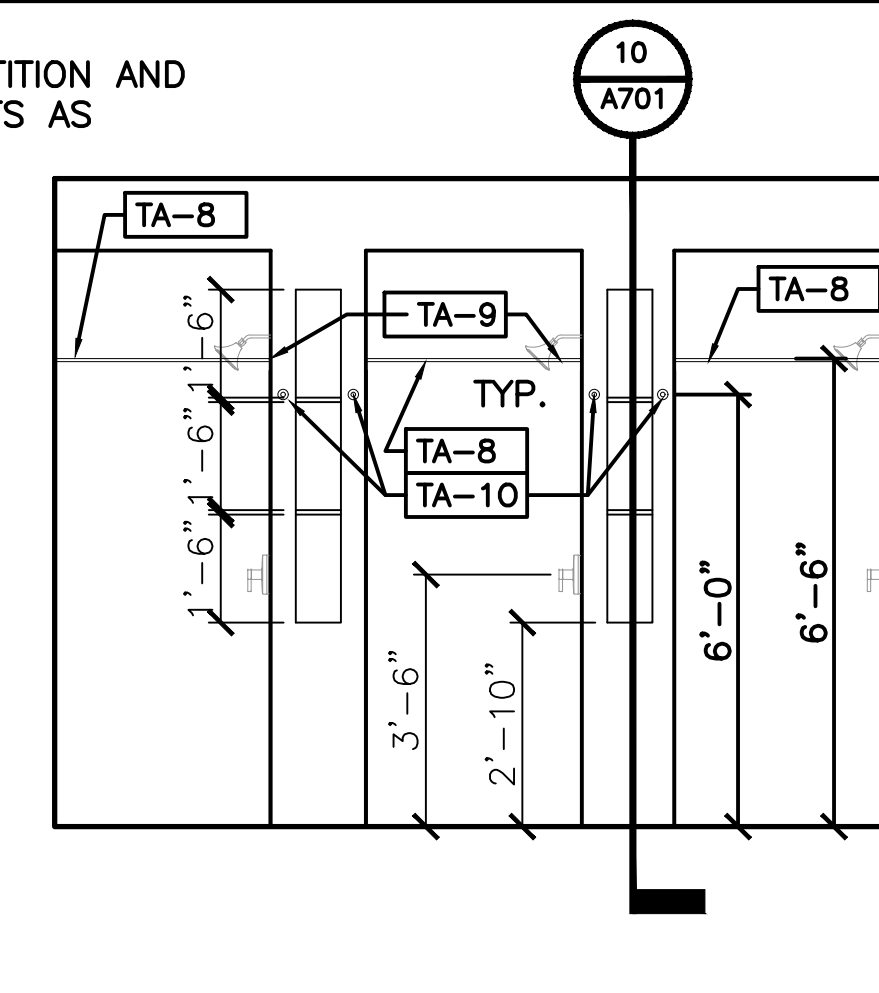


4 INT. ELEVATION-MEN'S RR  
 $\frac{3}{8}'' = 1'-0''$

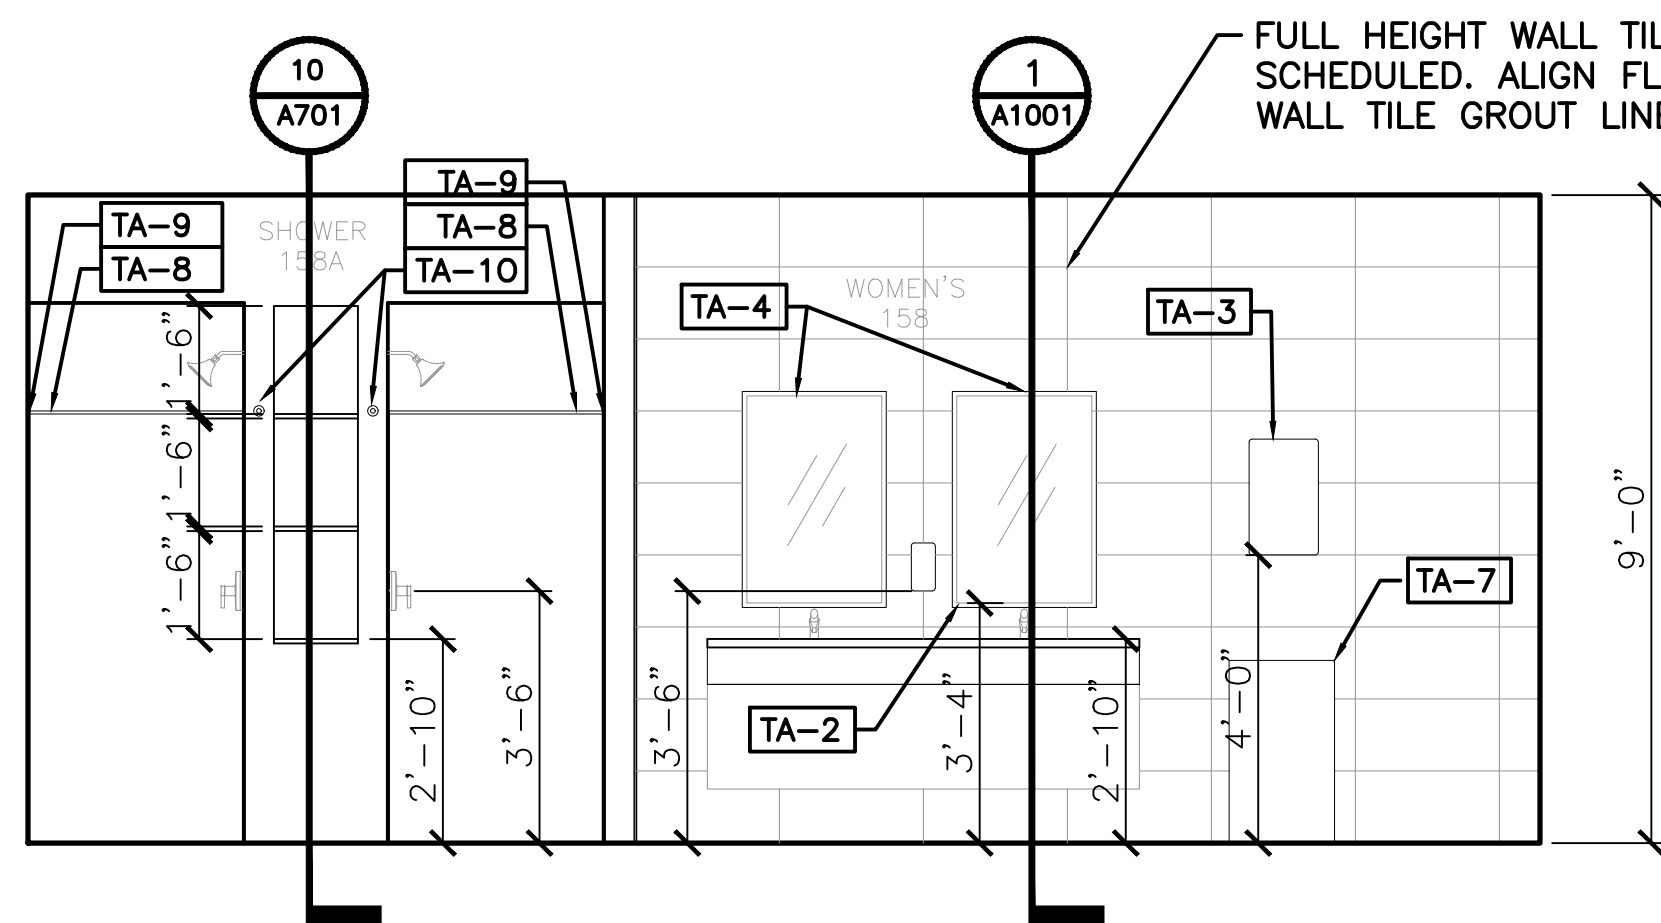


5 INT. ELEVATION-WOMEN'S RR  
 $\frac{3}{8}'' = 1'-0''$

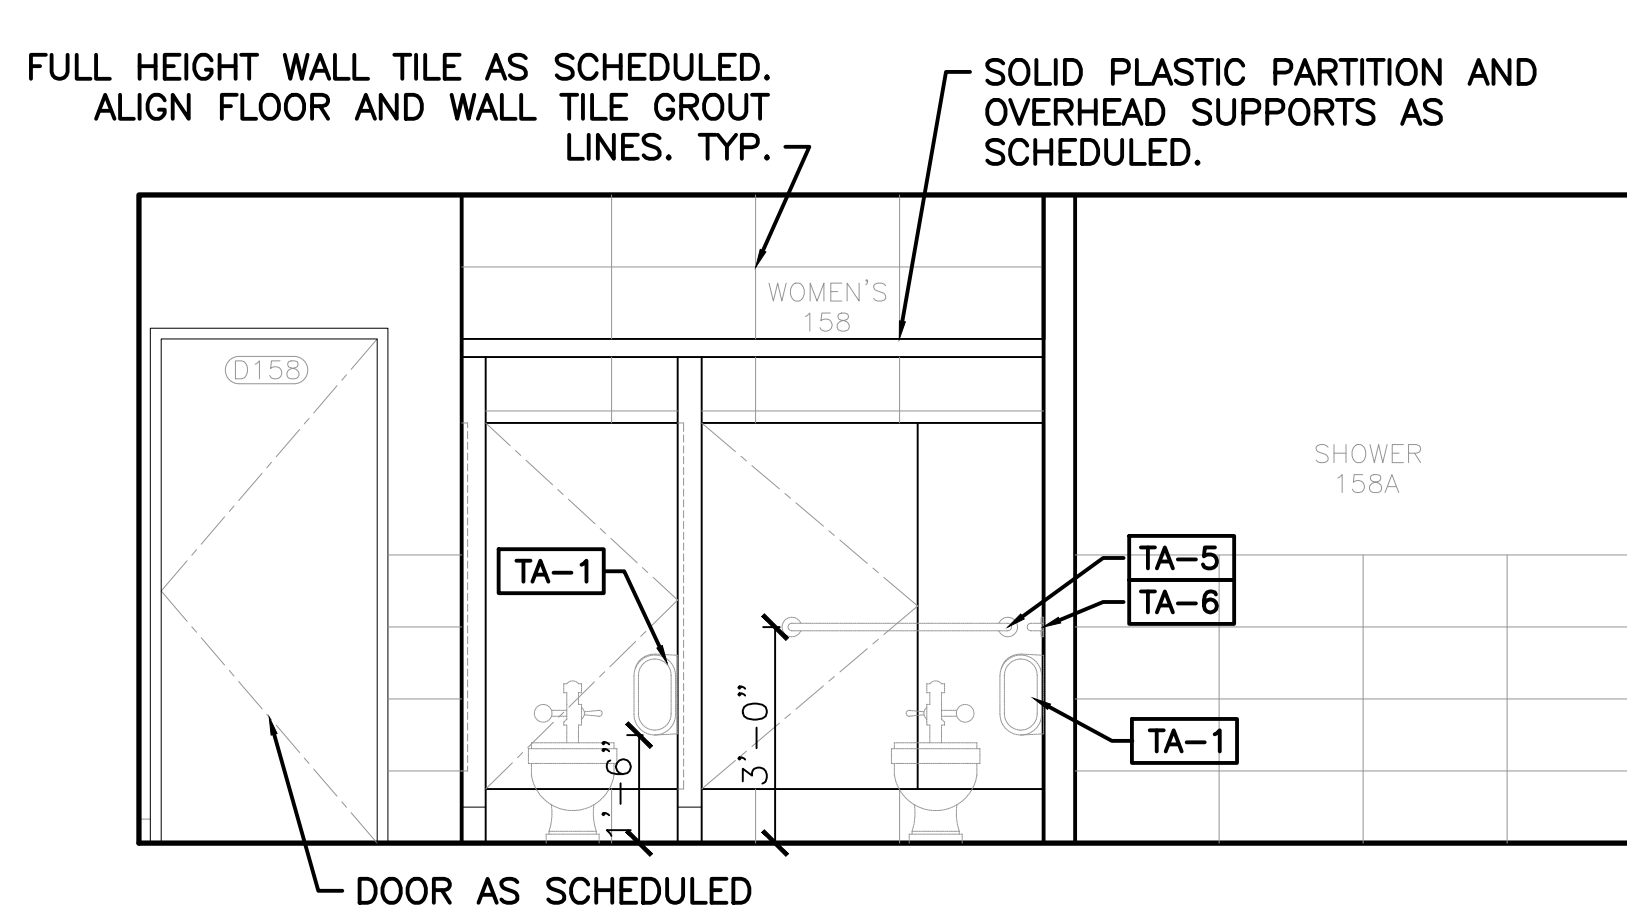


6 INT. ELEVATION-WOMEN'S RR  
 $\frac{3}{8}'' = 1'-0''$

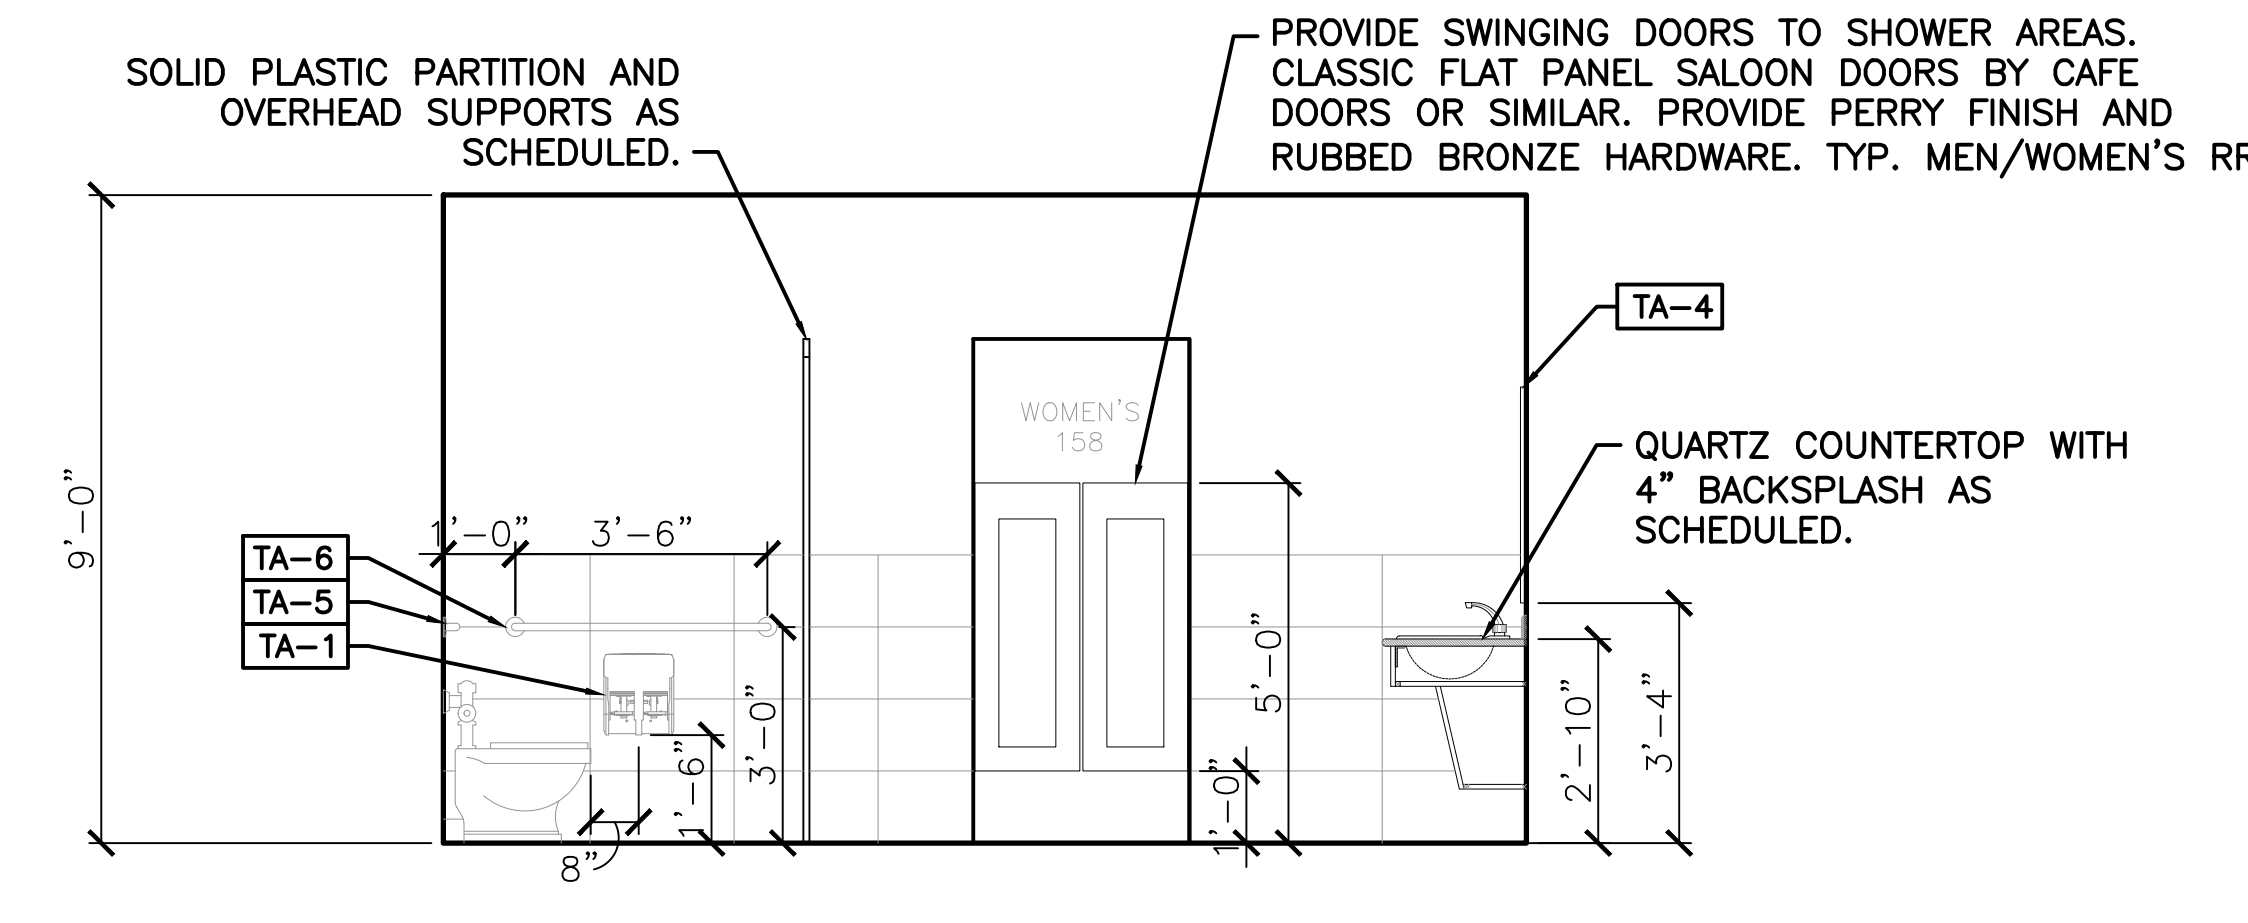


7 INT. ELEVATION-WOMEN'S RR  
 $\frac{3}{8}'' = 1'-0''$

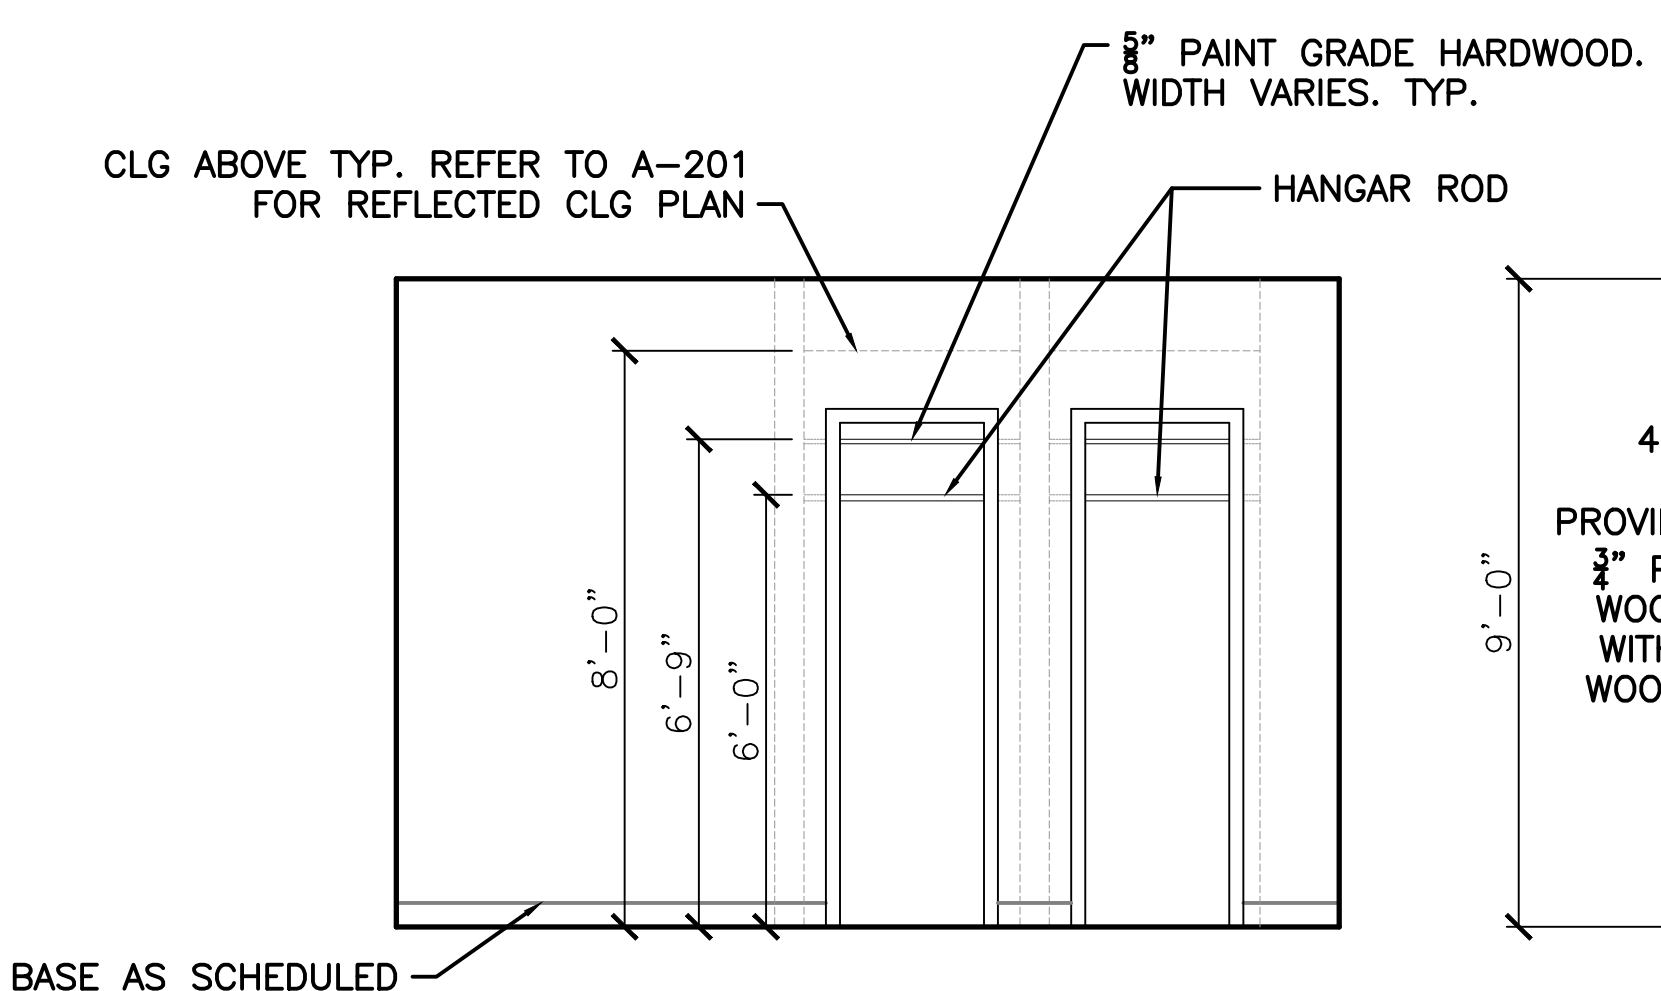

8 TYP. DORM CLOSET-BID OPTION  
 $\frac{3}{8}'' = 1'-0''$

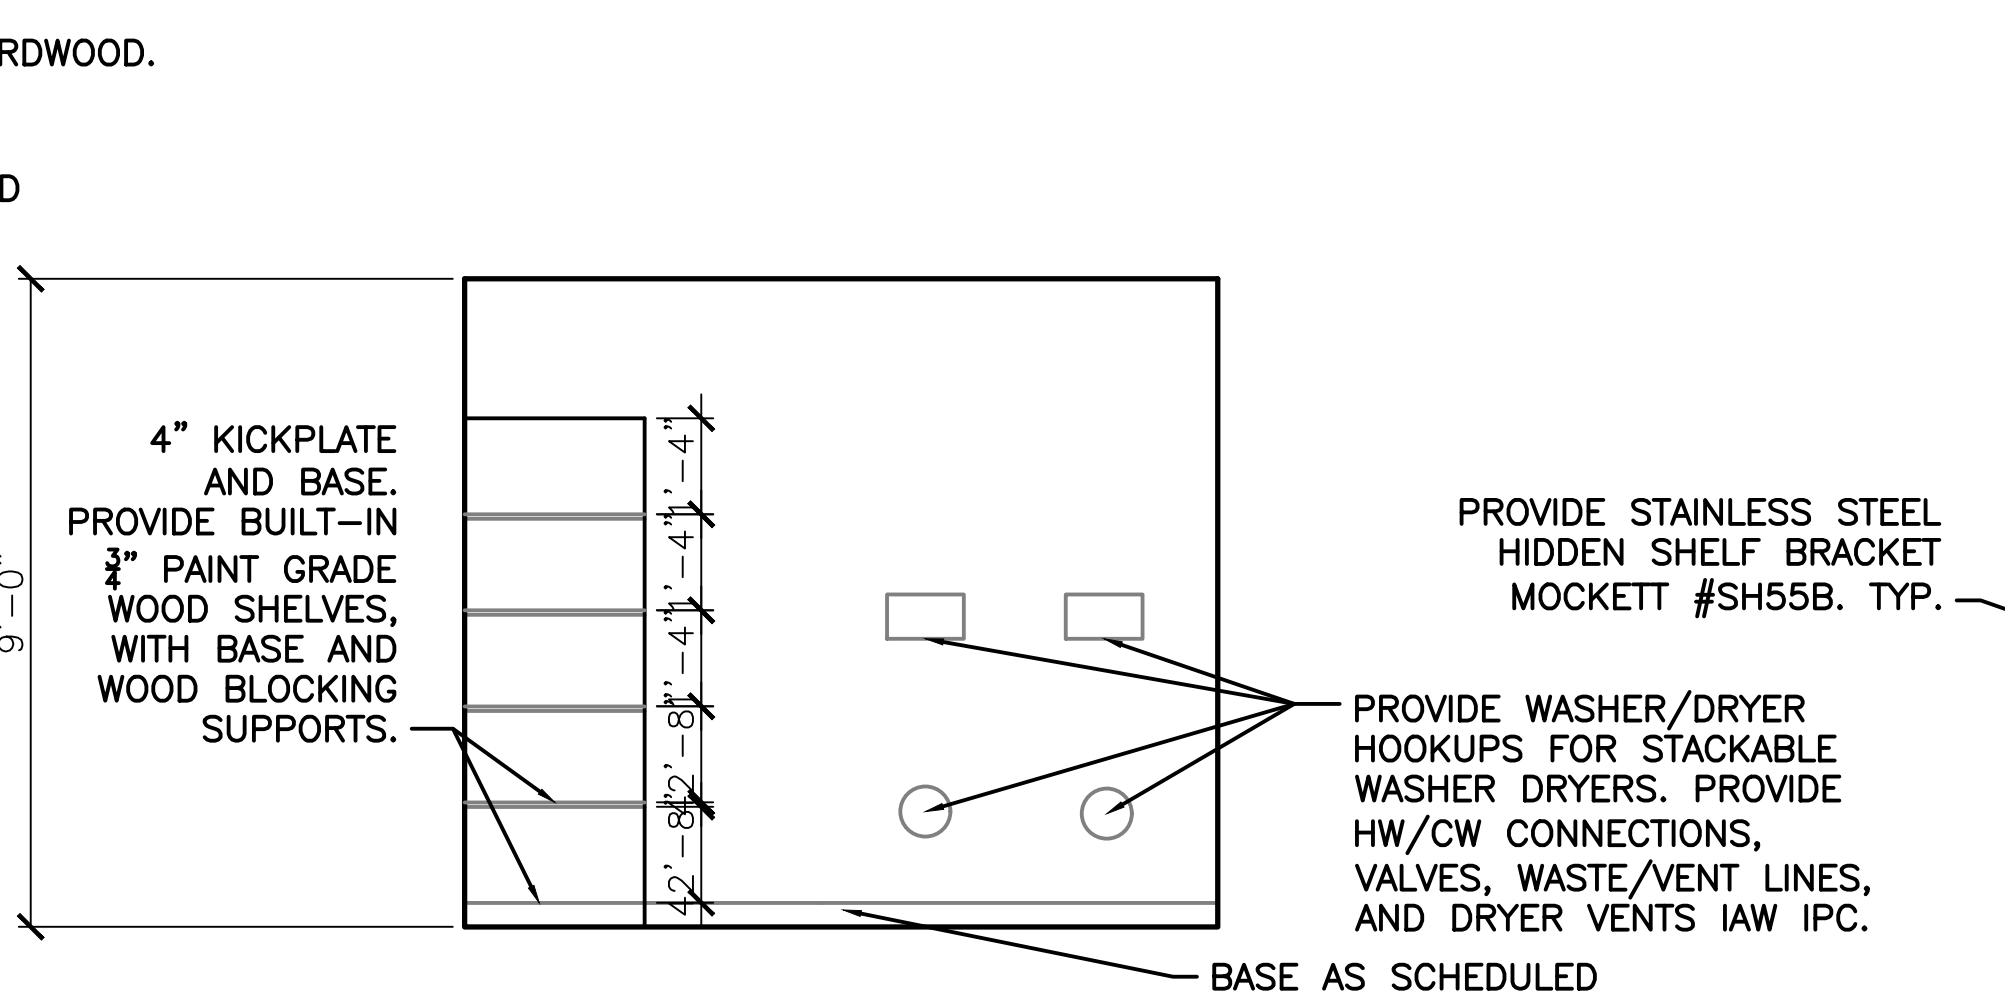

9 JANITOR'S CLOSET  
 $\frac{3}{8}'' = 1'-0''$

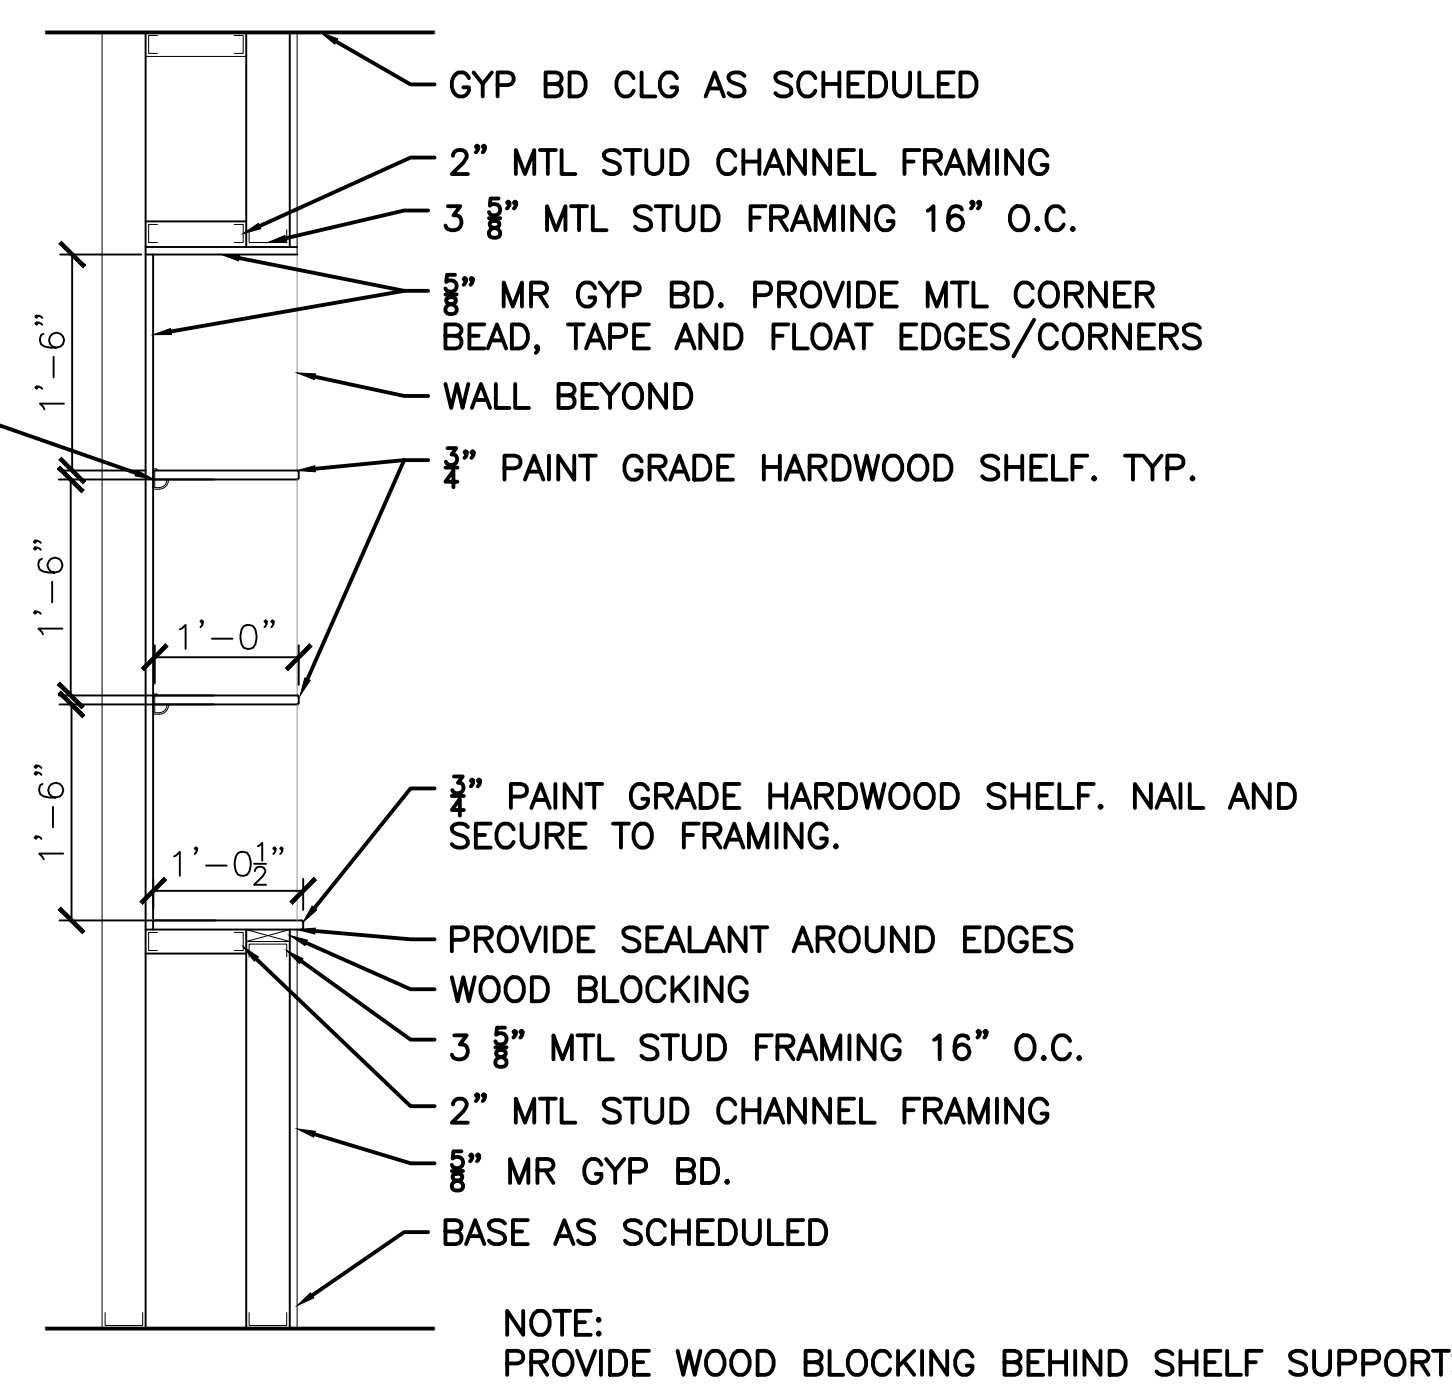

10 MILLWORK DTL  
 $\frac{3}{8}'' = 1'-0''$

GENERAL NOTES

- CONTRACTOR SHALL BE RESPONSIBLE FOR VERIFYING EXISTING DIMENSIONS, EQUIPMENT, AND CONDITIONS PRIOR TO START OF WORK.
- CONTRACTOR SHALL ENSURE WORK AREAS SHALL BE KEPT CLEAN, SAFE, AND IN A WORKMANLIKE CONDITION. DEBRIS SHALL BE CLEANED ON A DAILY BASIS AND SITE SHALL BE MAINTAINED IN ACCORDANCE WITH THE SPECIFICATIONS.
- CONTRACTOR SHALL COORDINATE WITH ALL OTHER TRADES.

TOILET ACCESSORY SCHEDULE (OR APPROVED EQUAL)

TAG #	NAME	MANUFACTURER	MODEL	NOTES
TA-1	TOILET PAPER DISPENSER	GEORGIA PACIFIC	COMPACT, MFG #56744A	CFCI - CONTRACTOR FURNISHED & INSTALLED
TA-2	SOAP DISPENSER	SC JOHNSON	PROLINE CURVE, #BLK2LDP	CFCI - CONTRACTOR FURNISHED & INSTALLED
TA-3	PAPER TOWEL DISPENSER	TORK	PEAKSERVE MINI CONTINUOUS, #552538	CFCI - CONTRACTOR FURNISHED & INSTALLED
TA-4	24" X 36" GLASS MIRROR	BOBRICK	#B-3942	CFCI - CONTRACTOR FURNISHED & INSTALLED
TA-5	GRAB BAR, 36"	BOBRICK	#B-5806 X 36	CFCI - CONTRACTOR FURNISHED & INSTALLED
TA-6	GRAB BAR, 42"	BOBRICK	#B-5806 X 42	CFCI - CONTRACTOR FURNISHED & INSTALLED
TA-7	WASTE RECEPTACLE	BOBRICK	#B-2400	CFCI - CONTRACTOR FURNISHED & INSTALLED
TA-8	SHOWER ROD & FLANGE	ASI	#1204-36/1204-1	CFCI - CONTRACTOR FURNISHED & INSTALLED
TA-9	SHOWER CURTAIN & HOOKS	ASI	#1200-V36/1200-SHU	CFCI - CONTRACTOR FURNISHED & INSTALLED
TA-10	HEAVY DUTY ROBE HOOKS	MOCKETT	#CH23 1-3/8" BUTTON COAT HOOK	CFCI - CONTRACTOR FURNISHED & INSTALLED



REVISIONS	DATE

DESIGNED BY	DRAWN BY	REVIEWED BY	SUBMITTED BY
J. H. R. L. A.	J. H. R. L. A.	R. T. J. H.	P. C. S.

PROJECT TITLE  
**FIRE STATION ADD/ALTER, B3321**  
**PROJECT NO. 1039839**  
**17th TRAINING WING**  
**GOODFELLOW AIR FORCE BASE, TEXAS**


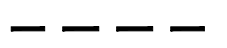








Project Number: 1039839
SHEET TITLE INTERIOR ELEVATIONS
Date: JAN 2024

SEQ. 26	SHEET A-701	OF 50
------------	----------------	----------



2 FINISH FLOOR PLAN-NEW ADDITION  
1/8" = 1' - 0"

LEGEND

- TL-1: 24"x24" FLOOR TILE 
- TL-2: 12X24" WALL TILE 
- WAINSCOT 12"x24" WALL TILE/ PT-1 
- PT-1: FIELD PAINT SW#9856 
- PT-2: ACCENT PAINT SW#9595 
- PT-4: PAINT SW#7007 
- CP-1: CARPET TILE 
- CP-4: BROADLOOM CARPET 
- LVP-1: LVP ACCENT WALL 
- CN-1: POLISHED CONCRETE 

FINISH SCHEDULE (NEW ADDITION)										
ROOM #	ROOM NAME	FLOOR	BASE	WALLS				CLG.	CLG. HT.	NOTES
				N	S	E	W			
142	MECHANICAL RM.	CN-1	RB-1	PT-3	PT-3	E	W	CL-2	10'-0"	
143	MEN'S RR	TL-1	TL-1	TL-2	PT-1	TL-2/PT-1	PT-2	CL-2	9'-0"	
143A	MEN'S SHOWER	TL-1	TL-1	-	TL-2	PT-2	PT-2	CL-2	9'-0"	
144	CORRIDOR	CP-1	RB-1	PT-1	PT-1	PT-1	PT-1	CL-1	9'-0"	
145	JAN. CLOSET	CN-1	RB-1	PT-3	PT-3	PT-3	PT-3	CL-2	9'-0"	
146	BEDROOM 1	CP-4	RB-1	PT-2	PT-1	PT-1	PT-1	CL-2	9'-0"	
147	COMMON AREA	CP-1	RB-1	PT-1/PT-2	PT-1/PT-2	PT-1/PT-2	PT-1/PT-2	CL-1	9'-0"	
148	CORRIDOR	CP-1	RB-1	-	PT-1	PT-1	PT-1	CL-1	9'-0"	
149	BEDROOM 3	CP-4	RB-1	PT-1	PT-2	PT-1	PT-1	CL-2	9'-0"	
150	BEDROOM 5	CP-4	RB-1	PT-2	PT-1	PT-1	PT-1	CL-2	9'-0"	
151	BEDROOM 7	CP-4	RB-1	PT-1	PT-1/PT-2	PT-1	PT-1/PT-2	CL-2	9'-0"	
152	BEDROOM 8	CP-4	RB-1	PT-1	PT-1/PT-2	PT-1	PT-2	CL-2	9'-0"	
153	BEDROOM 6	CP-4	RB-1	PT-2	PT-1	PT-1	PT-1	CL-2	9'-0"	
154	BEDROOM 4	CP-4	RB-1	PT-1	PT-2	PT-1	PT-1	CL-2	9'-0"	
155	BEDROOM 2	CP-4	RB-1	PT-2	PT-1	PT-1	PT-1	CL-2	9'-0"	
156	TELECOMM. RM.	CN-1	RB-1	PT-3	PT-3	PT-3	PT-3	CL-1	9'-0"	
158	WOMAN'S RR	TL-1	TL-1	TL-2	PT-1/PT-2	TL-2/PT-1	TL-2/PT-1	CL-2	9'-0"	
158A	WOMEN'S SHOWER	TL-1	TL-1	PT-2	TL-2	PT-1	-	CL-2	9'-0"	

FINISH SCHEDULE (BID OPTION - EXISTING FIRE STATION)										
ROOM #	ROOM NAME	FLOOR	BASE	WALLS				CLG.	CLG. HT.	NOTES
				N	S	E	W			
129-1	BEDROOM	CP-4	RB-1	PT-1	PT-1	PT-1	PT-1	CL-2	9'-0"	
129-1A	CLOSET	CP-4	RB-1	PT-1	PT-1	PT-1	PT-1	CL-2	9'-0"	
129-1B	CLOSET	CP-4	RB-1	PT-1	PT-1	PT-1	PT-1	CL-2	9'-0"	
129-2	BEDROOM	CP-4	RB-1	PT-1	PT-1	PT-1	PT-1	CL-2	9'-0"	
129-2A	CLOSET	CP-4	RB-1	PT-1	PT-1	PT-1	PT-1	CL-2	9'-0"	
129-2B	CLOSET	CP-4	RB-1	PT-1	PT-1	PT-1	PT-1	CL-2	9'-0"	
131-1	BEDROOM	CP-4	RB-1	PT-1	PT-1	PT-1	PT-1	CL-2	9'-0"	
131-1A	CLOSET	CP-4	RB-1	PT-1	PT-1	PT-1	PT-1	CL-2	9'-0"	
131-1B	CLOSET	CP-4	RB-1	PT-1	PT-1	PT-1	PT-1	CL-2	9'-0"	
131-2	BEDROOM	CP-4	RB-1	PT-1	PT-1	PT-1	PT-1	CL-2	9'-0"	
131-2A	CLOSET	CP-4	RB-1	PT-1	PT-1	PT-1	PT-1	CL-2	9'-0"	
131-2B	CLOSET	CP-4	RB-1	PT-1	PT-1	PT-1	PT-1	CL-2	9'-0"	
133	BEDROOM	CP-4	RB-1	PT-1	PT-1	PT-1	PT-1	CL-2	9'-0"	
133A	CLOSET	CP-4	RB-1	PT-1	PT-1	PT-1	PT-1	CL-2	9'-0"	
133B	CLOSET	CP-4	RB-1	PT-1	PT-1	PT-1	PT-1	CL-2	9'-0"	
134	BEDROOM	CP-4	RB-1	PT-1	PT-1	PT-1	PT-1	CL-2	9'-0"	
134A	CLOSET	CP-4	RB-1	PT-1	PT-1	PT-1	PT-1	CL-2	9'-0"	
134B	CLOSET	CP-4	RB-1	PT-1	PT-1	PT-1	PT-1	CL-2	9'-0"	


DOOR SCHEDULE (NEW ADDITION)												
DOOR #	ROOM NAME	TYPE	DOOR						HARDWARE	FRAME		NOTES
			WIDTH	HEIGHT	THICKNESS	MATERIAL	FINISH	PTD.		TYPE	FINISH	
142	MECHANICAL RM.	D	6'-0"	7'-0"	1-3/4"	H.M.	PTD.	3	B	PTD.	SW#7675 "SEALSKIN"	
143	MEN'S RR	C	3'-0"	7'-0"	1-3/4"	WOOD	STAIN	4	A	PTD.		
145	JANITOR'S CLOSET	C	3'-0"	7'-0"	1-3/4"	WOOD	STAIN	5	A	PTD.		
146	BEDROOM 1	A	3'-0"	7'-0"	1-3/4"	WOOD	STAIN	6	A	PTD.		
147A	COMMON AREA	E	6'-0"	7'-0"	1-3/4"	ALUM.	TRANSPARENT	2	C	ALUM.		
147B	COMMON AREA	F	3'-0"	7'-0"	1-3/4"	ALUM.	TRANSPARENT	3	D	ALUM.		
148	CORRIDOR	F	3'-0"	7'-0"	1-3/4"	ALUM.	TRANSPARENT	3	D	ALUM.		
149	BEDROOM 3	A	3'-0"	7'-0"	1-3/4"	WOOD	STAIN	6	A	PTD.		
150	BEDROOM 5	A	3'-0"	7'-0"	1-3/4"	WOOD	STAIN	6	A	PTD.		
151	BEDROOM 7	A	3'-0"	7'-0"	1-3/4"	WOOD	STAIN	6	A	PTD.		
152	BEDROOM 8	A	3'-0"	7'-0"	1-3/4"	WOOD	STAIN	6	A	PTD.		
153	BEDROOM 6	A	3'-0"	7'-0"	1-3/4"	WOOD	STAIN	6	A	PTD.		
154	BEDROOM 4	A	3'-0"	7'-0"	1-3/4"	WOOD	STAIN	6	A	PTD.		
155	BEDROOM 2	A	3'-0"	7'-0"	1-3/4"	WOOD	STAIN	6	A	PTD.		
156	TELECOMM. RM.	C	3'-0"	7'-0"	1-3/4"	WOOD	STAIN	5	A	PTD.		
158	WOMAN'S RR	C	3'-0"	7'-0"	1-3/4"	WOOD	STAIN	4	A	PTD.		

DOOR SCHEDULE (BID OPTIONS - EXISTING FIRE STATION)												
DOOR #	ROOM NAME	TYPE	DOOR						HARDWARE	FRAME		NOTES
			WIDTH	HEIGHT	THICKNESS	MATERIAL	FINISH	PTD.		TYPE	FINISH	
129-1	BEDROOM	C	3'-0"	7'-0"	1-3/4"	WOOD	STAIN	6	A	PTD.		
129-1A	CLOSET	B	2'-0"	7'-0"	1-3/4"	WOOD	STAIN	7	E	PTD.		
129-1B	CLOSET	B	2'-0"	7'-0"	1-3/4"	WOOD	STAIN	7	E	PTD.		
129-2	BEDROOM	C	3'-0"	7'-0"	1-3/4"	WOOD	STAIN	6	A	PTD.		
129-2A	CLOSET	B	2'-0"	7'-0"	1-3/4"	WOOD	STAIN	7	E	PTD.		
129-2B	CLOSET	B	2'-0"	7'-0"	1-3/4"	WOOD	STAIN	7	E	PTD.		
130	MEN'S RR	C	3'-0"	7'-0"	1-3/4"	WOOD	STAIN	4	A	PTD.		
131-1	BEDROOM	C	3'-0"	7'-0"	1-3/4"	WOOD	STAIN	6	A	PTD.		
131-1A	CLOSET	B	2'-0"	7'-0"	1-3/4"	WOOD	STAIN	7	E	PTD.		
131-1B	CLOSET	B	2'-0"	7'-0"	1-3/4"	WOOD	STAIN	7	E	PTD.		
131-2	BEDROOM	C	3'-0"	7'-0"	1-3/4"	WOOD	STAIN	6	A	PTD.		
131-2A	CLOSET	B	2'-0"	7'-0"	1-3/4"	WOOD	STAIN	7	E	PTD.		
131-2B	CLOSET	B	2'-0"	7'-0"	1-3/4"	WOOD	STAIN	7	E	PTD.		
133-1	BEDROOM	C	3'-0"	7'-0"	1-3/4"	WOOD	STAIN	6	A	PTD.		
133-1A	CLOSET	B	2'-0"	7'-0"	1-3/4"	WOOD	STAIN	7	E	PTD.		
133-1B	CLOSET	B	2'-0"	7'-0"	1-3/4"	WOOD	STAIN	7	E	PTD.		
133-2	BEDROOM	C	3'-0"	7'-0"	1-3/4"	WOOD	STAIN	6	A	PTD.		
133-2A	CLOSET	B	2'-0"	7'-0"	1-3/4"	WOOD	STAIN	7	E	PTD.		
133-2B	CLOSET	B	2'-0"	7'-0"	1-3/4"	WOOD	STAIN	7	E	PTD.		
134	MEN'S RR	C	3'-0"	7'-0"	1-3/4"	WOOD	STAIN	4	A	PTD.		

DOOR SCHEDULE NOTES:

- 18 GA. GALV. HOLLOW MTL. DOORS & ALL DOOR FRAMES SHALL BE 16 GA. GALV. HOLLOW MTL FRAMES EQ. TO REPUBLIC BRAND DOORS AND FRAMES PER SDI-100.
- WOOD DOORS SHALL BE EQUAL TO MASONITE ARCHITECTURAL BRAND. REFERENCE NOTE #3 BELOW.
- INTERIOR DOORS SHALL BE STAIN GRAIN SOLID CORE WOOD DOORS AS SCHEDULED. SOLID CORE WOOD DOORS SHALL BE 5-PLY W/ 1-3/8" HARDWOOD STILES, MIN., 1-1/8" SOLID WOOD RAILS, MIN., 5" WIDE SOLID BLOCKING FOR HARDWARE AND STAVE CORES. ROTARY CUT BIRCH VENEER THROUGHOUT WITH UNIFORM COLOR AND GRAIN WITH NO SPLOTCHES LARGE OR SMALL.
- WHERE FLOORING MATERIAL CHANGES BETWEEN ROOMS, THE CHANGES SHALL OCCUR AT THE CENTERLINE OF THE DOOR PANEL.
- PROVIDE COMPLETE HARDWARE SCHEDULE OF ITEMS FOR REVIEW & APPROVAL PRIOR TO INSTALLATION.
- PROVIDE COMPLETE HARDWARE AND ACCESSORIES FOR ALL DOORS LISTED HEREON, PROVIDE A.D.A. COMPLIANT DOOR HANDLES THROUGHOUT ONLY. RE: CURRENT A.D.A. REQUIREMENTS FOR ALL HARDWARE CRITERIA.
- INCLUDE HARDWARE FOR ELECTRIC PANELS AS REQUIRED.

FINISH LEGEND OR APPROVED EQ.					
NAME	DESCRIPTION	MFR	MODEL/STYLE	COLOR/FINISH	REMARKS
<b>FLOORING</b>					
CN-1	POLISHED CONCRETE	-			
CP-1	CARPET TILE (FIELD)	SHAW	GRADIENT	COLORWAY: "ADRIFT" 34512 OR SIMILAR	24"x24" CARPET TILE, WARM GREY FINISH
CP-2	NOT USED				
CP-3	NOT USED				
CP-4	CARPET TILE (BEDROOM)	MANNINGTON	COLLECTION: DWELLING	COLORWAY: LIVELY	12' BROADLOOM, INSTALL WITH BACKING/CUSHION IN ACCORDANCE WITH SPECIFICATIONS AND MFR INSTRUCTIONS.
<b>BASE</b>					
RB-1	RUBBER BASE	TARKETT	4" RUBBER BASE	44 DARK BROWN	CONTINUOUS ROLLED GOODS
<b>CEILING</b>					
CL-1	24"x24" LAY-IN CEILING	ARMSTRONG CORP.	ARMSTRONG CIRRUSS #577 / 2'X2' / BEVELED REGULAR 9/16" OR SIMILAR	WHITE / 576	INSTALL AT HEIGHTS AS INDICATED.
CL-2	GYPSUM BOARD	-		PAINT PT-4 (BRIGHT CEILING WHITE) AS INDICATED	INSTALL AT HEIGHTS AS INDICATED.
<b>PAINT</b>					
PT-1	PAINT (FIELD)	SHERWIN WILLIAMS	EGGSHELL	SW#9856 WHITE SESAME	
PT-2	PAINT (ACCENT)	SHERWIN WILLIAMS	EGGSHELL	SW#9595 BRAINTREE	
PT-3	PAINT (DOOR FRAME)	SHERWIN WILLIAMS	OIL-BASED	SW#7675 SEALSKIN	
PT-4	PAINT (CEILING)	SHERWIN WILLIAMS	FLAT	SW#7007 CEILING BRIGHT WHITE	
<b>MILLWORK</b>					
PL-1	PLASTIC LAMINATE (MILLWORK)	WILSONART	HD HIGH PRESSURE LAMINATE	EMPIRE MOHAGANY 7122	
SS-1	SOLID SURFACE COUNTERTOP	WILSONART	QUARTZ. 3CM THICK U.N.O	VICENTIA Q4063	
<b>TILE</b>					
TL-1	PORCELAIN FLOOR TILE	DALTILE	FABRIC ART / 24X24	MODERN LINEAR TAUPE ML62	
TL-2	PORCELAIN WALL TILE	DALTILE	FABRIC ART / 12X24	MODERN LINEAR TAUPE ML62	HORIZONTAL STACK BOND
<b>SPECIALTY</b>					
GR-1	GROUT	Bostick	TRUCOLOR RAPID CURE	H145 MOBE PEARL	
TR-1	CARPET TO TILE	SCHLUTER	RENO-TK	ANODIZED ALUMINUM	PROVIDE AT ALL TERMINATION POINTS WHERE APPLICABLE
TR-2	CARPET TO POLISHED CONCR.	MANNINGTON	UNIVERSAL REDUCER STRIP #146	BLACK #701	PROVIDE AT ALL TERMINATION POINTS WHERE APPLICABLE
TR-3	METAL TILE TRIM (COVE)	SCHLUTER	DILEX-AHK	ANODIZED ALUMINUM	PROVIDE AT ALL TERMINATION POINTS WHERE APPLICABLE
TR-4	METAL TILE TRIM	SCHLUTER	RENO-TK	ANODIZED ALUMINUM	PROVIDE AT ALL TERMINATION POINTS WHERE APPLICABLE
FRP-1	FIBERGLASS REINFORCED PLASTIC	CRANE COMPOSITES	GLASBOARD	PEBBLED / EMBOSSED	4'X8' SHEET
SP-1	SOLID PLASTIC PARTITIONS	SCRANTON PRODUCTS	HINY HIDERS TOILET PARTITIONS	GLACIER GREY / ORANGE PEEL FINISH	
CG-1	CORNER GUARDS	INPRO	ALUMINUM CORNER GUARD	1-1/2"x1-1/2" CLEAR ANODIZED ALUMINUM FINISH	SURFACE MOUNT IAW MFR INSTRUCTIONS

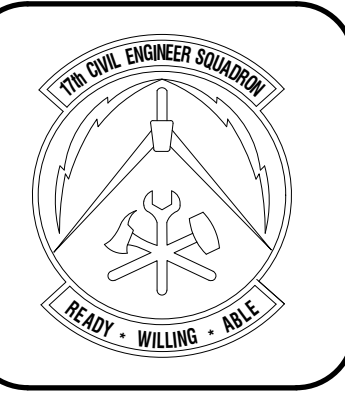







REVISIONS	DATE

DESIGNED BY	DRAWN BY	REVIEWED BY	SUBMITTED BY
J.H.WILLIAMS	J.H.WILLIAMS	RTI/AH	PCES

FIRE STATION ADD/ALTER, B3321  
 PROJECT NO. 1039839  
 17th TRAINING WING  
 GOODFELLOW AIR FORCE BASE, TEXAS

Project Number:	1039839
SHEET TITLE:	FINISHES AND SCHEDULES
Date:	JAN 2024



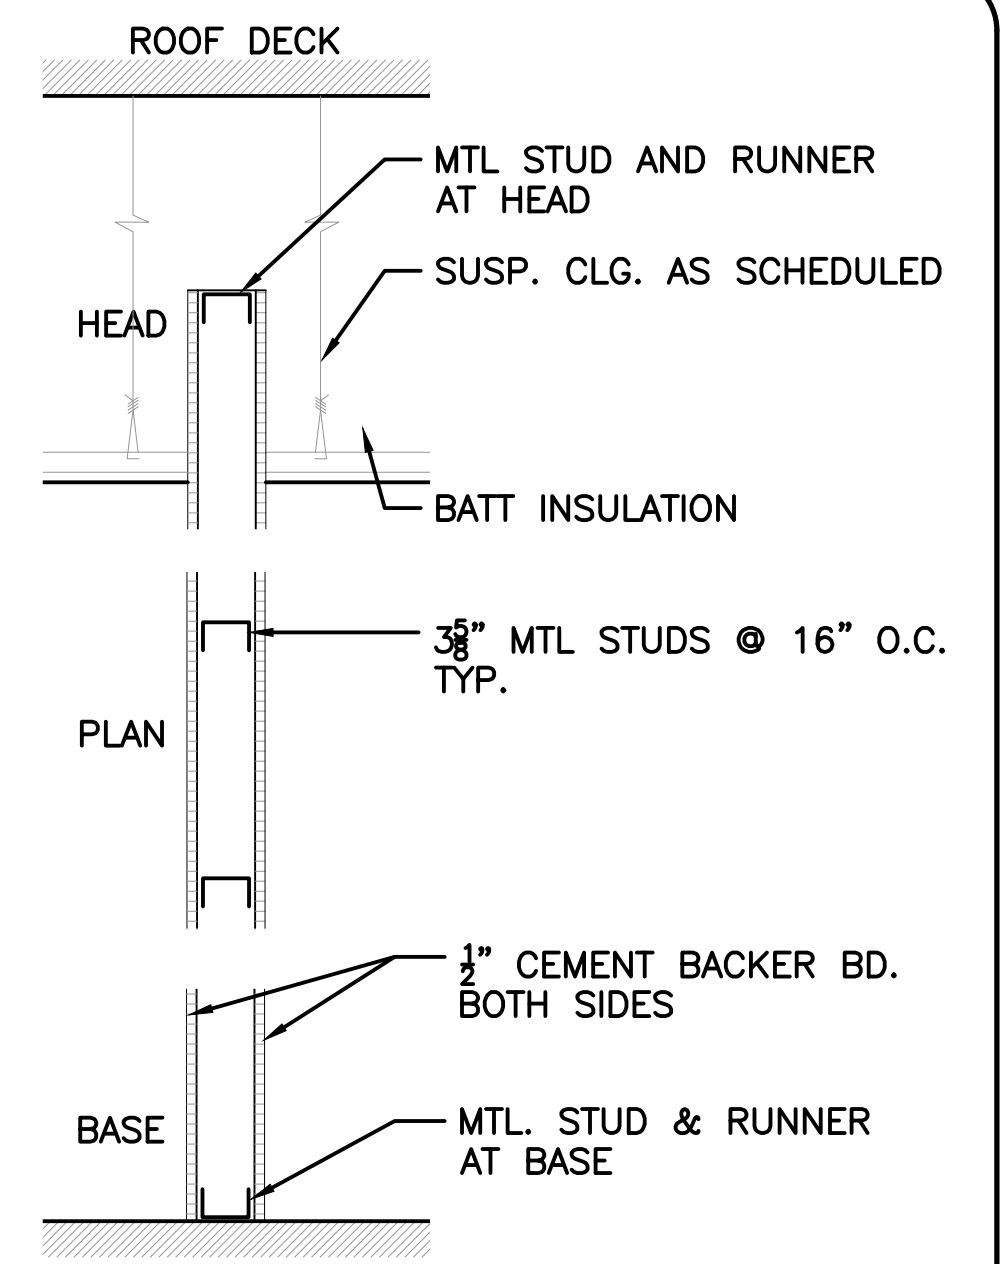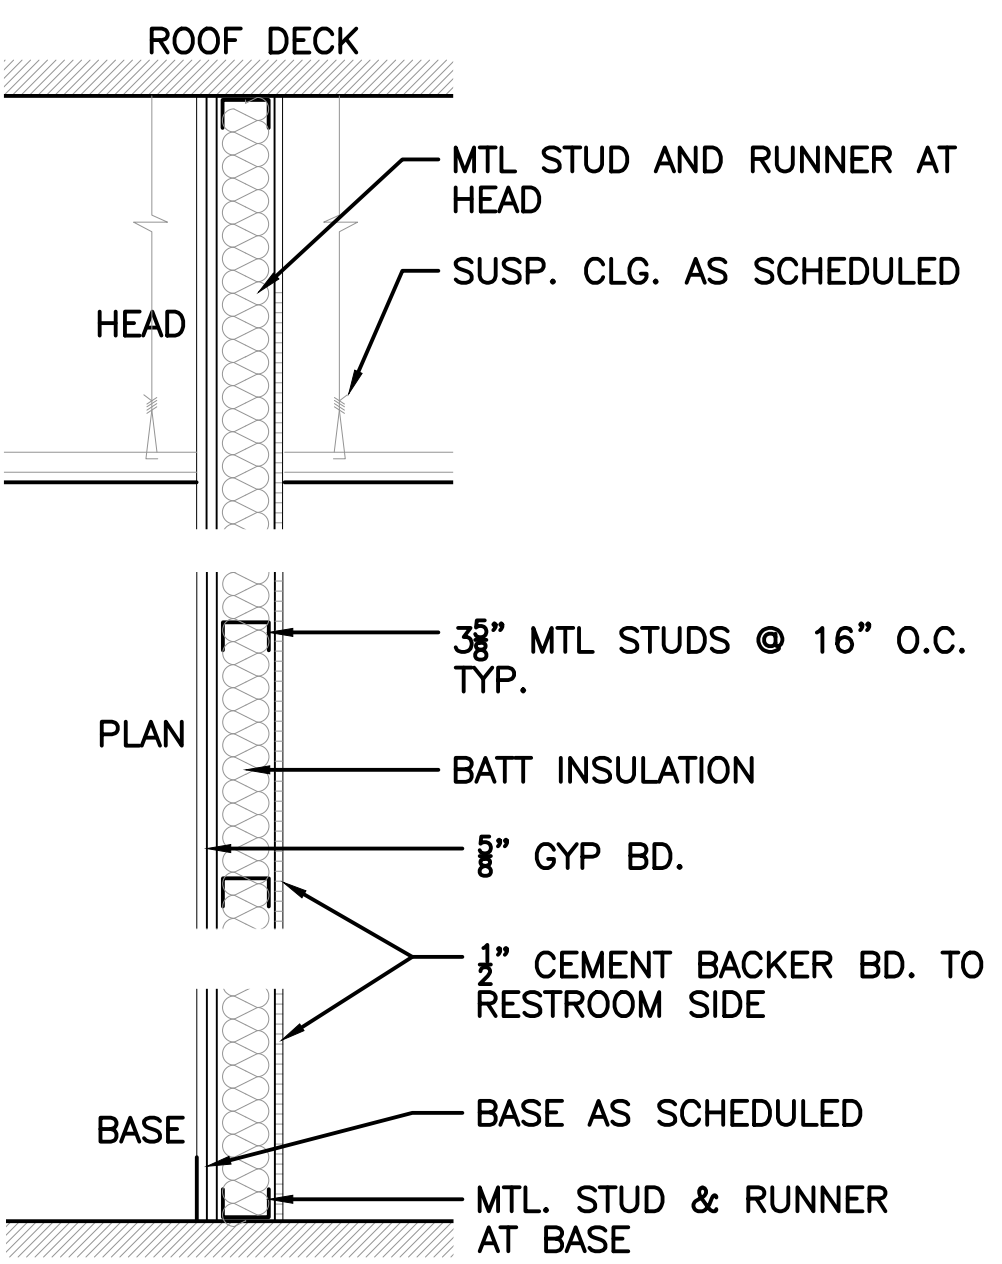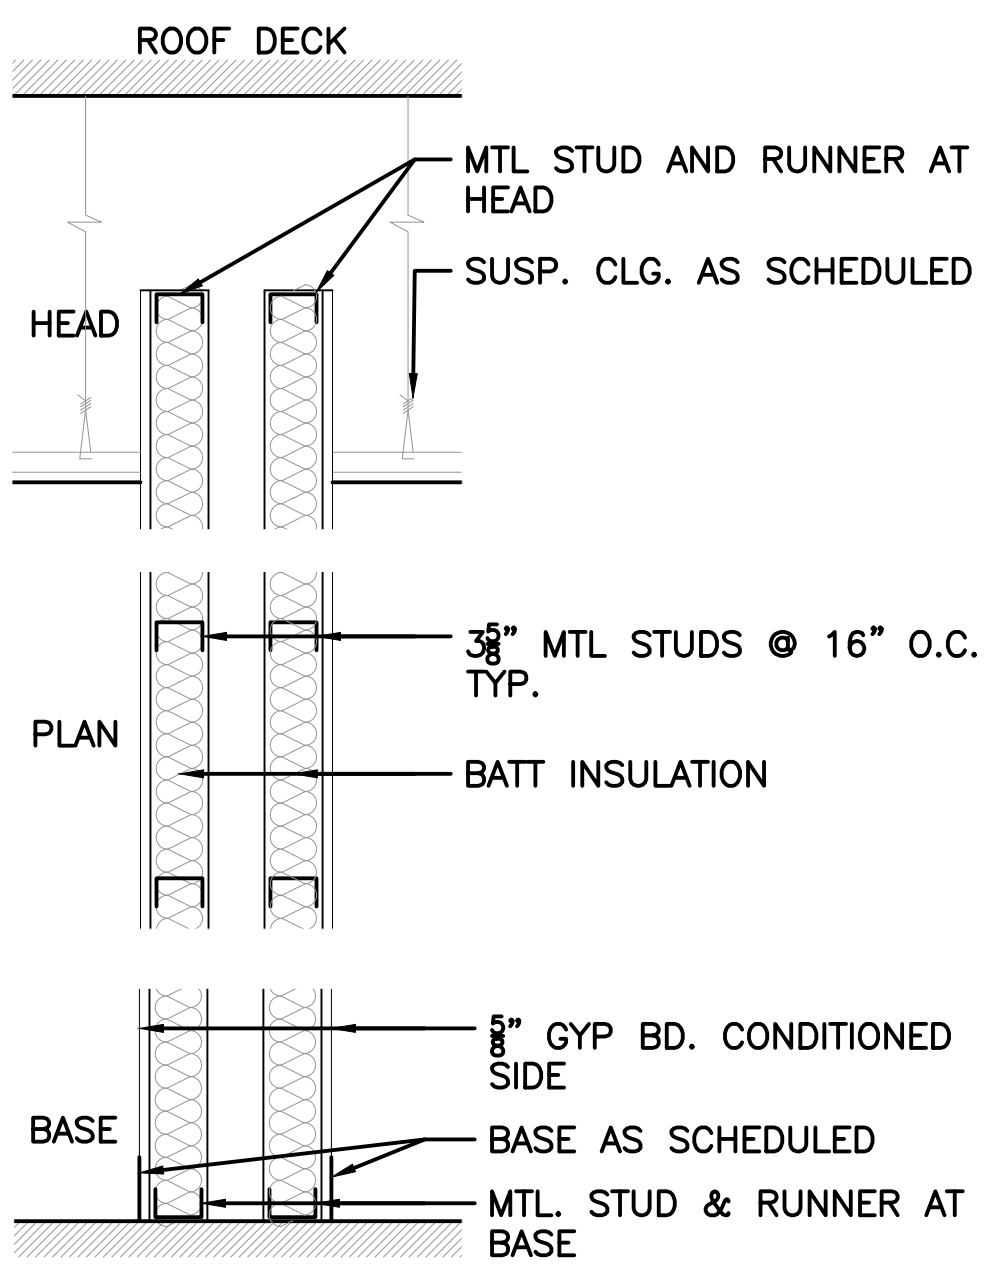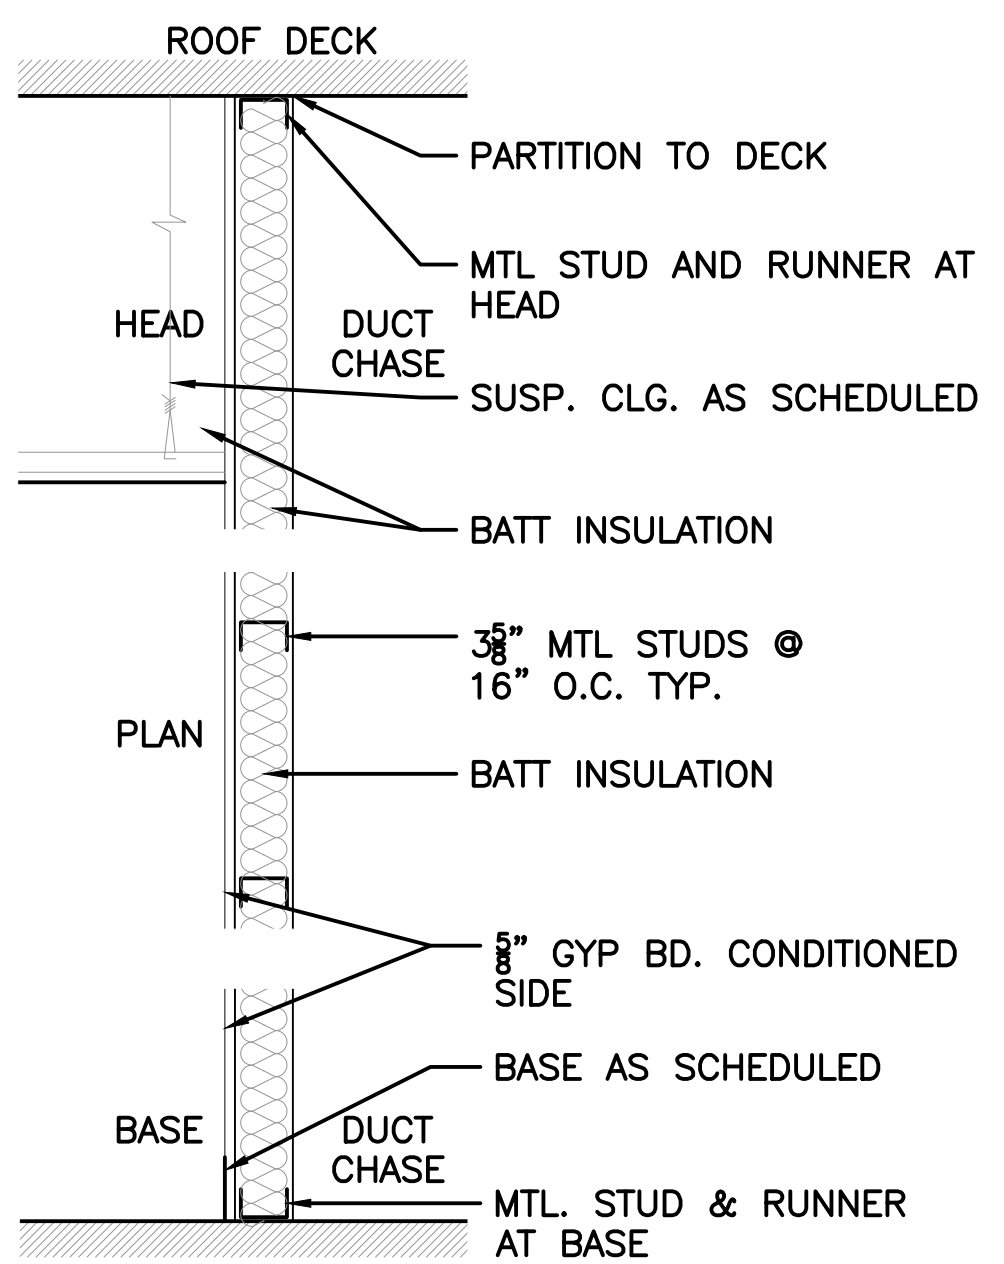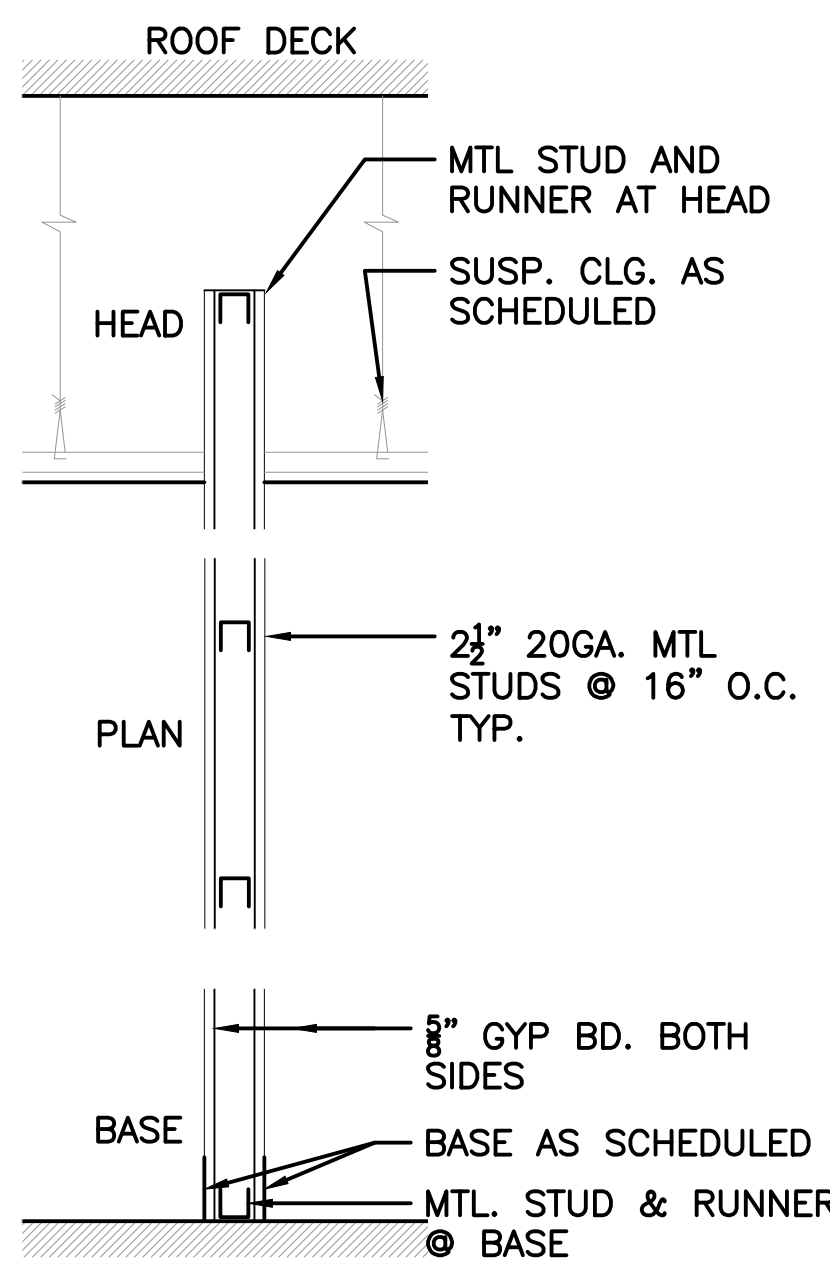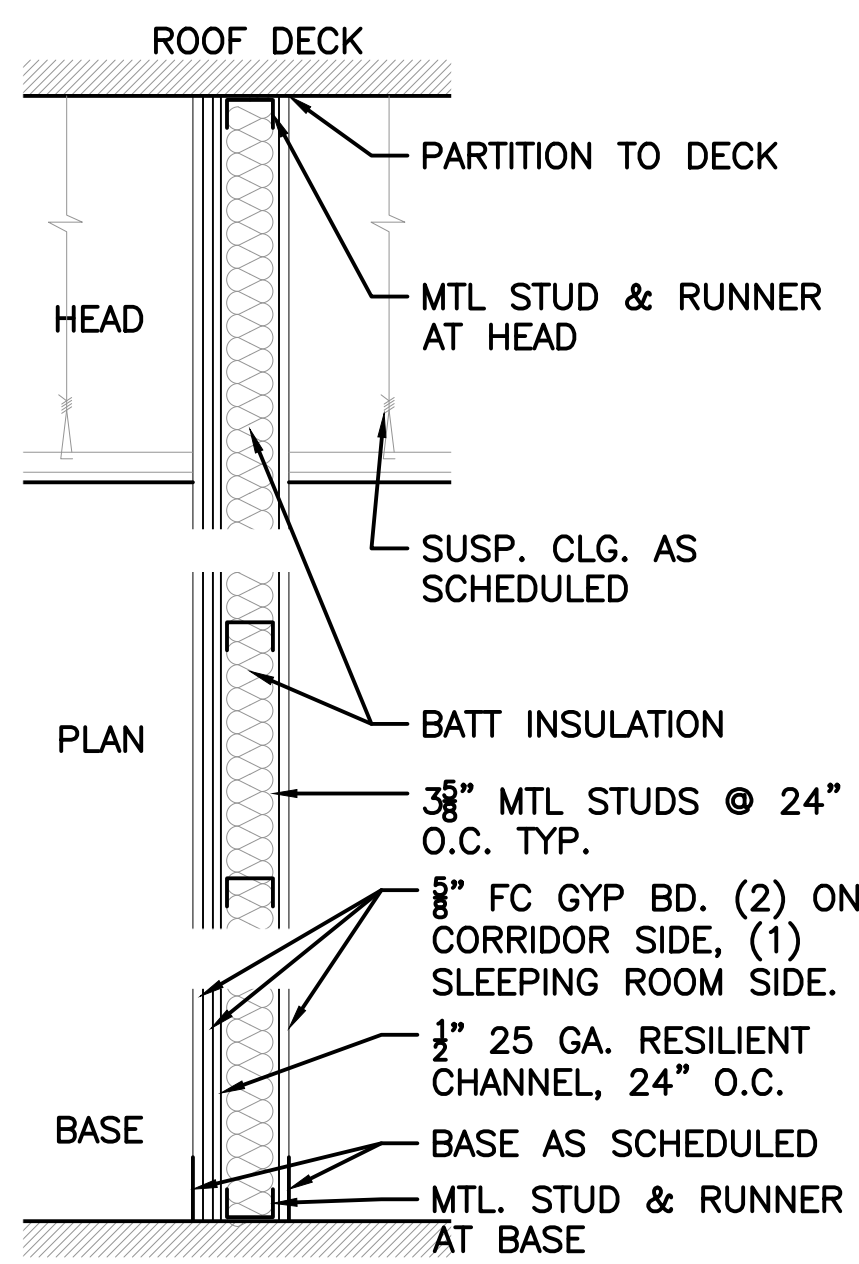

NOTE: 1A - BID OPTION PARTITIONS TO MATCH HEIGHT OF EXISTING PARTITIONS.

NOTE: SLEEPING AREA / CORRIDORS 1HR RATED WALL ASSEMBLY SEALED TO DECK. FIRESTOP ALL PENETRATIONS.


NOTE: CLOSET PARTITIONS 1HR RATED WALL ASSEMBLY. SEAL TO DECK. FIRESTOP ALL PENETRATIONS.

NOTE: RESTROOM CHASE 1HR RATED WALL ASSEMBLY. SEAL TO DECK. FIRESTOP ALL PENETRATIONS.

NOTE: RESTROOM PARTITIONS 6A: PARTITIONS ONLY RECEIVE BACKER BD. AND TILE FINISH ON RESTROOM SIDE.


1 PARTITION TYPES  
1" = 1' - 0"

NOTE: REFER TO A/401 FOR PARTITION HEAD DTLS. AND SUSP. CLG. SUPPORT DTLS.

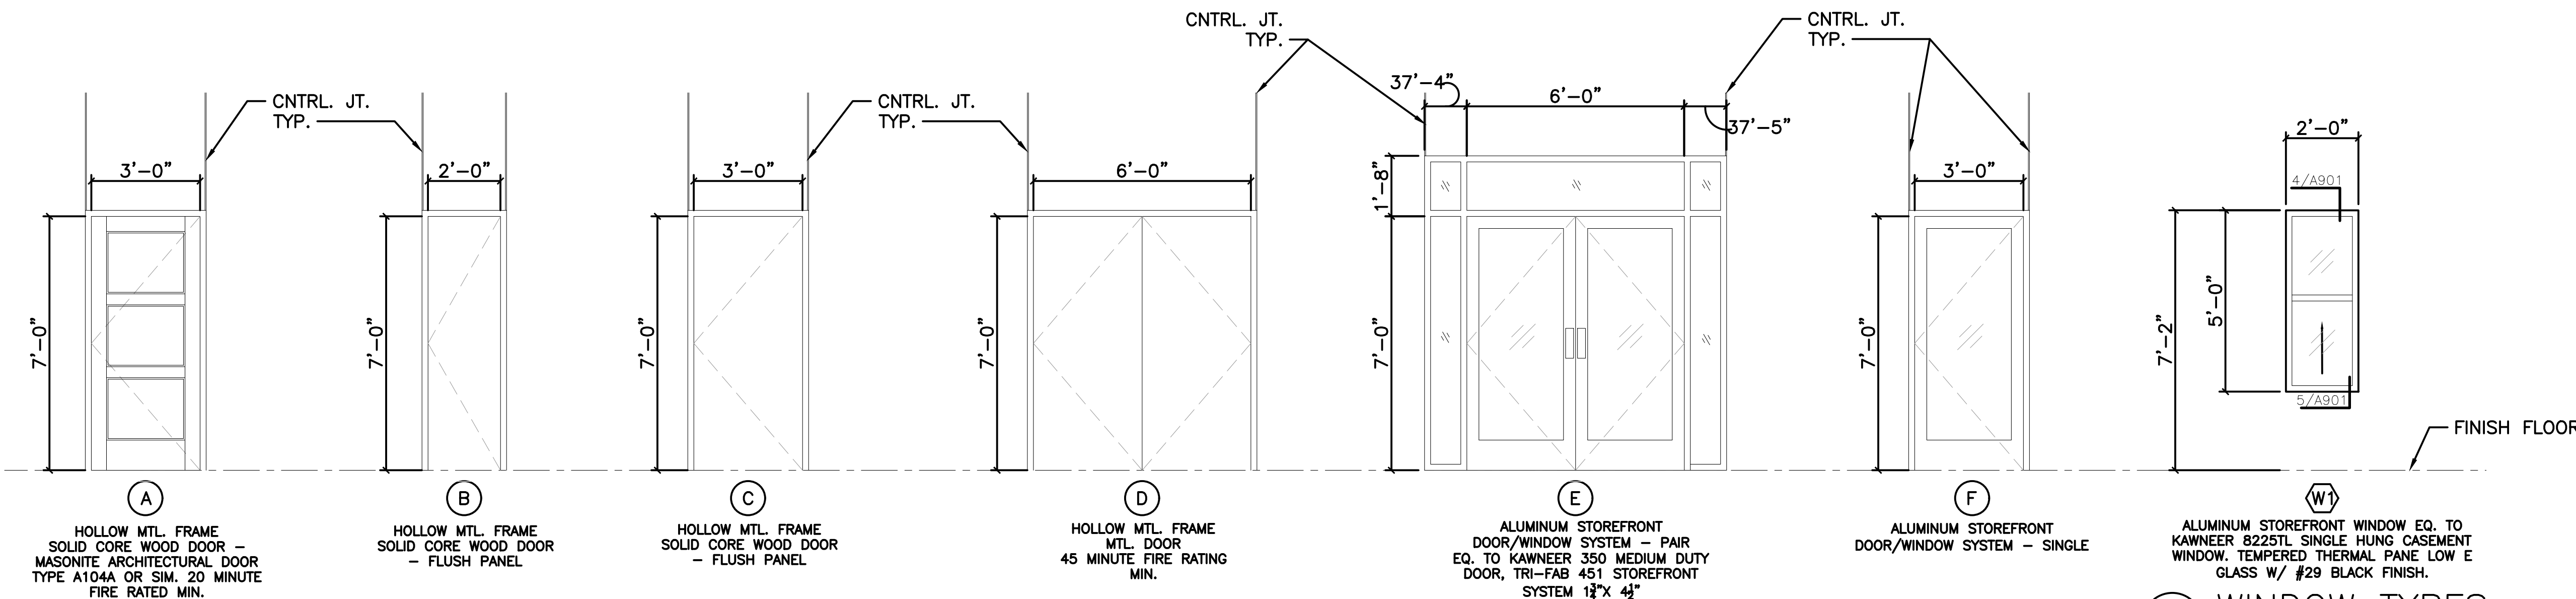


2 DOOR TYPES  
3/8" = 1' - 0"


3 WINDOW TYPES  
3/8" = 1' - 0"

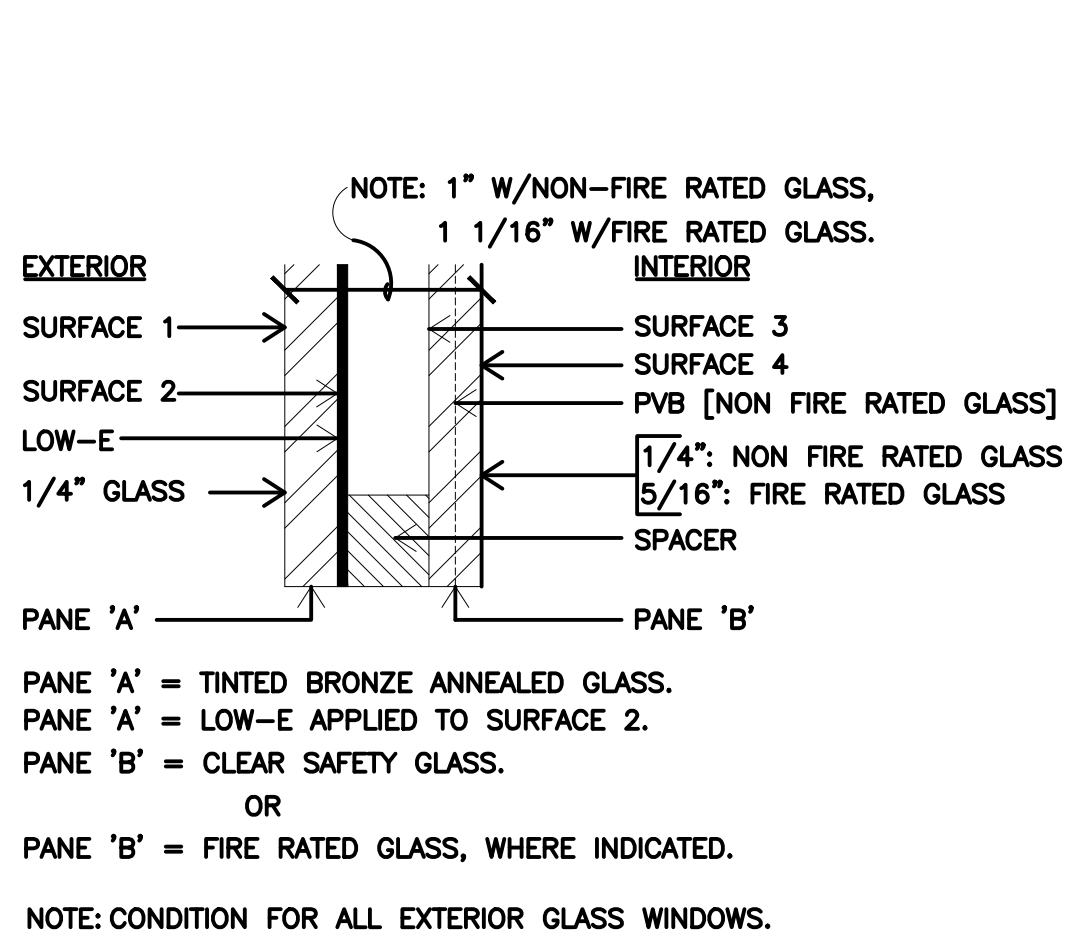


4 LOW "E" GLASS  
NTS

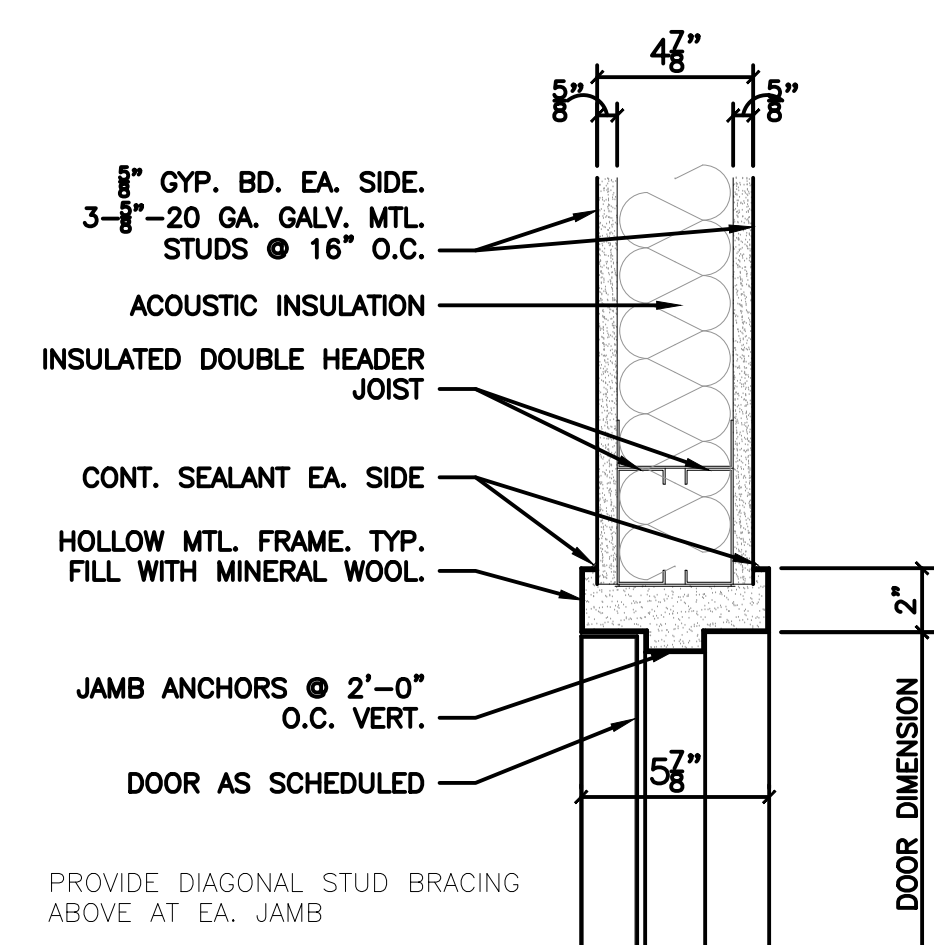


5 INT. DOOR HEAD  
SCALE: 1 1/2" = 1'-0"

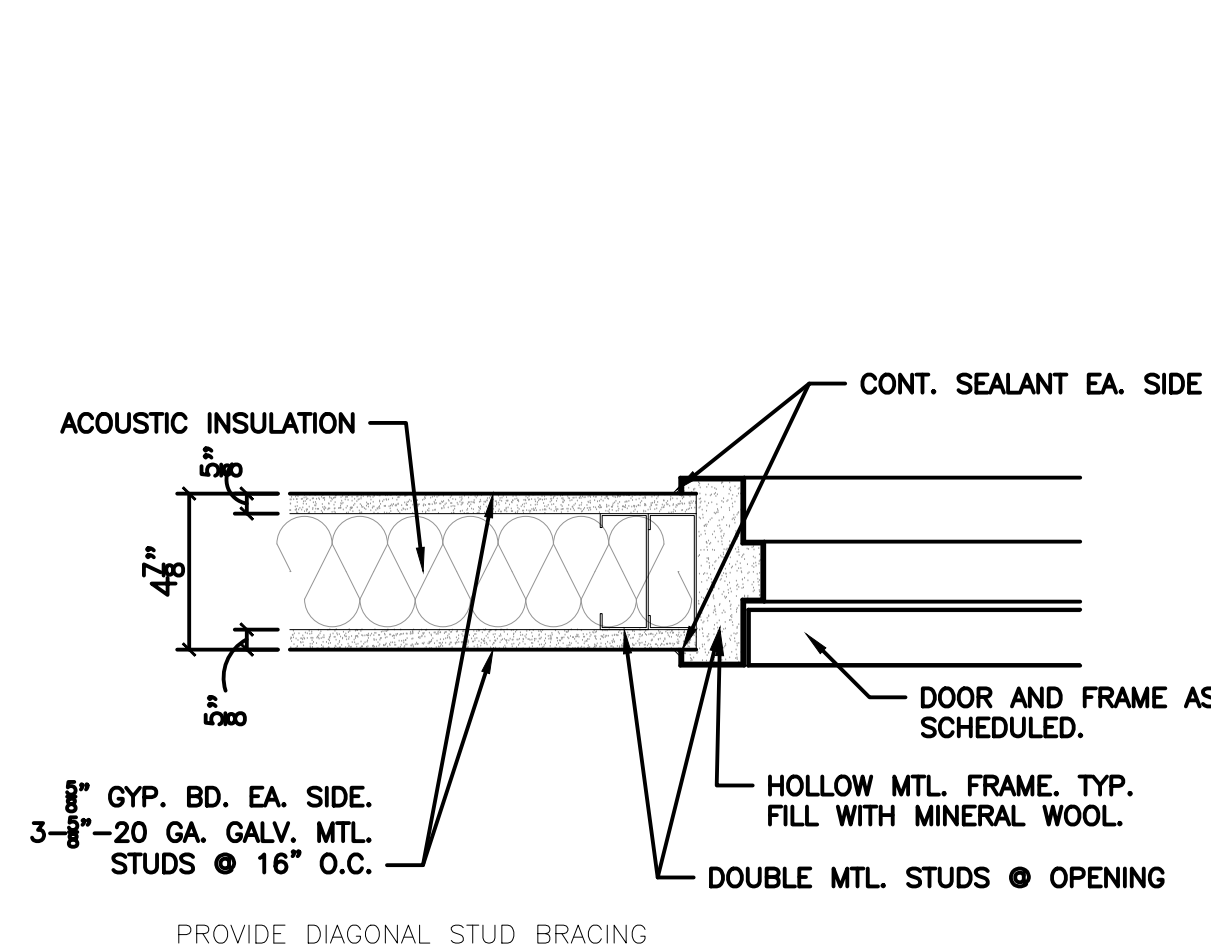


6 INT. DOOR JAMB  
SCALE: 1 1/2" = 1'-0"

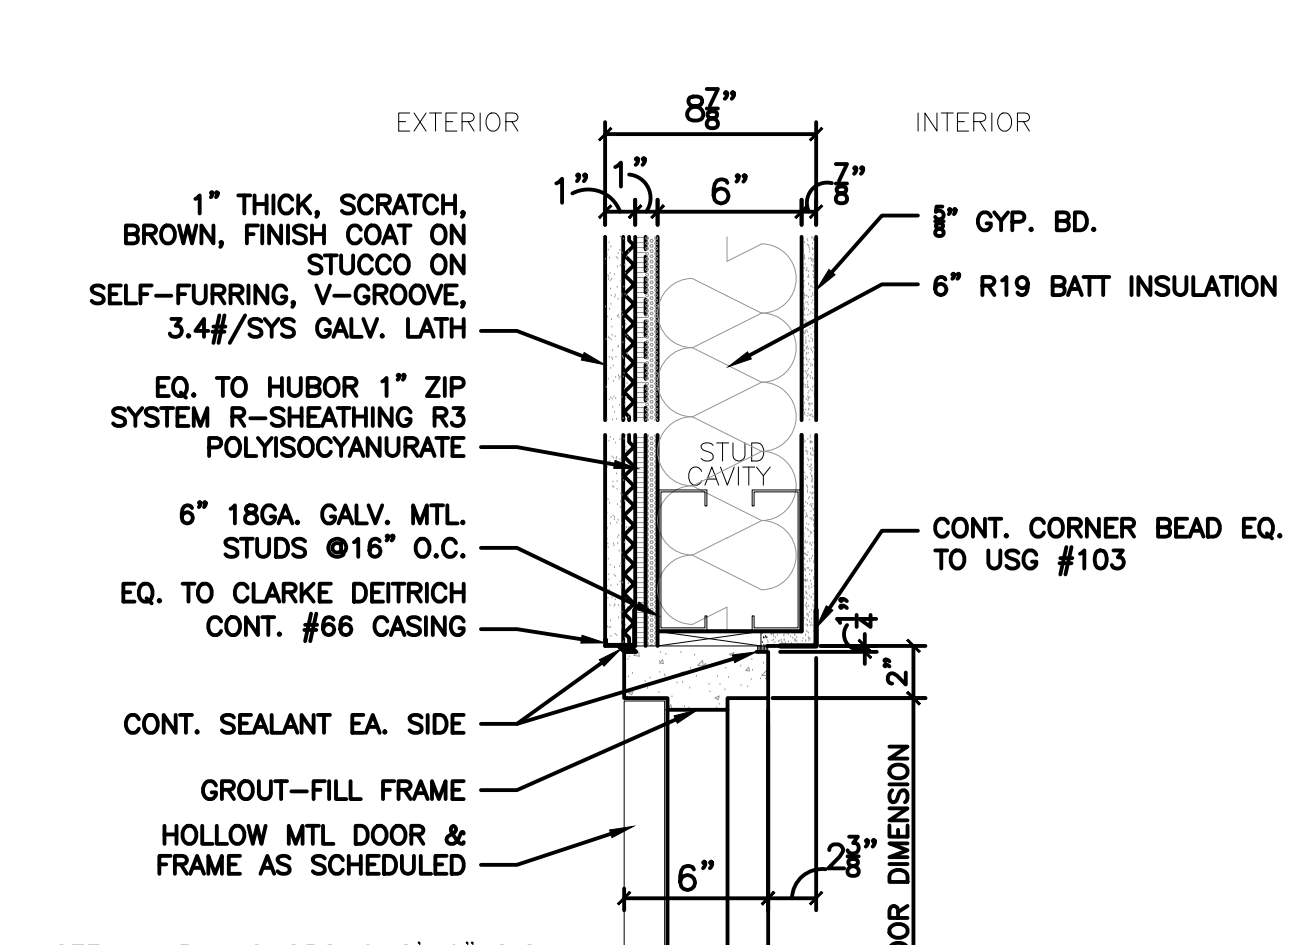

7 EXT. DOOR HEAD  
JAMB SIM.  
SCALE: 1 1/2" = 1'-0"

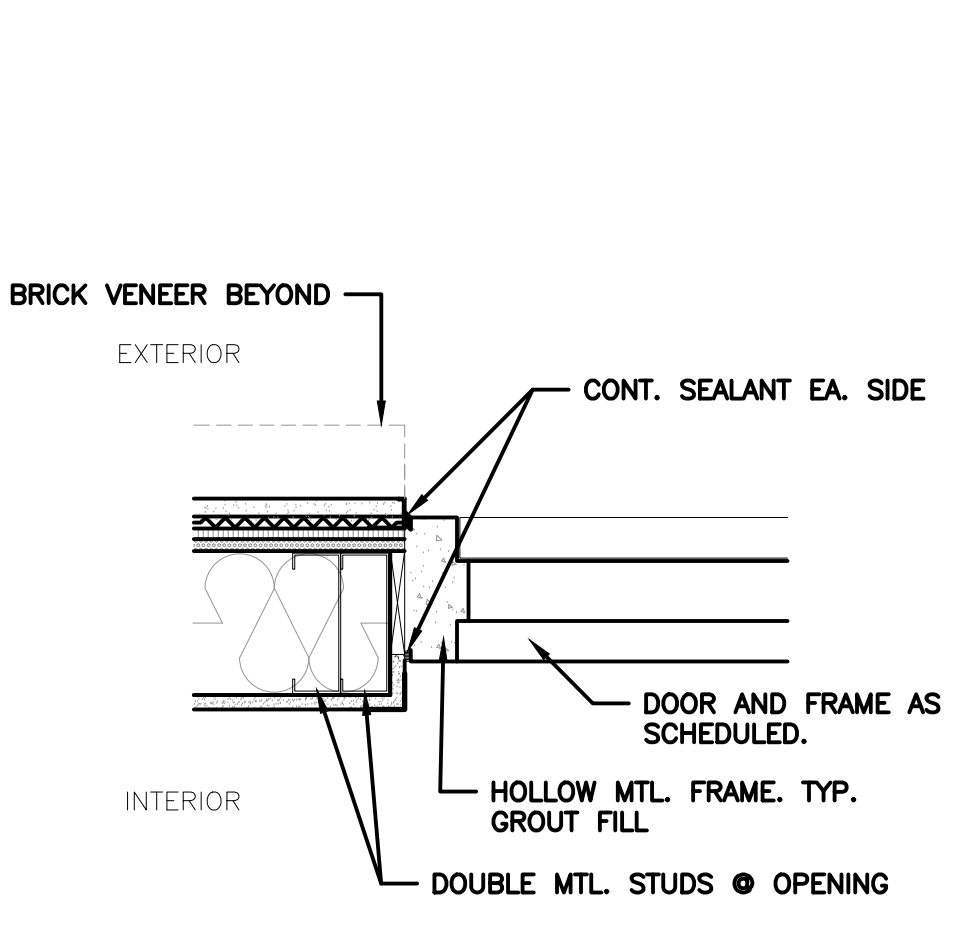

8 EXT. DOOR JAMB  
SCALE: 1 1/2" = 1'-0"

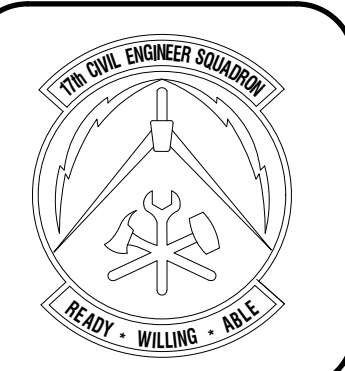


DATE	REVISIONS

Designed by JRM/MLA	Checked by JRM/MLA	Reviewed by RTJ/JH	Submitted by PCBS
------------------------	-----------------------	-----------------------	----------------------


PROJECT TITLE  
**FIRE STATION ADD/ALTER, B3321**  
**PROJECT NO. 1039839**  
**17th TRAINING WING**  
**GOODFELLOW AIR FORCE BASE, TEXAS**

Project Number: 1039839
SHEET TITLE DOORS, WINDOWS, AND PARTITION TYPES
Date: JAN 2024


SEQ.	SHEET	OF
28	A-802	50

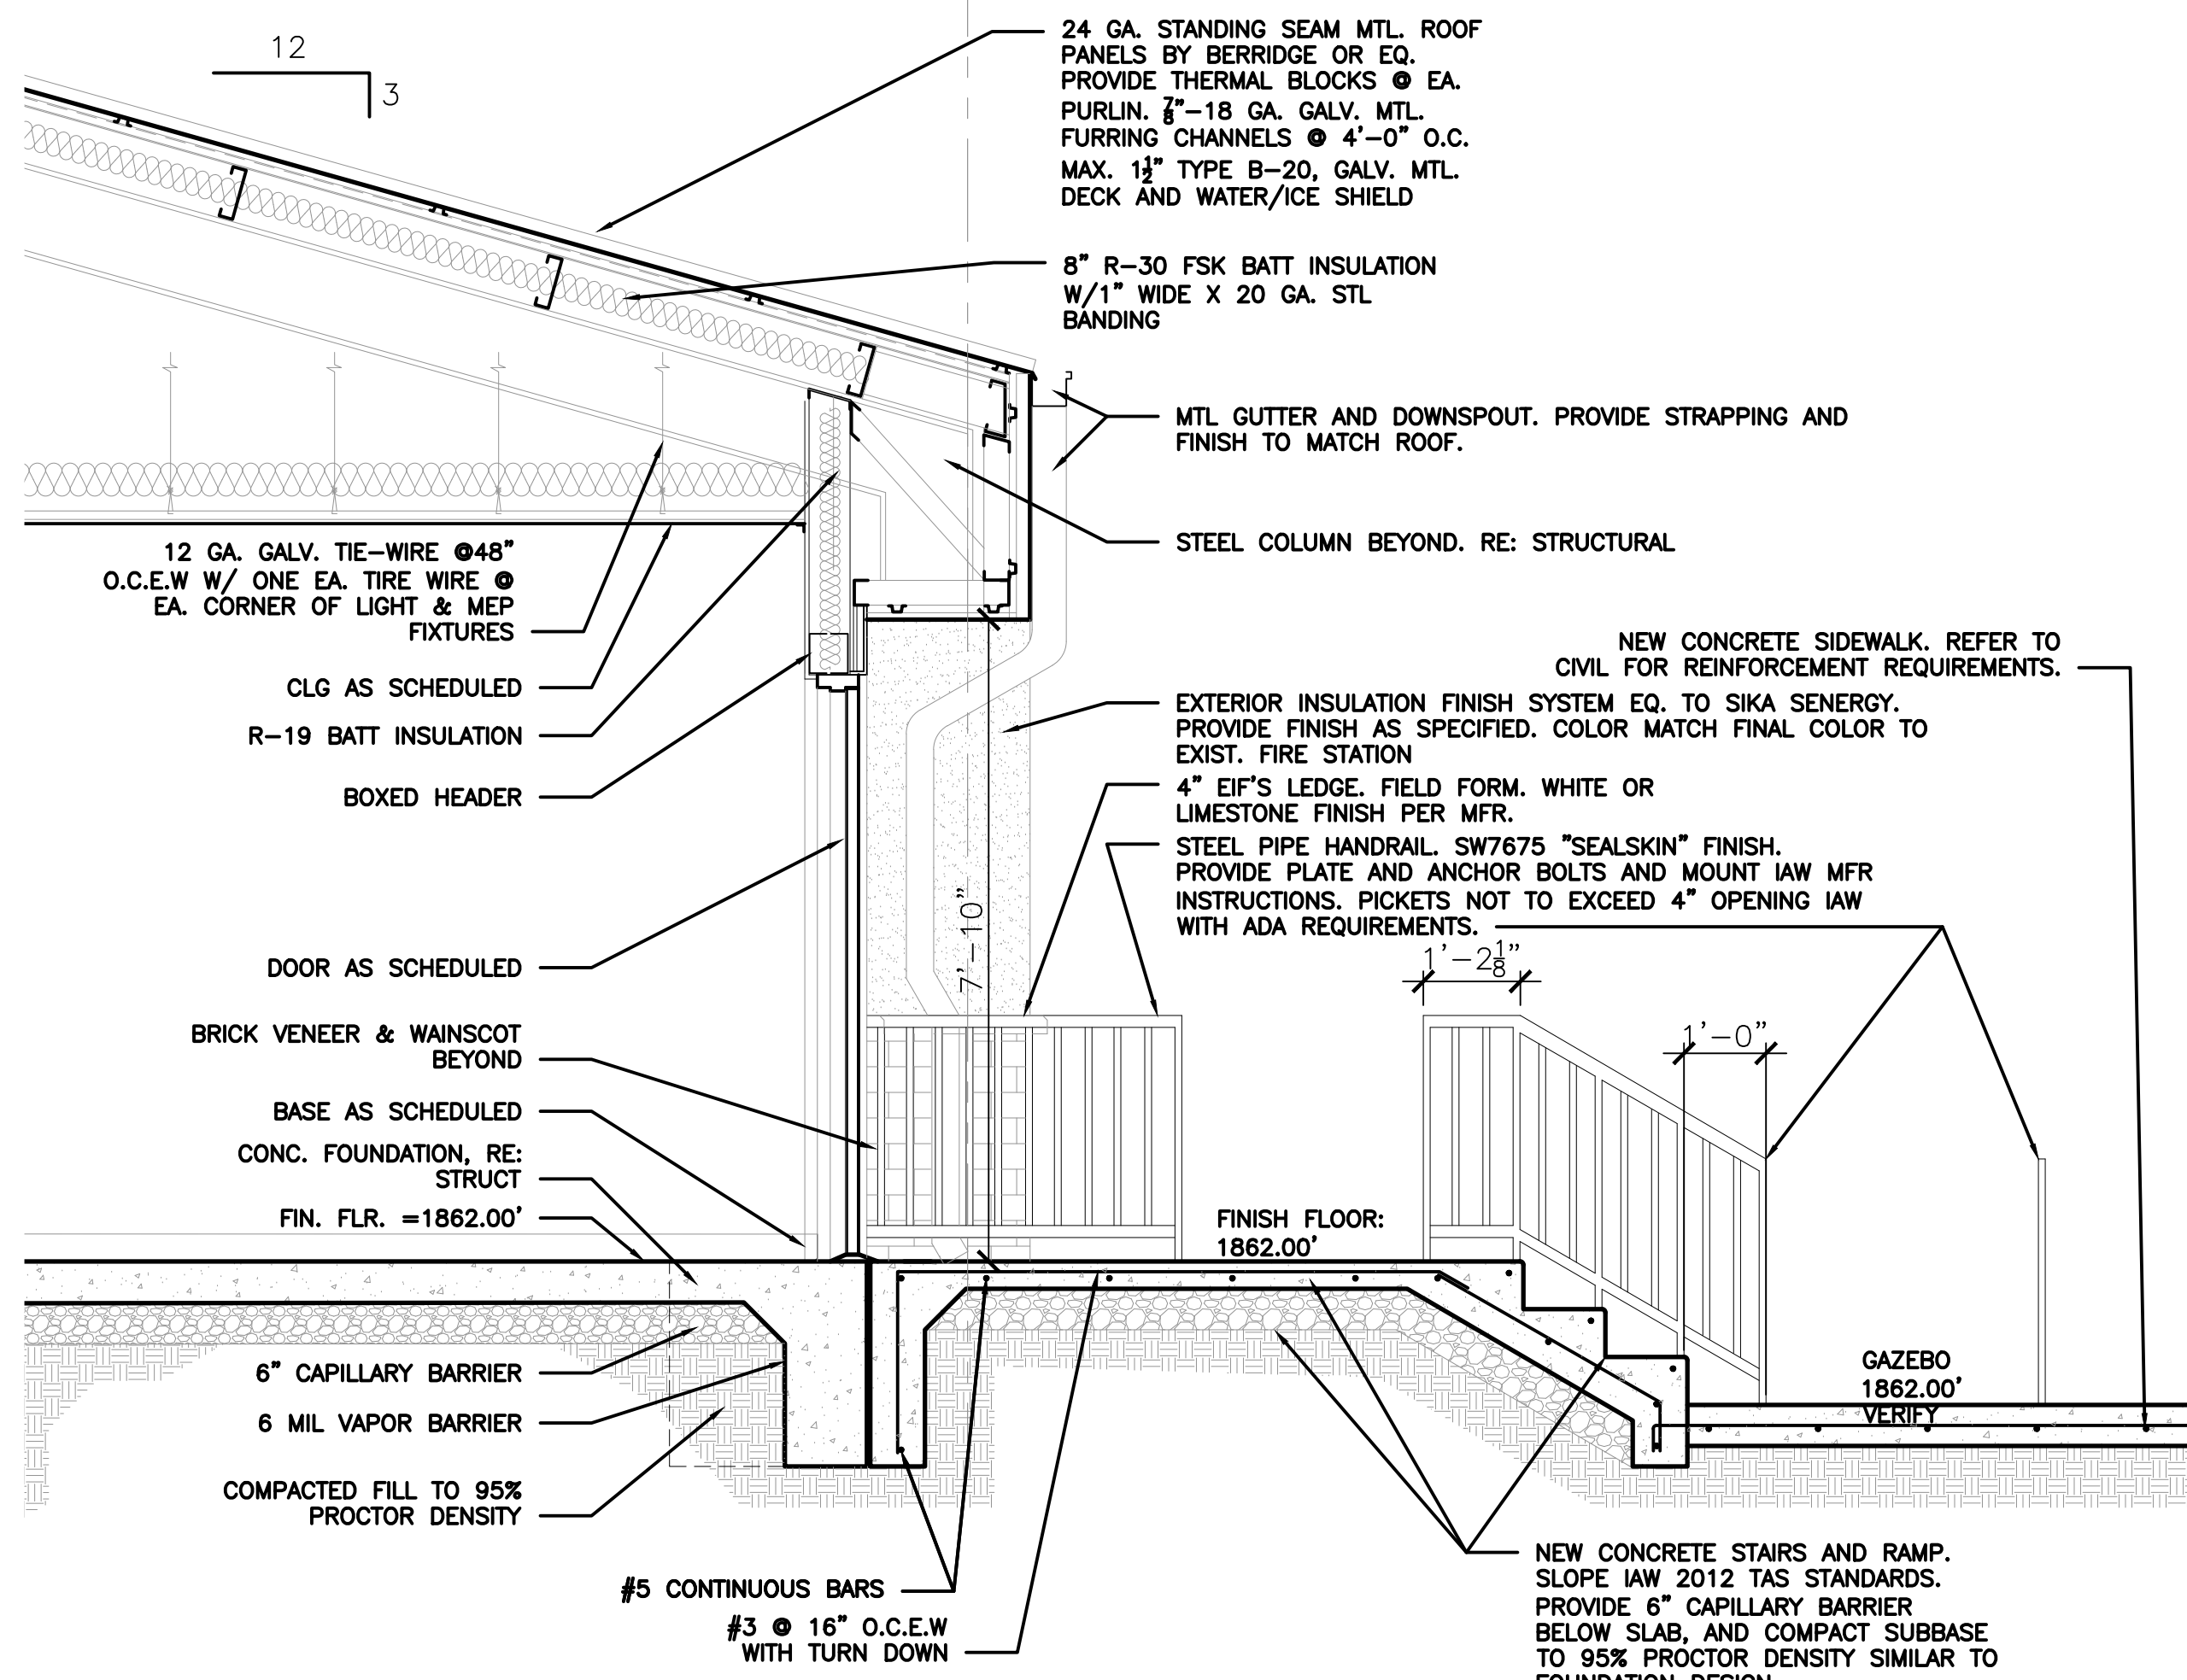


1 WALL SECTION-THRU DOOR  
1/2" = 1' - 0"

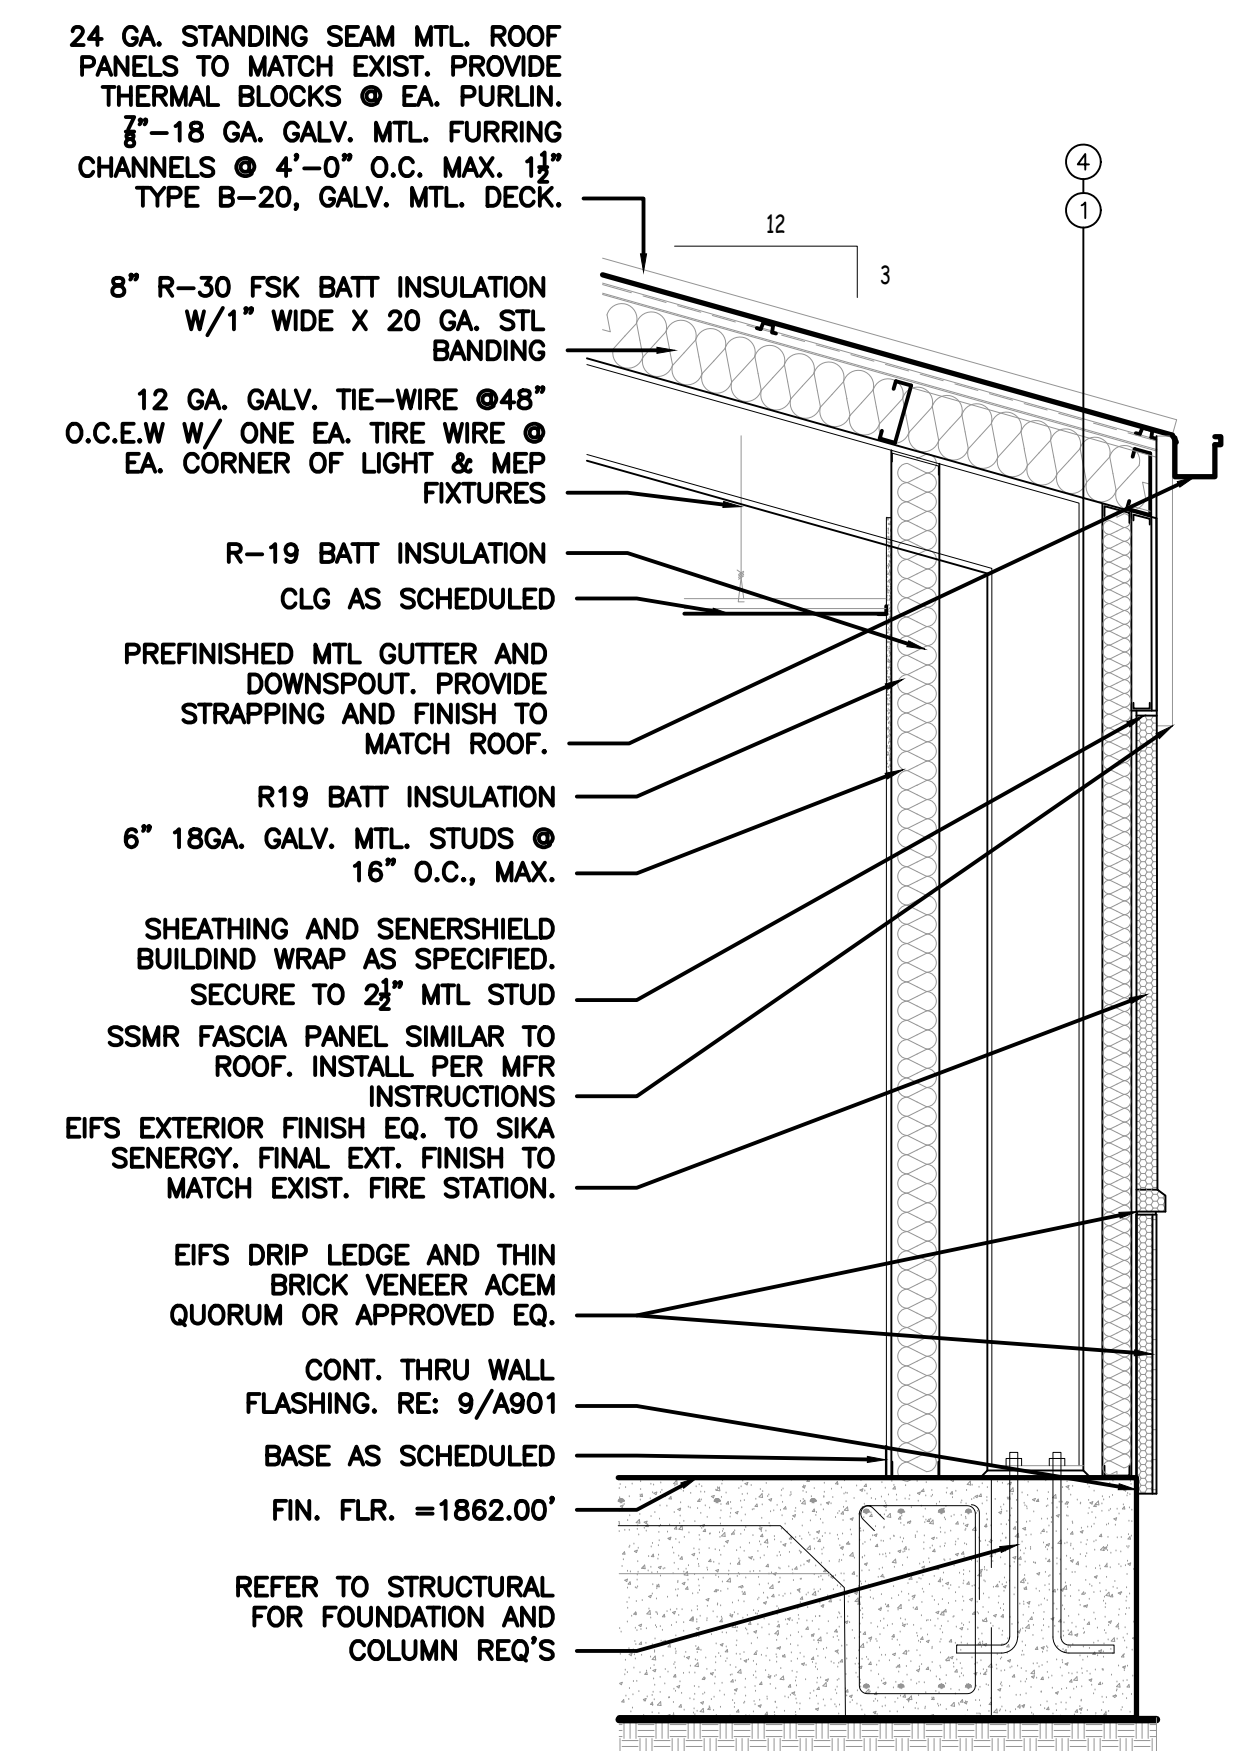


3 WALL SECTION-THRU COLUMN  
1/2" = 1' - 0"

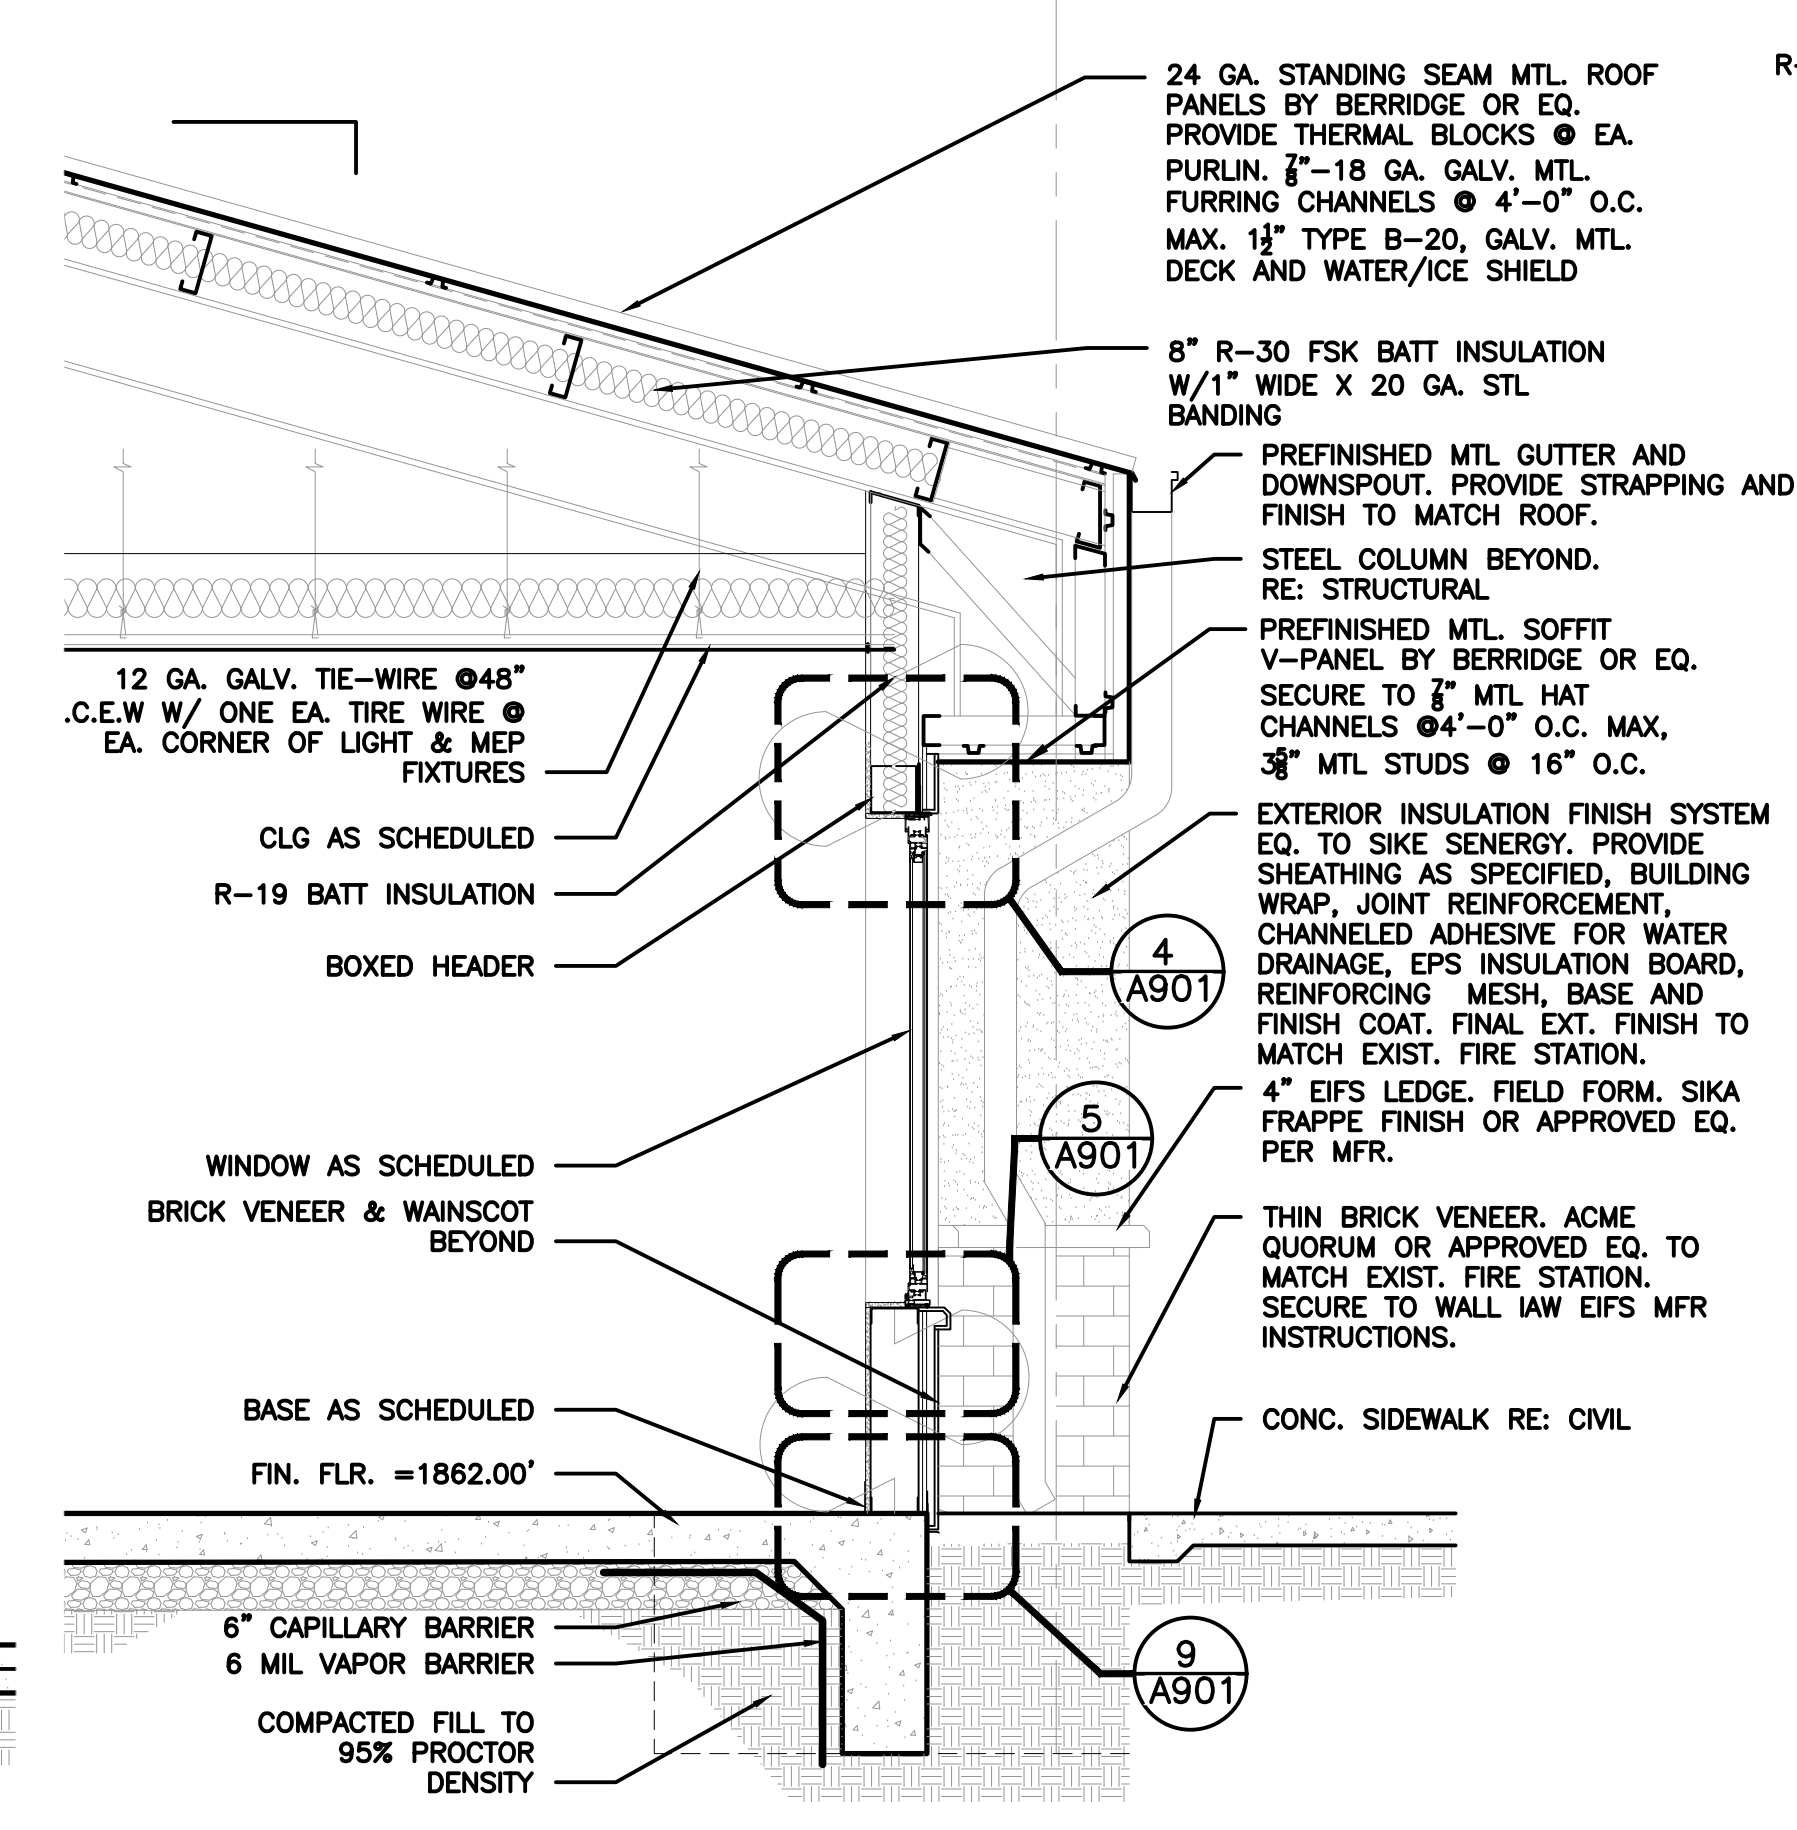


2 WALL SECTION-THRU WINDOW  
1/2" = 1' - 0"

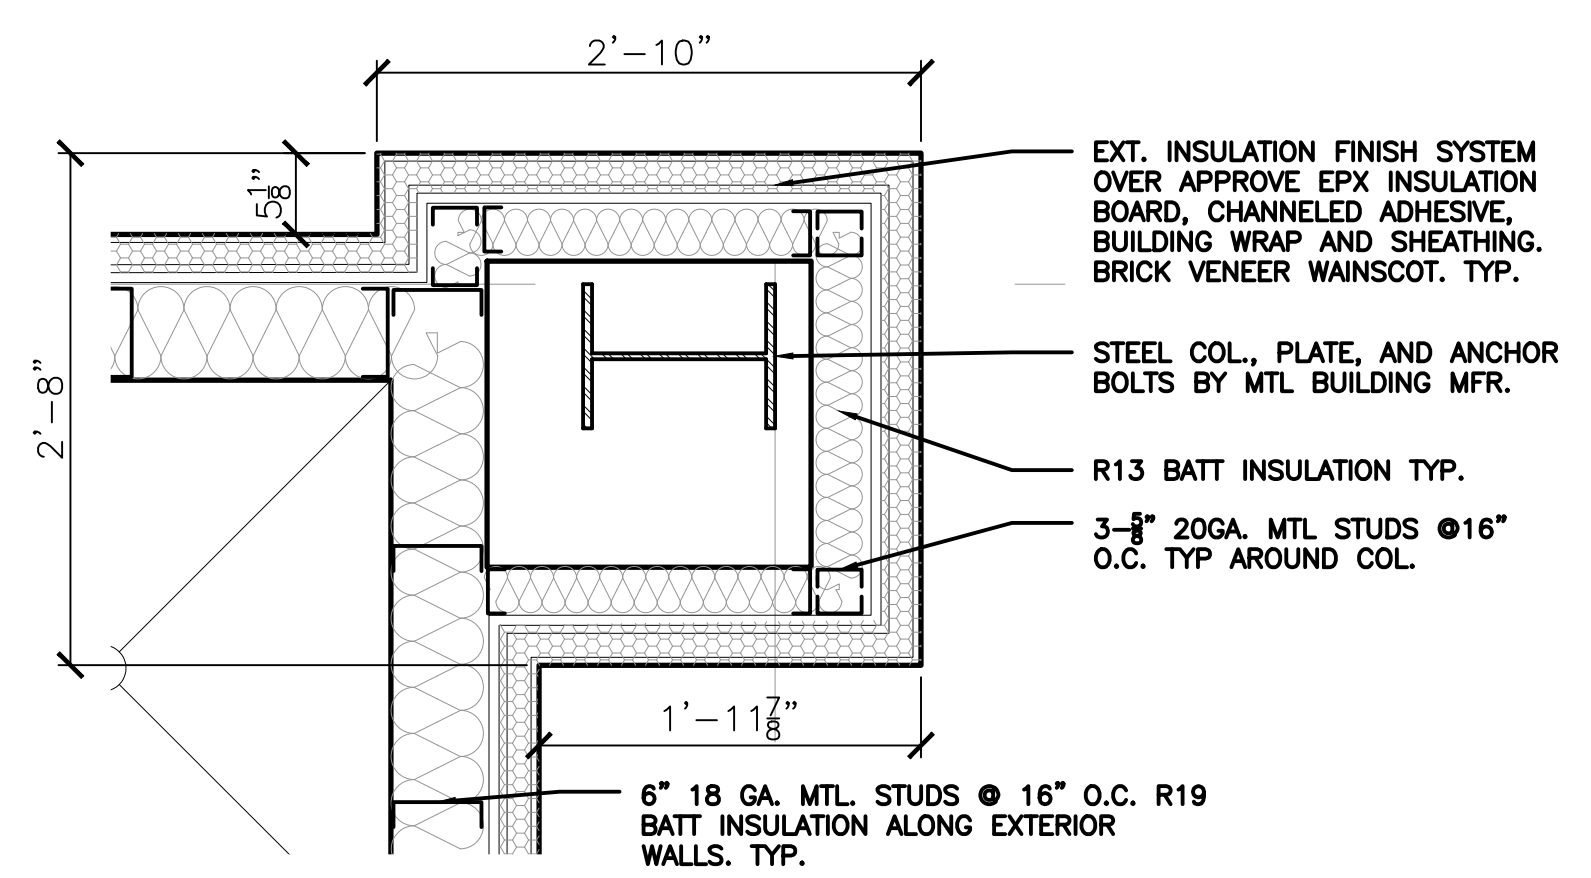


6 COL. FURRING DTL. - CORNER  
1" = 1' - 0"

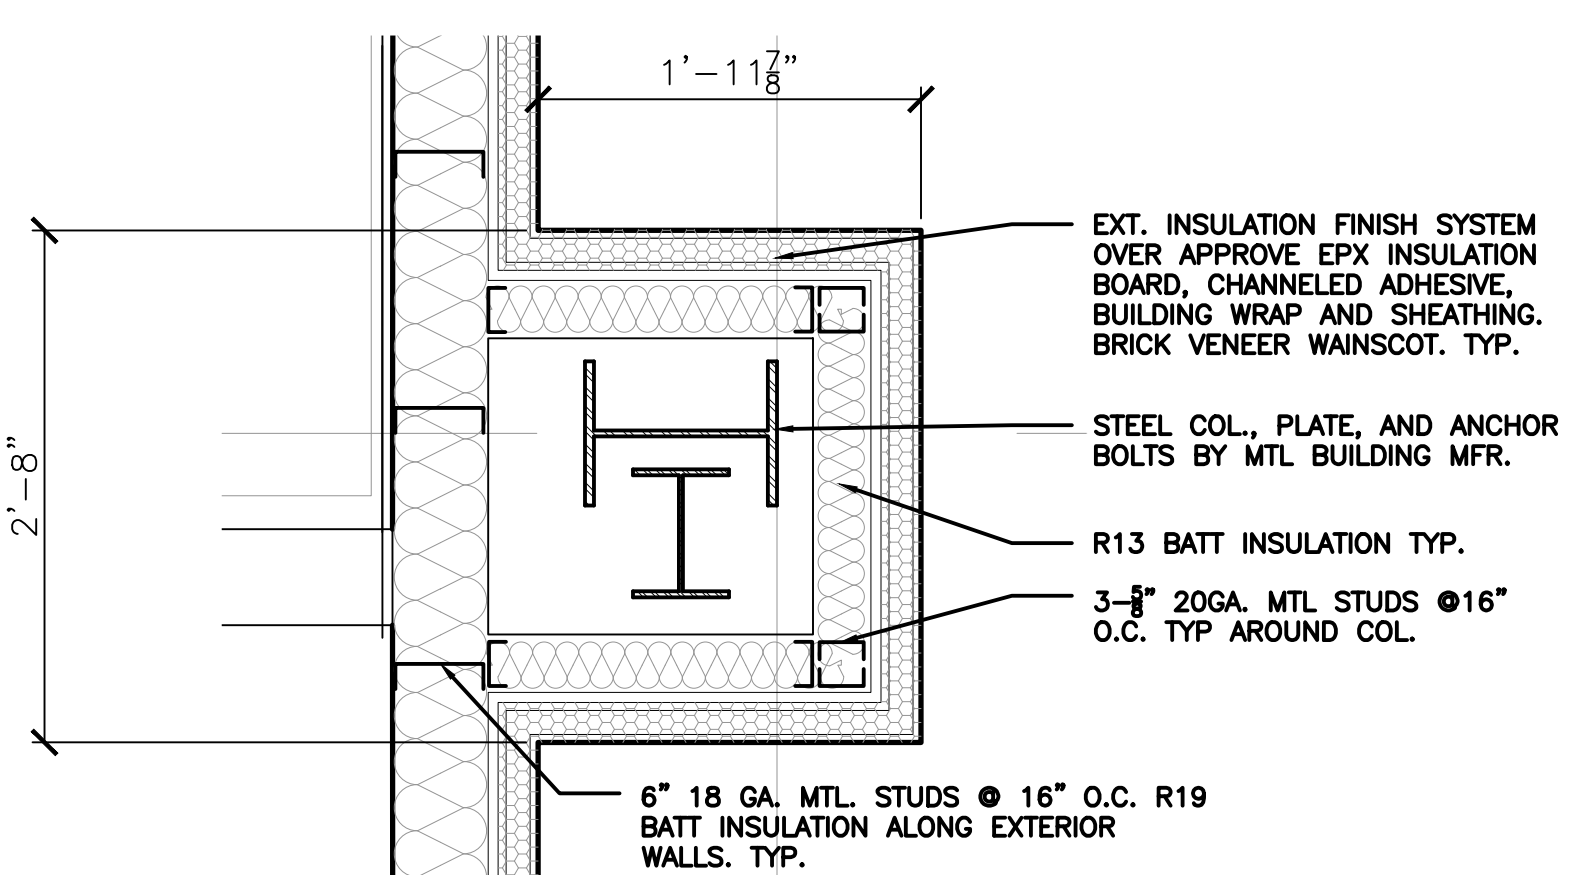


7 COL. FURRING DTL.-MIDDLE  
3/8" = 1' - 0"

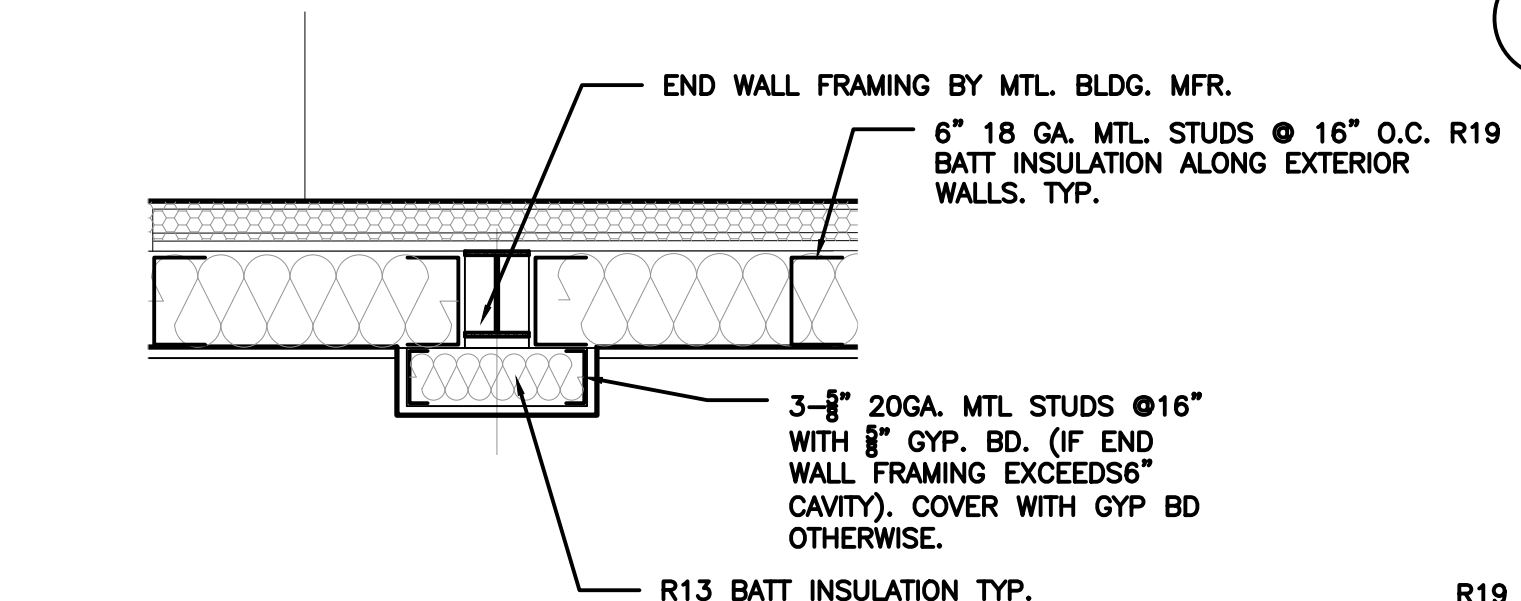


8 COL. FURRING DTL.-END WALL  
3/8" = 1' - 0"

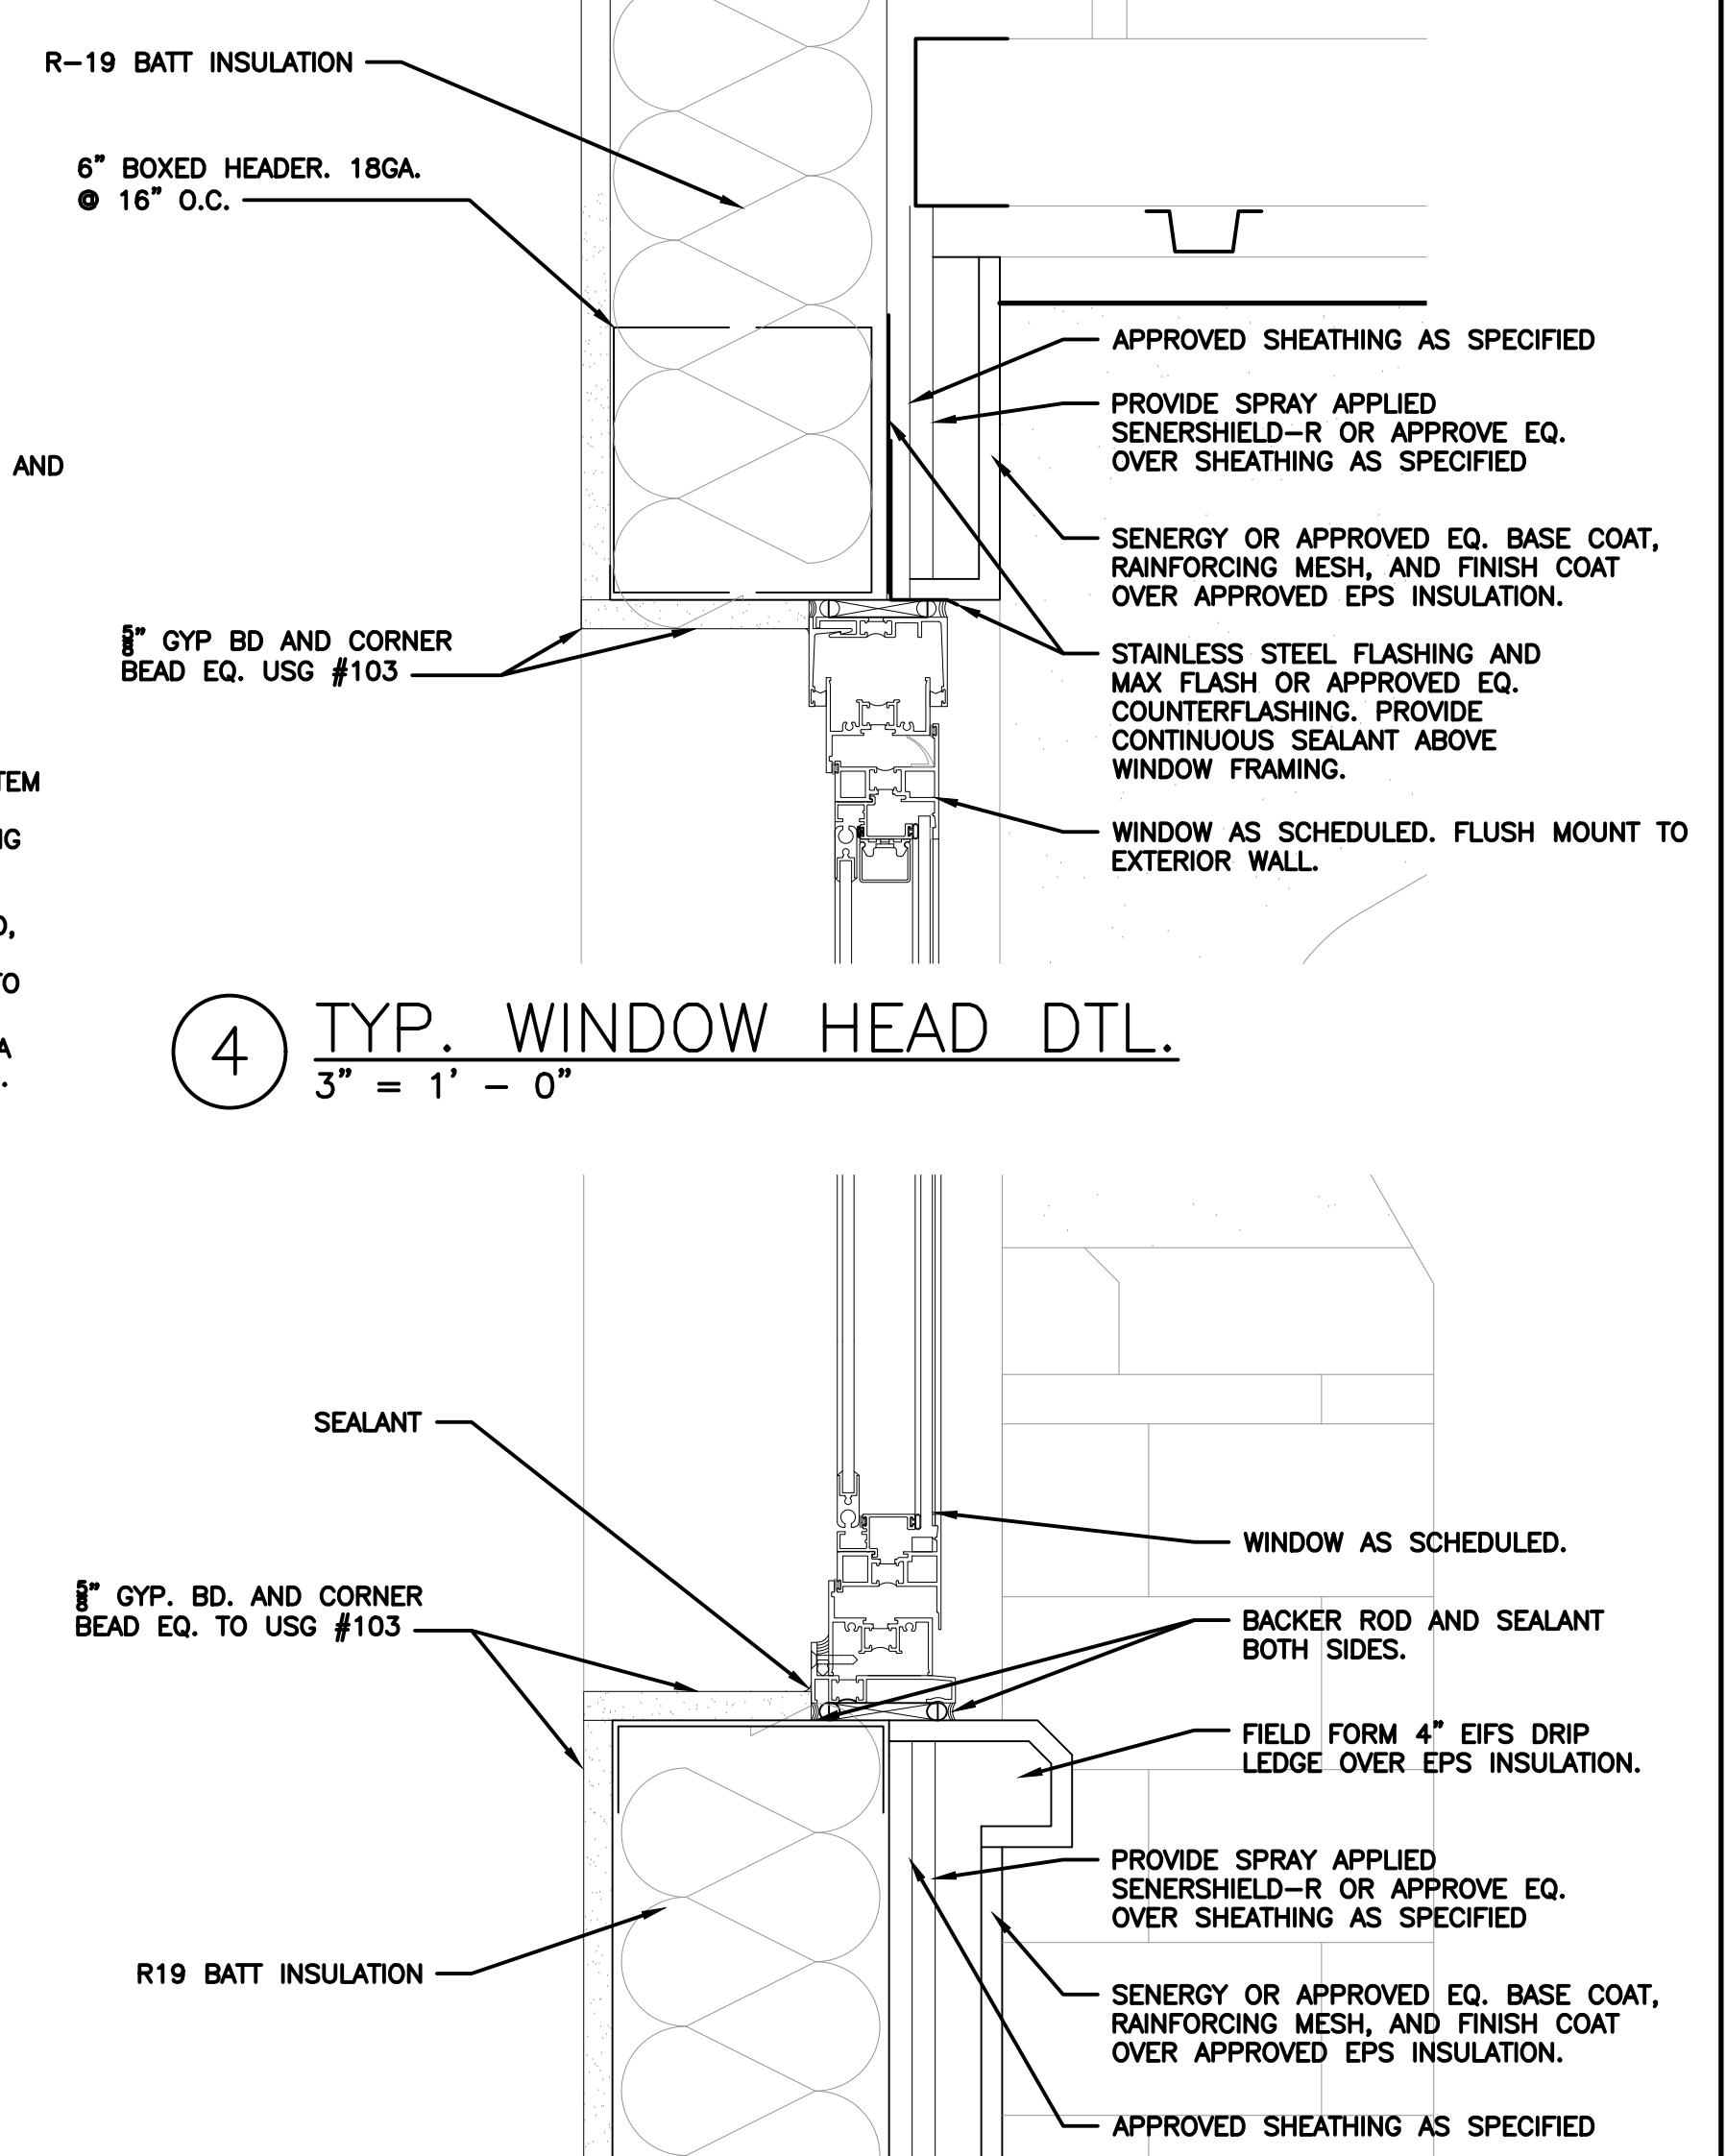

4 TYP. WINDOW HEAD DTL.  
3/8" = 1' - 0"

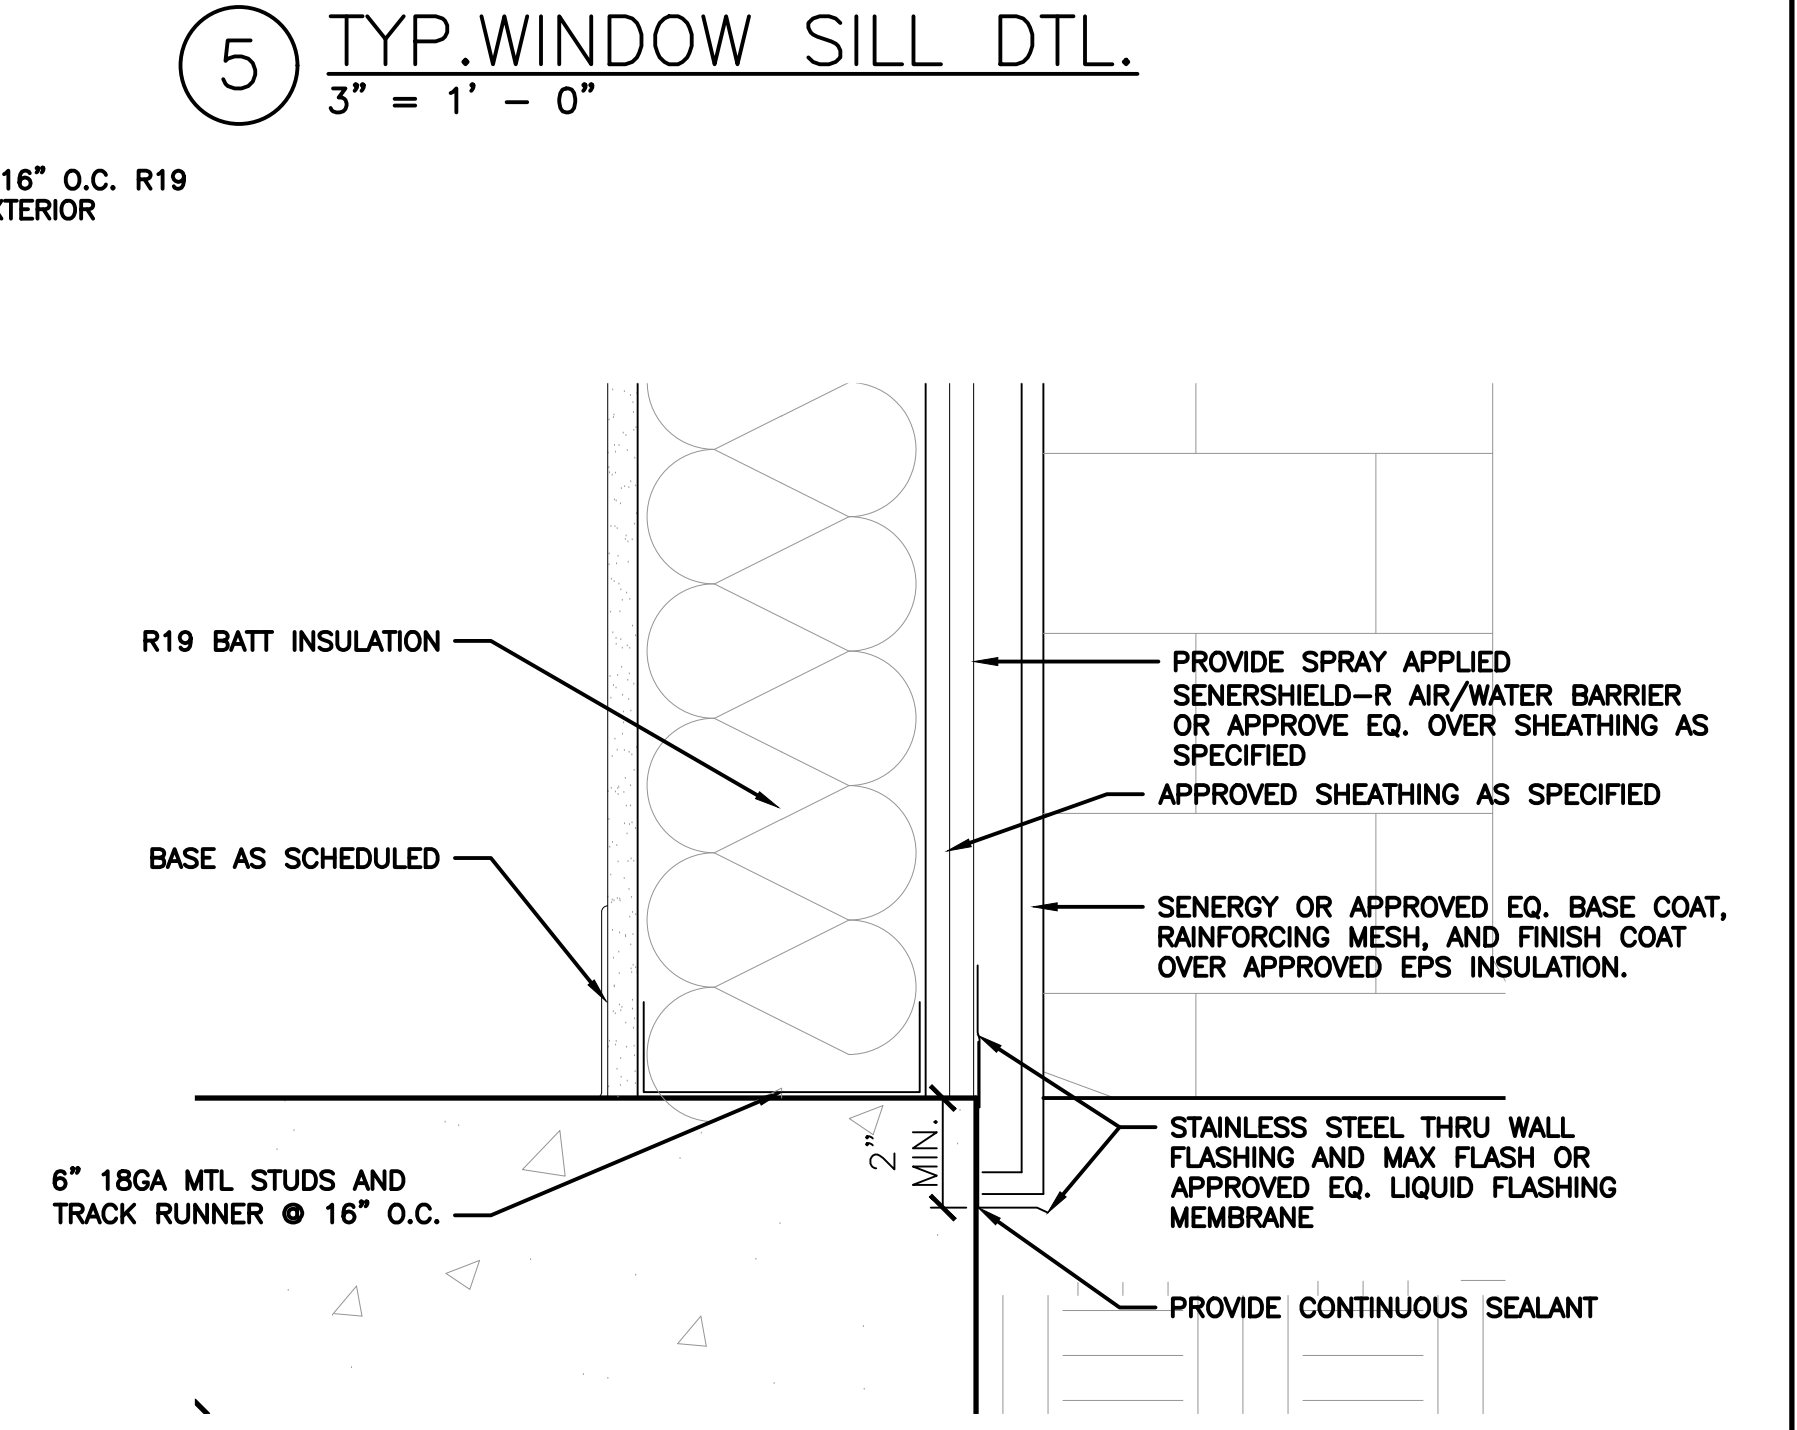


5 TYP. WINDOW SILL DTL.  
3/8" = 1' - 0"

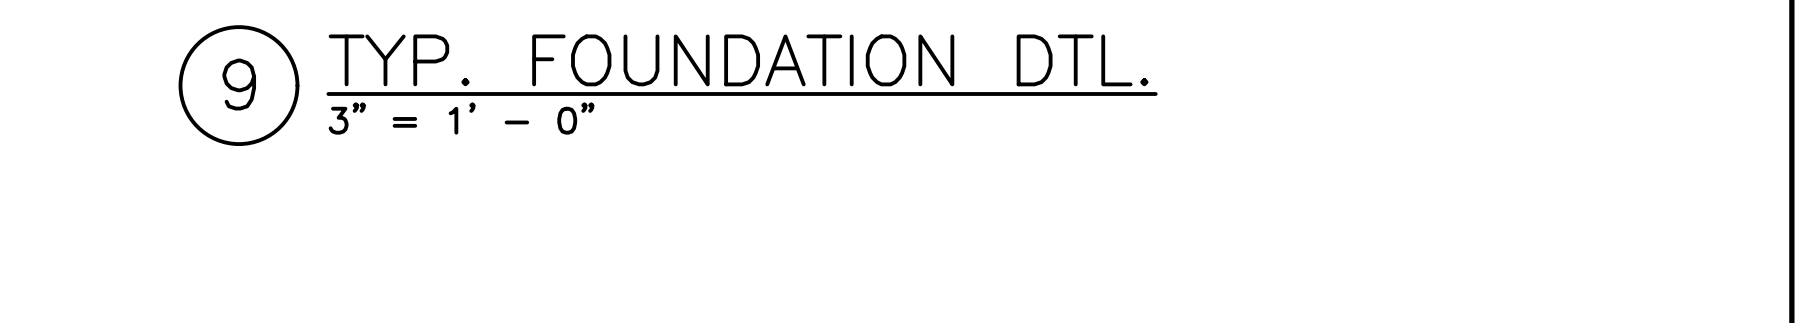

9 TYP. FOUNDATION DTL.  
3/8" = 1' - 0"

NOTE: MASONRY WALL TIES @ 16" O.C. VERTICAL AND 32" O.C. HORIZ.

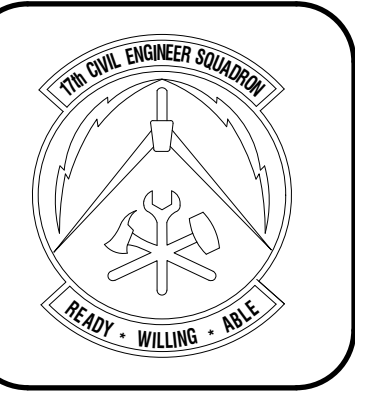

DATE

REVISIONS



Designed by: JH/MLLA  
 Drawn by: JH/MLLA  
 Reviewed by: RT/JH  
 Submitted by: PCES

PROJECT TITLE  
 FIRE STATION ADD/ALTER, B3321  
 PROJECT NO. 1039839  
 17th TRAINING WING  
 GOODFELLOW AIR FORCE BASE, TEXAS


Project Number:  
 1039839  
 SHEET TITLE  
 WALL SECTIONS AND DETAILS  
 Date:  
 JAN 2024

SEQ. SHEET OF  
 29 A-901 50




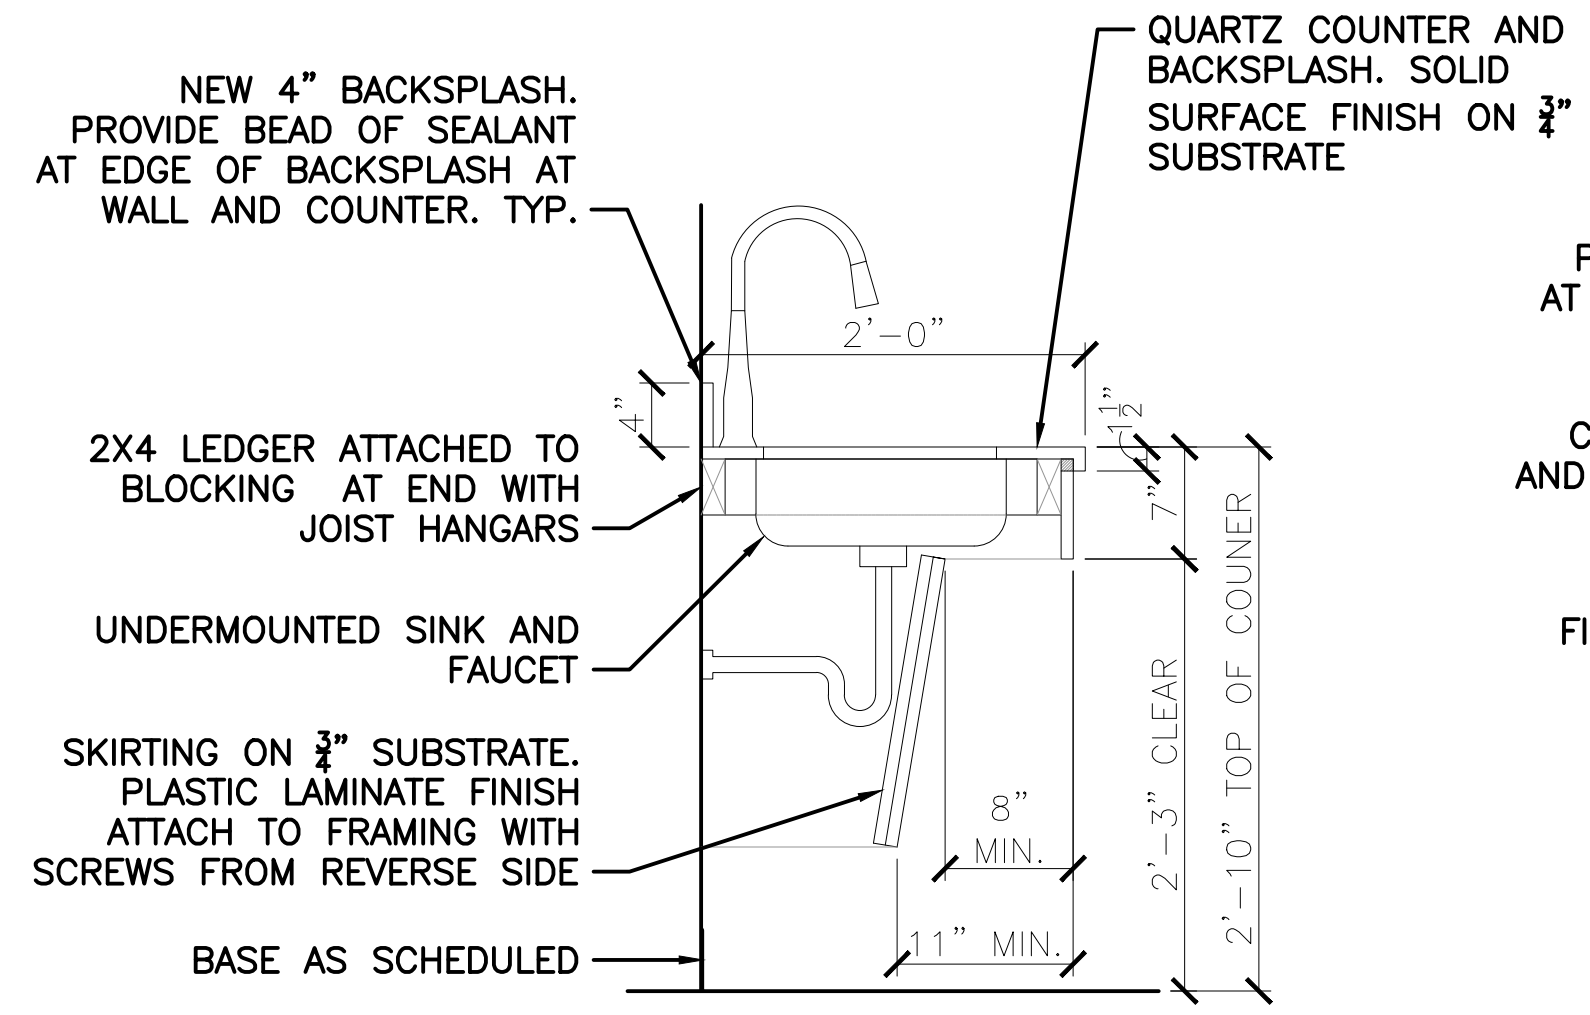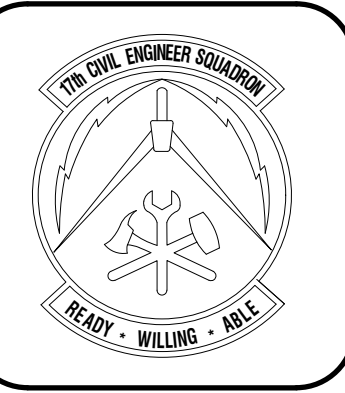


1 MILLWORK DTL.  
1" = 1' - 0"

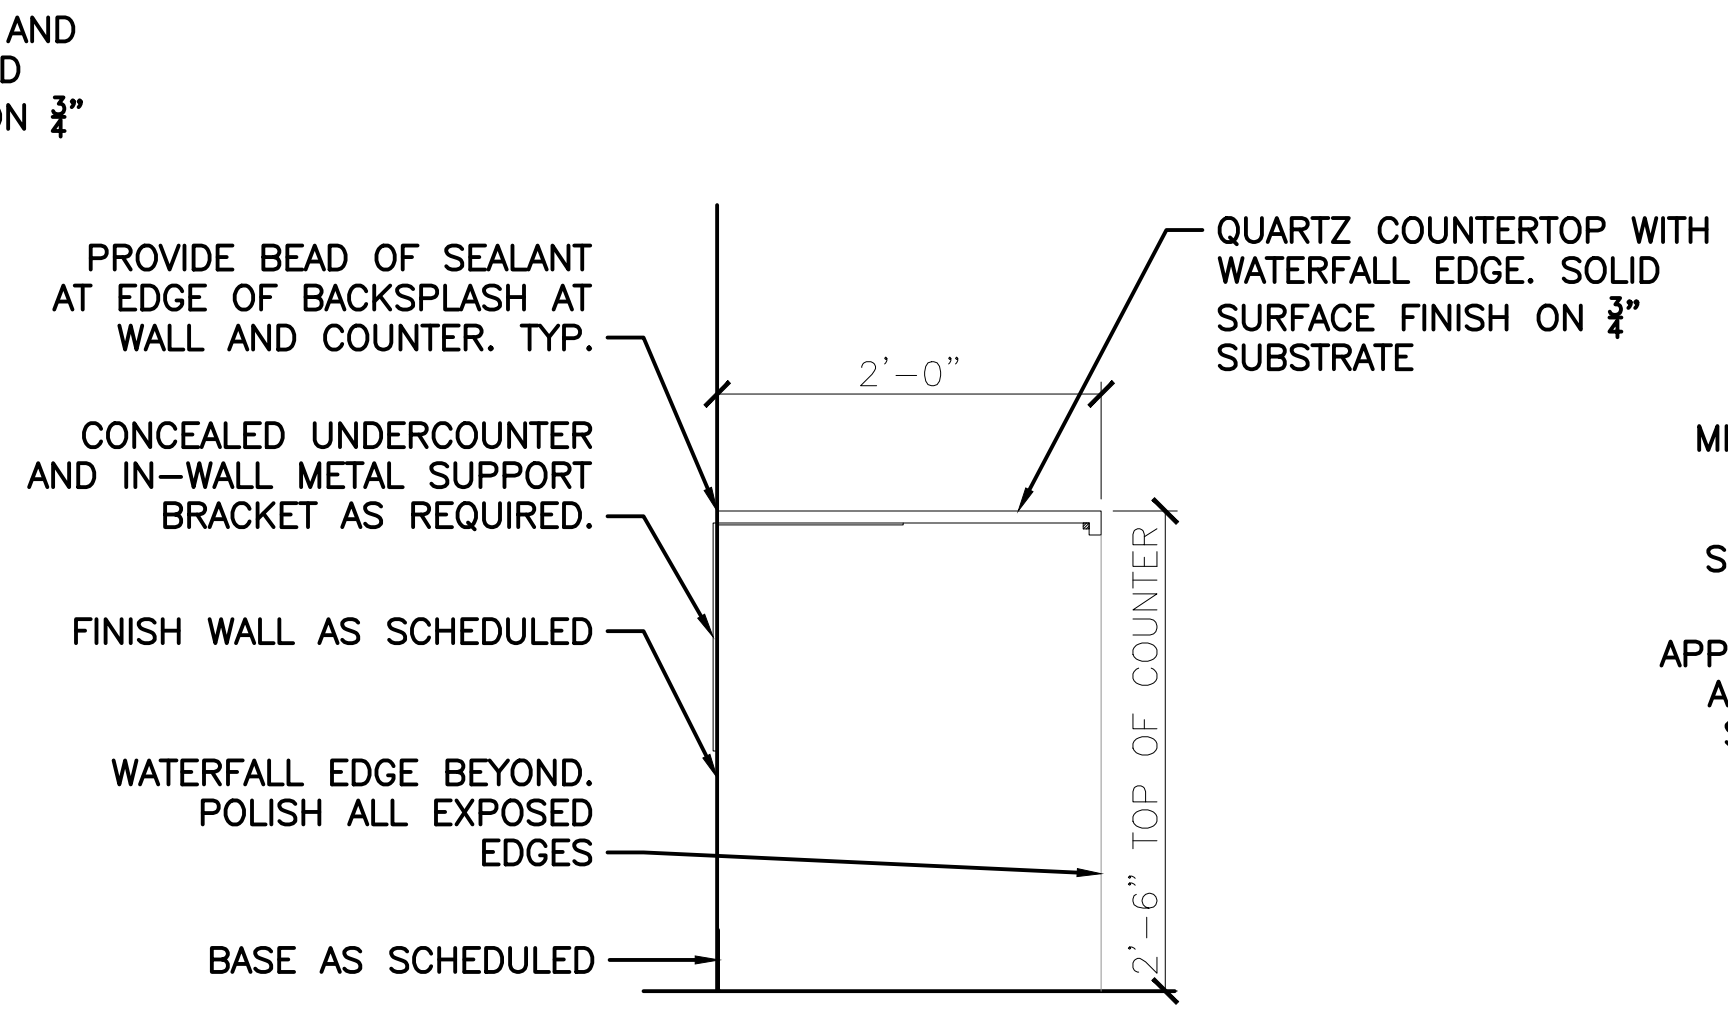


2 MILLWORK DTL.  
1" = 1' - 0"

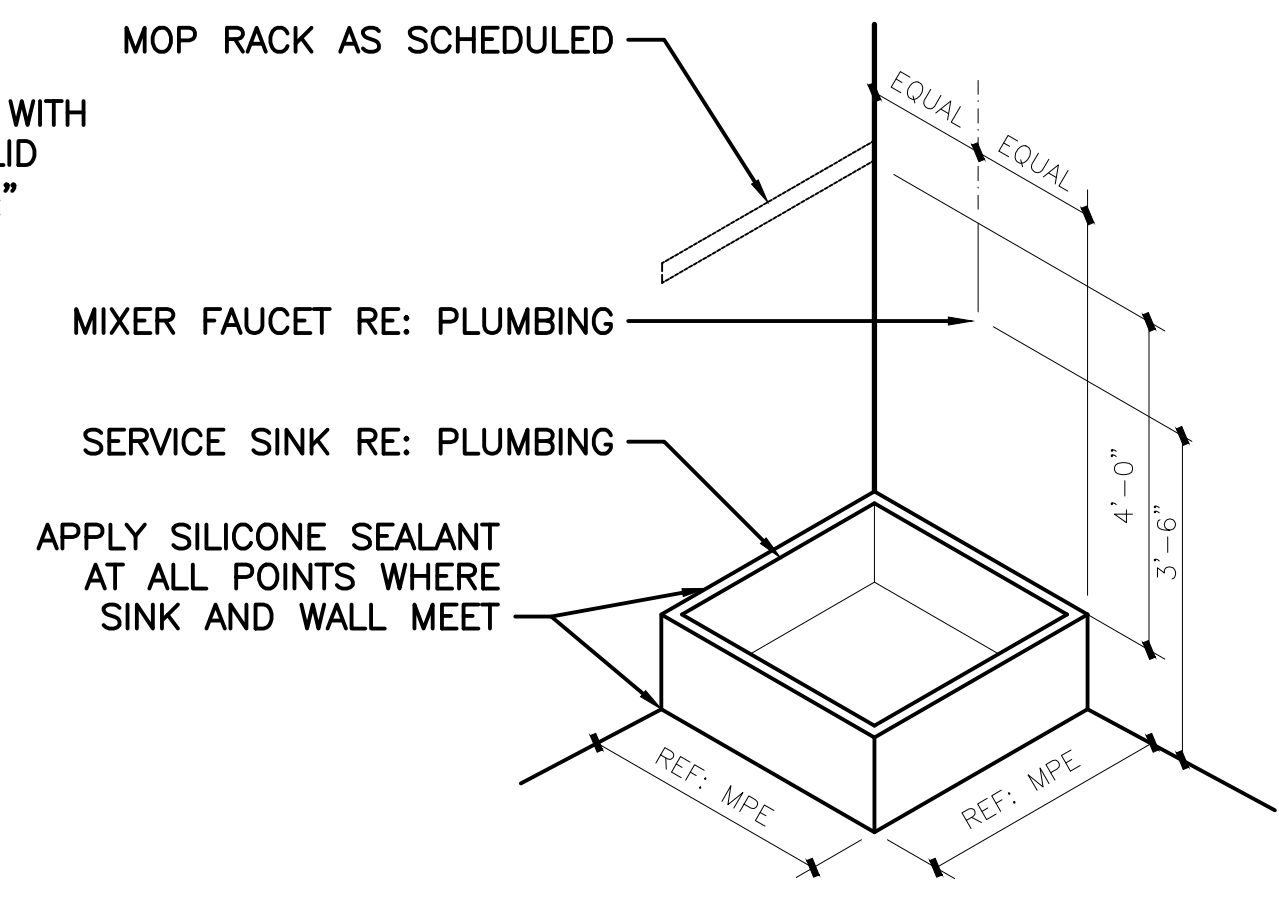


3 JAN. SINK DTL.  
NTS

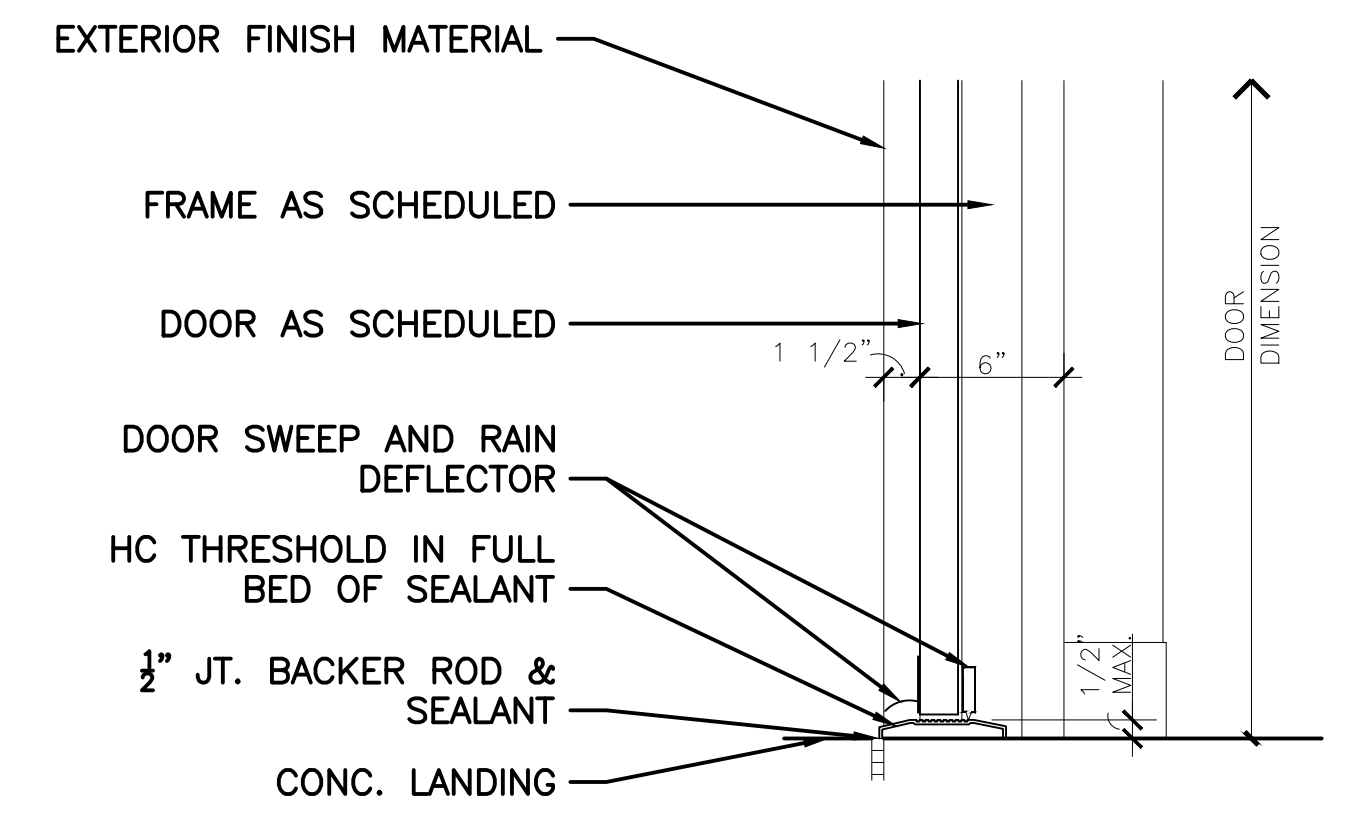


4 EXT. DOOR & FRAME @ FLOOR  
NTS

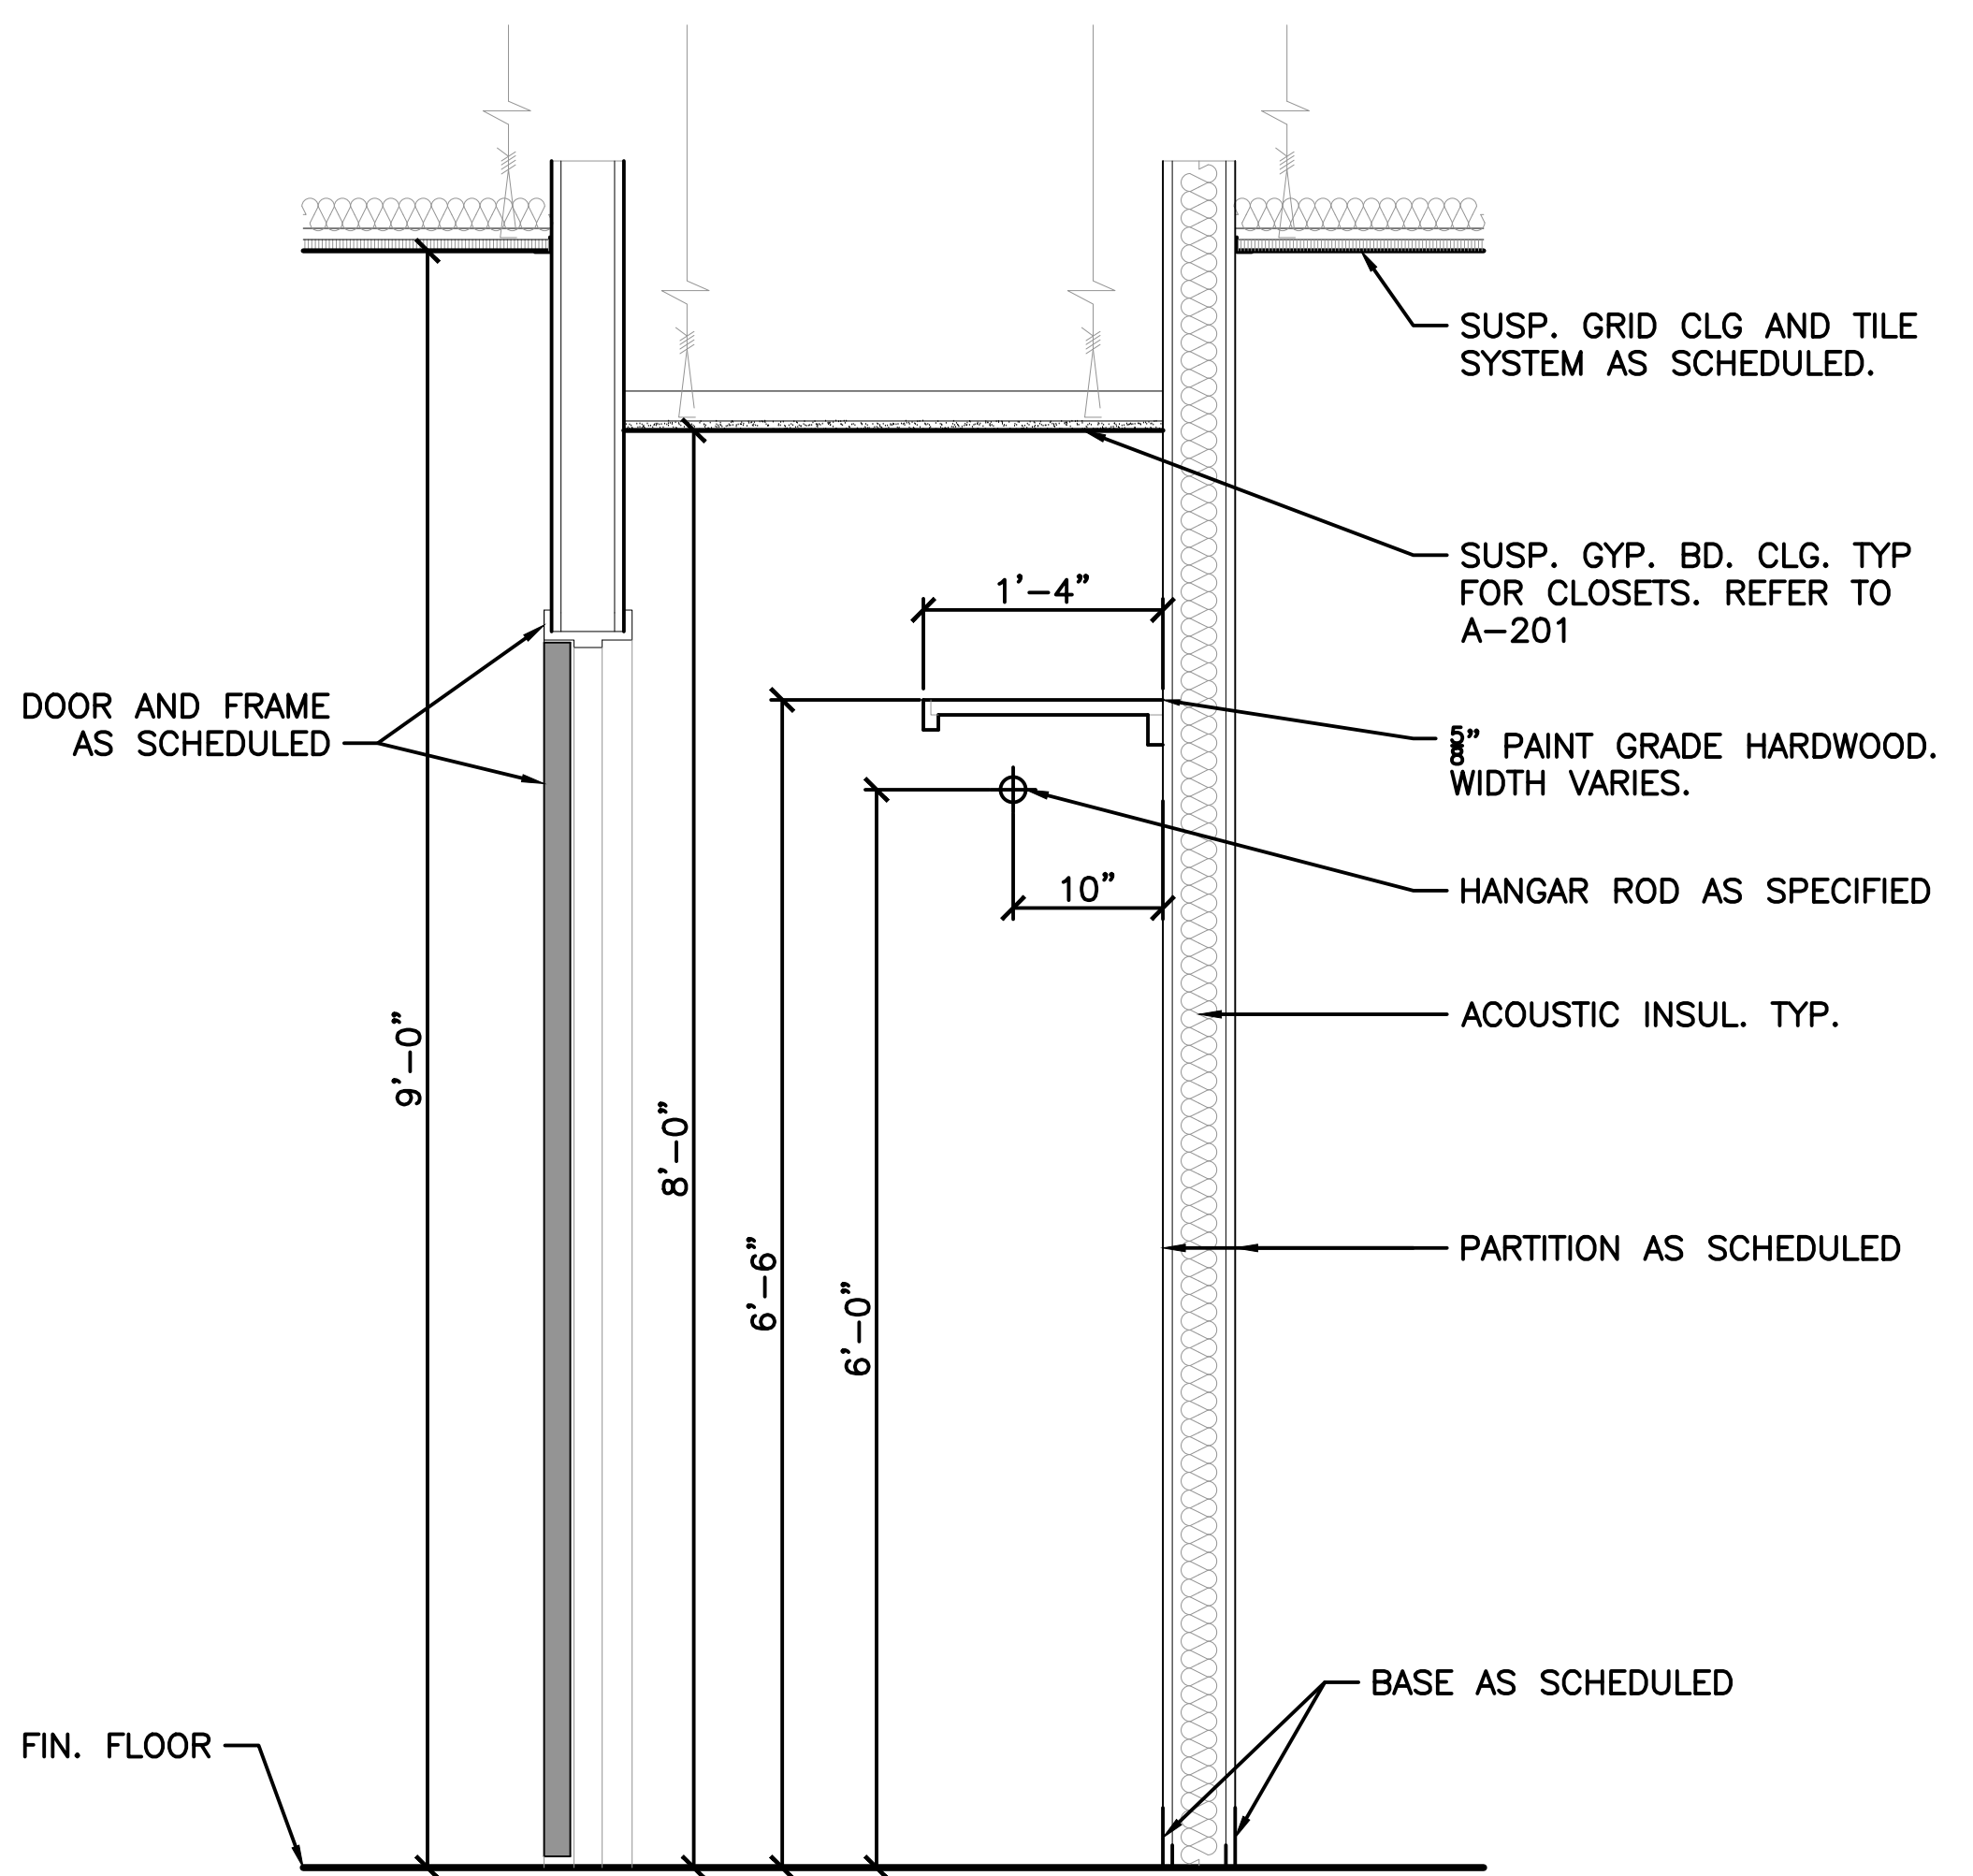


5 TYP. CLOSET SECTION  
1" = 1' - 0"

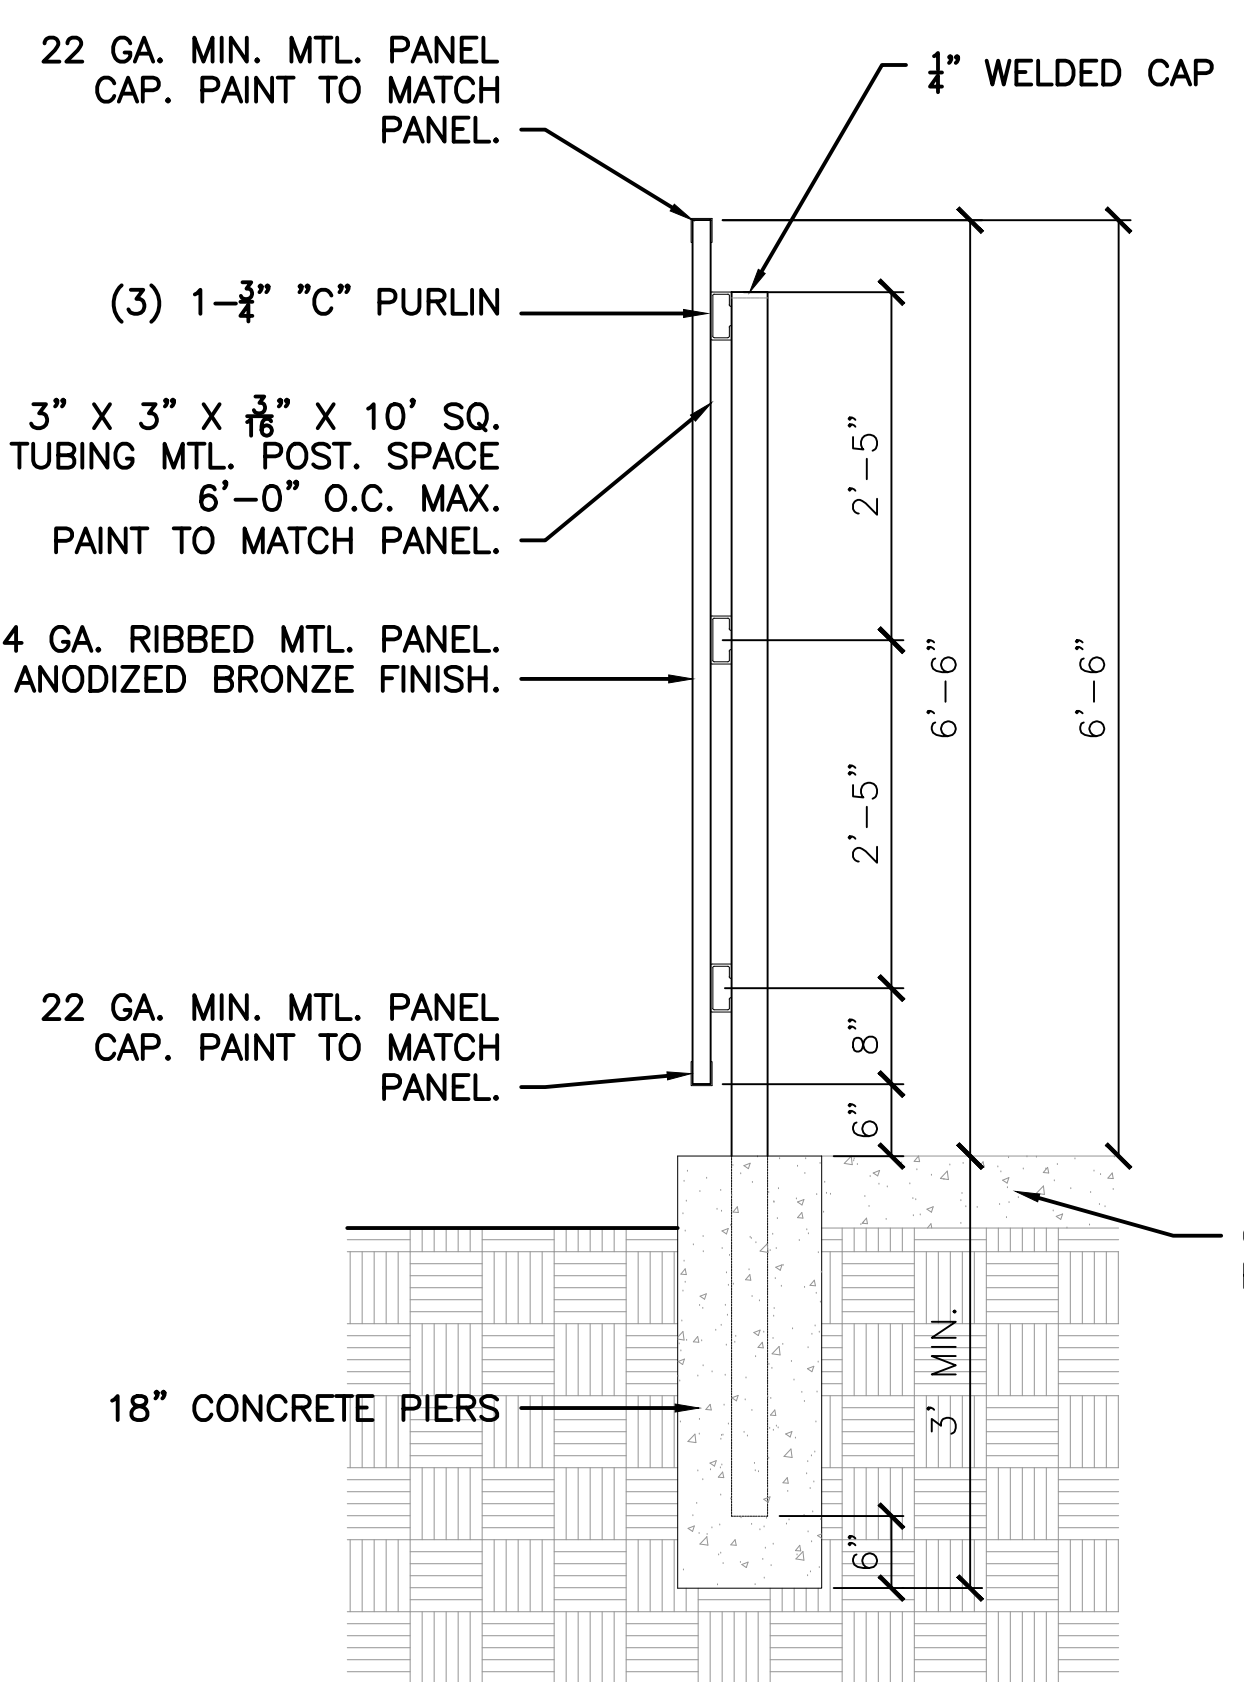


10 TYP. MTL. FENCE PANEL DTL.  
3/4" = 1' - 0"

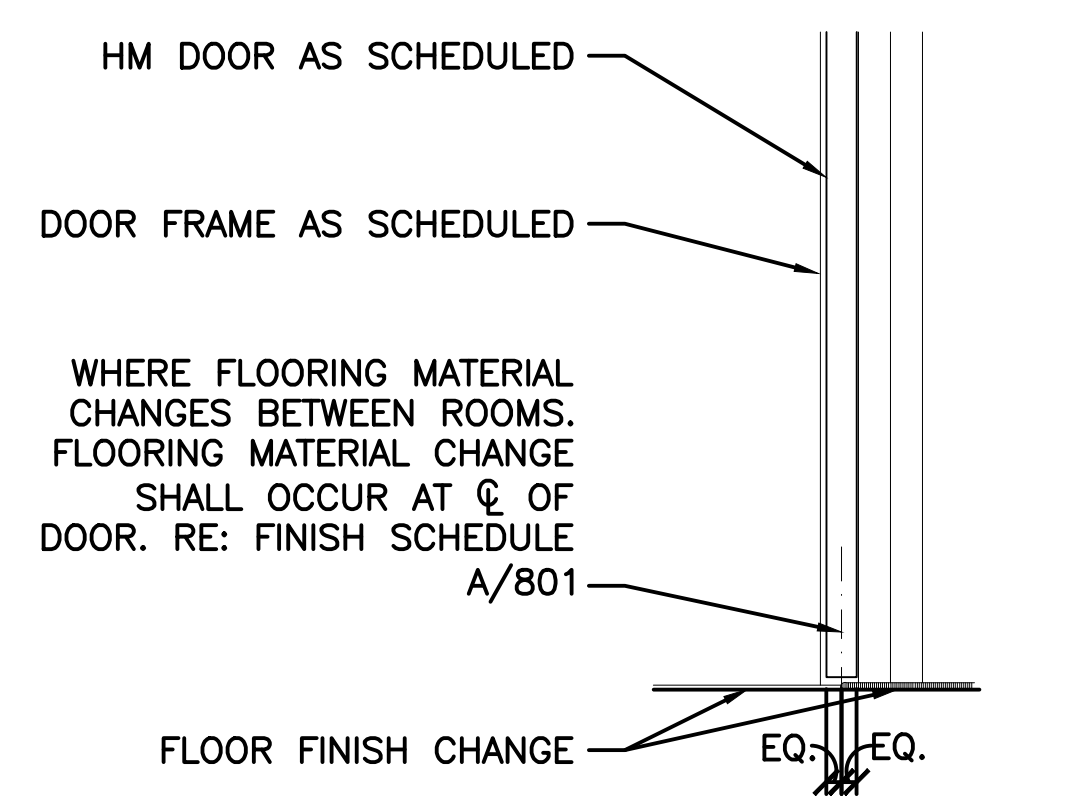


6 INT. DOOR & FRAME @ FLOOR  
NTS

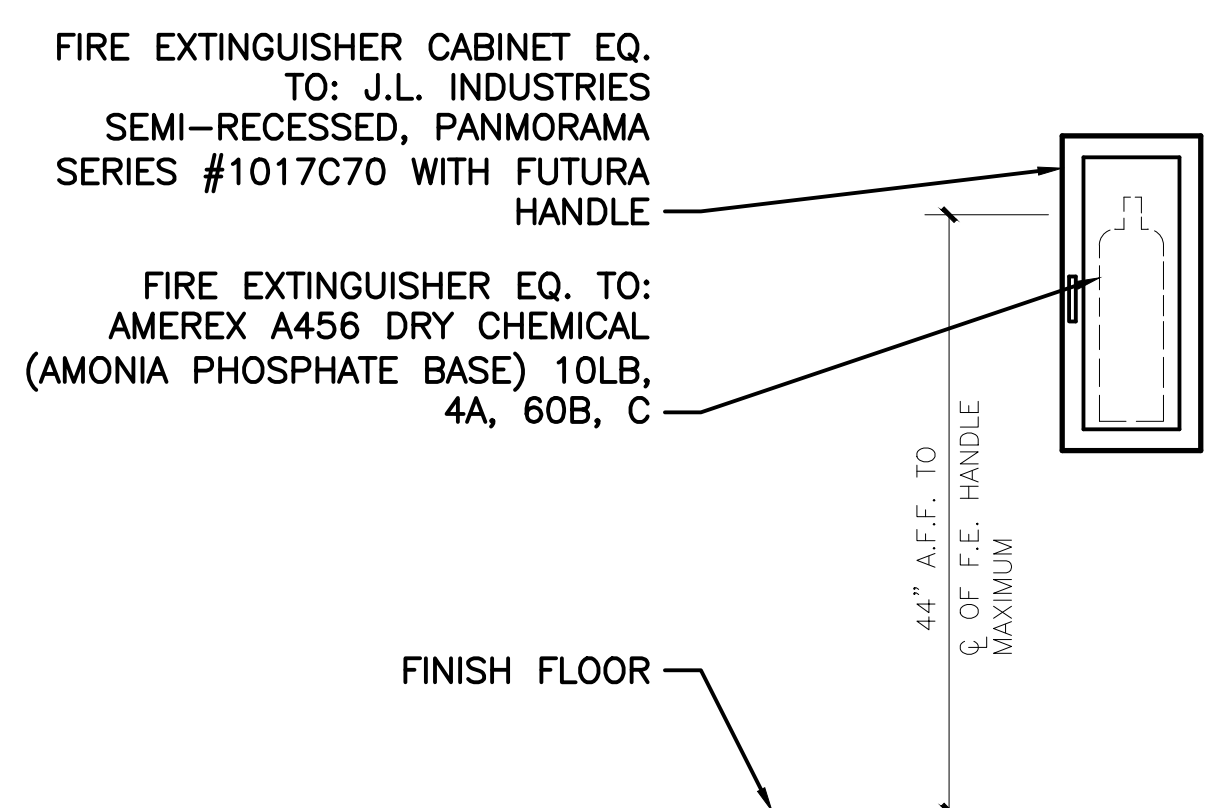


7 FIRE EXTINGUISHER CABINET DTL.  
NTS

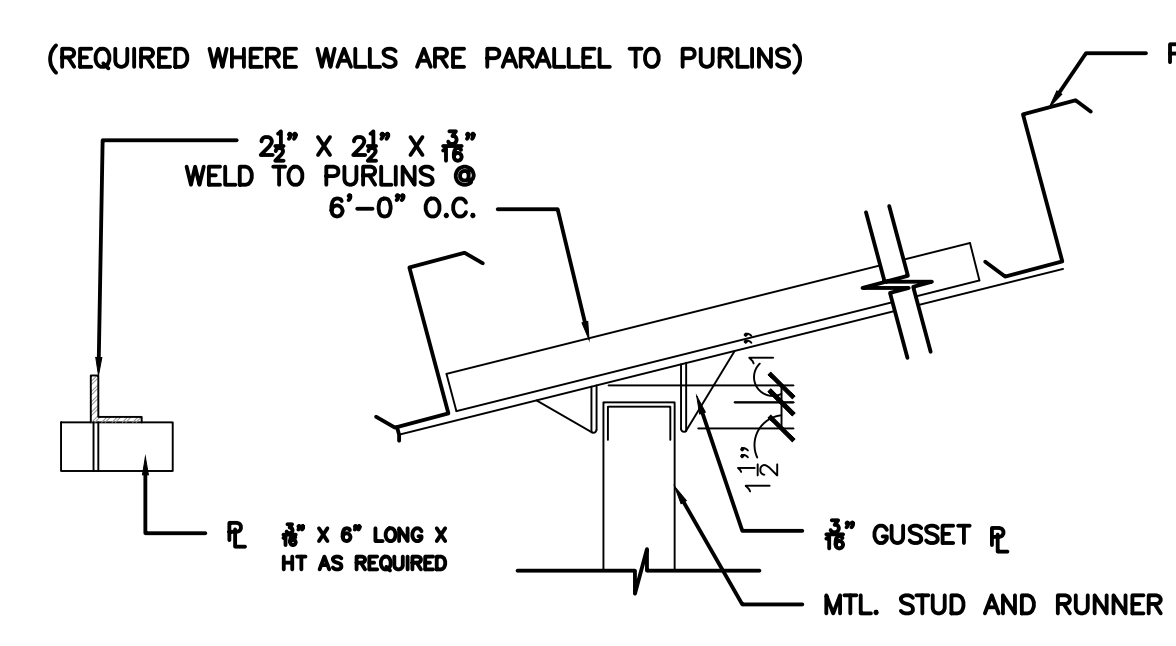


8 MTL. STUD PARTITION SUPPORT DTL.  
1 1/2" = 1' - 0"

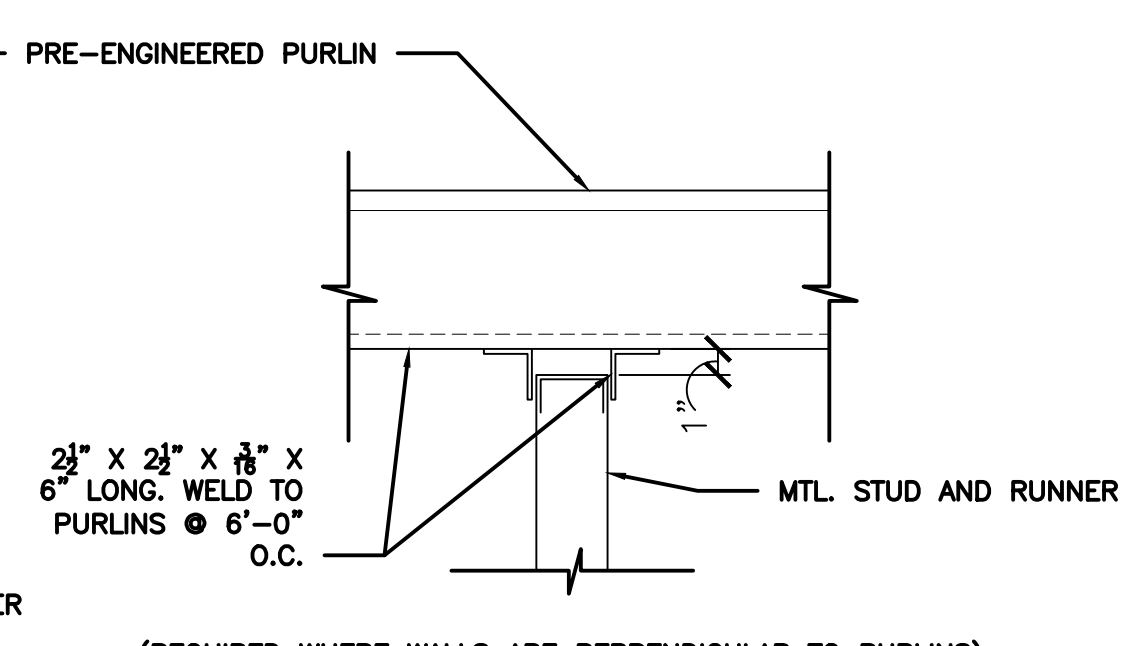

9 MTL. STUD PARTITION SUPPORT DTL.  
1 1/2" = 1' - 0"

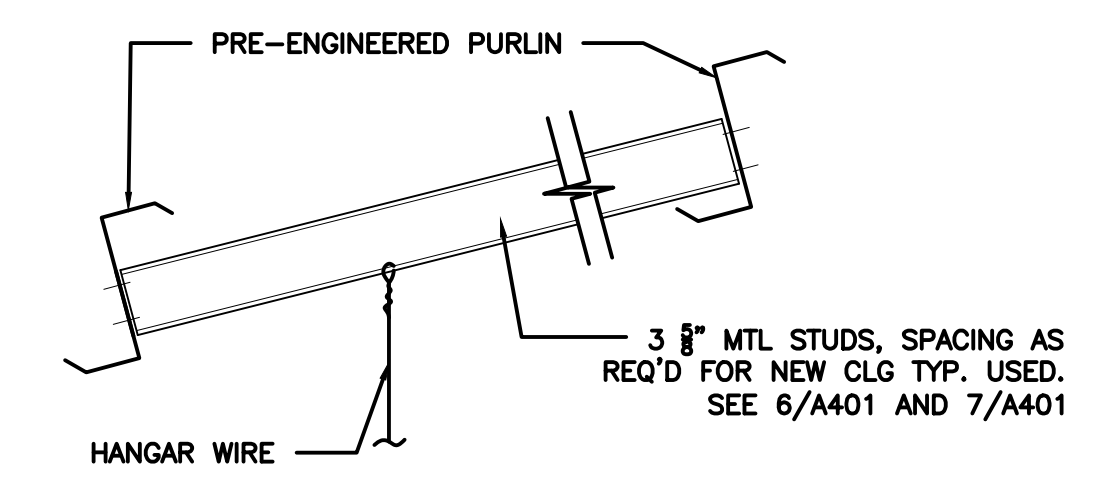

11 TYP. SUSP. CLG SUPPORT DTL.  
1 1/2" = 1' - 0"

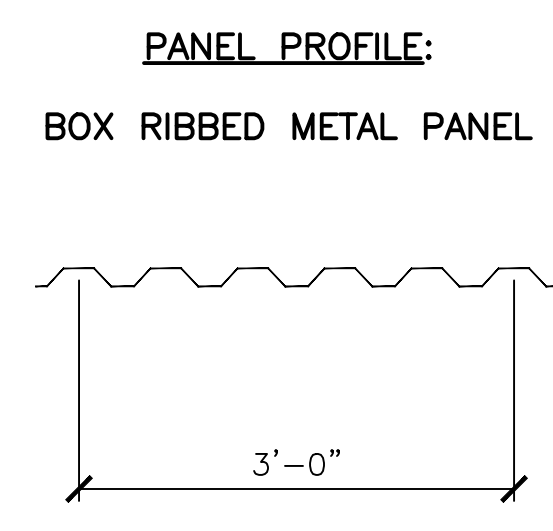

DATE

REVISIONS

Designed by: JH/MLLA  
 Drawn by: JH/MLLA  
 Reviewed by: RT/JH  
 Submitted by: PC/ES

PROJECT TITLE  
 FIRE STATION ADD/ALTER, B3321  
 PROJECT NO. 1039839  
 17th TRAINING WING  
 GOODFELLOW AIR FORCE BASE, TEXAS

Project Number:  
1039839  
 SHEET TITLE  
DETAILS  
 Date:  
JAN 2024

SEQ. SHEET OF  
 30 A-1001 50


# MECHANICAL SYMBOLS AND ABBREVIATIONS (NOT ALL APPLY)

STANDARD SYMBOLS				ABBREVIATIONS				
SYMBOL	DESCRIPTION	SYMBOL	DESCRIPTION	SYMBOL	DESCRIPTION	SYMBOL	DESCRIPTION	
<b>PIPING-HVAC</b>								
—PAR—	PROCESS ARGON	—PH <sub>3</sub> —	PHOSPHINE (HIGHLY TOXIC)	tee symbol	TEE, TURNED UP	SA	SOUND ATTENUATOR	
—CWS—	CHILLED WATER SUPPLY	—PN <sub>2</sub> —	PROCESS NITROGEN	tee symbol	TEE, TURNED DOWN	outside air symbol	OUTSIDE AIR (O. A.)	
—CWR—	CHILLED WATER RETURN	—R12—	DICHLORODIFLUOROMETHANE	valve symbol	VALVE IN RISER	acoustical lining symbol	ACOUSTICAL LINING (A.L.)	
—HWS—	HEATING WATER SUPPLY	—R14—	TETRAFLUOROMETHANE	valve symbol	VALVE ON ELBOW UP	exhaust fan symbol	EXHAUST FAN	
—HWR—	HEATING WATER RETURN	—Si <sub>2</sub> H <sub>6</sub> —	DISILANE (PYROPHORIC/TOXIC)	valve symbol	VALVE ON ELBOW DOWN	supply fan symbol	SUPPLY FAN	
—TWS—	TOWER WATER SUPPLY	—SiH <sub>4</sub> —	SILANE (PYROPHORIC/TOXIC)	elbow symbol	45 ELBOW	vent fan symbol	VENT FAN	
—TWR—	TOWER WATER RETURN	<b>PIPING-GASES</b>		elbow symbol	30 ELBOW	flexible duct symbol	FLEXIBLE DUCT CONNECTION	
—LPS—	LOW PRESSURE STEAM	—AR—	ARGON	elbow symbol	90 ELBOW	finned pipe symbol	FINNED PIPE RADIATION	
—MPS—	MEDIUM PRESSURE STEAM	—BA—	BREATHING AIR	tee symbol	TEE	rectangular outlet symbol	RECTANGULAR OUTLET, EXHAUST	
—HPS—	HIGH PRESSURE STEAM	—CA—	COMPRESSED AIR	tee symbol	CAP	sidewall outlet symbol	SIDEWALL OUTLET, REGISTERS/GRILLES	
—C—	CONDENSATE, GRAVITY	—CD—	CLEAN DRY AIR	rupture symbol	RUPTURE DISK	sidewall inlet symbol	SIDEWALL INLET, REGISTERS/GRILLES	
—PC—	CONDENSATE, PUMPED	—CH <sub>4</sub> —	METHANE	rupture symbol	SHOCK ABSORBER	undercut door symbol	UNDERCUT DOOR (h = CLEARANCE)	
—FOS—	FUEL OIL SUPPLY	—C <sub>2</sub> H <sub>2</sub> —	ACETYLENE	rupture symbol	FLOOR DRAIN	door grille symbol	DOOR GRILLE OR LOUVER	
—FOR—	FUEL OIL RETURN	—CO <sub>2</sub> —	CARBON DIOXIDE	rupture symbol	FLOOR SINK	transfer grille symbol	TRANSFER GRILLE OR LOUVER	
—FOG—	FUEL OIL GAGE LINE	—G—	NATURAL GAS	rupture symbol	EXPANSION JOINT	rectangular 4-way outlet symbol	RECTANGULAR 4-WAY OUTLET, SUPPLY	
—FOV—	FUEL OIL TANK VENT	—H <sub>2</sub> —	HYDROGEN	rupture symbol	LINE STRAINER	rectangular 4-way outlet symbol	RECTANGULAR 4-WAY OUTLET, SUPPLY	
—RD—	REFRIGERANT DISCHARGE (HOT GAS)	—HCV—	HOUSE CLEANING VACUUM	rupture symbol	CLEAN-OUT TO GRADE	rectangular 2-way outlet symbol	RECTANGULAR 2-WAY OUTLET, SUPPLY	
—RS—	REFRIGERANT SUCTION	—HE—	HELIUM	rupture symbol	OPEN SIGHT DRAIN, AIR GAP	rectangular 1-way outlet symbol	RECTANGULAR 1-WAY OUTLET, SUPPLY	
—RL—	REFRIGERANT LIQUID	—LAR—	LIQUID ARGON	rupture symbol	WALL CLEANOUT (WCO)	rectangular outlet symbol	RECTANGULAR OUTLET, RETURN	
---NAME---	DEMO PIPE	—LCO <sub>2</sub> —	LIQUID CARBON DIOXIDE	rupture symbol	FLOOR CLEANOUT (FCO)	rectangular outlet symbol	RECTANGULAR OUTLET, EXHAUST	
(E) NAME	EXISTING PIPE	—LN <sub>2</sub> —	LIQUID NITROGEN	rupture symbol	DIRECTION AND FLOW	round outlet symbol	ROUND OUTLET	
<b>PIPING-PLUMBING</b>								
-----	COLD WATER	—LO <sub>2</sub> —	LIQUID OXYGEN	rupture symbol	PRESSURE GAUGE	linear outlet symbol	LINEAR OUTLET (SIZE=NUMBER SLOTS X LENGTH OF SLOTS)	
-----	HOT WATER	—LPG—	LIQUID PETROLEUM GAS	rupture symbol	<b>VALVES</b>		linear inlet symbol	LINEAR INLET (SIZE=NUMBER SLOTS X LENGTH OF SLOTS)
-----	HOT WATER RETURN	—N <sub>2</sub> —	NITROGEN	rupture symbol	ball valve symbol	<b>MISCELLANEOUS</b>		
—W—	WATER	—O <sub>2</sub> —	OXYGEN	rupture symbol	gate valve symbol	centrifugal pump symbol	CENTRIFUGAL PUMP	
—NPW—	NON POTABLE WATER	—PV—	PROCESS VACUUM	rupture symbol	globe valve symbol	number detail bubble symbol	NUMBER DETAIL BUBBLE	
-----	SANITARY SEWER	—VAG—	VACUUM	rupture symbol	plug cock symbol	equipment mark symbol	EQUIPMENT MARK (AHU-1 SHOWN)	
-----	VENT	<b>PIPING-PROCESS LIQUIDS</b>		rupture symbol	swing check valve symbol	end point of removal symbol	END POINT OF REMOVAL	
—D—	GRAVITY DRAIN	—DI—	DEIONIZED WATER	rupture symbol	spring check valve symbol	keyed note construction symbol	KEYED NOTE CONSTRUCTION	
—PD—	PRESSURE DRAIN	—HF—	HYDROFLUORIC ACID	rupture symbol	hoose bibb symbol	manhole symbol	MANHOLE	
—AD—	ACID WASTE, GRAVITY	—PCWR—	PROCESS COLD WATER RETURN	rupture symbol	needle valve symbol	point of connection symbol	POINT OF CONNECTION FROM NEW TO EXISTING CONSTRUCTION	
—AV—	ACID VENT	—PCWS—	PROCESS COLD WATER SUPPLY	rupture symbol	butterfly valve symbol	letter section bubble symbol	LETTER SECTION BUBBLE	
—PAD—	ACID DRAIN, PUMPED	—POR—	PROCESS OIL RETURN	rupture symbol	motor operated globe valve symbol	break symbol	BREAK	
—RWL—	RAIN WATER LEADER	—POS—	PROCESS OIL SUPPLY	rupture symbol	motor operated gate valve symbol	keyed note, demolition symbol	KEYED NOTE, DEMOLITION	
—ORWL—	OVERFLOW RAIN WATER LEADER	—RO—	REVERSE OSMOSIS WATER	rupture symbol	solonoid operated valve symbol	meter symbol	METER	
—ST—	STORM SEWER	—SCW—	SOFTENED COLD WATER	rupture symbol	solonoid operated 3-way valve symbol	<b>TITLE</b>		
—S—	SOFT WATER	<b>PIPING-FITTINGS</b>		rupture symbol	self-contained temp. control valve symbol	TITLE NOT TO SCALE		
-----	DEMO PIPE	+	SCREWED JOINT	rupture symbol	external pressure reducing valve symbol	DETAIL BUBBLE		
-----	EXISTING PIPE	+	FLANGED JOINT	rupture symbol	internal pressure reducing valve symbol	TITLE - INDICATES THE TITLE OF THE DETAIL SCALE - INDICATES THE SCALE OF THE DETAIL (IF APPLICABLE)		
<b>PIPING-SPECIALTY</b>								
—AsH <sub>3</sub> —	ARSINE (HIGHLY TOXIC)	+	WELDED JOINT	rupture symbol	three way valve, electrical symbol	X - DENOTES DETAIL NUMBER		
—Cl <sub>2</sub> —	CHLORINE (CORROSIVE)	+	UNION	rupture symbol	three way valve, manual symbol	Y - DENOTES REFERENCE SHEET NUMBER		
—DMC—	DIMETHYLCADMIUM (METAL ORGANIC)	+	CONCENTRIC REDUCER	rupture symbol	three way valve, pneumatic symbol	Z - DENOTES SHEET NUMBER		
—DMT—	DIMETHYLTELLURIUM (METAL ORGANIC)	+	ECCENTRIC REDUCER	rupture symbol	angle valve symbol	DUCT SIZE, WHERE THE FIRST DIMENSION (E.G., 24) IS THE VISIBLE DUCT DIMENSION REFERENCE SPECIFICATION FOR INSULATION TYPE AND THICKNESS		
—H <sub>2</sub> Se—	HYDROGEN SELENIDE (TOXIC)	+	ELBOW, TURNED DOWN	rupture symbol	relief valve symbol	DOUBLE-WALL DUCT, DUCT SIZE AS INDICATED FOR DUCTS ABOVE		
—HCL—	HYDROGEN CHLORIDE (CORROSIVE)	+	ELBOW, TURNED UP	rupture symbol	diaphragm valve symbol	SIDE ACCESS DOOR (VERTICAL)		
—NH <sub>3</sub> —	AMMONIA (TOXIC)	+	AIR VENT	rupture symbol	backflow preventer symbol	TOP ACCESS DOOR (HORIZONTAL)		
—F—	FLUORINE	+	VACUUM RELIEF	rupture symbol	existing duct symbol	BOTTOM ACCESS DOOR (HORIZONTAL)		
		+	F & T TRAP	rupture symbol	demo equipment symbol	RETURN AIR (S. A.)		
		+	THERMOSTATIC TRAP	rupture symbol	demo air devices symbol	RETURN AIR (R. A.)		
						OUTSIDE AIR (O. A.)		

## GENERAL NOTES:

THESE MECHANICAL GENERAL NOTES APPLY TO ALL MECHANICAL DRAWINGS:

- ALL WORK SHALL BE PERFORMED IN ACCORDANCE WITH THE CODES AS REFERENCED IN THE RFP AND THE REQUIREMENTS STATED IN THE APPLICABLE SECTIONS OF THE NATIONAL FIRE CODES (NFPA STANDARDS) CURRENT AT THE TIME OF ISSUANCE OF THE RFP. AMENDMENTS TO THESE CODES AS SET FORTH BY THE AUTHORITY HAVING JURISDICTION SHALL SUPERSEDE THE INTERNATIONAL CODES AND NFPA STANDARDS AS ISSUED.
- DIVISION 23 OPERATIONS SHALL BE SUPERVISED BY A LICENSED MASTER MECHANICAL INSTALLER TO ENSURE THAT ALL WORK IS INSTALLED IN ACCORDANCE WITH THE APPLICABLE CODES AND THE CONSTRUCTION DOCUMENTS.
- EXISTING INFORMATION SHOWN WAS TAKEN FROM AS BUILT DRAWINGS PROVIDED BY GOODFELLOW AIR FOR BASE (GAFB) AND A WALK-THRU OF THE FACILITY. THE CONTRACTOR SHALL FIELD VERIFY THE EXISTING CONDITIONS PRIOR TO BID AND NOTIFY THE CONTRACTING OFFICER OF ANY SUBSTANTIAL DISCREPANCIES WHICH WOULD IMPACT BASIS OF DESIGN AND CONSTRUCTION.
- CONTRACTOR SHALL VISIT THE JOB SITE TO FAMILIARIZE THEMSELVES WITH EXISTING CONDITIONS AND TO VERIFY LOCATIONS, SIZE AND QUANTITIES OF EXISTING UTILITIES, MECHANICAL SYSTEMS, PLUMBING SYSTEMS, ETC. SUBMITTAL OF A BID SHALL SIGNIFY WILLINGNESS TO COMPLY WITH THE CONSTRUCTION DOCUMENTS AND ACCEPTANCE OF ON-SITE CONDITIONS AS THEY EXIST.
- THE INSTALLER IS RESPONSIBLE FOR COORDINATING WITH OTHER TRADES. THE INSTALLER SHALL NOT INSTALL OR FABRICATE ANY WORK SHOWN UNTIL ALL SUCH WORK IS FULLY COORDINATED. FURNISH AND INSTALL ADDITIONAL DUCTWORK, PIPING, OFFSETS, AND FITTINGS AS REQUIRED TO COORDINATE THE INSTALLATION WITH OTHER TRADES AS PART OF THE WORK.
- COORDINATE WITH AND OBTAIN APPROVAL FROM CONTRACTING OFFICER FOR ALL UTILITY OUTAGES A MINIMUM OF 7 DAYS IN ADVANCE.
- SECURE OPENINGS THROUGH WALLS, ROOFS AND FLOORS FROM WEATHER DURING CONSTRUCTION.
- SECURE OPENINGS THROUGH ROOFS AND FLOORS FROM FALL AND PROVIDE ALL APPROPRIATE FALL PROTECTION MEASURES PER OSHA REQUIREMENTS.
- SALVAGE EQUIPMENT ITEMS TO A DESIGNATED STORAGE OR DISPOSAL AREA AS DIRECTED BY THE CONTRACTING OFFICER.
- COVER ALL DUCTWORK OPENING DURING CONSTRUCTION TO PREVENT MIGRATION OF DUST.
- INSTALL CONSTRUCTION FILTERS AT ALL RETURN OPENINGS OF ALL EQUIPMENT DURING CONSTRUCTION TO PREVENT MIGRATION OF DUST.
- ALL PIPING AND CUT IN FINISHED ROOMS OR SPACES SHALL BE CONCEALED IN A FURRED CHASE OR ABOVE THE SUSPENDED CEILING.
- THE FIRST DUCT SIZE INDICATES THE DIMENSION OF FACE SHOWN ON PLAN VIEW ONLY.
- ACCESS PANELS IN GYP BOARD CEILINGS ARE REQUIRED FOR ALL VALVES, TRAPS, DAMPERS, CLEANOUTS, CONTROLS, ETC. UNLESS OTHERWISE SPECIFIED THE ACCESS PANELS SHALL BE 16 GAGE PAINTABLE STEEL CONSTRUCTION WITH A PIANO HINGED DOOR, FLANGE FRAME, WALL SLEEVE AND KEYS LOCK. THE PANELS IN EXPOSED, FINISHED AREAS SHALL BE STAINLESS STEEL. THE ACCESS PANELS IN FIRE RATED ASSEMBLIES SHALL HAVE THE SAME RATING AS THE ASSEMBLY.
- EXTERNAL STATIC PRESSURE NOTED THE ON THE SCHEDULES ONLY INCLUDES SYSTEM LOSSES AND EXCLUDES LOSSES DUE TO ITEMS IN THE UNIT ITSELF SUCH AS (COILS, CASING, DAMPERS AND CLEAN FILTERS)
- DIFFUSERS RESISTER AND GRILLE SIZES SHOWN ON THE FLOOR PLAN ARE NECK SIZES.
- REFER TO THE ARCHITECTURAL REFLECTED CEILING PLANS FOR EXACT LOCATIONS OF CEILING DIFFUSER, REGISTER AND GRILLES.
- IF A DAMPER IN THE DUCT IS LOCATED ABOVE A HARD CEILING FURNISH AND INSTALL A ROUND DAMPER YOUNG REGULATOR 5020-1200 OR EQUIVALENT WITH WORM GEAR REGULATOR USE WITH FLEXIBLE SHAFT AND CONCEALED CEILING CAP WITH BRACKET FASTENS ABOVE THE CEILING ACCESS THROUGH A 1" ZINC PLATED THREADED STEEL CAP. PAINT SHALL BE APPROVED BY THE CONTRACTOR OFFICER BEFORE PAINTING THE CAP TO MATCH CEILING COLOR.
- THE DRAWINGS ARE PART DIAGRAMMATIC IN NATURE AND THE CONTRACTOR SHALL BE RESPONSIBLE TO COORDINATE ALL NEW PIPING, NEW DUCTS, NEW EQUIPMENT WITH THE EXISTING CONDITIONS SUCH AS PIPING, EQUIPMENT, STRUCTURAL COMPONENTS AND ETC. PRIOR TO SUBMISSION OF PIPING LAYOUT SHOP DRAWINGS AND COMMENCEMENT OF WORK. CONTRACTOR SHALL FURNISH AND INSTALL ALL BENDS, OFFSETS, ADDITIONAL PIPING WALL PENETRATIONS, EXISTING PIPE RE-ROUTING ETC. AS REQUIRED TO CONFIRM WITH EXISTING CONDITIONS AND TO PROVIDE A FULLY FUNCTIONAL SYSTEMS.
- THESE DRAWINGS ARE ACCOMPANIED BY SPECIFICATIONS OF THE BUILDING AND DETAILS OF THE INSTALLATIONS INDICATING THE LOCATIONS OF EQUIPMENT, PIPING, DUCTWORK, OUTLETS, LIGHT FIXTURES, ETC. ITEMS SPECIFICALLY MENTIONED IN THE SPECIFICATIONS BUT NOT SHOWN ON THE DRAWINGS AND ITEMS SHOWN ON THE DRAWINGS BUT NOT SPECIFICALLY MENTIONED IN THE SPECIFICATIONS SHALL BE INSTALLED BY THE CONTRACTOR UNDER THE APPROPRIATE SECTION OR WORK AS IF THEY WERE INDICATED BY BOTH.
- THE SPECIFICATIONS DETERMINE THE NATURE AND SETTING OF THE SEVERAL MATERIALS, THE DRAWINGS ESTABLISH THE QUANTITIES, DIMENSIONS, DETAILS AND THE SCHEDULES WHICH GIVE THE PERFORMANCE CHARACTERISTICS.
- SHOULD THE DRAWINGS DISAGREE IN THEMSELVES AND WITH THE SPECIFICATIONS AND WITH VARIOUS CODES AND REGULATIONS, THE BETTER QUALITY OR GREATER QUANTITY OF WORK OR MATERIALS SHALL BE ASSUMED AND ESTIMATED AND UNLESS OTHERWISE DIRECTED BY THE CONTRACTING OFFICER AND ENGINEER IN WRITING SHALL BE PERFORMED OR FURNISHED. IN CASE THE SPECIFICATIONS SHOULD NOT FULLY AGREE WITH THE SCHEDULES, THE LATER SHALL GOVERN.

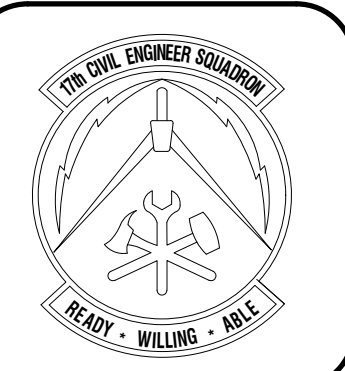


DATE				
REVISIONS				

Designed by	Drawn by	Reviewed by	Submitted by	PCES

FIRE STATION ADD/ALTER, B3321  
PROJECT NO. 1039839  
17th TRAINING WING  
GOODFELLOW AIR FORCE BASE, TEXAS

Project Number: 1039839	SHEET TITLE MECHANICAL SYMBOLS NOTES & ABBREVIATIONS
Date: JAN 2024	

SEQ.	SHEET	OF
31	M-001	50

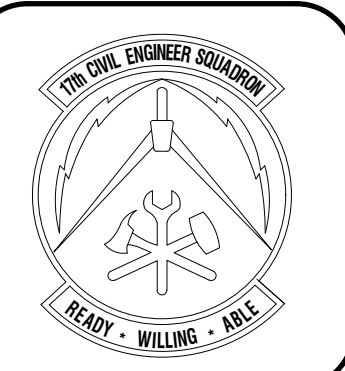

### GENERAL DEMOLITION NOTES:


1. REFERENCE SHEET M-001 FOR LEGENDS, SYMBOLS, ABBREVIATIONS AND FURTHER GENERAL NOTES.
2. NOT ALL EXISTING DUCTWORK IS SHOWN. DUCTWORK SHOWN IS THAT PERTAINING TO DEMOLITION / REMODEL. HVAC FACILITIES NOT SHOWN SHALL REMAIN IN SERVICE AND REMAIN UNTOUCHED.
3. PRIOR TO BIDDING, THE CONTRACTOR SHALL FIELD VERIFY EXISTING CONDITIONS INCLUDING: EXACT LOCATIONS, SIZES AND QUANTITIES OF ITEMS WHICH ARE TO BE REMOVED, RELOCATED, AND/OR ADDED. SUBMITTAL OF A BID MUST SIGNIFY WILLINGNESS TO COMPLY WITH THE CONTRACTING OFFICER'S REQUIREMENTS; THE DESIGN AND SPECIFICATIONS; AND ACCEPTANCE OF ON-SITE CONDITIONS AS THEY EXIST.
4. FACILITIES NOT INDICATED OR NOT INDICATED TO BE REMOVED MUST REMAIN IN SERVICE EXCEPT:
  - 4.1. FACILITIES IN WALLS AND PARTITIONS BEING REMOVED MUST BE REMOVED.
  - 4.2. FACILITIES WHICH INTERFERE WITH THE INSTALLATION OF NEW PARTITIONS MUST BE RELOCATED AS REQUIRED TO ACCOMMODATE THE NEW PARTITIONING.
5. VERIFY ALL EXISTING PIPE SIZES BEFORE REMOVAL.
6. PERFORM ALL DEMOLITION IN ACCORDANCE WITH SPECIFICATIONS AND COORDINATE WITH PHASING PLAN.
7. SECURE ALL OPENINGS THROUGH WALLS, ROOFS, AND FLOORS FROM WEATHER DURING CONSTRUCTION. SECURE OPENINGS THROUGH ROOFS AND FLOORS WITH APPROPRIATE FALL PROTECTION MEASURES PER OSHA REQUIREMENTS.
8. COVER ALL DUCTWORK OPENINGS DURING CONSTRUCTION TO PREVENT MIGRATION OF DUST. INSTALL CONSTRUCTION FILTERS AT ALL RETURN OPENINGS OF ALL EQUIPMENT DURING CONSTRUCTION AND REPLACE AS REQUIRED TO PREVENT MIGRATION OF DUST.
9. PROVIDE DUST BARRIERS TO CRITICAL EQUIPMENT AREAS.
10. WHERE DEMOLITION WORK REQUIRES WORK IN HALLWAY: THE CONTRACTOR SHALL BE RESPONSIBLE FOR REMOVING THE MINIMUM CEILING TILES REQUIRED TO PERFORM WORK AND STORING TEMPORARILY UNTIL DEMOLITION IS COMPLETE, UPON WHICH THE CONTRACTOR SHALL REINSTALL SUCH CEILING TILES. WHERE DEMO WORK INSIDE OF CORRIDOR REQUIRES DEMOLITION OF GYP. BD. CEILINGS, THE CONTRACTOR SHALL BE RESPONSIBLE FOR CUTTING AND REMOVING THE MINIMUM AMOUNT OF AREA REQUIRED TO PERFORM WORK AND PROVIDING NEW GYP. BD. OF SIMILAR TYPE AND THICKNESS UPON COMPLETION OF DEMO WORK. UPON COMPLETION OF DEMOLITION CONTRACTOR SHALL PATCH, REPAIR, TAPE, AND FLOAT SEAMS TO MATCH EXISTING.
11. WHERE DEMOLITION WORK REQUIRES WORK IN FITNESS AREAS: THE CONTRACTOR SHALL BE RESPONSIBLE FOR REMOVING THE MINIMUM CEILING TILES REQUIRED TO PERFORM WORK AND STORING TEMPORARILY UNTIL DEMOLITION IS COMPLETE. THE GOVERNMENT WILL BE RESPONSIBLE FOR REMOVING FITNESS MACHINES AND EQUIPMENT PRIOR TO START OF CONTRACTOR WORK, AND WILL REINSTALL MACHINES AND EQUIPMENT UPON COMPLETION OF WORK.

### KEYNOTES (X)


1. CONTRACTOR SHALL DEMOLISH EXISTING SUPPLY AND RETURN AIR DUCT GRILLS, BRANCHES, INSULATION, AND CAP DUCTWORK AT MAIN TRUNK.
2. CONTRACTOR SHALL DEMOLISH EXISTING THERMOSTAT INCLUDING WIRING, DEVICES, CONDUIT, AND CIRCUIT.

### LEGEND

--- DEMO

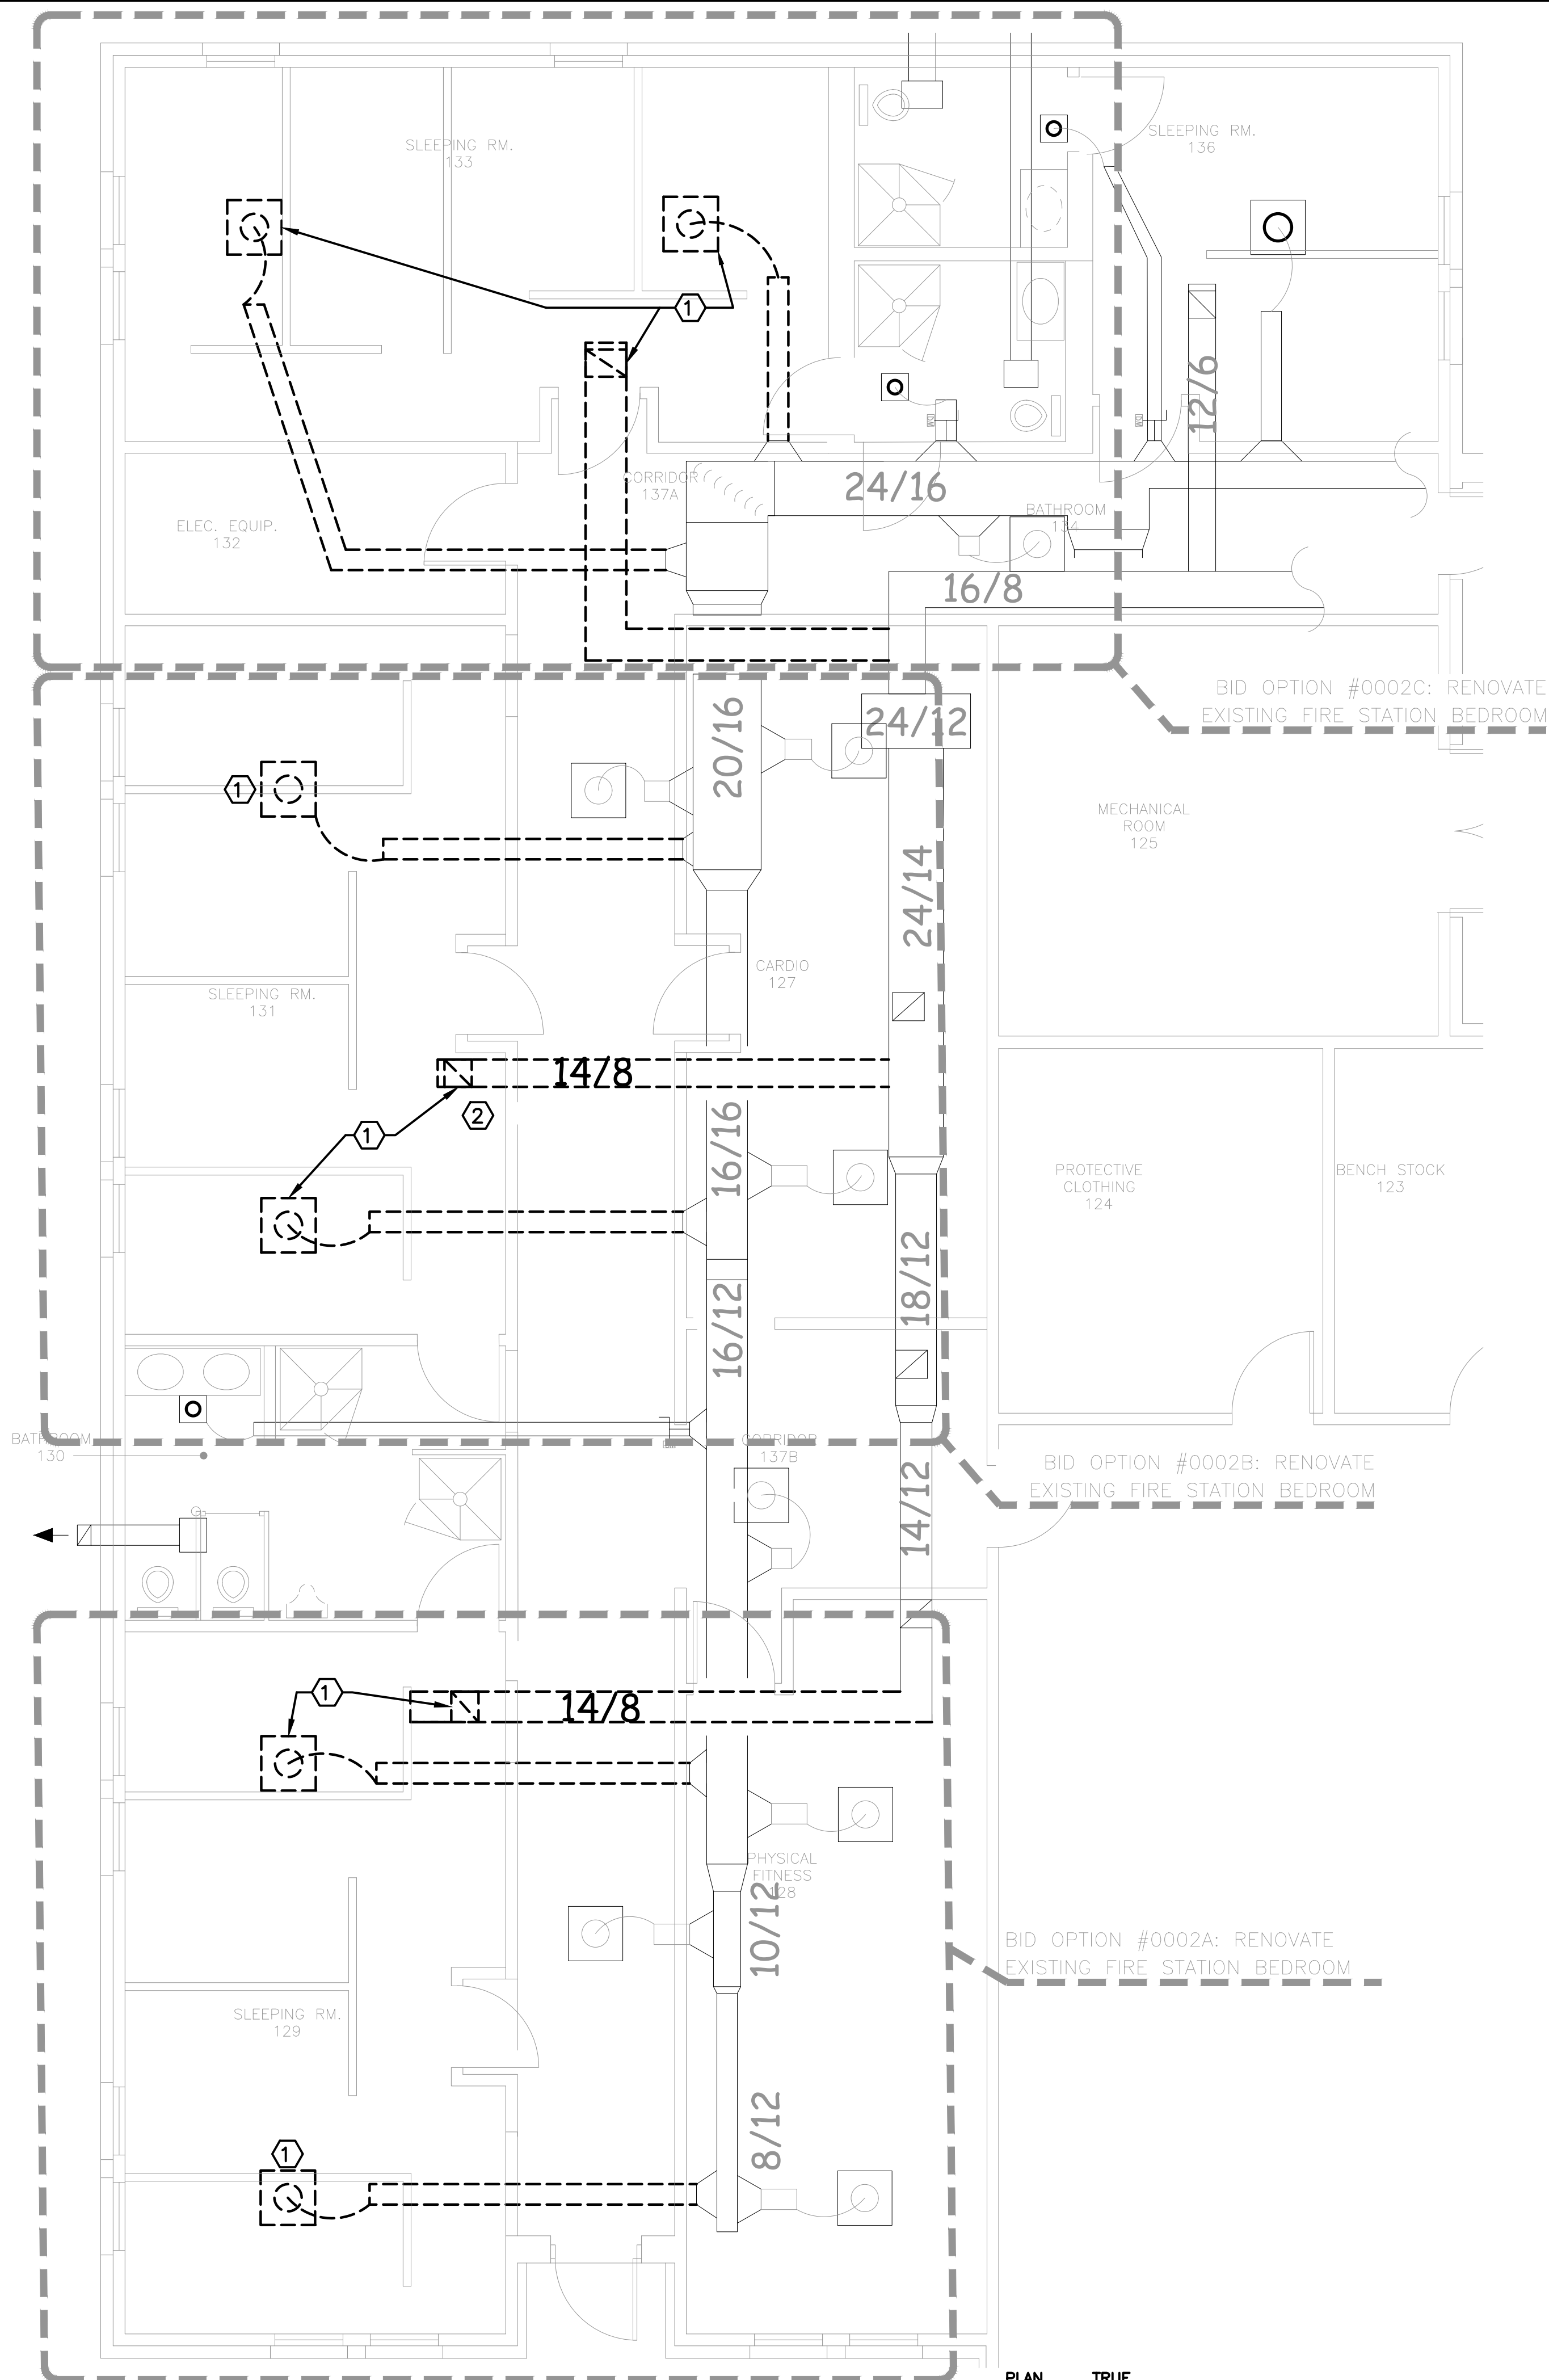

1 EXISTING BUILDING HVAC DEMOLITION PLAN  
SCALE: 1/8"=1'-0"

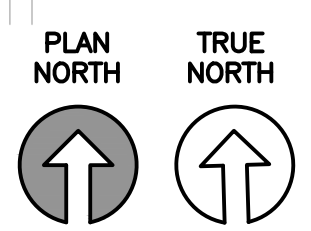

REVISIONS	DATE

Designed by JH/MLLA	Drawn by JH/MLLA	Reviewed by RT/JH	Submitted by PCES
------------------------	---------------------	----------------------	----------------------

PROJECT TITLE  
**FIRE STATION ADD/ALTER, B3321**  
**PROJECT NO. 1039839**  
**17th TRAINING WING**  
**GOODFELLOW AIR FORCE BASE, TEXAS**

Project Number: 1039839
SHEET TITLE HVAC DEMO - BID OPTIONS
Date: JAN 2024

SEQ.	SHEET	OF
32	MD-101	50




**GENERAL NOTES:**



1. REFERENCE SHEET M-001 FOR LEGEND, SYMBOLS, ABBREVIATIONS AND FURTHER GENERAL NOTES.

**KEYNOTES AS NOTATED BY: (X)**

1. FURNISH AND INSTALL AIR TERMINAL UNIT, CONTROLS, AND APPURTENANCES (REF. 1/M-501).
2. FURNISH AND INSTALL A BACNET COMPATIBLE THERMOSTAT.
3. FURNISH AND INSTALL A NEW EQUIPMENT PAD WITH 4" OF GRAVEL BASE BENEATH THE FOOTPRINT OF THE PAD. THE NEW EQUIPMENT PAD SHALL BE 5 1/2" THICK, 3,000 PSI CONCRETE WITH #4 REINFORCEMENT BARS ON 10" CENTERS EACH WAY. EXTEND THE PAD 4" BEYOND THE EDGES OF THE EQUIPMENT CURB. CHAMFER OR RADIUS THE TOP EDGES 1/2" X 1/2".
4. FURNISH AND INSTALL A DEDICATED OUTDOOR AIR SYSTEM UNIT, PLENUM CURB, CONTROLS AND APPURTENANCES. COORDINATE THE INSTALLATION OF THE DUCT SMOKE DETECTOR SERVING PAC-1 WITH THE FIRE ALARM INSTALLER.
5. FURNISH AND INSTALL A BAROMETRIC RELIEF DAMPER AND TERMINATE THE RELIEF AIR DUCT WITH A WEATHERHOOD WITH AN INSECT SCREEN.
6. FURNISH AND INSTALL A 2" HUB DRAIN AND DRY WELL. ROUTE CONDENSATE PIPING OVER THE HUB DRAIN, TURN DOWN AND TERMINATE WITH AN AIR GAP. FOR MORE INFORMATION REFERENCE DETAIL 2/M-502.
7. FURNISH AND INSTALL A DX UNIT AND APPURTENANCES (REF. 1/M-502). FURNISH AND INSTALL A CONTROL CIRCUIT AND REFRIGERANT PIPING FROM THE OUTDOOR UNIT TO THE INDOOR FAN COIL UNIT. SIZE AND INSTALL THE REFRIGERANT PIPING IN ACCORDANCE WITH THE MANUFACTURER'S RECOMMENDATIONS. THE CONNECTION FROM THE OUTDOOR UNIT TO THE INDOOR FAN COIL UNIT SHALL BE ROUTED IN LIQUID TIGHT FLEXIBLE CONDUIT.
8. ROUTE THE REFRIGERANT PIPING AND CONTROL CIRCUIT DOWN IN THE WALL TO 6" AFF. SLEEVE THE EXTERIOR FACING AND ROUTE THE PIPING AND CONTROL CIRCUIT OUT THROUGH THE SLEEVE. SEAL CAULK THE ANNULAR SPACE BETWEEN THE PIPING/CONDUIT AND THE SLEEVE WEATHER TIGHT.
9. ROUTE INSULATED 3/4" PIPING FROM THE INTEGRAL CONDENSATE PUMP UP TO ABOVE THE CEILING AND CONNECT TO THE GRAVITY SLOPED CONDENSATE PIPING.
10. ROUTE THE CONDENSATE DRAIN DOWN WITHIN THE WALL, PENETRATE OUTSIDE, TURN DOWN AND TERMINATE WITH A 2" AIR GAP.
11. FURNISH AND INSTALL A CEILING MOUNTED EXHAUST FAN, CONTROLS AND APPURTENANCES. THE EXHAUST FAN SHALL BE SUSPENDED AND SUPPORTED FROM THE STRUCTURE ABOVE. ROUTE EXHAUST DUCTWORK FROM THE UNITS DISCHARGE CONNECTION THROUGH A ROOF CURB TO A ROOF JACK TRANSITION AND CONNECT. THE ROOF CURB SHALL BE FABRICATED TO ACCOUNT FOR THE ROOF PITCH SUCH THAT THE ROOF JACK IS INSTALLED LEVEL.
12. FURNISH AND INSTALL A SUSPENDED ELECTRIC UNIT HEATER WITH INTEGRAL THERMOSTAT AND APPURTENANCES. THE HEATER SHALL BE SEQUENCED SUCH THAT THE TEMPERATURE OF THE ROOM DOES NOT FALL BELOW 45 DEG F (ADJ.).
13. CONTRACTOR SHALL PROVIDE FLUE EXHAUST (FE) AND COMBUSTION AIR INTAKE (CIA) DUCTWORK THROUGH THE EXTERIOR WALL AND TERMINATE WITH A MFR APPROVED 45 DEGREE DOWN ELBOWS INSECT SCREEN. TERMINATION POINT SHALL BE 10'-6" ABOVE FINISHED FLOOR.

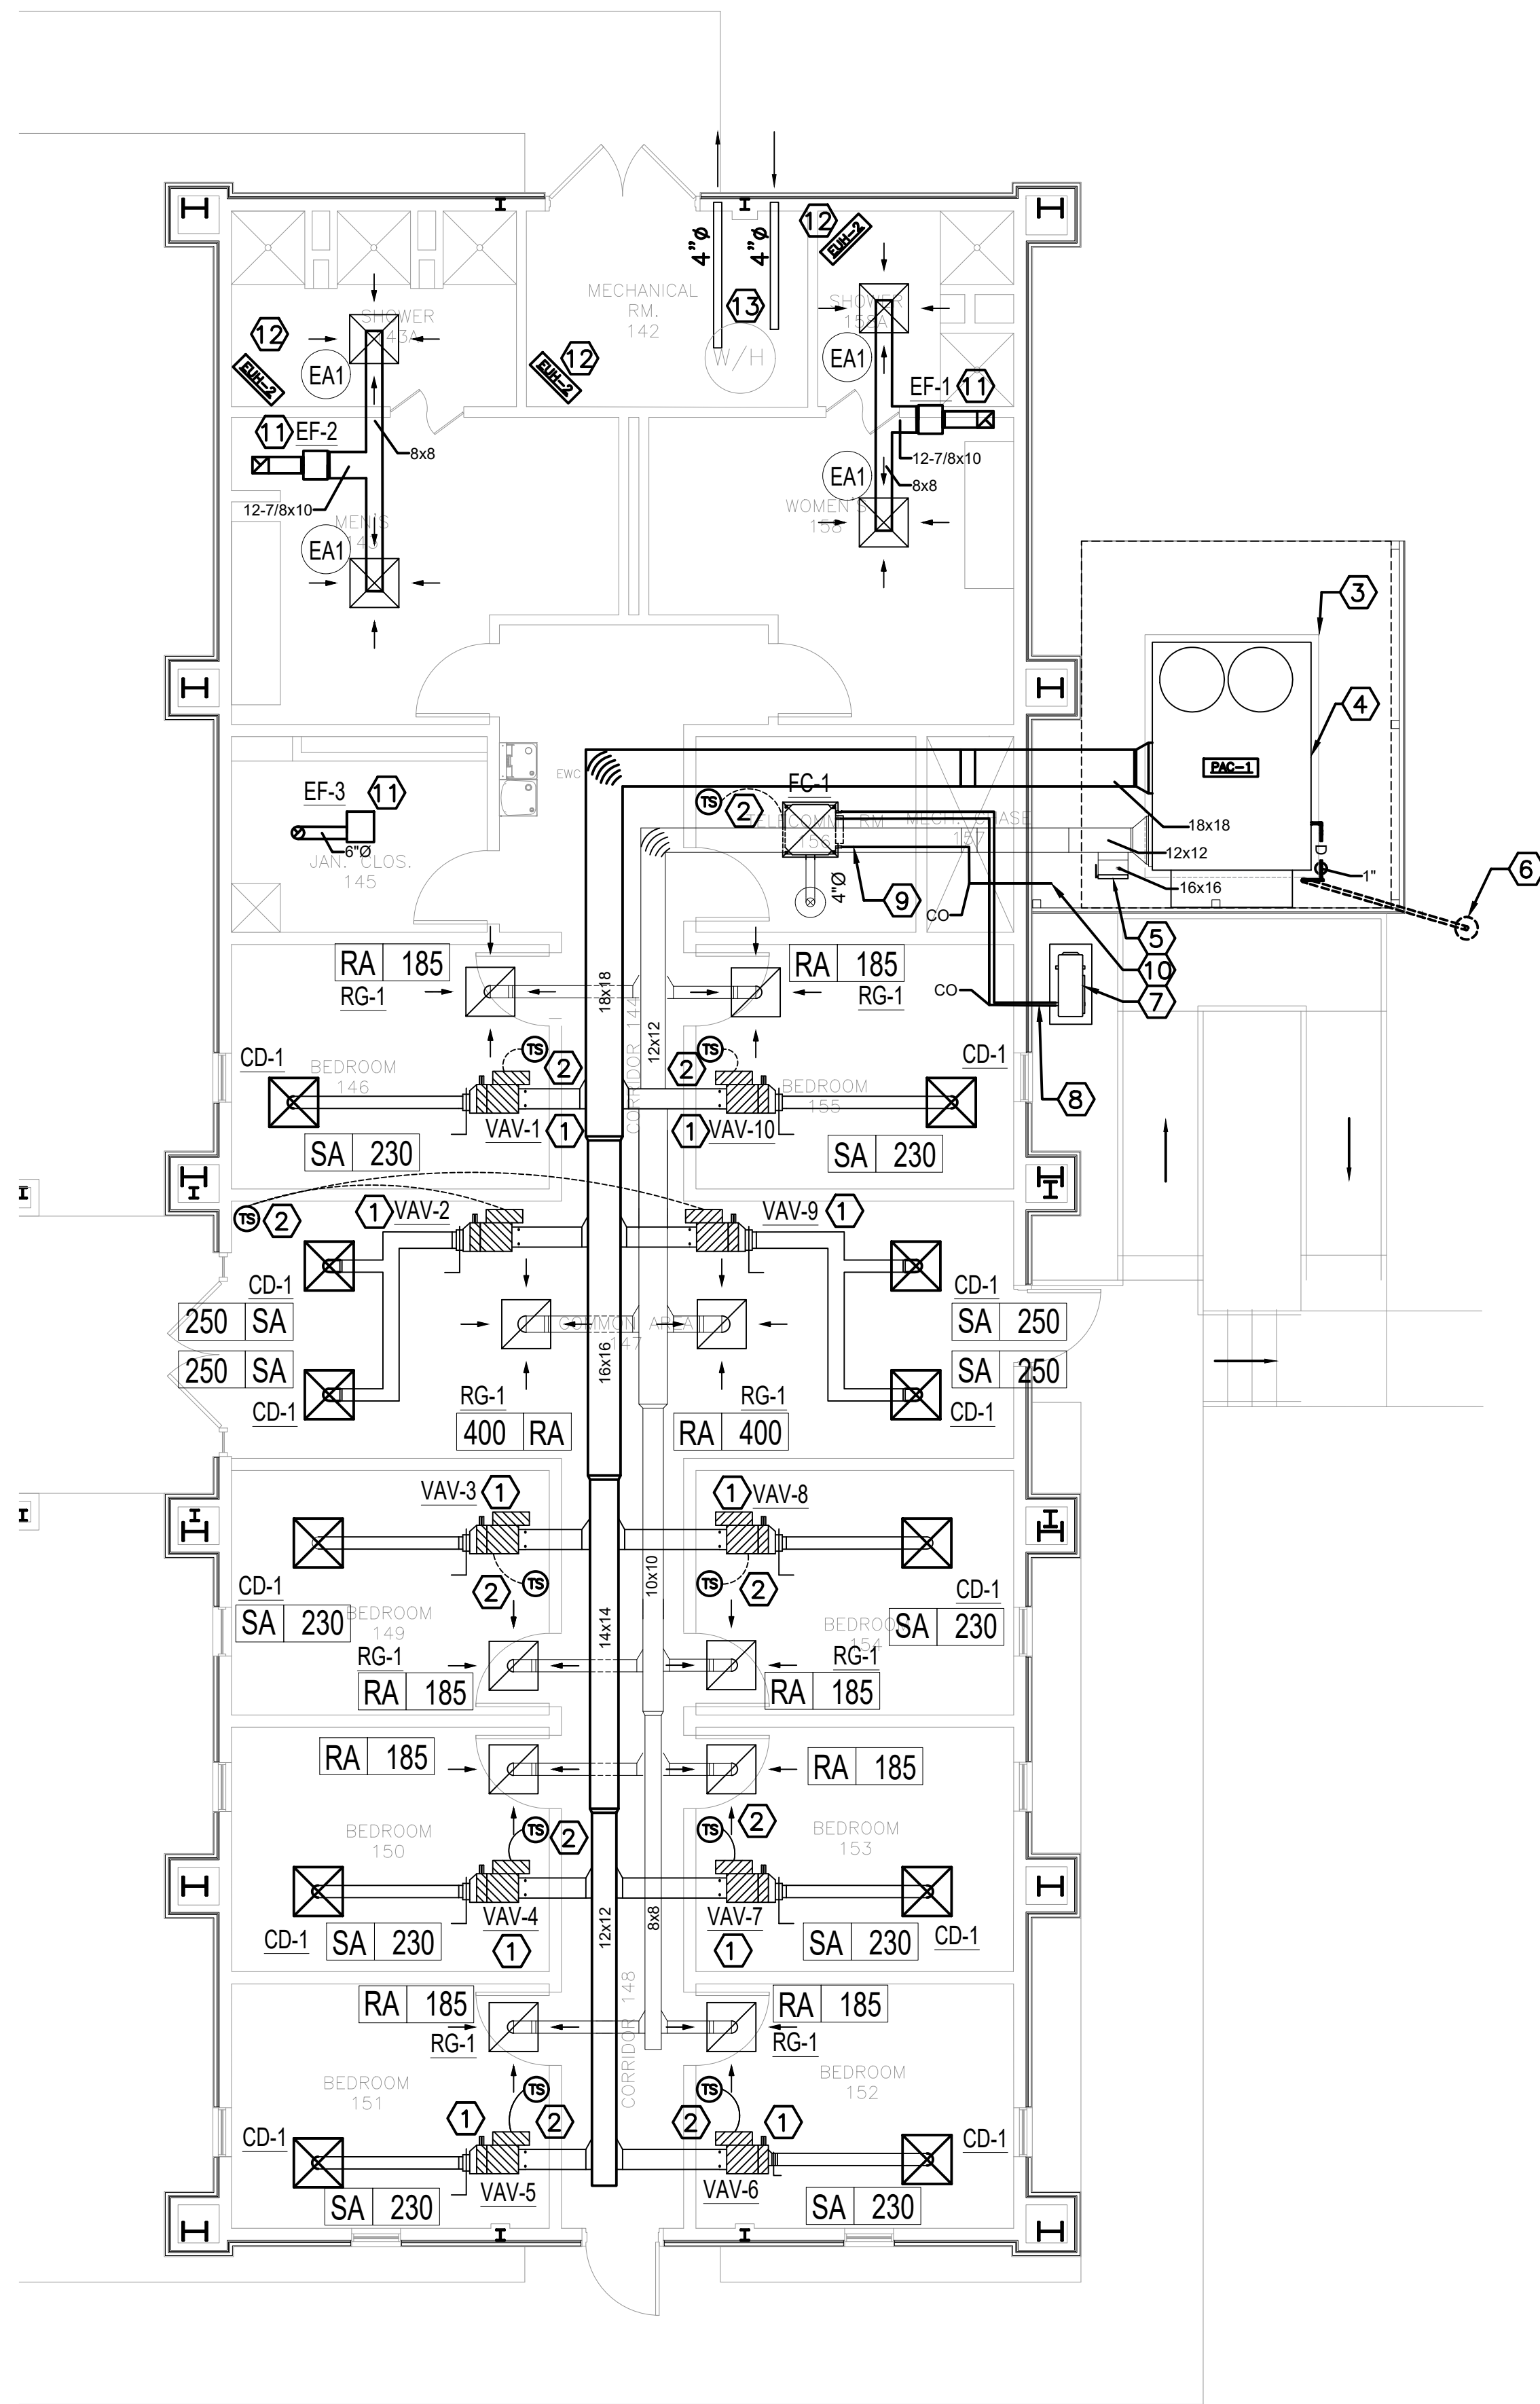

1 HVAC PLAN - ADDITION  
3/8" = 1' - 0"

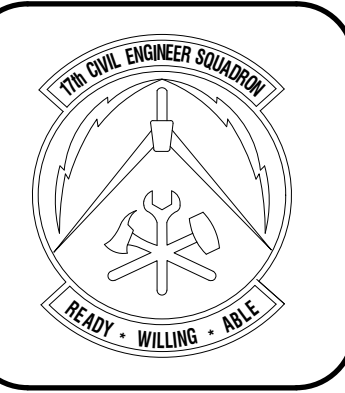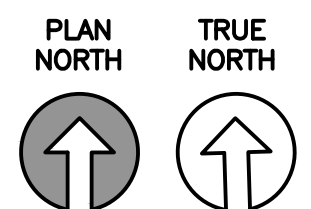


REVISIONS	DATE

Designed by JH/MLLA	Drawn by JH/MLLA	Reviewed by RT/JH	Submitted by PC/ES
------------------------	---------------------	----------------------	-----------------------

PROJECT TITLE  
**FIRE STATION ADD/ALTER, B3321  
PROJECT NO. 1039839  
17th TRAINING WING  
GOODFELLOW AIR FORCE BASE, TEXAS**

Project Number: 1039839
SHEET TITLE HVAC PLAN - NEW ADDITION
Date: JAN 2024

SEQ.	SHEET	OF
33	M-101	50

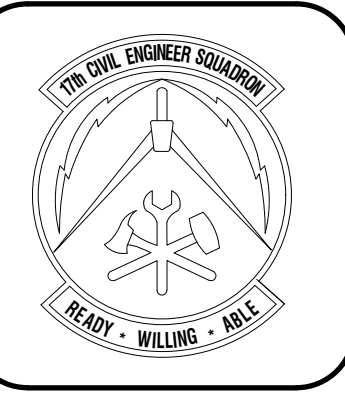

**GENERAL NOTES:**

1. REFERENCE SHEET M-101 FOR LEGEND, SYMBOLS, ABBREVIATIONS, AND FURTHER GENERAL NOTES.
2. MINOR ALTERATION WORK INCLUDING: CUT, PATCH, PAINT AND OTHERWISE FINISH SURFACES SHALL MATCH ADJACENT SURFACES.
3. REGARDLESS OF WHICH BID OPTION IS AWARDED, THE CONTRACTOR WILL BE RESPONSIBLE FOR PROVIDING (1) HEAT PUMP, CONCRETE PAD, CORRESPONDING PIPING FOR A COMPLETE AND FUNCTIONAL SYSTEM.

**KEYNOTES:** ⓧ

1. FURNISH AND INSTALL A NEW EQUIPMENT PAD WITH 4" OF GRAVEL BASE BENEATH THE FOOTPRINT OF THE PAD. THE NEW EQUIPMENT PAD SHALL BE 5-1/2" THICK, 3000 PSI CONCRETE WITH #4 REINFORCEMENT BARS ON 10" CENTERS EACH WAY. EXTEND THE PAD 4" BEYOND THE EDGES OF THE EQUIPMENT CURB. CHAMFER OR RADIUS THE TOP EDGES 1/2" X 1/2".
2. FURNISH AND INSTALL A HEAT PUMP AND PERTINENT APPURTENANCES (REF 7/M-501), FURNISH AND INSTALL A CONTROL CIRCUIT AND REFRIGERANT PIPING FROM THE HEAT PUMP UNIT TO EACH INDOOR UNIT (6 TOTAL). SIZE AND INSTALL THE REFRIGERANT PIPING IN ACCORDANCE WITH THE MANUFACTURER'S RECOMMENDATIONS. THE CONNECTION TO THE HEAT PUMP UNIT SHALL BE ROUTED IN LIQUID TIGHT FLEXIBLE CONDUIT.
3. FURNISH AND INSTALL A INDOOR UNIT AND PERTINENT APPURTENANCES IN ACCORDANCE WITH MFR INSTRUCTIONS.
4. FURNISH AND INSTALL A TEMPERATURE SENSOR.
5. ROUTE THE REFRIGERANT PIPING AND CONTROL CIRCUIT DOWN IN THE WALL TO 6" AFF. SLEEVE THE EXTERIOR FACING AND ROUTE THE PIPING AND CONTROL CIRCUIT OUT THROUGH THE SLEEVE. SEAL CAULK THE ANNULAR SPACE BETWEEN THE PIPING/CONDUIT AND SLEEVE WEATHER TIGHT.


REVISIONS	DATE

Designed by JH/MLA	Drawn by JH/MLA	Reviewed by RT/JH	Submitted by PCES
-----------------------	--------------------	----------------------	----------------------

PROJECT TITLE  
**FIRE STATION ADD/ALTER, B3321**  
**PROJECT NO. 1039839**  
**17th TRAINING WING**  
**GOODFELLOW AIR FORCE BASE, TEXAS**

Project Number: 1039839
SHEET TITLE HVAC PLAN - BID OPTIONS
Date: JAN 2024

SEQ.	SHEET	OF
34	<b>M-102</b>	50

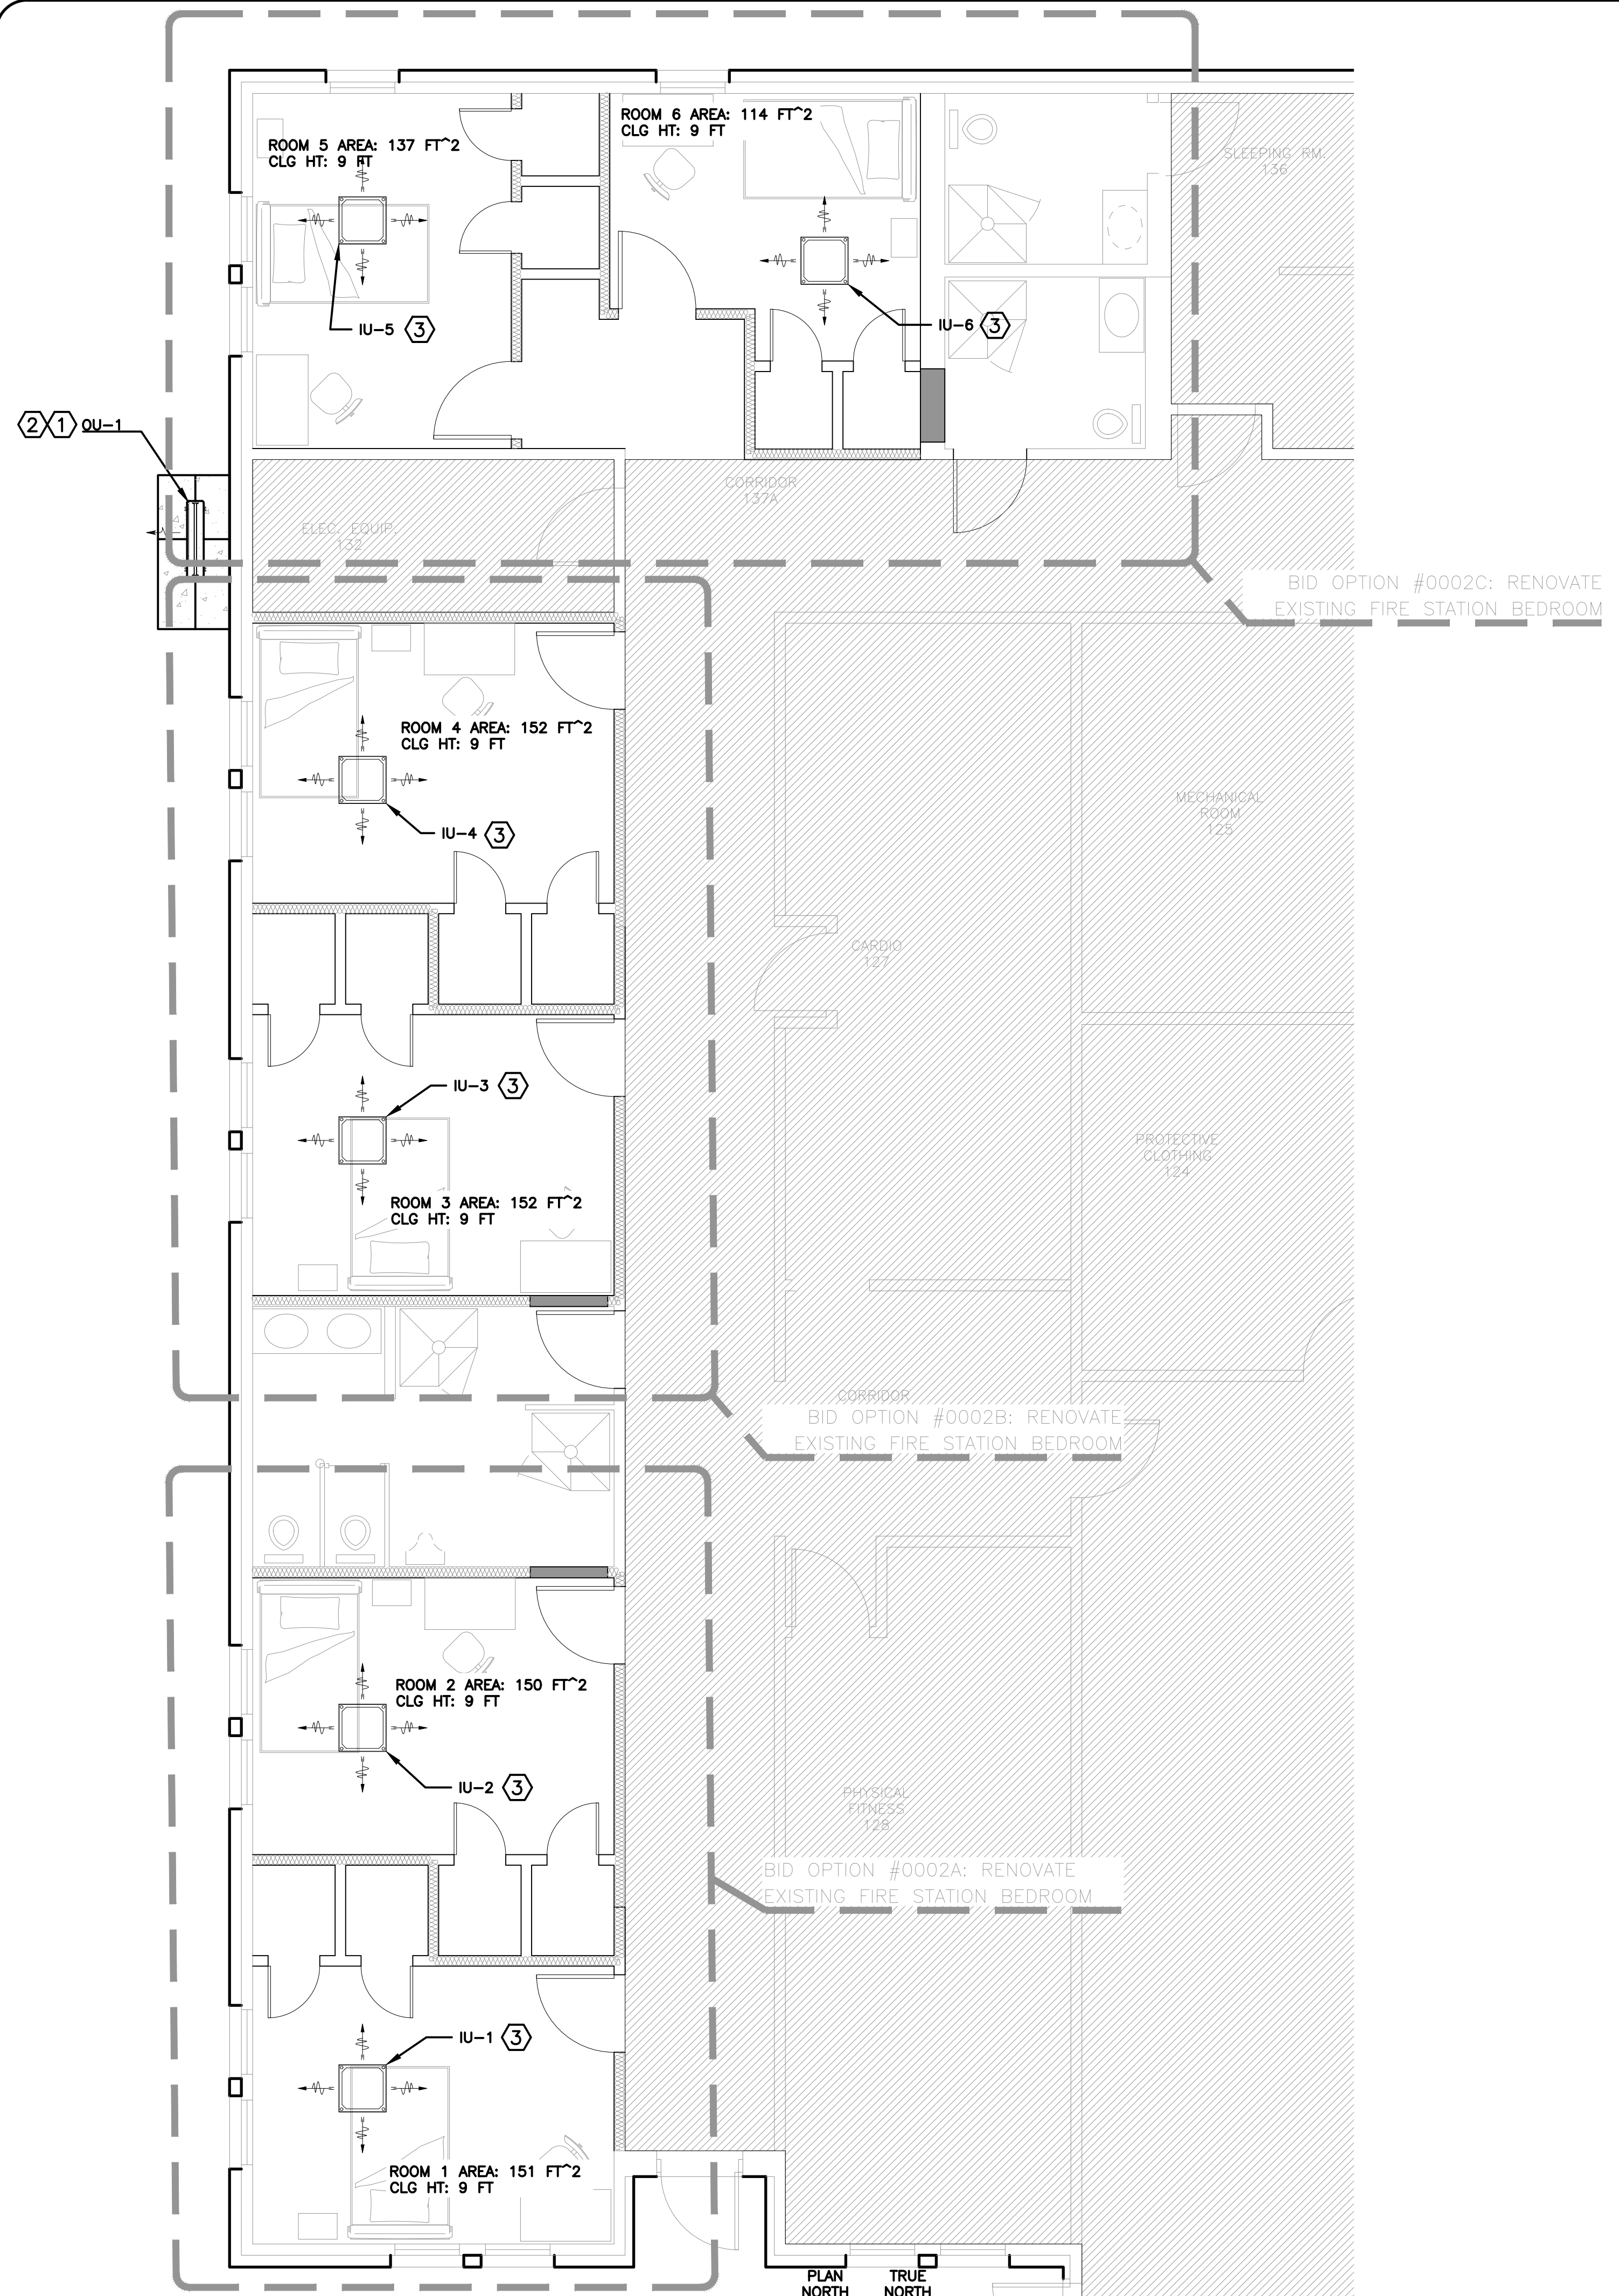

**1 HVAC PLAN - BID OPTIONS**  
SCALE: 1/4"=1'-0"





PACKAGED UNIT SCHEDULE																
MARK	OUTSIDE AIR FLOW RATE (CFM)	EXTERNAL STATIC PRESSURE AT MAXIMUM AIR FLOW (W.G.)	SPACE SHR	COOLING								ELECTRICAL			NOTES	
				MIN. COOLING SUPPLY AIR FLOW RATE	MAX COOLING SUPPLY AIR FLOW RATE (CFM)	ENTERING AIR DB TEMP. (F)	ENTERING AIR (WB) TEMP. (F)	LEAVING AIR DB TEMP (F)	LEAVING AIR WB TEMP. (F)	SENSIBLE CAPACITY (MBH)	LATENT CAPACITY (MBH)	TOTAL CAPACITY (MBH) AT 97.8 (F) AMBIENT	VOLTS/PHASE	MCA		MOCP
PAC-1	375	2"	0.916	-	2840	74.3	60.3	52.6	51.3	63.7	5.9	69.6	208/3	74.1	90	1,2,3,4,5,6,7,8

NOTES:  
1. FURNISH AND INSTALL PACKAGED UNIT WITH A METAL CONDENSER COIL (HAIL) GUARD.  
2. FURNISH AND INSTALL PACKAGED UNIT WITH A FILTER RACK AND 2" THICK MERV 13 FILTERS.  
3. FURNISH AND INSTALL THE UNIT WITH A SINGLE POINT ELECTRICAL CONNECTION AND NON-CORROSIVE DRAIN PAN.  
4. THE CONDENSER SETION SHALL BE SELECTED BASED ON AN OUTDOOR AMBIENT AIR TEMPERATURE OF 105 F AT THE COOLING CONDITIONS.  
5. FURNISH AND INSTALL UNIT WITH AN ECONOMIZER SEQUENCE, DAMPERS, RELIEF DAMPER, CONTROLS, AND ACCESSORIES.  
6. THE PACKAGE UNIT SHALL BE A TRANE "HORIZON" MODEL OR APPROVED EQUAL.  
7. SYSTEM SHALL INCLUDE LOW AMBIENT CONTROL.  
8. SYSTEM SHALL INCLUDE SOUND ATTENUATION PACKAGE

FAN COIL UNIT SCHEDULE													
MARK	NOMINAL COOLING CAPCAITY (BTUH)	SUPPLY AIR FLOW (CFM)	OUTSIDE AIR (CFM)	EFFICIENCY RATING (SEER)	ELECTRICAL								NOTES
					FAN COIL UNIT				HEAT PUMP UNIT				
					MARK	VOLTS/P HASE/HZ	MCA	MAX FUSE	MARK	VOLTS/PHASE	MCA	MAX FUSE	
FC/HP-1	18000	450	5	17	FC-1	POWERED BY OUTDOOR UNIT			HP-1	208-230/1	18.3	20	1,2,3,4,5,6

NOTES:  
1. FURNISH AND INSTALL THE HEAT PUMP WITH CONDENSER COIL (HAIL) GUARD AND OPTIONAL WIND BAFFLE FOR EXTENDED OPERATING RANGE.  
2. FURNISH AND INSTALL THE UNIT WITH SINGLE POINT OF ELECTRICAL CONNECTION.  
3. FURNISH AND INSTALL THE UNIT WITH BACNET COMPATIBLE THERMOSTAT.  
4. FURNISH AND INSTALL THE UNIT WITH A LOW AMBIENT STARTUP KIT.  
5. FURNISH AND INSTALL THE FC UNIT WITH AN INTERGRAL CONDENSATE PUMP.  
6. THE SYSTEM SHALL BE MANUFACTURED BY TRANE, CARRIER, BRYANT, OR APPROVED EQUAL.

FAN SCHEDULE										
MARK	Description	CFM	EXTERNAL STATIC PRESSURE (W/G)	SOUND (SONES)	FAN			ELECTRICAL	REFERENCE SELECTION: GREENHECK	NOTES
					RPM	WATTS	DRIVE			
EF-1	144 MALE	290	0.25	1.3	1095	73	DIRECT	115/1	CSP-A390	1,2,3
EF-2	157 FEMALE	240	0.25	1.3	964	48	DIRECT	115/1	CSP-A390	1,2,3
EF-3	146 JANITOR	80	0.25	0.9	796	80	DIRECT	115/1	SP-B110	1,2

NOTES:  
1. FURNISH AND INSTALL FAN WITH INTEGRAL BACKDRAFT DAMPER AND FAN SPEED CONTROLLER.  
2. FURNISH AND INSTALL FEMP OR ENERGY STAR COMPLIANT FAN.  
3. FURNISH AND INSTALL FAN TO BE CONTROLLED TO OPERATE WITH THE LIGHTIN OCCUPANCY OR VACANCY SENSOR + 15 MINUTES.

ELECTRIC UNIT HEATER SCHEDULE			
MARK	HEATER SIZE	ELECTRICAL VOLTS/PHASE	NOTES
EUH-1	4 KW	208/3	1,2
EUH-2	4 KW	208/3	1,2
EUH-3	3 KW	208/3	1,2

NOTES:  
1. FURNISH AND INSTALL AN ELECTRIC RESISTANCE HEATER WITH INTEGRAL THERMOSTAT AND APPURTENCES  
2. MOUNT THE UNIT HEATER SUSPENDED FROM THE STRUCTURE

DUCTLESS VRF W/ HEAT RECOVERY SCHEDULE															
MARK	NOMINAL COOLING CAPCAITY (BTUH)	NOMINAL HEATING CAPCAITY (BTUH)	SUPPLY AIR FLOW (CFM)	OUTSIDE AIR (CFM)	EFFICIENCY RATING (SEER)	ELECTRICAL								BASIS OF DESIGN	NOTES
						FAN COIL UNIT				HEAT PUMP UNIT					
						MARK	VOLTS/PHASE/HZ	MCA	MAX FUSE	MARK	VOLTS/PHASE/HZ	MCA	MAX FUSE		
OU-1	6000	6600	-	-	20.5	-	-	-	-	OU-1	208-230/1/60	36.3	40	6	1,2,3,4,5
IU-1	7500	8500	220/270/320	-	-	IU-1	208-230/1/60	0.5	15	-	-	-	-	7	5
IU-2	7500	8500	220/270/320	-	-	IU-2	208-230/1/60	0.5	15	-	-	-	-	7	5
IU-3	7500	8500	220/270/320	-	-	IU-3	208-230/1/60	0.5	15	-	-	-	-	7	5
IU-4	7500	8500	220/270/320	-	-	IU-4	208-230/1/60	0.5	15	-	-	-	-	7	5
IU-5	7500	8500	220/270/320	-	-	IU-5	208-230/1/60	0.5	15	-	-	-	-	7	5
IU-6	7500	8500	220/270/320	-	-	IU-6	208-230/1/60	0.5	15	-	-	-	-	7	5


NOTES:  
1. FURNISH AND INSTALL THE HEAT PUMP WITH CONDENSER COIL (HAIL) GUARD AND OPTIONAL WIND BAFFLE FOR EXTENDED OPERATING RANGE.  
2. FURNISH AND INSTALL THE UNIT WITH SINGLE POINT OF ELECTRICAL CONNECTION.  
3. FURNISH AND INSTALL THE UNIT WITH BACNET COMPATIBLE THERMOSTAT.  
4. FURNISH AND INSTALL THE UNIT WITH A LOW AMBIENT STARTUP KIT.  
5. THE SYSTEM SHALL BE MANUFACTURED BY TRANE, CARRIER, BRYANT, OR APPROVED EQUAL.  
6. TOSHIBA/CARRIER MCY-MAP0607H5-UL-HEAT PUMP  
7. TOSHIBA/CARRIER MMU-AP0071MH2UL-COMPACY 4-WAY CASSETTE

AIR DEVICE SCHEDULE										
MARK	TYPE	NECK SIZE (IN)	MODULE SIZE (IN)	MATERIAL	MAX. CFM	THROW AT 100 FEET	TOTAL STATIC PRESSURE (IN WG)	NOISE CRITERIA RATING (NC)	BASIS OF DESIGN:	NOTES
CD1	SUPPLY CEILING DIFFUSER	6 Ø	24X24	ALUMINUM	275	5	0.099	25-30	TITUS OMNI	1
RG1	RETURN CEILING GRILLE	22X10	24X24	ALUMINUM	700	-	0.06	18	TITUS 350 FL	1
EG1	EXHAUST CEILING GRILLE	8X8	24X24	ALUMINUM	415	-	0.013	18	GREENHECK XG-CC5	1

NOTES:  
1. FURNISH AND INSTALL AIR DEVICE WITH LAY-IN BORDER FRAME FOR LAY-IN CEILING AND SURFACE MOUNTING FRAME FOR ALL OTHER APPLICATIONS.

AIR TERMINAL UNIT SCHEDULE										
MARK	TYPE	CFM			HEATING			ELECTRICAL		
		MAX	MIN	CFM	MIN. KW (NOTE 3)	NOMINAL KW (NOTE 3)	VOLTAGE /PHASE	MCA	MOCP	
VAV-1	SINGLE DUCT W/HEATING COIL (BEDROOM 146)	230	150	150	2.2	2.5	208/3	8.7	15	
VAV-2	SINGLE DUCT W/HEATING COIL (COMMON AREA 147W)	500	300	300	4.3	4.5	208/3	15.6	20	
VAV-3	SINGLE DUCT W/HEATING COIL (BEDROOM 149)	230	150	150	2.2	2.5	208/3	8.7	15	
VAV-4	SINGLE DUCT W/HEATING COIL (BEDROOM 150)	230	150	150	2.2	2.5	208/3	8.7	15	
VAV-5	SINGLE DUCT W/HEATING COIL (BEDROOM 151)	230	150	150	2.2	2.5	208/3	8.7	15	
VAV-6	SINGLE DUCT W/HEATING COIL (BEDROOM 152)	230	150	150	2.2	2.5	208/3	8.7	15	
VAV-7	SINGLE DUCT W/HEATING COIL (BEDROOM 153)	230	150	150	2.2	2.5	208/3	8.7	15	
VAV-8	SINGLE DUCT W/HEATING COIL (BEDROOM 154)	230	150	150	2.2	2.5	208/3	8.7	15	
VAV-9	SINGLE DUCT W/HEATING COIL (COMMON AREA 147E)	500	300	300	4.3	4.5	208/3	15.6	20	
VAV-10	SINGLE DUCT W/HEATING COIL (BEDROOM 155)	230	150	150	2.2	2.5	208/3	8.7	15	

NOTES APPLY TO ALL VAV AIR TERMINAL UNITS:  
1. INLET STATIC = 1.5" W.C.; MAX UNIT PRESSURE DROP = 0.5" W.C.; MAX NC = 25  
2. PROVIDE DUCT TRANSITION AT UNIT WHERE UNIT INLET SIZE AND DUCT RUNOUT SIZE ARE DIFFERENT.  
3. PROVIDE SCR CONTROLLED MODULATING ELECTRIC REHEAT COIL FOR VAVs

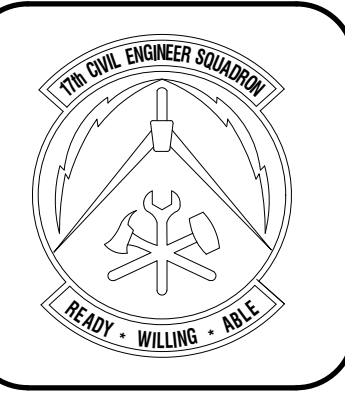

REVISIONS	DATE

Designed by JH/ML/A	Drawn by JH/ML/A	Reviewed by RT/JH	Submitted by PC/ES
------------------------	---------------------	----------------------	-----------------------


PROJECT TITLE  
**FIRE STATION ADD/ALTER, B3321**  
**PROJECT NO. 1039839**  
**17th TRAINING WING**  
**GOODFELLOW AIR FORCE BASE, TEXAS**

Project Number: 1039839
SHEET TITLE HWC SCHEDULES
Date: JAN 2024

SEQ.	SHEET	OF
36	M-601	50





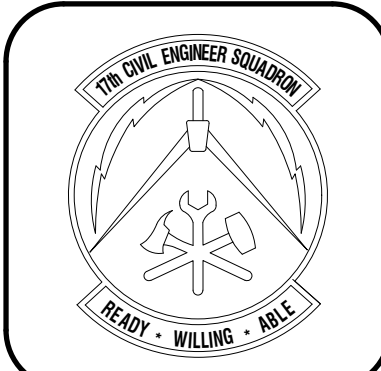

# ELECTRIC STANDARD SYMBOLS AND ABBREVIATIONS (NOT ALL APPLY)

STANDARD SYMBOLS - POWER		STANDARD SYMBOLS - POWER		STANDARD SYMBOLS - LIGHTING		STANDARD SYMBOLS - COMM/DATA			
SYMBOL	DESCRIPTION	SYMBOL	DESCRIPTION	SYMBOL	DESCRIPTION	SYMBOL	DESCRIPTION		
	SINGLE RECEPTACLE, 125V, 30A, NEMA 5-30R		BALANCED MAGNETIC SWITCH		LED LIGHT, RECESSED, SURFACE OR PENDANT MOUNT (SEE FIXTURE SCHEDULE FOR MOUNTING TYPE)		DATA OUTLET, WALL MOUNT		
	DUPLEX RECEPTACLE, 125V, 20A, NEMA 5-20R		SAFETY SWITCH AND MOTOR CONTROLLER, COMBINATION, PROVIDE WITH ELECTRICAL LOCK-OUT PROVISIONS. MOUNT TOP AT 72" ABOVE FLOOR UNLESS NOTE OTHERWISE		LED LIGHT, SURFACE, PENDANT, OR RECESSED MOUNT, EMERGENCY (SEE FIXTURE SCHEDULE FOR MOUNTING TYPE)		DATA JACK, FLOOR MOUNT		
	DUPLEX RECEPTACLE, GFCI, 125V, 20A, NEMA 5-20R		FUSED DISCONNECT, MOUNT TOP AT 72" ABOVE FLOOR UNLESS NOTE OTHERWISE		LED LIGHT, STRIP		COMBINATION DATA/TELEPHONE OUTLET, WALL MOUNT		
	DUAL DUPLEX RECEPTACLE, 125V, 15A, NEMA 5-15R		SAFETY SWITCH, MOUNT TOP AT 72" ABOVE FLOOR UNLESS NOTE OTHERWISE		LED LIGHT, STRIP, NIGHT LIGHT		COMBINATION DATA/TELEPHONE JACK, FLOOR MOUNT		
	DUPLEX RECEPTACLE, GFCI, 125V, 15A, NEMA 5-15R		ENCLOSED BREAKER, MOUNT TOP AT 72" ABOVE FLOOR UNLESS NOTE OTHERWISE		LED LIGHT, STRIP, EMERGENCY		TELEPHONE OUTLET, WALL MOUNT		
	DUPLEX RECEPTACLE, 125V, 15A, NEMA 5-15R		SWITCH-MOTOR RATED, THERMAL OVERLOAD, FOR FRACTIONAL HORSEPOWER MOTORS		LED LIGHT, CEILING OR PENDANT		TELEPHONE JACK, FLOOR MOUNT		
	DUPLEX RECEPTACLE, CEILING SURFACE MOUNTED, 125V, 15A, NEMA 5-15R		CABLE TRAY		LED LIGHT, RECESSED		PA/AUDIO		
	DUAL DUPLEX RECEPTACLE, RAISED FLOOR MOUNT, 125V, 20A, NEMA 5-20R		ELECTRICAL PRIMARY, AERIAL		EXIT LIGHT, WALL MOUNT, SINGLE FACE, 90 MINUTE BATTERY PACK, R LETTER MEANS RECESSED		SPEAKER CEILING MOUNTED		
	RECEPTACLE, 20A, 125V, 2P/3W, LOCKING, NEMA REF XX-20R		ELECTRICAL PRIMARY, AERIAL, EXISTING		SWITCH, SINGLE POLE SINGLE THROW (SPST) SWITCH, SMALL LETTER INDICATES DEVICE SWITCHED		SPEAKER WALL MOUNTED		
	POWER POLE, RECESS MOUNT		ELECTRICAL PRIMARY, UNDERGROUND		SWITCH, DOUBLE POLE SINGLE THROW (DPST) SWITCH, SMALL LETTER INDICATES DEVICE SWITCHED (IF USED)		COMMUNICATION CABLE, UNDERGROUND, EXISTING		
	PLUG-IN STRIP, AS SPECIFIED ON PLANS		ELECTRICAL PRIMARY, UNDERGROUND, EXISTING		SWITCH, SINGLE POLE DOUBLE THROW (SPDT-3 POLE) SWITCH, SMALL LETTER INDICATES DEVICE SWITCHED (IF USED)		FIBER OPTIC CABLE		
	PANELBOARD, 240V OR 208V, RECESS MOUNT		ELECTRICAL SECONDARY, AERIAL		SWITCH, DOUBLE POLE DOUBLE THROW (DPDT-4 POLE) SWITCH, SMALL LETTER INDICATES DEVICE SWITCHED (IF USED)	<b>ANNOTATIVE SYMBOLS</b>			
	PANELBOARD, 240V OR 208V, SURFACE MOUNT		ELECTRICAL SECONDARY, AERIAL, EXISTING		SWITCH, SINGLE POLE, DIMMING TYPE SWITCH, SMALL LETTER INDICATES DEVICE SWITCHED (IF USED)				
	PANELBOARD, 480V, RECESS MOUNT		ELECTRICAL SECONDARY, UNDERGROUND		SWITCH, EMERGENCY POWER OFF		KEY NOTE X - DENOTES THE KEY NOTE NUMBER		
	PANELBOARD, 480V, SURFACE MOUNT		ELECTRICAL SECONDARY, UNDERGROUND, EXISTING		SWITCH, SINGLE POLE, WEATHERPROOF SWITCH, SMALL LETTER INDICATES DEVICE SWITCHED (IF USED)		CIRCUIT IDENTIFICATION XX - DENOTES FEEDER NUMBER/IDENTIFICATION		
	FIRE ALARM CONTROL PANEL, SURFACE MOUNT		ELECTRICAL DUCTBANK		PHOTOCELL, HEAVY DUTY DIE CAST HOUSING, SPST, 120V OR 208/277V, 1800VA	<b>TITLE</b> NOT TO SCALE			
	JUNCTION BOX, SIZE FOR WIRE FILL OR AS SPECIFIED		CEILING FAN, RECESSED		OCCUPANCY SENSOR, CEILING MOUNT				
	JUNCTION BOX, FLOOR MOUNT		WATT-HOUR METER		HUMIDITY SENSOR, CEILING MOUNT	<b>DETAIL BUBBLE</b> TITLE - INDICATES THE TITLE OF THE DETAIL SCALE - INDICATES THE SCALE OF THE DETAIL (IF APPLICABLE) X - DENOTES DETAIL NUMBER Y - DENOTES SHEET NUMBER Z - DENOTES REFERENCE SHEET NUMBER			
	GENERATOR, AS SPECIFIED ON PLANS		CONDUIT OR WIRE REPAIR ITEM						
	GROUND ROD		HAND-OFF-AUTO SWITCH	<b>ABBREVIATIONS</b>					
	GROUND		START/STOP STATION						
	TRANSFORMER, PAD MOUNT/POLE MOUNT AS SCHEDULED		AUXILIARY SWITCH - FIRST LETTER DENOTES SWITCH TYPE P=PRESSURE; T=TEMPERATURE; V=VIBRATION; F=FLOW	A	AMPERE(S)	F.C.O.	FLOOR CLEAN OUT	N.T.S.	NOT TO SCALE
	EMERGENCY MANAGEMENT CONTROL SYSTEM PANEL		ON/OFF SWITCH	A.C.	ABOVE COUNTER	F.D.	FIRE DAMPER	O	OXYGEN
	CABLE TV OUTLET		STOP PUSH BUTTON	A/C	AIR CONDITIONED	FLR	FLOOR	O.A.	OUTSIDE AIR
	EXPOSED RACEWAY, CROSS LINES INDICATE WIRE NUMBER (   -PHASE,   -NEUTRAL,   -SWITCH,   -GROUND)	<b>STANDARD SYMBOLS - LIGHTING</b>		A.D.	ACCESS DOOR	FPM	FEET PER MINUTE	OBD	OPPOSED BLADE DAMPER
	CONCEALED RACEWAY, IN WALLS OR ABOVE CEILING				WALL PACK, WALL MOUNT	A.F.F.	ABOVE FINISHED FLOOR	F.S.D.	FIRE/SMOKE DAMPER
	POINT OF CONNECTION FROM NEW TO EXISTING CONSTRUCTION		LED LIGHT, WALL MOUNT	AP	ACCESS PANEL	FT	FEET, FOOT	O.H.	OVERHEAD
	HOMERUN, NUMBER OF ARROWS INDICATES NUMBER OF PHASES		LED LIGHT, WALL MOUNT, EMERGENCY	AS	AIR SEPARATOR	GFCI	GROUND FAULT CURRENT INTERRUPTER	P	PUMP
	MOTOR CONTROLLER, MOUNT TOP AT 72" ABOVE FLOOR UNLESS NOTE OTHERWISE		LED LIGHT, RECESSED MOUNT	B	BOILER	GND.	GROUND	PRV	PRESSURE REDUCING VALVE
				B.F.	BELOW FLOOR	GPM	GALLONS PER MINUTE	PSIG	POUNDS PER SQUARE INCH
				B.G.	BELOW GRADE	GW	GREASE WASTE	QTY.	QUANTITY
				CB	CIRCUIT BREAKER	H	HOOD	RA	RETURN AIR
				CH	WATER COOLED CHILLER	HP	HORSEPOWER	REQ'D	REQUIRED
				CISP	CAST IRON SOIL PIPE	HW	HOT WATER	RPM	REVOLUTIONS PER MINUTE
				CKT	CIRCUIT	HWCP	HOT WATER CIRCULATION PUMP	RTU	ROOF TOP UNIT
				CLG.	CEILING	HZ	HERTZ	SC	SHARED CIRCUIT
				C.O.	CLEANOUT	IN.	INCHES	S.D.	SMOKE DAMPER
				C.O.T.	COMPRESSION TANK	IN. WTR.	INCHES OF WATER	SF	SUPPLY FAN
				CT	COOLING TOWER	IG	ISOLATED GROUND	SP	STATIC PRESSURE
				CU	CONDENSING UNIT	J-BOX	JUNCTION BOX	ST	STEAM
				CW	COLD WATER	KVA	KILOVOLT AMPERE	SWBD	SWITCHBOARD
				DB	DRY BULB	KW	KILOWATT	T.C.	TIME CLOCK
				DIA.	DIAMETER	LOUV.	LOUVER	T.E.	TELEPHONE
				DN.	DOWN	LAT.	LEAVING AIR TEMPERATURE	TMV	THERMOSTATIC MIXING VALVE
				DWG.	DRAWING	M.V.	MEDICAL VACUUM	TV	TELEVISION
				EA	EXISTING ITEM TO REMAIN	MAX.	MAXIMUM	TYP.	TYPICAL
				EA	EACH	MIN.	MINIMUM	UH	UNIT HEATER
				EAT	ENTERING AIR TEMPERATURE	MLO	MAIN LUGS ONLY	U.N.O.	UNLESS NOTED OTHERWISE
				ED	EJECTION DISCHARGE	MAU	MAKE UP AIR UNIT	V	VOLT(S)
				EF	EXHAUST FAN	N	NITROGEN	VFD	VARIABLE FREQUENCY DRIVE
				ESP	EXTERNAL STATIC PRESSURE	N2O	NITROUS OXIDE	V.T.R.	VENT THRU ROOF
				EWT	ENTERING WATER TEMPERATURE	N.C.	NORMALLY CLOSED	W.C.O.	WALL CLEAN OUT
				EXST	EXISTING	NIC	NOT IN CONTRACT	WH	WATER HEATER
				F	DEGREES FAHRENHEIT	NL	NIGHT LIGHT	WP	WEATHERPROOF

**GENERAL NOTES:**

ALL WORK SHALL BE PERFORMED IN ACCORDANCE WITH CODES ADOPTED BY THE AUTHORITY HAVING JURISDICTION (AHJ) AND THE REQUIREMENTS STATED IN THE RFP, UNITED FACILITY CRITERIA AND APPLICABLE SECTIONS OF THE NATIONAL FIRE CODES (NFPA STANDARDS) CURRENT AT THE RFP WAS AMENDMENTS TO THESE CODES AS SET FORTH BY THE AUTHORITY HAVING JURISDICTION SHALL SUPERSEDE THESE CODES AND NFPA STANDARDS AS ISSUED.

1. INTERRELATION BETWEEN THE DRAWINGS AND THE SPECIFICATIONS: IN GENERAL, THE DRAWINGS INDICATE LOCATIONS, QUANTITIES AND CAPACITIES AND THE SPECIFICATIONS INDICATE QUALITY, OPTIONS, WARRANTIES AND COMPLIANCE STANDARDS. IN THE EVENT THERE IS A CONFLICT BETWEEN THE DRAWINGS AND THE SPECIFICATIONS AND THE DRAWINGS, THE GREATER QUALITY OR QUANTITY SHALL BE REQUIRED. IN ALL CASES, THE ENGINEER OF RECORD SHALL BE THE INTERPRETER OF THE DOCUMENTS.

2. INTERRELATION BETWEEN THE DRAWINGS: IN THE EVENT OF A CONFLICT BETWEEN A DETAIL AND A FLOOR PLAN, THE LARGER SIZE, QUANTITY, LENGTH OR OPTIONS SHALL BE REQUIRED. IN THE EVENT OF CONFLICT BETWEEN WHAT IS SHOWN ON THE FLOOR PLAN AND A KEYED NOTE, THE KEYED NOTE SHALL GOVERN. IN ALL CASES, THE ENGINEER OF RECORD SHALL BE THE INTERPRETER OF THE DOCUMENTS.

3. PRIOR TO BIDDING, THE DIVISION 26 INSTALLER SHALL VISIT THE JOB SITE TO BECOME FAMILIAR WITH EXISTING CONDITIONS AND TO VERIFY LOCATIONS AND SIZES OF EXISTING EQUIPMENT, CONDUCTORS, ETC. SUBMITTAL OF A BID SHALL SIGNIFY WILLINGNESS TO COMPLY WITH THE CONSTRUCTION DOCUMENTS AND ACCEPTANCE OF ON-SITE CONDITIONS AS THEY EXIST.

4. THE EXISTENCE AND LOCATION OF UTILITIES, MECHANICAL SYSTEMS, ELECTRICAL SYSTEMS AND OTHER CONSTRUCTION INDICATED AS EXISTING ARE NOT GUARANTEED. BEFORE BEGINNING WORK, INVESTIGATE AND VERIFY THE EXISTENCE AND LOCATION OF MECHANICAL AND ELECTRICAL SYSTEMS AND OTHER CONSTRUCTION AFFECTING THE WORK.

5. COOPERATE FULLY WITH SEPARATE CONTRACTORS SO WORK ON THOSE CONTRACTS MAY BE CARRIED OUT SMOOTHLY WITHOUT INTERFERING WITH OR DELAYING WORK UNDER THIS CONTRACT. COORDINATE THE WORK OF THIS CONTRACT WITH WORK PERFORMED UNDER SEPARATE CONTRACTS.

6. DO NOT INTERRUPT UTILITIES SERVING FACILITIES OCCUPIED BY GOVERNMENT OR OTHERS UNLESS PERMITTED BY THE GOVERNMENT. THE CONTRACTOR SHALL PROVIDE THE GOVERNMENT WITH A MINIMUM 14 DAYS NOTIFICATION, UON.

7. THE DRAWINGS ARE DIAGRAMMATIC ONLY AND SHALL NOT BE SCALED. NOT ALL NEC REQUIRED ITEMS SUCH AS RACEWAYS, CONDUCTORS, GROUNDING SYSTEMS, ETC. CAN BE SHOWN. FURNISH AND INSTALL RACEWAYS, CONDUCTORS, ETC. AS REQUIRED FOR A COMPLETE AND FUNCTIONAL, NEC COMPLIANT SYSTEM.

8. THE INSTALLER IS RESPONSIBLE FOR COORDINATING WITH OTHER TRADES. THE INSTALLER SHALL NOT INSTALL OR FABRICATE ANY WORK SHOWN UNTIL ALL SUCH WORK IS FULLY COORDINATED, FURNISH AND INSTALL ADDITIONAL RACEWAYS, CONDUCTORS, ETC. AS REQUIRED TO COORDINATE THE INSTALLATION WITH OTHER TRADES AS PART OF THE WORK.

9. TAKE FIELD MEASUREMENTS AS REQUIRED TO FIT THE WORK PROPERLY. RECHECK MEASUREMENTS BEFORE INSTALLING EACH PRODUCT. WHERE PORTIONS OF THE WORK ARE INDICATED TO FIT TO OTHER CONSTRUCTION, VERIFY DIMENSIONS OF OTHER CONSTRUCTION BY FIELD MEASUREMENTS BEFORE FABRICATION. COORDINATE FABRICATION SCHEDULE WITH CONSTRUCTION PROGRESS TO AVOID DELAYING THE WORK. FURNISH AND INSTALL ADDITIONAL RACEWAYS, CONDUCTORS, ETC. AS REQUIRED TO ACCOMMODATE FIELD CONDITIONS AS PART OF THE WORK.

10. THE WORK SHALL BE SUPERVISED BY A MASTER ELECTRICIAN TO ASSURE THAT ALL WORK IS INSTALLED IN ACCORDANCE WITH APPLICABLE CODES AND THE CONSTRUCTION DOCUMENTS.

11. REFER TO ARCHITECTURAL REFLECTED CEILING PLANS FOR EXACT LOCATIONS OF LIGHTING FIXTURES.

12. IT SHALL BE THE RESPONSIBILITY OF THE CONTRACTOR TO RELOCATE TO THE PROPER SIDE OF THE DOOR ANY SWITCH, RECEPTACLE OR DEVICE BEING AFFECTED BY ANY CHANGE IN DIRECTION OF DOOR SWINGS AS SHOWN ON THE ARCHITECTURAL FLOOR PLAN.

13. MECHANICAL EQUIPMENT SIZES ARE AS DESIGNED, BREAKERS, CONDUIT STARTERS, CONDUCTORS, ETC. SHALL BE ADJUSTED TO THE EQUIPMENT SUBMITTED AND APPROVED FOR INSTALLATION ON THIS PROJECT.

14. REMOTE MOUNTED MOTORS SHALL BE PROVIDED WITH RECEPTACLES AND PLUGS OR DISCONNECT SWITCHES TO BE COMPATIBLE WITH THE CONSTRUCTION TYPE AND THE NEC.

15. EACH MOTOR BEING INSTALLED ON THIS CONTRACT SHALL BE PROVIDED WITH THERMAL PROTECTION IN EITHER A MANUAL OR MAGNETIC STARTER. THERMAL ELEMENTS SHALL BE SIZED AND INSTALLED ACCORDING TO THE NAMEPLATE FULL LOAD AMP RATING OF THE MOTOR.

16. KILOWATT (KW) RATINGS FOR EQUIPMENT MOTOR LOADS ARE AS DESIGNED WITH 90% POWER FACTOR RATING ASSUMED. THE CONTRACTOR SHALL BE RESPONSIBLE FOR INCREASING THE SIZE, AS REQUIRED, OF ALL FEEDERS AND PROTECTIVE DEVICES SERVING ANY ITEMS OF EQUIPMENT SUPPLIED WITH POWER FACTOR RATINGS LESS THAN 90% EFFICIENCY.

17. IN ALL AREAS THE GENERAL CONTRACTOR SHALL BE RESPONSIBLE FOR COORDINATION BETWEEN THE ELECTRICAL AND MECHANICAL TRADES TO PROVIDE CLEARANCE ABOVE CEILING BETWEEN RECESSED LIGHTING FIXTURES AND THERMAL INSULATION OR DUCTWORK IN ACCORDANCE WITH THE NEC, PARAGRAPH 410-66.

18. A CIRCUIT SHALL BE DEFINED TO INCLUDE ALL OF THE FOLLOWING: CONDUIT, CONDUCTORS, BOXES, WIRING DEVICES, COVERPLATES, WIREWAYS, ETC.

19. MULTIWIRE BRANCH CIRCUITS AS DEFINED BY THE NATIONAL ELECTRICAL CODE SHALL NOT BE USED. A DEDICATED NEUTRAL CONDUCTOR SHALL BE RUN FOR EACH BRANCH CIRCUIT, UON.

20. THE CONTRACTOR SHALL LABEL EACH JUNCTION/PULL BOX COVER PLATE WITH THE CIRCUIT NUMBER OF THE CIRCUITS IT CONTAINS. LABEL EACH EXITING CONDUIT AT THE POINT WHERE IT EXITS THE JUNCTION BOX WITH THE CIRCUIT NUMBER IT CONTAINS. IF THE RACEWAY SYSTEM IS IN AN EXPOSED AREA LABEL THE INSIDE OF THE JUNCTION/PULL BOX COVER PLATE ONLY.

21. LABEL THE RECEPTACLE AND LIGHT SWITCH FACEPLATES WITH THE CIRCUIT DESIGNATION. THE LABEL SHALL BE CLEAR WITH 1/4" BLACK LETTERS AND SHALL BE MACHINE PRINTED.

22. RECEPTACLES RATED FOR 15A OR 20A/125V AND INSTALLED WITHIN 6FT OF THE OUTSIDE OF A SINK SHALL BE GFCI PROTECTED. IF THE RECEPTACLE IS NOT ACCESSIBLE THEN GFCI PROTECTED CIRCUIT BREAKER SHALL BE USED.

DATE				
REVISIONS				

Designed by: JH/MLLA  
 Drawn by: JH/MLLA  
 Reviewed by: RT/JAH  
 Submitted by: PCES


**FIRE STATION ADD/ALTER, B3321  
 PROJECT NO. 1039839  
 17th TRAINING WING  
 GOODFELLOW AIR FORCE BASE, TEXAS**

Project Number: 1039839

SHEET TITLE: ELECTRICAL SYMBOLS NOTES & ABBREVIATIONS

Date: JAN 2024



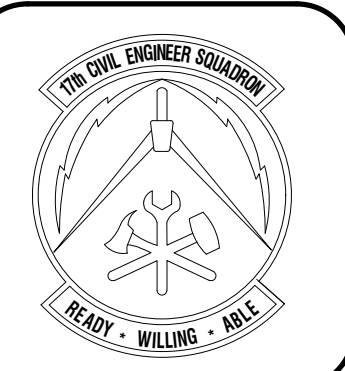


REVISIONS	DATE

Designed by JH/ML/A	Drawn by JH/ML/A	Reviewed by RT/JH	Submitted by PC/ES
------------------------	---------------------	----------------------	-----------------------

PROJECT TITLE  
**FIRE STATION ADD/ALTER, B3321  
PROJECT NO. 1039839  
17th TRAINING WING  
GOODFELLOW AIR FORCE BASE, TEXAS**


Project Number: 1039839
SHEET TITLE <b>ELECTRICAL DEMOLITION PLAN</b>
Date: JAN 2024

SEQ. 39	SHEET <b>ED-101</b>	OF 50
------------	------------------------	----------

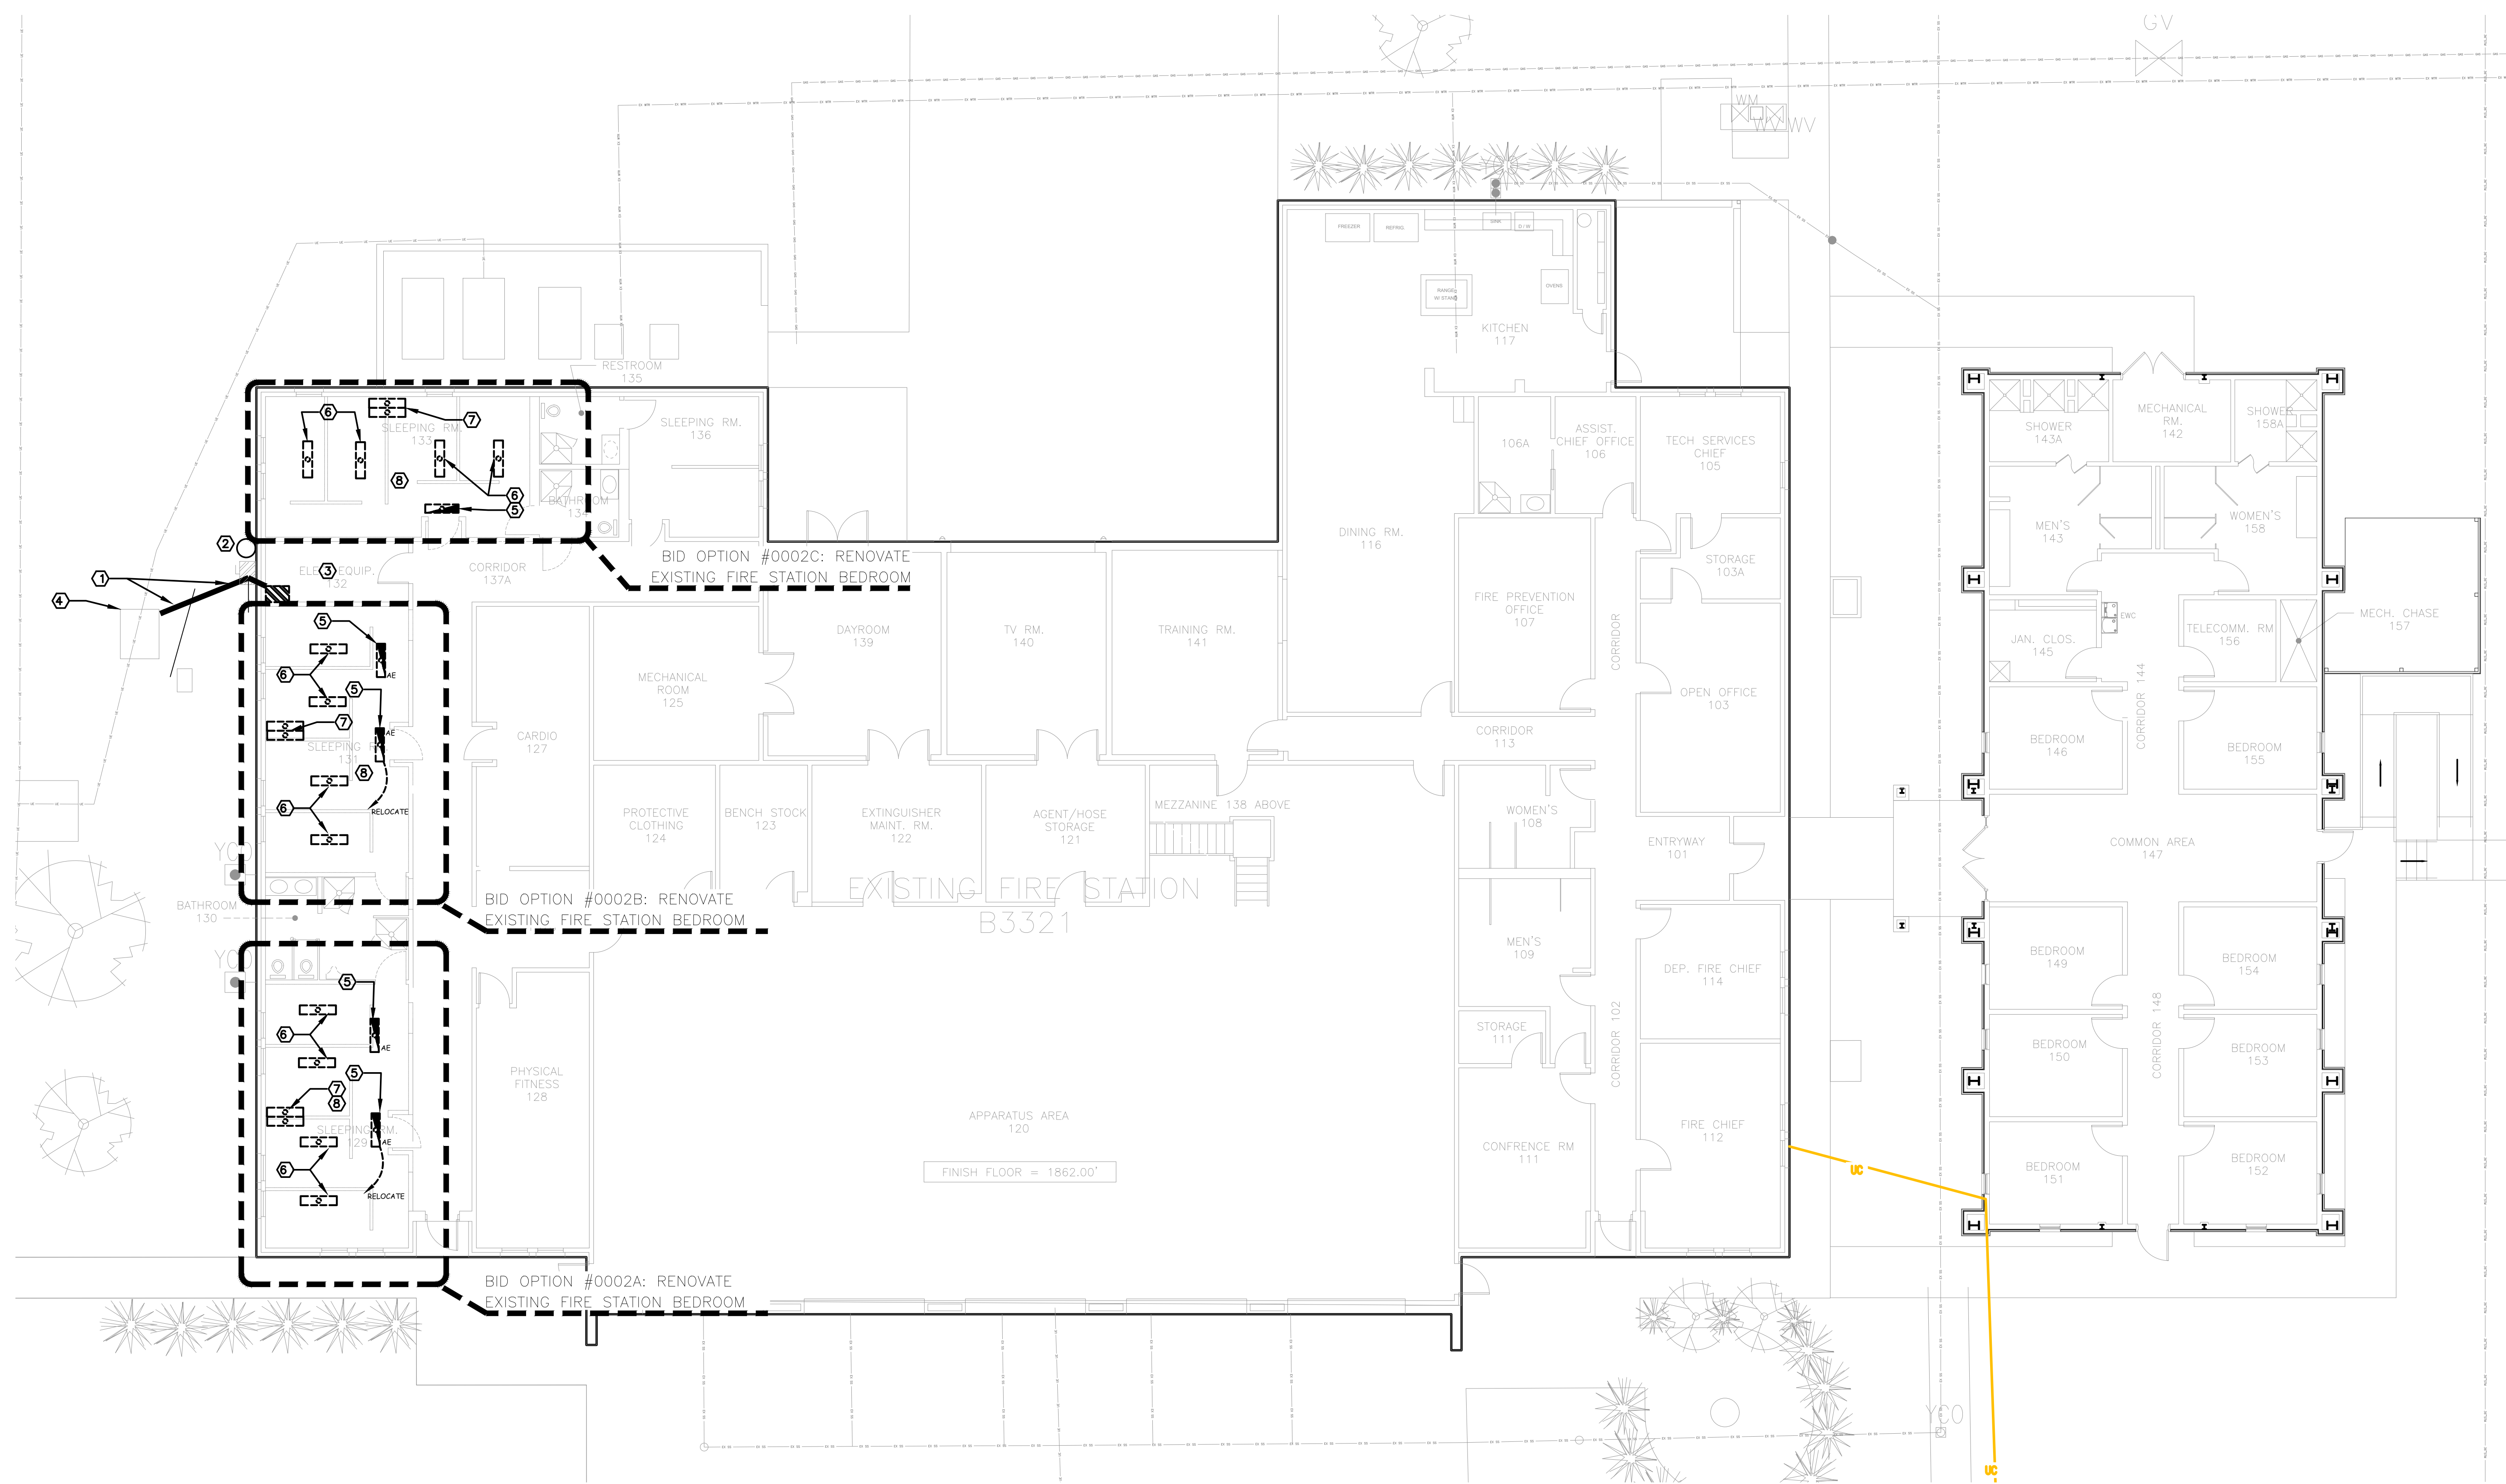

- KEYNOTES** AS NOTATED BY (X)
- EXISTING UNDERGROUND SERVICE CIRCUIT FROM TRANSFORMER TO MAIN DISTRIBUTION PANEL (MDP)
  - CONTRACTOR SHALL DEMO EXISTING MAIN SERVICE DISCONNECT AND METER.
  - CONTRACTOR SHALL DEMOLISH EXISTING MDP.
  - EXISTING 150KVA TRANSFORMER AND PAD
  - CONTRACTOR SHALL REMOVE AND REPLACE EXISTING EMERGENCY LIGHTING IN ROOMS 129 AND 131. NEW LAMPS SHALL BE CONNECTED TO THE SAME CIRCUIT FEEDING EMERGENCY LIGHTING IN THESE TWO ROOMS.
  - CONTRACTOR SHALL REMOVE AND REPLACE EXISTING LIGHT FIXTURES WITH NEW DIMMABLE LED EQUIVALENT AS SHOWN ON E601 LIGHTING SCHEDULE. REPLACE SWITCHES CONTROLLING THESE LIGHTS BY SWITCHES. CONTRACTOR SHALL ENSURE TO RELOCATE SWITCHES FOR EACH NEWLY PARTITIONED ROOM.
  - CONTRACTOR SHALL DEMOLISH EXISTING WALL MOUNTED FIXTURES. EXISTING CIRCUITS ARE TO REMAIN AND ENCLOSED IN JUNCTION BOXES ABOVE THE CEILING.
  - CONTRACTOR SHALL RELOCATE CIRCUITS IN BID OPTION ROOMS AS NEEDED TO ALLOW FOR NEW RECESSED FIXTURES AS SHOWN ON A-201

- GENERAL NOTES**
- THESE WORK PLANS ARE ONLY MEANT TO CONVEY THE SCOPE OF WORK FOR CONTRACTOR BIDDING AND REFERENCE PURPOSES ONLY. THE CONTRACTOR SHALL BE RESPONSIBLE FOR PROVIDING ALL NECESSARY PLANS, DRAWINGS, LINE DIAGRAMS, PANEL AND LOAD CALCULATIONS BEARING THE SEAL OF AN ELECTRICAL ENGINEER TO ENSURE THE COMPLETE INSTALLATION OF ALL NECESSARY ELECTRICAL SYSTEMS IN THE NEW ADDITION AND BID OPTION AREAS, IF AWARDED.
  - CONTRACTOR SHALL BE RESPONSIBLE FOR VERIFYING EXISTING CONDITIONS, EQUIPMENT, CURRENT PANEL CAPACITY, NEW LOAD REQUIREMENTS, AND DIMENSIONS PRIOR TO START OF WORK.
  - PLACEMENT OF NEW SERVICE CIRCUIT, NEW MAIN SERVICE DISCONNECT, AND NEW MDP SHALL BE DONE BEFORE DEMOLITION. CONTRACTOR SHALL PROVIDE TEMPORARY POWER TO FACILITY TO AVOID POWER INTERRUPTION. THE CONTRACTOR SHALL ENSURE TO HAVE ELECTRICAL EQUIPMENT AND MATERIALS INCLUDING PANELS, SWITCHES, WIRING, CONDUIT, AND ACCESSORIES READY AND AVAILABLE AT THE SITE PRIOR TO BEGINNING WORK ON THE EXISTING FIRE STATION.
  - THE CONTRACTOR SHALL COORDINATE HIS/HER WORK WITH THAT OF ALL OTHER TRADES, INCLUDING BUT NOT LIMITED TO, ELECTRICAL, HVAC, STRUCTURAL AND GENERAL ARCHITECTURE.
  - EXISTING OUTLETS AND RECEPTACLES IN BID OPTION ROOMS ARE TO REMAIN UNLESS NOTED OTHERWISE.
  - THE GOVERNMENT HAS CONFIRMED WITH AEP, AS THE PRIMARY UTILITY PROVIDER, THAT A NEW, AND OR, UPSIZED TRANSFORMER WILL NOT BE REQUIRED TO PERFORM THE DESCRIBED IN THESE DRAWINGS.
  - CONTRACTOR SHALL DO ALL ELECTRICAL INSTALLATION ACCORDING NEC AND UFC STANDARDS.
  - IN BID OPTION AREAS, THE CONTRACTOR SHALL BE RESPONSIBLE FOR DEMOLISHING ANY EXISTING PUBLIC ANNOUNCING (PA) SPEAKERS, AND REUSING EXISTING CIRCUITS FOR NEW WORK. CONTRACTOR SHALL INSTALL NEW SOFT-START PUBLIC ANNOUNCING SPEAKERS IN EACH BEDROOM SIMILAR TO THOSE REQUIRED IN THE NEW ADDITION.

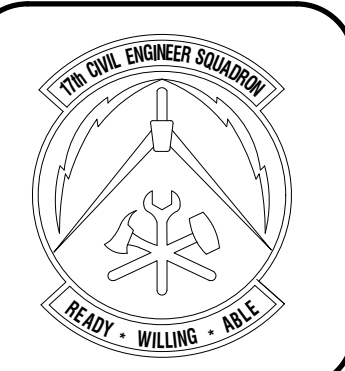

REVISIONS	DATE

Designed by JHR/MLA	Drawn by JHR/MLA	Reviewed by RTJ/AJ	Submitted by PCBS
------------------------	---------------------	-----------------------	----------------------

PROJECT TITLE  
**FIRE STATION ADD/ALTER, B3321  
PROJECT NO. 1039839  
17th TRAINING WING  
GOODFELLOW AIR FORCE BASE, TEXAS**

Project Number: 1039839
SHEET TITLE <b>ELECTRICAL POWER SUPPLY</b>
Date: JAN 2024

SEQ.	SHEET	OF
40	<b>E-101</b>	50




**1 ELECTRICAL POWER PLAN**  
 $\frac{1}{8}'' = 1' - 0''$   
 PLAN NORTH    TRUE NORTH

- KEYNOTES** AS INDICATED BY (X)
- EXISTING UNDERGROUND SERVICE CONNECTION.
  - CONTRACTOR SHALL PROVIDE NEW GROUNDED MAIN SERVICE DISCONNECT AND METER. SIZE AND TYPE AS DETERMINED BY ELECTRICAL ENGINEER.
  - CONTRACTOR SHALL SIZE, FURNISH, AND INSTALL A NEW MAIN DISTRIBUTION PANEL AS NEEDED TO SUPPORT CURRENT FIRE STATION FUNCTIONS AND NEW BUILDING ADDITION.
  - CONTRACTOR SHALL PROVIDE NEW D1 PANEL INSIDE NEW ADDITION BUILDING MECHANICAL ROOM, INCLUDING NEW METER AND MAIN DISCONNECT OUTSIDE MECH ROOM. ALL D1 PANEL CIRCUIT BREAKERS SHALL BE INVERSE TIME CB RATED FOR OVERLOAD PROTECTION.
  - CONTRACTOR SHALL PROVIDE NEW 250FT UNDERGROUND FEEDER CIRCUIT FROM MDP TO D1
  - CONTRACTOR SHALL PROVIDE NEW C-TV FEEDER IN PVC CONDUIT FROM EXISTING SUDDENLINK SERVICE ENTRANCE TO NEW C-TV SPLITTER BOX. CONTRACTOR SHALL PROVIDE ALL NEEDED EQUIPMENT IN EXISTING SUDDENLINK ENTRANCE TO ACCOMMODATE NEW CONNECTION. NEW FLUSH MOUNTED SPLITTER BOX SHALL COLLECT ALL C-TV IN NEW BUILDING. SEE E-301
  - NEW VOICE/DATA/PA FEEDER FROM NEW BUILDING TO NEW TELEPHONE BOARD/DATA SWITCHES/SPEAKER BOX. CONTRACTOR SHALL PROVIDE NEW TELEPHONE/DATA/PA FEEDER IN PVC CONDUIT FROM NEW BUILDING FLUSH MOUNTED COLLECTION POINT BOX TO NEW TELEPHONE BOARD/DATA SWITCHES/SPEAKERS AMPLIFIER BOX. CONTRACTOR SHALL PROVIDE NEW DATA SWITCH TO ACCOMMODATE FOR NEW DEMAND. REFER TO DIVISION 27 "STATEMENT OF OBJECTIVES (SOO)" FOR ADDITIONAL INFORMATION.
  - REFER TO ONE-LINE DIAGRAM ON E-601 FOR CIRCUIT/CONDUCTORS SPECIFICATIONS.
  - EXISTING C-TV BOX
  - EXISTING SPEAKER AMPLIFIER BOX
  - EXISTING RELAYS CONTROL BOX
  - NEW TELEPHONE BOARD AND DATA SWITCHES

- GENERAL NOTES**
- THESE WORK PLANS ARE ONLY MEANT TO CONVEY THE SCOPE OF WORK FOR CONTRACTOR BIDDING AND REFERENCE PURPOSES ONLY. THE CONTRACTOR SHALL BE RESPONSIBLE FOR PROVIDING ALL NECESSARY PLANS, DRAWINGS, LINE DIAGRAMS, PANEL AND LOAD CALCULATIONS BEARING THE SEAL OF AN ELECTRICAL ENGINEER TO ENSURE THE COMPLETE INSTALLATION OF ALL NECESSARY ELECTRICAL SYSTEMS IN THE NEW ADDITION AND BID OPTION AREAS, IF AWARDED.
  - CONTRACTOR SHALL BE RESPONSIBLE FOR VERIFYING EXISTING CONDITIONS, EQUIPMENT, CURRENT PANEL CAPACITY, NEW LOAD REQUIREMENTS, AND DIMENSIONS PRIOR TO START OF WORK.
  - PLACEMENT OF NEW SERVICE CIRCUIT, NEW MAIN SERVICE DISCONNECT, AND NEW MDP SHALL BE DONE BEFORE DEMOLITION. CONTRACTOR SHALL PROVIDE TEMPORARY POWER TO FACILITY TO AVOID POWER INTERRUPTION. THE CONTRACTOR SHALL ENSURE TO HAVE ELECTRICAL EQUIPMENT AND MATERIALS INCLUDING PANELS, SWITCHES, WIRING, CONDUIT, AND ACCESSORIES READY AND AVAILABLE AT THE SITE PRIOR TO BEGINNING WORK ON THE EXISTING FIRE STATION.
  - THE CONTRACTOR SHALL COORDINATE HIS/HER WORK WITH THAT OF ALL OTHER TRADES, INCLUDING BUT NOT LIMITED TO, ELECTRICAL, HVAC, STRUCTURAL AND GENERAL ARCHITECTURE.
  - EXISTING OUTLETS AND RECEPTACLES IN BID OPTION ROOMS ARE TO REMAIN UNLESS NOTED OTHERWISE.
  - THE GOVERNMENT HAS CONFIRMED WITH AEP, AS THE PRIMARY UTILITY PROVIDER, THAT A NEW, AND OR, UPSIZED TRANSFORMER WILL NOT BE REQUIRED TO PERFORM THE DESCRIBED IN THESE DRAWINGS.
  - CONTRACTOR SHALL DO ALL ELECTRICAL INSTALLATION ACCORDING NEC AND UFC STANDARDS.
  - CONTRACTOR SHALL NOT WIRE NEW DISTRIBUTION PANEL FOR NEW FIRE STATION DORMITORY TO EXISTING FIRE STATION EMERGENCY GENERATOR UNLESS NOTED OTHERWISE.



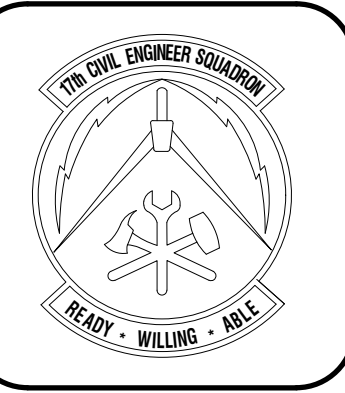

DATE	
REVISIONS	

Designed by	JH/RML/A
Drawn by	JH/RML/A
Reviewed by	RT/JH
Submitted by	PCES

PROJECT TITLE  
**FIRE STATION ADD/ALTER, B3321**  
**PROJECT NO. 1039839**  
**17th TRAINING WING**  
**GOODFELLOW AIR FORCE BASE, TEXAS**

Project Number	1039839
SHEET TITLE	<b>LIGHTING PLAN</b>
Date	JAN 2024


SEQ.	SHEET	OF
41	<b>E-201</b>	50

**KEYNOTES** AS INDICATED BY (X)

1. ALL SWITCHES SA AND LIGHTS CONTROLLED BY THEM SHALL BE DIMMABLE SWITCHES
2. ALL CORRIDOR LIGHTING SHALL BE CONTROLLED BY OCCUPANCY SENSORS
3. OUTDOOR LIGHTING SHALL BE PHOTOCELL CONTROLLED AS INDICATED. CONTRACTOR SHALL PROVIDE SURFACE MOUNTED LED WALL PACKS ABOVE MECH. RM 142 AND EAST COMMON AREA RM147 ENTRANCES. COORDINATE WITH GAFB BASE STANDARDS FOR STANDARD PRODUCT TYPE.
4. RESTROOM LIGHTS TO BE CONTROLLED BY OCCUPANCY SENSORS.
5. CONTRACTOR SHALL PROVIDE SURFACE MOUNTED 6" LED ROUND LIGHTING, COMPLETE WITH CIRCUIT, AND CONDUIT BENEATH PORCH CANOPY. COORDINATE WITH GAFB BASE STANDARDS FOR STANDARD PRODUCT TYPE.
6. CONTRACTOR SHALL CENTER AND INSTALL FIXTURE ON CEILING ABOVE LABORATORY. REFER TO ARCHITECTURAL.
7. CONTRACTOR SHALL INSTALL EMERGENCY LIGHTING TO THE EXISTING CIRCUIT AS DESCRIBED IN THESE DRAWINGS.


**GENERAL NOTES**

1. THESE WORK PLANS ARE ONLY MEANT TO CONVEY THE SCOPE OF WORK FOR CONTRACTOR BIDDING AND REFERENCE PURPOSES ONLY. THE CONTRACTOR SHALL BE RESPONSIBLE FOR PROVIDING ALL NECESSARY PLANS, DRAWINGS, LINE DIAGRAMS, PANEL AND LOAD CALCULATIONS BEARING THE SEAL OF AN ELECTRICAL ENGINEER TO ENSURE THE COMPLETE INSTALLATION OF ALL NECESSARY ELECTRICAL SYSTEMS IN THE NEW ADDITION AND BID OPTION AREAS, IF AWARDED.
2. CONTRACTOR SHALL BE RESPONSIBLE FOR VERIFYING EXISTING CONDITIONS, EQUIPMENT, CURRENT PANEL CAPACITY, NEW LOAD REQUIREMENTS, AND DIMENSIONS PRIOR TO START OF WORK.
3. PLACEMENT OF NEW SERVICE CIRCUIT, NEW MAIN SERVICE DISCONNECT, AND NEW MDP SHALL BE DONE BEFORE DEMOLITION. CONTRACTOR SHALL PROVIDE TEMPORARY POWER TO FACILITY TO AVOID POWER INTERRUPTION. THE CONTRACTOR SHALL ENSURE TO HAVE ELECTRICAL EQUIPMENT AND MATERIALS INCLUDING PANELS, SWITCHES, WIRING, CONDUIT, AND ACCESSORIES READY AND AVAILABLE AT THE SITE PRIOR TO BEGINNING WORK ON THE EXISTING FIRE STATION.
4. THE CONTRACTOR SHALL COORDINATE HIS/HER WORK WITH THAT OF ALL OTHER TRADES, INCLUDING BUT NOT LIMITED TO, ELECTRICAL, HVAC, STRUCTURAL AND GENERAL ARCHITECTURE.
5. EXISTING OUTLETS AND RECEPTACLES IN BID OPTION ROOMS ARE TO REMAIN UNLESS NOTED OTHERWISE.
6. THE GOVERNMENT HAS CONFIRMED WITH AEP, AS THE PRIMARY UTILITY PROVIDER, THAT A NEW, AND OR, UPSIZED TRANSFORMER WILL NOT BE REQUIRED TO PERFORM THE DESCRIBED IN THESE DRAWINGS.
7. CONTRACTOR SHALL DO ALL ELECTRICAL INSTALLATION ACCORDING NEC AND UFC STANDARDS.
8. ALL CONDUCTORS SHALL BE IN CONCEALED EMT CONDUITS IN WALLS OR ABOVE CEILING FOR INTERIOR APPLICATIONS AND IMC CONDUITS FOR EXTERIOR APPLICATIONS UNLESS NOTED OTHERWISE; MINIMUM CONDUCTOR SIZE ALLOWED IS #12 COPPER.
9. CONTRACTOR SHALL PROVIDE ALL REQUIRED EQUIPMENTS TO PERFORM THIS JOB ACCORDING TO CODE, INDUSTRY STANDARDS, AND AS DESCRIBED EVEN IF ALL EQUIPMENT IS NOT LISTED ON THESE DRAWINGS.

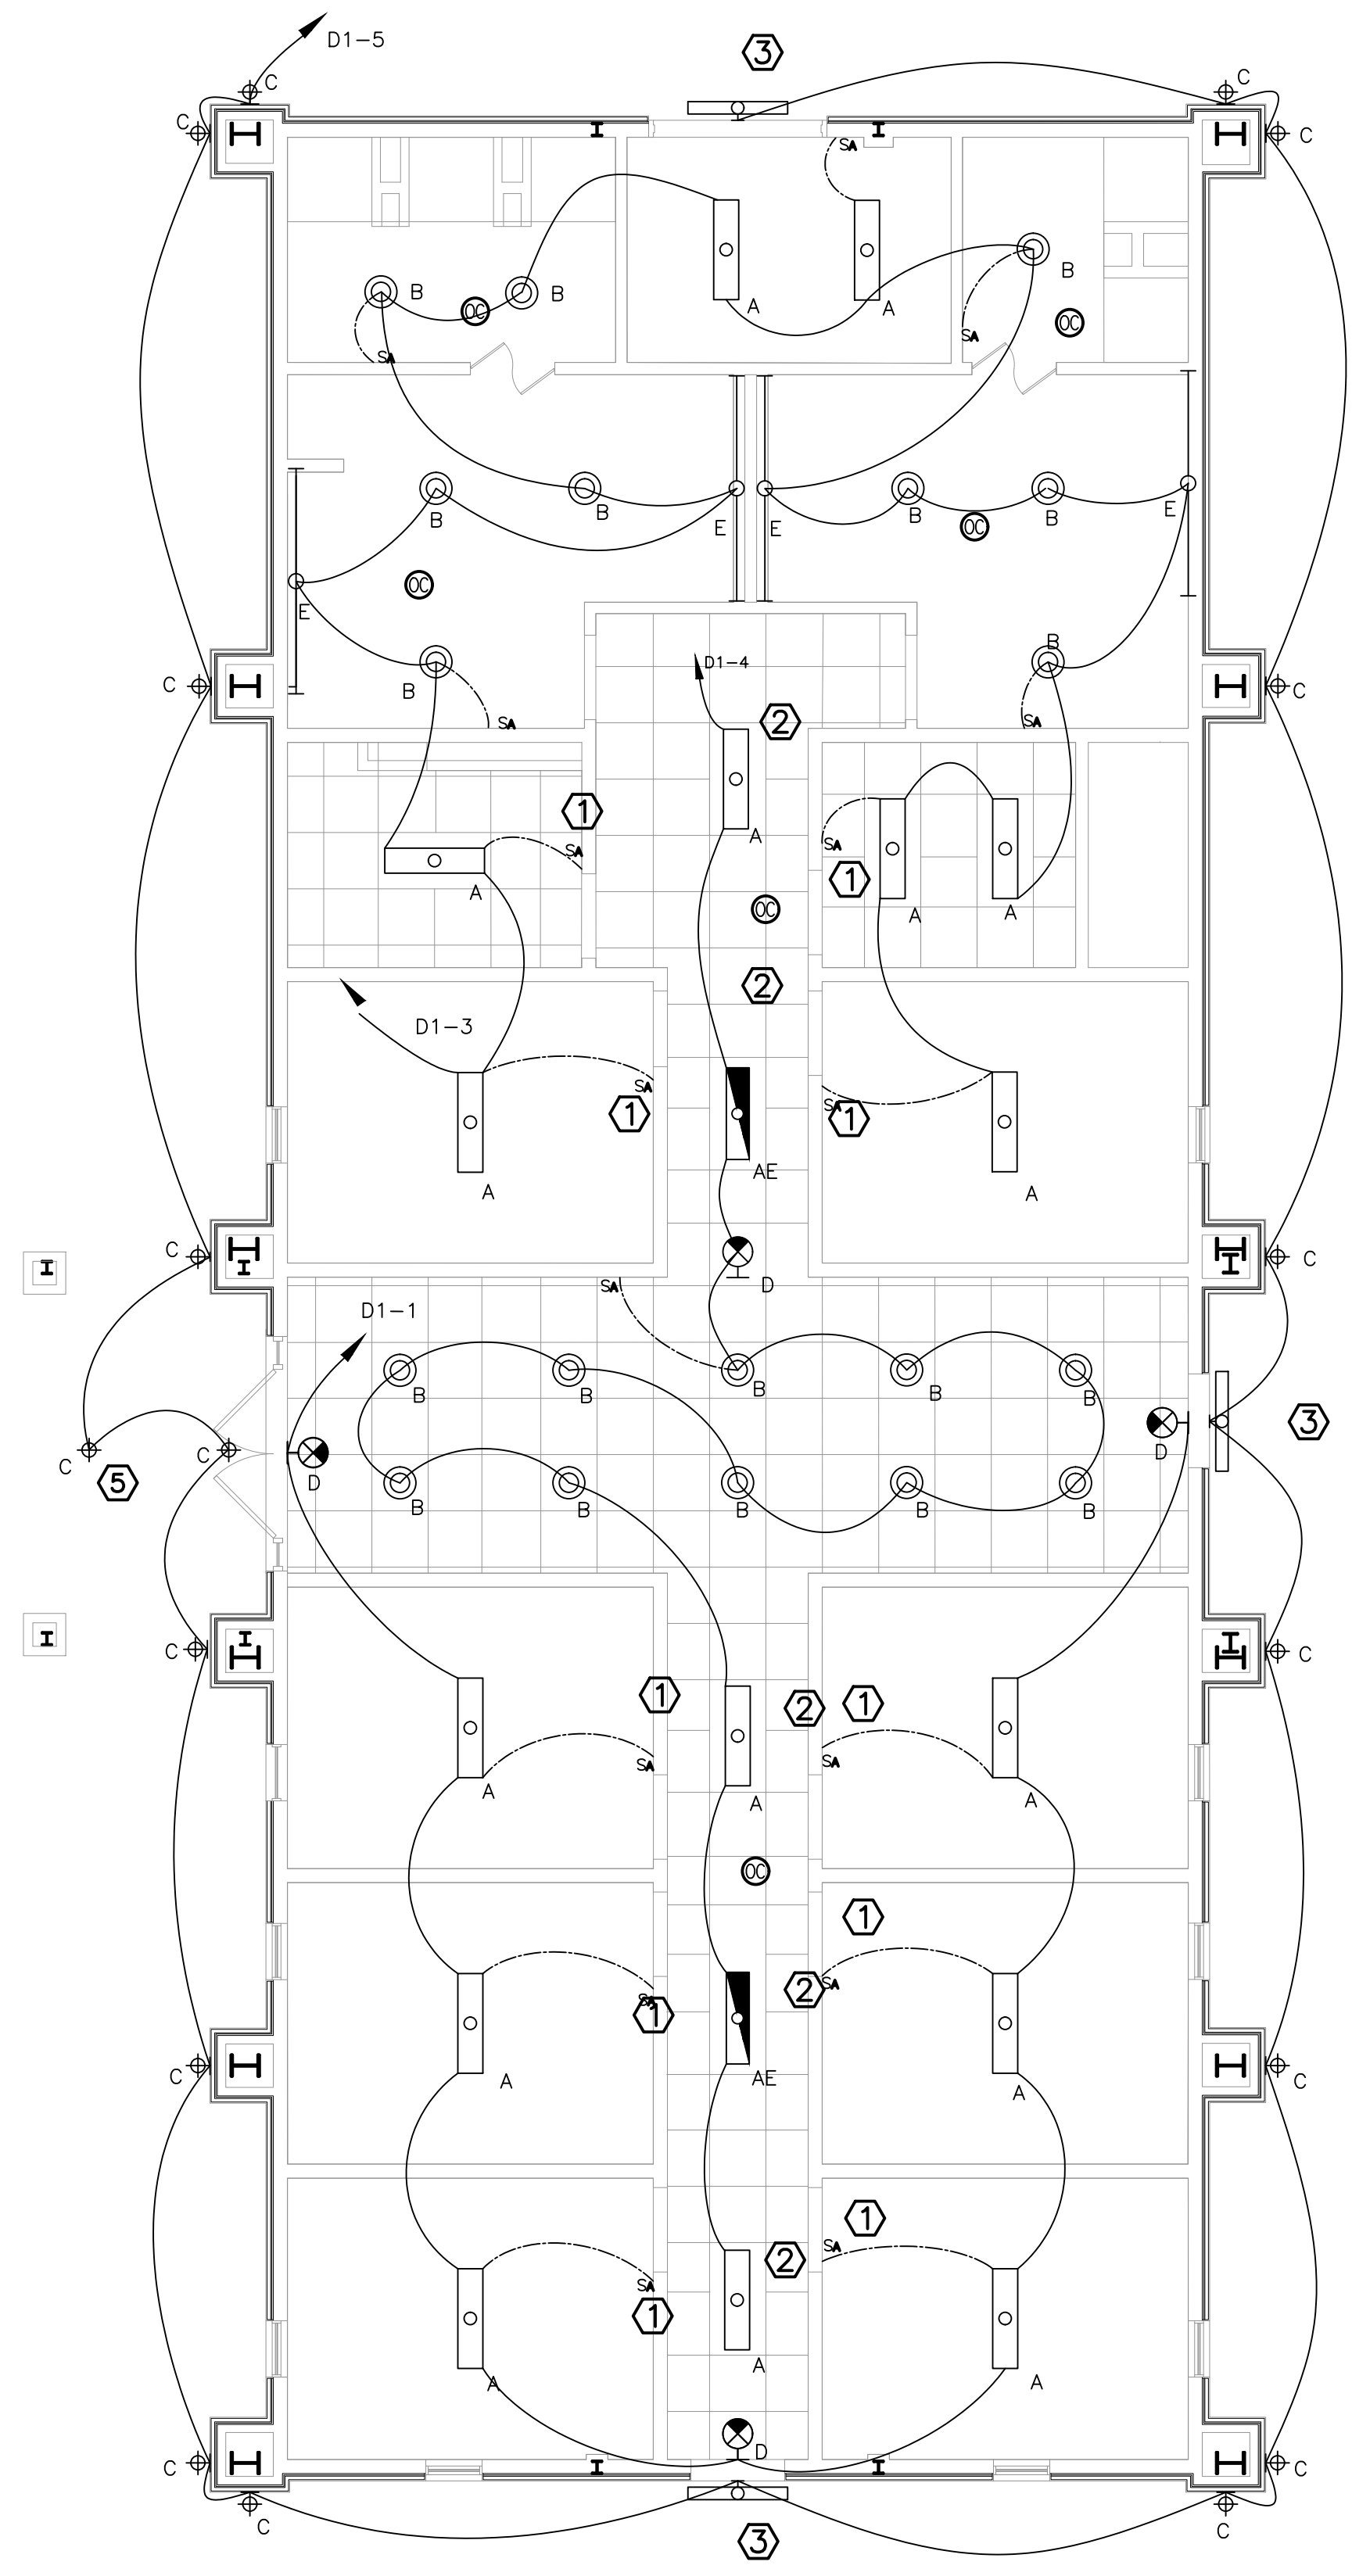

**1 LIGHTING PLAN**  
 $\frac{1}{16}'' = 1' - 0''$

FIXTURE TYPE	MANUFACTURER MODEL #	DESCRIPTION	VOLTAGE	MOUNTING	TYPE OF LAMPS
			VA		
A	COOPER CRUZE ST (BAA-24CZ2-30-UNV-L840-CD-1-U)	2X4 LED TROFFER	120/277V	SUSP. CLG. DROP IN	LED 4000K
			3000 LUMENS		
			120/277V		
AE	COOPER CRUZE ST (BAA-24CZ2-30-UNV-EL14W-L840-CD-1-U)	2X2 LED TROFFER (EMERGENCY)	120/277V	SUSP. CLG. DROP IN	LED 4000K
			3000 LUMENS		
			120/277V		
B	COOPER PORTFOLIO (BAA-LD6C-10-90-40-D010-B26-M-1-H)	6" RECESSED CAN LIGHTING	120/277V	RECESSED	LED 4000K
			1100 LUMENS		
			120/277V		
C	COOPER LANERA (BAA-9002-W2-RW-LED3590-M-M-BZ-L1-UNV-WIS)	UP/DN SURFACE MOUNTED EXT. LIGHT	120/277V	WALL MOUNTED	LED
D	COOPER SURE-LITES (CX-7-1-SD)	SURFACE MOUNTED EXIT LIGHT		SURFACE MOUNTED	LED
E	COOPER (BAA-S123DRP-S-560D-8-40-ETT-8FO-1-UNV-D0-F-W)	ARCHITECTURAL STRIP LIGHT	120/270V	SURFACE MOUNTED	LED 4000K
			560 LMS/FT		

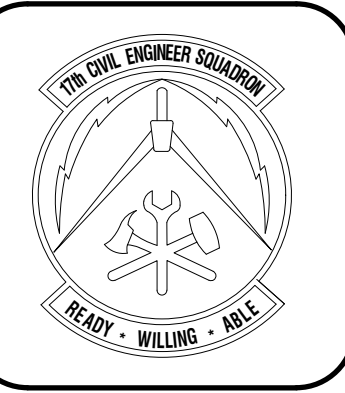



DATE	
REVISIONS	

Designed by	JH/MLLA
Drawn by	JH/MLLA
Reviewed by	RT/JH
Submitted by	PCBS

PROJECT TITLE  
**FIRE STATION ADD/ALTER, B3321**  
**PROJECT NO. 1039839**  
**17th TRAINING WING**  
**GOODFELLOW AIR FORCE BASE, TEXAS**

Project Number:	1039839
SHEET TITLE	<b>POWER PLAN</b>
Date:	JAN 2024

SEQ.	SHEET	OF
42	<b>E-301</b>	50

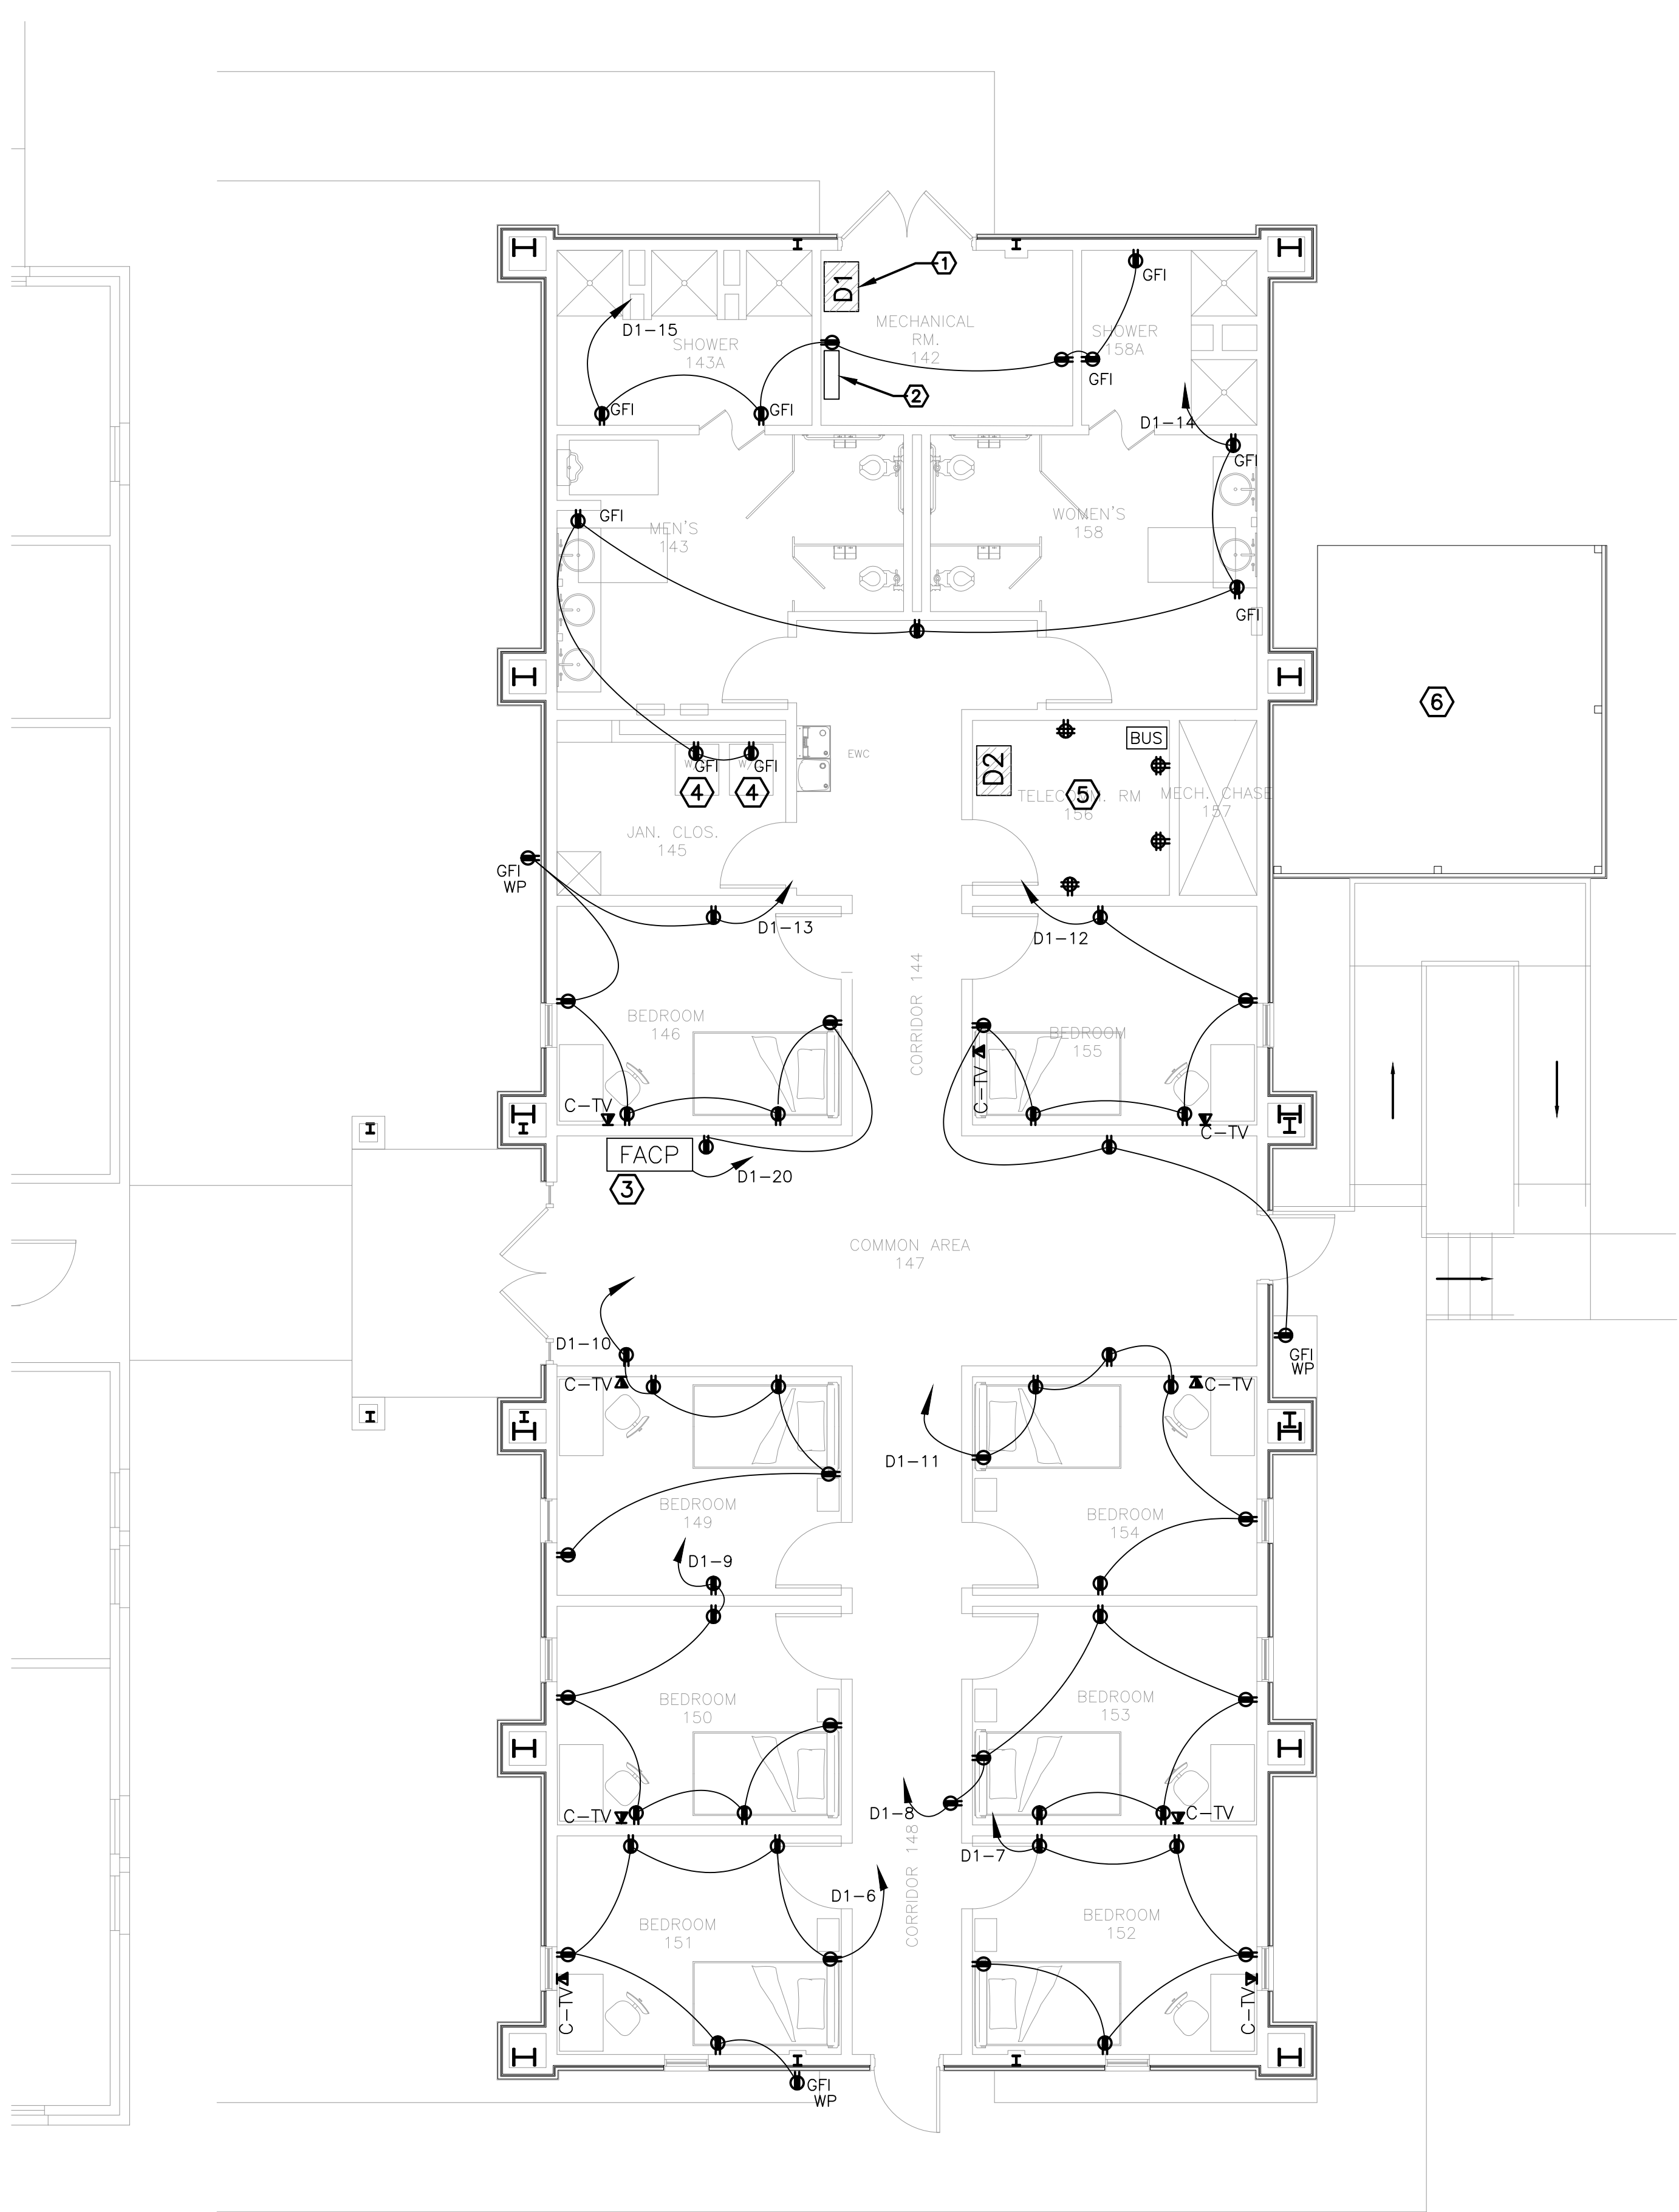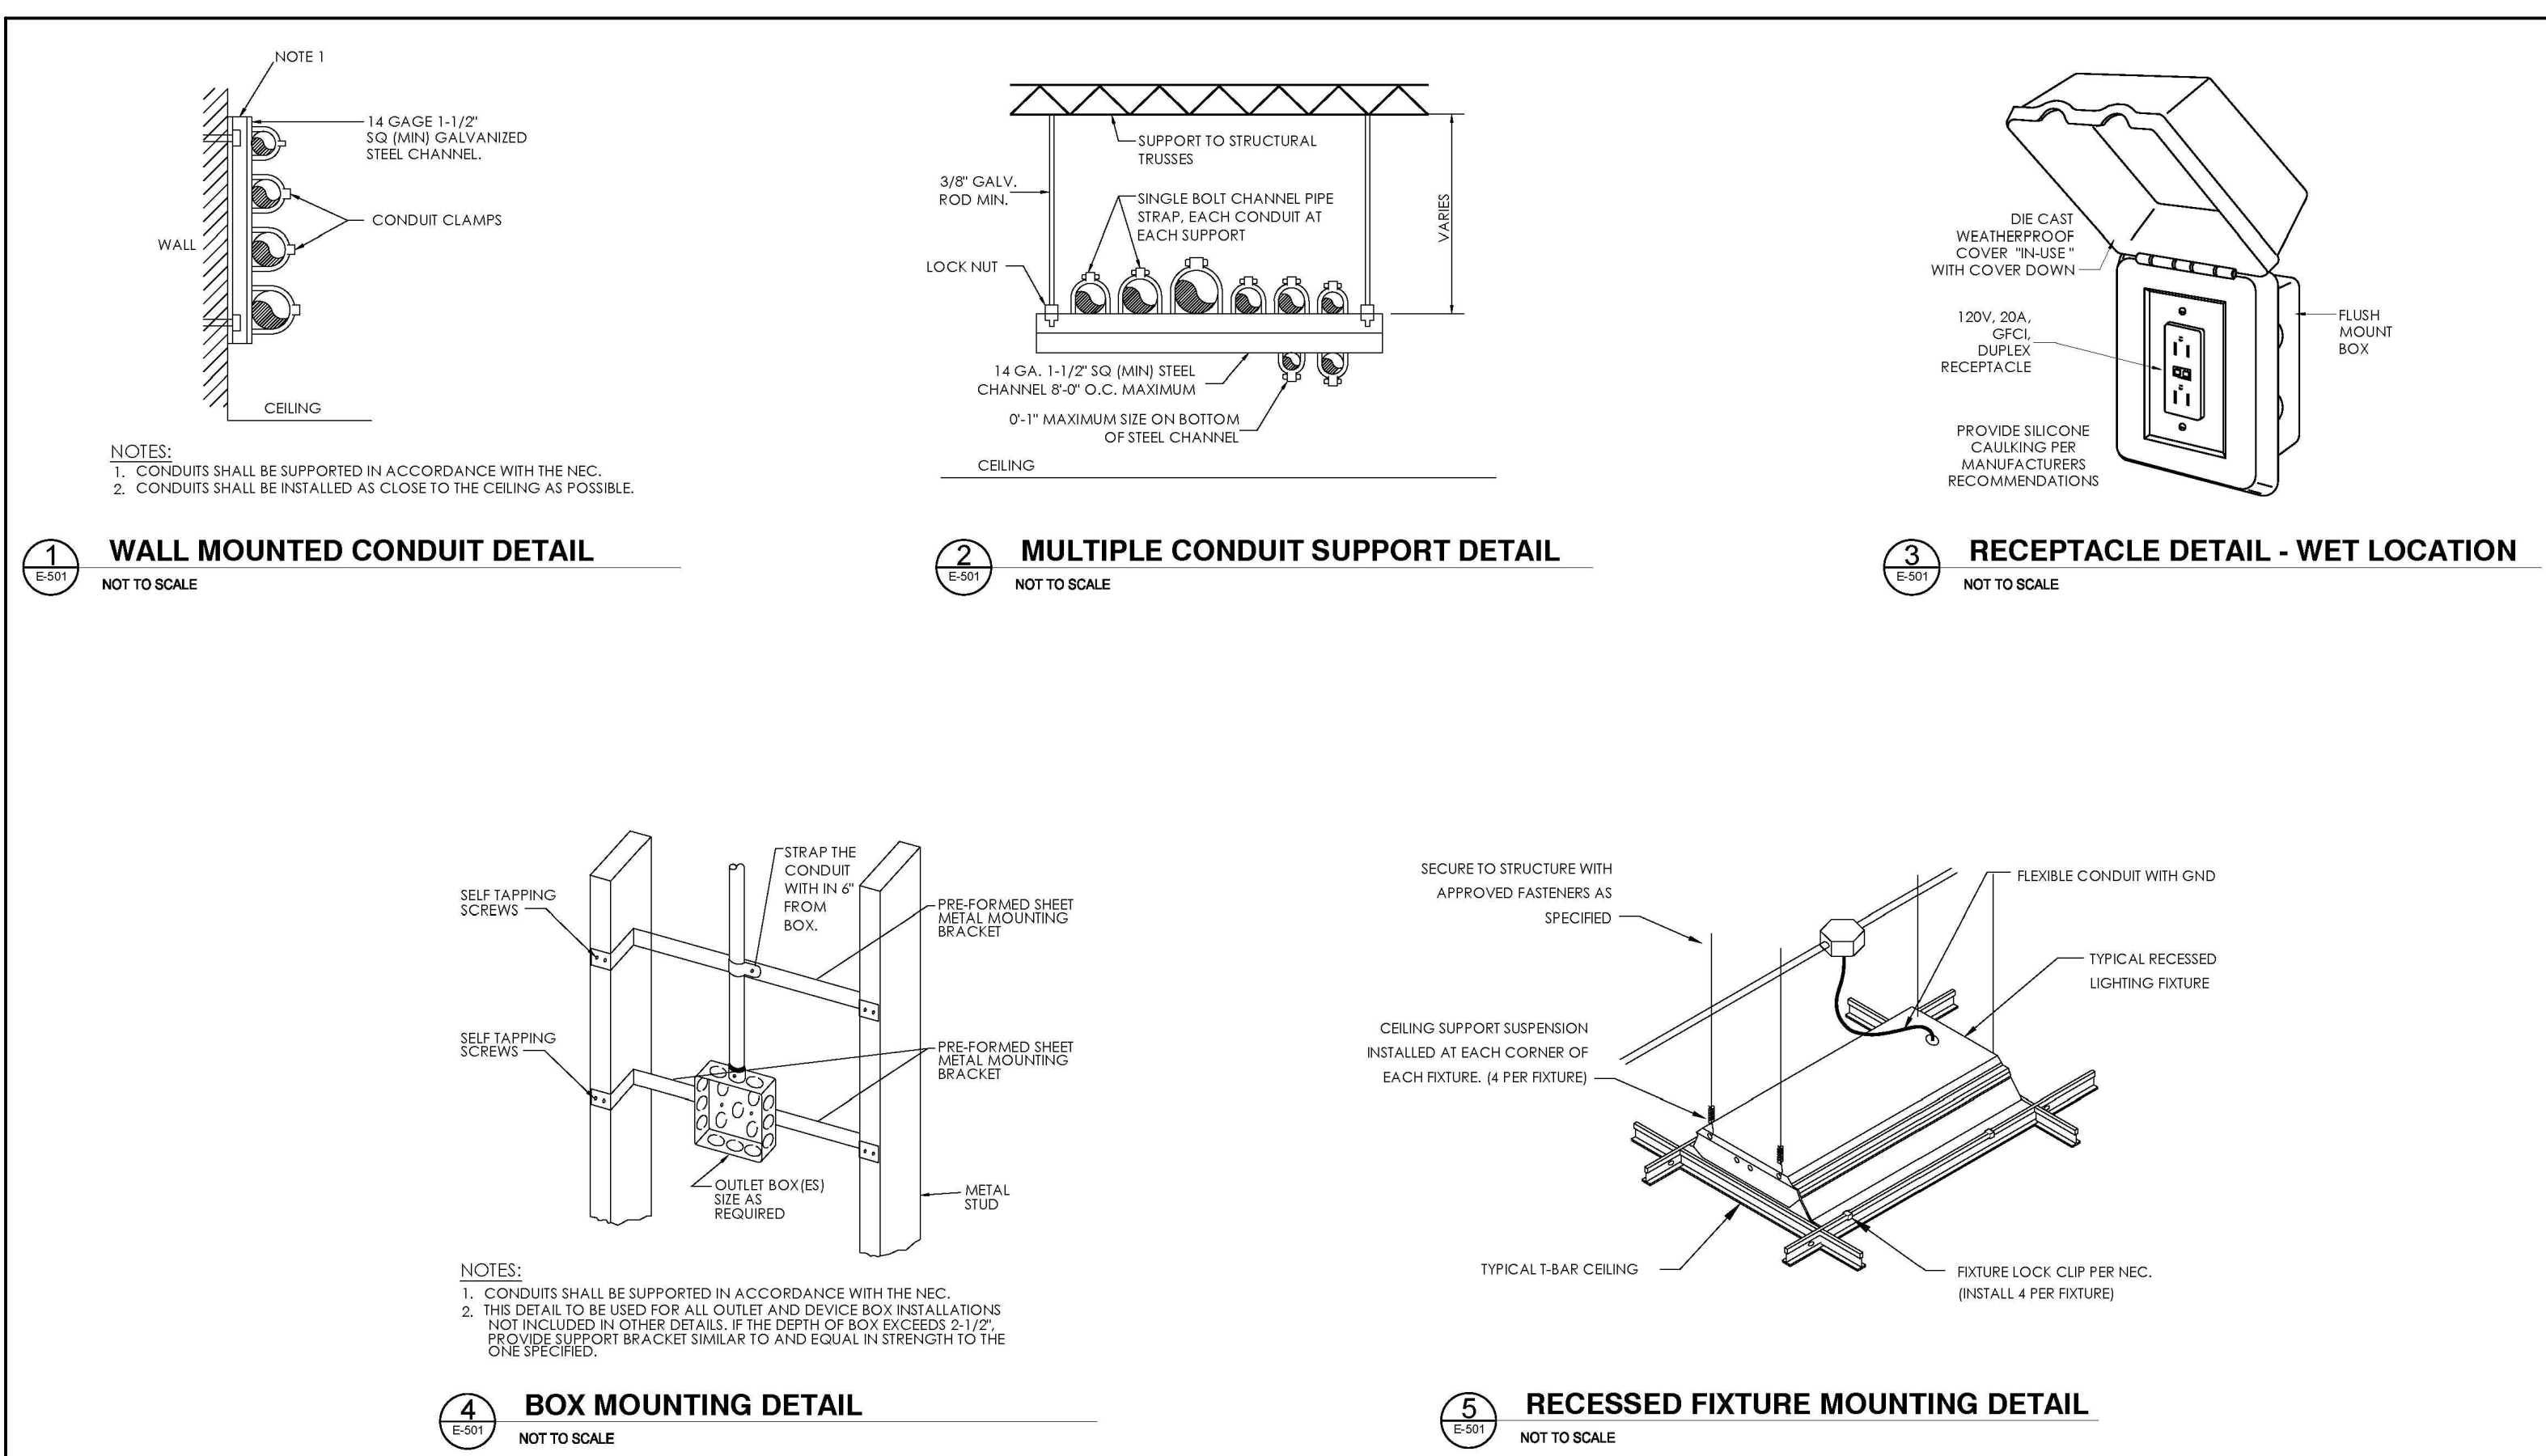

**KEYNOTES**


1. CONTRACTOR SHALL PROVIDE D1, ELECTRICAL PANEL. PROVIDE PANEL TYPE AND INSTALL AS SPECIFIED.
2. CONTRACTOR SHALL PROVIDE COAXIAL CABLE TV IN CONDUIT TO MECHANICAL ROOM NEW C-TV SPLITTER BOX
3. CIRCUIT BREAKER SERVING FACP CIRCUIT D1-20 SHALL HAVE AN APPROVED BREAKER LOCKING DEVICE TO COMPLY WITH NFPA 72
4. CONTRACTOR SHALL PROVIDE NEW GFCI OUTLETS, OR CIRCUITS APPROVED FOR WASHER AND DRYER USAGE.
5. CONTRACTOR SHALL PROVIDE DEDICATED ELECTRICAL PANEL FOR TELECOMMUNICATIONS ROOM IN ACCORDANCE WITH UFC 3-580-01 AND TIA-569-C. REFER TO DIVISION 27 "STATEMENT OF OBJECTIVES (SOO)" FOR ADDITIONAL INFORMATION.
6. CONTRACTOR SHALL PROVIDE NEW ELECTRICAL DISCONNECT AND DEDICATED CIRCUIT FOR NEW PACKAGED UNIT AND TELECOMMUNICATIONS ROOM FAN COIL UNIT.

**GENERAL NOTES**

1. THESE WORK PLANS ARE ONLY MEANT TO CONVEY THE SCOPE OF WORK FOR CONTRACTOR BIDDING AND REFERENCE PURPOSES ONLY. THE CONTRACTOR SHALL BE RESPONSIBLE FOR PROVIDING ALL NECESSARY PLANS, DRAWINGS, LINE DIAGRAMS, PANEL AND LOAD CALCULATIONS BEARING THE SEAL OF AN ELECTRICAL ENGINEER TO ENSURE THE COMPLETE INSTALLATION OF ALL NECESSARY ELECTRICAL SYSTEMS IN THE NEW ADDITION AND BID OPTION AREAS, IF AWARDED.
2. CONTRACTOR SHALL BE RESPONSIBLE FOR VERIFYING EXISTING CONDITIONS, EQUIPMENT, CURRENT PANEL CAPACITY, NEW LOAD REQUIREMENTS, AND DIMENSIONS PRIOR TO START OF WORK.
3. PLACEMENT OF NEW SERVICE CIRCUIT, NEW MAIN SERVICE DISCONNECT, AND NEW MDP SHALL BE DONE BEFORE DEMOLITION. CONTRACTOR SHALL PROVIDE TEMPORARY POWER TO FACILITY TO AVOID POWER INTERRUPTION. THE CONTRACTOR SHALL ENSURE TO HAVE ELECTRICAL EQUIPMENT AND MATERIALS INCLUDING PANELS, SWITCHES, WIRING, CONDUIT, AND ACCESSORIES READY AND AVAILABLE AT THE SITE PRIOR TO BEGINNING WORK ON THE EXISTING FIRE STATION.
4. THE CONTRACTOR SHALL COORDINATE HIS/HER WORK WITH THAT OF ALL OTHER TRADES, INCLUDING BUT NOT LIMITED TO, ELECTRICAL, HVAC, STRUCTURAL AND GENERAL ARCHITECTURE.
5. EXISTING OUTLETS AND RECEPTACLES IN BID OPTION ROOMS ARE TO REMAIN UNLESS NOTED OTHERWISE.
6. THE GOVERNMENT HAS CONFIRMED WITH AEP, AS THE PRIMARY ELECTRICAL SERVICE PROVIDER, THAT A NEW, AND OR, UPSIZED TRANSFORMER WILL NOT BE REQUIRED TO PERFORM THE DESCRIBED IN THESE DRAWINGS.
7. CONTRACTOR SHALL PERFORM ALL ELECTRICAL WORK ACCORDING NEC AND UFC STANDARDS.
8. THE CONTRACTOR SHALL PROVIDE GROUND CONDUCTOR FOR ALL CIRCUITS
9. ALL CONDUCTORS SHALL BE IN CONCEALED EMT CONDUITS IN WALLS OR ABOVE CEILING FOR INTERIOR APPLICATIONS AND IMC CONDUITS FOR EXTERIOR APPLICATIONS UNLESS NOTED OTHERWISE; MINIMUM CONDUCTOR SIZE ALLOWED IS #12 COPPER
10. CONTRACTOR SHALL PROVIDE ALL REQUIRED EQUIPMENTS TO PERFORM THIS JOB ACCORDING TO CODE, INDUSTRY STANDARDS, AS DESCRIBED EVEN IF ALL EQUIPMENT IS NOT LISTED ON THESE DRAWINGS.

**1 POWER PLAN**  
 1/8" = 1' - 0"



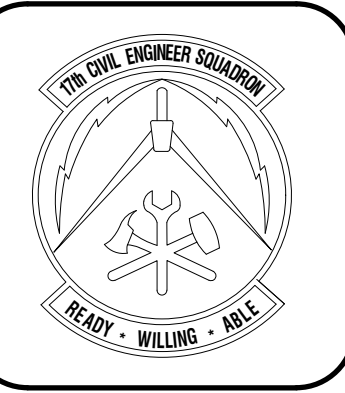

REVISIONS	DATE

Designed by JH/MLA	Drawn by JH/MLA	Reviewed by RT/JH	Submitted by PCBS
-----------------------	--------------------	----------------------	----------------------

PROJECT TITLE  
**FIRE STATION ADD/ALTER, B3321  
PROJECT NO. 1039839  
17th TRAINING WING  
GOODFELLOW AIR FORCE BASE, TEXAS**

Project Number: 1039839
SHEET TITLE <b>PA SYSTEM PLAN</b>
Date: JAN 2024


SEQ. 43	SHEET <b>E-401</b>	OF 50
------------	-----------------------	----------

**KEYNOTES** AS INDICATED BY ☒


1. OUTDOOR SPEAKERS SHALL BE RATED FOR OUTDOOR USE.

**GENERAL NOTES**

1. CONTRACTOR SHALL PROVIDE DEDICATED ALERT SPEAKER WITH A SOFT-START AUDIO OUTPUT CONTROLLABLE FROM THE DISPATCH AND TIED INTO THE FIREFIGHTING ALERT SYSTEM/AMPLIFIER. CONTRACTOR SHALL TIE SPEAKERS TO ANY EXISTING ZONE IN THE PA/AMPLIFIER SYSTEM. SEE E-101
2. CONTRACTOR SHALL DO ALL ELECTRICAL INSTALLATION ACCORDING NEC AND UFC STANDARDS.
3. ALL CONDUCTORS SHALL BE IN CONCEALED EMT CONDUITS IN WALLS OR ABOVE CEILING FOR INTERIOR APPLICATIONS AND IMC CONDUITS FOR EXTERIOR APPLICATIONS UNLESS NOTED OTHERWISE; MINIMUM CONDUCTOR SIZE ALLOWED IS #12 COPPER.
4. THE CONTRACTOR SHALL PROVIDE GROUND CONDUCTOR FOR ALL CIRCUITS, AS APPLICABLE.
5. THE CONTRACTOR SHALL COORDINATE WORK WITH THAT OF ALL OTHER TRADES.
6. CONTRACTOR SHALL PROVIDE ALL REQUIRED EQUIPMENTS TO PERFORM THIS JOB ACCORDING TO CODE, INDUSTRY STANDARDS, AS DESCRIBED EVEN IF ALL EQUIPMENT IS NOT LISTED ON THESE DRAWINGS.

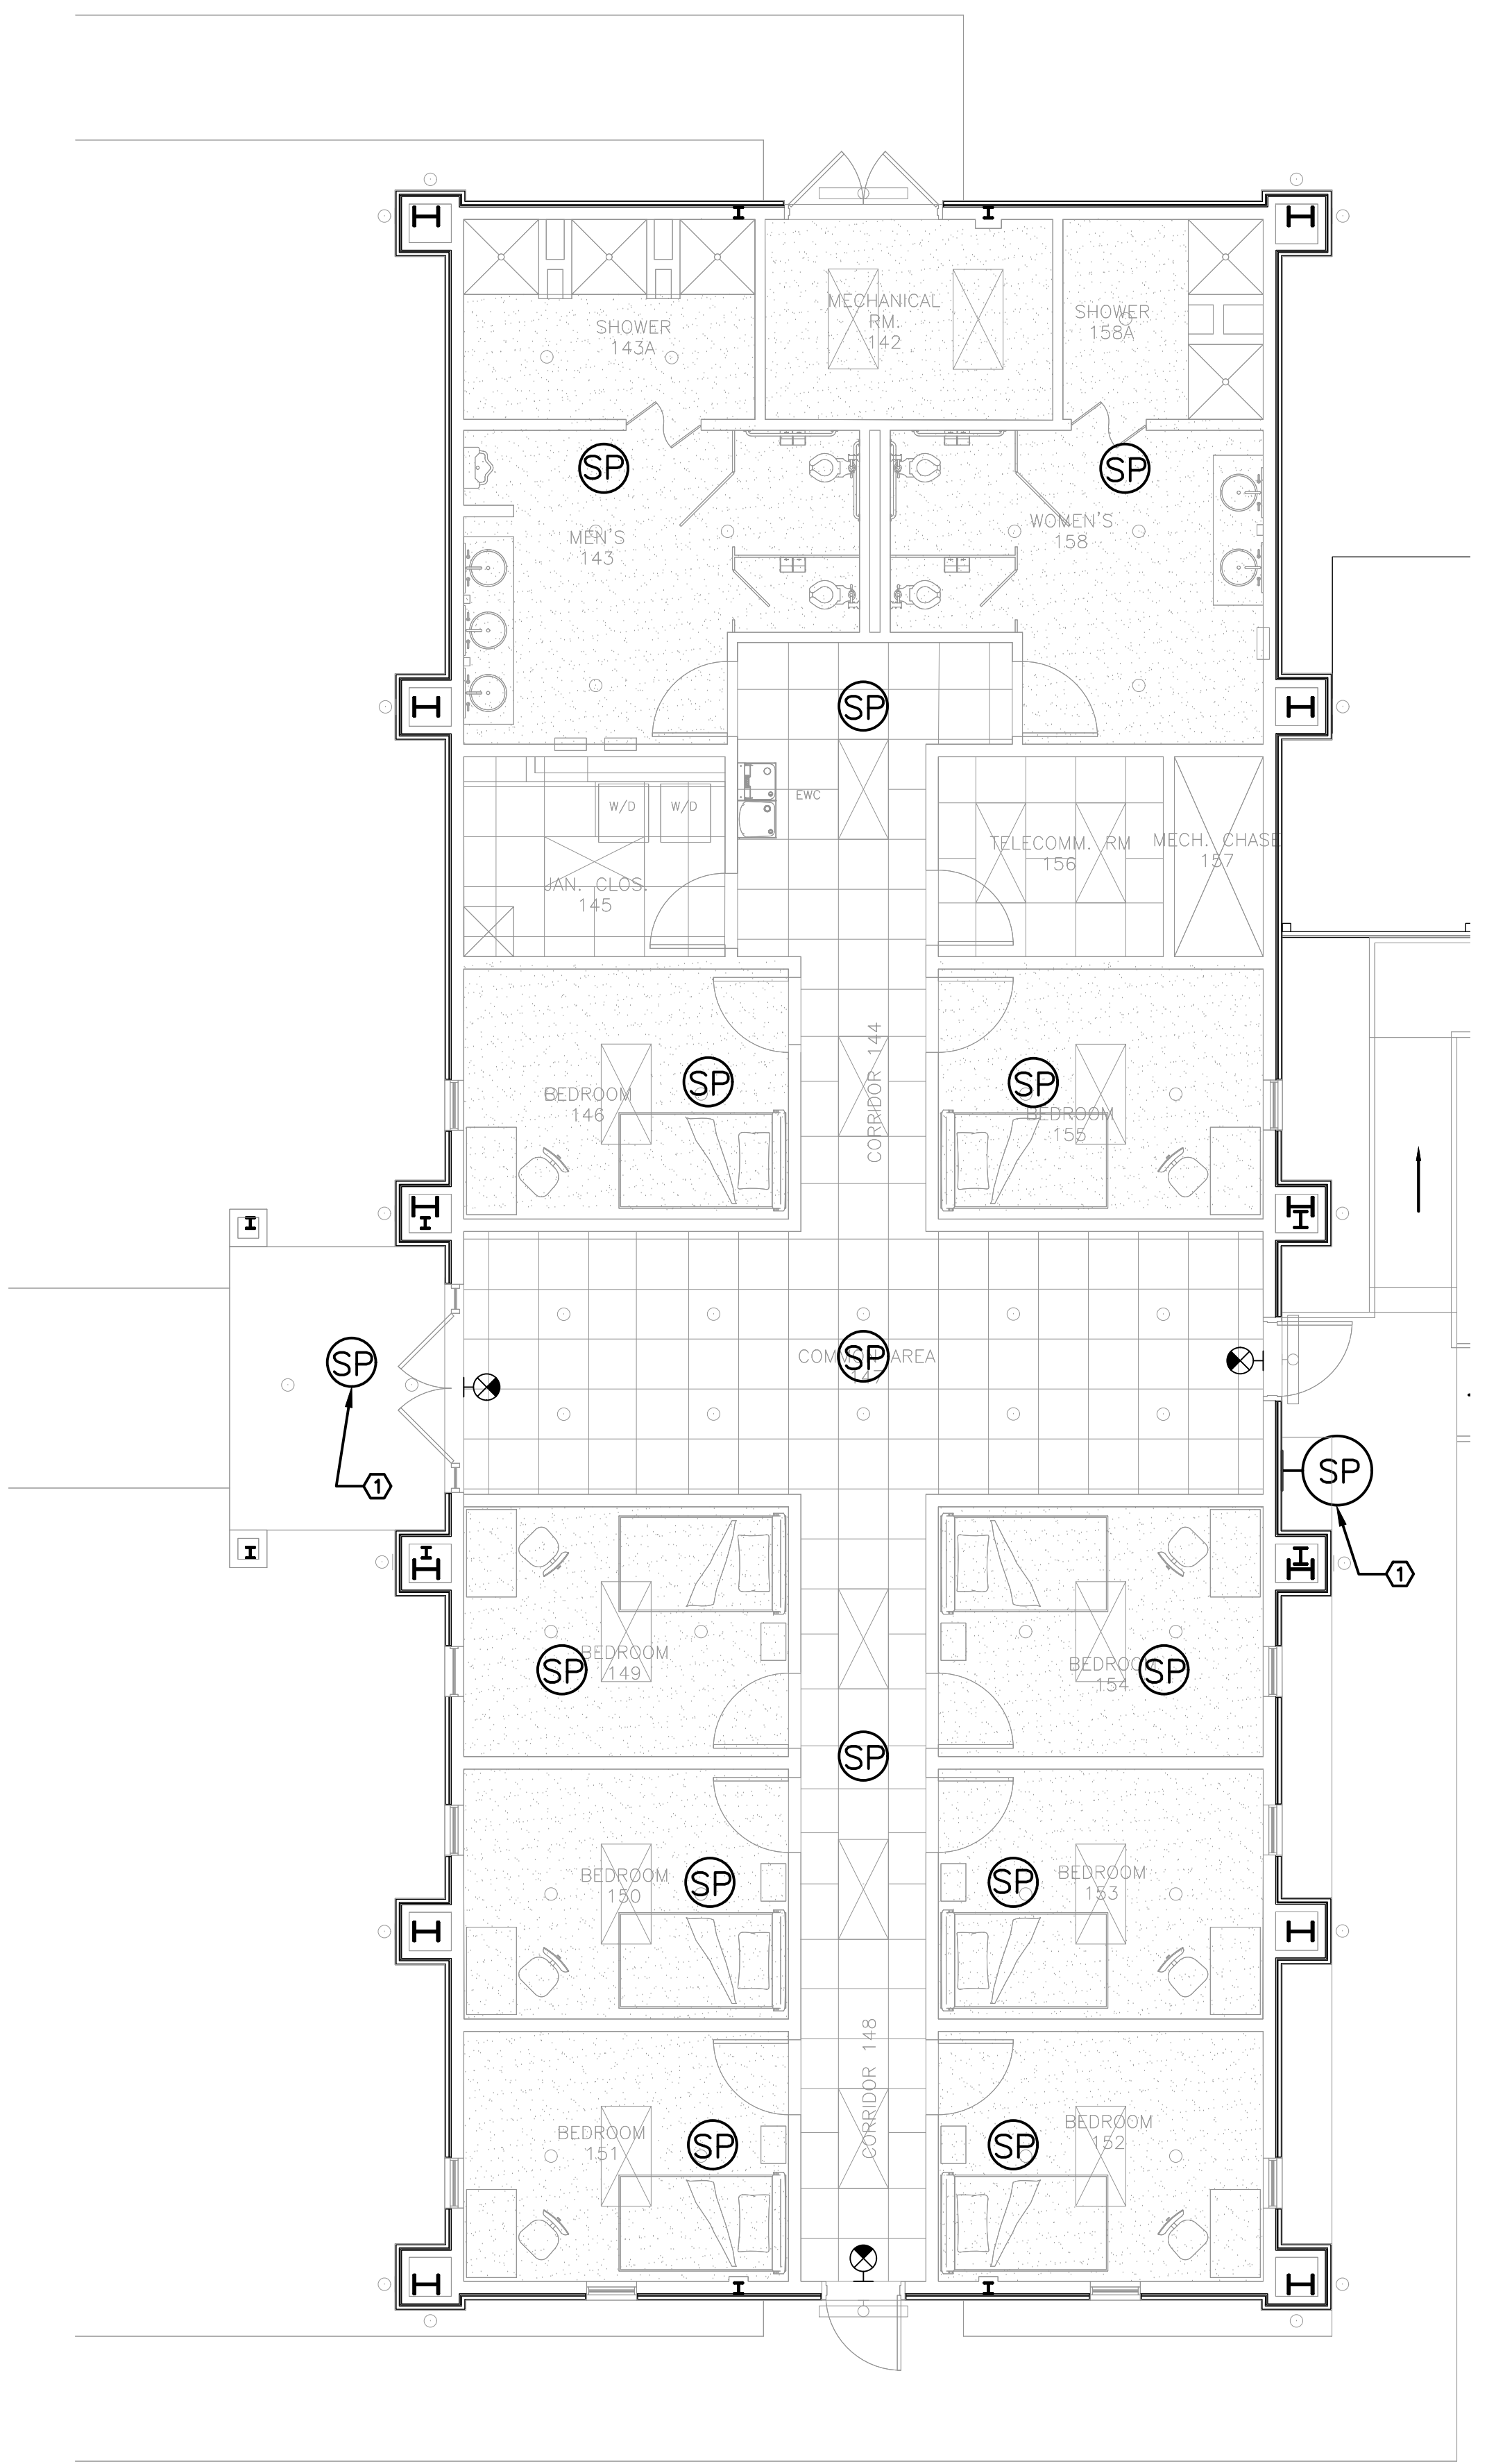

1 PA SYSTEM PLAN  
1/8" = 1' - 0"

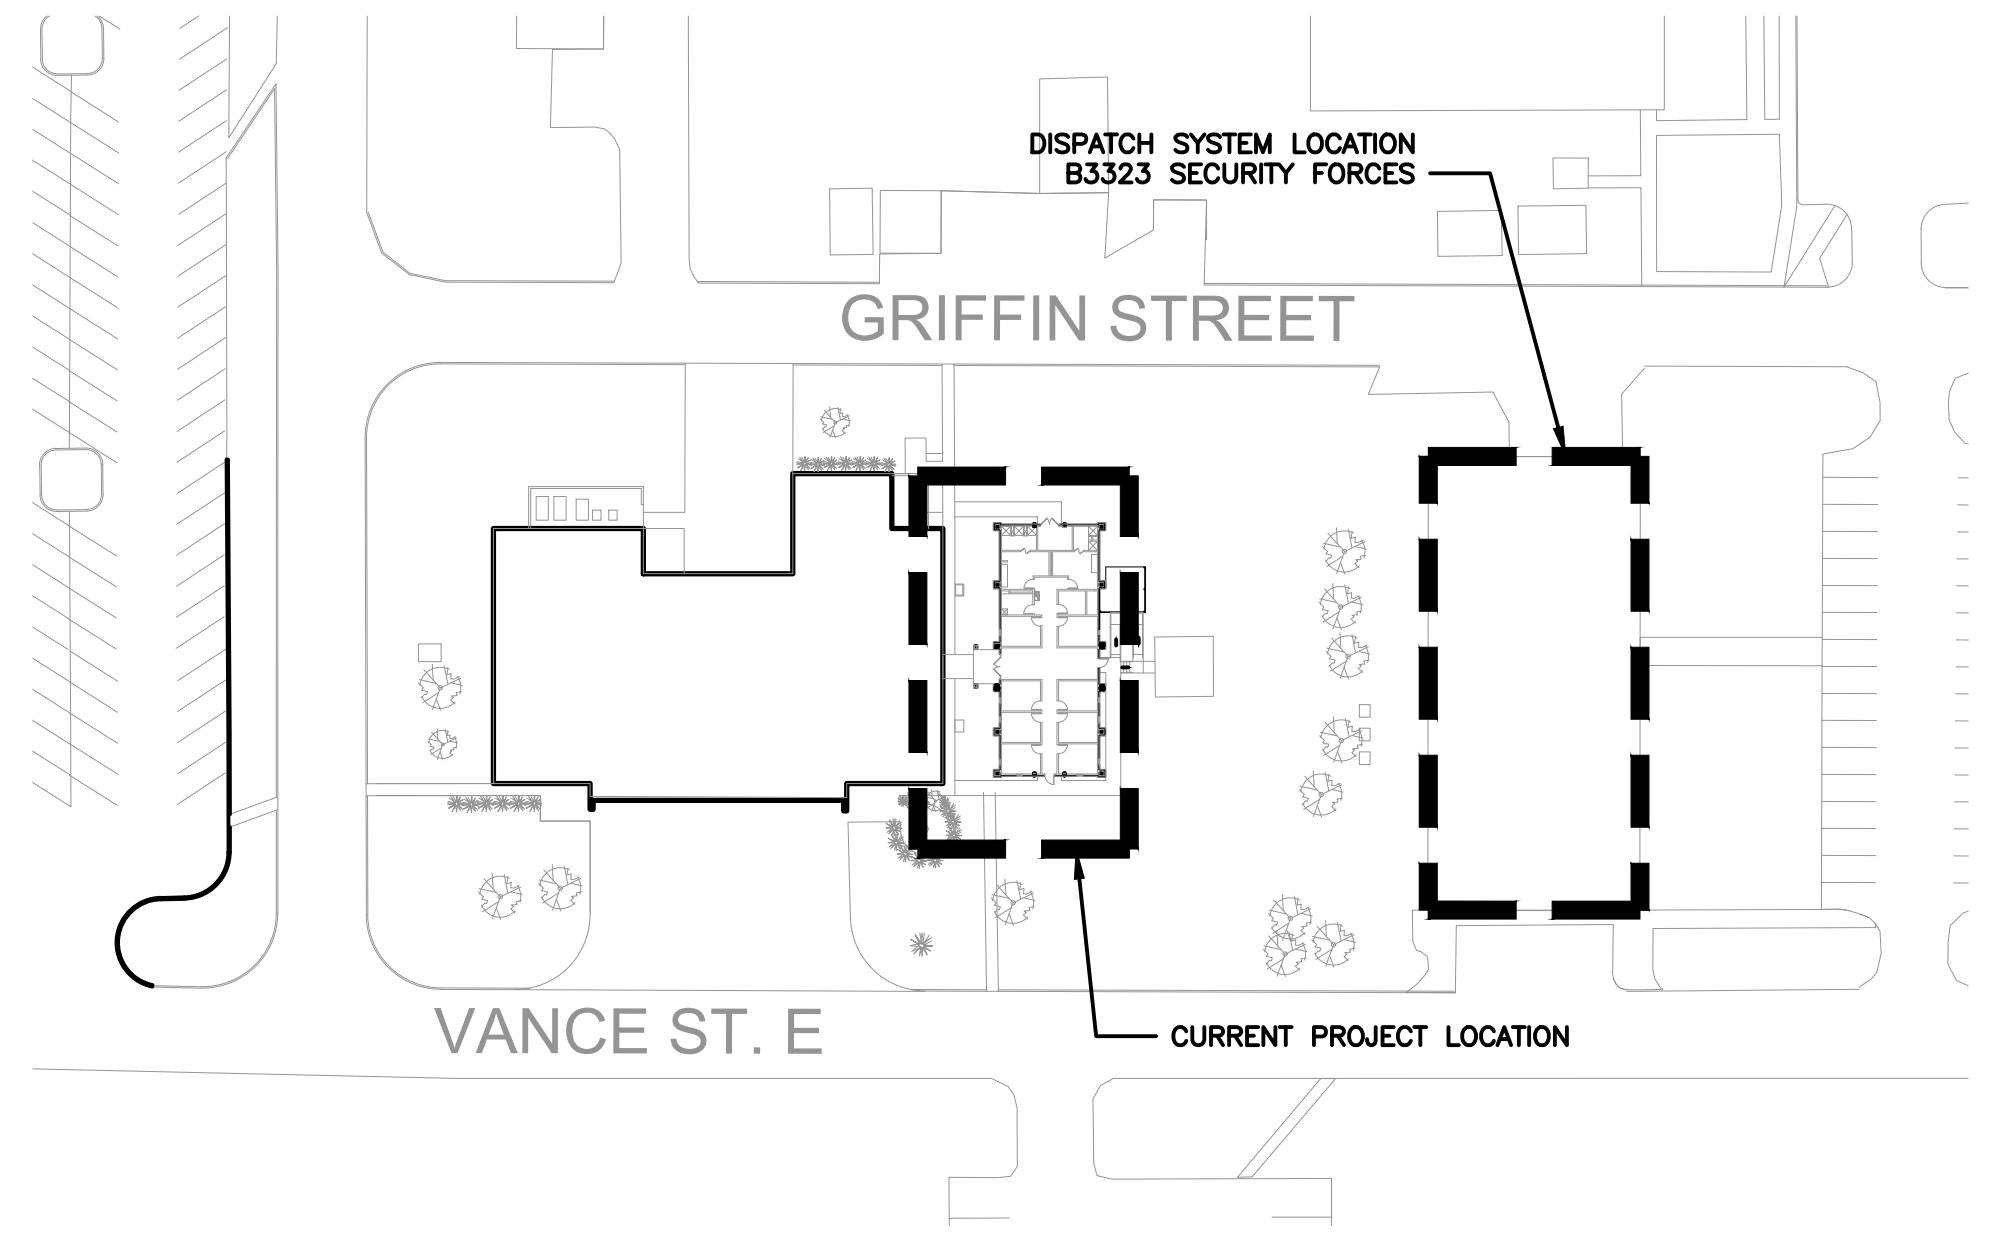

KEY PLAN  
1/8" = 1' - 0"

120/208 V, 3 <sup>φ</sup> , 4W, 600 MLO										120/208 V, 3 <sup>φ</sup> , 4W, 100 mcb									
PANEL MDP					SURFACE MOUNT					PANEL C1					FLUSH MOUNT				
CKT NO.	TRIP AMPS	NO. POLES	LOAD SERVED	PHASE LOAD [VA]			LOAD SERVED	CKT NO.	TRIP AMPS	NO. POLES	LOAD SERVED	PHASE LOAD [VA]			LOAD SERVED	CKT NO.	TRIP AMPS	NO. POLES	
				A	B	C						A	B	C					
1	-	-		2.8				2	-	-	TELEPHONE BOARD	360			2	20	1		
				4.433							500								
3	45	3	Conduit Unit 1	2.8			Conduit Unit 2	4	70	3		500			4	20	1		
				4.433							500								
5	-	-		2.8				6	-	-		500			6	20	1		
				4.433							500								
7	-	-		1.614				8	-	-		500			8	20	1		
				0.722							500								
9	25	3	Air Compressor	1.614			Furnace 2	10	20	30		500			10	20	1		
				0.722							540								
11	-	-		1.614				12	-	-		720			12	20	1		
				0.722							100								
13	-	-		9.211				14	-	-		180			14	20	1		
				10.376							180								
15	100	3	Emergency ATC	9.211			Panel G1	16	100	3		180			16	20	1		
				10.376							180								
17	-	-		9.211				18	-	-		180			18	20	1		
				10.376							180								
19	-	-		9.023				20	-	-					20	-	1		
				8.515															
21	100	3	Panel L1	9.023			Panel P1	22	100	3					22	-	1		
				8.515															
23	-	-		9.023				24	-	-					24	-	1		
				8.515															
25	-	-		16.965			SPACE	26	-	-					26	-	1		
27	200	3	Panel D1	16.965			SPACE	28	-	-					28	-	1		
29	-	-		16.965			SPACE	30	-	-					30	-	1		
TOTAL				63.659	63.659	63.659	TOTAL	TOTAL				2,220	2,400	2,180	TOTAL				

TOTAL CONNECTED LOAD: 238.73 kVA HIGHEST TOTAL AMPS 531  
 ESTIMATED CONNECTED LOAD: 190.98 kVA

TOTAL CONNECTED LOAD: 8500 VA HIGHEST TOTAL AMPS 20  
 ESTIMATED CONNECTED LOAD: 6800 VA

120/208 V, 3 <sup>φ</sup> , 4W, 225A MLO										120/208 V, 3 <sup>φ</sup> , 4W, 100A MCB									
PANEL L1					SURFACE MOUNT					PANEL E1					SURFACE MOUNT				
CKT NO.	TRIP AMPS	NO. POLES	LOAD SERVED	PHASE LOAD [VA]			LOAD SERVED	CKT NO.	TRIP AMPS	NO. POLES	LOAD SERVED	PHASE LOAD [VA]			LOAD SERVED	CKT NO.	TRIP AMPS	NO. POLES	
				A	B	C						A	B	C					
1	20	1	PARKING LOT LIGHTS	1,160			APRON LIGHTS	2	20	1		387			2	20	1		
				1,860							700								
3	20	1	EXTERIOR LIGHTS	400			EXTERIOR LIGHTS	4	20	1		700			4	20	1		
				550							560								
5	20	1	PATIO LIGHTS	770			DORM LIGHTS	6	20	1		1,080			6	20	1		
				910							1,470								
7	20	1	SPARE	770			WEST LIGHTS	8	20	1		1,080			8	20	1		
				910							1,000								
9	20	1	KITCHEN LIGHTS	980			EAST LIGHTS	10	20	1		902			10	20	1		
				1,460							902								
11	20	1	EAST HILL LIGHTS	420			OFFICE LIGHTS	12	20	1		902			12	20	1		
				1,120							902								
13	20	1	WEST EWC	500			GARAGE LIGHTS	14	20	1		902			14	20	1		
				1,080							360								
15	20	1	WEST RECPTLS	900			GARAGE LIGHTS	16	20	1		560			16	20	1		
				1,080							720								
17	20	1	WEST RECPTLS	900			GARAGE LIGHTS	18	20	1		540			18	20	1		
				1,080							1,350								
19	20	1	DORM BED LIGHTS	400			WEST RECPTLS	20	20	1		662			20	-	-		
				360							1,350								
21	20	1	WEST RECPTLS	720			WEST RECPTLS	22	20	1		500			22	20	1		
				540							180								
23	20	1	WEST RECPTLS	720			WEST RECPTLS	24	20	1		180			24	20	1		
				540							180								
25	20	1	DORM BED LIGHTS	400			WEST RECPTLS	26	20	1		180			26	20	1		
				360							180								
27	20	1	DORM BED LIGHTS	400			WEST RECPTLS	28	-	-		180			28	-	-		
				360															
29	20	1	WEST RECPTLS	360			DORM BED LIGHTS	30	-	-					30	-	-		
				400															
31	20	1	SPARE	180			SPACE	32	-	-					32	-	-		
				180															
33	20	1	CLIN 002-DORM LIGHTS	320			SPACE	34	-	-					34	-	-		
				180															
35	20	1	SPARE	180			CLIN 003-LIGHTS/RECPTLS	36	-	-					36	-	-		
				780															
37	1	1	SPACE				SPACE	38	-	-					38	-	-		
39	1	1	SPACE				SPACE	40	-	-					40	-	-		
41	1	1	SPACE				SPACE	42	-	-					42	-	-		
TOTAL				8,700	7,890	8,320	TOTAL	TOTAL				6,801	5,204	6,604	TOTAL				

TOTAL CONNECTED LOAD: 31,138 VA HIGHEST TOTAL AMPS 75  
 ESTIMATED CONNECTED LOAD: 24,910 VA

TOTAL CONNECTED LOAD: 23,261 VA HIGHEST TOTAL AMPS 57  
 ESTIMATED CONNECTED LOAD: 18,609 VA

120/208 V, 3 <sup>φ</sup> , 4W, 100A MCB										120/208 V, 3 <sup>φ</sup> , 4W, 225A MLO									
PANEL G1					FLUSH MOUNT					PANEL P1					SURFACE MOUNT				
CKT NO.	TRIP AMPS	NO. POLES	LOAD SERVED	PHASE LOAD [VA]			LOAD SERVED	CKT NO.	TRIP AMPS	NO. POLES	LOAD SERVED	PHASE LOAD [VA]			LOAD SERVED	CKT NO.	TRIP AMPS	NO. POLES	
				A	B	C						A	B	C					
1	-	-		4,453			HOSE DRYER	2	30	2		500			2	20	1		
				2,392							1,270								
3	-	-	SCBA AIR COMP	4,453				3	20	1	WH RECIRC PUMP	100			4	20	1		
				2,392							400								
5	-	-		4,453			ROOM EXHAUST	6	20	1		360			6	20	1		
				500							720								
7	20	1	EXHAUST AIR COMP	534			STORAGE EXHAUST	7	20	1	EAST RECPTLS	900			7	20	1		
				400							720								
9	20	1	GARAGE RECPTLS	540			GARAGE RECPTLS	10	20	1		720			10	20	1		
				540							500								
11	20	1	GARAGE RECPTLS	540			WASHER	12	20	1		900			12	20	1		
				662							720								
13	20	1	DRYER	662			GARAGE RECPTLS	14	20	1		720			14	20	1		
				720							360								
15	20	1	GARAGE RECPTLS	540			GARAGE RECPTLS	16	20	1		400			16	20	1		
				540							720								
17	20	1	GARAGE RECPTLS	540			GARAGE RECPTLS	18	20	1		900			18	20	1		



PLUMBING SYMBOLS AND ABBREVIATIONS (NOT ALL APPLY)

STANDARD SYMBOLS		ABBREVIATIONS	
SYMBOL	DESCRIPTION	SYMBOL	DESCRIPTION
<b>PIPING-PLUMBING</b>			
	COLD WATER		ELBOW, TURNED DOWN
	HOT WATER		ELBOW, TURNED UP
	HOT WATER RETURN		AIR VENT
	WATER		VACUUM RELIEF
	NON POTABLE WATER		TEE, TURNED UP
	SANITARY SEWER		TEE, TURNED DOWN
	VENT		VALVE IN RISER
	GRAVITY DRAIN		VALVE ON ELBOW UP
	PRESSURE DRAIN		VALVE ON ELBOW DOWN
	ACID WASTE, GRAVITY	<b>CONTROLS</b>	
	ACID VENT		45 ELBOW
	ACID DRAIN, PUMPED		30 ELBOW
	RAIN WATER LEADER		90 ELBOW
	OVERFLOW RAIN WATER LEADER		TEE (SHOW SIZES WHEN REDUCING TEE)
	STORM SEWER		CAP
	SOFT WATER		RUPTURE DISK
<b>PIPING-GASES</b>			
	ARGON		SEALED AIR CHAMBER SHOCK ABSORBER
	BREATHING AIR		FLOOR SINK
	COMPRESSED AIR		EXPANSION JOINT
	CLEAN DRY AIR		LINE STRAINER
	METHANE		CLEAN-OUT TO GRADE
	ACETYLENE		OPEN SIGHT DRAIN, AIR GAP
	CARBON DIOXIDE		WALL CLEANOUT (WCO)
	NATURAL GAS		FLOOR CLEANOUT (FCO)
	HYDROGEN		DIRECTION AND FLOW
	HOUSE CLEANING VACUUM		PRESSURE GAUGE
	HELIUM	<b>VALVES</b>	
	LIQUID ARGON		BALL VALVE
	LIQUID CARBON DIOXIDE		GATE VALVE
	LIQUID HYDROGEN		GLOBE VALVE
	LIQUID NITROGEN		PLUG COCK
	LIQUID OXYGEN		SWING CHECK VALVE
	LIQUID PETROLEUM GAS		SPRING CHECK VALVE
	NITROGEN		HOSE BIBB
	OXYGEN		NEEDLE VALVE
	MEDICAL VACUUM		BUTTERFLY VALVE
	PROCESS VACUUM		BALANCING VALVE
	VACUUM		MOTOR OPERATED GLOBE VALVE
<b>PIPING-FITTINGS</b>			
	SCREWED JOINT		MOTOR OPERATED GATE VALVE
	FLANGED JOINT		SOLENOID OPERATED VALVE
	WELDED JOINT		SOLENOID OPERATED 3-WAY VALVE
	UNION		SELF-CONTAINED TEMP. CONTROL VALVE
	CONCENTRIC REDUCER		EXTERNAL, PRESSURE REDUCING VALVE
	ECCENTRIC REDUCER		INTERNAL, PRESSURE REDUCING VALVE
			THREE WAY VALVE, ELECTRICAL
			THREE WAY VALVE, MANUAL
			THREE WAY VALVE, PNEUMATIC

GENERAL NOTES:

THESE PLUMBING GENERAL NOTES APPLY TO ALL PLUMBING DRAWINGS:

- ALL PLUMBING SHALL MEET THE REQUIREMENTS OF THE INTERNATIONAL PLUMBING CODE (IPC-LATEST EDITION AT TIME OF ISSUANCE OF THE RFP) AND THE CONTRACT SPECIFICATIONS.
- THE DIVISION 22 OPERATIONS SHALL BE SUPERVISED BY A LICENSED MASTER PLUMBER TO ASSURE THAT ALL WORK IS INSTALLED IN ACCORDANCE WITH APPLICABLE CODES AND THE CONSTRUCTION DOCUMENTS.
- DRAWINGS ARE DIAGRAMMATIC ONLY AND SHALL NOT BE SCALED. NOT ALL ITEMS CAN BE SHOWN. CONTRACTOR SHALL DETERMINE LOCATIONS OF EXISTING SYSTEMS, CONDITIONS AND COMPONENTS IN THE FIELD.
- CONTRACTOR SHALL DETERMINE EXACT LOCATIONS OF EXISTING UTILITIES IN THE FIELD, WHETHER OR NOT SHOWN ON DRAWINGS. EXERCISE CAUTION AND IDENTIFY LOCATIONS OF UNMARKED UTILITY LINES AS NECESSARY TO PERFORM WORK OF THIS SECTION.
- IT SHALL BE THE RESPONSIBILITY OF THIS CONTRACTOR TO COORDINATE HIS WORK WITH THAT OF ALL OTHER TRADES, INCLUDING BUT NOT LIMITED TO, ELECTRICAL, HVAC, STRUCTURAL AND GENERAL ARCHITECTURE. CONTRACTOR SHALL ENSURE NO SANITARY SEWER PIPING IS ROUTING PARALLEL IN OR UNDER STRUCTURAL FOUNDATION BEAMS.
- ANY INTERFERENCE SHALL BE BROUGHT TO THE ATTENTION OF THE CONSTRUCTION MANAGER AND CONTRACTING OFFICER, AND SHALL BE RESOLVED PRIOR TO THE INSTALLATION OF THE WORK INVOLVED.
- NO WORK SHALL BE INSTALLED IN VIOLATION OF ANY GOVERNING CODES. ANY WORK SHOWN ON THE DRAWINGS WHICH IS IN VIOLATION OF SUCH CODES SHALL BE BROUGHT TO THE ATTENTION OF THE CONTRACTING OFFICER AND SHALL BE RESOLVED PRIOR TO THE INSTALLATION OF THE WORK INVOLVED.
- ALL PIPING PENETRATING CEILINGS AND WALLS SHALL BE INSTALLED WITH CHROME (STAINLESS STEEL WHERE NOTED) PLATED ESCUTCHEONS AT THE PENETRATION. ALL PIPING PENETRATING RATED PARTITIONS SHALL BE MADE WITH AN APPROVED UL FIRESTOP SYSTEM. EXPOSED PIPING SHALL BE CHROME PLATED.
- VERIFY PLUMBING FIXTURE SCHEDULE WITH CONTRACTING OFFICER PRIOR TO START OF CONSTRUCTION. FIXTURE SELECTIONS AND INSTALLATION SHALL MEET ALL REQUIREMENTS OF THE ARCHITECTURAL BARRIERS ACT (ABA) ACCESSIBILITY REQUIREMENTS.
- CONTRACTOR SHALL BE RESPONSIBLE FOR REPLACING ANY EXISTING WORK DAMAGED DURING THE COURSE OF CONSTRUCTION, WITH EQUAL OR BETTER MATERIAL AND WITHOUT ADDITIONAL CHARGE.
- ALL EQUIPMENT SHALL BE INSTALLED IN STRICT COMPLIANCE WITH MANUFACTURER'S WRITTEN INSTALLATION INSTRUCTION.
- CONTRACTOR SHALL PROVIDE ALL MISCELLANEOUS STEEL SHAPES, HANGER RODS, STRAPS, ETC. REQUIRED FOR ALL SYSTEM INSTALLATIONS FOR A COMPLETE, FUNCTIONAL, FURTHERMORE PROVIDE ALL SEISMIC RESTRAINTS AS REQUIRED BY THE INTERNATIONAL BUILDING CODE.
- SEAL ALL EXTERIOR WALL PENETRATIONS WEATHER TIGHT. FURNISH AND INSTALL RATED SLEEVES AT ALL FIRE WALL PENETRATIONS AND SEAL AROUND ALL PIPE WITH FIRE STOP SEALANT. COORDINATE PENETRATIONS AND FIRE STOPPING WITH THE GENERAL CONTRACTOR AND OR CONSTRUCTION MANAGER.
- CONTRACTOR SHALL MAKE TESTS AT HIS OWN EXPENSE, AS REQUIRED BY CONTRACTING OFFICER AND/OR ANY INSPECTION DEPARTMENT. TEST SHALL BE MADE TO VERIFY WHETHER THE EXISTING PIPING/EQUIPMENT SYSTEM AND NEW PIPING SYSTEMS AND EQUIPMENT INSTALLED COMPLY WITH SPECIFICATIONS AND ARE IN PROPER WORKING ORDER.
- IF THERE IS A DISCREPANCY BETWEEN THE SPECIFICATIONS AND DRAWINGS, THE CONTRACTOR SHALL FURNISH AND INSTALL THE GREATER VALUE AND QUALITY OF EITHER THE SPECIFICATIONS OR DRAWINGS. IN ALL CASES, THE ENGINEER OF RECORD SHALL BE THE INTERPRETER OF THE DOCUMENTS.
- IF THERE IS A DISCREPANCY BETWEEN THE DRAWING DETAILS AND DRAWING FLOOR PLAN, THE CONTRACTOR SHALL FURNISH AND INSTALL THE GREATER VALUE AND QUALITY OF EITHER THE DETAIL OR FLOOR PLAN. IN ALL CASES, THE ENGINEER OF RECORD SHALL BE THE INTERPRETER OF THE DOCUMENTS.
- SANITARY, SOIL, WASTE AND VENT PIPING SHALL SLOPE NOT LESS THAN: 1/8" PER FOOT FOR PIPING 2 1/2" IN DIAMETER OR LESS, 1/16" PER FOOT FOR PIPING 3" TO 6" IN DIAMETER, 1/32" PER FOOT FOR PIPING 8" OR LARGER IN DIAMETER.
- THE CONTRACTOR SHALL PROVIDE ISOLATION VALVES ON WATER PIPING TO EACH GROUP OF FIXTURES. ACCESS PANELS ARE REQUIRED IN GYP BOARD CEILINGS AND WALLS FOR ALL VALVES, TRAPS, CLEANOUTS, ETC. ACCESS PANELS SHALL BE 16 GAGE PAINTABLE STEEL CONSTRUCTION WITH A PIANO HINGED DOOR, FLANGE FRAME, WALL SLEEVE AND VANDAL PROOF SCREWS. PANELS IN EXPOSED TILE OR BLOCK ACCESS PANELS IN FIRE RATED ASSEMBLIES SHALL HAVE THE SAME RATING AS THE ASSEMBLY. STOPS ARE REQUIRED AT ALL PLUMBING FIXTURES.
- WHERE DISSIMILAR METALS ARE TO BE JOINED AS WELL AS PIPES THAT REQUIRE SUPPORTS, APPROVED INSULATION UNIONS AND COOPER CLAD BRACKETS TO SUPPORT PIPES ARE TO BE USED.
- INSULATE ALL HOT AND COLD WATER PIPING. INSULATION SHALL BE OF THE TYPE SPECIFIED PER SPECIFICATIONS AND MINIMUM THICKNESS SPECIFIED IN ASHRAE STANDARD 90.1 LATEST EDITION


(AT DATE OF RFP) AND UFC CRITERIA, WHICHEVER IS GREATER. ALL INSULATION SHALL HAVE COMPLETE FIRE AND SMOKE HAZARD RATINGS. INSULATION SHALL BE A CLASS FIBERGLASS OR EQUIVALENT. MANUFACTURED BY OWENS-CORNING FIBERGLASS OR EQUIVALENT. INSULATION SHALL HAVE A MINIMUM DENSITY OF 4.0 LB AND A K FACTOR OF 0.25.

- CONTRACTOR SHALL BE RESPONSIBLE FOR ALL FIXTURE, CASEWORK AND EQUIPMENT ROUGH-IN DIMENSIONS AND CORRECT FLOOR AND WALL PENETRATIONS.
- ALL DOMESTIC WATER PIPING SHALL BE DISINFECTED IN ACCORDANCE WITH AWWA.
- DRAWINGS DO NOT INDICATE ALL DETAILS, FITTINGS AND EXACT LOCATION OF PIPE OR EQUIPMENT. THE CONTRACTOR SHALL PROVIDE ALL NECESSARY MATERIALS AND LABOR IN AN APPROPRIATE MANNER TO ENSURE FULLY FUNCTIONAL SYSTEMS ACCEPTABLE TO THE CO, OWNER, AUDITED AND ENGINEER.

GENERAL DEMOLITION NOTES:

THESE PLUMBING GENERAL NOTES APPLY TO ALL PLUMBING DRAWINGS:

- PERFORM ALL DEMOLITION IN ACCORDANCE WITH SPECIFICATION SECTION 02 41 00 EXISTING CONDITIONS - DEMOLITION. WORK IS TO BE PERFORMED WITH THE GOAL OF MAXIMIZING SALVAGE AND RECYCLING OF MATERIALS.
- COORDINATE WITH AND OBTAIN APPROVAL FROM CONTRACTING OFFICER FOR ALL UTILITY OUTAGES A MINIMUM OF 72 HOURS IN ADVANCE.
- SECURE ALL OPENINGS THROUGH WALLS, ROOFS AND FLOORS FROM WEATHER DURING CONSTRUCTION.
- SECURE OPENINGS THROUGH ROOFS AND FLOORS FROM FALL AND PROVIDE ALL APPROPRIATE FALL PROTECTION MEASURES PER OSHA REQUIREMENTS.
- SALVAGE EQUIPMENT ITEMS TO A DESIGNATED STORAGE OR DISPOSAL AREA AS DIRECTED BY THE CONTRACTING OFFICER.
- CONTRACTOR TO LOCATE ALL UNDERGROUND UTILITIES PRIOR TO START OF CONSTRUCTION AND MARK APPROPRIATELY.
- CONTRACTOR SHALL REVIEW OWNER'S HAZARDOUS MATERIAL TEST REPORTS AND COORDINATED WORK WITH ABATEMENT CONTRACTOR(S) AS APPROPRIATE. NOTIFY CONTRACTING OFFICER AND/OR CONTRACTING OFFICER'S REPRESENTATIVE IMMEDIATELY OF ANY MATERIAL SUSPECTED OR KNOWN TO BE HAZARDOUS FOR WORK INSTRUCTIONS PRIOR TO CONTINUING OF WORK ON THAT SECTION OR AREA OF CONSTRUCTION AS APPROPRIATE.
- PIPING UNDER CONCRETE SLAB ON GRADE FLOORS MAY BE CUT BELOW CONCRETE FLOOR, CAPPED, AND ABANDONED IN PLACE IF NOT INTERFERING WITH INSTALLATION OF NEW PIPING OR OTHER TRADES.
- CAP ALL UNUSED PIPING BELOW GRADE. MARK ABANDONED PIPING EXTERIOR TO BUILDING WITH METALLIC BURIED WARNING TAPE 6" BELOW GRADE.
- PLUG ALL FLOOR DRAINS TO REMAIN PRIOR TO START OF CONSTRUCTION TO PREVENT ENTRY OF DEBRIS DURING CONSTRUCTION.
- REMOVE ALL RUBBISH AND DEBRIS CAUSED BY THE DEMOLITION WORK AND DISPOSE OF PROPERLY. CLEAN ALL RELATED EXISTING AND NEW PLUMBING FIXTURES AND EQUIPMENT AT COMPLETION OF DEMOLITION WORK.

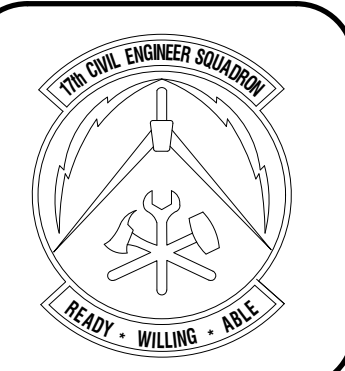


DATE				
REVISIONS				

Designed by	JH/MLLA
Drawn by	JH/MLLA
Reviewed by	RT/JH
Submitted by	PCES

PROJECT TITLE  
**FIRE STATION ADD/ALTER, B3321**  
**PROJECT NO. 1039839**  
**17th TRAINING WING**  
**GOODFELLOW AIR FORCE BASE, TEXAS**

Project Number:	1039839
SHEET TITLE	PLUMBING NOTES SYMBOLS & ABBREVIATIONS
Date:	JAN 2024

SEQ.	SHEET	OF
45	P-001	50

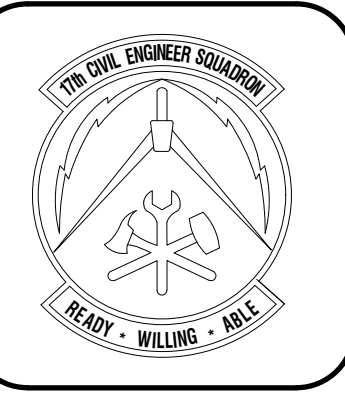


### GENERAL NOTES

1. REFERENCE SHEET P-001 FOR LEGEND, SYMBOLS, ABBREVIATIONS, SPECIFICATIONS AND FURTHER GENERAL NOTES.
2. ALL SANITARY SEWER PIPING SHALL BE PVC SCHEDULE 80.
3. CONTRACTOR SHALL ENSURE WASTE FROM CLOTHES SHALL DISCHARGE THROUGH AN AIR BREAK INTO A STANDPIPE.
4. AIR BREAK SHALL BE PROVIDED BETWEEN THE INDIRECT WASTE PIPE AND THE TRAP SEAL OF THE WASTE RECEPTOR.

### KEYNOTES

1. SS PIPING RISE FROM BELOW FLOOR TO SERVE THE PLUMBING FIXTURE(S). REFERENCE P-301 FOR MORE INFORMATION.
2. VENT PIPING RISE FROM BELOW FLOOR TO SERVE THE PLUMBING FIXTURE(S). REFERENCE P-301 FOR MORE INFORMATION.
3. FURNISH AND INSTALL A FLOOR-MOUNTED, FLOOR OUTLET, FLUSH VALVE WATER CLOSET AND APPURTENANCES. ROUTE 4" SS PIPING FROM THE HORIZONTAL 4" SS BELOW FLOOR TO THE FIXTURE AND CONNECT, ROUTE 2" VENT PIPING FROM THE WATER CLOSETS TO HORIZONTAL VENT PIPE ABOVE. HORIZONTAL VENT PIPE FROM WATER CLOSETS SHALL BE 3", PROVIDE 4" VTR.
4. FURNISH AND INSTALL AN UNDERMOUNT LAVATORY, FAUCET, THERMOSTATIC MIXING VALVE AND APPURTENANCES. ROUTE 1 1/2" SS PIPING FROM THE LAVATORY DRAIN ROUGH-IN CONNECTION DOWN WITHIN THE WALL TO THE HORIZONTAL SS PIPING BELOW THE FLOOR AND CONNECT. ROUTE 2" VENT PIPING UP WITHIN THE WALL FROM THE SS PIPING SERVING THE LAVATORY TO ABOVE THE CEILING AND CONNECT TO THE 2" HORIZONTAL VENT PIPING ABOVE. 2" VERTICAL VENT PIPE AND 2" HORIZONTAL PIPE TO VENTS ABOVE WATER CLOSETS. FURNISH AND INSTALL THE P-TRAP AND APPURTENANCES FROM THE DRAIN TO THE LAVATORY, AND CONNECT.
5. FURNISH AND INSTALL A WALL-HUNG URINAL AND FLUSH VALVE. ROUTE A 2" SS PIPE DOWN WITHIN THE WALL FROM THE OUTLET OF THE URINAL TO THE HORIZONTAL SS PIPE BELOW THE FLOOR AND CONNECT. ROUTE A 2" VENT PIPE UP IN THE WALL FROM THE FIXTURE TO THE HORIZONTAL VENT PIPING AND CONNECT. 2" VERTICAL VENT PIPE AND 2" HORIZONTAL PIPE TO VENTS ABOVE WATER CLOSETS.
6. FURNISH AND INSTALL A SHOWER ASSEMBLY, FAUCETS, THERMOSTATIC MIXING VALVE, ACCESSORIES AND APPURTENANCES. FURNISH AND INSTALL A GRID STRAINER SHOWER DRAIN. TRAP THE DRAIN, ROUTE 1 1/2" SS PIPING BELOW FLOOR, AND CONNECT TO THE HORIZONTAL SS PIPING. ROUTE A 2" VENT UP IN THE WALL TO ABOVE THE CEILING AND CONNECT TO THE HORIZONTAL VENT PIPING.
7. FURNISH AND INSTALL A MOP BASIN, FAUCET, ACCESSORIES AND APPURTENANCES. ROUTE AND P-TRAP THE 1 1/2" SS PIPING FROM THE DRAIN OF THE MOP BASIN TO THE SS PIPING BELOW THE FLOOR AND CONNECT. ROUTE A 2" VENT UP WITHIN THE WALL TO 2" HORIZONTAL VENT ABOVE CEILING AND CONNECT TO EWC. COMBINED 2" VENT PIPE TO 2" VTR.
8. FURNISH AND INSTALL A FLOOR DRAIN WITH TRIP GUARD ASSEMBLY. ROUTE A 2" SS PIPE FROM THE FLOOR DRAIN TRAP OUTLET TO THE HORIZONTAL SS PIPING BELOW FLOOR AND CONNECT. ROUTE A 2" VENT PIPE UP IN THE WALL FROM THE FIXTURE TO THE HORIZONTAL VENT PIPING IN THE ATTIC AND CONNECT.
9. FURNISH AND INSTALL A WALL-HUNG, BI-LEVEL DRINKING FOUNTAIN WITH BOTTLE FILLER. ROUTE A 1 1/2" SS PIPE FROM THE OUTLET OF THE ELECTRIC DRINKING FOUNTAIN DOWN WITHIN THE WALL AND TO THE HORIZONTAL SS AND CONNECT. FURNISH AND INSTALL A WCO. ROUTE A 2" VENT UP WITHIN THE WALL TO THE HORIZONTAL VENT ABOVE CEILING AND CONNECT TO MOP SINK (MS-1). COMBINED 2" VENT PIPE TO 2" VTR.
10. FURNISH AND INSTALL A GAS WATER HEATER, SUPPORT PLATFORM, EXPANSION TANK, DRAIN PAN, AND APPURTENANCES. REFERENCE DETAIL 3/P-501 FOR MORE INFORMATION. ROUTE THE 3/4" T&P PIPING DOWN TO EXISTING FLOOR DRAIN, TURN DOWN AND TERMINATE.
11. FURNISH AND INSTALL ALL CLEANOUTS IN AN ACCESSIBLE LOCATION A MINIMUM OF 42" AFF. THE WALL CLEANOUT ACCESS COVER SHALL BE CONSTRUCTED OF STAINLESS STEEL.

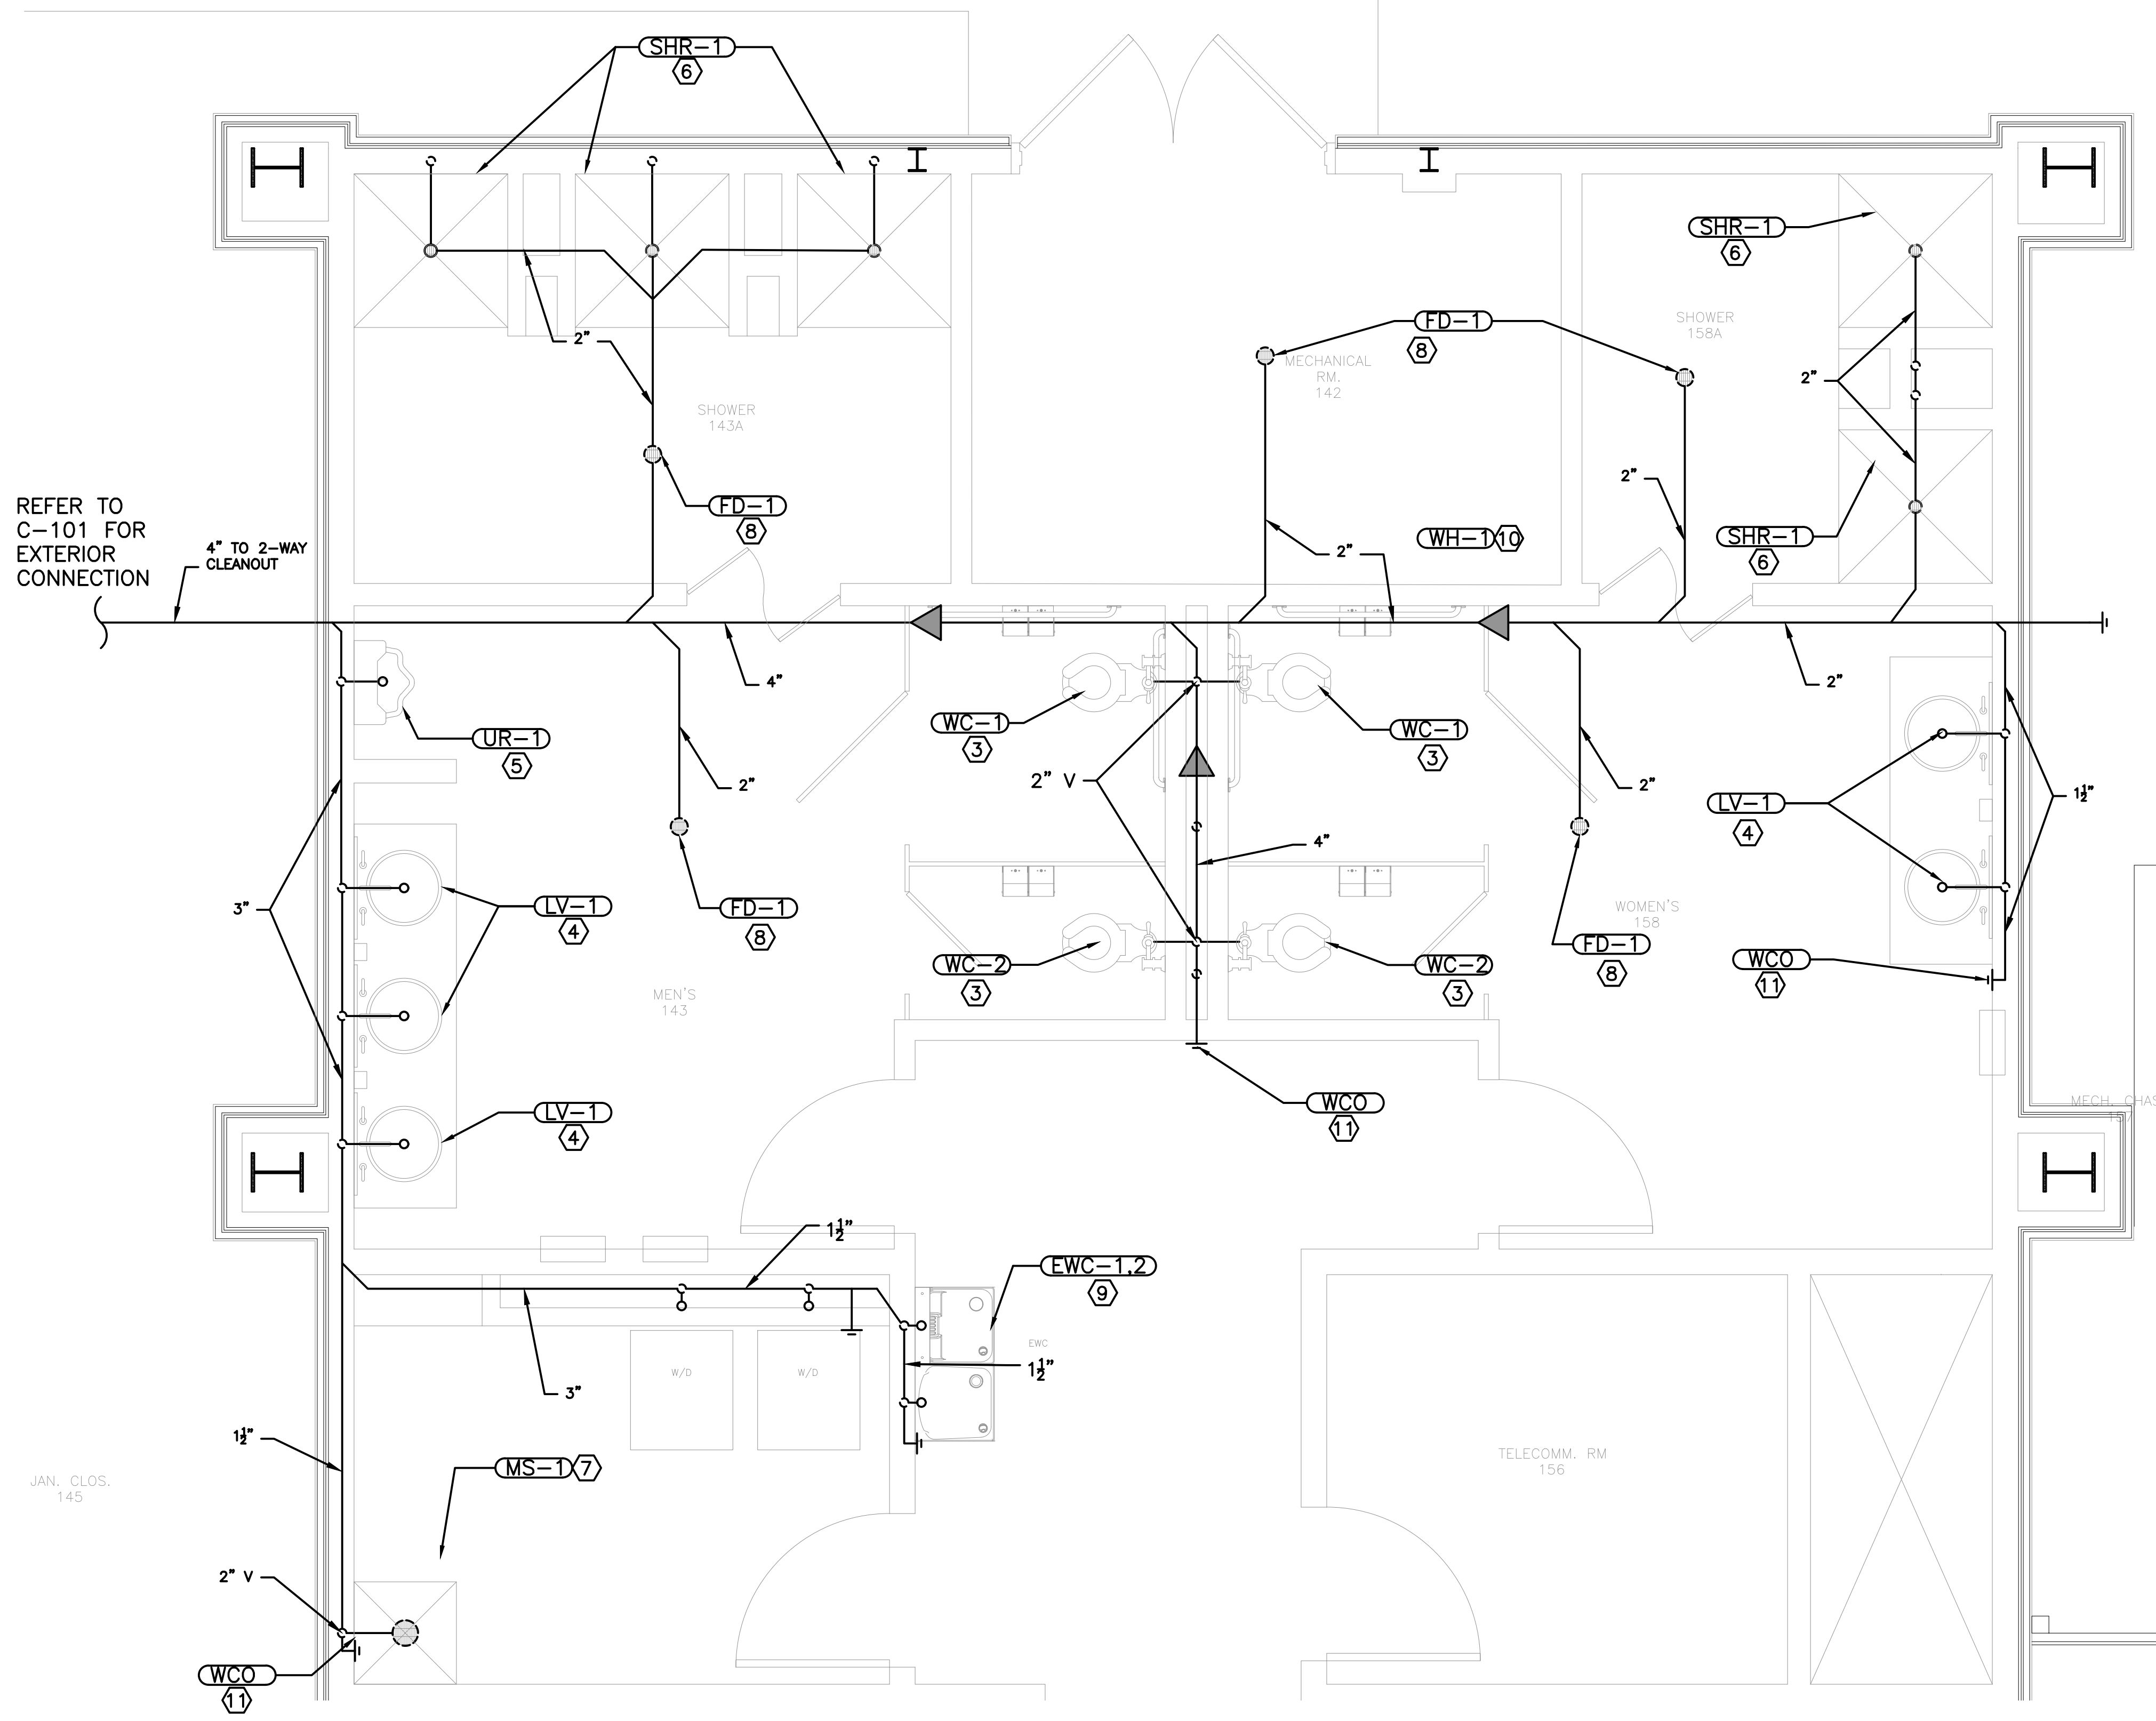


REFER TO C-101 FOR EXTERIOR CONNECTION

JAN. CLOS. 145

## 1 SANITARY SEWER PLAN

3/16" = 1' - 0"

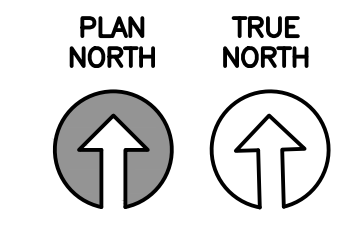

DATE	REVISIONS


Designed by JHR/MLA	Drawn by JHR/MLA	Reviewed by RTI/JH	Submitted by PCBS
------------------------	---------------------	-----------------------	----------------------

PROJECT TITLE  
**FIRE STATION ADD/ALTER, B3321**  
**PROJECT NO. 1039839**  
**17th TRAINING WING**  
**GOODFELLOW AIR FORCE BASE, TEXAS**

Project Number: 1039839
SHEET TITLE SANITARY SEWER PLAN
Date: JAN 2024

SEQ. 46	SHEET <b>P-101</b>	OF 50
------------	-----------------------	----------



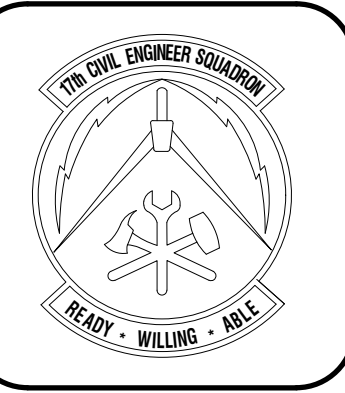


### GENERAL NOTES


1. REFERENCE SHEET P-001 FOR LEGEND, SYMBOLS, ABBREVIATIONS, SPECIFICATIONS AND FURTHER GENERAL NOTES.
2. DOMESTIC PLUMBING SHALL BE (PEX) OR APPROVED EQUAL.
  - 2.1. PEX PIPING SHALL BE INSTALLED ACCORDING TO THE MANUFACTURER'S RECOMMENDATIONS.
3. CONTRACTOR SHALL FURNISH AND INSTALL AN ACCESS PANEL FOR ITEMS IN INACCESSIBLE LOCATIONS.
4. FOR WASHER/DRYER LOCATIONS, WATER SUPPLY TO WASHER SHALL BE PROTECTED AGAINST BACKFLOW BY AN AIR GAP THAT INTEGRAL WITH THE MACHINE. (X)

### KEYNOTES

1. FURNISH AND INSTALL A FLOOR-MOUNTED, FLOOR OUTLET, FLUSH VALVE WATER CLOSET AND APPURTENANCES. ROUTE A 1" CW PIPING FROM THE HORIZONTAL CW PIPING ABOVE THE CEILING DOWN WITHIN THE WALL TO THE ROUGH-IN CONNECTION AT THE WALL. FURNISH AND INSTALL A SUPPLY, STOP AND APPURTENANCES FROM THE CW ROUGH-IN TO THE WATER CLOSET AND CONNECT.
2. FURNISH AND INSTALL AN UNDERMOUNT LAVATORY, FAUCET, THERMOSTATIC MIXING VALVE AND APPURTENANCES. ROUTE 1/2" CW AND 1/2" HW PIPING FROM THE HORIZONTAL CW & HW PIPING ABOVE THE CEILING DOWN WITHIN THE WALL TO THE ROUGH-IN CONNECTION, TO THE THERMOSTATIC MIXING VALVE AND LAVATORY FAUCET AND CONNECT. FURNISH AND INSTALL THE SUPPLIES, STOPS, AND APPURTENANCES FROM THE CW, AND HW ROUGH-INS TO THE LAVATORY, THERMOSTATIC MIXING VALVE AND FAUCET AND CONNECT.
3. FURNISH AND INSTALL A WALL-HUNG URINAL AND DFLUSH VALVE. ROUTE A 3/4" CW PIPE FROM THE HORIZONTAL CW PIPE ABOVE THE CEILING DOWN IN THE WALL TO THE INLET OF THE FLUSH VALVE AND CONNECT.
4. FURNISH AND INSTALL A SHOWER ASSEMBLY, FAUCETS, THERMOSTATIC MIXING VALVE, ACCESSORIES AND APPURTENANCES. ROUTE 1/2" CW AND 1/2" HW PIPING FROM THE (PEX) MANIFOLD IN MECHANICAL ROOM, ABOVE THE CEILING DOWN WITHIN THE WALL TO THE ROUGH-IN AND CONNECT.
5. FURNISH AND INSTALL A MOP BASIN, FAUCET, ACCESSORIES AND APPURTENANCES. ROUTE 3/4" CW AND 3/4" HW FROM THE CW AND HW PIPING ABOVE THE CEILING DOWN IN THE WALL TO THE FAUCET AND CONNECT.
6. FURNISH AND INSTALL A WALL-HUNG, BI-LEVEL DRINKING FOUNTAIN WITH BOTTLE FILLER. ROUTE 1/2" CW PIPE FROM THE HORIZONTAL CW PIPE ABOVE THE CEILING DOWN IN THE WALL TO THE INLET OF THE ELECTRIC DRINKING FOUNTAIN AND CONNECT.
7. FURNISH AND INSTALL A WATER HAMMER ARRESTOR, VALVE AND ACCESS PANEL. THE ARRESTOR SHALL BE INSTALLED WITHIN THE WALL/CHASE CAVITY. FURNISH AND INSTALL AN ACCESS PANEL AT THE INACCESSIBLE LOCATION.
8. FURNISH AND INSTALL A CIRCUIT SETTER ABOVE THE CEILING. SET THE CIRCUIT SETTER TO 0.5 GPM.

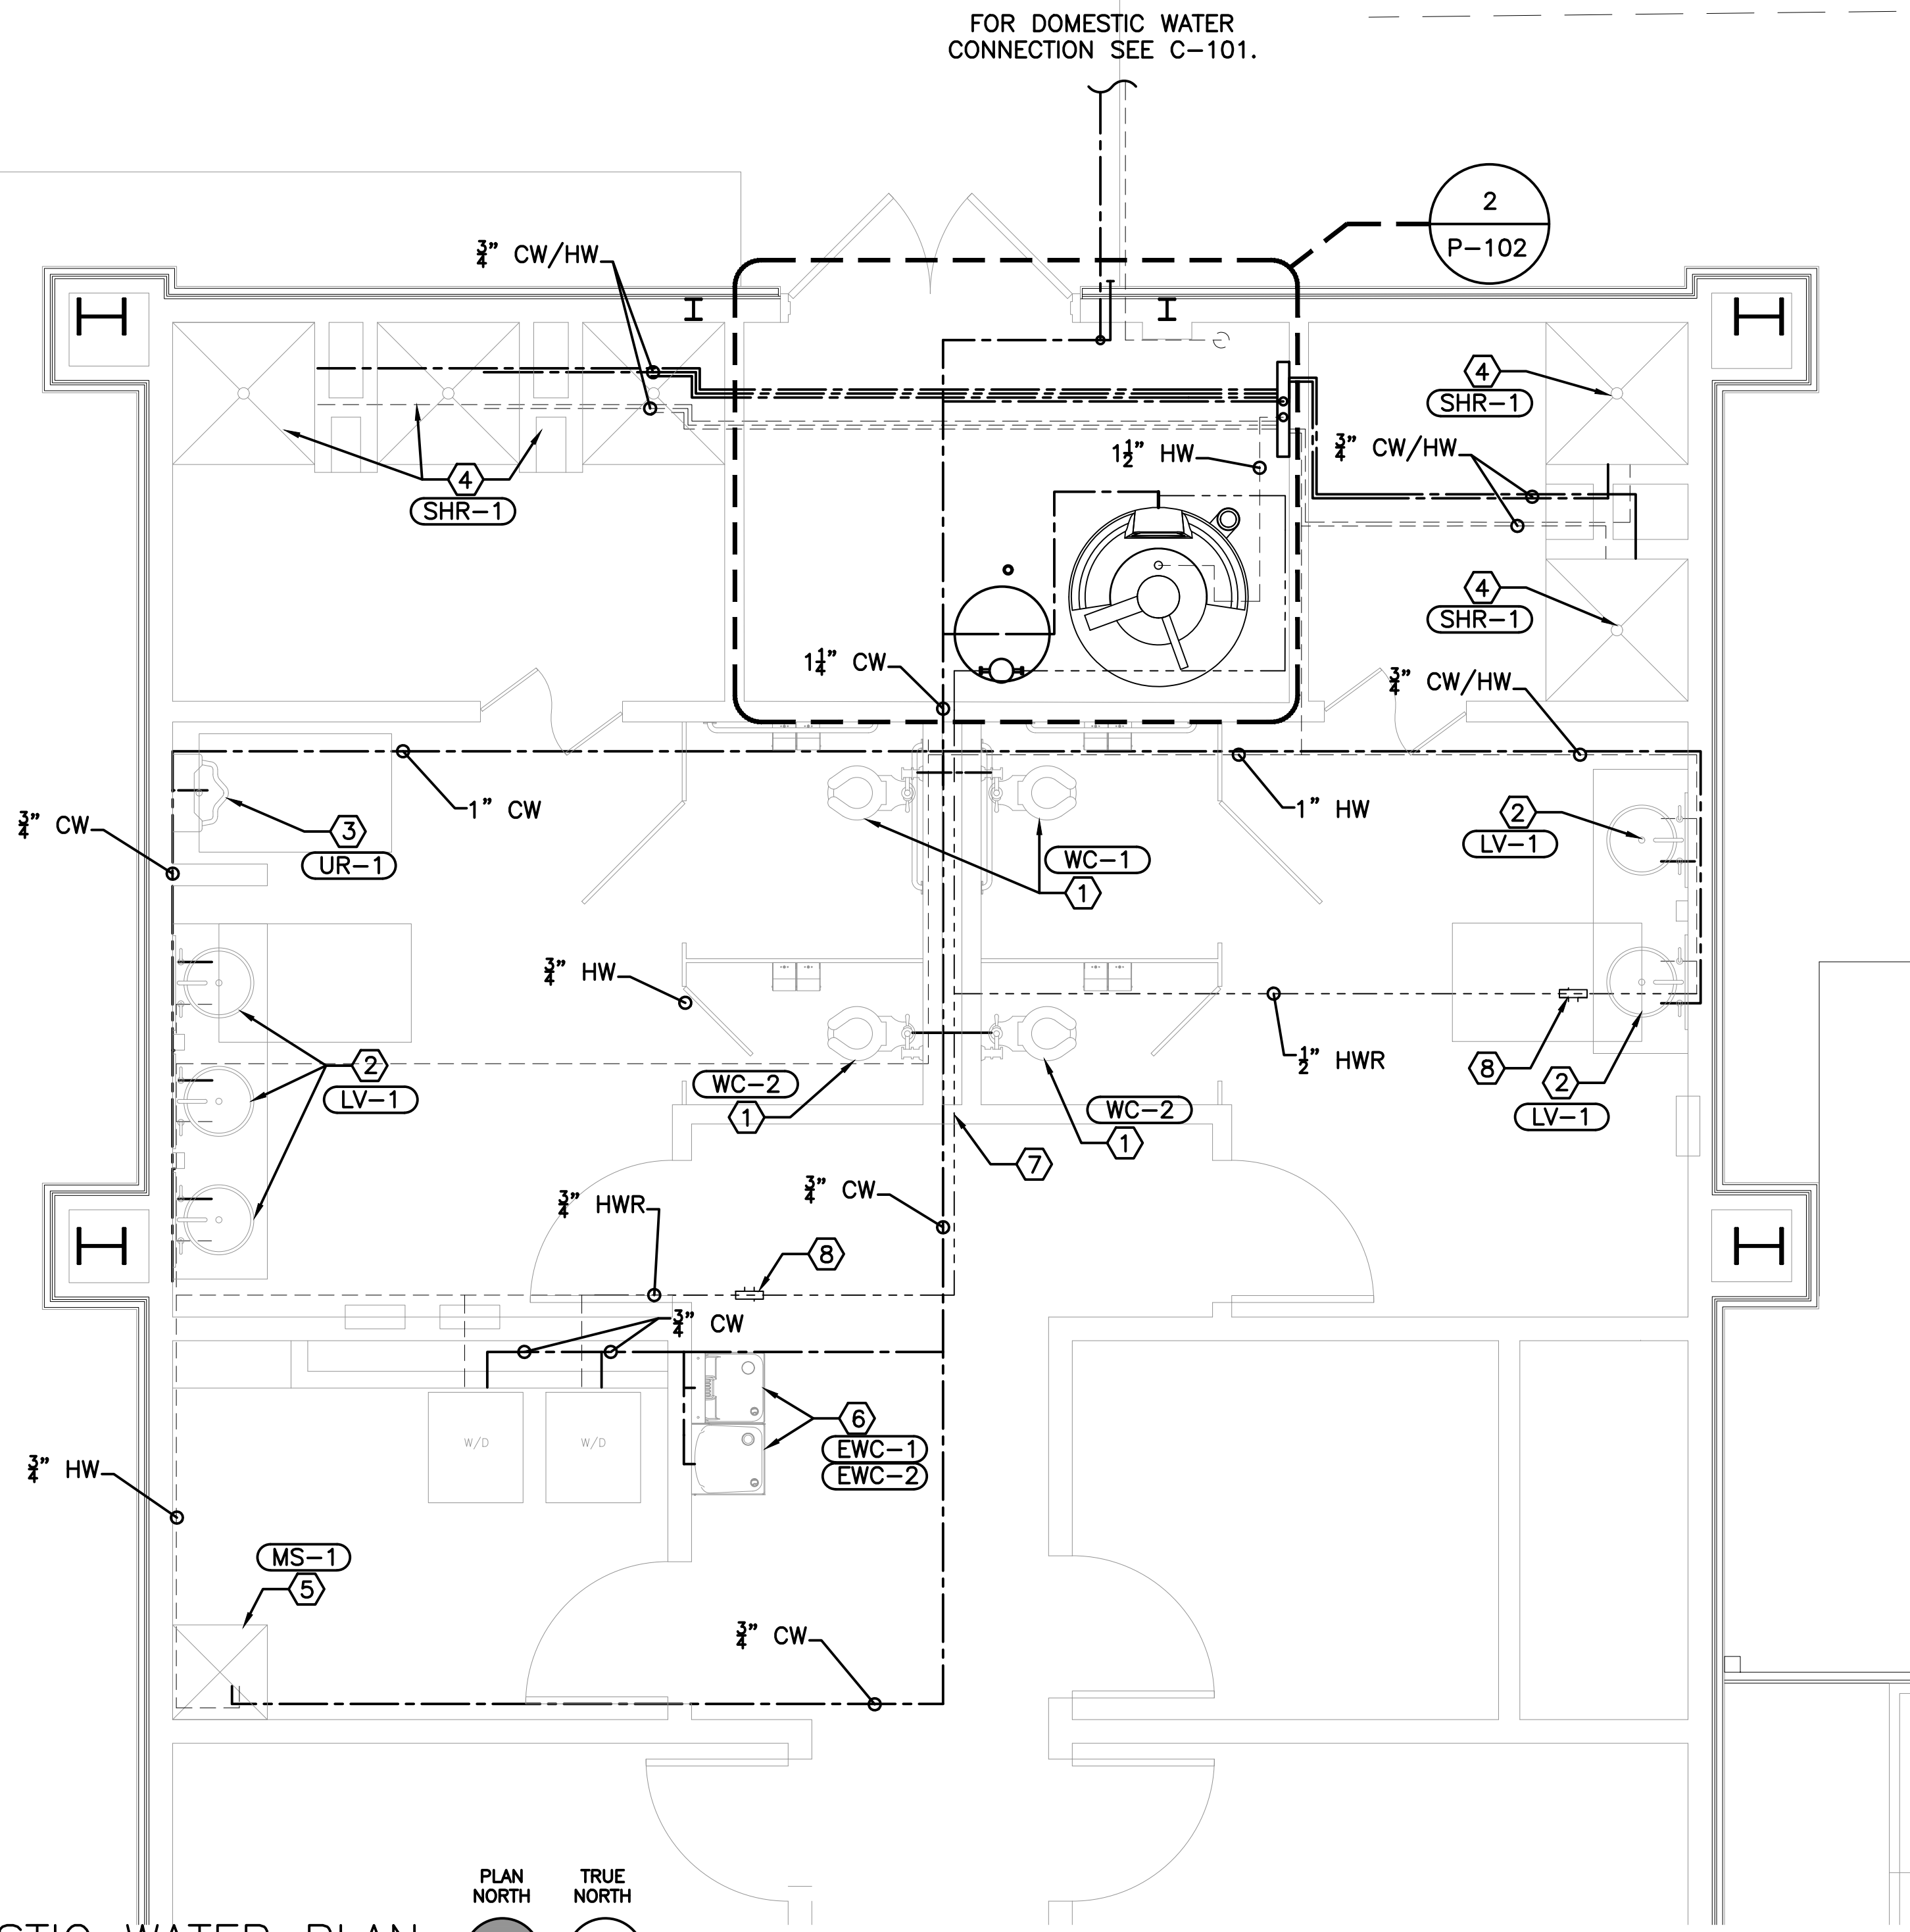


1 DOMESTIC WATER PLAN  
1/4" = 1' - 0"

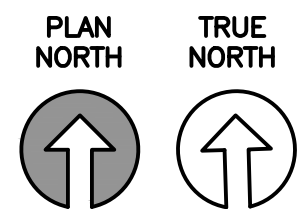


### ENLARGED MECH. RM. KEYNOTES (X)

1. CONTRACTOR SHALL CONNECT TO EXISTING DOMESTIC WATER MAIN. RE:C101
2. NOT USED.
3. CONTRACTOR SHALL FURNISH AND INSTALL A GAS WATER HEATER, SUPPORT PLATFORM, EXPANSION TANK, DRAIN PAN, AND APPURTENANCES, REFERENCES SHEET P-501 FOR ADDITIONAL INFORMATION. ROUTE THE 3/4" T&P PIPING DOWN TO EXISTING FLOOR DRAIN, TURN DOWN AND TERMINATE.
4. CONTRACTOR SHALL FURNISH AND INSTALL GAS PIPING CONNECTION TO EQUIPMENT, REFERENCE SHEET P-501.
5. CONTRACTOR SHALL FURNISH AND INSTALL A DOMESTIC HOT WATER RECIRCULATION PUMP, REFERENCE SHEET P-501.
6. CONTRACTOR SHALL FURNISH AND INSTALL A DOMESTIC PLUMBING APPROVED PEX CW AND HW MANIFOLD.
7. NATURAL GAS SERVICE CONNECTION. REFER TO C-101.
8. DASHED LINE INDICATES NEW FIRE SUPPRESSION RISER ASSEMBLY AND DOUBLE CHECK BACKFLOW PREVENTER PER IPC. COORDINATE SIZE AND ASSEMBLY WITH QFPE. REFER TO FA-101.
9. CONTRACTOR SHALL PROVIDE DOMESTIC WATER RISER AND ENTRY POINT
10. CONTRACTOR TO PROVIDE NEW 1/2" EXTERIOR WALL HYDRANT AND COVERED ENCLOSURE.
11. CONTRACTOR TO PROVIDE NEW WATER SERVICE ENTRANCE ISOLATION VALVE.

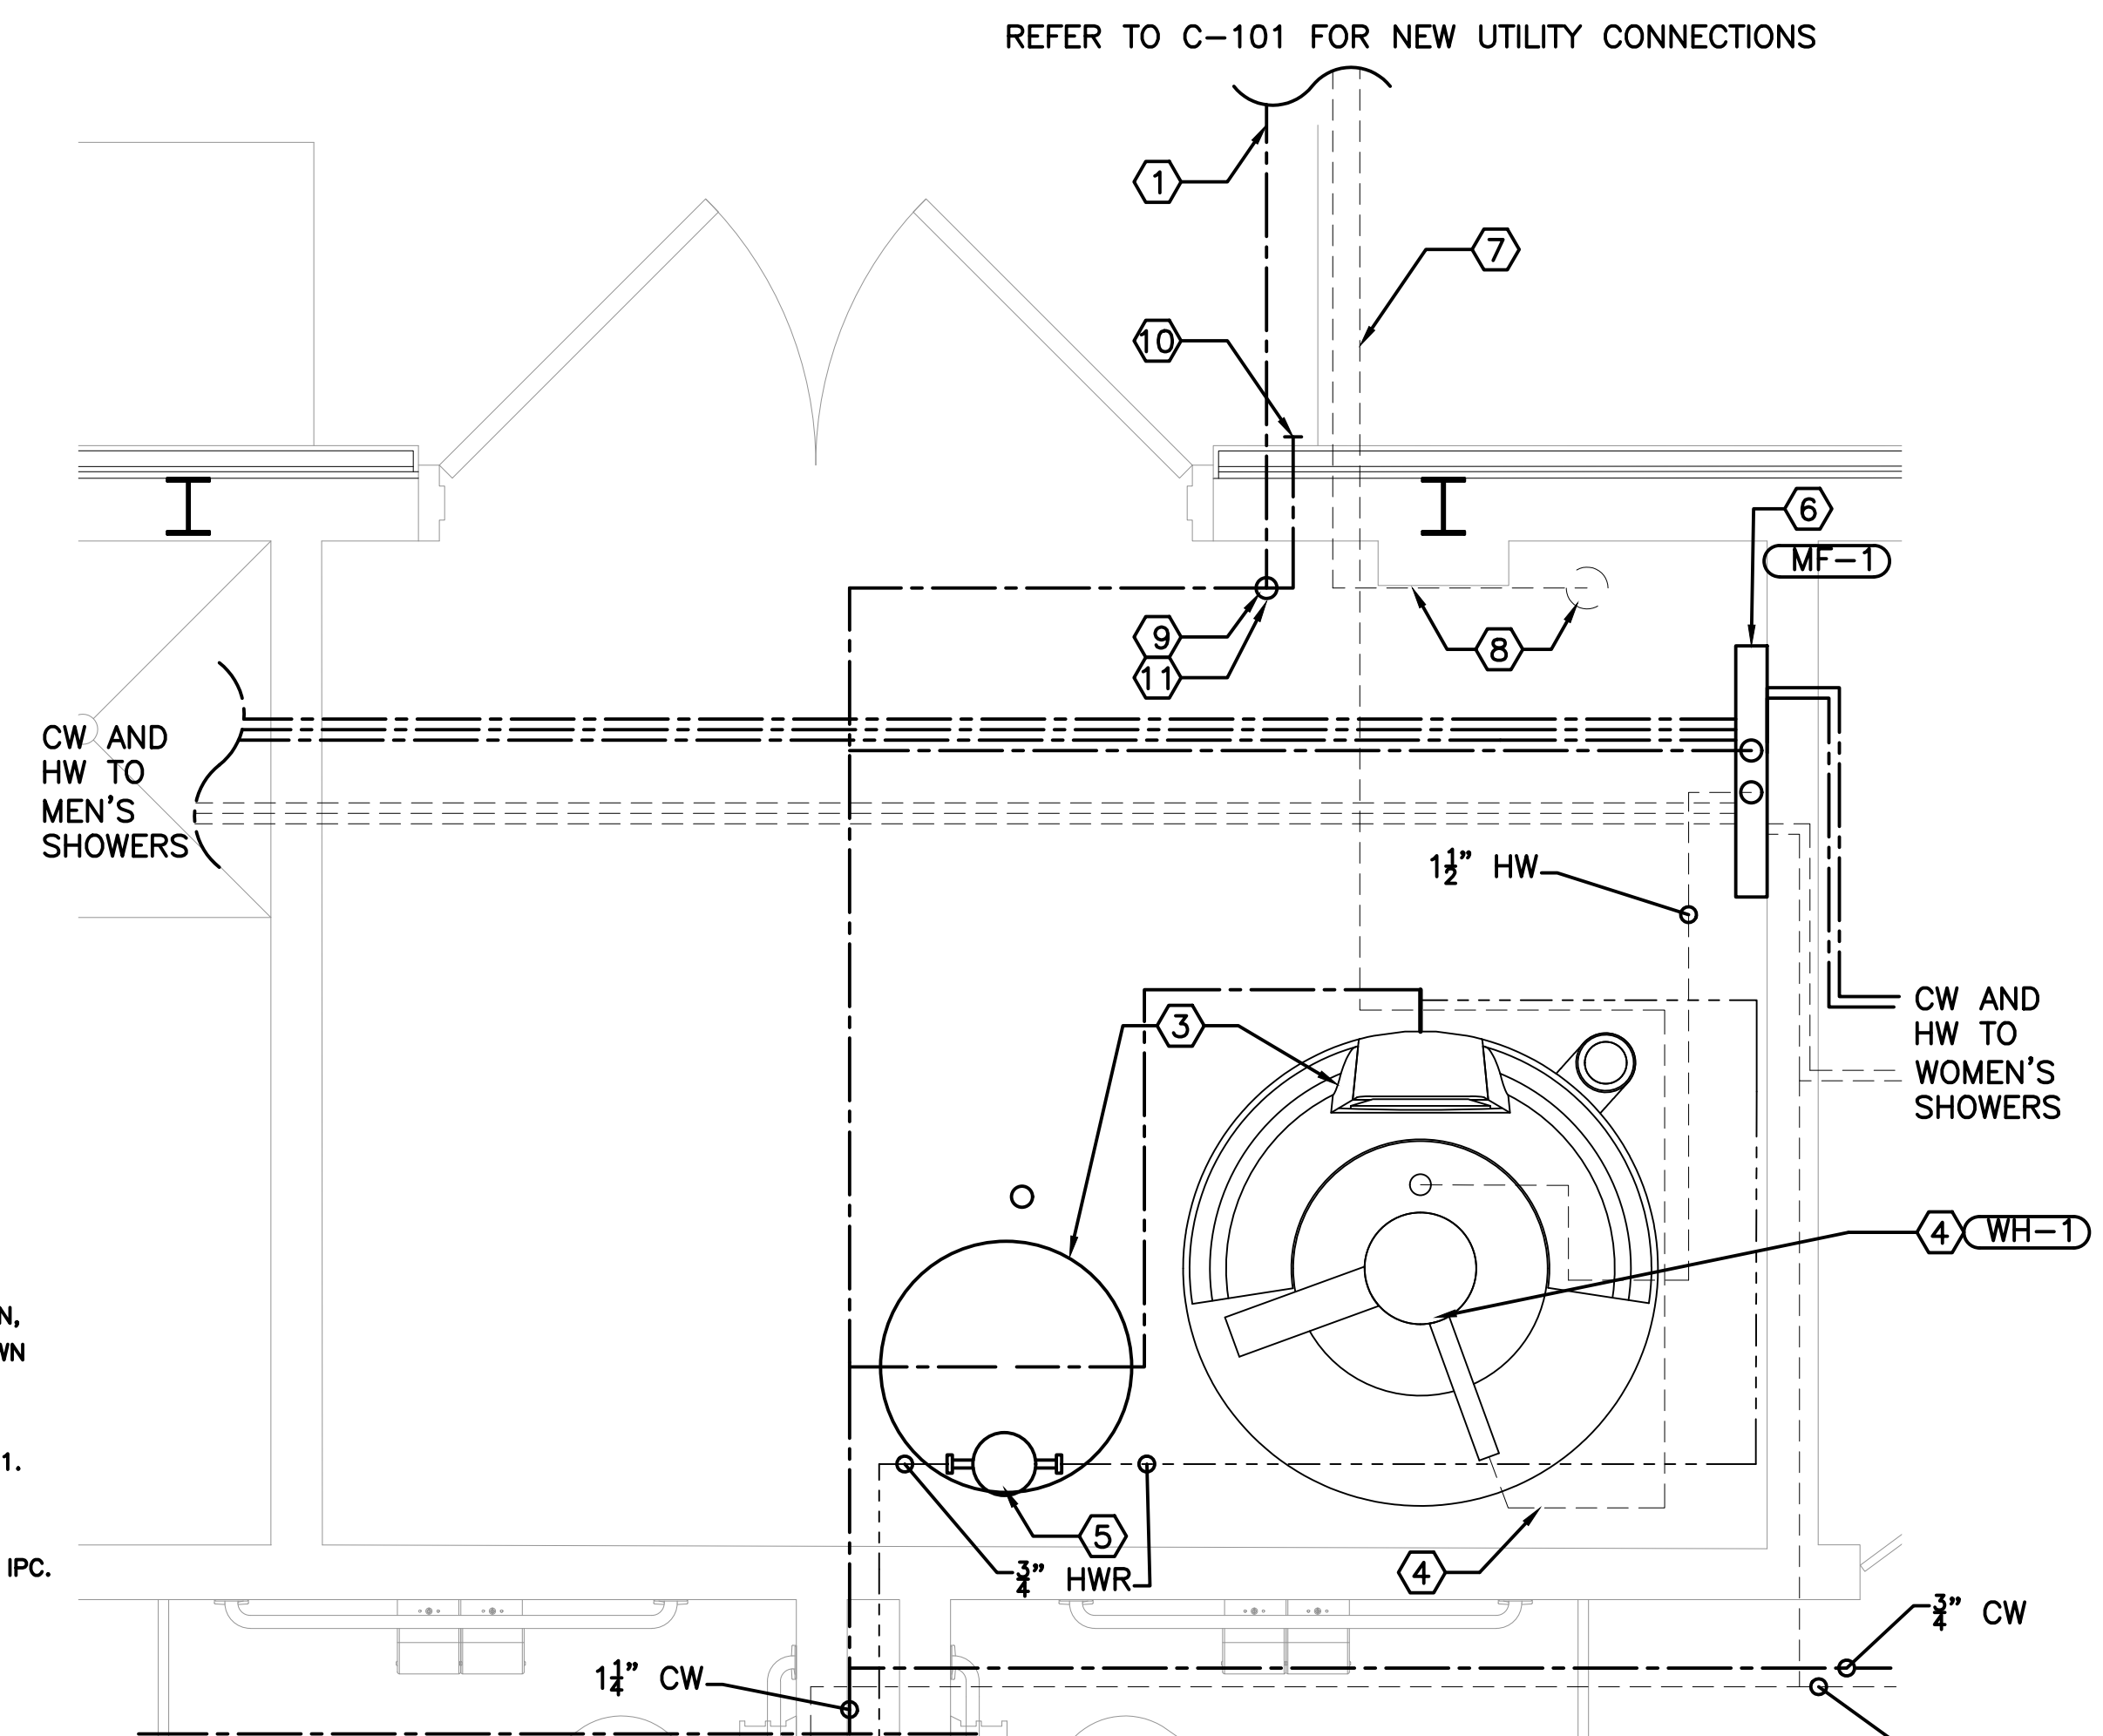

2 ENLARGED MECHANICAL ROOM PLUMBING PLAN  
1/4" = 1' - 0"

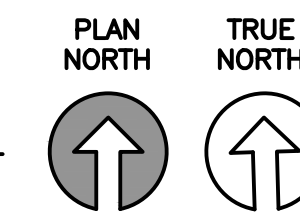


DATE	REVISIONS

Designed by J. RAMIREZ	Drawn by J. RAMIREZ	Reviewed by RTI/JH	Submitted by PCBS
---------------------------	------------------------	-----------------------	----------------------


PROJECT TITLE  
**FIRE STATION ADD/ALTER, B3321**  
**PROJECT NO. 1039839**  
**17th TRAINING WING**  
**GOODFELLOW AIR FORCE BASE, TEXAS**

Project Number: 1039839
SHEET TITLE SANITARY SEWER PLAN
Date: JAN 2024


SEQ. 47	SHEET <b>P-102</b>	OF 50
------------	-----------------------	----------

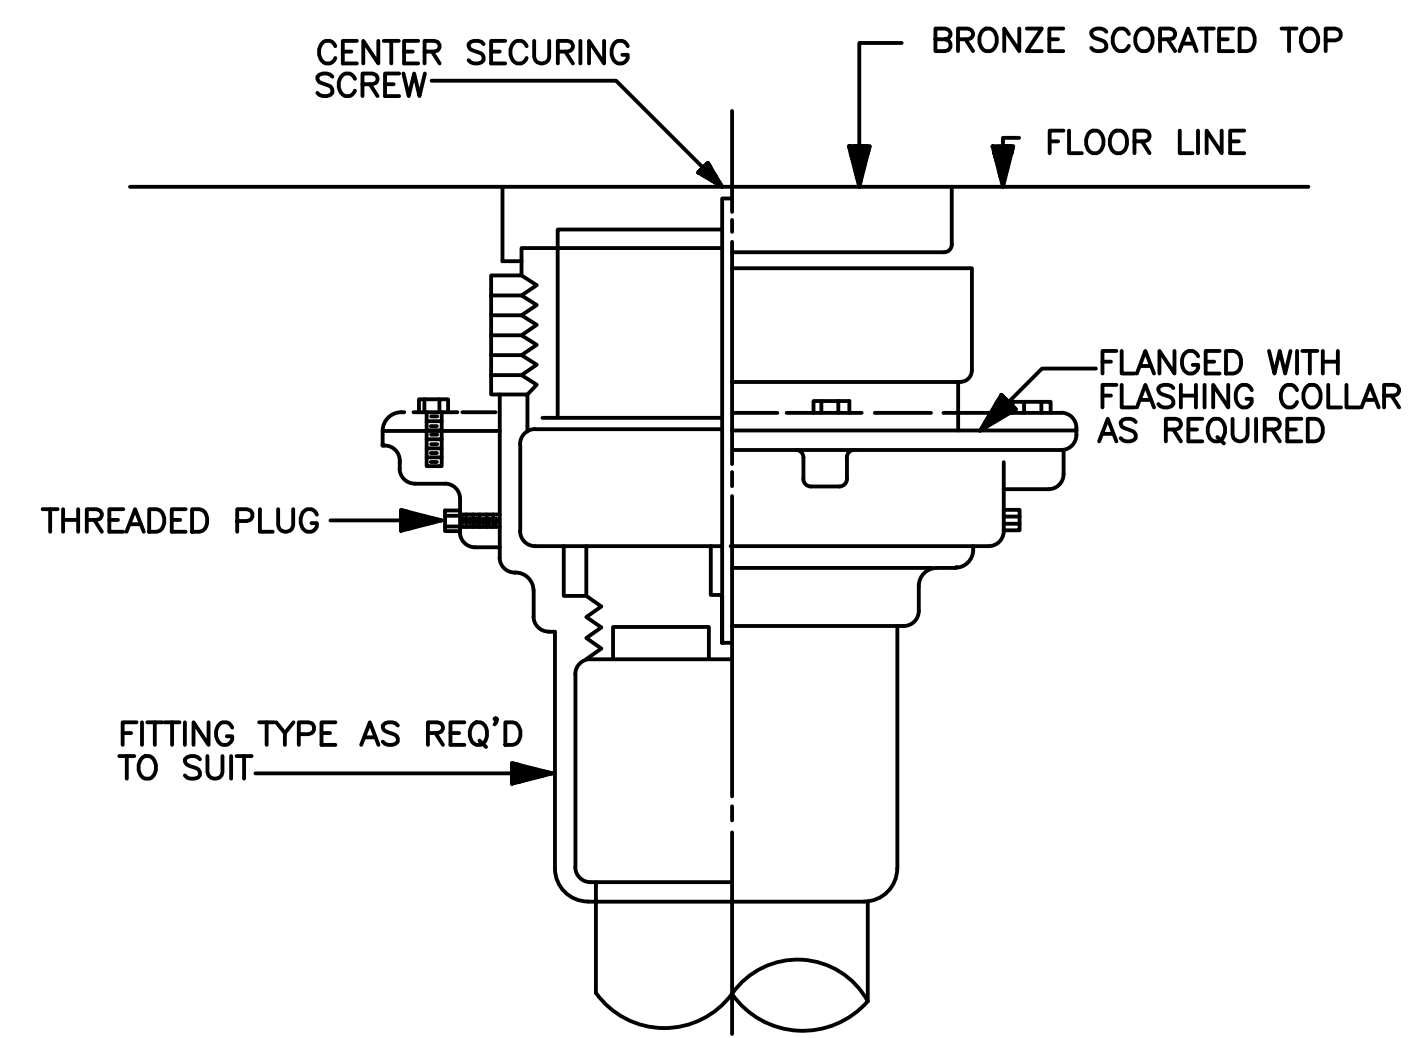



1 FLOOR DRAIN DETAIL (TYP.)  
NTS

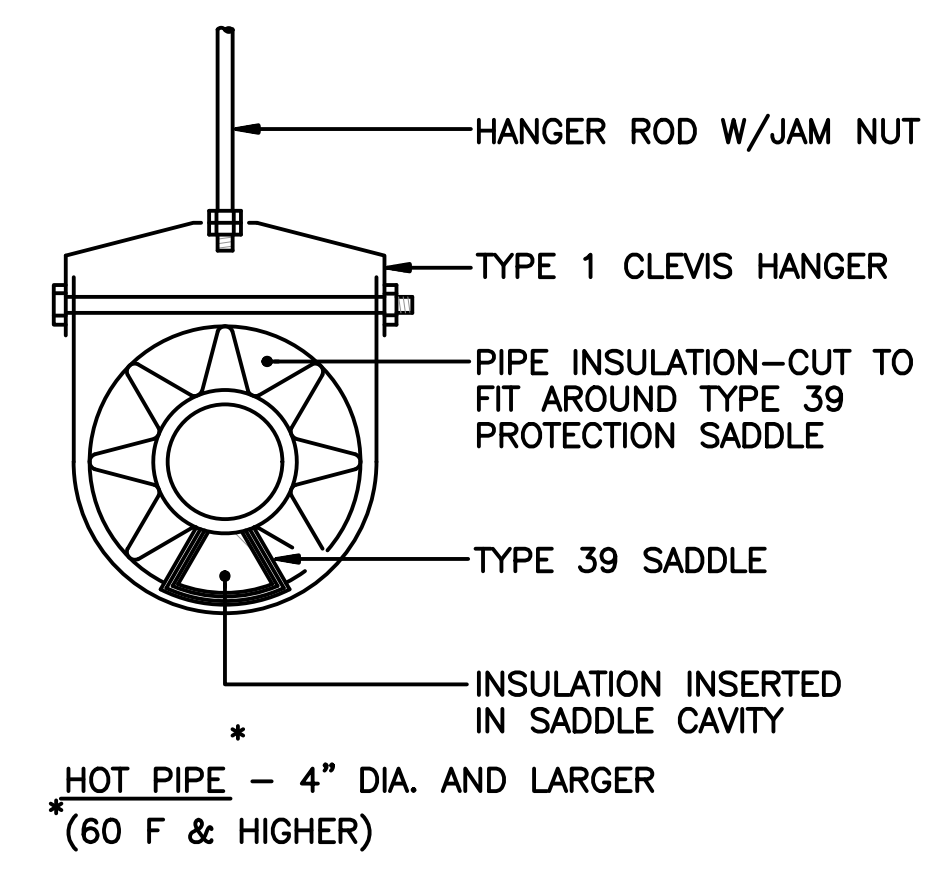


2 PIPE HANGAR DETAIL  
NTS

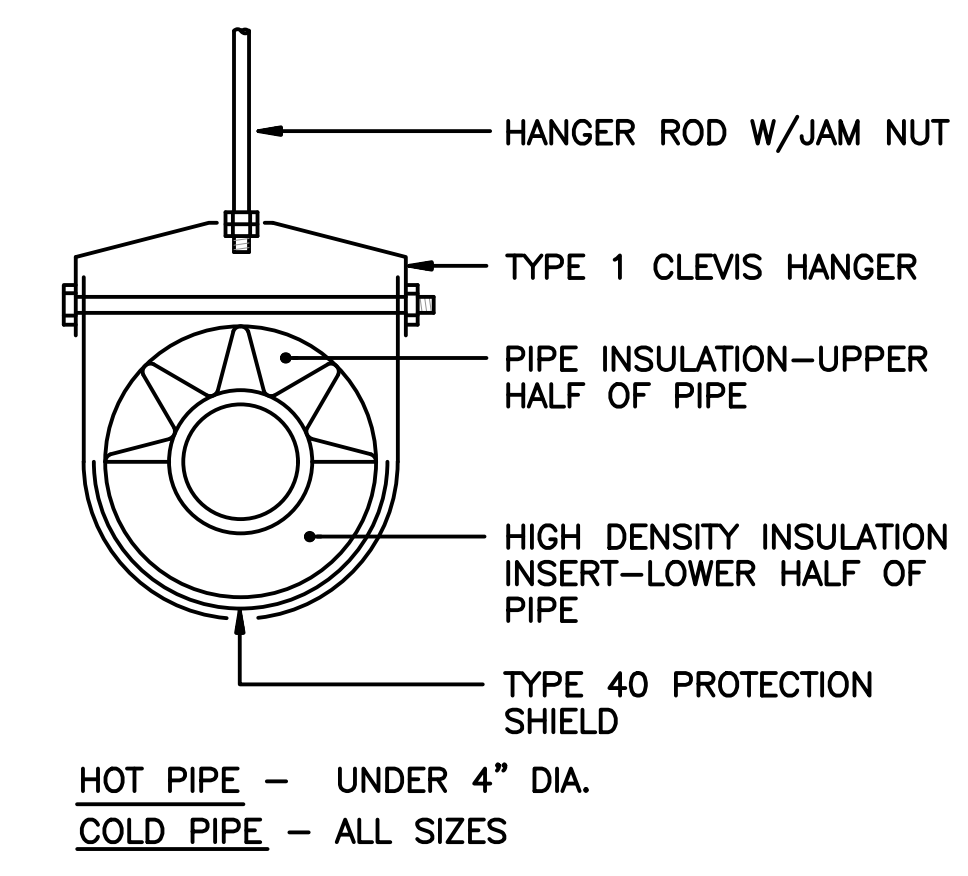


3 MOP SINK DETAIL  
NTS

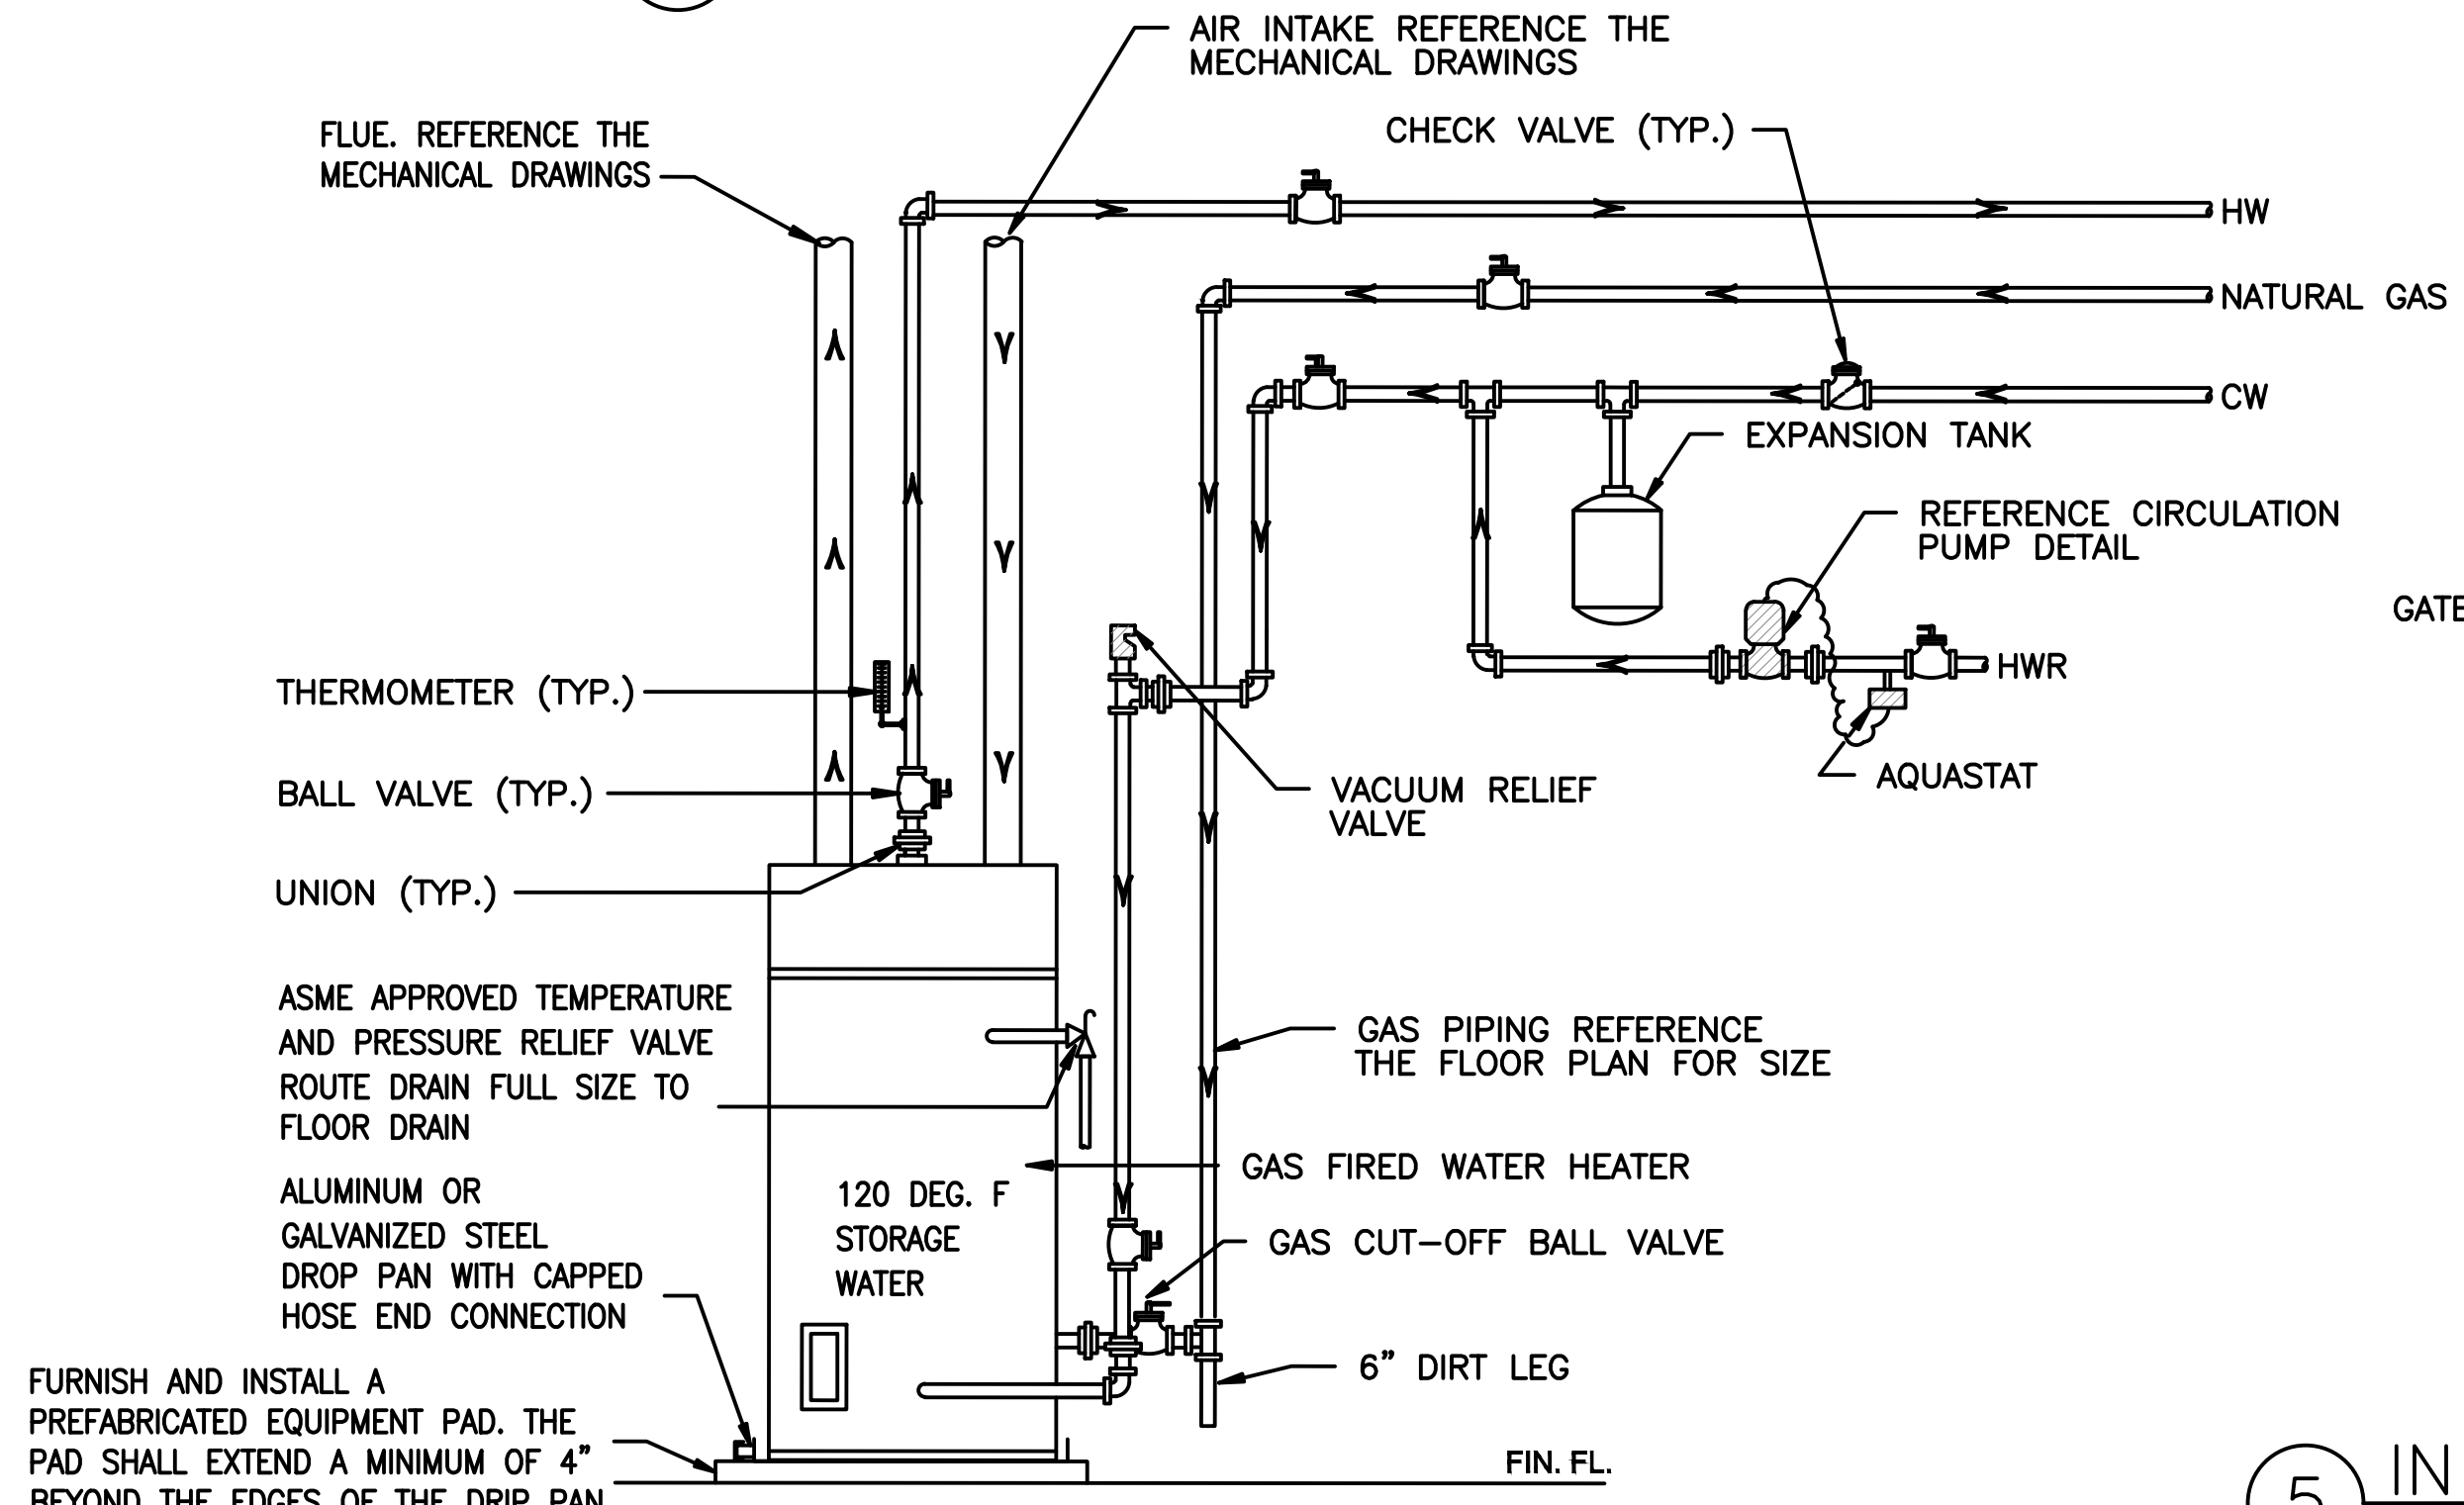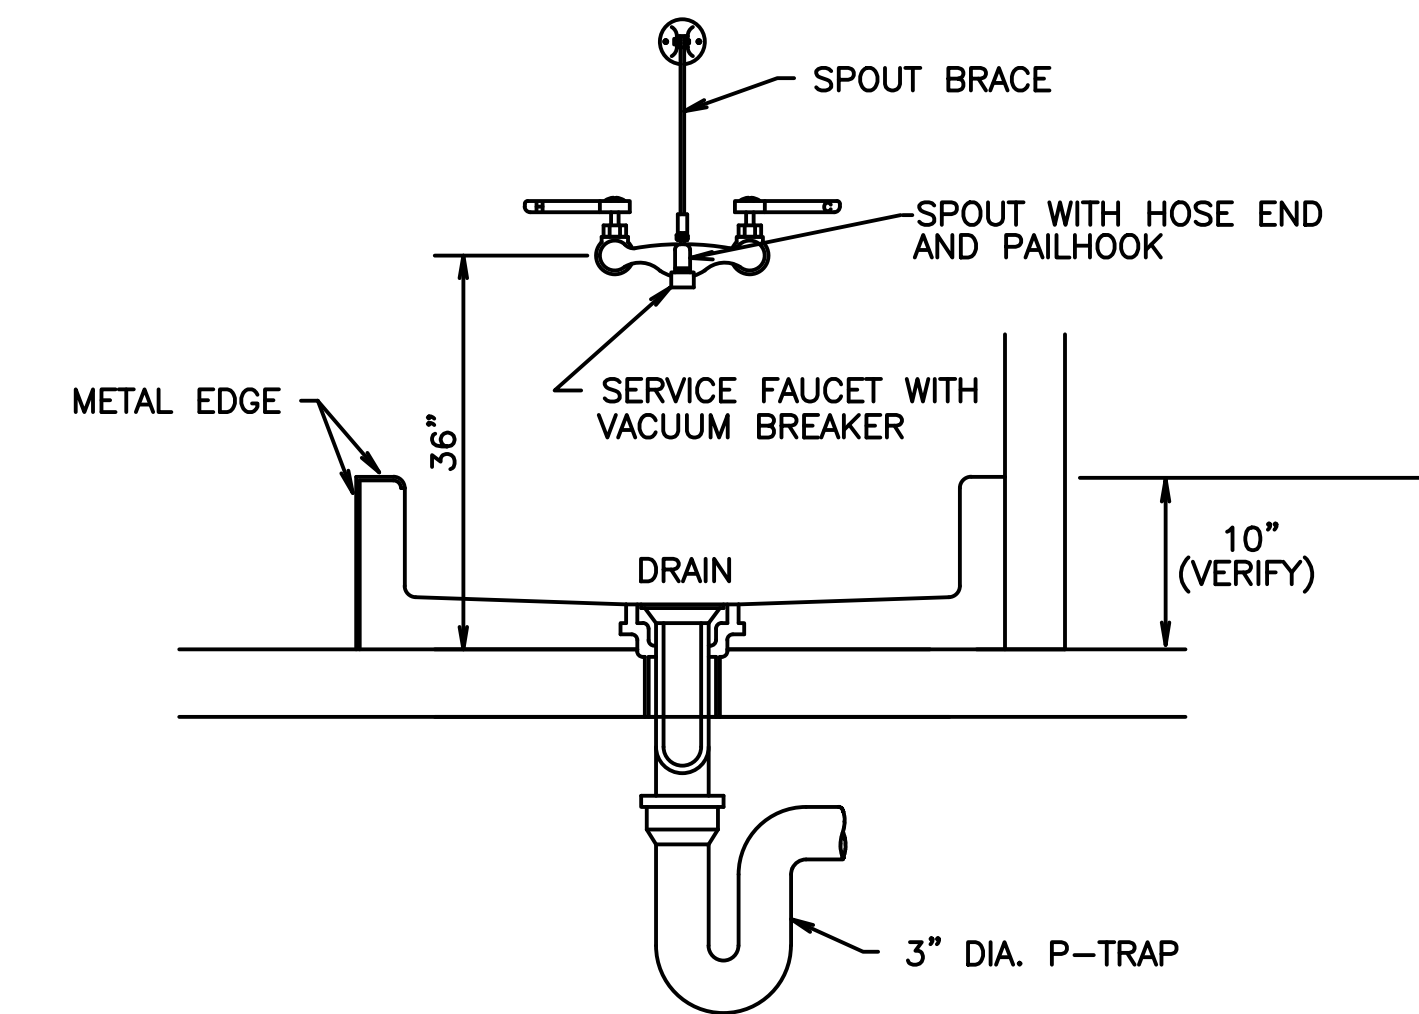


4 GAS FIRED WATER HEATER DTL  
NTS

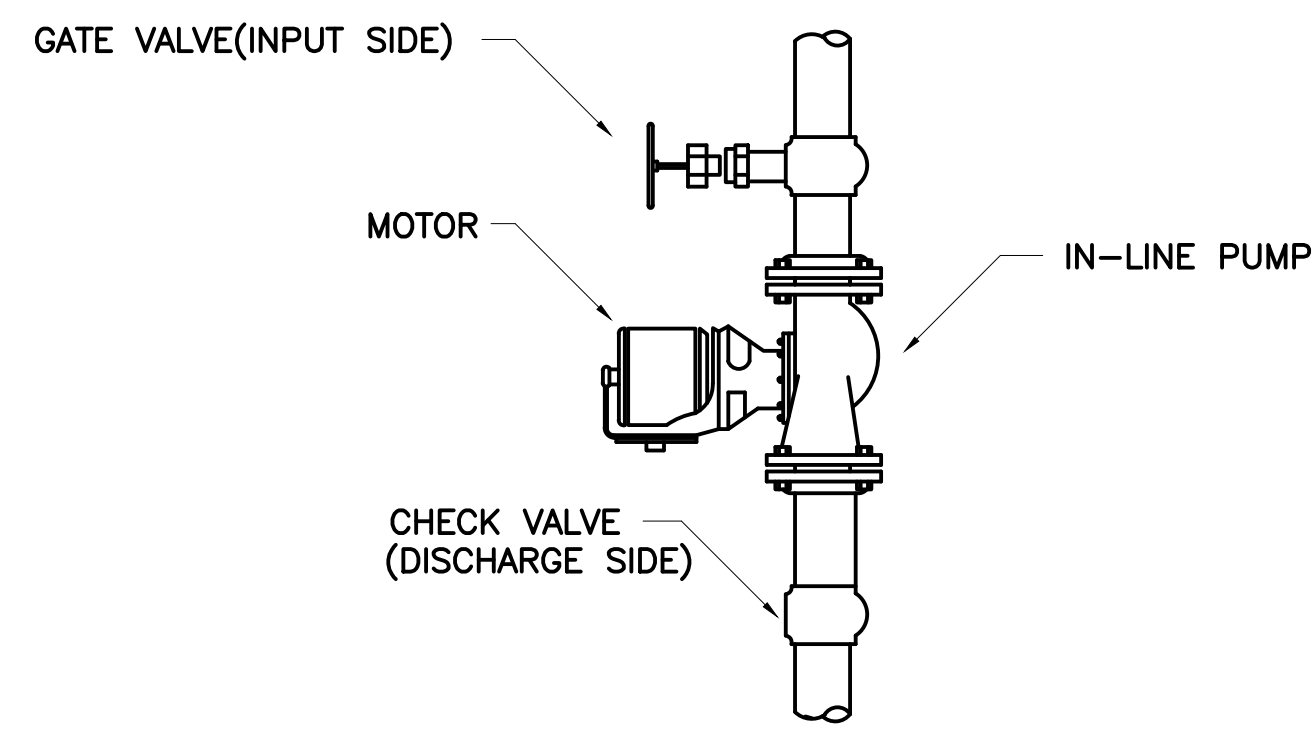


5 IN LINE RECIRCULATION PUMP DTL.  
NTS

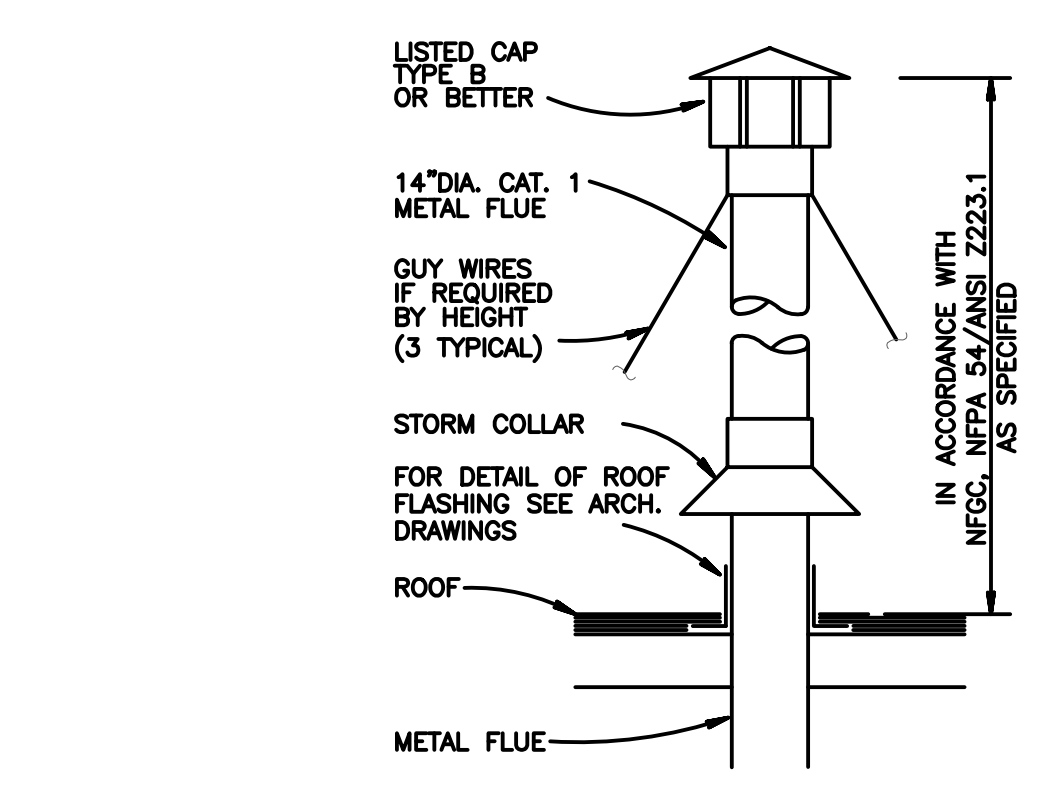


6 FLUE THROUGH ROOF DETAIL  
NTS

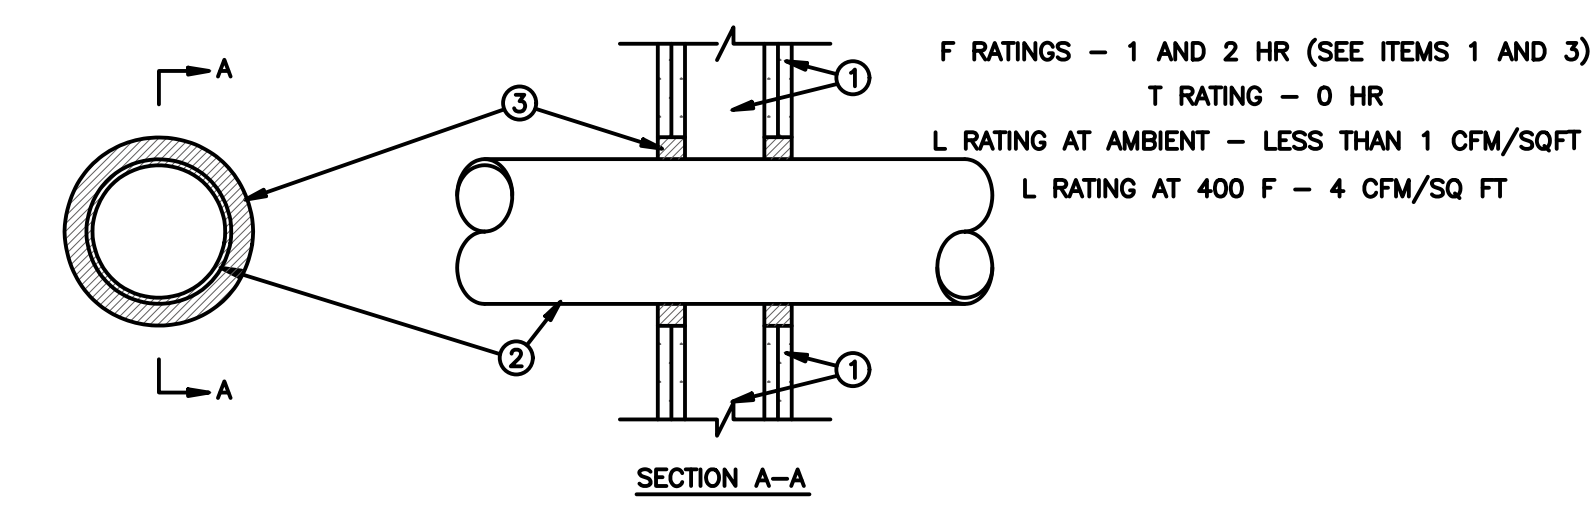


- WALL ASSEMBLY - 1 OR 2 HR FIRE-RATED GYPSUM WALLBOARD/STUD WALL PER U300 OR U400 SERIES WALL AND PARTITION DESIGNS IN THE UL FIRE RESISTANCE DIRECTORY.
- THE F RATING OF THE FIRESTOP SYSTEM IS EQUAL TO THE F RATING OF THE WALL ASSEMBLY.
- THROUGH-PENETRANTS - ONE METALLIC PIPE, CONDUIT OR TUBING TO BE INSTALLED EITHER CONCENTRICALLY OR ECCENTRICALLY WITHIN THE FIRESTOP SYSTEM. THE ANNULAR SPACE SHALL BE MIN 0" TO MAX 2 1/4". PIPE MAY BE INSTALLED WITH CONTINUOUS POINT CONTACT. PIPE, CONDUIT OR TUBING MAY BE INSTALLED AT AN ANGLE NOT GREATER THAN 45 DEGREES FROM PERPENDICULAR. PIPE, CONDUIT OR TUBING TO BE RIGIDLY SUPPORTED ON BOTH SIDES OF WALL ASSEMBLY. THE FOLLOWING TYPES AND SIZES OF METALLIC PIPES, CONDUITS OR TUBING MAY BE USED:
  - A. STEEL PIPE - NOM 30" DIAM (OR SMALLER) SCHEDULE 10 (OR HEAVIER) STEEL PIPE.
  - B. IRON PIPE - NOM 30" DIAM (OR SMALLER) CAST OR DUCTILE IRON PIPE.
  - C. CONDUIT - NOM 4" DIAM (OR SMALLER) STEEL ELECTRICAL METALLIC TUBING OR 6" DIAM STEEL CONDUIT.
  - D. COPPER TUBING - NOM 6" DIAM (OR SMALLER) TYPE L (OR HEAVIER) COPPER TUBING.
  - E. COPPER PIPE - NOM 6" DIAM (OR SMALLER) REGULAR (OR HEAVIER) COPPER PIPE.
- FILL, VOID OR CAVITY MATERIAL - APPROVED UL LISTED FIRE STOP SEALANT BEARING THE UL CLASSIFICATION MARK - MIN 3/8" THICKNESS OF FILL MATERIAL APPLIED WITHIN THE ANNULUS, FLUSH WITH BOTH SURFACES OF WALL. AT THE POINT OR CONTINUOUS CONTACT LOCATIONS BETWEEN PIPE AND WALL, A MIN 1/2" DIAM BEAD OF FILL MATERIAL SHALL BE APPLIED AT THE PIPE WALL INTERFACE ON BOTH SURFACES OF WALL.

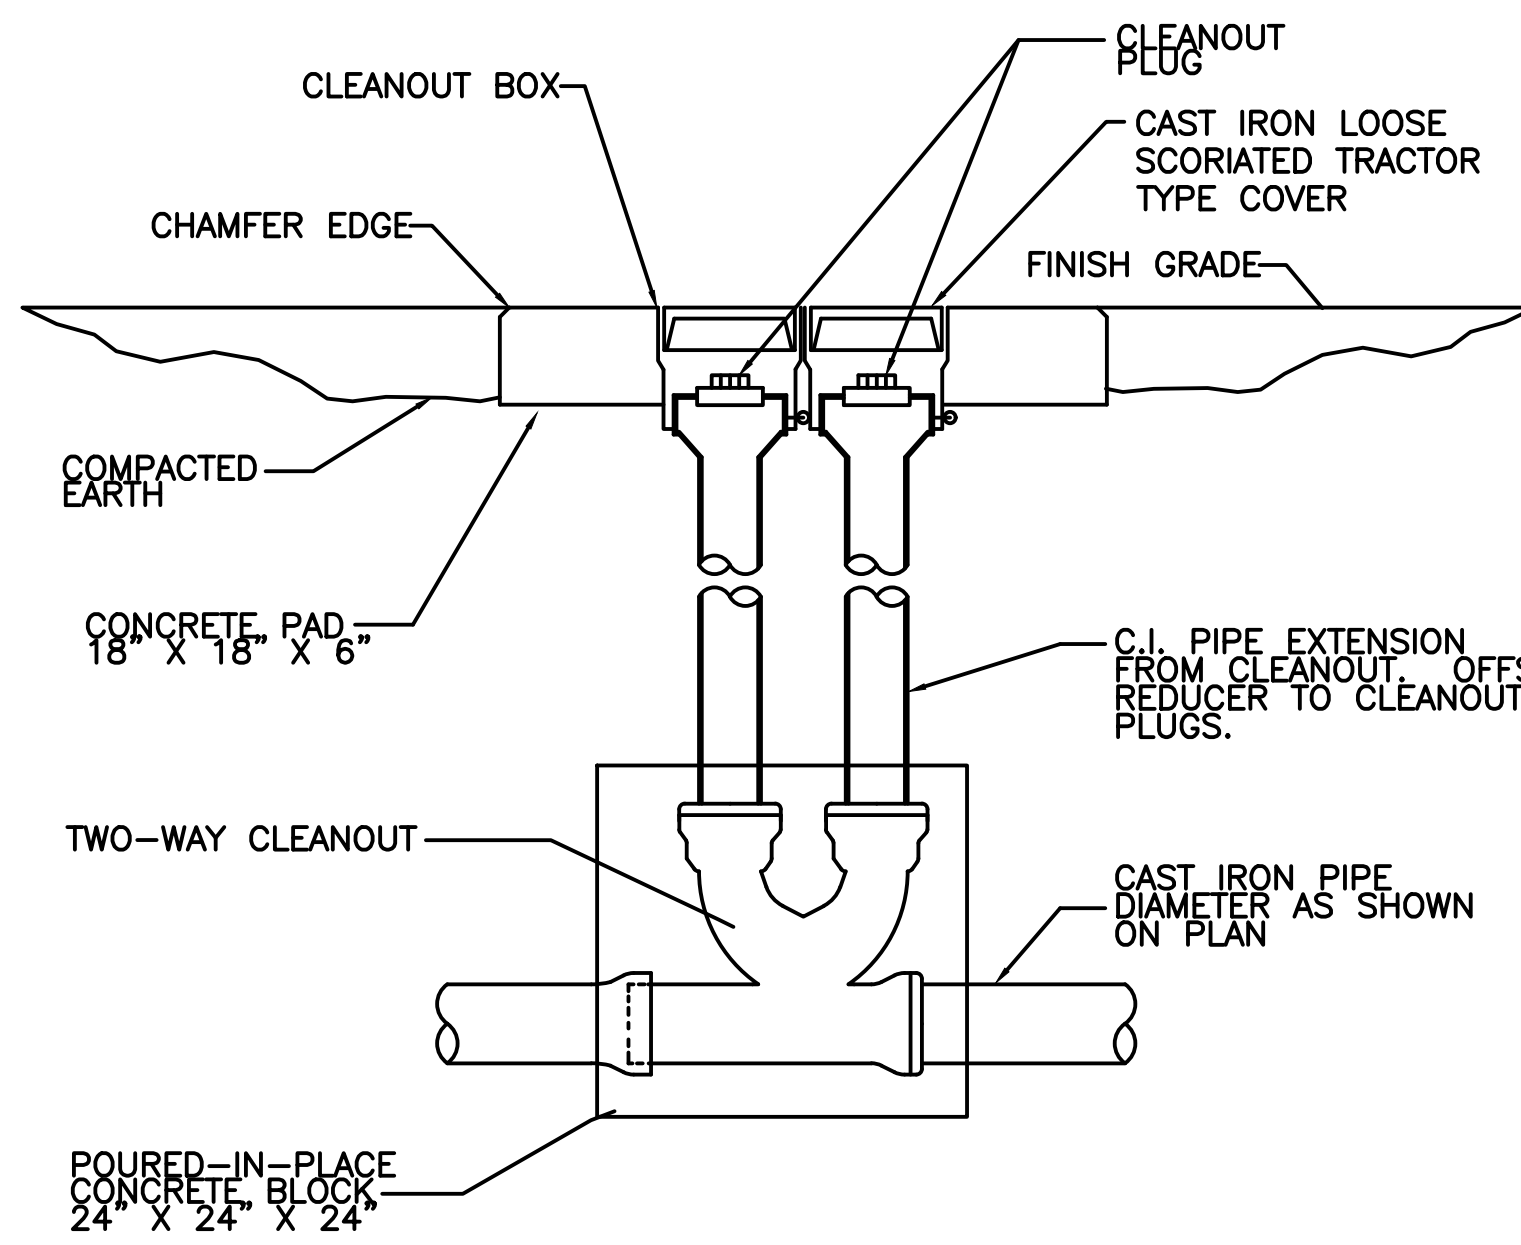

7 EXTERIOR AND DOUBLE CLEANOUT DETAIL  
NTS

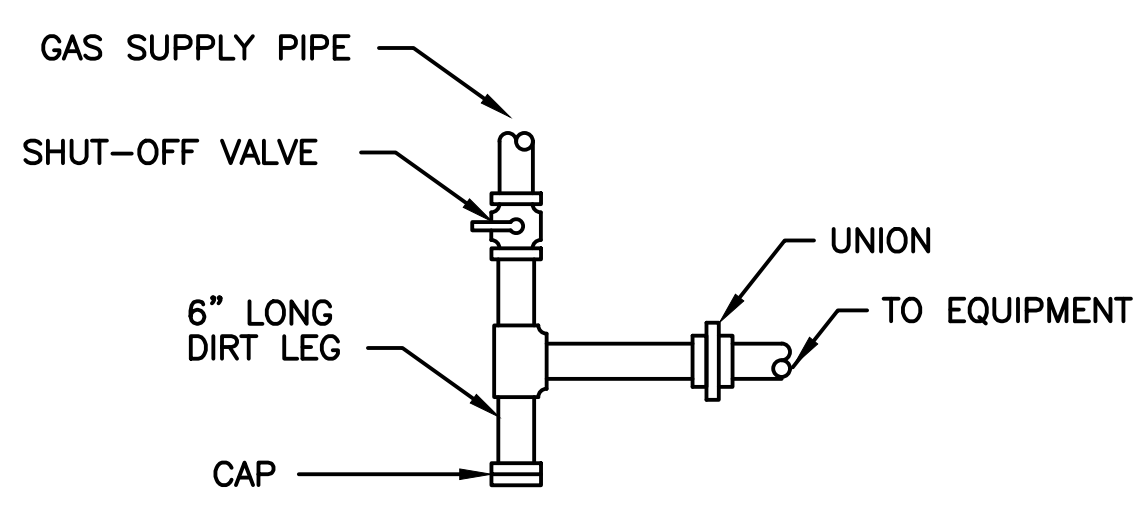


8 GAS CONNECTION DETAIL (TYP.)  
NTS

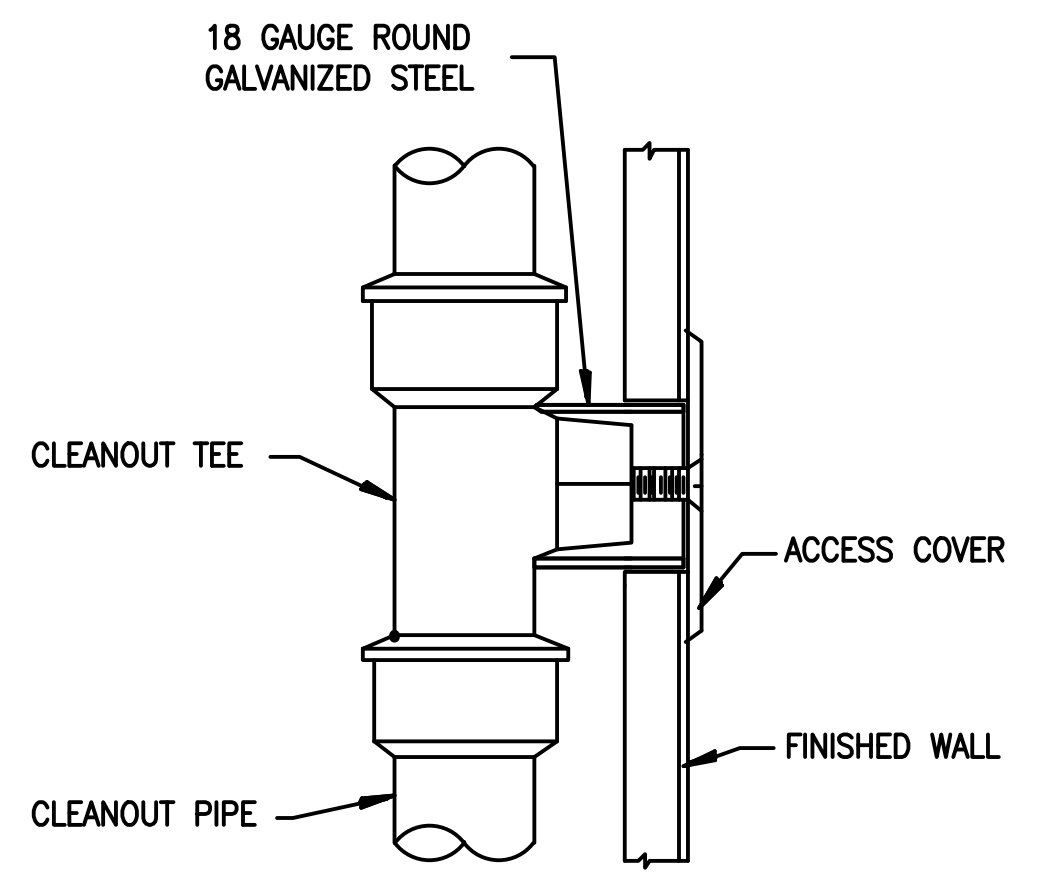

9 WALL CLEANOUT DETAIL  
NTS

10 FIRE PROTECTION DETAIL WALL/FLOOR PENETRATION  
NTS

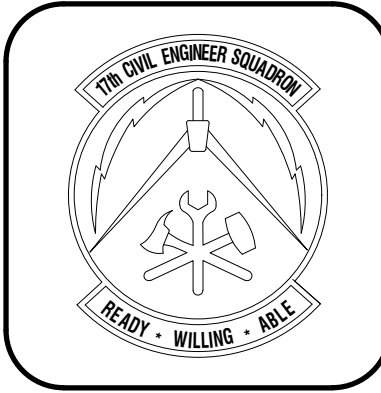

DATE	
REVISIONS	

Designed by	J.H.R.L.A.
Drawn by	J.H.R.L.A.
Reviewed by	RTI/JH
Submitted by	P/CBS

FIRE STATION ADD/ALTER, B3321  
 PROJECT NO. 1039839  
 17th TRAINING WING  
 GOODFELLOW AIR FORCE BASE, TEXAS

Project Number	1039839
SHEET TITLE	PLUMBING DETAILS 1
Date	JAN 2024

SEQ.	SHEET	OF
50	P-501	50


**PLUMBING FIXTURE SCHEDULE**

MARK	DESCRIPTION	WASTE PIPE	VENT PIPE	COLD WATER	HOT WATER	WASTE FIXTURE UNITS	ELECTRICAL	REMARKS	BASIS OF DESIGN MANUFACTURER & MODEL NUMBER
		IN	IN	IN	IN				
WC-1	WATER CLOSET, 1.1/1.6 G.P.F. FLUSHOMETER, SIPHON JET WITH ENLONGATED BOWL AND TOP SULLY SPUD, MOUNT RIM AT 16-1/2" A.F.F. FOR ADA/ABA COMPLIANCE. VERIFY FLUSH HANDLE PER ABA REQUIREMENTS. FLOOR FLANGE SHALL BE COPPER ALLOY, CAST IRON, OR PLASTIC. GASKET SHALL BE WAX-TYPE SEAL. COLOR: WHITE FLUSHVALVE: DUAL FLUSH MANUAL	4	2	1	-	4	N/A	VITREOUS CHINA, TOP SPUD, FLOOR MOUNTED, FLOOR OUTLET, ELONGATED BOW, PROVIDE WITH HEAVY DUTY INJECTION MOLDED PLASTIC, OPEN FRONT TOILET SEAT WITH COVER AND CHECK HINGES COMPLYING WITH ANSI Z124.5 FOR COMMERCIAL HEAVY DUTY. FIXTURE SHALL BE FURNISHED AND INSTALLED IN ACCORDANCE WITH ADA/ABA STANDARDS FOR ADULTS.	WATER CLOSET: KOHLER HighdM Ultra #K-96057 FLUSH VALVE: SLOAN WES 111-1.6/1.1 SEAT: BEMIS COMMERCIAL #1955SSCT
WC-2	WATER CLOSET, 1.1/1.6 G.P.F. FLUSHOMETER, SIPHON JET WITH ENLONGATED BOWL AND TOP SUPPLY SPUD, MOUNT RIM AT 15" A.F.F., VERIFY FLUSH HANDLE PER ABA REQUIREMENTS. COLOR: WHITE FLUSHVALVE: DUAL FLUSH MANUAL	4	2	1	-	4	N/A	VITREOUS CHINA, TOP SPUD, FLOOR MOUNTED, FLOOR OUTLET, ELONGATED BOW, PROVIDE WITH HEAVY DUTY INJECTION MOLDED PLASTIC, OPEN FRONT TOILET SEAT WITH COVER AND CHECK HINGES COMPLYING WITH ANSI Z124.5 FOR COMMERCIAL HEAVY DUTY. FIXTURE SHALL BE FURNISHED AND INSTALLED IN ACCORDANCE WITH ADA/ABA STANDARDS FOR ADULTS.	WATER CLOSET: KOHLER HighdM Ultra #K-96057 FLUSH VALVE: SLOAN WES 111-1.6/1.1 SEAT: BEMIS COMMERCIAL #1955SSCT
UR-1	URINAL, 0.125 GPF FLUSHOMETER ULTRA HIGH EFFICIENCY WASHOUT, MOUNT RIM AT 17" A.F.F FOR ADA/ABA COMPLIANCE. COLOR: WHITE	2	2	3/4	-	2	N/A	VITREOUS CHINA, TOP SPUD, WALL CARRIER SYSTEM, BACK OUTLET, EXTENDED RIM, WASHOUT FLUSHING ACTION, CHROME-PLATED MANUAL FLUSHOMETER. FIXTURE SHALL BE FURNISHED AND INSTALLED IN ACCORDANCE WITH ADA/ABA STANDARDS FOR ADULTS.	URINAL: KOHLER BARDON #K-4991-ET-0 FLUSH VALVE: SLOAN REGAL #186-0.125
LV-1	LAVATORY, ACCESSIBLE, ADA COMPLIANT, UNDER COUNTER MOUNTED ENAMELED CAST IRON, COUNTER MOUNTED, SINGLE LEVER 4" ON CENTER CHROME-PLATED FAUCET, LESS POP-UP, 0.5 GPM AERATOR, GRID STRAINER DRAIN AND THERMOSTATIC MIXING VALVE. PIPE INSULATION: WHITE FOAM PER ADA COLOR: WHITE	2	2	1/2	1/2	1	N/A	FLUSHOMETER. FIXTURE SHALL BE FURNISHED AND INSTALLED IN ACCORDANCE WITH ADA/ABA STANDARDS FOR ADULTS. FURNISH AND INSTALL TMV-1 AND PIPING PROTECTION COVERS BELOW THE LAVATORY.	LAVATORY: KOHLER #K-2874 FAUCET: AMERICAN STANDARD #7386050.002
SHR-1	SHOWER ASSEMBLY WITH TEMPTRON PRESSURE BALANCED MIXING VALVE WITH INTEGRAL SERVICE STOPS, 1.5 GPM, VOLUME DIVERTER, INTEGRAL VOLUME CONTROL, VACUUM BREAKER, TRIM AND DRAIN.	2	2	1/2	1/2	2	N/A	THE HOT WATER LIMIT STOPS SHALL BE SET TO 110 DEGREES FARENHEIT. MIXING VALVE SHALL BE ASSE 1016 COMPLIANT.	SHOWER ASSEMBLY: AQUATIC BATH #136364PC 36"X36 SINGLE PIECE SOLID ACRYLIC SHOWER UNIT
MS-1	HIGH DENSITY COMPOSITE SERVICE BASIN WITH INTEGRAL DRAIN, STAINLESS STEEL STRAINER, HOSE & BRACKET, MOP HANGAR AND WALL-MOUNTED CHROME PLATED FAUCET WITH VACUUM BREAKER, INTEGRAL STOPS, ADJUSTABLE WALL BRACE, PAIL HOOK AND 3/4" THREAD ON SPOUT, STAINLESS STEEL WALL GUARDS.	3	2	1/2	1/2	2	N/A	THE FIXTURE SHALL BE FURNISHED AND INSTALLED WITH 120 DEGREE FARENHEIT PIPING.	MOP BASIN: #Z1996-24 FAUCET: DELTA #28T9 HOSE & BRACKET: ZURN #Z1996-HH MOP HANGER: ZURN #Z1996-MH WALL GUARD: ZURN #Z1996-WG
EW-1.2	WATER COOLER, WALL MOUNTED, BI-LEVEL, UL LISTED, BARRIER FREE PER ANSI A117.1-1980. MEETS ADA AND ABA ACCESSIBILITY REQUIREMENTS.	2	2	3/4	3/4	5	120 V, DUPLEX RECEPTACLE	FIXTURE SHALL BE FURNISHED AND INSTALLED IN ACCORDANCE WITH ADA/ABA STANDARDS FOR ADULTS.	ELKAY #EZSTL8WSLK
TMV-1	PIPE PER MANUFACTURER RECOMMENDED PIPING INSTRUCTIONS. POINT OF USE ASSE 1070 COMPLIANT THERMOSTATIC MIXING VALVE.	-	-	1/2	1/2	-	N/A	-	WATTS #LFMMV
FD-1	FLOOR DRAIN, CAST IRON WITH ANCHOR FLANGE AND 6" SQUARE NICKEL BRONZE STRAINER WITH VANDAL RESISTANT SCREWS. DOMESTIC HOT WATER RECIRCULATION PUMP, BRONZE CONSTRUCTION, DOMESTIC WATER CIRCULATOR PUMP, WITH AQUASTAT AND PROGRAMMABLE TIMER.	3	2	-	-	2	N/A	FURNISH AND INSTALL WITH TRAP GUARD INSERT.	MIFAB #F1100 SERIES
RCP-1	CONSTRUCTION, DOMESTIC WATER CIRCULATOR PUMP, WITH AQUASTAT AND PROGRAMMABLE TIMER.	-	-	-	-	-	120 V, DUPLEX RECEPTACLE	FURNISH AND INSTALL WITH PROGRAMMABLE TIMER AND AQUASTAT.	BELL & GOSSETT #ECOCIRC 19-16 SERIES

**WATER HEATER SCHEDULE**

MARK	STORAGE (GALLONS)	RECOVERY CAPACITY @90° F RISE, BASED ON 96% THERMAL EFFICIENCY (GAL/HR)	ELECTRICAL		BASIS OF DESIGN	TYPE	NOTES
			VOLTS	PHASE			
WH-1	119	388	120	1	AO SMITH BTH-300(A)	GAS-FIRED	1,2,3

- NOTES:
- REFERENCE DETAIL 4P-501 FOR ADDITIONAL INSTALLATION REQUIREMENTS.
  - THE WATER HEATER SHALL BE INSTALLED IN ACCORDANCE WITH CODE/HAJH REQUIRED DRAIN PAN, T&P VALVE, EXPANSION TANK, HEAT TRAP, STAND, SHUT-OFF VALVES, CHECK VALVE AND APPURTENANCES
  - SET THE INTEGRAL WATER HEATER CONTROLS TO MAINTAINING THE STORAGE WATER AT 120° F.

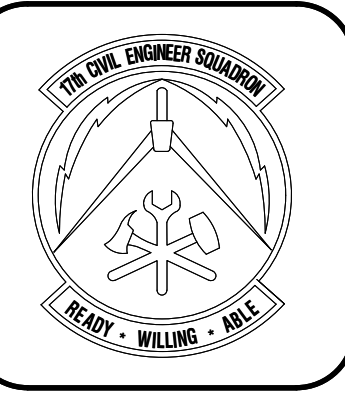

REVISIONS	DATE


Designed by: JRM/MLA	Drawn by: JRM/MLA	Reviewed by: RTJ/JH	Submitted by: PCES
-------------------------	----------------------	------------------------	-----------------------

**PROJECT TITLE**  
**FIRE STATION ADD/ALTER, B3321**  
**PROJECT NO. 1039839**  
**17th TRAINING WING**  
**GOODFELLOW AIR FORCE BASE, TEXAS**

Project Number: 1039839
SHEET TITLE PLUMBING SCHEDULES
Date: JAN 2024

SEQ.	SHEET	OF
52	<b>P-601</b>	50



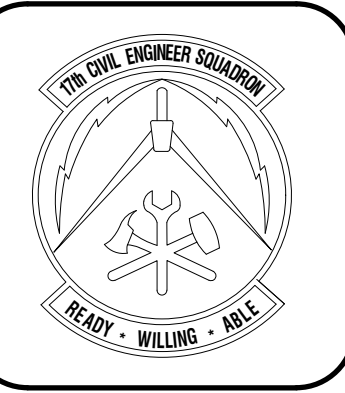

DATE	REVISIONS

Designed by JHR/LA	Drawn by JHR/LA	Reviewed by RT/AH	Submitted by PCES
-----------------------	--------------------	----------------------	----------------------

PROJECT TITLE  
**FIRE STATION ADD/ALTER, B3321**  
**PROJECT NO. 1039839**  
**17th TRAINING WING**  
**GOODFELLOW AIR FORCE BASE, TEXAS**

Project Number: 1039839
SHEET TITLE FIRE PROTECTION PLAN NOTES & SYMBOLS
Date: JAN 2024

SEQ.	SHEET	OF
54	FA-001	50

**GENERAL NOTES:**

1. THE CONTRACTOR SHALL PROVIDE THE SERVICES OF A QUALIFIED FIRE PROTECTION ENGINEER (QFPE) AS PART OF THEIR BID PROPOSAL TO COMPLETE THE REQUIRED ITEMS AS DESCRIBED IN THESE DRAWINGS.
2. THE INFORMATION PROVIDED ON THE CONTRACT DOCUMENTS SERVES TO GUIDE THE CONTRACTOR IN THE DESIGN AND INSTALLATION OF A COMPLETE FIRE PROTECTION SYSTEM.
3. MUST COMPLY WITH UFC 1-200-01. NOTE: THIS UFC REFERENCES ALL OTHER DOD UFCs AND BUILDING CODES. MUST COMPLY WITH UFC 3-600-01 AND ALL STANDARDS AND CODES REFERENCED BY THIS UFC. THIS INCLUDES, BUT IS NOT LIMITED TO, NFPA STANDARDS AND CODES, ICC CODES, TIA STANDARDS, CEREG DESIGN GUIDE.
4. ALL DESIGN WORK SHALL BE PERFORMED BY A QUALIFIED FIRE PROTECTION ENGINEER (QFPE). THIS FPE SHALL ALSO BE CONSIDERED THE QUALIFIED FIRE PROTECTION ENGINEER (QFPE) FOR THIS PROJECT AS DEFINED BY UFC 3-600-01, AND SHALL BE RESPONSIBLE FOR PERFORMING ALL WORK DESCRIBED IN THAT UFC FOR QFPE.
5. THE QFPE SHALL BE REGULARLY AND DIRECTLY INVOLVED IN ALL ASPECTS OF DESIGN, INSTALLATION, ACCEPTANCE TESTING AND COMMISSIONING OF FIRE PROTECTION, FIRE ALARM AND LIFE SAFETY SYSTEMS AND FEATURES. THE QFPE SHALL PERSONALLY CONDUCT AND/OR WITNESS ALL ACCEPTANCE TESTING FOR FIRE PROTECTION, FIRE ALARM AND LIFE SAFETY SYSTEMS AND FEATURES.
6. THE QFPE SHALL BE RESPONSIBLE FOR REVIEWING DESIGNS AND SUBMITTALS FOR ALL TRADES TO ENSURE THAT FIRE PROTECTION AND LIFE SAFETY FEATURES ARE MAINTAINED THROUGHOUT THE CONTRACT. THIS INCLUDES, BUT IS NOT LIMITED TO, DEVELOPING AND SUBMITTING THE REVIEW LETTER AT THE 100% DESIGN DESCRIBED IN UFC 3-600-01 SECTION 1-7.3.
7. ADDITIONAL INFORMATION REGARDING FIRE PROTECTION AND LIFE SAFETY REQUIREMENTS CAN BE FOUND IN THE ARCHITECTURAL AND ELECTRICAL SECTIONS. THE QFPE AS DESCRIBED ABOVE SHALL BE RESPONSIBLE FOR OVERSEEING THE DESIGN, INSTALLATION, ACCEPTANCE TESTING AND COMMISSIONING OF ALL FIRE PROTECTION AND LIFE SAFETY REQUIREMENTS FOUND THROUGHOUT THIS CONTRACT.
8. THE CONTRACTOR SHALL PROVIDE AN AS BUILT DRAWING AT THE END OF PROJECT.

**DESIGN NOTES:**



1. THE QFPE SHALL COORDINATE WITH ALL TRADES TO ENSURE THAT ALL MEANS OF EGRESS AND LIFE SAFETY COMPONENTS AND SYSTEMS AS DESCRIBED IN UFC 3-600-01 AND NFPA 101 ARE DESIGNED, INSTALLED AND TESTED IN ACCORDANCE WITH THE STANDARDS OF THIS SECTION.
2. THE NEW BUILDING THAT MEETS THE MINIMUM REQUIREMENTS FOR FIRE SPRINKLERS SHALL BE FULLY SPRINKLERED IN ACCORDANCE WITH UFC 3-600-01. THE MINIMUM PRESSURE AND FLOW REQUIREMENTS SHALL BE CALCULATED TO THE BASE OF RISER AND TO THE DEMARCATION BOUNDARY WITH POTABLE WATER AT THE BASE. THE BORE DATA SHALL BE ON THE NAMEPLATE FOR EACH SPRINKLER RISER. THE PRESSURE AND FLOW REQUIREMENTS AT THE POINT OF DEMARCATION SHALL BE PROVIDED IN WRITING TO THE GOVERNMENT NO LATER THAN THE 65% DESIGN STAGE. THE QFPE SHALL BE RESPONSIBLE FOR DETERMINING IF THE NEW BUILDING MEETS THE MINIMUM REQUIREMENTS FOR FIRE SPRINKLERS PER UFC 3-600-01 AND INCLUDE THIS IN THE DESIGN ANALYSIS. ALL BUILDINGS, BOTH NEW AND EXISTING, THAT MEET THE THRESHOLD FOR REQUIRING SPRINKLERS SHALL BE PROVIDED WITH AUTOMATIC FIRE SPRINKLERS IN ACCORDANCE WITH UFC 3-600-01 AND NFPA 13.
3. NEW BUILDING SHALL HAVE CALCULATED FIRE FLOWS FOR FIREFIGHTING PURPOSES PERFORMED BY THE QFPE IN ACCORDANCE WITH UFC 3-600-01 AND NFPA 1. THESE FIRE FLOWS SHALL BE PROVIDED TO THE GOVERNMENT IN WRITING PRIOR TO THE 65% DESIGN SUBMITTAL.
4. THE QFPE IS RESPONSIBLE FOR ALL FIRE PROTECTION DESIGN FROM THE POINT OF DEMARCATION DOWN THROUGHOUT BUILDING. THE CONTRACTOR SHALL BE RESPONSIBLE FOR PROVIDING ALL EQUIPMENT, MATERIALS AND CONSTRUCTION REQUIRED TO DELIVER A FULLY OPERATIONAL FIRE SPRINKLER AND FIRE ALARM SYSTEMS TO THE GOVERNMENT, FOR THE NEW BUILDING REQUIRING FIRE SPRINKLERS AND FIRE ALARM BY THE QFPE PER THIS SCOPE OF WORK.
5. IF BID OPTIONS ARE AWARDED. CONTRACTOR SHALL INCLUDE ALL NECESSARY SHOP DRAWINGS, CALCULATIONS, DIAGRAMS, DEVICES, MATERIALS, LABOR, SUPERVISION, AND ACCESSORIES NEEDED FOR COMPLETE AND FUNCTIONAL SYSTEM IN EACH BID OPTION AWARDED. IN EACH OPTION AWARDED THE CONTRACTOR SHALL BE RESPONSIBLE FOR REMOVING AND DEMOLISHING EXISTING FIRE ALARM DEVICES, CORRESPONDING CONDUIT, JUNCTION BOXES, WIRING, AND ACCESSORIES AND PROVIDE NEW.

**FIRE ALARM SYSTEM:**

1. THE FIRE CONTROL UNIT SHALL COMPLY WITH UFC 3-600-01 AND NFPA 72. THE ADDRESSABLE FIRE ALARM CONTROL PANEL SHALL BE MONACO MAAP-X, MODEL 227-965-XX (WITH INTERNAL RADIO). THE SYSTEM SHALL INCLUDE AN OMNI DIRECTIONAL ANTENNA AND LIGHTNING ARRESTOR.
2. THE FIRE ALARM SYSTEM SHALL PROVIDE THE FOLLOWING:
  - A. TRANSMISSION OF ALARM, SUPERVISORY, AND TROUBLE SIGNALS TO THE GOODFELLOW AIR FORCE BASE FIRE DEPARTMENT (GFABFD).
  - B. CARBON MONOXIDE DETECTION IN ROOMS WITH AND ADJACENT TO FUEL BURNING EQUIPMENT INCLUDING DISTINCT NOTIFICATION FOR CARBON MONOXIDE ALARMS IN ACCORDANCE TO UFC 3-600-01
  - C. DEACTIVATION OF HEATING VENTILATION AND AIR CONDITIONING FANS UPON FIRE ALARM ACTIVATION
3. CONTRACTOR SHALL ENSURE THAT 17 CES FIRE ALARM TECHNICIANS, 17 CES FIRE PREVENTION OFFICE, PROJECT MANAGER AND OTHER STAKEHOLDERS IN ACCORDANCE WITH NFPA AND UFC-03-600-1; ARE NOTIFIED OF ALL ALARM SYSTEM AND SPRINKLER SYSTEM ACCEPTANCE TEST.
4. CONTRACTOR SHALL PROVIDE ALL CERTIFICATION DOCUMENTATION TO THE 17 CES FIRE PREVENTION OFFICE WHEN THE ALARM ACCEPTANCE TESTING IS COMPLETE.

**KEYNOTES:**

1. DESIRED LOCATION OF FIRE PROTECTION SYSTEM RISER. DESIGN TO BE MINIMUM DISTANCE FROM SURROUNDING WALLS TO ENSURE THAT IT DOES NOT OBSTRUCT THE EXHAUST FAN IN THE MECHANICAL ROOM.
2. LOCATION OF NEW FIRE ALARM CONTROL PANEL (FACP)

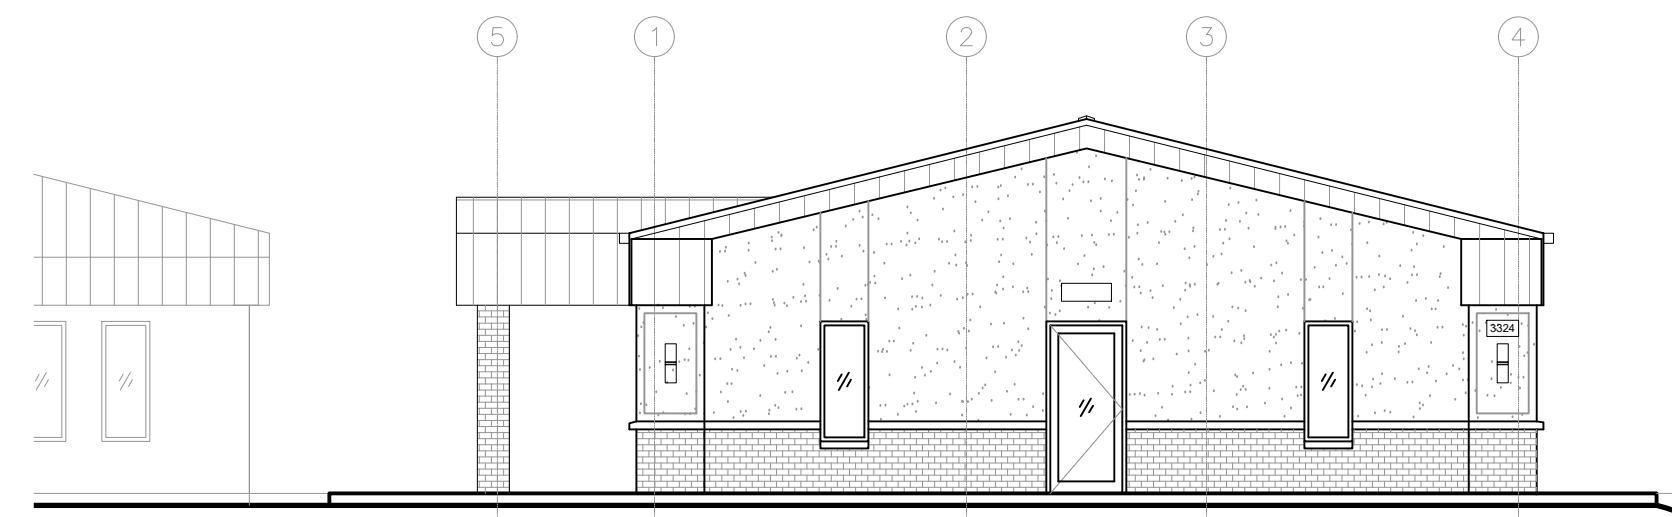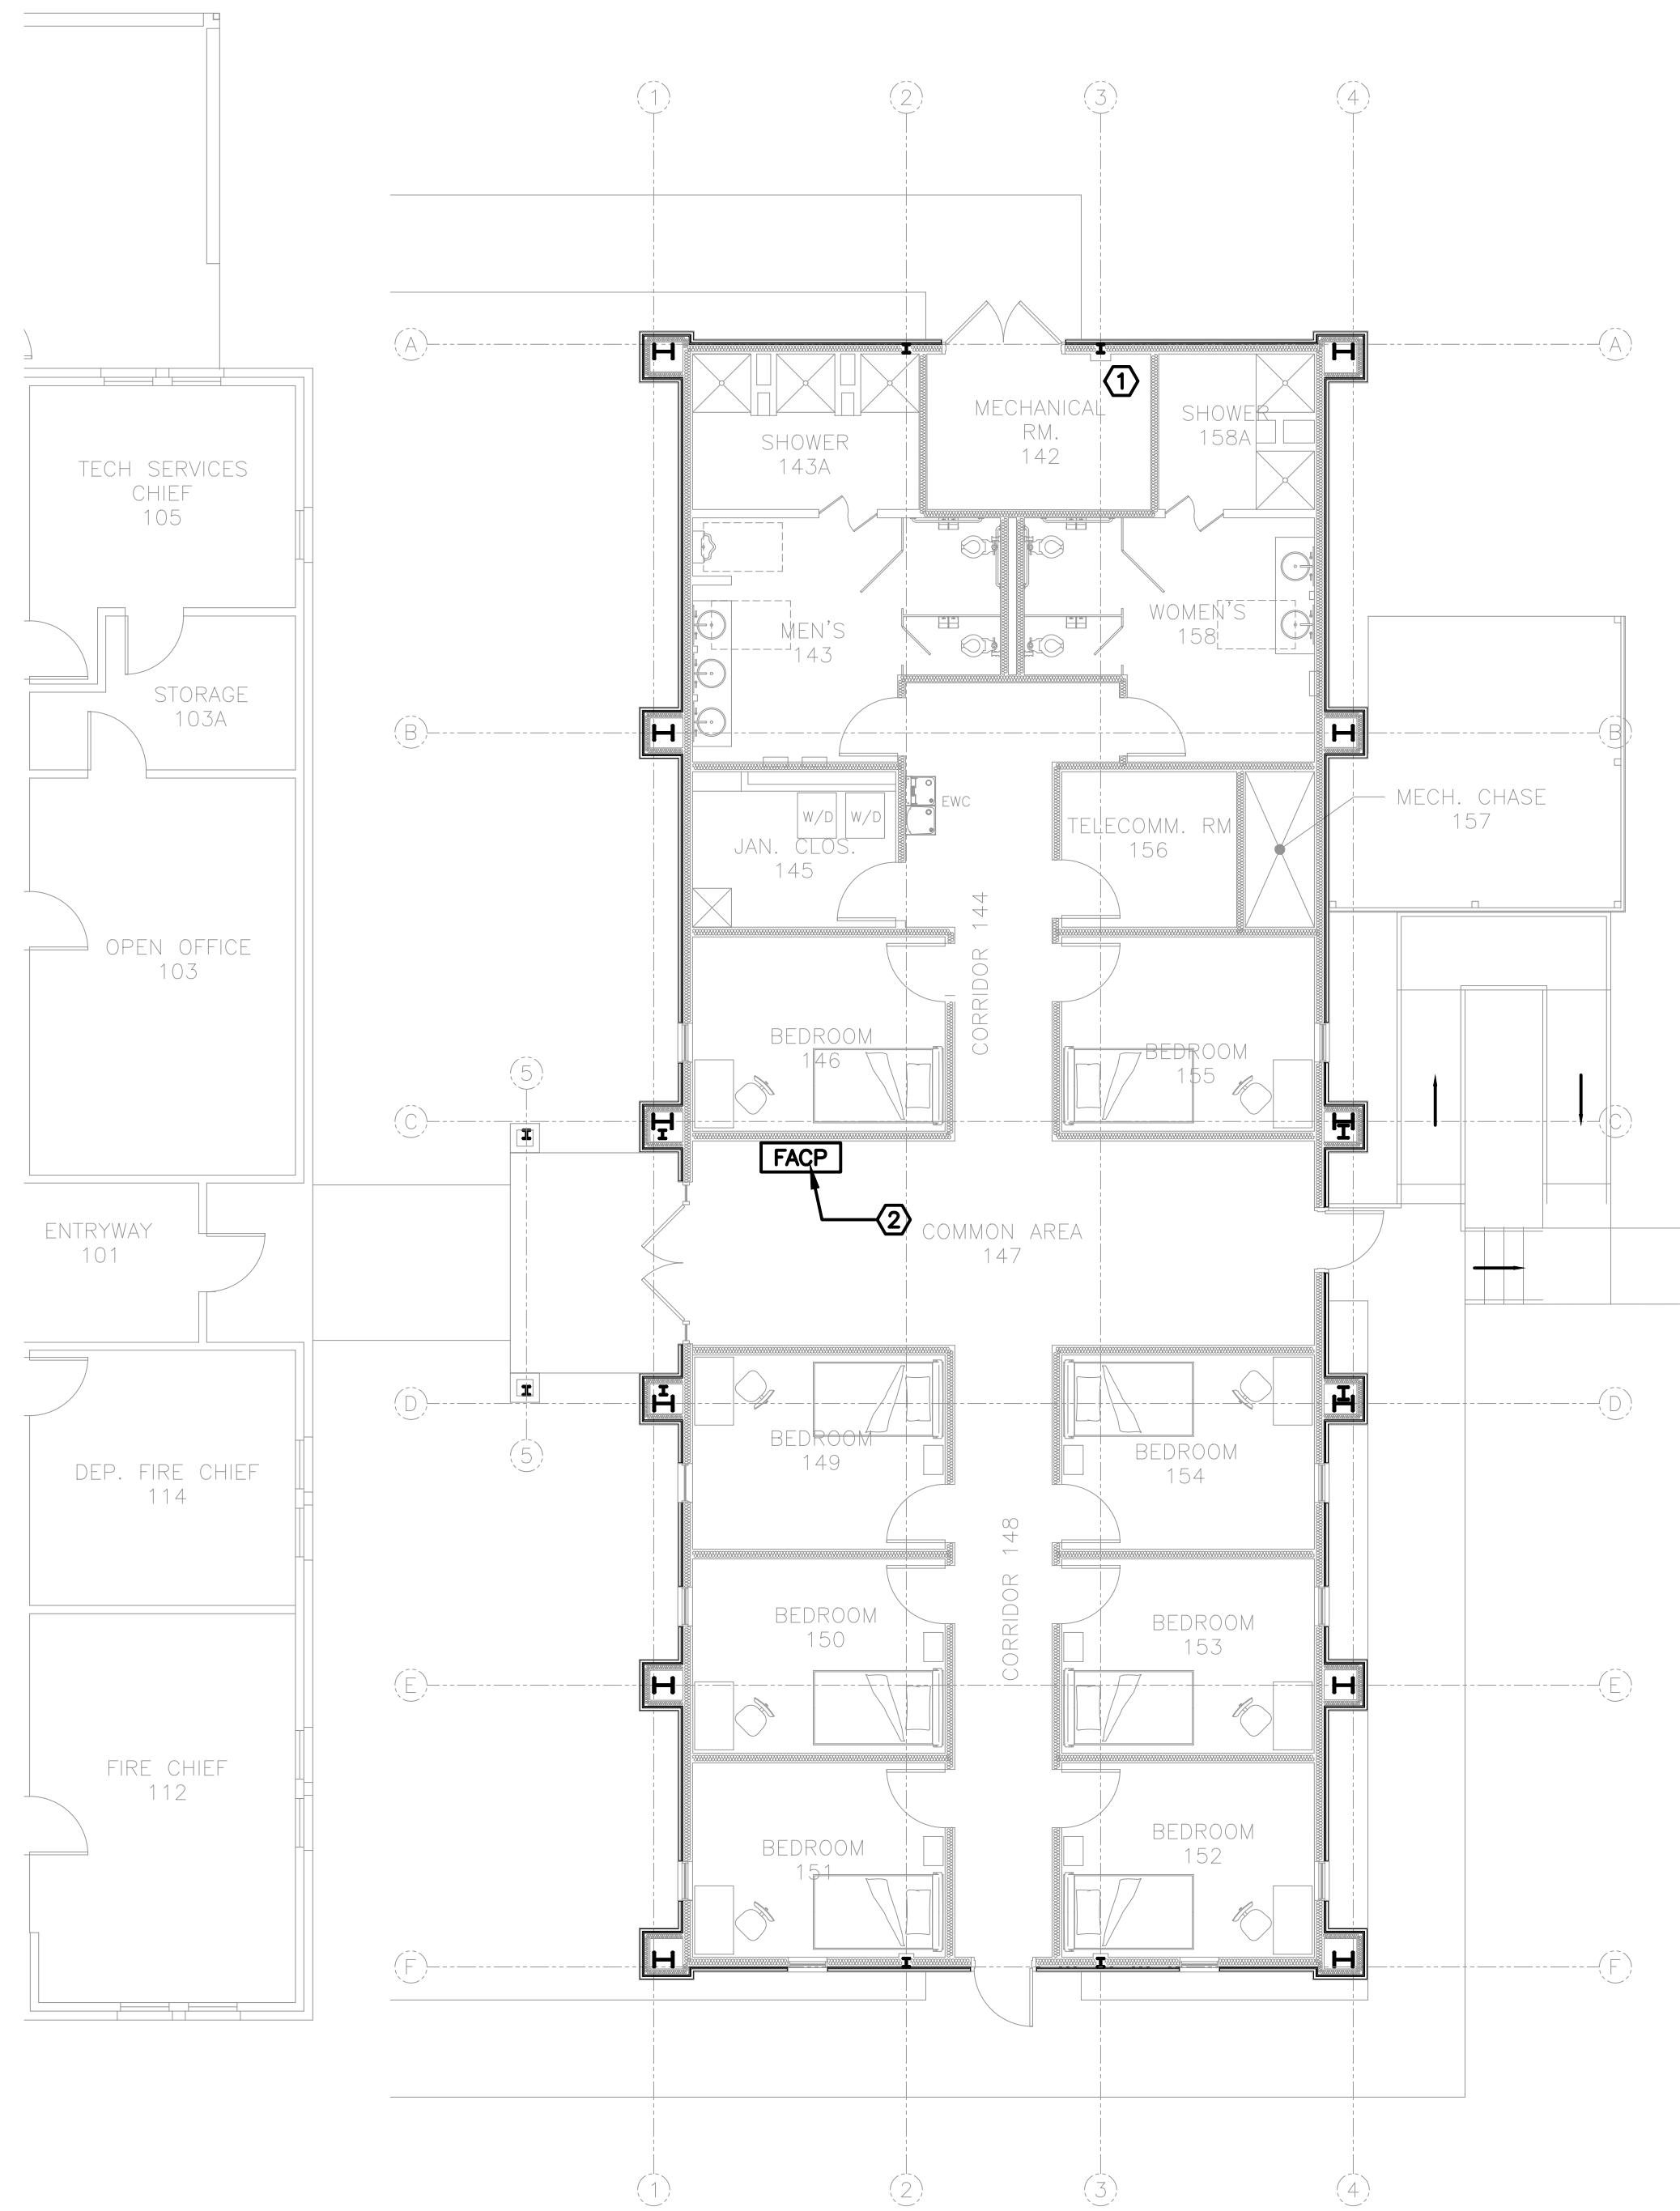

**2 SOUTH ELEVATION**  
 $\frac{1}{8}'' = 1' - 0''$

**1 NEW ADDITION FLOORPLAN**  
 $\frac{1}{8}'' = 1' - 0''$