


CITY OF BEAUFORT



MOSSY OAKS DRAINAGE IMPROVEMENT PLANS - BASIN 1

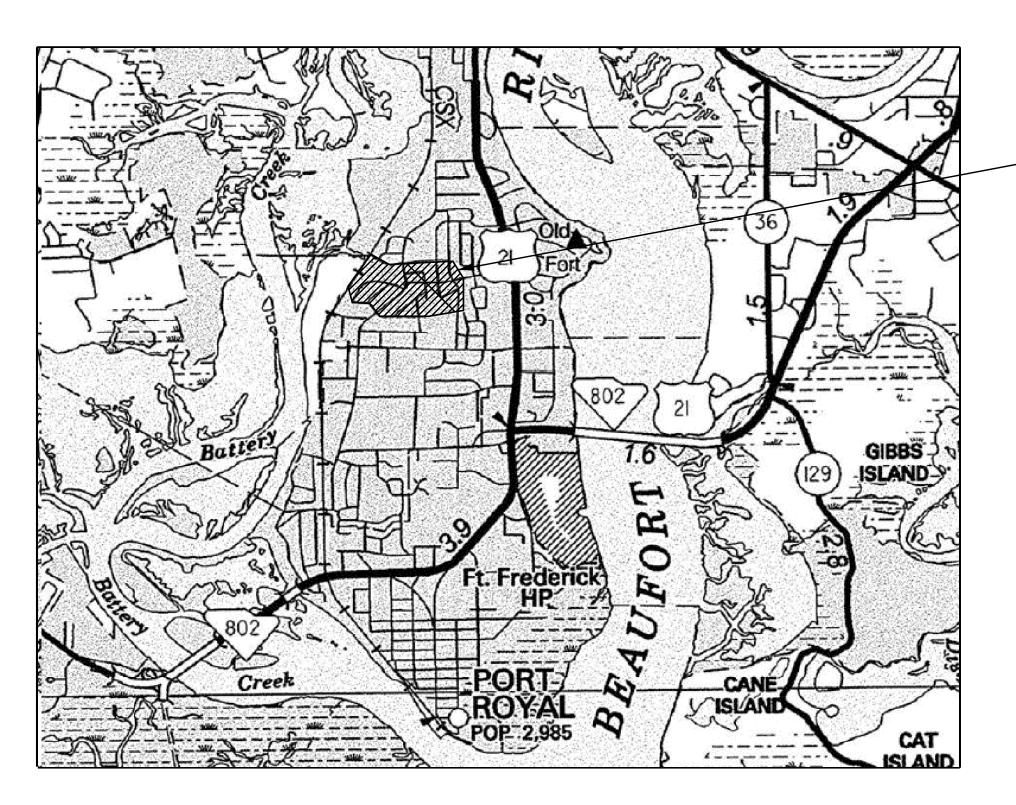

LAYOUT NTS


	BATTERY CREEK ROAD	TOTAL (MILES)
NET LENGTH OF ROADWAY	0.09	0.09
NET LENGTH OF BRIDGES	-	_
NET LENGTH OF PROJECT	0.09	0.09
LENGTH OF EXCEPTIONS	_	_
GROSS LENGTH OF PROJECT	0.09	0.09


EQUALITIES IN STATIONING: NONE

NOTE: EXCEPT AS MAY OTHERWISE BE SPECIFIED ON THE PLANS OR IN THE SPECIAL PROVISIONS, ALL MATERIALS AND WORKMANSHIP ON THIS PROJECT SHALL TO CONFORM WITH SOUTH CAROLINA DEPARTMENT OF TRANSPORTATION STANDARD SPECIFICATIONS FOR HIGHWAY CONSTRUCTION (2007 EDITION) AND STANDARD DRAWINGS FOR ROAD CONSTRUCTION IN EFFECT AT THE TIME OF LETTING.



STATE	COUNTY	FILE NO.	PROJECT NO.	ROUTE NO.	SHEET NO.
SC	BEAUFORT			S–7–159	1

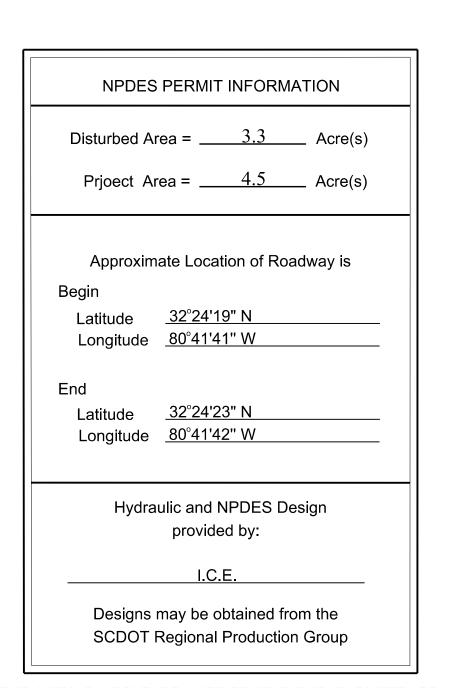

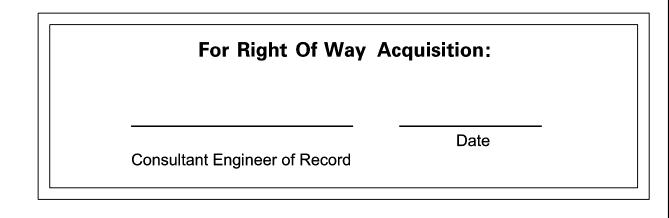



- PROJECT AREA



ENGINEER OF RECORD



FOR CONSTRUCTION :

DATE

PAY ITEM	DESCRIPTION	QUANTITY	UNIT
1031000	MOBILIZATION	1	LS
1032010	BONDS AND INSURANCE	1	LS
1050800	CONSTRUCTION STAKES, LINES & GRADES	1	EA
1071000	TRAFFIC CONTROL	1	LS
1090200	AS-BUILT CONSTRUCTION PLANS	1	LS
2012000	CLEARING & GRUBBING WITHIN ROADWAY	1	LS
2023000	REMOVAL & DISPOSAL OF EXISTING PAVEMENT	28.3	SY
2027000	REMOVAL & DISPOSAL OF EXISTING CONCRETE	15.7	CY
2031200	SITE EXCAVATION	1	LS
3100310	HOT MIX ASPHALT BASE COURSE - TYPE B	16	TON
4013990	MILLING EXISTING ASPHALT PAVEMENT (VARIABLE)	319.1	SY
4020320	HOT MIX ASPHALT INTERMEDIATE COURSE TYPE B	147	TON
4030320	HOT MIX ASPHALT SURFACE COURSE TYPE C	114	TON
6020005	PERMANENT CONSTRUCTION SIGNS (GROUND MOUNTED)	76	SF
7065010	TIMBER BOARDWALK (10' WIDE)	30	LF
7143618	18" SMOOTH WALL PIPE	88	LF
7143624	24" SMOOTH WALL PIPE	58	LF
7143654	54" SMOOTH WALL PIPE	104	LF
7204100	CONCRETE SIDEWALK (4" UNIFORM)	162	SY
7204900	DETECTABLE WARNING MATERIAL	41	SF
8041020	RIP-RAP (CLASS B)	44	TON
8048200	GEOTEXTILE FOR EROSION CONTROL UNDER RIPRAP(CLASS 2)TYPE A	40	SY
8100100	PERMANENT COVER	0.25	ACRE
8100200	TEMPORARY COVER	0.12	ACRE
8104005	FERTILIZER (NITROGEN)	25	LB
8104010	FERTILIZER (PHOSPHORIC ACID)	25	LB
8104015	FERTILIZER (POTASH)	25	LB
8105005	AGRICULTURAL GRANULAR LIME	491	LB
8109901	MOWING	1	ACRE
8153000	SILT FENCE	753	LF
8153090	REPLACE/REPAIR SILT FENCE	75	LF
8154050	REMOVAL OF SILT RETAINED BY SILT FENCE	188	LF



SUMMARY OF ESTIMATED QUANTITIES

EVALUATE: CONSULTING & ENGINEERING



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REV. NO.		BY	DATE
DESIGNE	D BY:	RNT	
DRAWN	BY:	RNT	
CHECKE	D BY:	JCH	

STATE	COUNTY	FILE NO.	PROJECT NO.	ROUTE NO.	SHEET NO.
SC	BEAUFORT			S–7–159	2

	BEAUFORT COUNTY	
	CITY OF BEAUFORT	
	BATTERY CREEK ROAD (S-7-159)	
DESCRIPTION OF REVISION	BASIN 1	
DATE <u>08/22/2019</u>	SUMMARY OF ESTIMATED QUANTITIES	
DATE <u>08/22/2019</u>		
DATE <u>08/22/2019</u>	SHEET 2 SCALE: NTS	

GENERAL CONSTRUCTION NOTES

SEE INDIVIDUAL CURVES ON REFERENCE DATA SHEET FOR SUPERELEVATION RATE AND DESIGN SPEED, AS APPLICABLE.

THE LOCATIONS OF EXISTING UTILITIES SHOWN ON THE PLANS HAVE BEEN DETERMINED FROM AVAILABLE INFORMATION AND ARE PROVIDED FOR THE CONVENIENCE OF THE CONTRACTOR. THE ENGINEER ASSUMES NO RESPONSIBILITY FOR THE ACCURACY OR COMPLETENESS OF THE UTILITIES INFORMATION SHOWN ON THE DRAWINGS. IT IS THEREFORE THE CONTRACTOR'S RESPONSIBILITY TO CONFIRM THAT THE PROPER COORDINATION WITH THE VARIOUS UTILITY OWNERS HAS BEEN PERFORMED.

THE CONTRACTOR SHALL COOPERATE WITH THE UTILITY OWNERS DURING RELOCATION OPERATIONS. THE CONTRACTOR SHALL EXERCISE CAUTION WHEN CROSSING AN UNDERGROUND UTILITY WHETHER SHOWN ON THE DRAWINGS OR LOCATED BY THE UTILITY COMPANY. COST OF DAMAGES TO ANY UTILITIES AS A RESULT OF CONSTRUCTION SHALL BE THE RESPONSIBILITY OF THE CONTRACTOR.

ALL WORKMANSHIP AND MATERIALS USED ON THIS PROJECT SHALL CONFORM TO THE SCDOT STANDARD SPECIFICATIONS FOR HIGHWAY CONSTRUCTION (2007 EDITION), SCDOT 2007 SUPPLEMENTAL SPECIFICATIONS, SCDOT SUPPLEMENTAL TECHNICAL SPECIFICATIONS IN EFFECT AT THE TIME OF LETTING, AND SCDOT 2009 STANDARD DRAWINGS EXCEPT WHERE OTHERWISE NOTED IN THE PLANS.


ALL EXISTING ROAD SIGNS AFFECTED BY CONSTRUCTION ACTIVITIES SHALL BE RETAINED, RELOCATED, OR REMOVED AS DIRECTED BY ENGINEER. PAYMENT FOR THIS WORK SHALL BE INCLUDED IN THE LUMP SUM COST FOR CLEARING AND GRUBBING.

ALL NEW SIGNS SHALL BE PLACED IN ACCORDANCE WITH THE MANUAL ON UNIFORM TRAFFIC CONTROL DEVICES AND SCDOT STANDARD DRAWINGS. NEW 2P & 3P SIGN SUPPORTS REQUIRED FOR RELOCATED SIGNS WILL BE PAID PER LINEAR FOOT INSTALLED AND ACCEPTED.

THE CONTRACTOR SHALL FURNISH, INSTALL, AND MAINTAIN ALL NECESSARY PROVISIONS FOR TRAFFIC CONTROL FOR THE DURATION OF THE PROJECT. THESE PROVISIONS, AS IN EACH CASE IS APPLICABLE, WILL CONFORM TO THE REQUIREMENTS CONTAINED IN THE SCDOT STANDARD SPECIFICATIONS, STANDARD DRAWINGS, SUPPLEMENTAL SPECIFICATIONS, SPECIAL PROVISIONS, THE FEDERAL HIGHWAY ADMINISTRATION MANUAL ON UNIFORM TRAFFIC CONTROL DEVICES, AND AS DIRECTED BY THE ENGINEER. THE CONTRACTOR SHALL SUBMIT THE TRAFFIC CONTROL PLAN TO THE COUNTY FOR APPROVAL BEFORE BEGINNING CONSTRUCTION.

THE LUMP SUM COST FOR TRAFFIC CONTROL SHALL INCLUDE ALL WORK AS DIRECTED ABOVE. THIS LUMP SUM COST SHALL INCLUDE TEMPORARY CONSTRUCTION SIGNS, BARRICADES, DRUMS, CONES, LIGHTS, AND OTHER ITEMS AS REQUIRED TO COMPLETE THIS WORK.

CONTRACTOR SHALL REFER TO SCDOT STD. DWG. 605-010-02 FOR PLACEMENT OF PERMANENT CONSTRUCTION SIGNS. THIS PROJECT REQUIRES ONE (1) SCHEME C. SIGNS SHALL BE PAID FOR PER SQUARE FOOT INSTALLED AND ACCEPTED UNDER THE BID ITEM FOR PERMANENT CONSTRUCTION SIGNS.

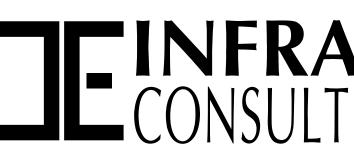

GENERAL NOTES

EROSION CONTROL NOTES:

IF NECESSARY, SLOPES, WHICH EXCEED EIGHT (8) VERTICAL FEET SHOULD BE STABILIZED WITH SYNTHETIC OR VEGETATIVE MATS, IN ADDITION TO HYDROSEEDING. IT MAY BE NECESSARY TO INSTALL TEMPORARY SLOPE DRAINS DURING CONSTRUCTION. TEMPORARY BERMS MAY BE NEEDED UNTIL THE SLOPE IS BROUGHT TO GRADE.

STABILIZATION MEASURES SHALL BE INITIATED AS SOON AS PRACTICABLE IN PORTIONS OF THE SITE WHERE CONSTRUCTION ACTIVITIES HAVE TEMPORARILY OR PERMANENTLY CEASED, BUT IN NO CASE MORE THAN FOURTEEN (14) DAYS AFTER WORK HAS CEASED, EXCEPT AS STATED BELOW.

A) WHERE STABILIZATION BY THE 14TH DAY IS PRECLUDED BY SNOW COVER OR FROZEN GROUND CONDITIONS STABILIZATION MEASURES MUST BE INITIATED AS SOON AS PRACTICAL.

B) WHERE CONSTRUCTION ACTIVITY ON A PORTION OF THE SITE IS TEMPORARILY CEASED. AND EARTH-DISTURBING ACTIVITIES WILL BE RESUMED WITHIN 14 DAYS. TEMPORARY STABILIZATION MEASURES DO NOT HAVE TO BE INITIATED ON THAT PORTION OF THE SITE

ALL SEDIMENT AND EROSION CONTROL DEVICES SHALL BE INSPECTED ONCE EVERY CALENDAR WEEK. IF PERIODIC INSPECTION OR OTHER INFORMATION INDICATES THAT A BMP HAS BEEN INAPPROPRIATELY OR INCORRECTLY INSTALLED, THE PERMITTEE MUST ADDRESS THE NECESSARY REPLACEMENT OR MODIFICATION TO CORRECT THE BMP WITHIN 48 HOURS OF IDENTIFICATION.

PROVIDE SILT FENCE AND/OR OTHER CONTROL DEVICES, AS MAY BE REQUIRED, TO CONTROL SOIL EROSION DURING UTILITY CONSTRUCTION. ALL DISTURBED AREAS SHALL BE CLEANED, GRADED, AND STABILIZED WITH GRASSING IMMEDIATELY AFTER THE UTILITY INSTALLATION. FILL, COVER, AND TEMPORARY SEEDING AT THE END OF EACH DAY ARE RECOMMENDED. IF WATER IS ENCOUNTERED WHILE TRENCHING, THE WATER SHOULD BE FILTERED TO REMOVE ANY SEDIMENTS BEFORE BEING PUMPED BACK INTO ANY WATERS OF THE STATE.

ALL EROSION CONTROL DEVICES SHALL BE PROPERLY MAINTAINED DURING ALL PHASES OF CONSTRUCTION UNTIL THE COMPLETION OF ALL CONSTRUCTION ACTIVITIES AND ALL DISTURBED AREAS HAVE BEEN STABILIZED. ADDITIONAL CONTROL DEVICES MAY BE REQUIRED DURING CONSTRUCTION IN ORDER TO CONTROL EROSION AND/OR OFFSITE SEDIMENTATION. ALL TEMPORARY CONTROL DEVICES SHALL BE REMOVED ONCE CONSTRUCTION IS COMPLETE AND THE SITE IS STABILIZED.

THE CONTRACTOR MUST TAKE NECESSARY ACTION TO MINIMIZE THE TRACKING OF MUD ONTO PAVED ROADWAY(S) FROM CONSTRUCTION AREAS AND THE GENERATION OF DUST. THE CONTRACTOR SHALL DAILY REMOVE MUD/SOIL FROM PAVEMENT, AS MAY BE REQUIRED.

RESIDENTIAL SUBDIVISIONS REQUIRE EROSION CONTROL FEATURES FOR INFRASTRUCTURE AS WELL AS FOR INDIVIDUAL LOT CONSTRUCTION. INDIVIDUAL PROPERTY OWNERS SHALL FOLLOW THESE PLANS DURING CONSTRUCTION OR OBTAIN APPROVAL OF AN INDIVIDUAL PLAN IN ACCORDANCE WITH S.C REG. 72-300 ET SEQ. AND SCR100000.

TEMPORARY DIVERSION BERMS AND/OR DITCHES WILL BE PROVIDED AS NEEDED DURING CONSTRUCTION TO PROTECT WORK AREAS FROM UPSLOPE RUNOFF AND/OR TO DIVERT SEDIMENT-LADEN WATER TO APPROPRIATE TRAPS OR STABLE OUTLETS.

ALL WATERS OF THE STATE (WOS), INCLUDING WETLANDS, ARE TO BE FLAGGED OR OTHERWISE CLEARLY MARKED IN THE FIELD. A DOUBLE ROW OF SILT FENCE IS TO BE INSTALLED IN ALL AREAS WHERE A 50-FOOT BUFFER CANNOT BE MAINTAINED BETWEEN THE DISTURBED AREA AND ALL WOS. A 10-FOOT BUFFER SHOULD BE MAINTAINED BETWEEN THE LAST ROW OF SILT FENCE AND ALL WOS.

LITTER, CONSTRUCTION DEBRIS, OILS, FUELS, AND BUILDING PRODUCTS WITH SIGNIFICANT POTENTIAL FOR IMPACT (SUCH AS STOCKPILES OF FRESHLY TREATED LUMBER) AND CONSTRUCTION CHEMICALS THAT COULD BE EXPOSED TO STORM WATER MUST BE PREVENTED FROM BECOMING A POLLUTANT SOURCE IN STORM WATER DISCHARGES.

A COPY OF THE SWPPP. INSPECTION RECORDS, AND RAINFALL DATA MUST BE RETAINED AT THE CONSTRUCTION SITE OR A NEARBY LOCATION EASILY ACCESSIBLE DURING NORMAL BUSINESS HOURS, FROM THE DATE OF COMMENCEMENT OF CONSTRUCTION ACTIVITIES TO THE DATE THAT FINAL STABILIZATION IS REACHED.

INITIATE STABILIZATION MEASURES ON ANY EXPOSED STEEP SLOPE (3H:1V OR GREATER) WHERE LAND-DISTURBING ACTIVITIES HAVE PERMANENTLY OR TEMPORARILY CEASED, AND WILL NOT RESUME FOR A PERIOD OF 7 CALENDAR DAYS.

MINIMIZE SOIL COMPACTION AND UNLESS INFEASIBLE, PRESERVE TOPSOIL.

MINIMIZE THE DISCHARGE OF POLLUTANTS FROM EQUIPMENT AND VEHICLE WASHING, WHEEL WASH WATER, ANDOTHER WASH WATERS. WASH WATERS MUST BE TREATED IN A SEDIMENT BASIN OR ALTERNATIVE CONTROL THATPROVIDES EQUIVALENT OR BETTER TREATMENT PRIOR TO DISCHARGE.

THE FOLLOWING DISCHARGES FROM SITES ARE PROHIBITED:

- WASTEWATER FROM WASHOUT OF CONCRETE, UNLESS MANAGED BY AN APPROPRIATE CONTROL; – WASTEWATER FROM WASHOUT AND CLEANOUT OF STUCCO, PAINT, FORM RELEASE OILS, CURING COMPOUNDS AND OTHER CONSTRUCTION MATERIALS;

- FUELS, OILS OR OTHER POLLUTANTS USED IN VEHICLE AND EQUIPMENT OPERATION AND MAINTENANCE; AND

- SOAPS OR SOLVENTS USED IN VEHICLE AND EQUIPMENT WASHING.

AFTER CONSTRUCTION ACTIVITIES BEGIN, INSPECTION MUST BE CONDUCTED AT A MINIMUM OF AT LEAST ONCE EVERY CALENDAR WEEK AND MUST BE CONDUCTED UNTIL FINAL STABILIZATION IS REACHED ON ALL AREAS OF THE CONSTRUCTION SITE.

JEINFRASTRUCTURE CONSULTING & ENGINEERING



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REV. NO.	BY	DATE	DESCRIPTION OF REVISION
DESIGNE	D BY: BJL		DATE <u>08/22/2019</u>
DRAWN	BY: <u>BJL</u>		DATE <u>08/22/2019</u>
CHECKE	D BY: <u>JCH</u>		DATE <u>08/22/2019</u>
	и DI. <u>JC</u> П		DATE <u>08/22/2019</u>

STATE	COUNTY	FILE NO.	PROJECT NO.	ROUTE NO.	SHEET NO.
SC	BEAUFORT			S–7–159	3

EROSION CONTROL NOTES (CON'T)

IF EXISTING BMPS NEED TO BE MODIFIED OR IF ADDITIONAL BMPS ARE NECESSARY TO COMPLY WITH THE REQUIREMENTS OF THIS PERMIT AND/OR SC'S WATER QUALITY STANDARDS, IMPLEMENTATION MUST BE COMPLETED BEFORE THE NEXT STORM WATER EVENT WHENEVER PRACTICABLE, THE SITUATION MUST BE DOCUMENTED IN THE SWPPP AND ALTERNATIVE BMPS MUST BE IMPLEMENTED AS SOON AS REASONABLY POSSIBLE.

A PRE-CONSTRUCTION CONFERENCE MUST BE HELD FOR EACH CONSTRUCTION SITE WITH AN APPROVED ON-SITE SWPPP PRIOR TO THE IMPLEMENTATION OF CONSTRUCTION ACTIVITIES. FOR NON-LINEAR PROJECTS THAT DISTURB 10 ACRES OR MORE THIS CONFERENCE MUST BE HELD ON-SITE UNLESS THE DEPARTMENT AS APPROVED OTHERWISE.


THE CONTRACTOR IS REQUIRED TO IDENTIFY AND MAINTAIN AN ON-SITE CONCRETE WASHDOWN AREA THAT MEETS ALL REQUIREMENTS / BMPS OF SCDHEC. APPROVED WASHOUT AREAS MAY INCLUDE SECTIONS OF SIDEWALK THAT HAVE BEEN FORMED AND THAT ARE LOCATED AHEAD OF THE CURRENT CONCRETE POUR. THE CONTRACTOR WILL BE RESPONSIBLE FOR REMOVAL OF CONCRETE REMNANTS AND PREPARING THE SUBGRADE IN THESE AREAS PRIOR TO PLACEMENT OF THE NEXT DAYS CONCRETE POUR.


SEQUENCE OF CONSTRUCTION


- OBTAIN NPDES COVERAGE FROM DHEC
- NOTIFY SC DHEC REGIONAL OFFICE AND THE CITY OF BEAUFORT DEPARTMENT OF PUBLIC WORKS 48 HOURS PRIOR TO ANY LAND DISTRUBING ACTIVITIES.
- 3. INSTALL TREE PROTECTION AND DELINEATE CLEARING LIMITS.
- 4. CLEARING & GRUBBING ONLY AS NECESSARY FOR INSTALLATION OF PERIMETER CONTROLS (E.G. SILT FENCE).
- INSTALL PERIMETER CONTROLS (E.G. SILT FENCE).
- CLEARING AND GRUBBING OF SITE (SEDIMENT & EROSION CONTROL MEASURES FOR THESE AREAS MUST ALREADY BE INSTALLED.
- 7. WORK ON SPANISH MOSS TRAIL (IE TEMPORARY COFFER DAM. SHEET PILE WALL, REPLACE CULVERTS, HEADWALL, FLAP GATES, RECONSTRUCT PATHWAY)
- 8. CLEAN DITCHES
- 9. INSTALL UPSTREAM STORM DRAINAGE.
- 10. INSTALL COFFER DAM FOR BATTERY CREEK ROAD.
- 11. DETOUR WORK FOR BATTERY CREEK ROAD STORM DRAINAGE CROSSING
- 12. FINE GRADING ON BATTERY CREEK ROAD.
- 13. ASPHALT PAVING.
- 14. CONSTRUCT SIDEWALK.
- 15. FINISH GRADING AND FINAL GRASSING.
- 16. MAINTAIN ALL SEDIMENT AND EROSION CONTROL DEVICES FOR THE EXTENT OF THE PROJECT
- 17. REMOVAL OF SEDIMENT CONTROLS AFTER SITE HAS BEEN STABILIZED.
- 18. CONTACT THE CITY OF BEAUFORT DEPARTMENT OF PUBLIC WORKS FOR FINAL PROJECT INSPECTION.
- 19. FILE NOTICE OF TERMINATION.


BEAUFORT COUNTY CITY OF BEAUFORT

BATTERY CREEK ROAD (S-7-159) BASIN 1 GENERAL CONSTRUCTION NOTES

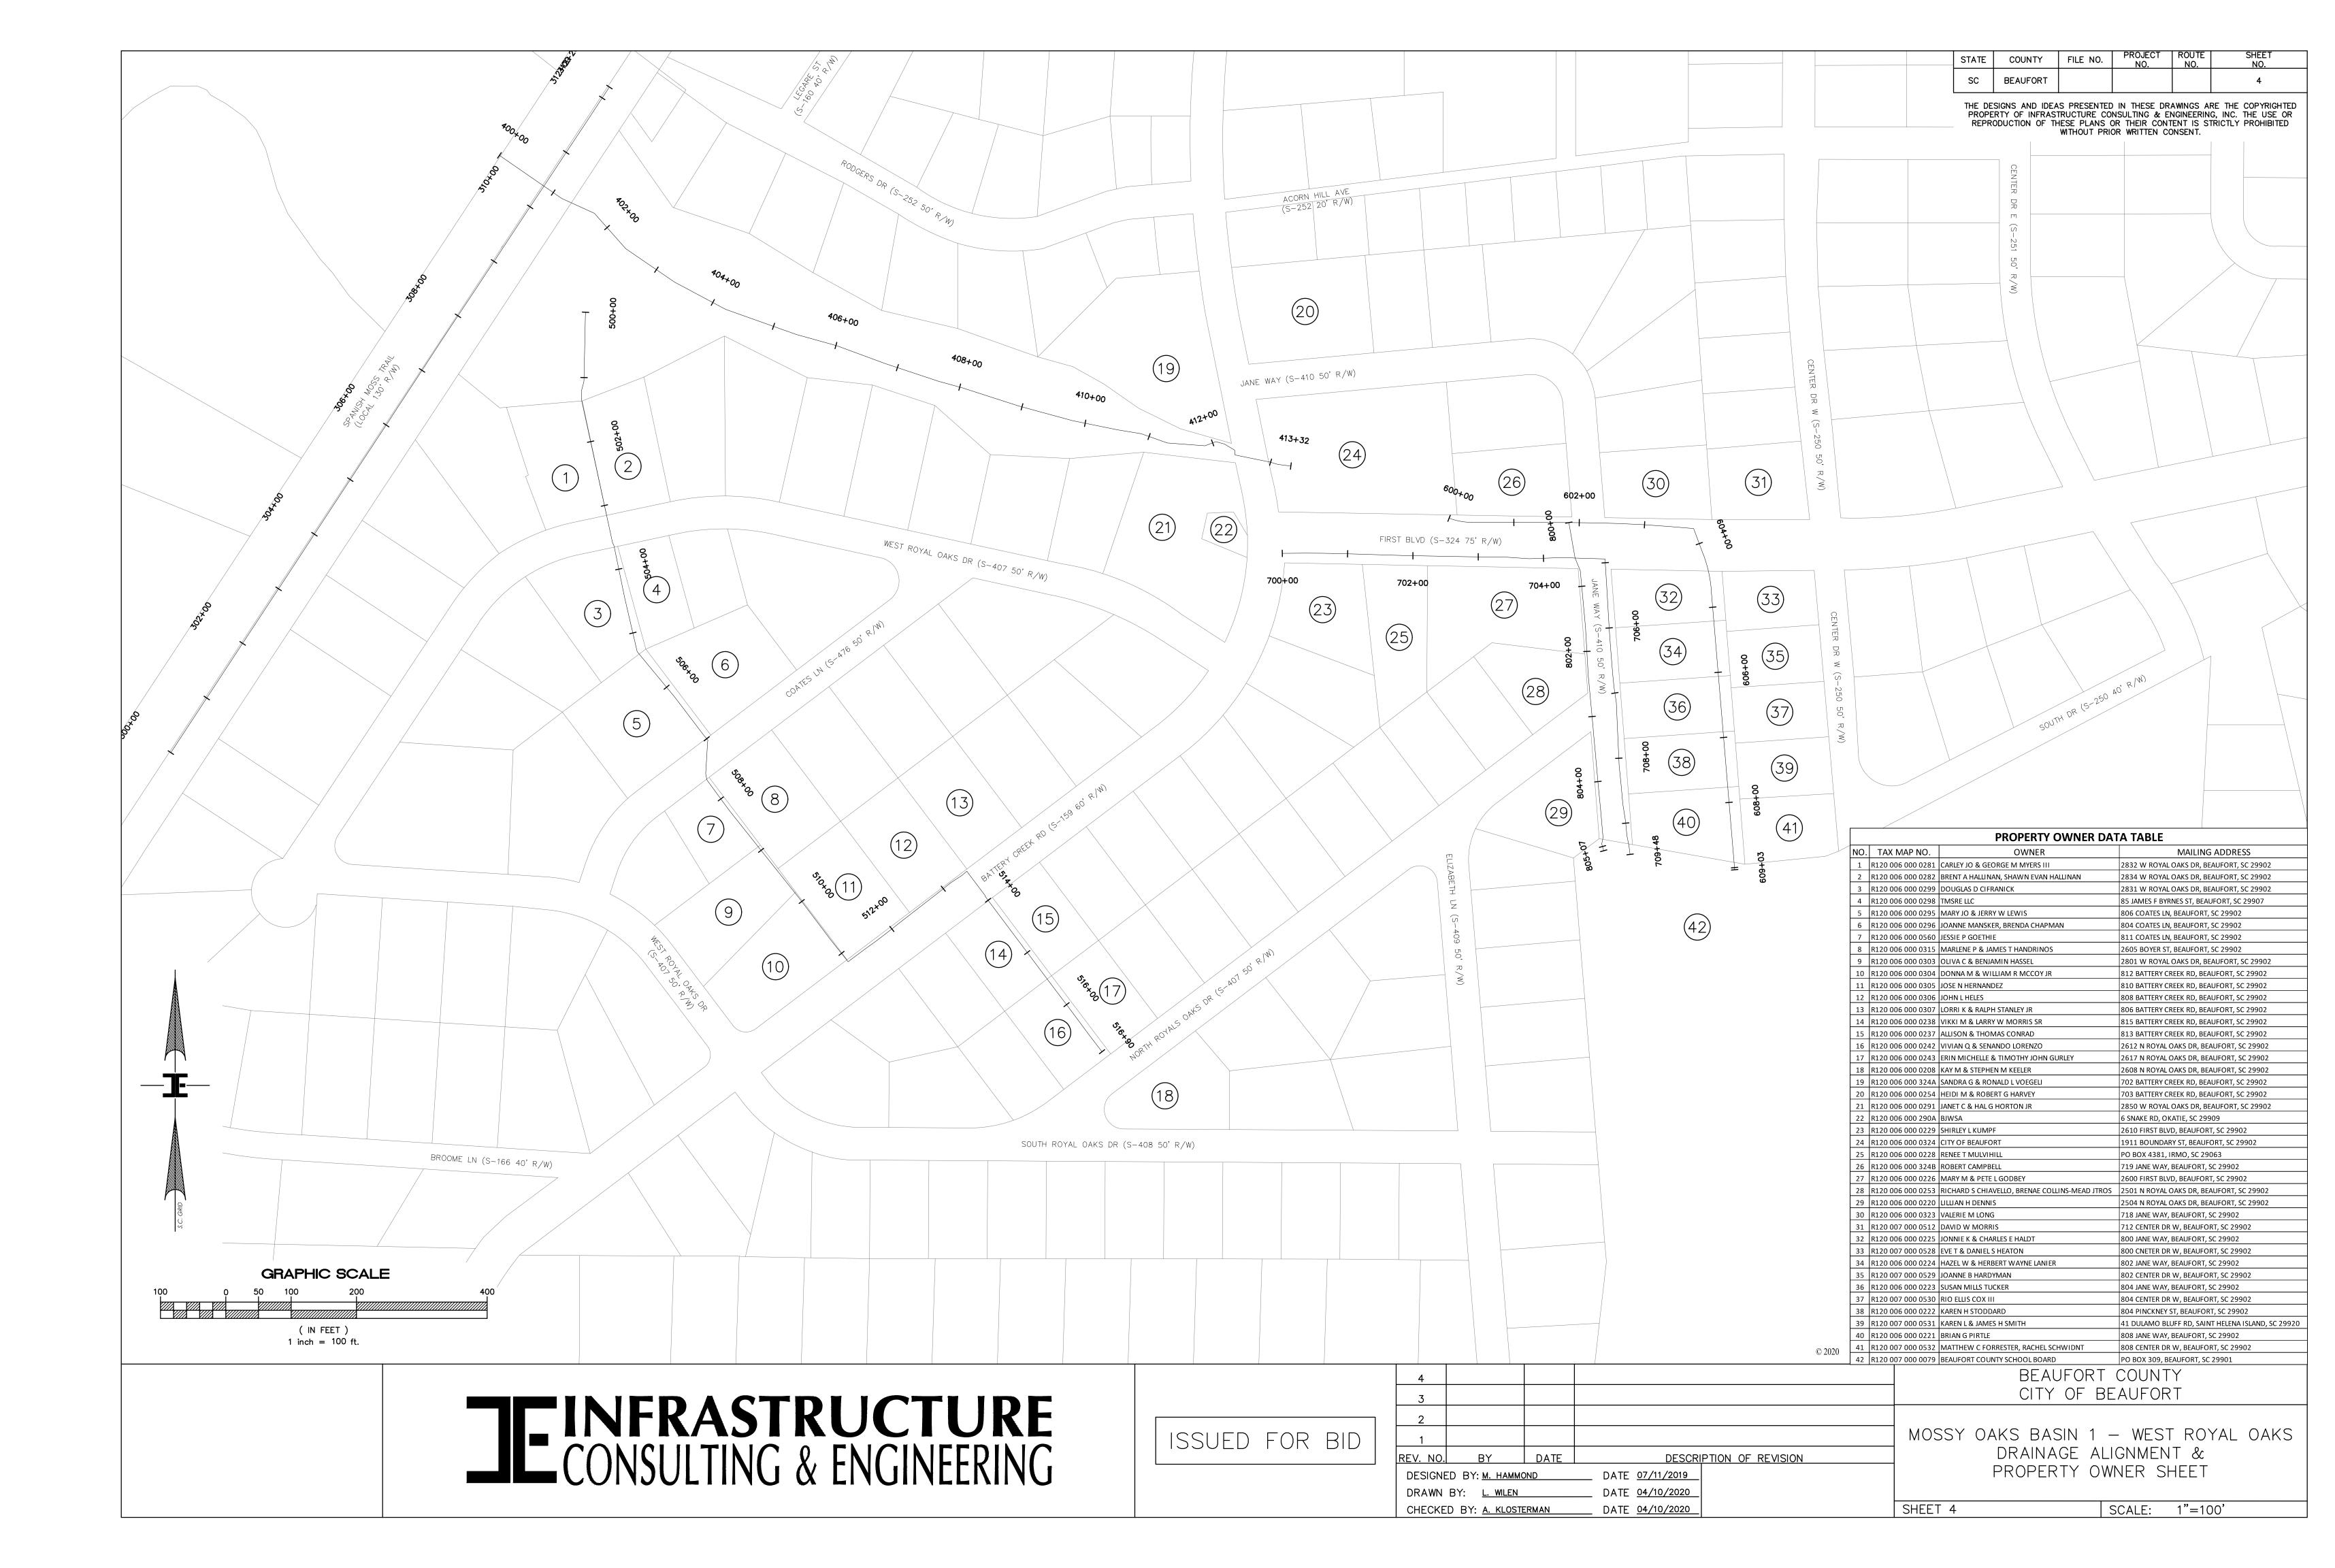

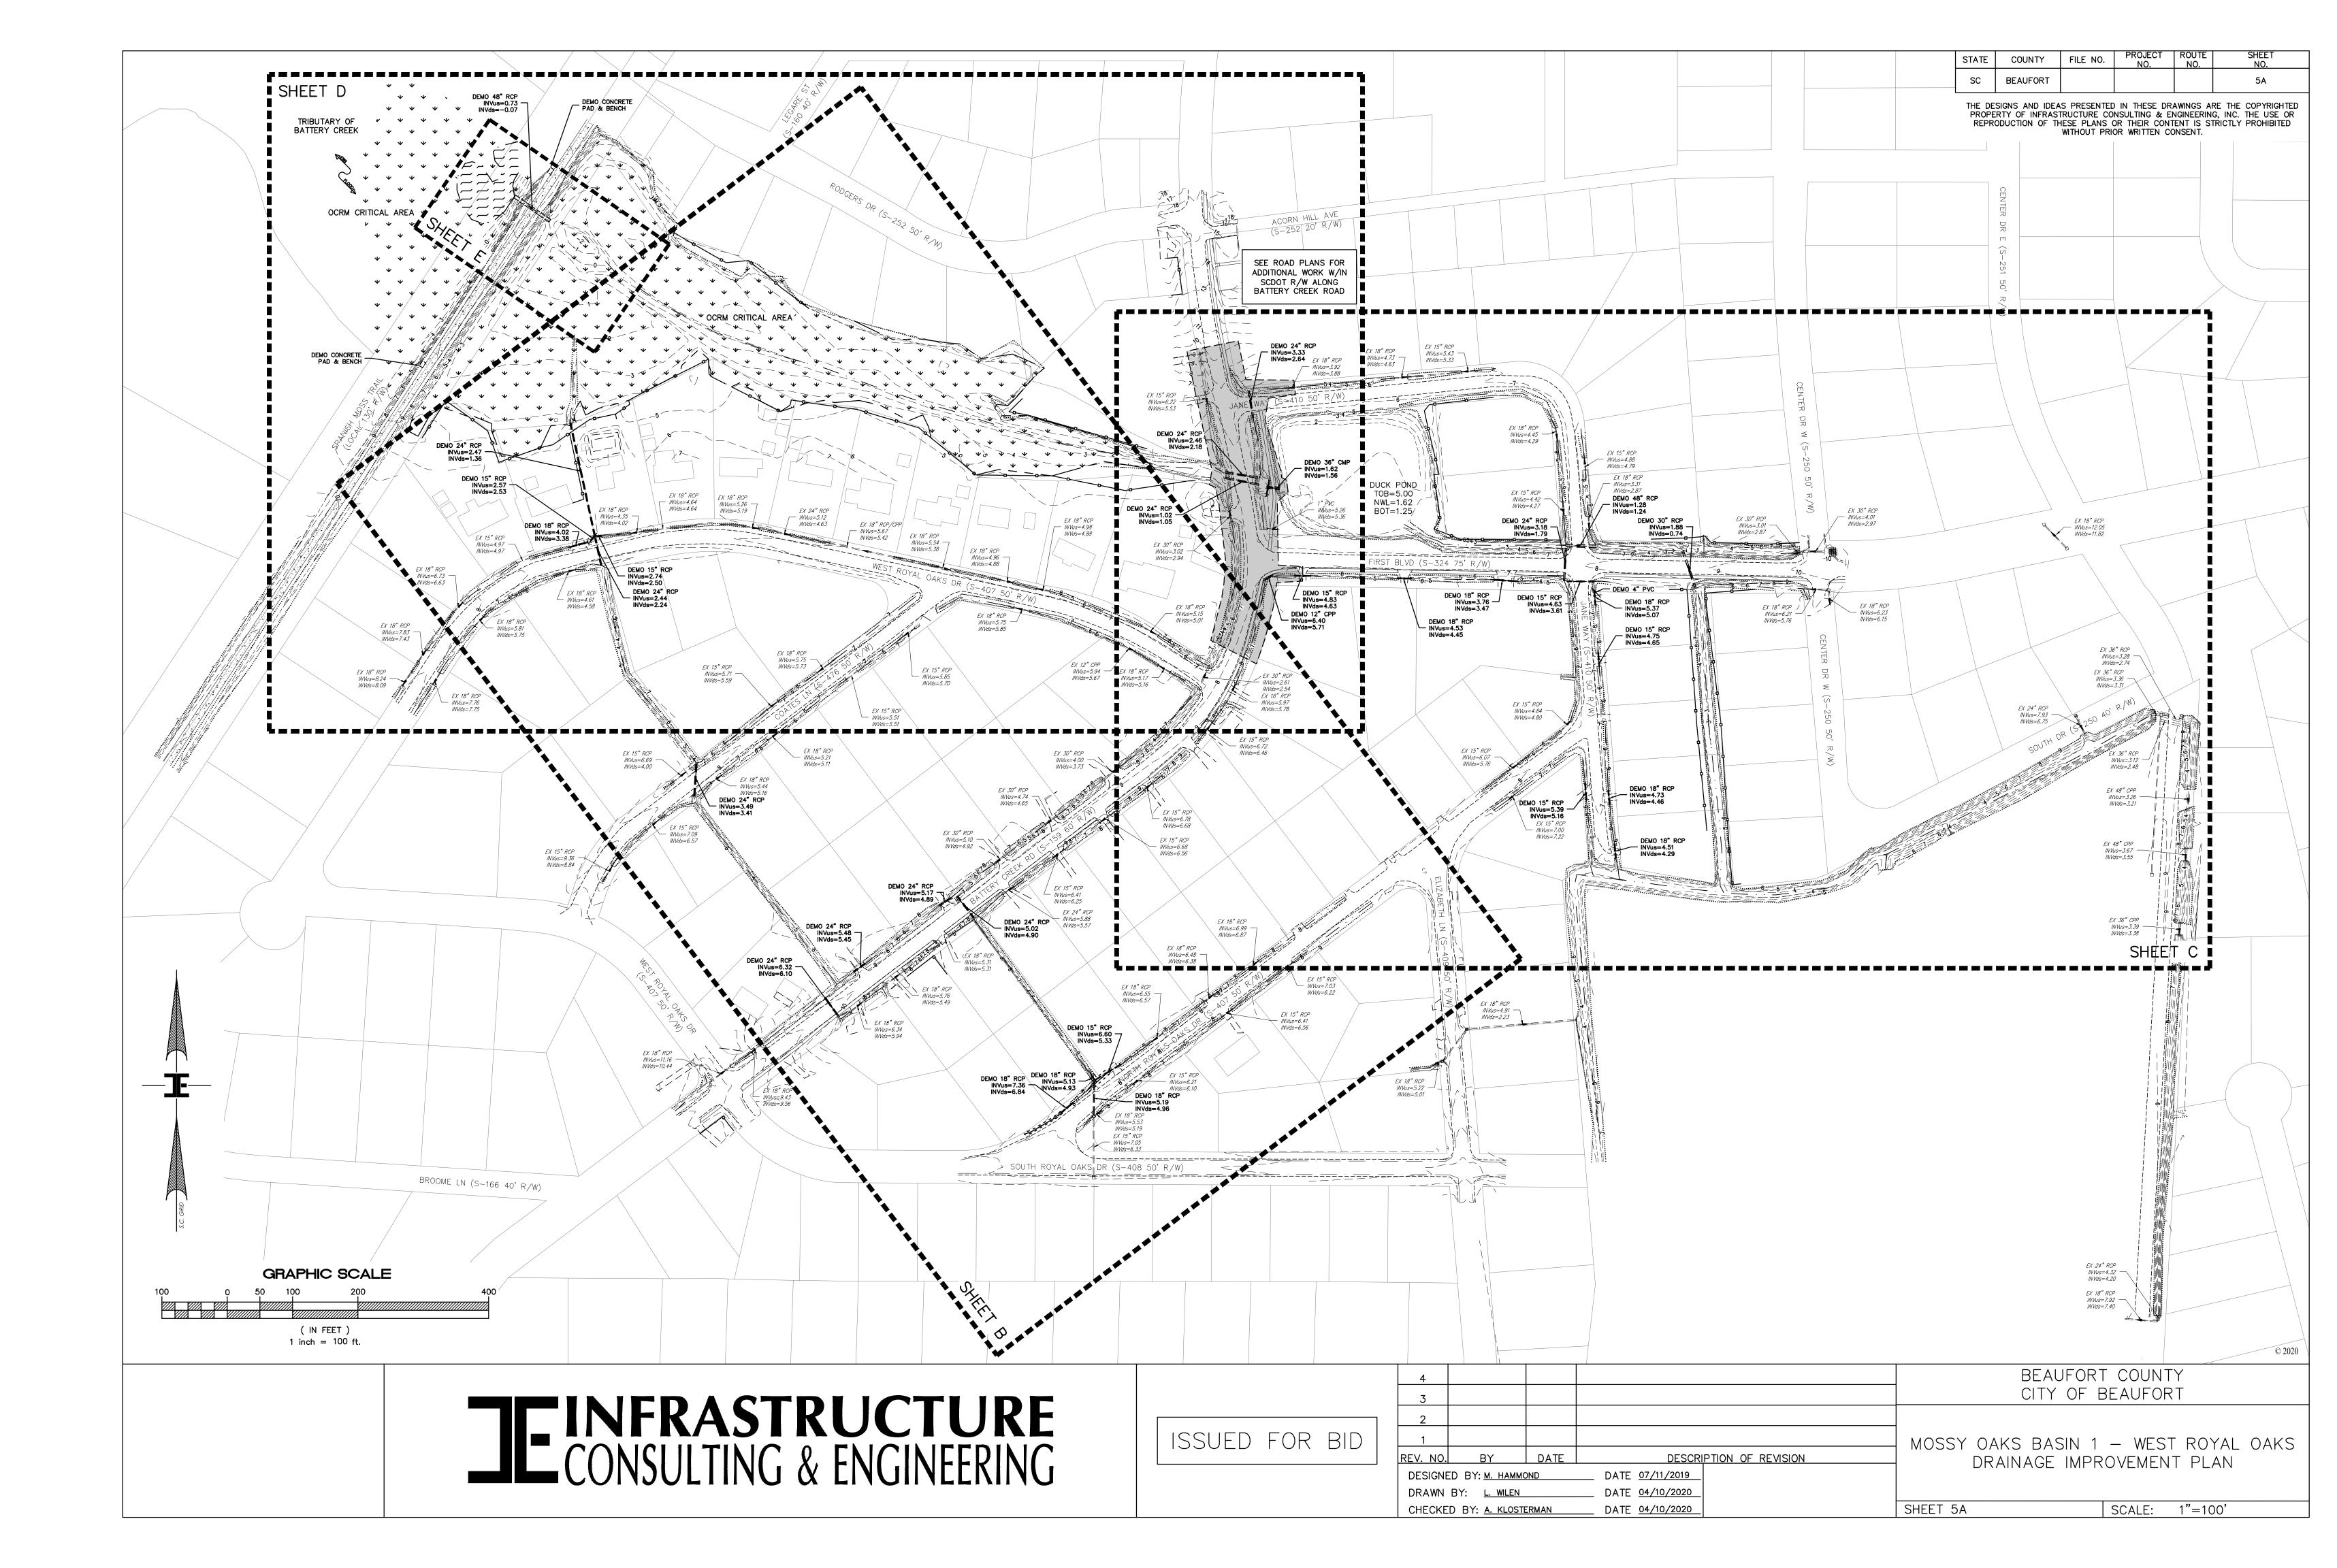

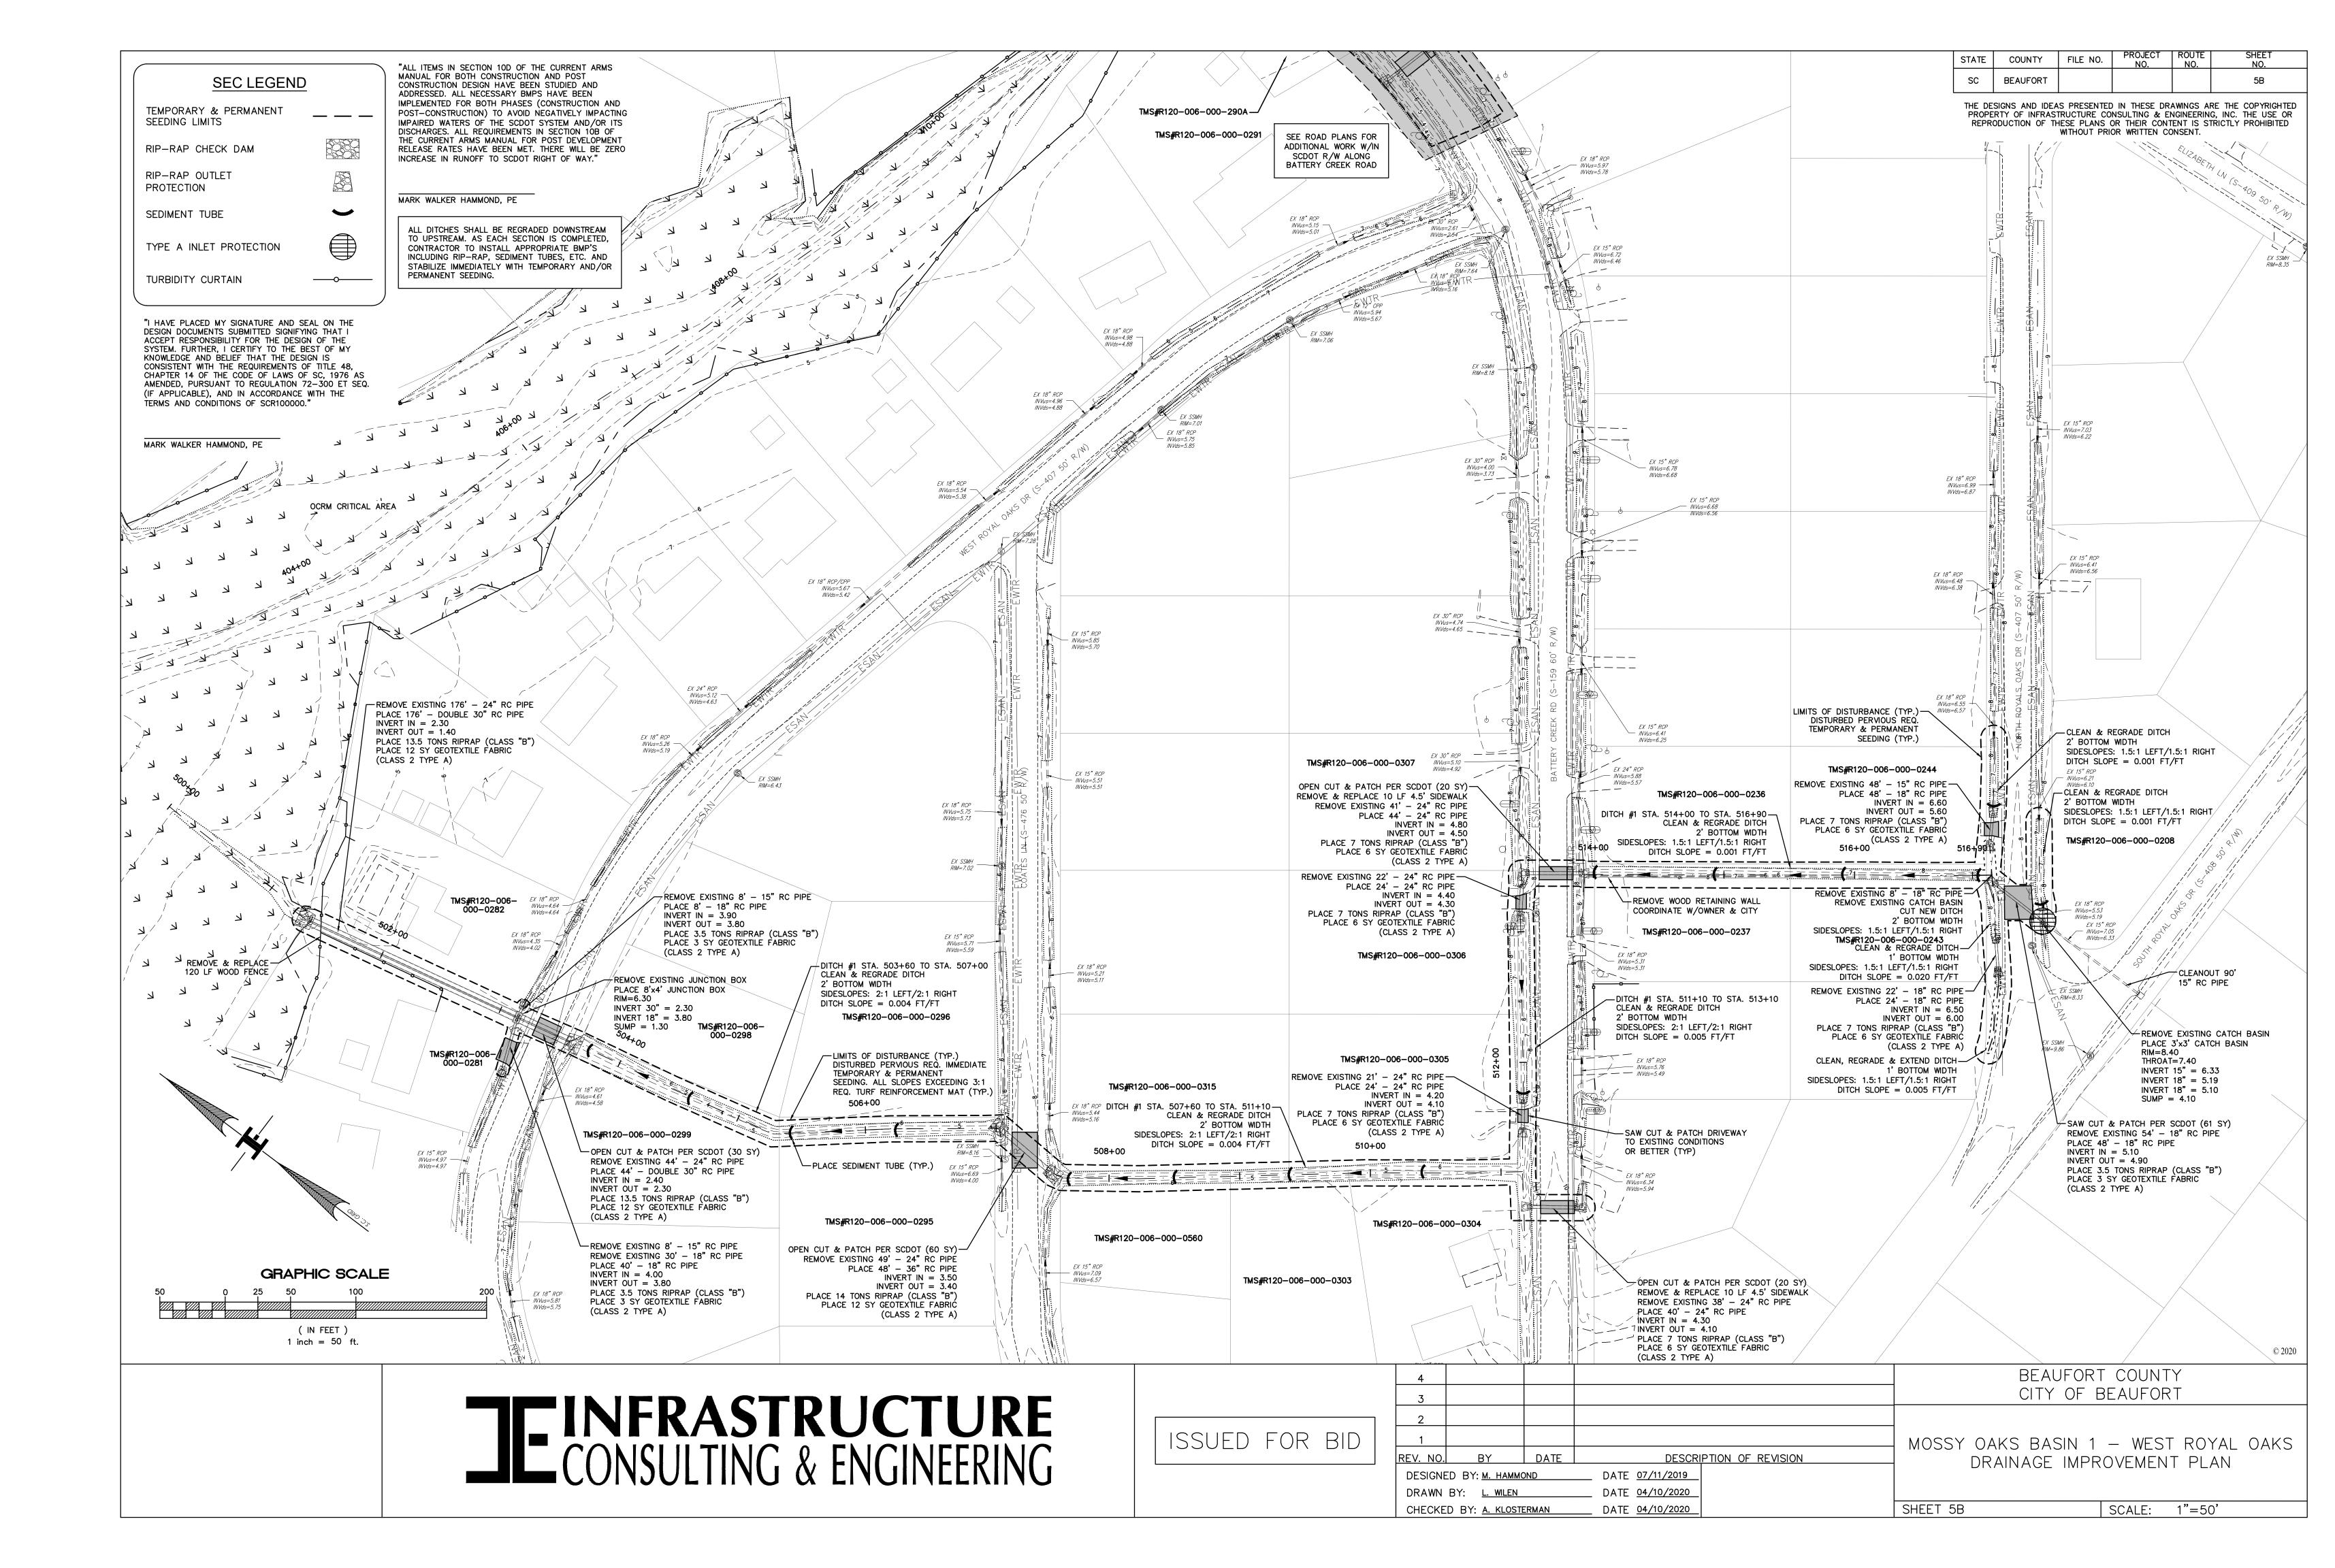

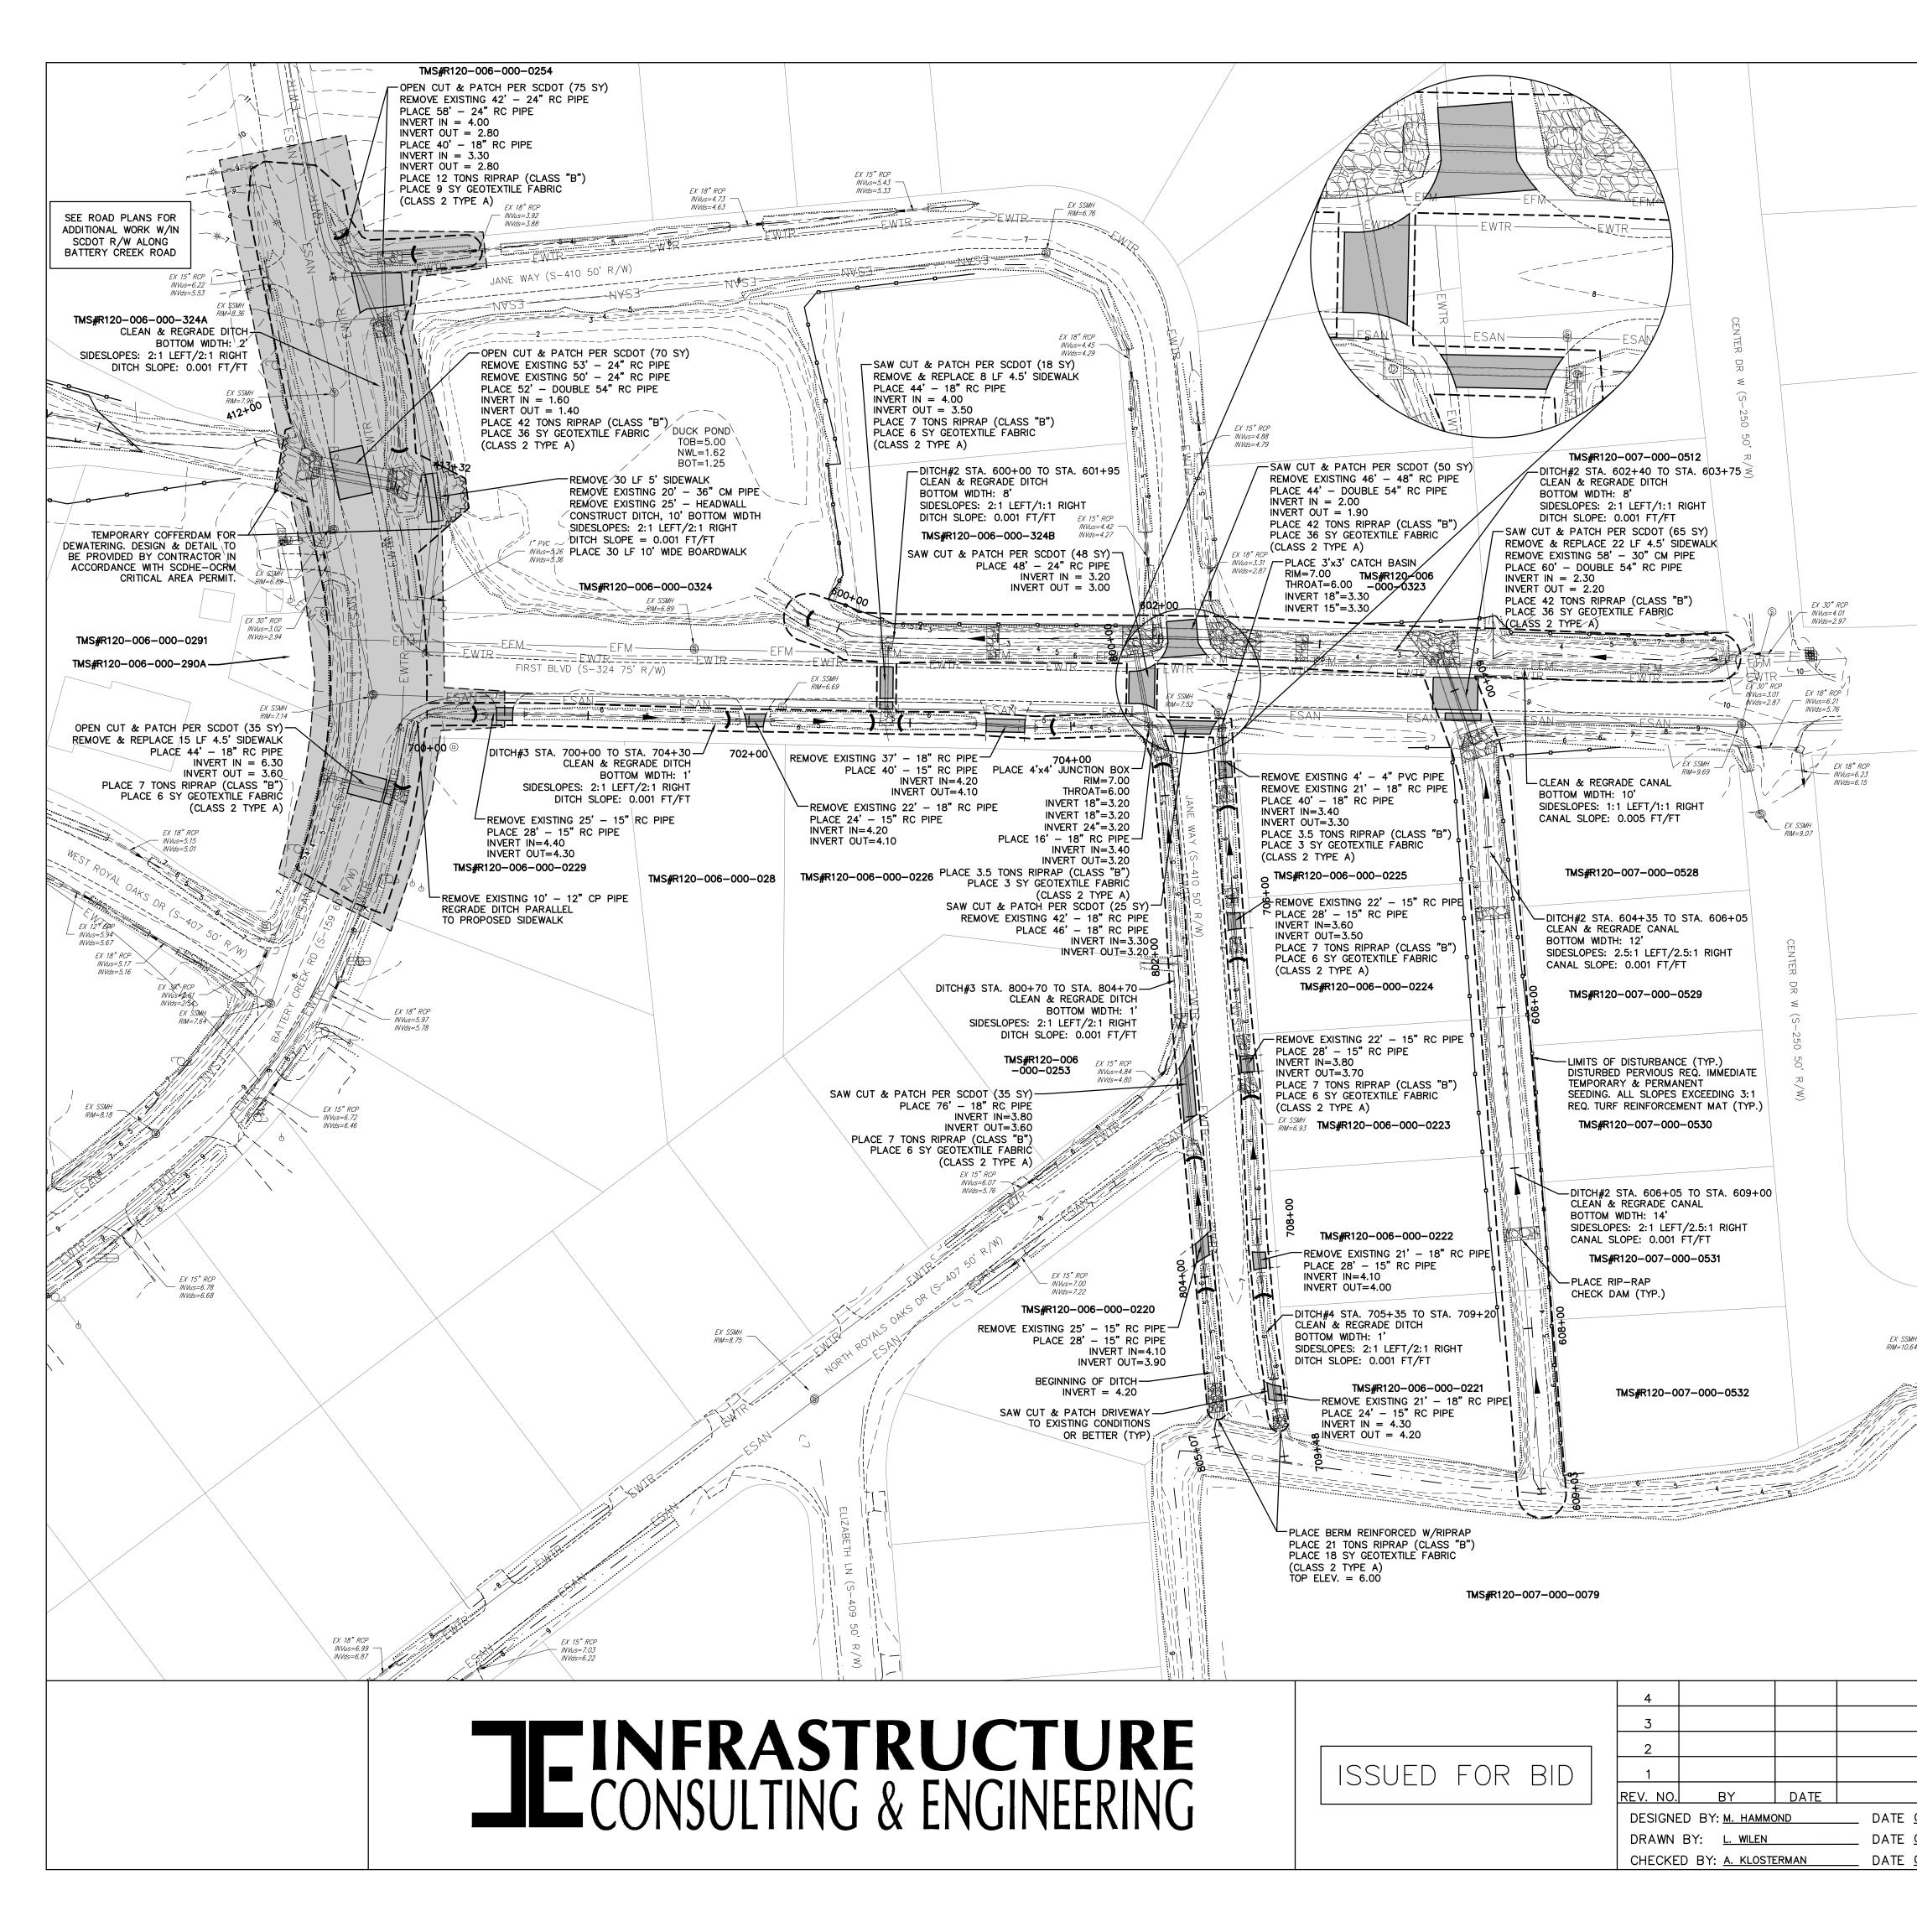


"I HAVE PLACED MY SIGNATURE AND SEAL ON THE DESIGN DOCUMENTS SUBMITTED SIGNIFYING THAT I ACCEPT RESPONSIBILITY FOR THE DESIGN OF THE SYSTEM. FURTHER, I CERTIFY TO THE BEST OF MY KNOWLEDGE AND BELIEF THAT THE DESIGN IS CONSISTENT WITH THE REQUIREMENTS OF TITLE 48, CHAPTER 14 OF THE CODE OF LAWS OF SC, 1976 AS AMENDED, PURSUANT TO REGULATION 72-300 ET SEQ. (IF APPLICABLE), AND IN ACCORDANCE WITH THE TERMS AND CONDITIONS OF SCR100000."

MARK WALKER HAMMOND, PE

MARK WALKER HAMMOND, PE

PERMANENT SEEDING.

"ALL ITEMS IN SECTION 10D OF THE CURRENT ARMS MANUAL FOR BOTH CONSTRUCTION AND POST CONSTRUCTION DESIGN HAVE BEEN STUDIED AND ADDRESSED. ALL NECESSARY BMPS HAVE BEEN IMPLEMENTED FOR BOTH PHASES (CONSTRUCTION AND POST-CONSTRUCTION) TO AVOID NEGATIVELY IMPACTING IMPAIRED WATERS OF THE SCDOT SYSTEM AND/OR ITS DISCHARGES. ALL REQUIREMENTS IN SECTION 10B OF THE CURRENT ARMS MANUAL FOR POST DEVELOPMENT RELEASE RATES HAVE BEEN MET. THERE WILL BE ZERO INCREASE IN RUNOFF TO SCDOT RIGHT OF WAY."

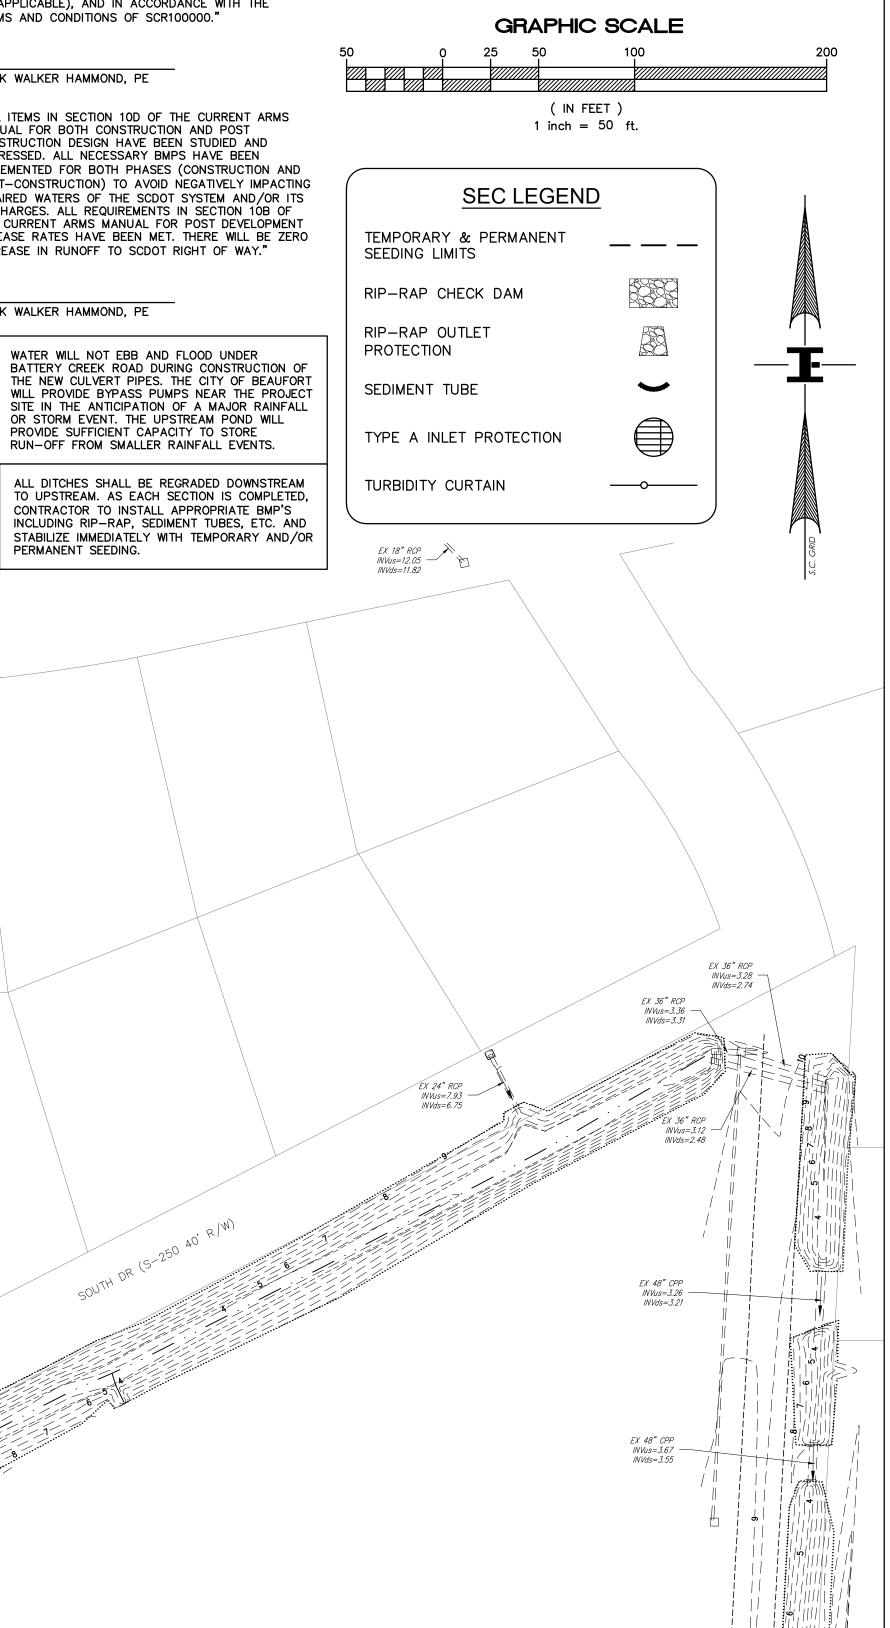

PROJECT NO.

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REPRODUCTION OF THESE PLANS OR THEIR CONTENT IS STRICTLY PROHIBITED

WITHOUT PRIOR WRITTEN CONSENT.

COUNTY FILE NO.

BEAUFORT

STATE

SC

ROUTE

NO

SHEET

5C

NO

DESCRI	PTION	OF	REVISION	
07/11/2019				
04/10/2020				
04/10/2020				
04/10/2020				

MOSSY OAKS BASIN 1 - WEST ROYAL OAKS DRAINAGE IMPROVEMENT PLAN


BEAUFORT COUNTY


CITY OF BEAUFORT


SHEET 5C


SCALE: 1"=50'

EX 36" CPP INVus=3.39 -INVds=3.38

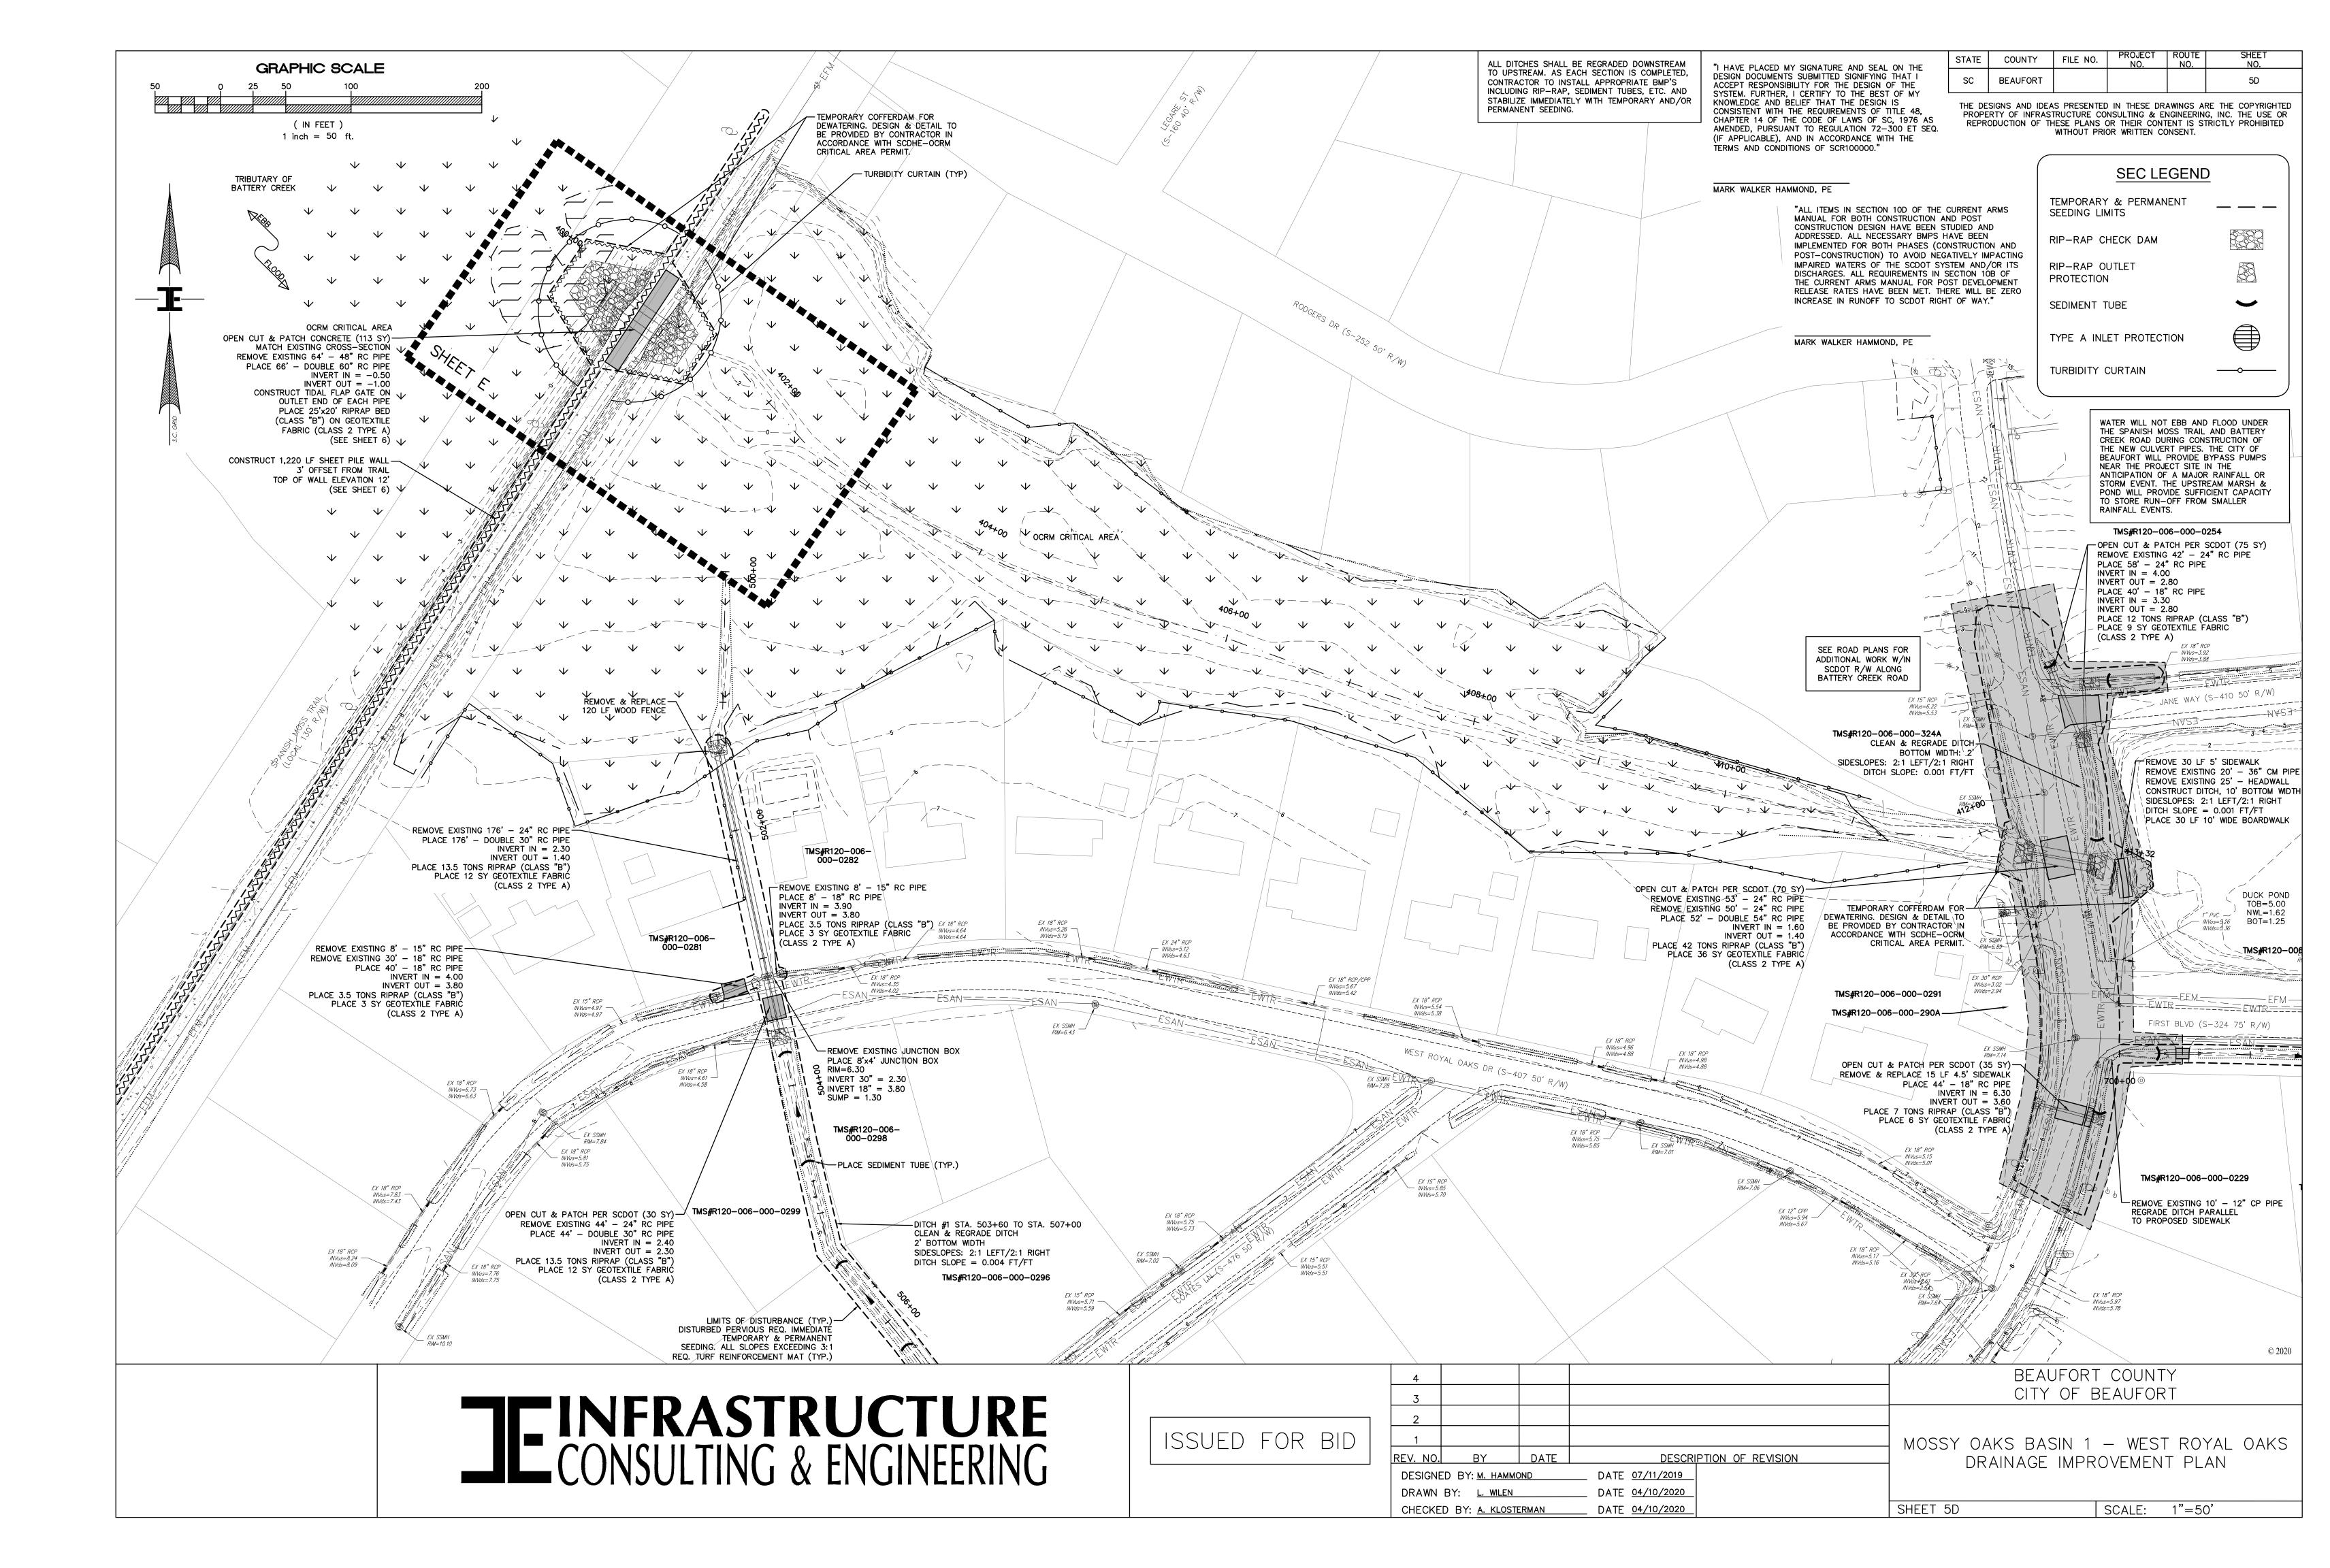

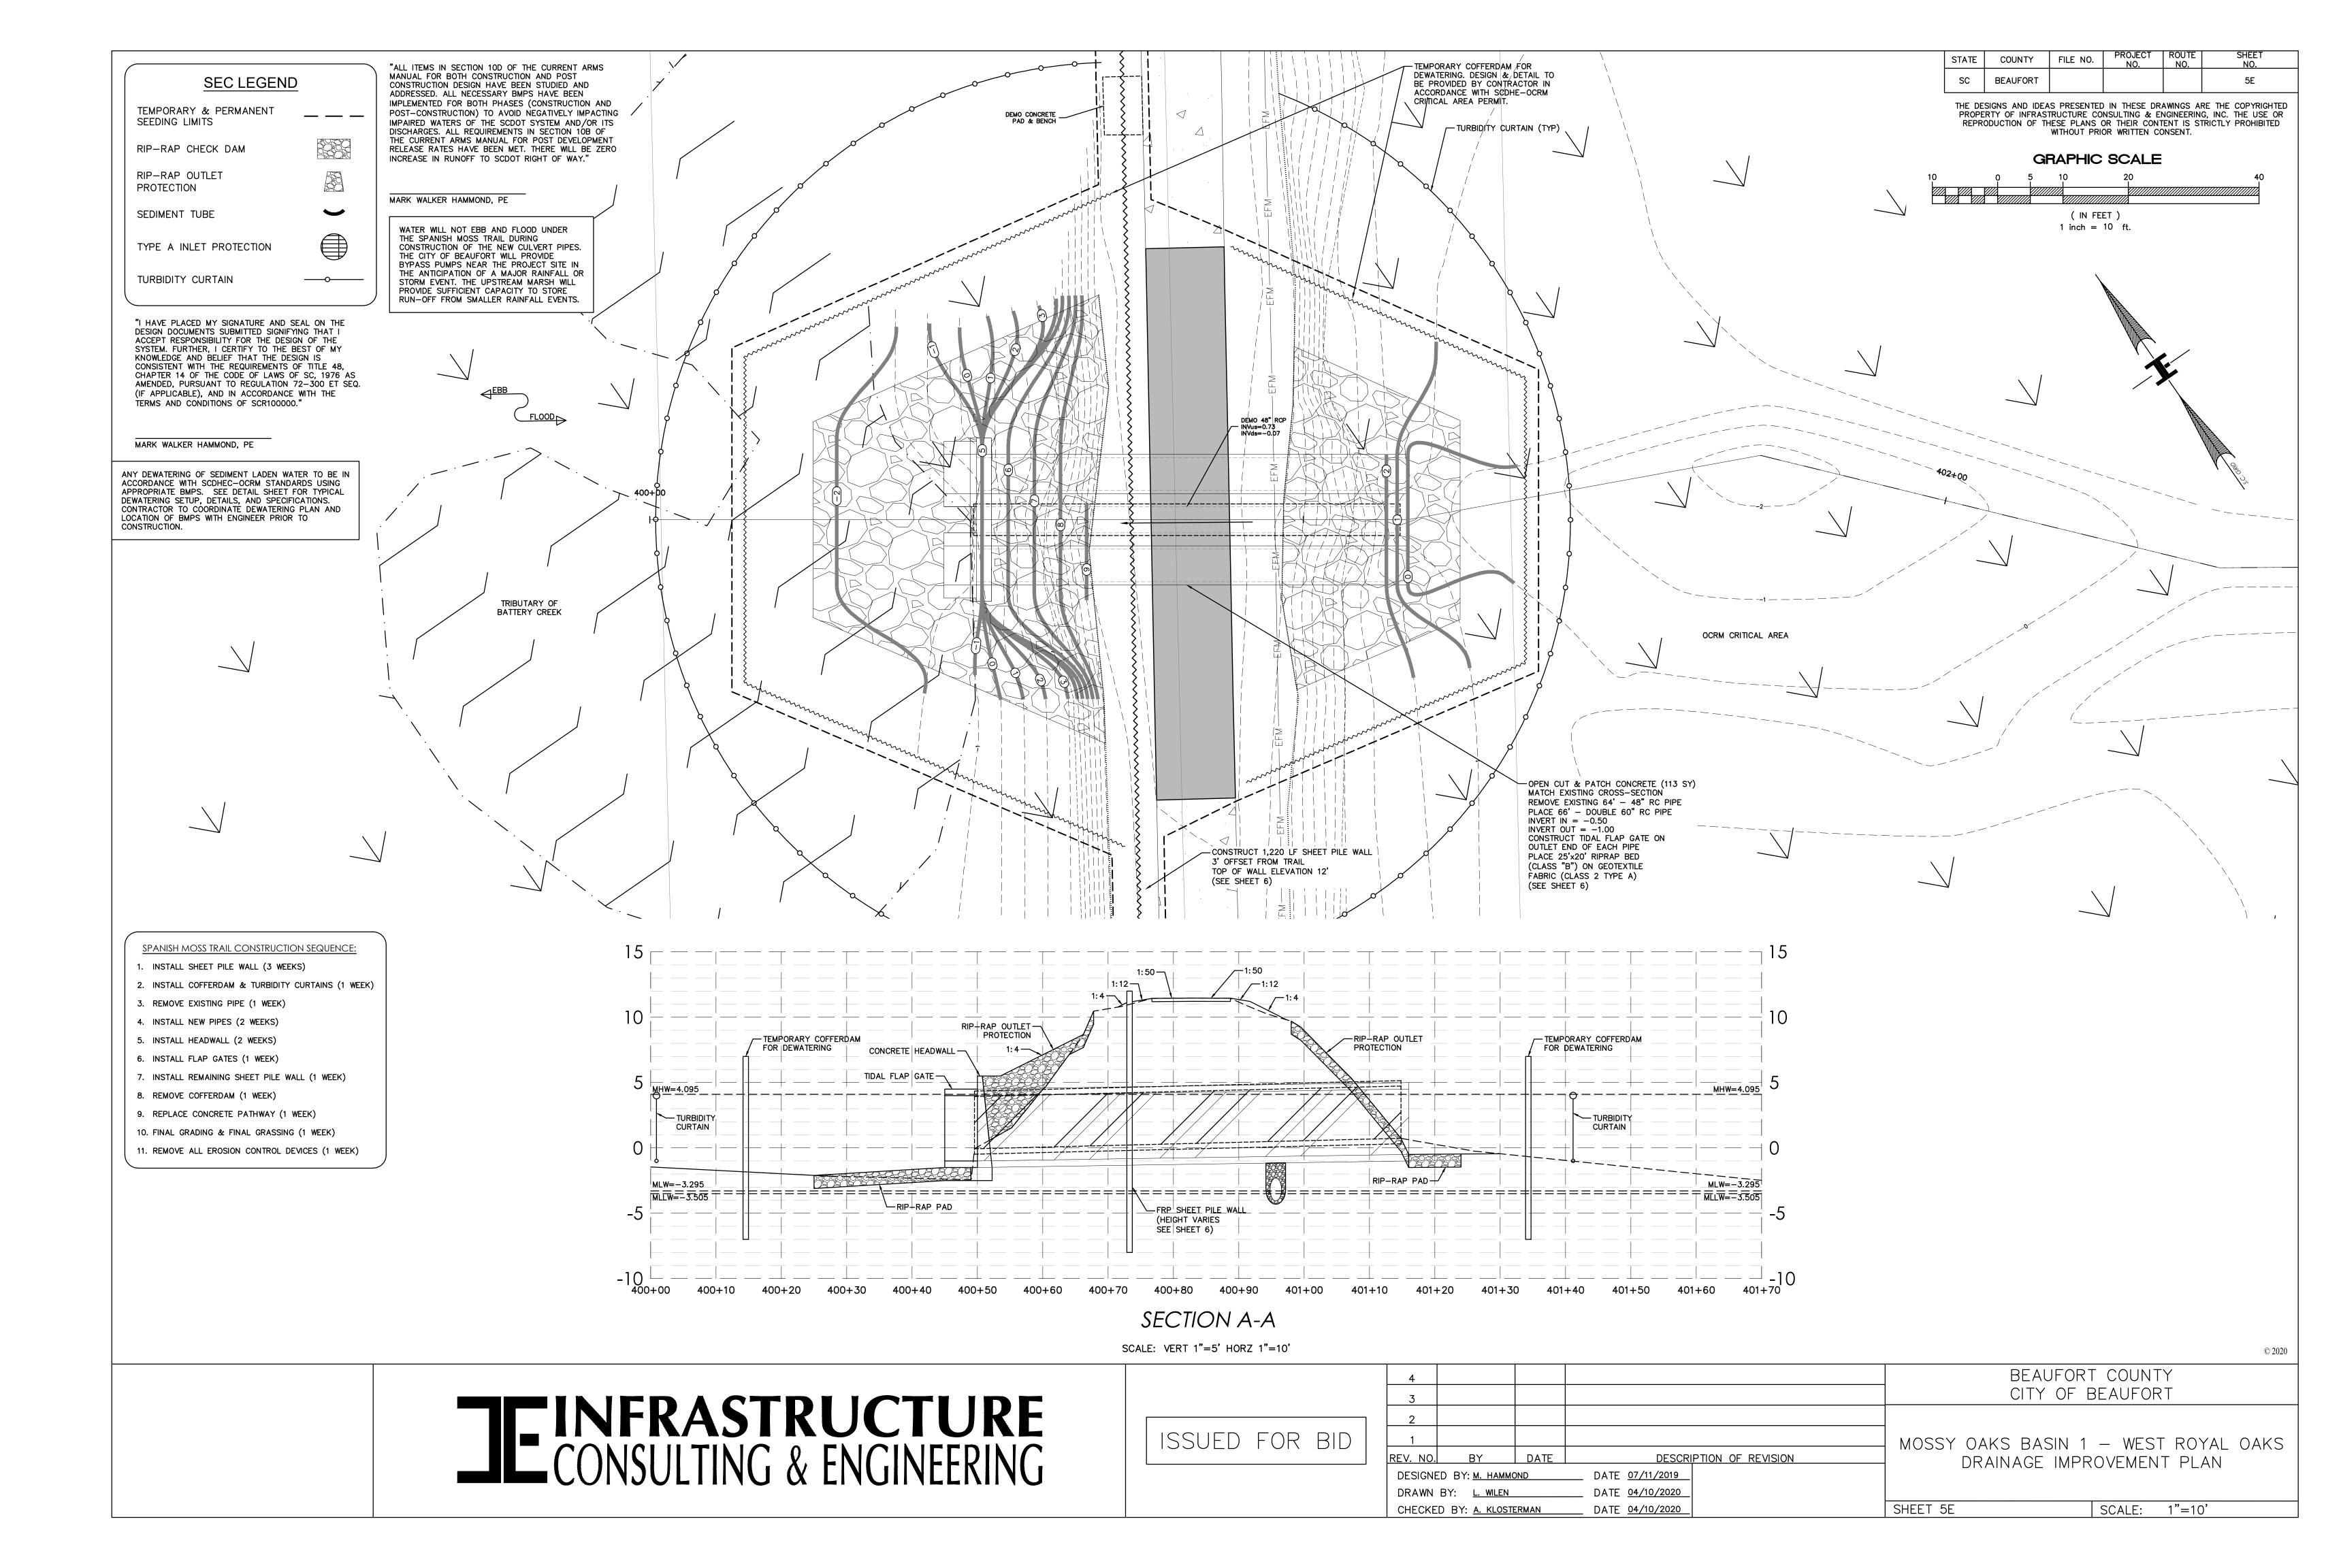

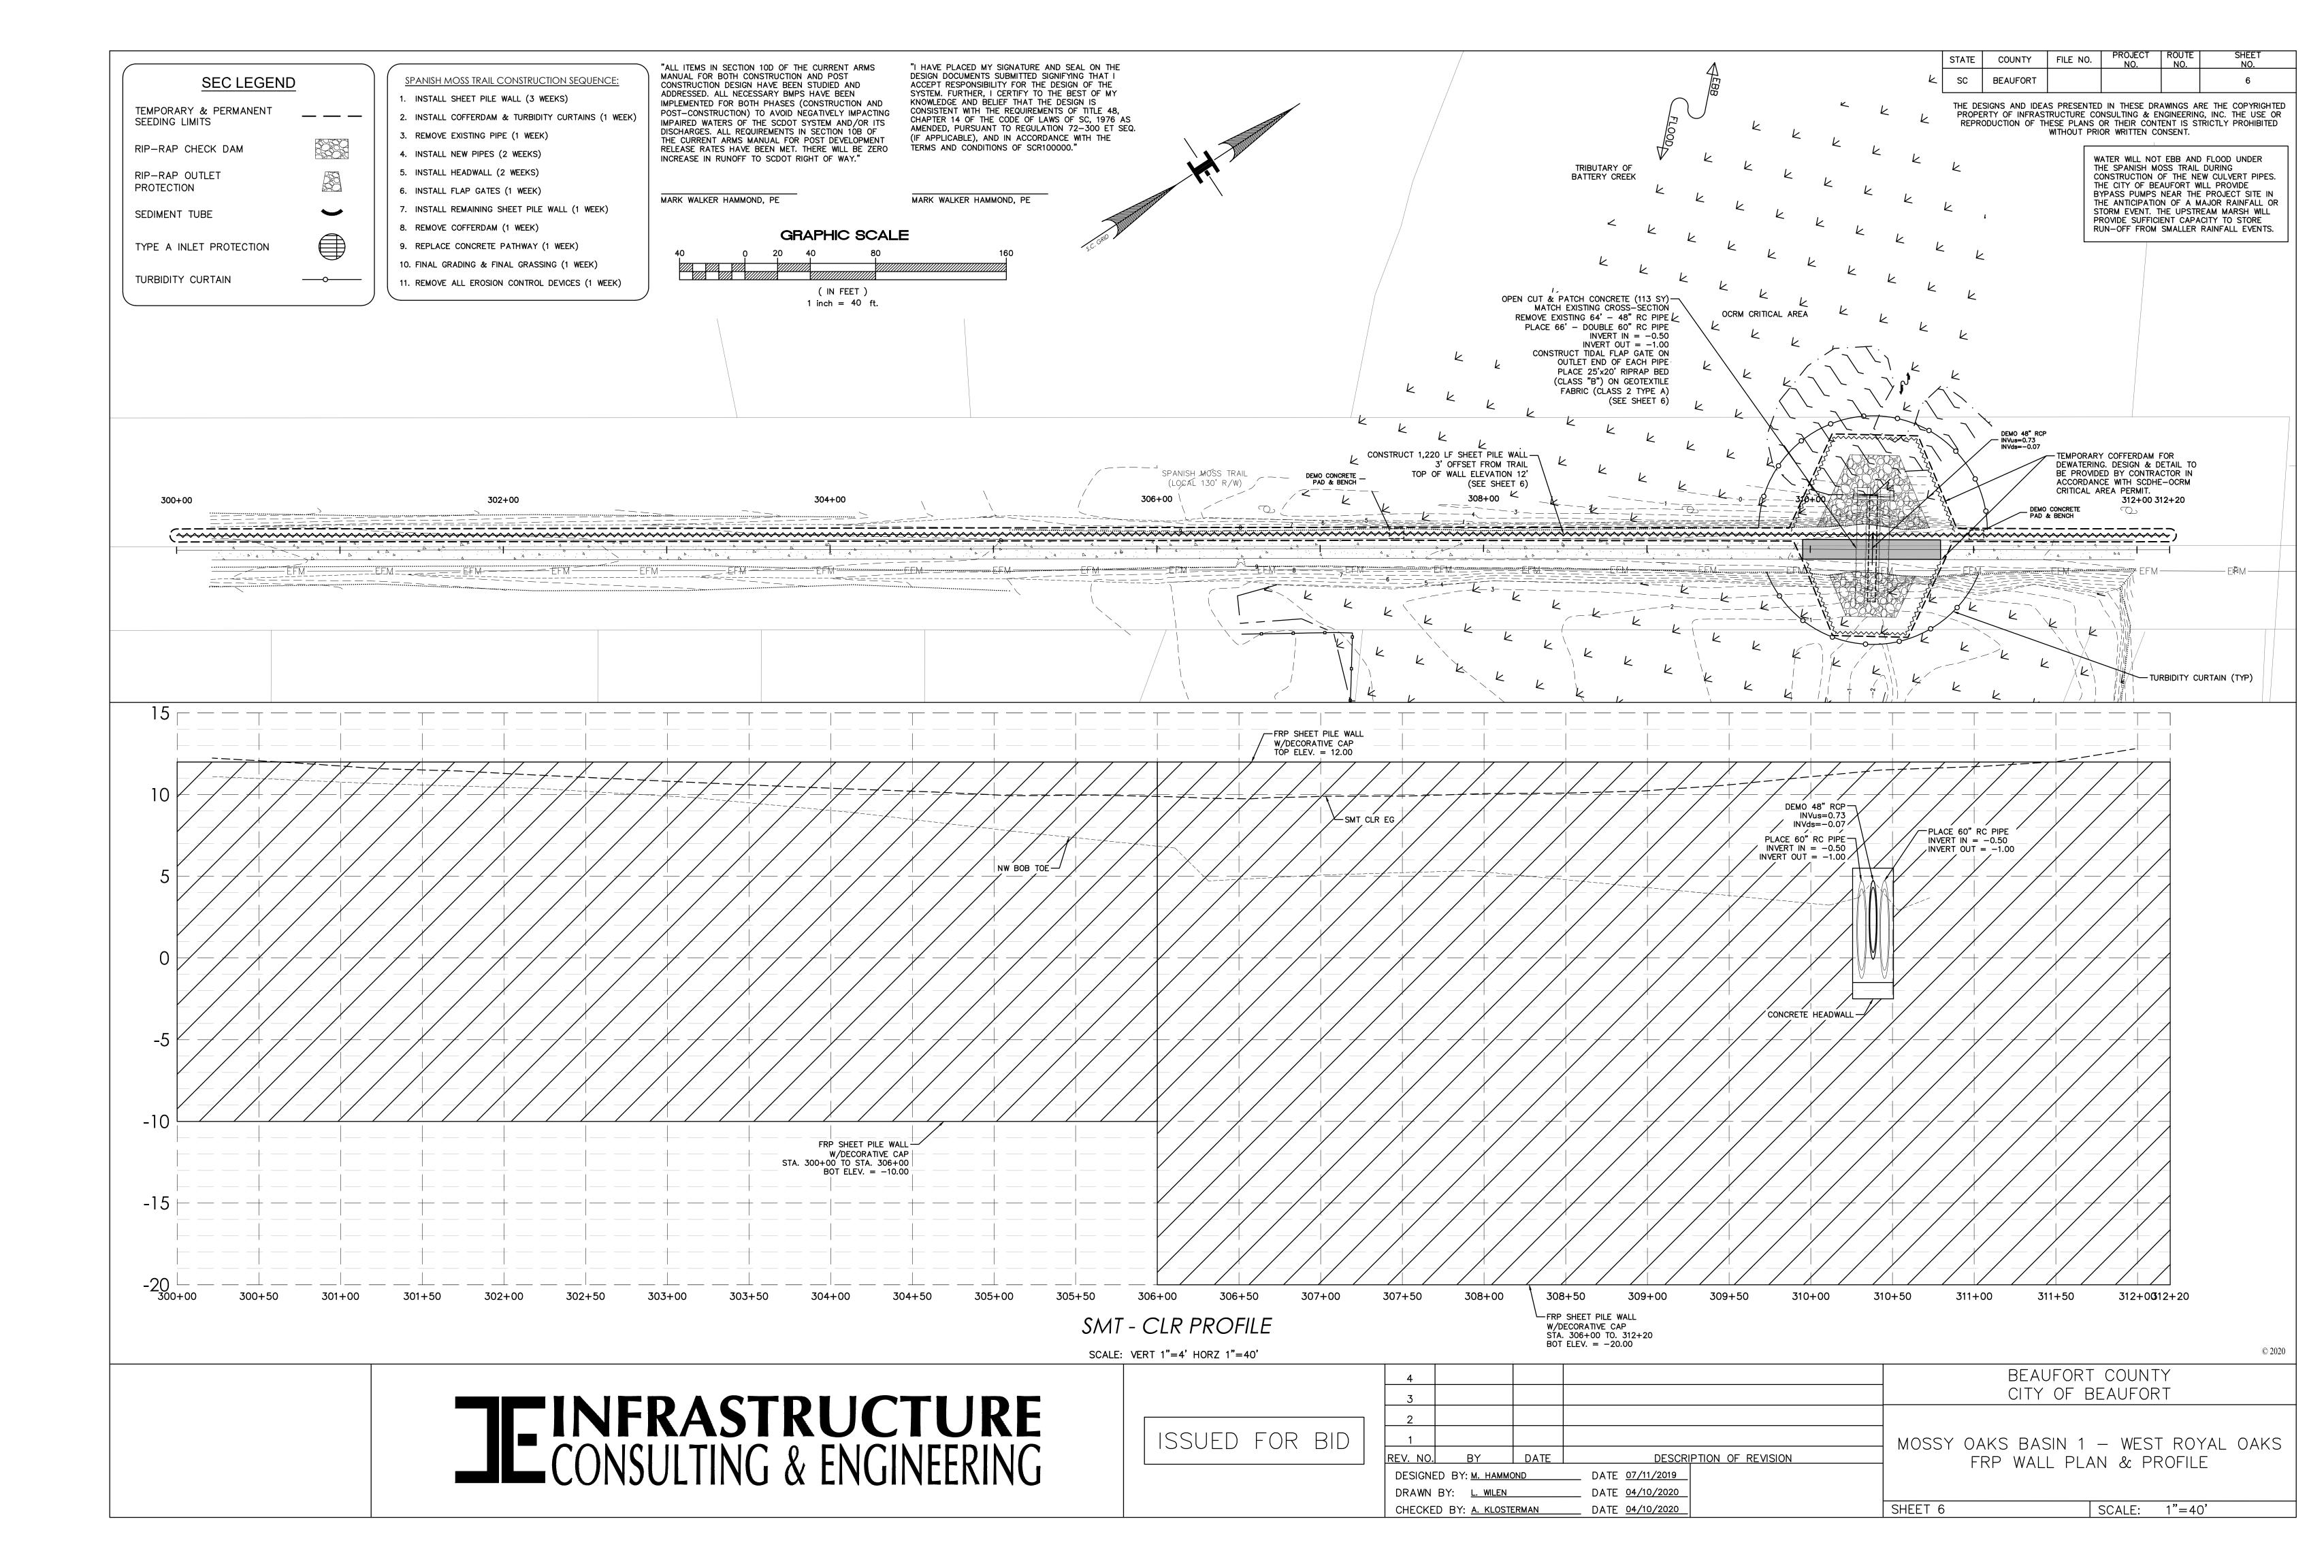

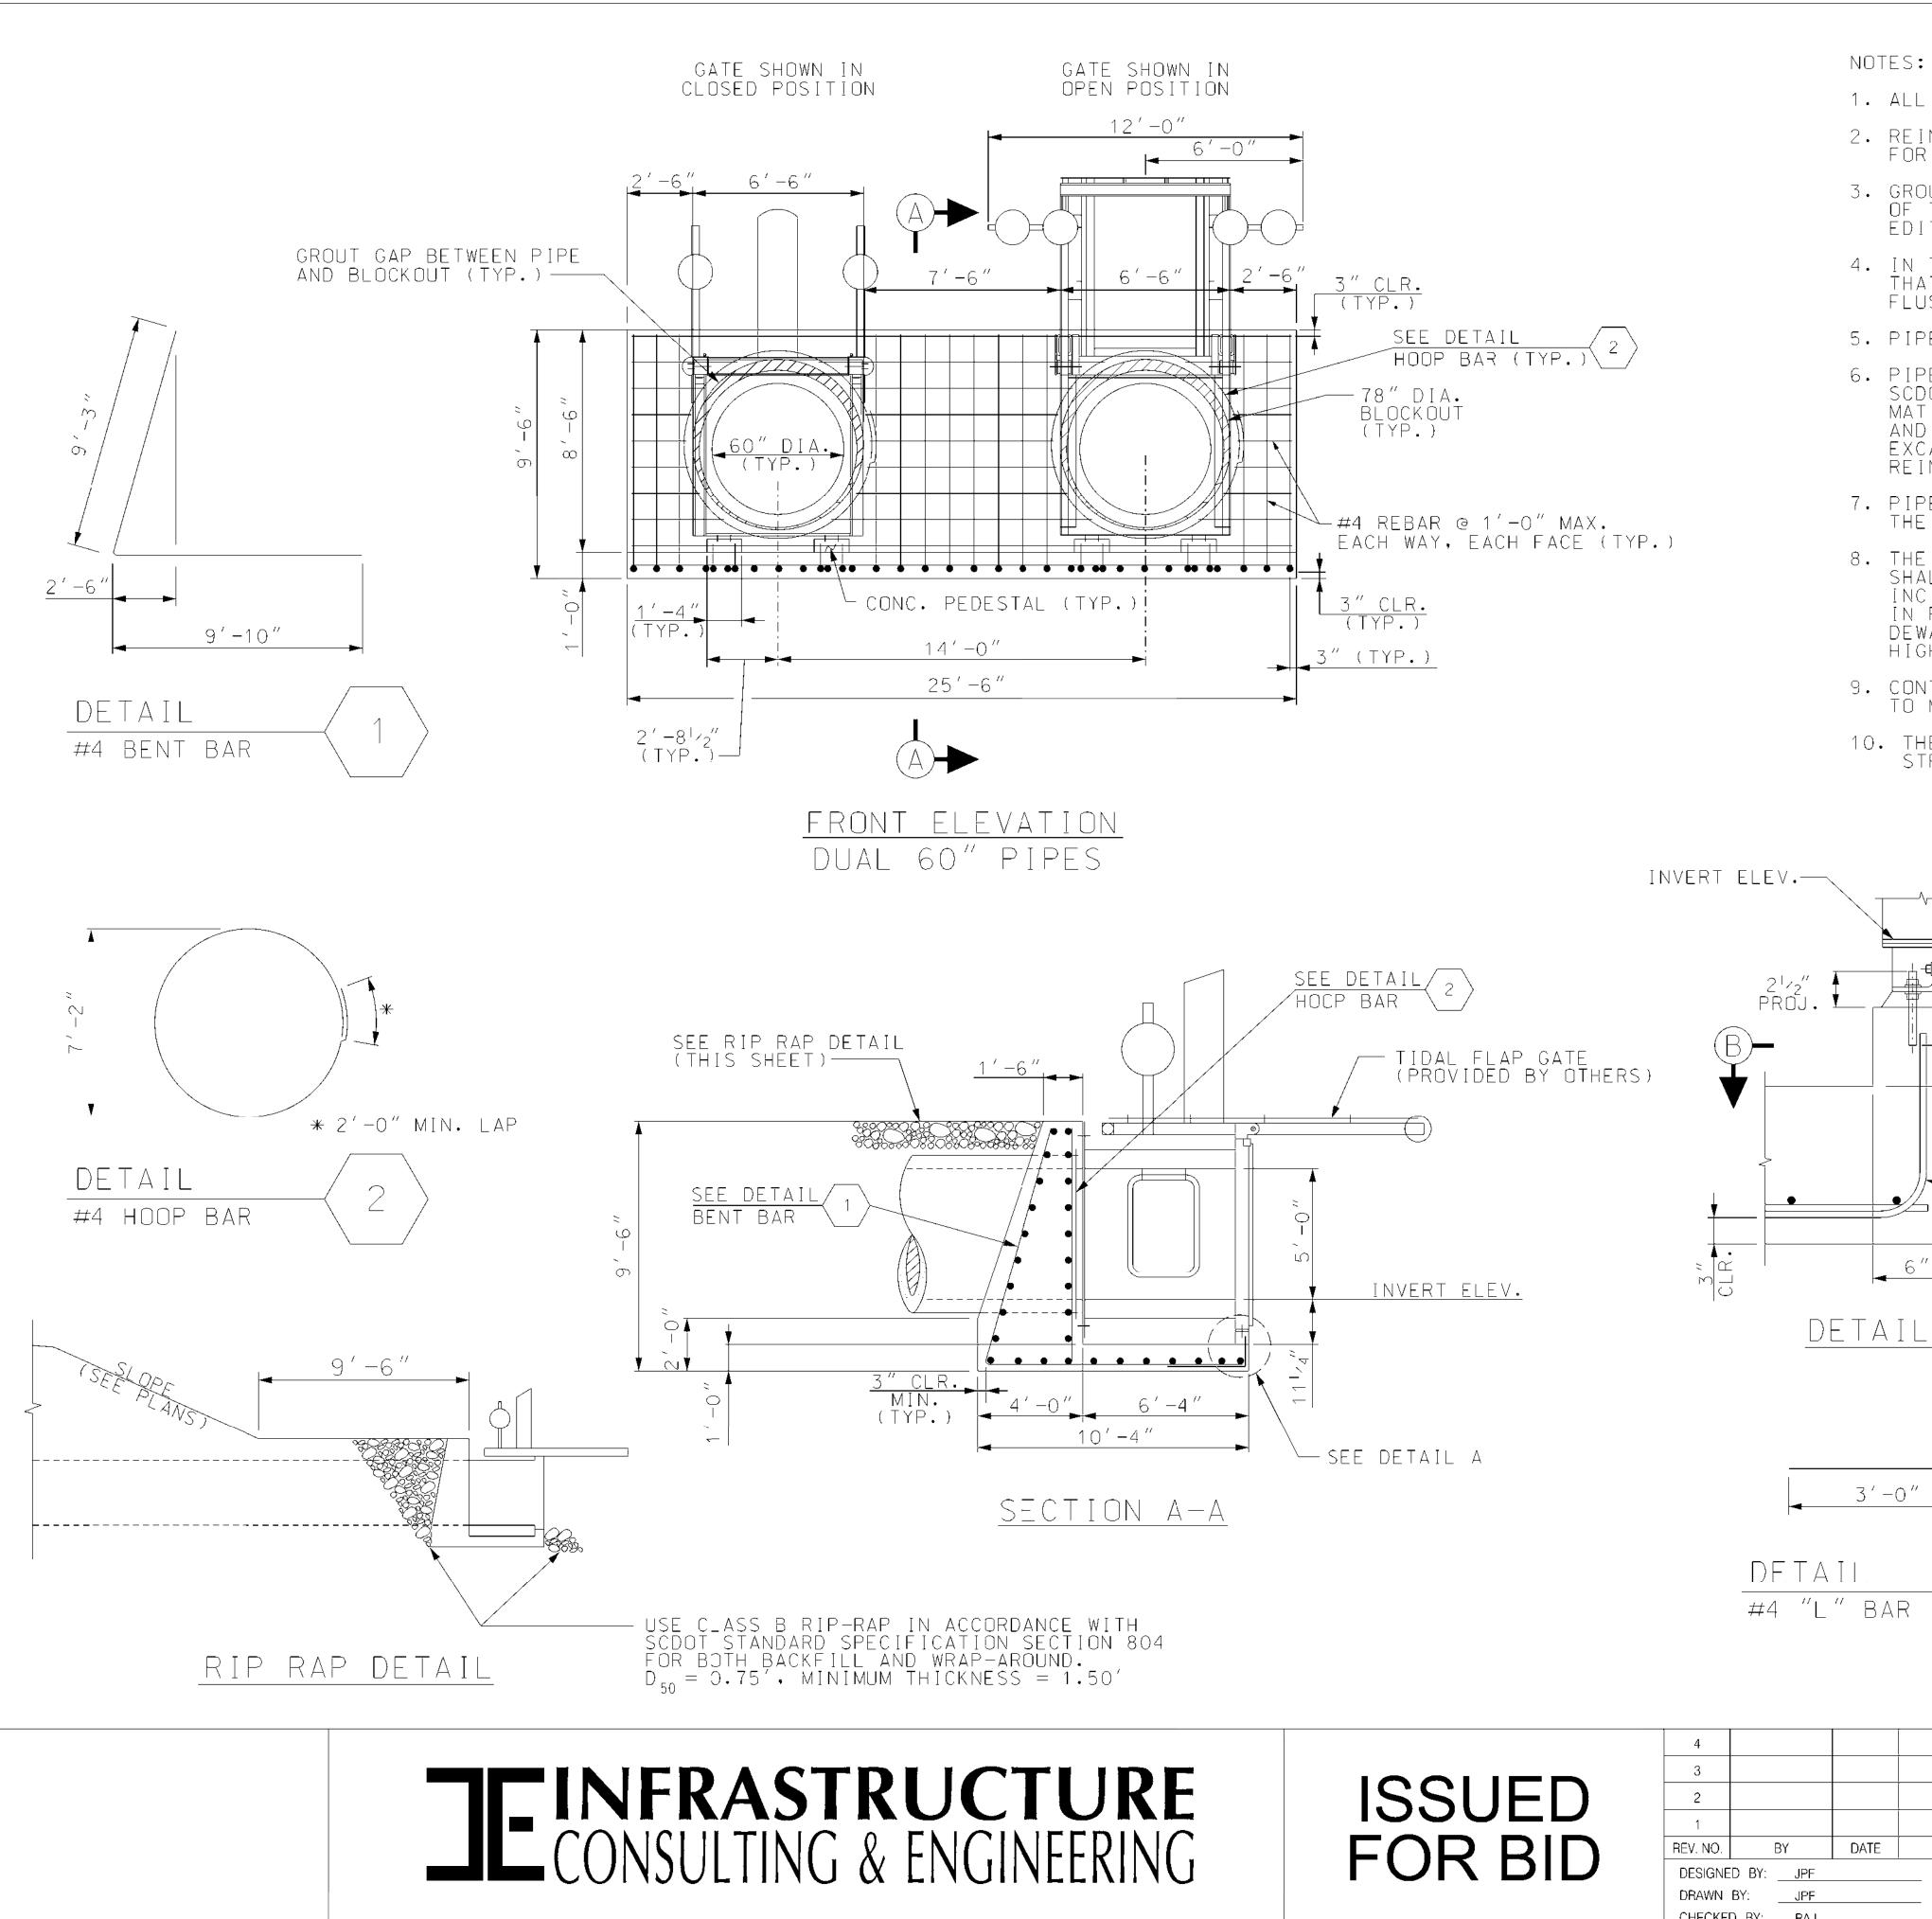



NOTES: 1. All concrete shall be cast-in-plac	CE (CLASS 4000).
2. REINFORCING STEEL SHALL BE ASTM A- for concrete reinforcement, grade	
3. GROUT SHALL BE TYPE M MORTAR MATER OF THE SCDOT STANDARD SPECIFICATI(EDITION).	RIAL IN ACCORDANCE WITH SECTION 718 DNS FOR HIGHWAY CONSTRUCTION (LATEST
4. IN THE EVENT THE HEADWALL IS SKEWE That protrudes beyond the exposed flush and grouted smooth with the	FACE OF THE HEADWALL SHALL BE CUT
5. PIPES SHALL BE GROUTED IN PLACE.	
6. PIPES AND HEADWALL SHALL BE BACKFI SCDOT STANDARD SPECIFICATIONS. TH MAT SUBGRADE. THE SUBGRADE SHALL AND BACKFILLED WITH WELL-GRADED SA EXCAVATION, PLACE MIRAFI HP270 GEO REINFORCEMENT AND SEPARATION.	HE CULVERTS SHALL BEAR ON A STONE BE EXCAVATED A MINIMUM OF 2 FEET
7. PIPE INVERTS SHALL BE SET IN ACCOP The spanish moss trail improvement ?.)	
8. THE CONTRACT UNIT PRICE FOR STRAID SHALL INCLUDE THE COST OF FURNISHI INCIDENTAL TO THE CONSTRUCTION OF IN PLACE AS SHOWN (INCLUDING CLASS	ING ALL MATERIALS AND WORK THE STRUCTURE COMPLETE AND 5 B RIP-RAP, TEMPORARY SHORING & 5 SCDOT STANDARD SPECIFICATIONS FOR
9. CONTRACTOR SHALL INSTALL TEMPORARY to maintain a dry, stable work env	
10. THE PAY ITEM SHALL BE: Straight concrete headwall (60" f	PIPE 2 LINES) — EACH
INVERT ELEV.	D
B - B	3 ANCHOR BOLT*
SEE DETAIL 3	
Image: minimum display="block"/> Image: minimum display="blo	
DETAIL A	
	<u>Section B-B</u>
BE BE	HOR BOLTS (PROVIDED BY OTHERS) SHALL INSTALLED USING HILTI HIT V3 ADHESIVE ECTION SYSTEM OR APPROVED EQUAL (TYP.)
DETAIL #4 "L" BAR 3	
4	BEAUFORT COUNTY CITY OF BEAUFORT
2 1 1 DATE DESCRIPTION OF REVISION	SPANISH MOSS TRAIL BASIN 1
REV. NO. BY DATE DESCRIPTION OF REVISION DESIGNED BY: JPF DATE 08/22/2019 DRAWN BY: JPF DATE 08/22/2019	HEADWALL DETAILS
CHECKED BY: RAJ DATE <u>08/22/2019</u>	SHEET SCALE: NTS

 DATE	08/22/2019
 DATE	<u>08/22/2019</u>

ROUTE NO. SPANISH WOSS TRAIL

SHEET NO.


7


PROJECT NO.

FILE NO.

STATE COUNTY

SC BEAUFORT

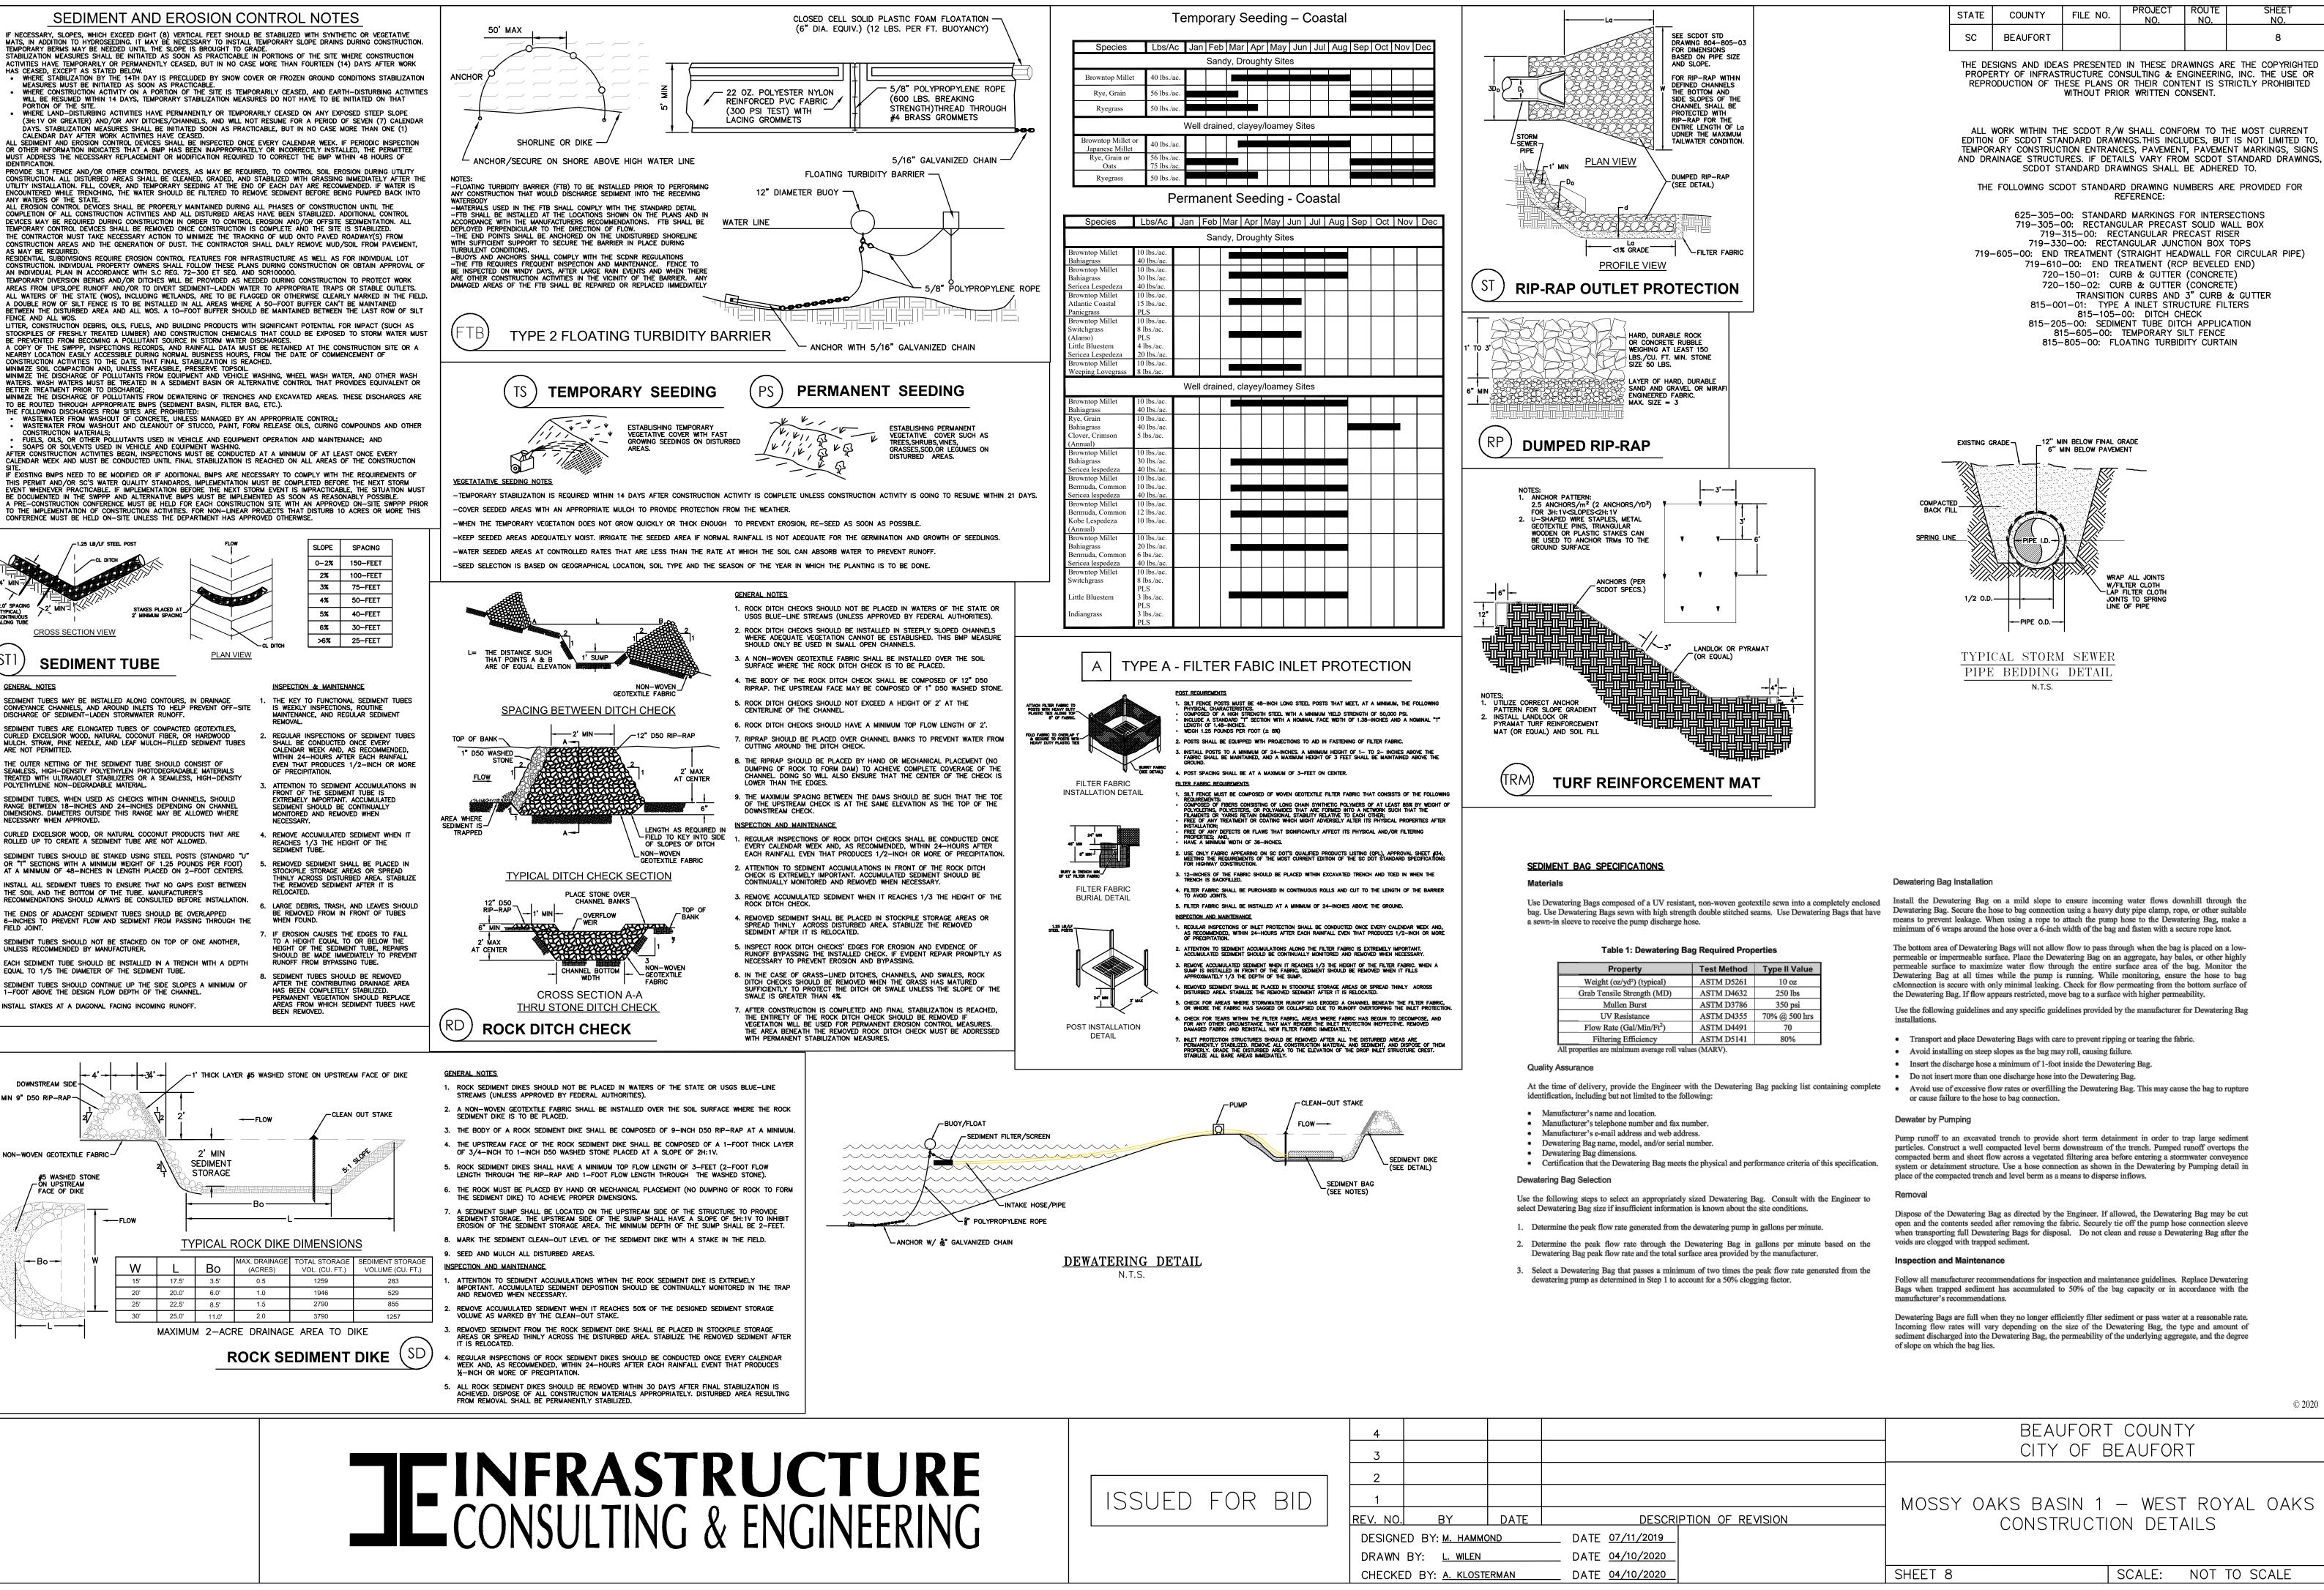

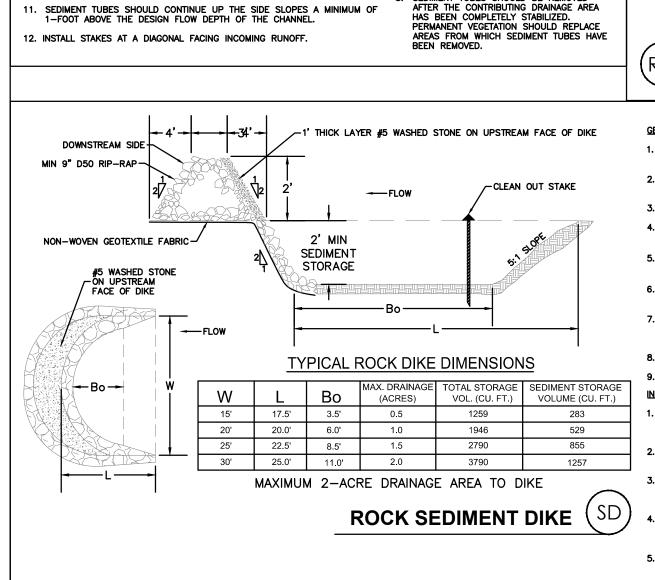

- ENCOUNTERED WHILE TRENCHING, THE WATER STOULD BE TREACTED TO TREACT TO TREACT THE STATE. ANY WATERS OF THE STATE. ALL EROSION CONTROL DEVICES SHALL BE PROPERLY MAINTAINED DURING ALL PHASES OF CONSTRUCTION UNTIL THE COMPLETION OF ALL CONSTRUCTION ACTIVITIES AND ALL DISTURBED AREAS HAVE BEEN STABILIZED. ADDITIONAL CONTROL DEVICES MAY BE REQUIRED DURING CONSTRUCTION IN ORDER TO CONTROL EROSION AND/OR OFFSITE SEDIMENTATION. ALL TEMPORARY CONTROL DEVICES SHALL BE REMOVED ONCE CONSTRUCTION IS COMPLETE AND THE SITE IS STABILIZED. CONSTRUCTION AREAS AND THE GENERATION OF DUST. THE CONTRACTOR SHALL DAILY REMOVE MUD/SOIL FROM PAVEMENT, AS MAY BE REQUIRED AS MAT BE REQUIRED. RESIDENTIAL SUBDIVISIONS REQUIRE EROSION CONTROL FEATURES FOR INFRASTRUCTURE AS WELL AS FOR INDIVIDUAL LOT CONSTRUCTION. INDIVIDUAL PROPERTY OWNERS SHALL FOLLOW THESE PLANS DURING CONSTRUCTION OR OBTAIN APPROVAL OF AN INDIVIDUAL PLAN IN ACCORDANCE WITH S.C REG. 72–300 ET SEQ. AND SCR100000. TEMPORARY DIVERSION BERMS AND/OR DITCHES WILL BE PROVIDED AS NEEDED DURING CONSTRUCTION TO PROTECT WORK AREAS FROM UPSLOPE RUNOFF AND/OR TO DIVERT SEDIMENT-LADEN WATER TO APPROPRIATE TRAPS OR STABLE OUTLETS ALL WATERS OF THE STATE (WOS), INCLUDING WETLANDS, ARE TO BE FLAGGED OR OTHERWISE CLEARLY MARKED IN THE FIELD. A DOUBLE ROW OF SILT FENCE IS TO BE INSTALLED IN ALL AREAS WHERE A 50-FOOT BUFFER CAN'T BE MAINTAINED BETWEEN THE DISTURBED AREA AND ALL WOS. A 10-FOOT BUFFER SHOULD BE MAINTAINED BETWEEN THE LAST ROW OF SILT FENCE AND ALL WOS. STOCKPILES OF FRESHLY TREATED LUMBER) AND CONSTRUCTION CHEMICALS THAT COULD BE EXPOSED TO STORM WATER MUST BE PREVENTED FROM BECOMING A POLLUTANT SOURCE IN STORM WATER DISCHARGES. BE PREVENIED FROM BECOMING A POLLUTANI SOURCE IN STIORM WATER DISCHARGES. A COPY OF THE SWPPP, INSPECTIONS RECORDS, AND RAINFALL DATA MUST BE RETAINED AT THE CONSTRUCTION SITE OR A NEARBY LOCATION EASILY ACCESSIBLE DURING NORMAL BUSINESS HOURS, FROM THE DATE OF COMMENCEMENT OF CONSTRUCTION ACTIVITIES TO THE DATE THAT FINAL STABILIZATION IS REACHED. MINIMIZE SOIL COMPACTION AND, UNLESS INFEASIBLE, PRESERVE TOPSOIL. MINIMIZE THE DISCHARGE OF POLLUTANTS FROM EQUIPMENT AND VEHICLE WASHING, WHEEL WASH WATER, AND OTHER WASH WATERS. WASH WATERS MUST BE TREATED IN A SEDIMENT BASIN OR ALTERNATIVE CONTROL THAT PROVIDES EQUIVALENT OR BETTER TMEATMENT PRIOR TO DISCHARGE: BETTER TREATMENT PRIOR TO DISCHARGE; MINIMIZE THE DISCHARGE OF POLLUTANTS FROM DEWATERING OF TRENCHES AND EXCAVATED AREAS. THESE DISCHARGES ARE TO BE ROUTED THROUGH APPROPRIATE BMPS (SEDIMENT BASIN, FILTER BAG, ETC.). THE FOLLOWING DISCHARGES FROM SITES ARE PROHIBITED: WASTEWATER FROM WASHOUT OF CONCRETE, UNLESS MANAGED BY AN APPROPRIATE CONTROL; WASTEWATER FROM WASHOUT AND CLEANOUT OF STUCCO, PAINT, FORM RELEASE OILS, CURING COMPOUNDS AND OTHER CONSTRUCTION MATERIALS:
- LITTER, CONSTRUCTION DEBRIS, OILS, FUELS, AND BUILDING PRODUCTS WITH SIGNIFICANT POTENTIAL FOR IMPACT (SUCH AS

IDENTIFICATION

CONFERENCE MUST BE HELD ON-SITE UNLESS THE DEPARTMENT HAS APPROVED OTHERWISE.

STAKES PLACED AT

-1.25 LB/LF STEEL POST

SEDIMENT TUBE

SEDIMENT TUBES MAY BE INSTALLED ALONG CONTOURS, IN DRAINAGE CONVEYANCE CHANNELS, AND AROUND INLETS TO HELP PREVENT OFF-SITE DISCHARGE OF SEDIMENT-LADEN STORMWATER RUNOFF.

SEDIMENT TUBES ARE ELONGATED TUBES OF COMPACTED GEOTEXTILES, CURLED EXCELSIOR WOOD, NATURAL COCONUT FIBER, OR HARDWOOD MULCH. STRAW, PINE NEEDLE, AND LEAF MULCH-FILLED SEDIMENT TUBES

THE OUTER NETTING OF THE SEDIMENT TUBE SHOULD CONSIST OF SEAMLESS, HIGH-DENSITY POLYETHYLEN PHOTODEGRADABLE MATERIALS TREATED WITH ULTRAVIOLET STABILIZERS OR A SEAMLESS, HIGH-DENSITY

SEDIMENT TUBES, WHEN USED AS CHECKS WITHIN CHANNELS, SHOULD RANGE BETWEEN 18-INCHES AND 24-INCHES DEPENDING ON CHANNEL DIMENSIONS. DIAMETERS OUTSIDE THIS RANGE MAY BE ALLOWED WHERE

CURLED EXCELSIOR WOOD, OR NATURAL COCONUT PRODUCTS THAT ARE ROLLED UP TO CREATE A SEDIMENT TUBE ARE NOT ALLOWED.

SEDIMENT TUBES SHOULD BE STAKED USING STEEL POSTS (STANDARD "U" AT A MINIMUM OF 48-INCHES IN LENGTH PLACED ON 2-FOOT CENTERS.

INSTALL ALL SEDIMENT TUBES TO ENSURE THAT NO GAPS EXIST BETWEEN

THE SOIL AND THE BOTTOM OF THE TUBE. MANUFACTURER'S RECOMMENDATIONS SHOULD ALWAYS BE CONSULTED BEFORE INSTALLATION.

THE ENDS OF ADJACENT SEDIMENT TUBES SHOULD BE OVERLAPPED 6-INCHES TO PREVENT FLOW AND SEDIMENT FROM PASSING THROUGH THE

SEDIMENT TUBES SHOULD NOT BE STACKED ON TOP OF ONE ANOTHER, UNLESS RECOMMENDED BY MANUFACTURER.

10. EACH SEDIMENT TUBE SHOULD BE INSTALLED IN A TRENCH WITH A DEPTH

EQUAL TO 1/5 THE DIAMETER OF THE SEDIMENT TUBE.

2.0' SPACING (TYPICAL) CONTINUOUS ALONG TUBE

GENERAL NOTES

2' MIN-1 '


ECESSARY WHEN APPROVED.

CROSS SECTION VIEW

- 8. IF EXISTING BMPS NEED TO BE MODIFIED OR IF ADDITIONAL BMPS ARE NECESSARY TO COMPLY WITH THE REQUIREMENTS OF
- THIS PERMIT AND/OR SC'S WATER QUALITY STANDARDS, IMPLEMENTATION MUST BE COMPLETED BEFORE THE NEXT STORM EVENT WHENEVER PRACTICABLE. IF IMPLEMENTATION BEFORE THE NEXT STORM EVENT IS IMPRACTICABLE, THE SITUATION MUST BE DOCUMENTED IN THE SWPPP AND ALTERNATIVE BMPS MUST BE IMPLEMENTED AS SOON AS REASONABLY POSSIBLE.
- A PRE-CONSTRUCTION CONFERENCE MUST BE HELD FOR EACH CONSTRUCTION SITE WITH AN APPROVED ON-SITE SWPPP PRIOR TO THE IMPLEMENTATION OF CONSTRUCTION ACTIVITIES. FOR NON-LINEAR PROJECTS THAT DISTURB 10 ACRES OR MORE THIS

PLAN VIEW

- CL DITCH

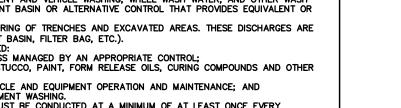



Property	Test Method	Type II Value
Weight (oz/yd²) (typical)	ASTM D5261	10 oz
rab Tensile Strength (MD)	ASTM D4632	250 lbs
Mullen Burst	ASTM D3786	350 psi
UV Resistance	ASTM D4355	70% @ 500 hrs
Flow Rate (Gal/Min/Ft ²)	ASTM D4491	70
Filtering Efficiency	ASTM D5141	80%
etias ara minimum azoraga rall za	Ines (MADI)	

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BASIN 1 – WEST ROYAL OAKS


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DESCRIPTION OF REVISION		
ATE 07/11/2019		CON
ATE <u>04/10/2020</u>		
ATE <u>04/10/2020</u>	SHEET 8	



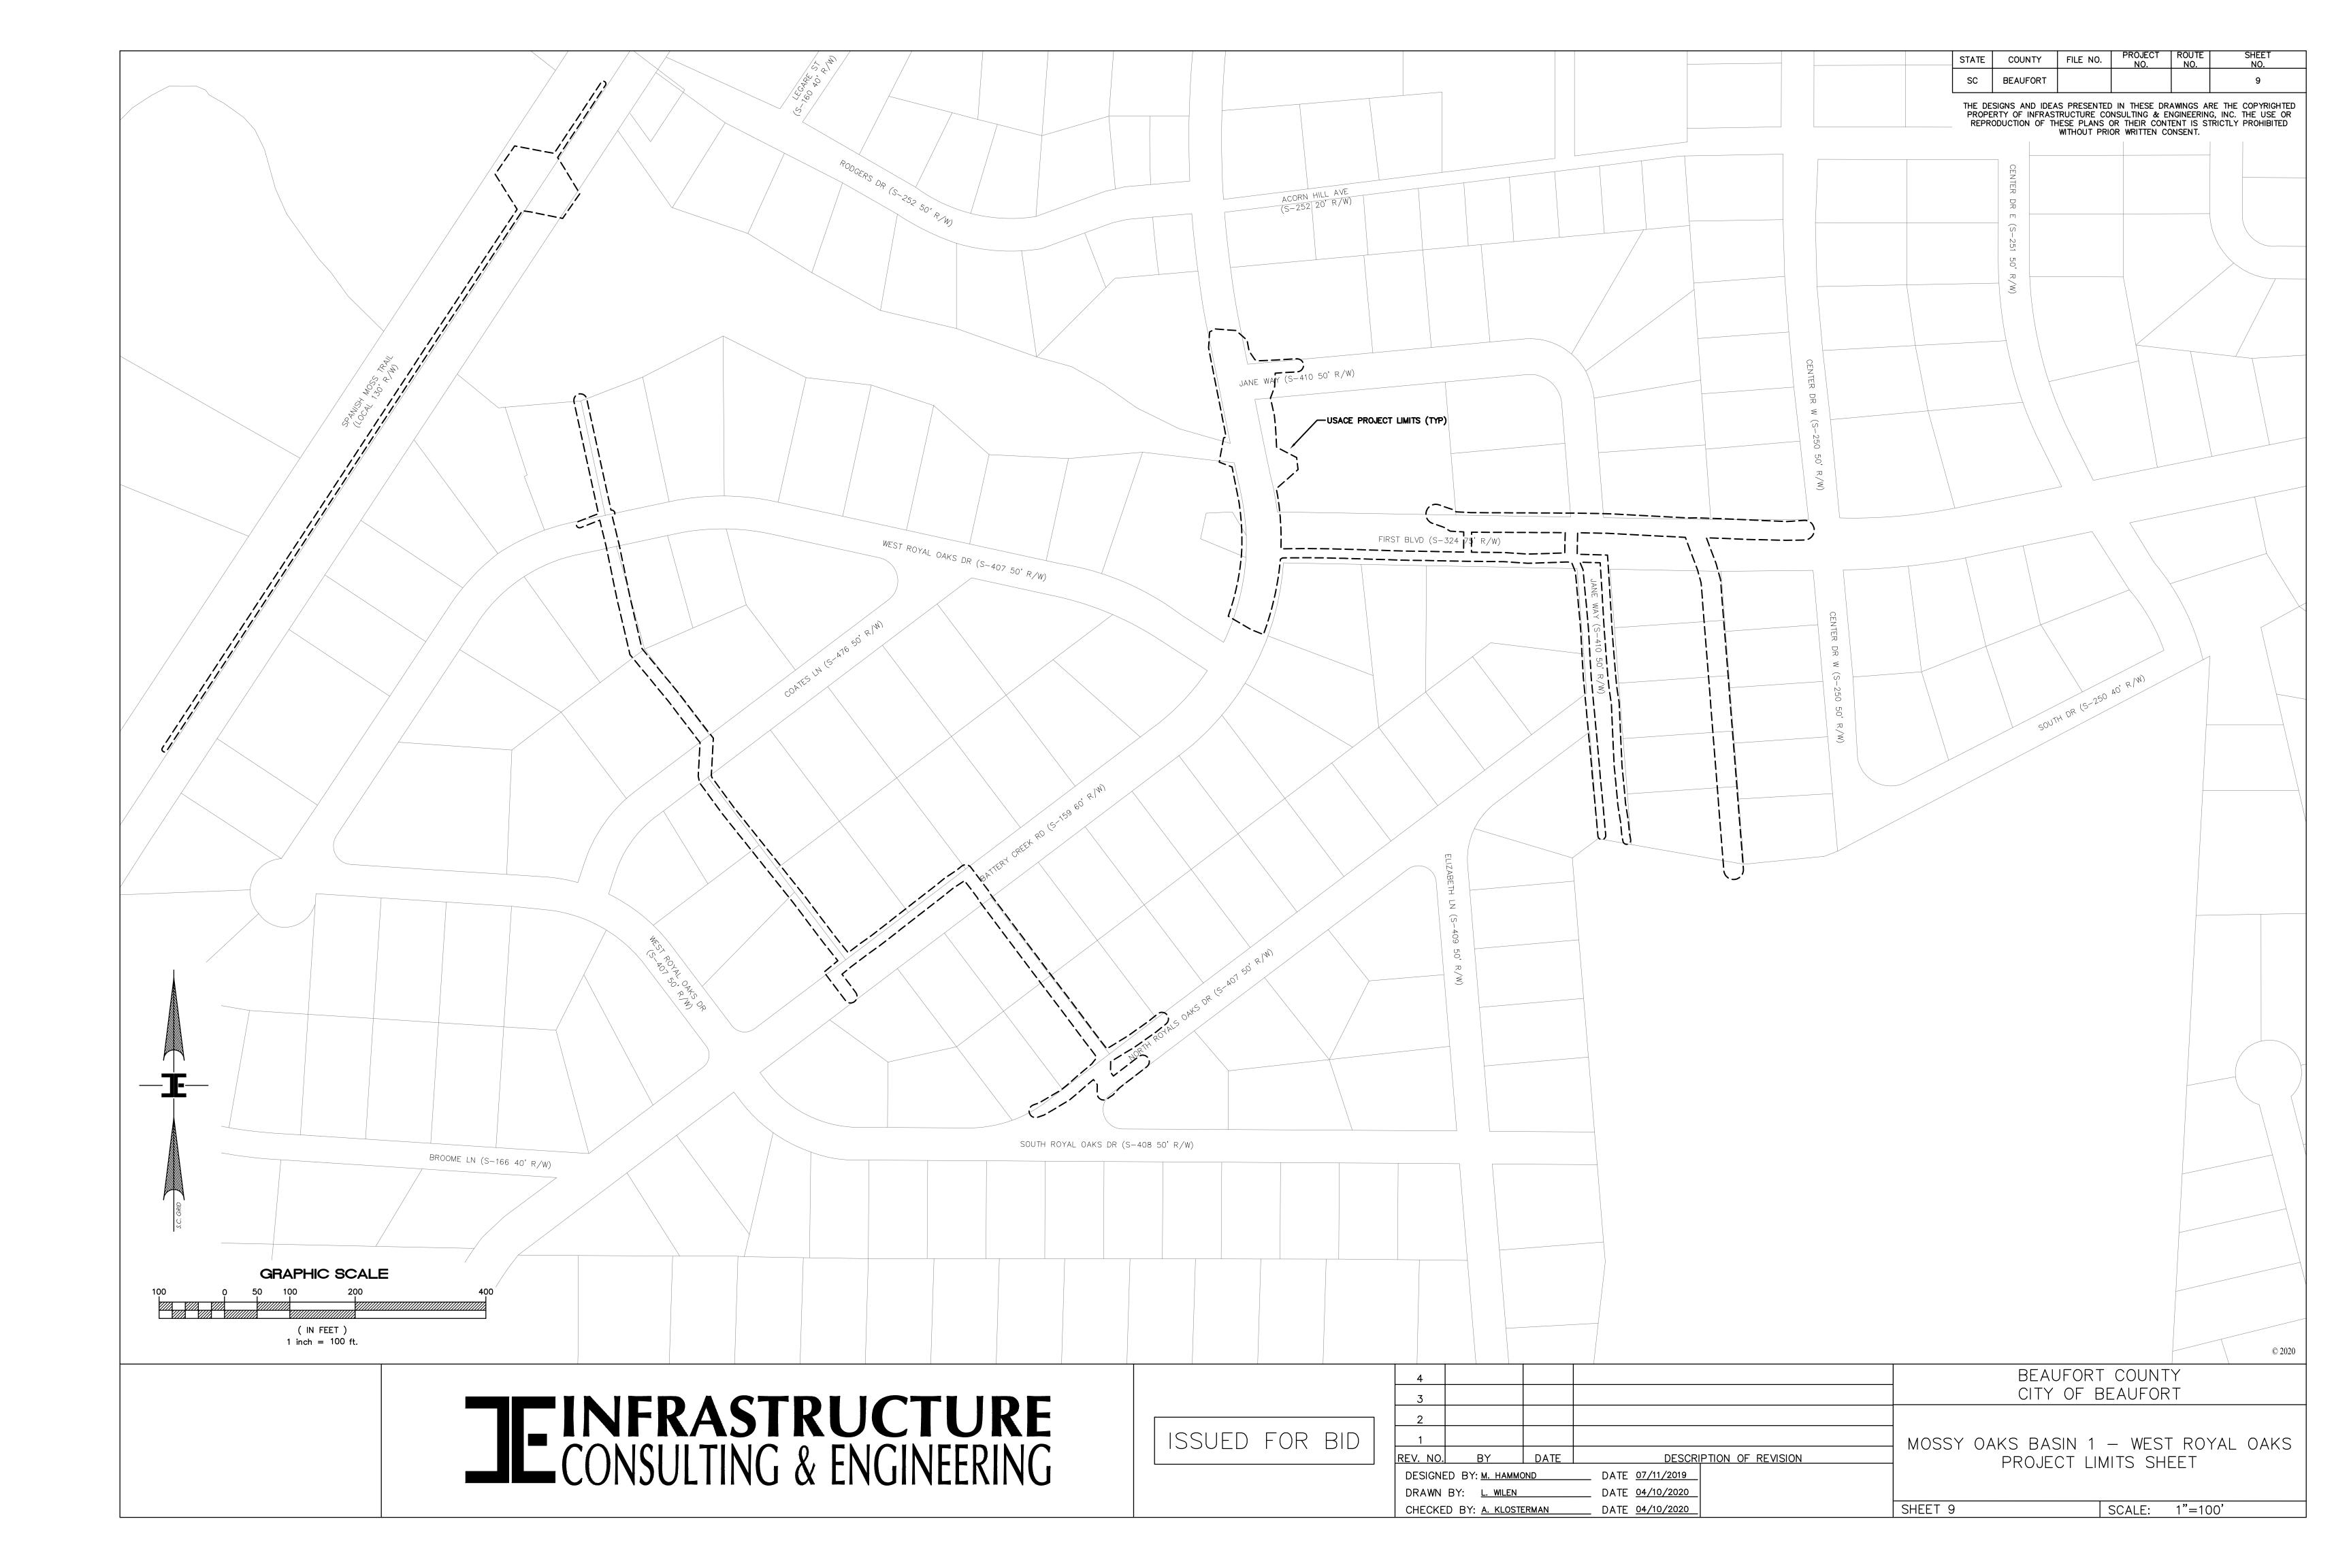

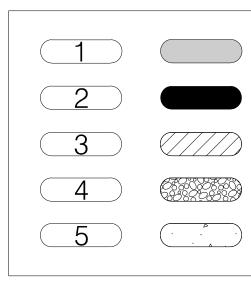EXISTING_GROUND

EXISTING PAVEMENT – RETAIN HOT MIX ASPHALT SURFACE COURSE TYPE C (150 PSY) HOT MIX ASPHALT INTERMEDIATE COURSE TYPE B (200 PSY) HOT MIX ASPHALT BASE COURSE TYPE B (400 PSY) CONCRETE SIDEWALK (4" UNIFORM)

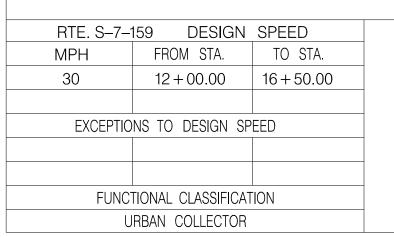





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TYPICAL SECTION

STATE	COUNTY	FILE NO.	PROJECT NO.	ROUTE NO.	SHEET NO.
SC	BEAUFORT			S–7–159	9

EXISTING GROUND $1/7 \equiv 1/7 \equiv 1/7$
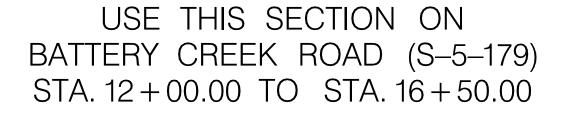
> BEAUFORT COUNTY CITY OF BEAUFORT

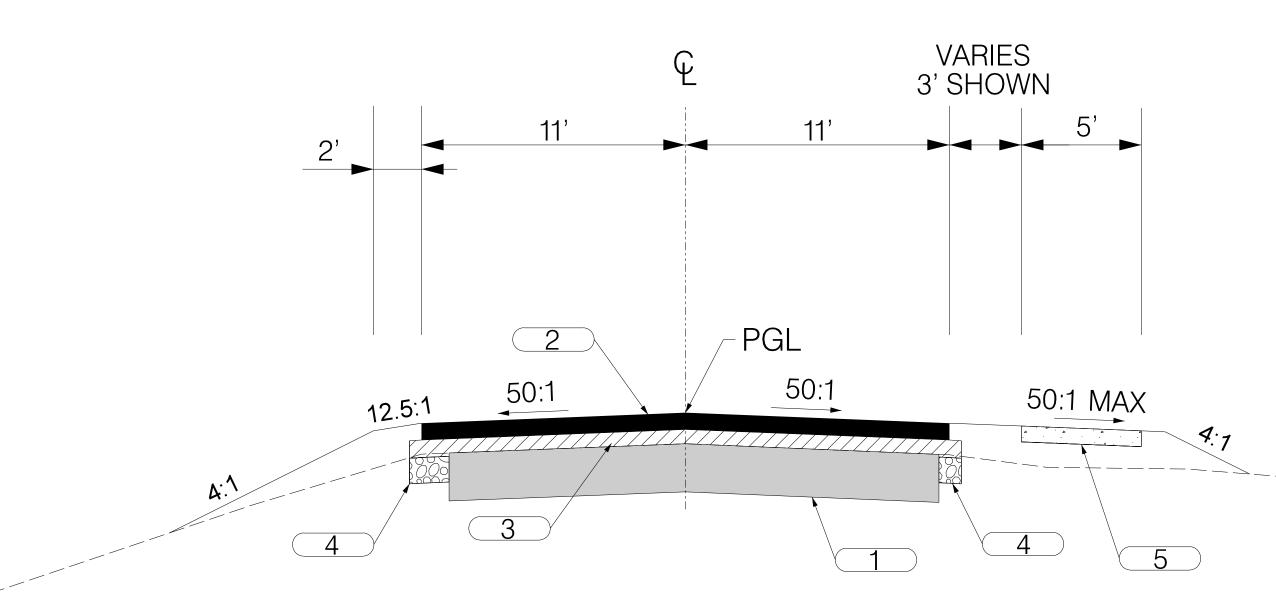BATTERY CREEK ROAD (S-7-159) BASIN 1 TYPICAL SECTION SHEET

DESCRIPTION OF REVISION

____ DATE <u>08/22/2019</u> ____ DATE <u>08/22/2019</u> ____ DATE <u>08/22/2019</u>

SHEET 9

CT					OBTA	NN		REMAINDER	REMAINDER					DRAINAGE	FROSION	ENTRANCE			
ст •	PROPERTY OWNER	TAX MAP REFERENCE	TOTAL TRACT ACRES	OUTFALL DITCH ACRES	LEFT	RIGHT	TOTAL	ACRES	REMAINDER RIGHT ACRES	DATE ACQUIRED	TYPE OF INSTRUMENT	OUTFALL DITCH PERMISSION (YES)	SLOPE PERMISSION (YES)	DRAINAGE STRUCTURE PERMISSION (YES)	EROSION CONTROL PERMISSION (YES)	CONSTRUCTION PERMISSION (YES)	R	EMARKS	
SHERRY N	M. HYLAND HALL	R120 006 000 0230 0000	X.XX																
SHIRLEY L	L. KUMPF	R120 006 000 0229 0000	X.XX																
HAL G. H	IORTON, JR. AND JANET C. HORTON	R120 006 000 0291 0000	X.XX												YES				
BJWSA		R120 006 000 290A 0000	1.00																
CITY OF E	BEAUFORT	R120 006 000 0324 0000	1.04																
RONALD	L. VOEGELI AND SANDRA G. VOEGELI	R120 006 000 324A 0000	1.00																
KATHERIN	NE H. PIERCE	R120 006 000 0254 0000	x.xx										YES		YES				
RENEE T.	. MULVIHILL	R120 006 000 0228 0000	x.xx																
																			= NOTES:
																			TOTAL OBTAIN INCLUDES MARSH AND OUTFALL DIT
																			OBTAINS WILL BE SHOWN SQUARE FEET AND ACRE
																			OBTAINS WILL BE SHOWN SQUARE FEET AND ACRES WILL BE SHOWN IN PAREN UNDER SQUARE FEET.IN AREAS OBTAINS MAY BE
																			IN ACRES ONLY. OUTFAL WILL BE SHOWN IN ACRE
																			SHOW REMAINDER IN SQL FEET WHEN LESS THAN
																			ACRE.
							-					4 3						BEAUFOR CITY OF	T COUNTY BEAUFORT
		INFR	AS	IKU		UK	E		ISSI	JFD		2							K ROAD (S–7–159)



RIGHT OF WAY DATA SHEET

LCONSULTING & ENGINEERING




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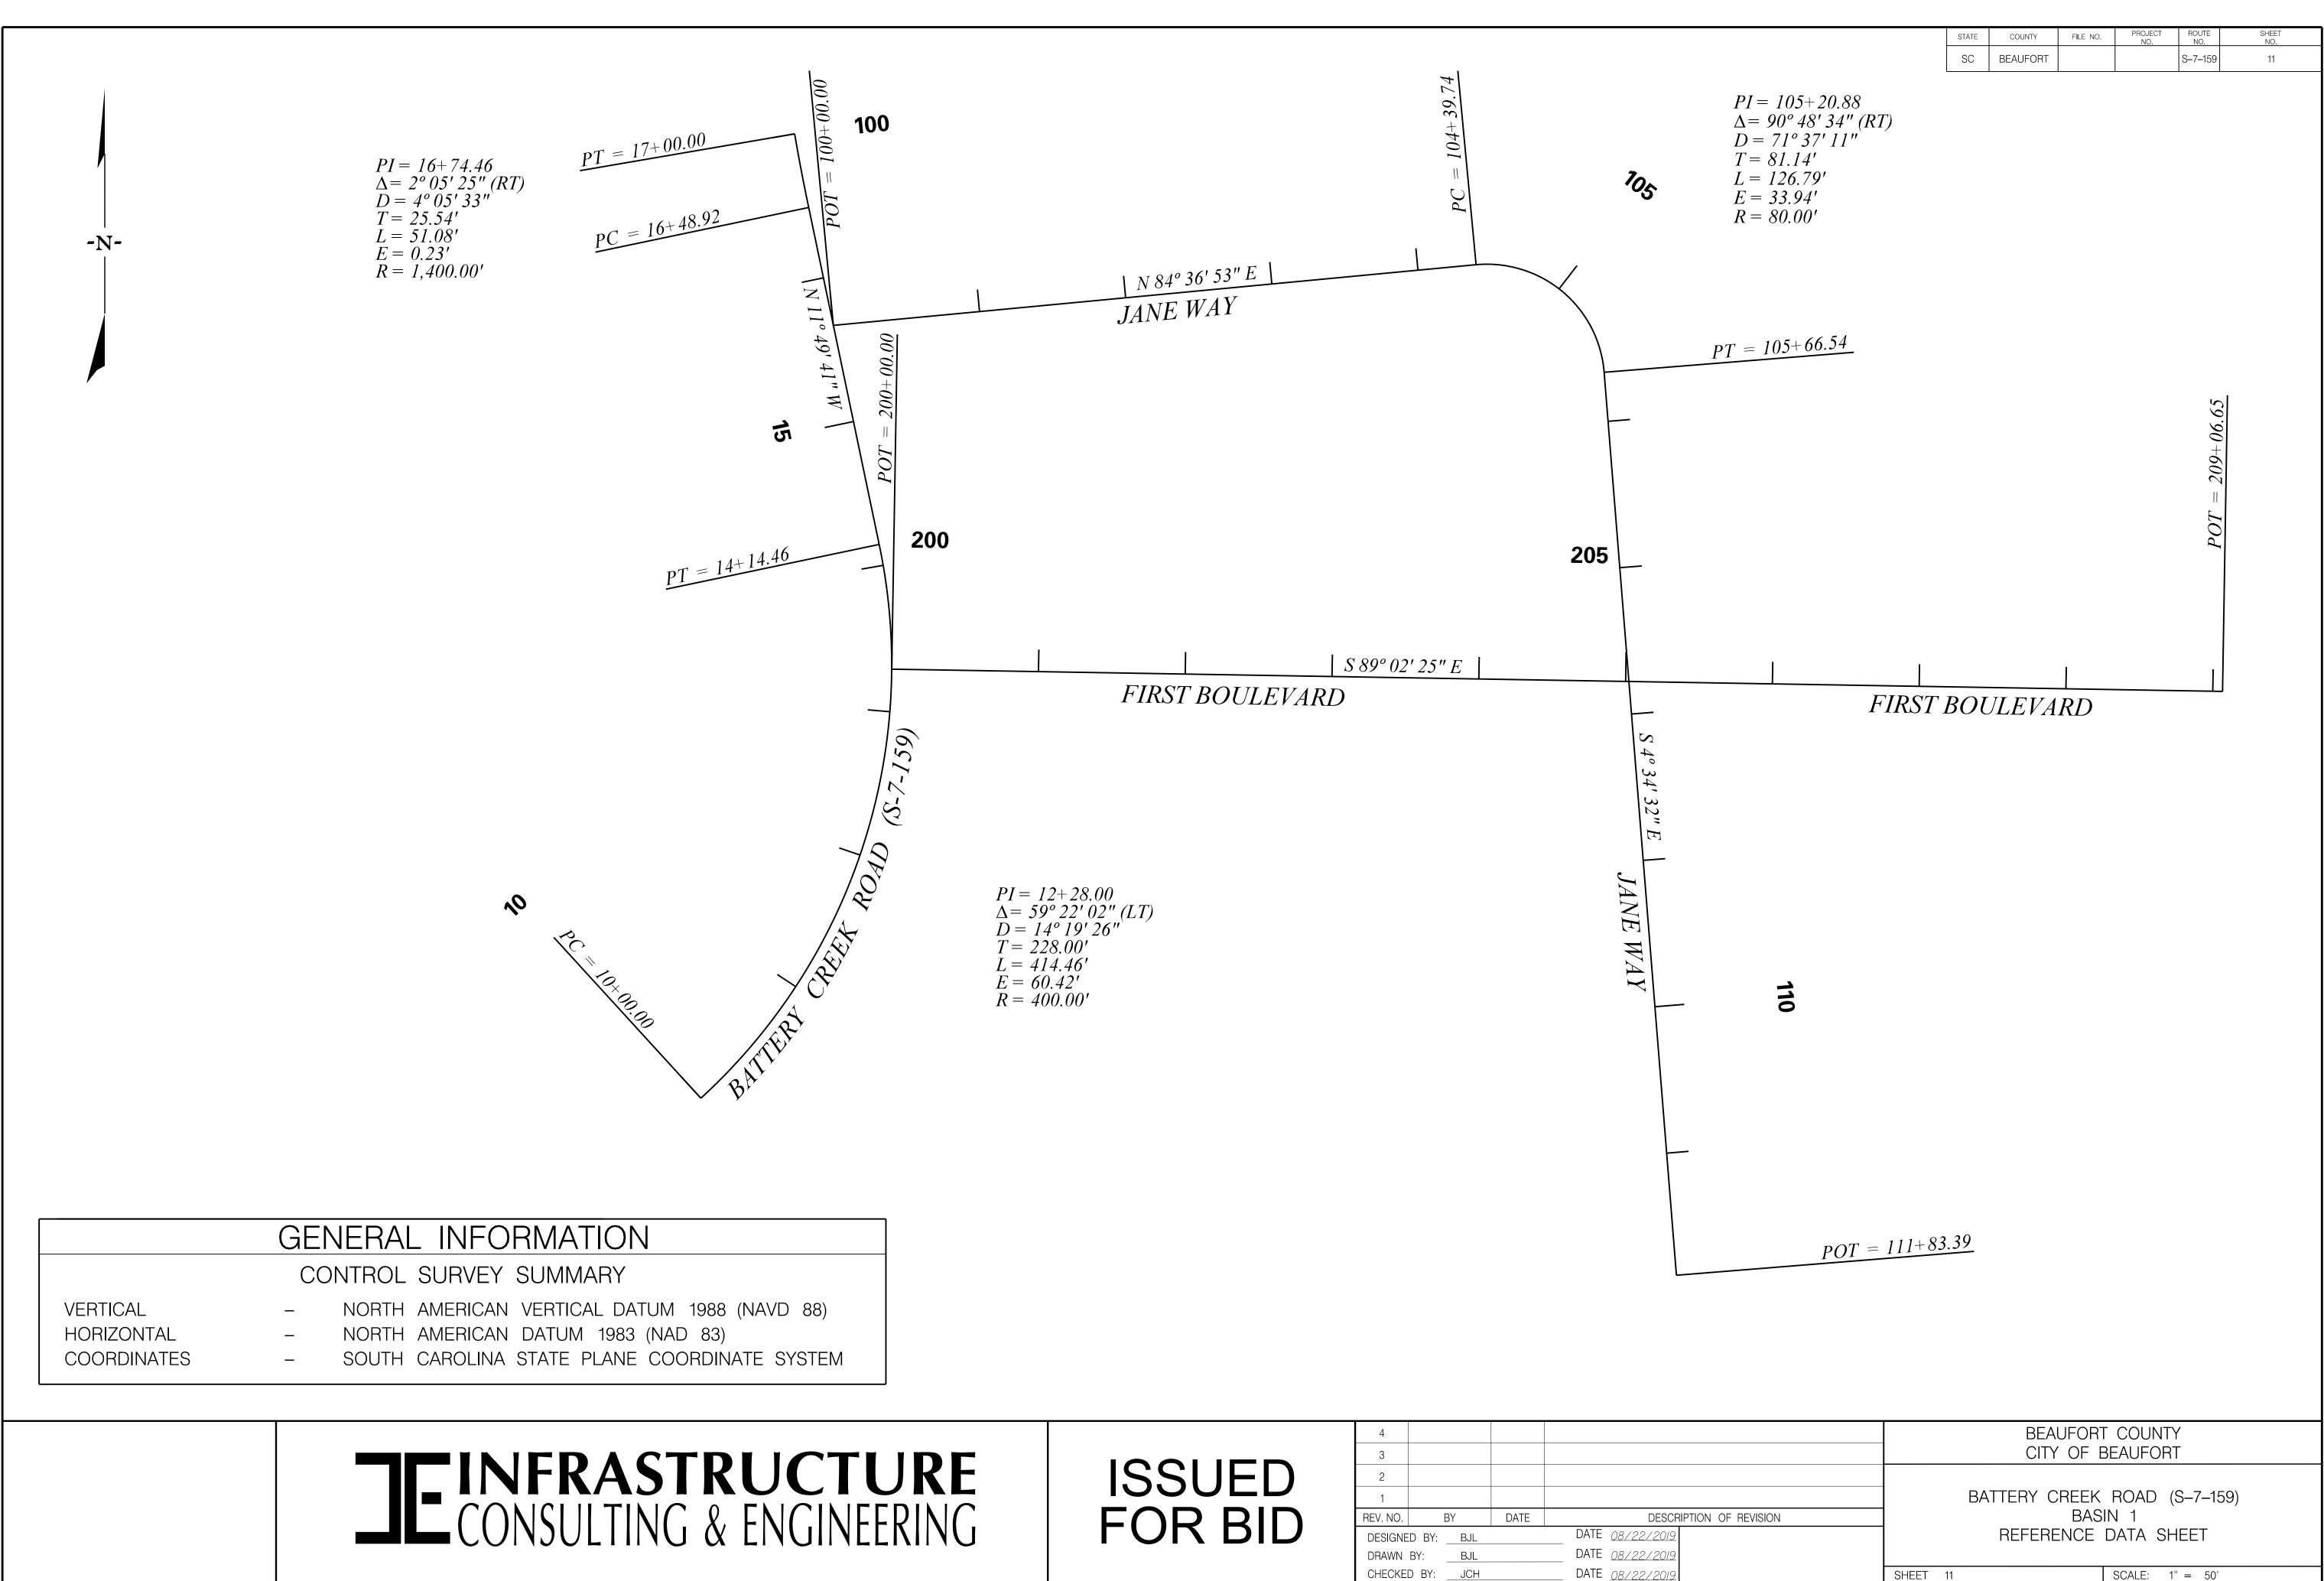
STATE	COUNTY	FILE NO.	PROJECT NO.	ROUTE NO.	SHEET NO.
SC	BEAUFORT			S–7–159	10

BATTERY CREEK ROAD (S–7–159) BASIN 1 RIGHT OF WAY DATA SHEET


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DATE	08/22/2019


DESCRIPTION OF REVISION



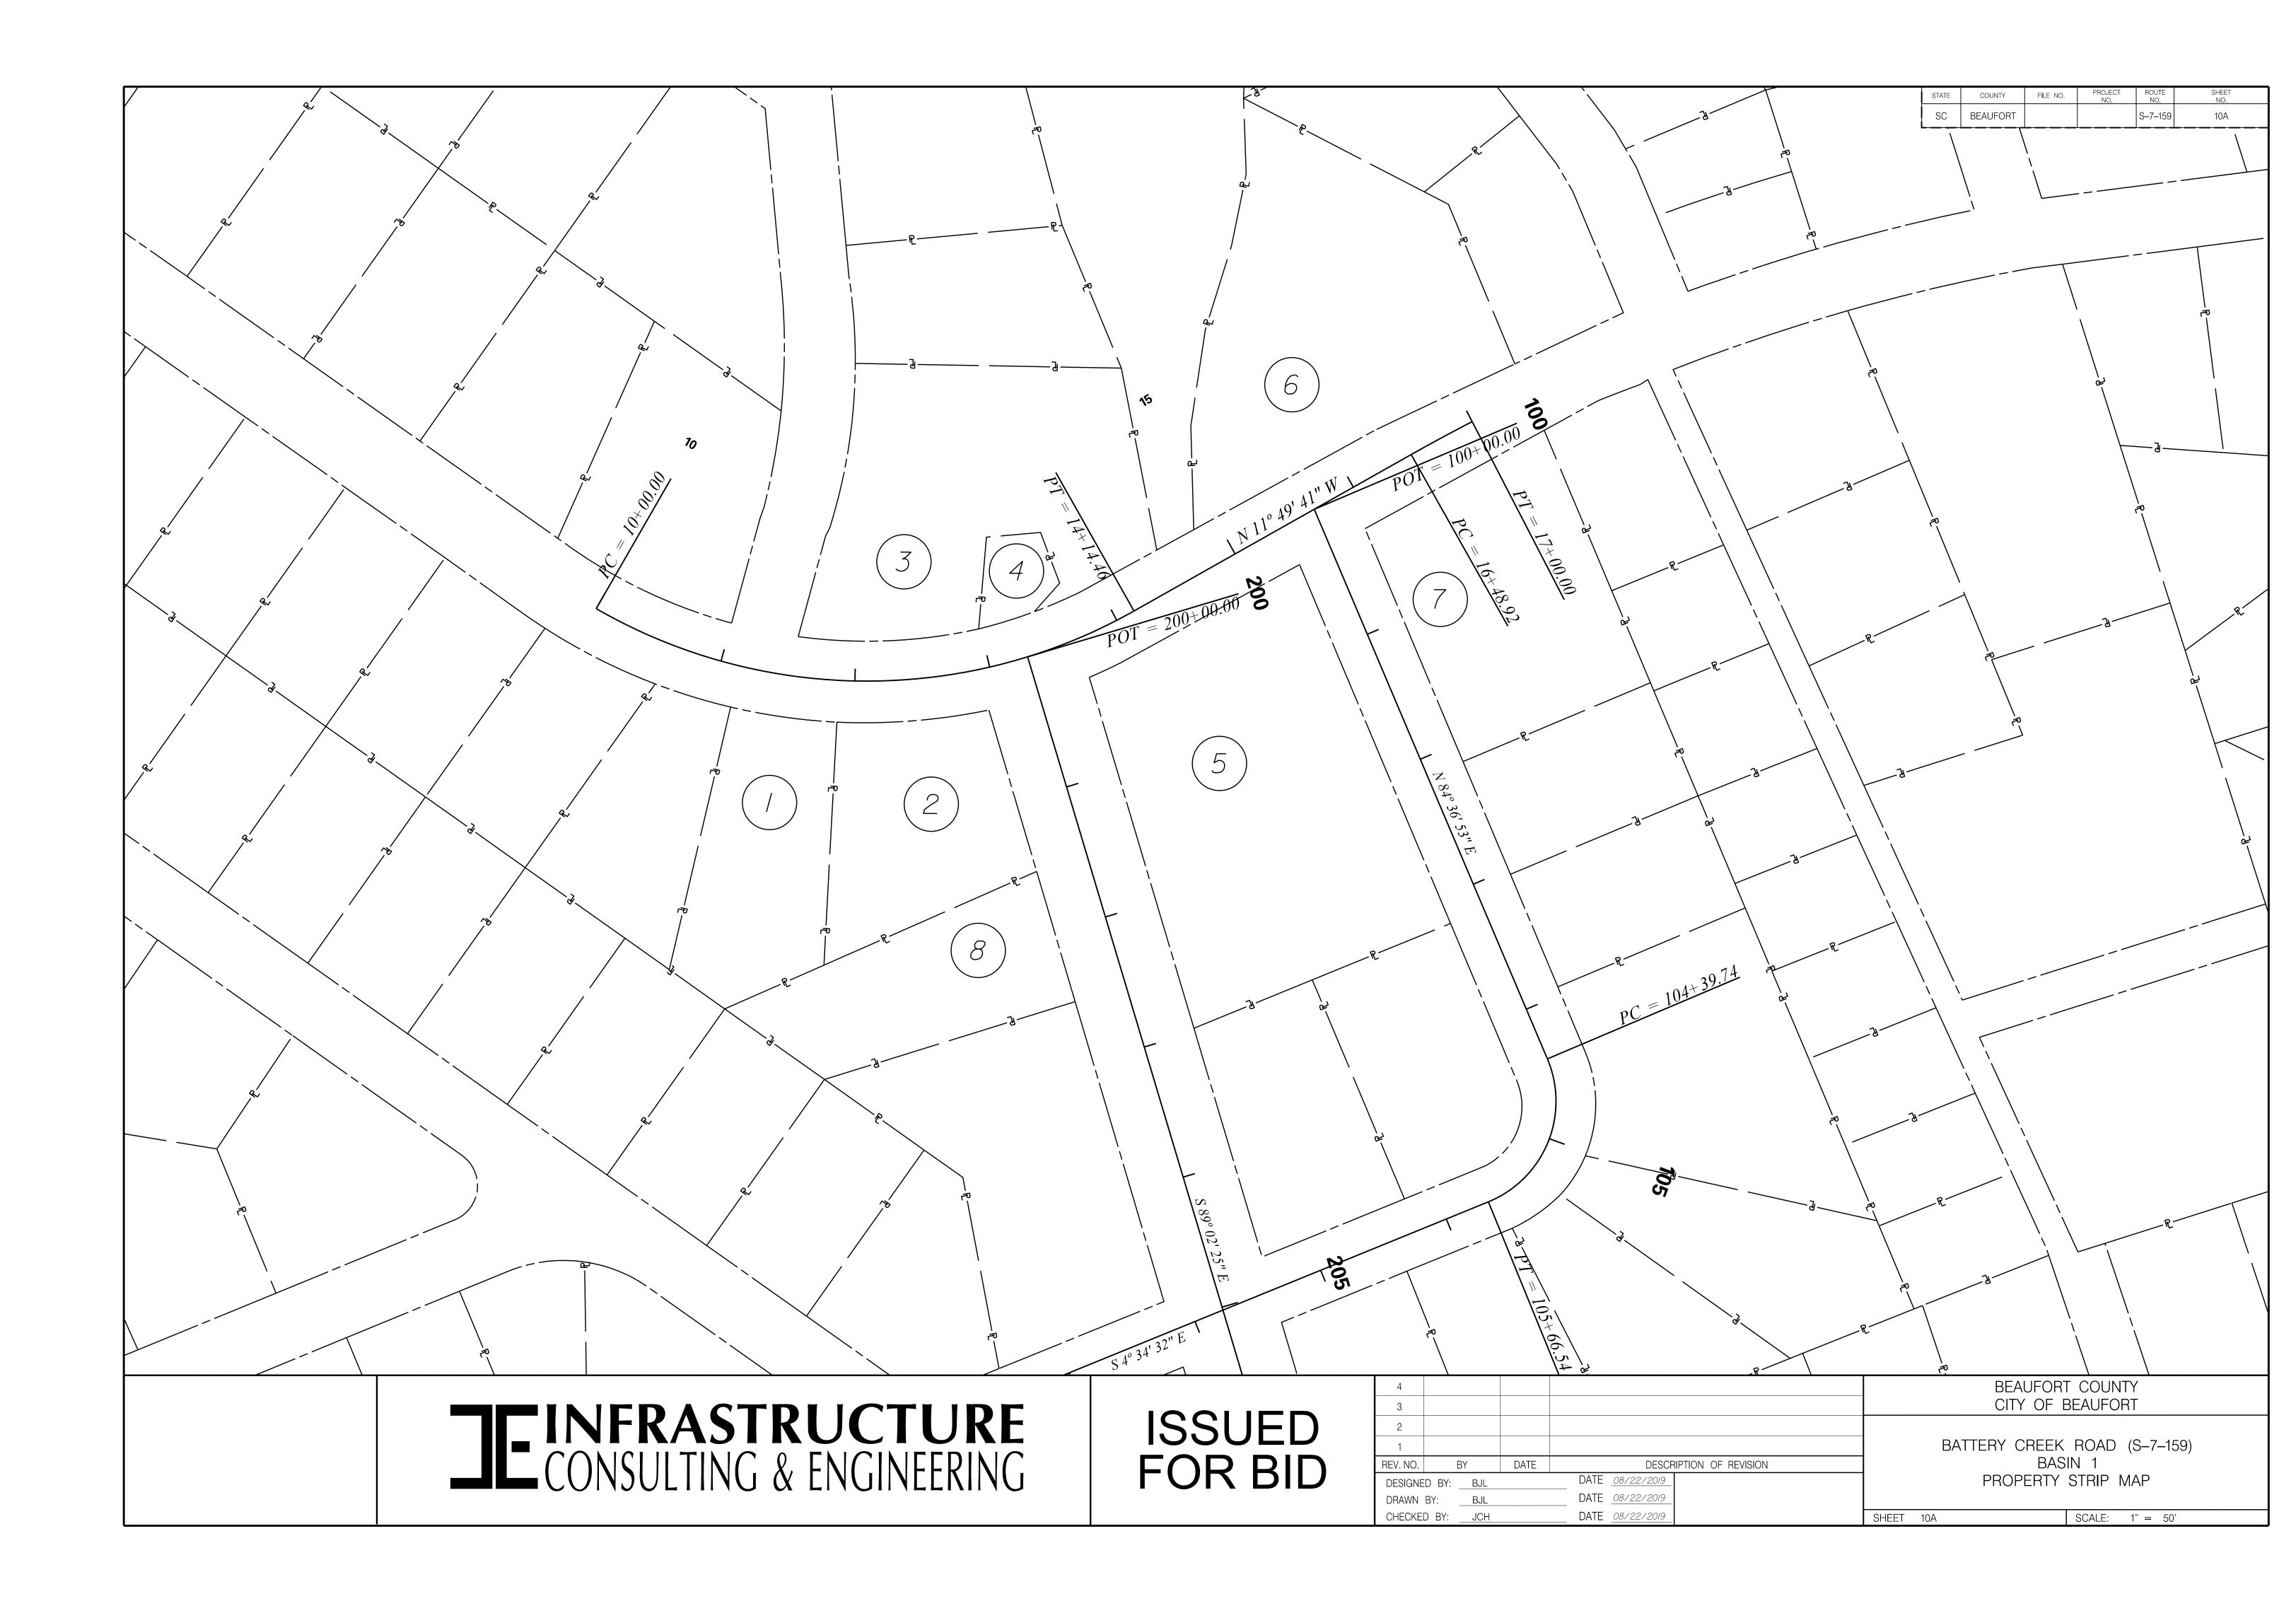


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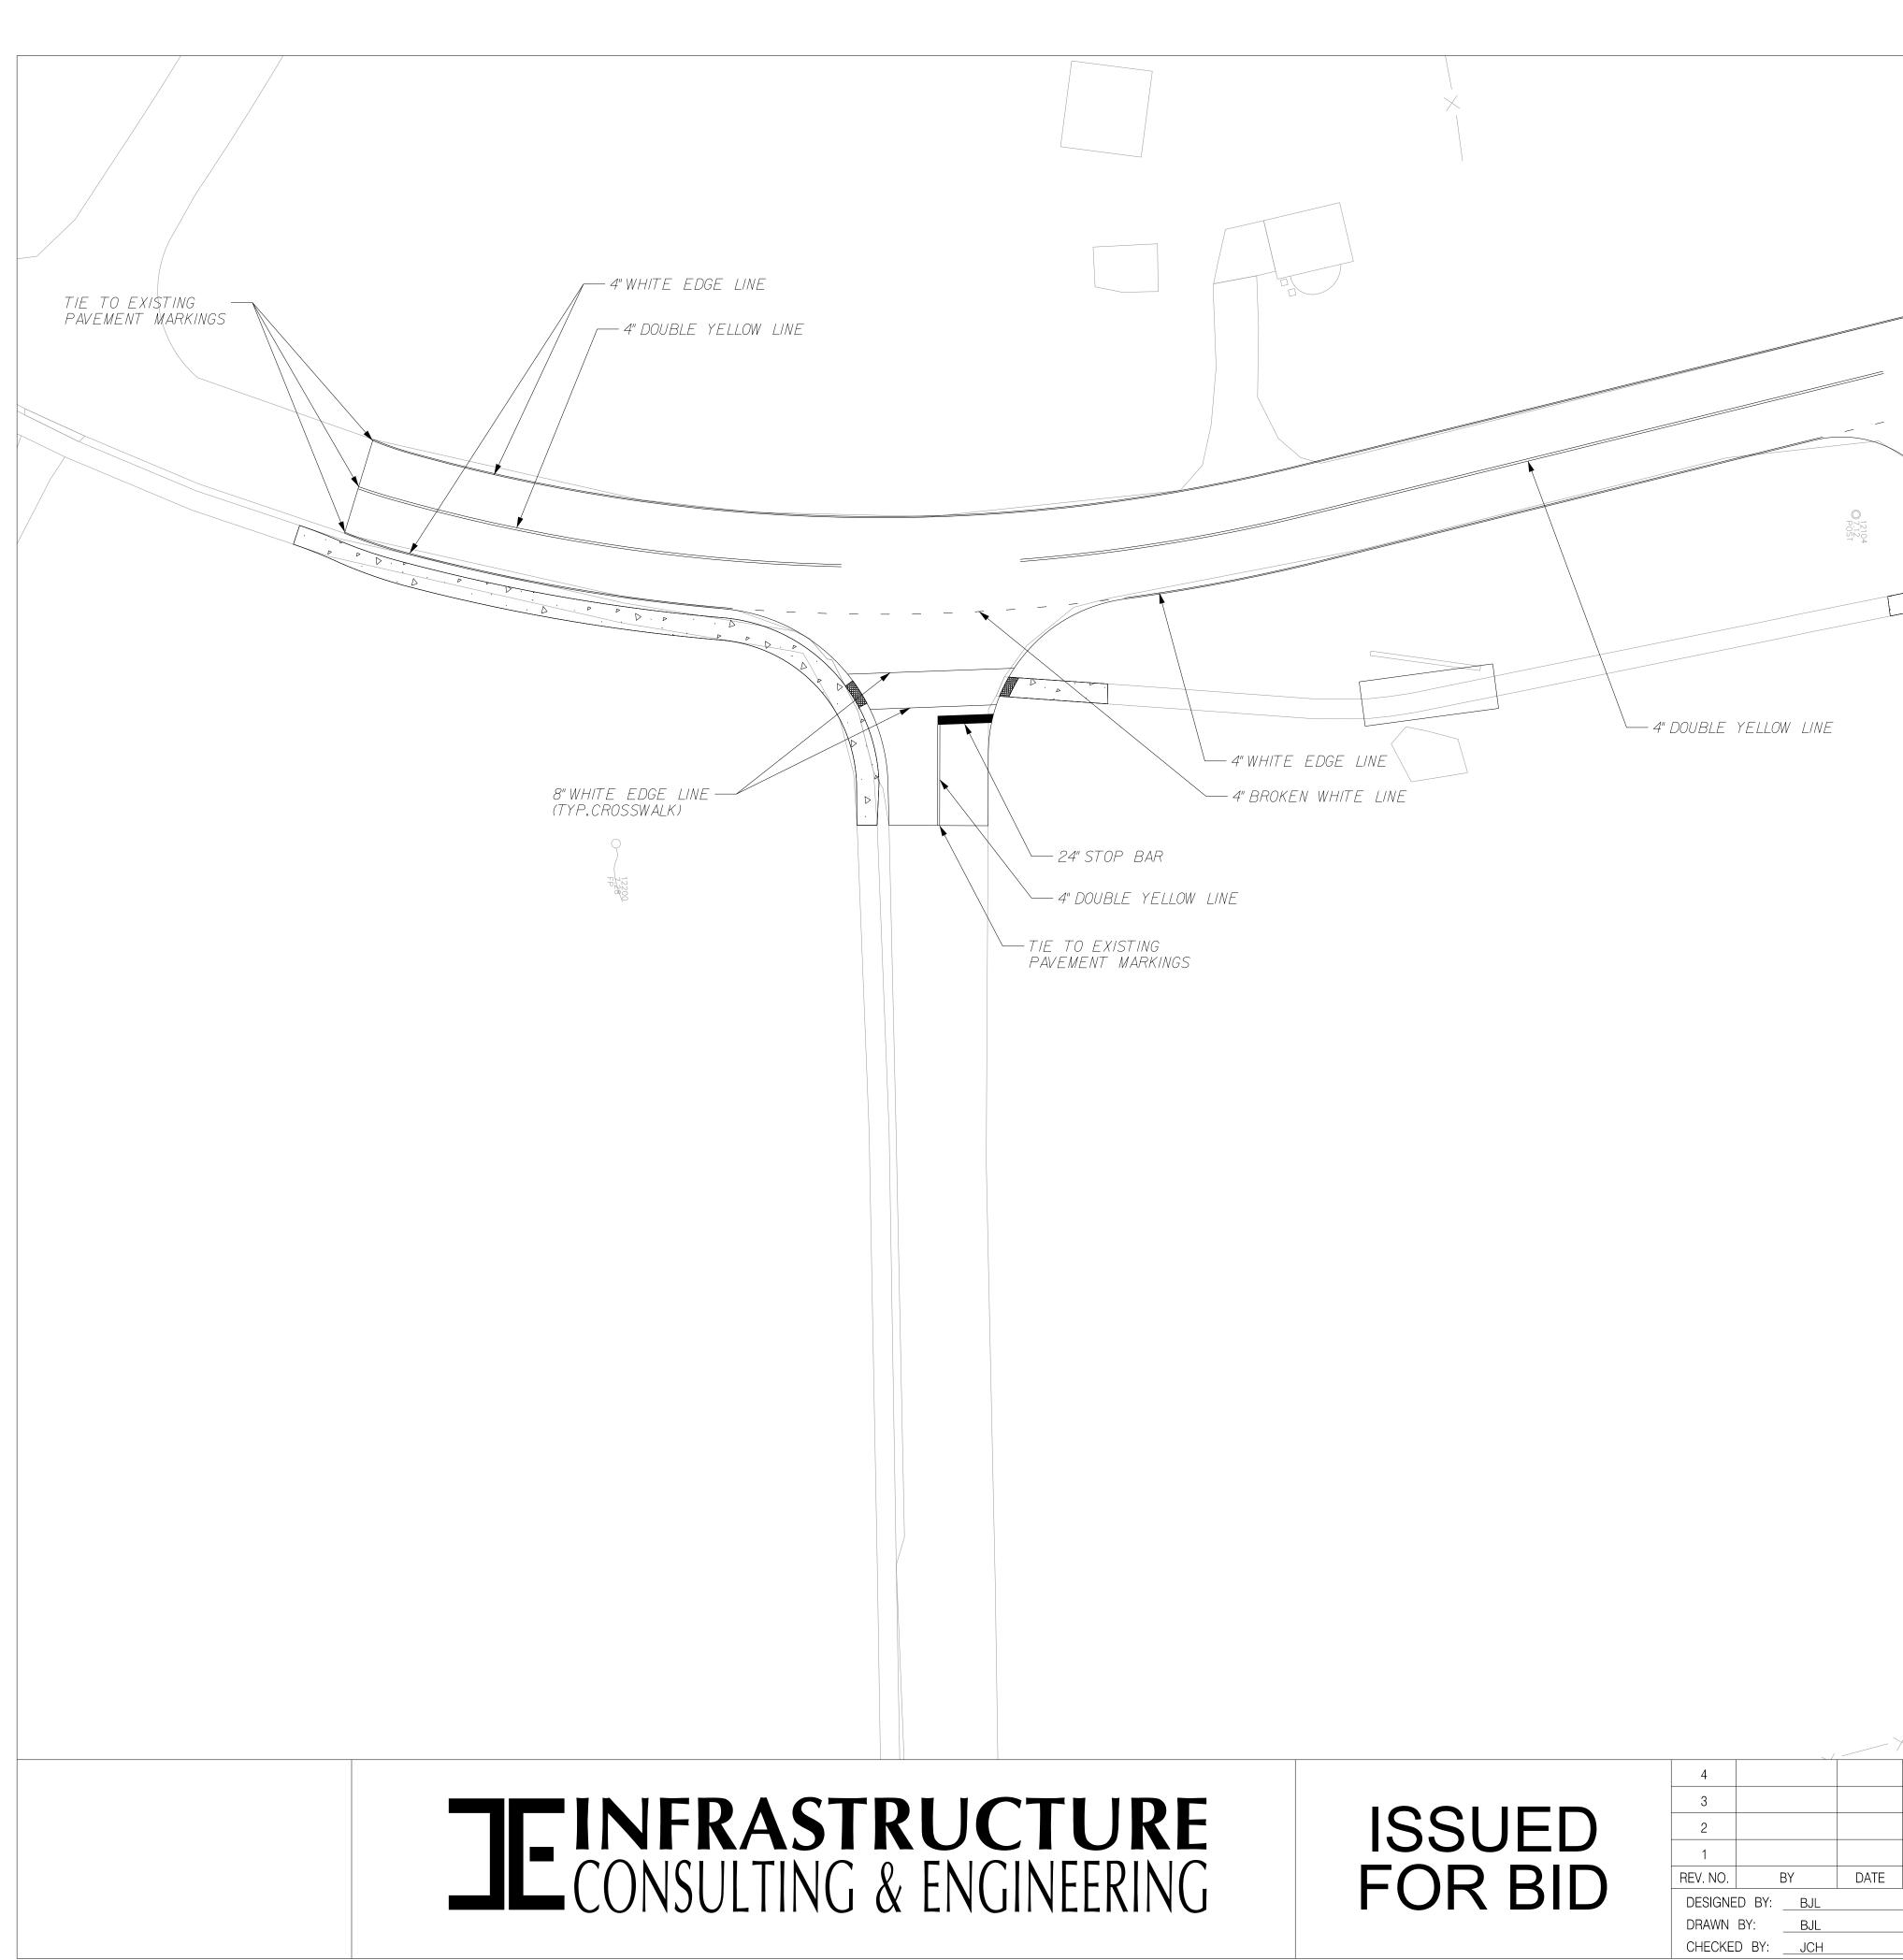


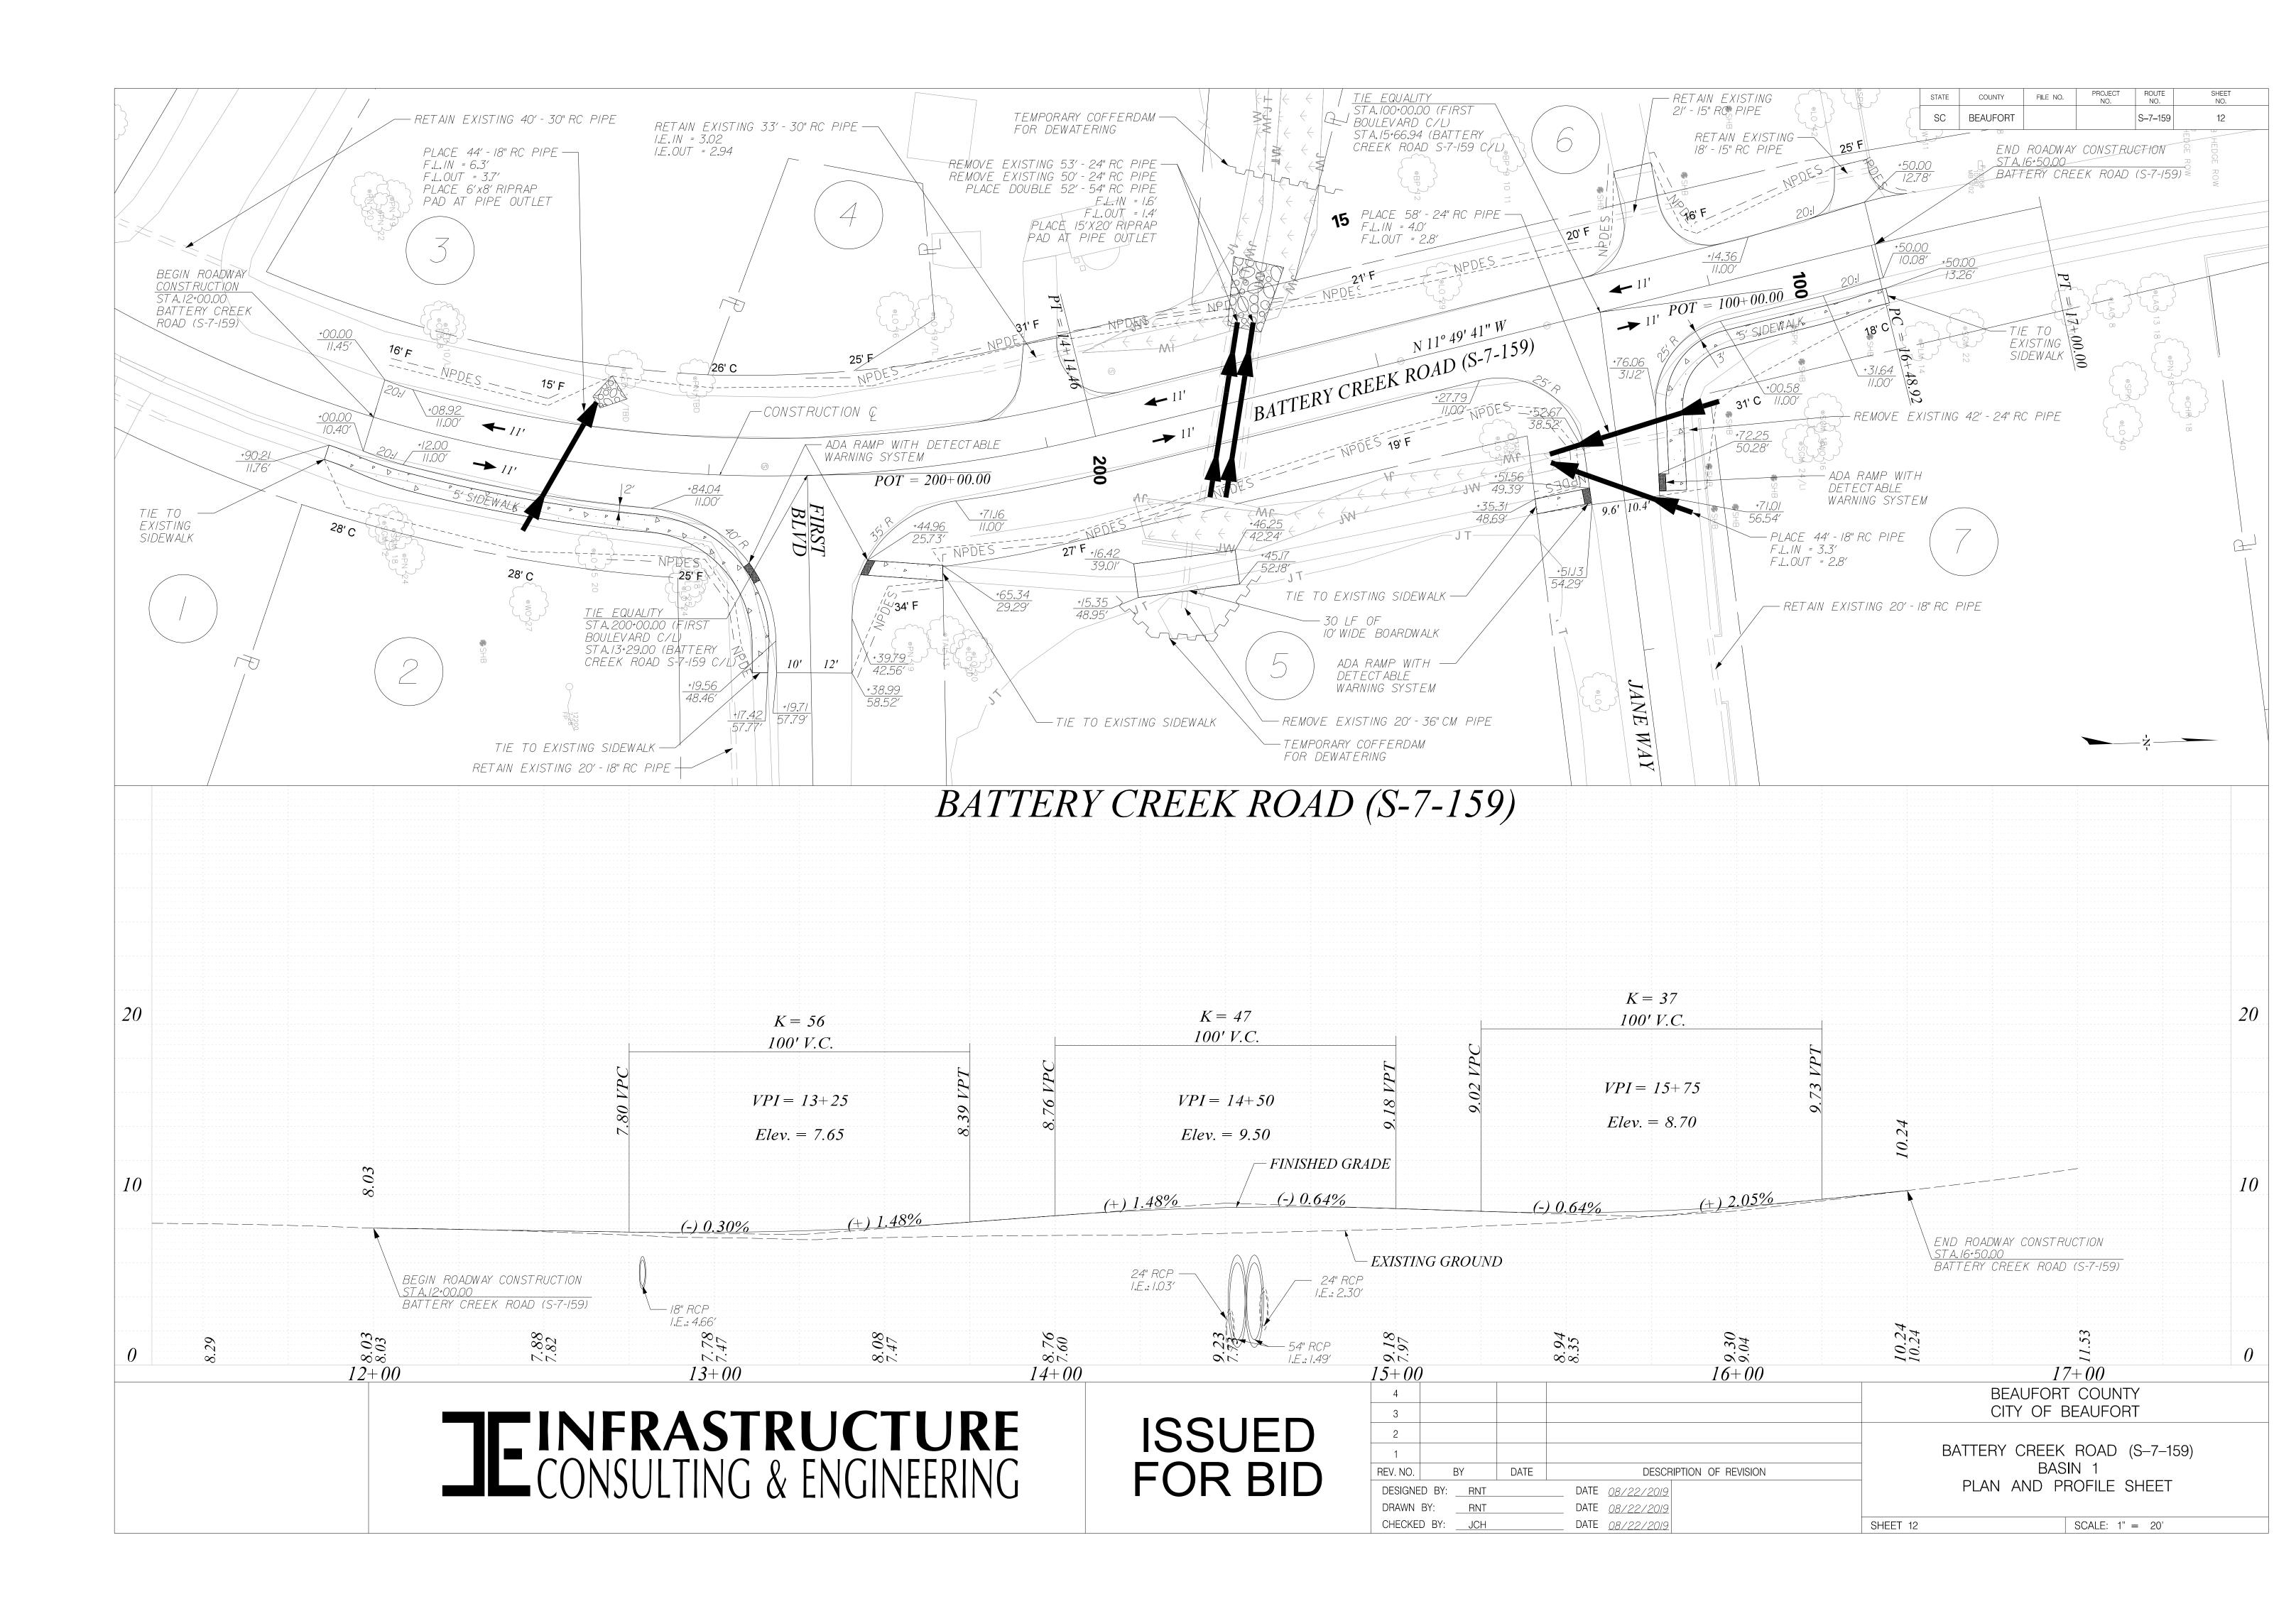

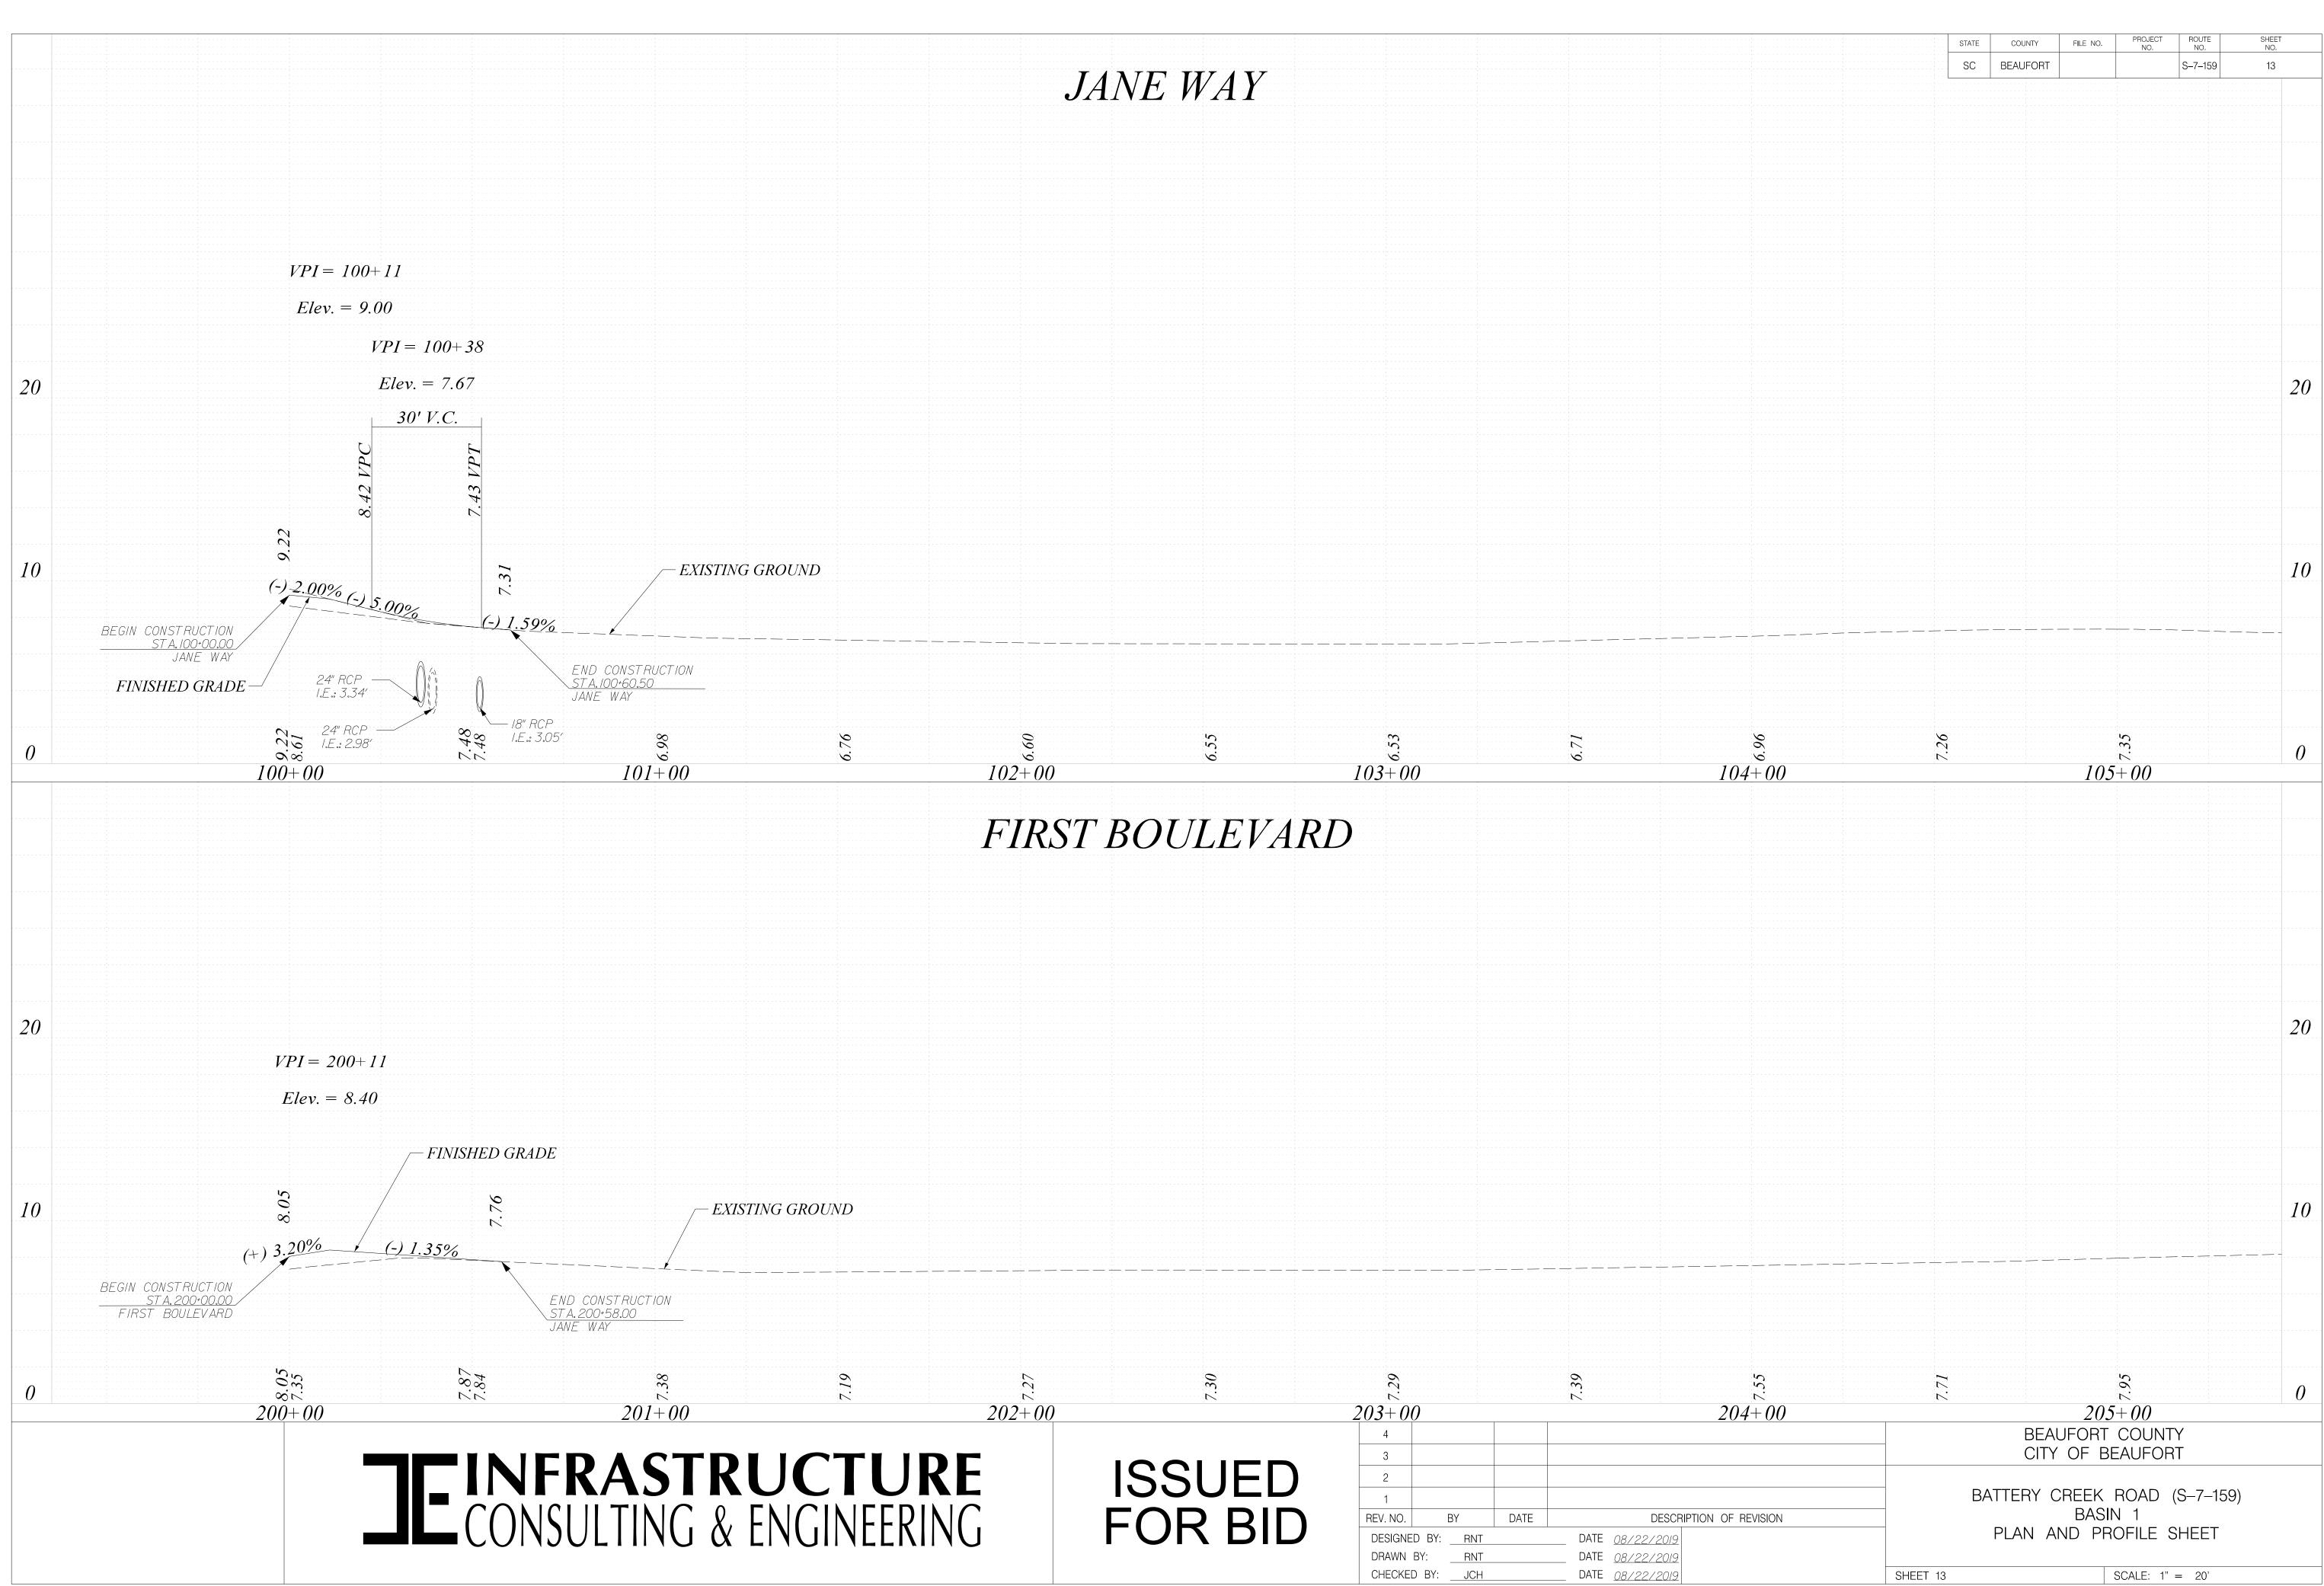





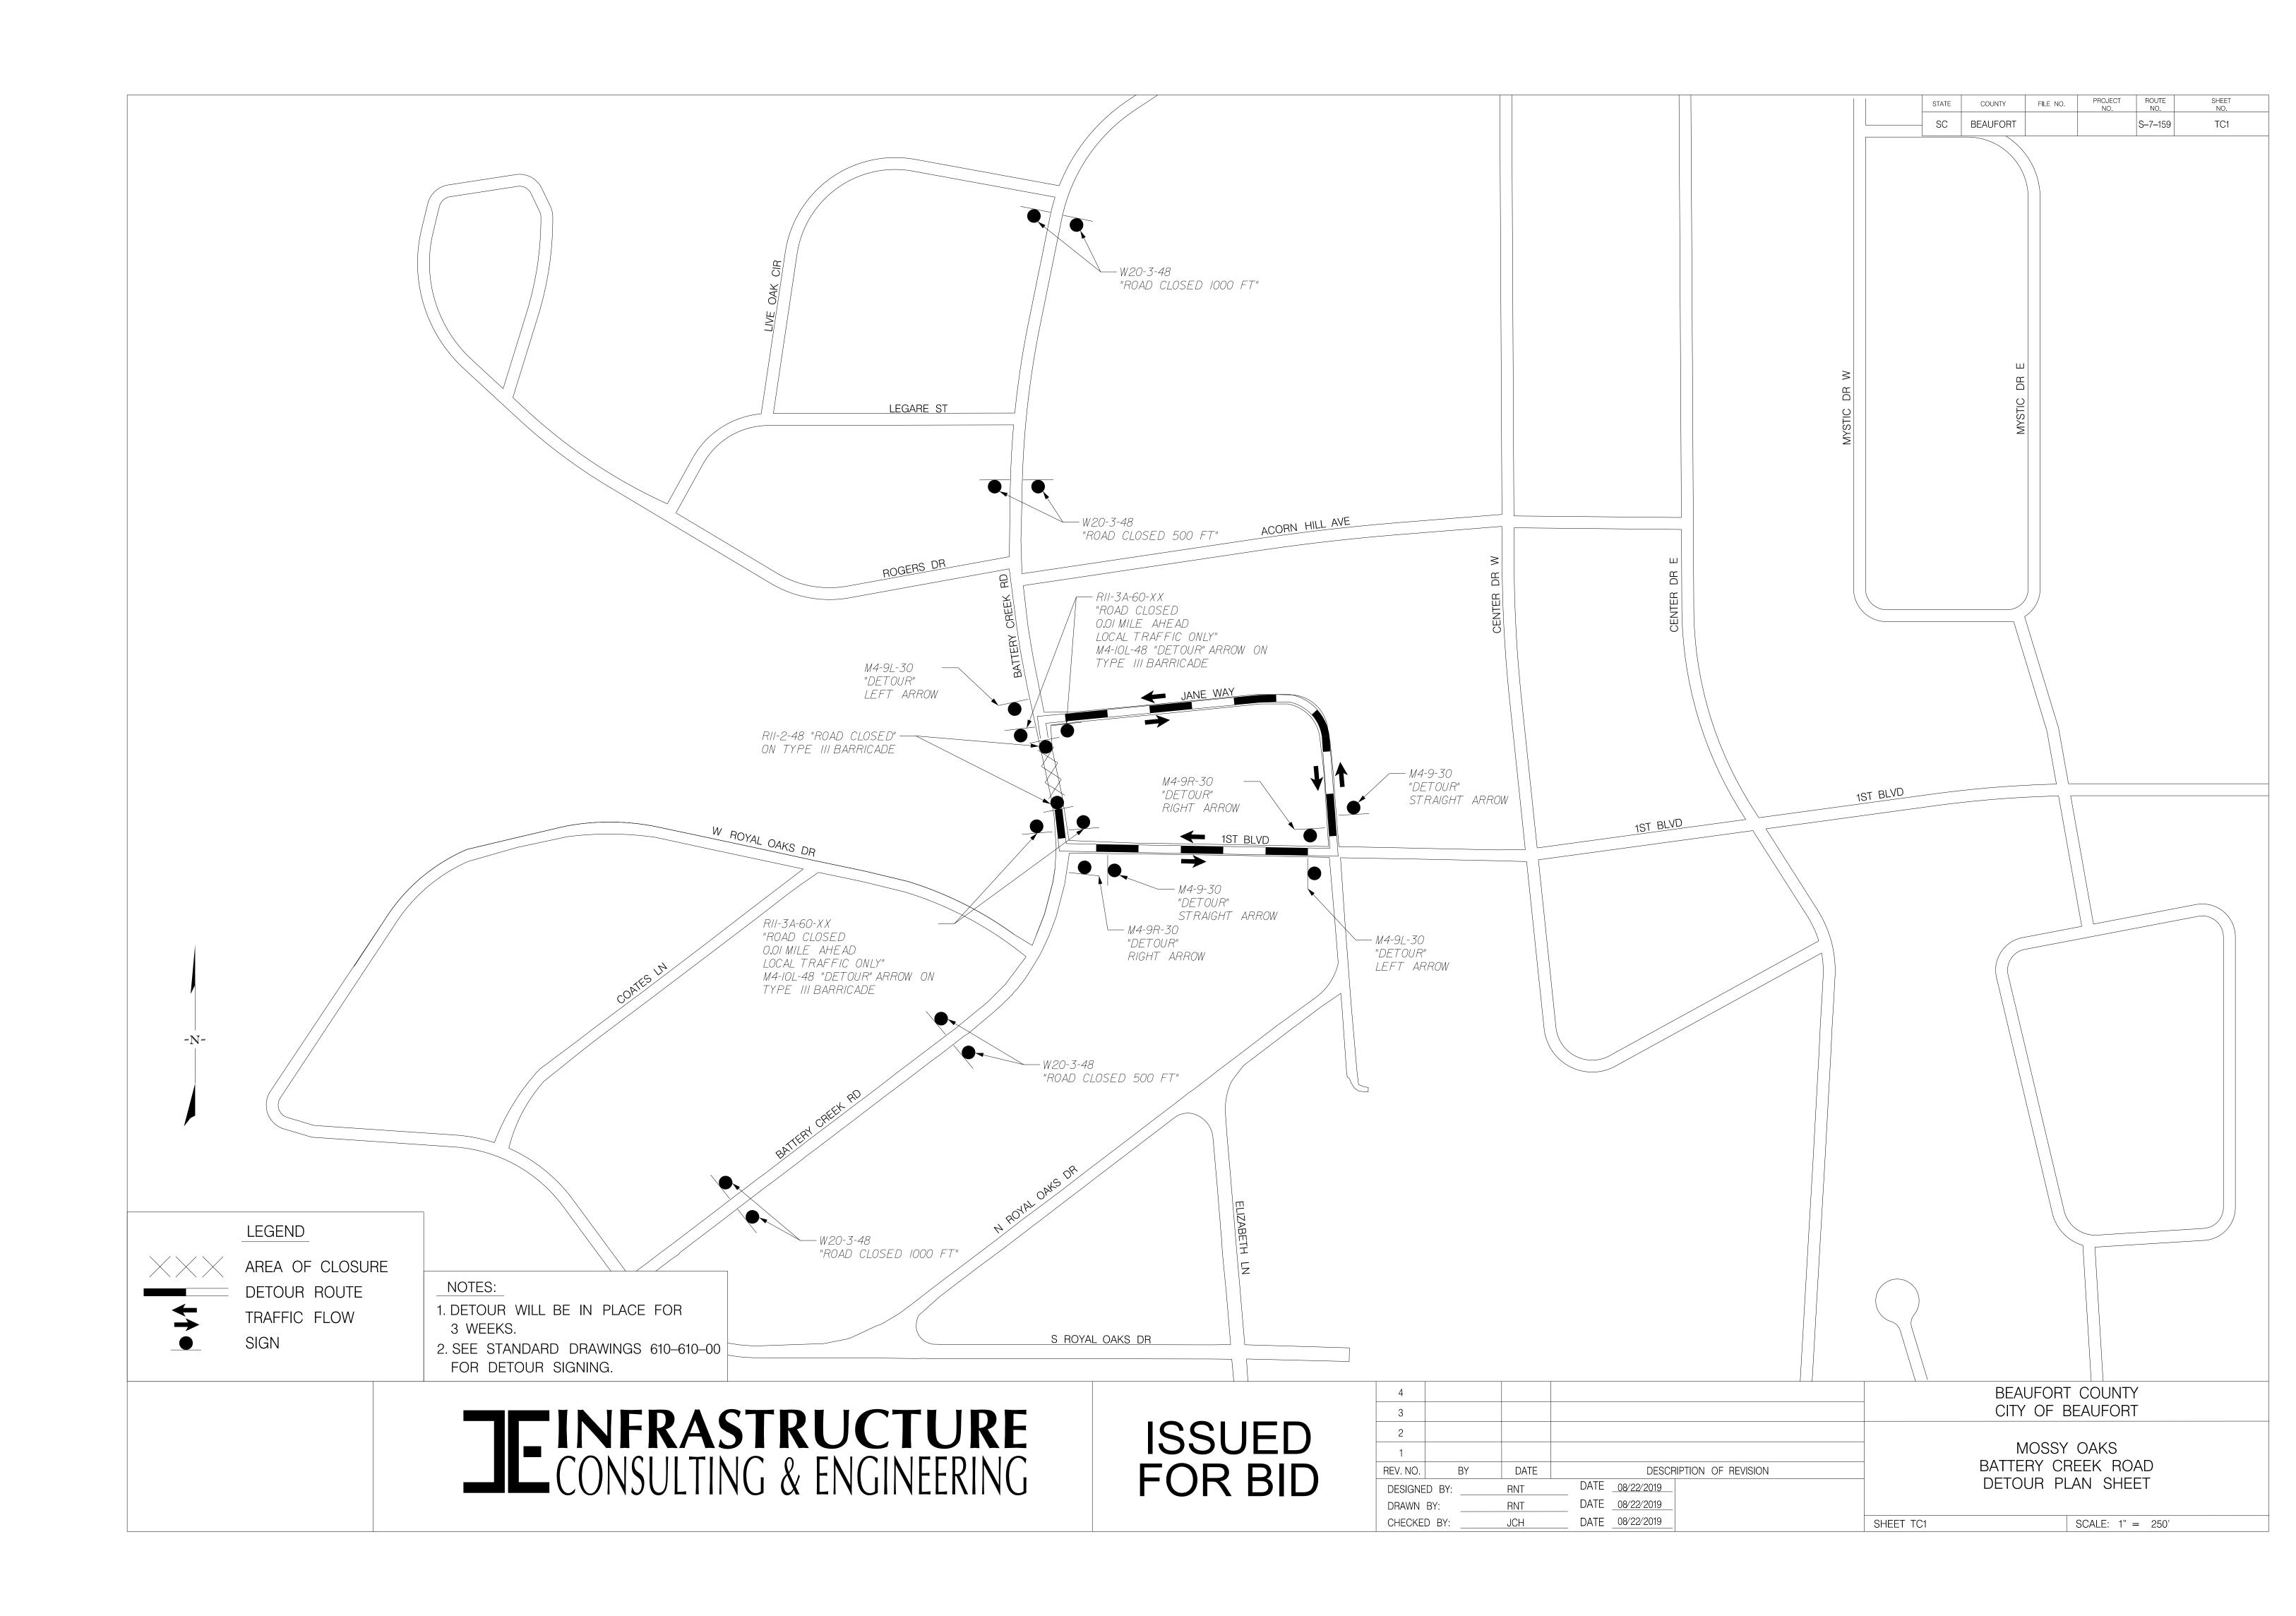


	STATE	COUNTY FILE NO.	PROJECT ROUTE NO. NO.	SHEET NO.
	SC	BEAUFORT	S-7-159	PM1
	PAVE	TO EXISTING MENT MARKINGS		
		ПР 1120568 ИВ 902		
	2			
	\ 4" DOU	BLE YELLOW LINE		
	4" WHITE E			
	BROKEN WHITE L	INE		
24" STOP L				
8" WHITE EDGE (TYP.CROSSWAL				
			ĩ	
		BEAUFORT		
		CITY OF B	EAUFORT	
DESCRIPTION OF REVISION	BA	ATTERY CREEK BASI	ROAD (S–7–159 N 1))
DATE <u>08/22/2019</u> DATE <u>08/22/2019</u>		PAVEMENT MAI		
DATE <u>08/22/2019</u> DATE <u>08/22/2019</u>	SHEET PM1		SCALE: 1" = 20'	

RECEIVING WATERS

ROAD / ROUTE	OUTFALL DIT	СН	NAME OF	NAME OF ULTIMATE		
KOAD / KOUTE	STATION	SIDE	RECEIVING WATERS	RECEIVING WATERS		
S-159	14+75	LT	TRIB TO BATTERY CREEK	BATTERY CREEK		

ROAD / ROUTE	STATI	ON TO	CIDE	DEPTH OF MAT	
RUAD / RUUIE	STAT	ΓΙΟΝ	SIDE	(FT)	

	SEDIMENT DAM															
NO	ROAD / ROUTE	STATION	SIDE	DRAINED OR NOT DRAINED	LENGTH OF SILT BASIN	WIDTH OF SILT BASIN	DAM	SIDE SLOPE OF SILT BASIN	SPILLWAY BOTTOM WIDTH	DAM BOTTOM WIDTH	RIP RAP CLASS	TOTAL STORAGE VOLUME	SEDIMENT STORAGE HEIGHT	OUTFALL CHANNEL WIDTH	OUTFALL CHANNEL DEPTH	OUTFALL CHANNEL LENGTH

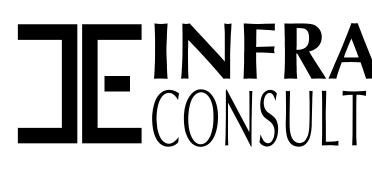

COLL TYDES	
EROSION CONTROL DATA S	

SOIL TYPES											
		SOIL PARTICLE SIZE (COARSE / FINE)	ZONE								
12+00	16+50	COARSE	COASTAL PLAIN								
	STAT	STATION TO STATION	STATION (COARSE / FINE)								

TURF REINFORCED MATTING (TRM)

				·		
SLOPE	SLOPES (x : 1) DITCH BOTTOM TYPE 1				TYPE 2	TYPE 3
FRONT	BACK	WIDTH (FT)		(MSY)	(MSY)	(MSY)
			TOTALS			
				•	•	•

HEE											NO.	NO.
								SC	BEAUFORT			EC1
)KA	DEPTH OF	DITCH	r	I KOL	BLANKET				
DAD / ROUTE		ON TO FION	SIDE		BOTTOM WIDTH (FT)	x FRONT	: 1 BACK	MSY				
S-159 S-159	12+00 12+00	13+00 13+25	RT LT	1.5 1.5	0 0	4	2.0 2.0	0.106 0.132				
S-159	14+80	16+00	LT	1.5	0	4	2.0	0.127				
										_		
							TOTAL	0.366				
			SEI	DIMEN '	Г ТИВЕ	S IN	DITCI	ES				
DAD / ROUTE		ON TO FION	SIDE	AVERAGE LENGTH	SPACING (FT)	ΤΟ	TAL	COMMENT	S			
S-159 S-159	12+00 12+00	13+25 13+00	LT RT	12 12	150 150		24					
S-159 S-159	14+80 16+00	16+50 16+50	LT RT	12 12	150 150		24					
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									STATE SC	COUNTY BEAUFORT	FILE NO.	PROJECT NO.	ROUTE NO.	SHEET NO. EC1
SHEE	× II N												I	
	Τ	EMPO	DRA				I	L BLANKET						
ROAD / ROUTE		ON TO FION	SIDE	DEPTH OF BLANKET (FT)	DITCH BOTTOM WIDTH (FT)	X	PES 1 BACK	Μ	[SY					
S-159 S-159	12+00 12+00	13+00 13+25	RT LT	1.5 1.5	0	4	2.0 2.0	0.	106 132					
S-159	14+80	16+00	LT	1.5	0	4	2.0	0.	127					
		1				,	FOTAL	0.	366					
	STATI	ON TO		DIMENT AVERAGE	F TUBE SPACING									
ROAD / ROUTE S-159	STA 12+00	ΓΙΟΝ 13+25	SIDE LT	LENGTH 12	(FT) 150	2		COM	MENTS	•				
S-159 S-159 S-159	12+00 14+80 16+00	13+00 16+50 16+50	RT LT RT	12 12 12	150 150 150		4 6 4							
	10:00			12										
					TOTAL	1)8							
								[
4 3												COUNTY AUFORT		
2			=						B	ATTERY C	REEK F	ROAD (S	6–7–159	9)
REV. NO. B		DATE	DATE	DES = <u>08/22/20</u>	CRIPTION OF 1	REVISION				ROSION C	BASIN	1		
	RNT		DATE	E <u>08/22/20</u> E <u>08/22/20</u> E <u>08/22/20</u>	<u>19</u>			SHEET EC				SCALE: NTS		
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