Hydraulic Design Reference for these plans is the:

2009

Edition of SCDOT's "Requirements for Hydraulic Design Studies"

Design Reference for these plans is the:

2021

SCDOT Roadway Design Manual

NPDES PERMIT INFORMATION

Approximate Location of Roadway is

33°20'54" N 79°26'21" W

33°21'7" N

79°26'17" W

Hydraulic and NPDES Design provided by:

Stantec Consulting

Disturbed Area = 1.1 Acre(s)

Project Area = ____1.7 Acre(s)

Latitude


Longitude

	INDEX OF SHEETS								
SHEET NO.	DESCRIPTION	SHEET SUBTOTALS							
1	TITLE SHEET	1							
3	TYPICAL SECTIONS	1							
5	GENERAL CONSTRUCTION NOTES	1							
5A	SURVEY CONTROL SHEET	1							
6-8	PLAN SHEETS	3							
9-10	PROFILE SHEETS	2							
PM1	SIGNING AND PAVEMENT MARKING PLAN	1							
U1-U3	UTILITY SHEETS	3							
EC1-EC5	EROSION CONTROL SHEETS	5							
X1-X8	CROSS SECTIONS	8							
D1-D4	STANDARD DETAILS	4							
TOTAL		30							



PROPOSED PLANS FOR GEORGETOWN COUNTY

PLOVER DRIVE PAVING IMPROVEMENTS

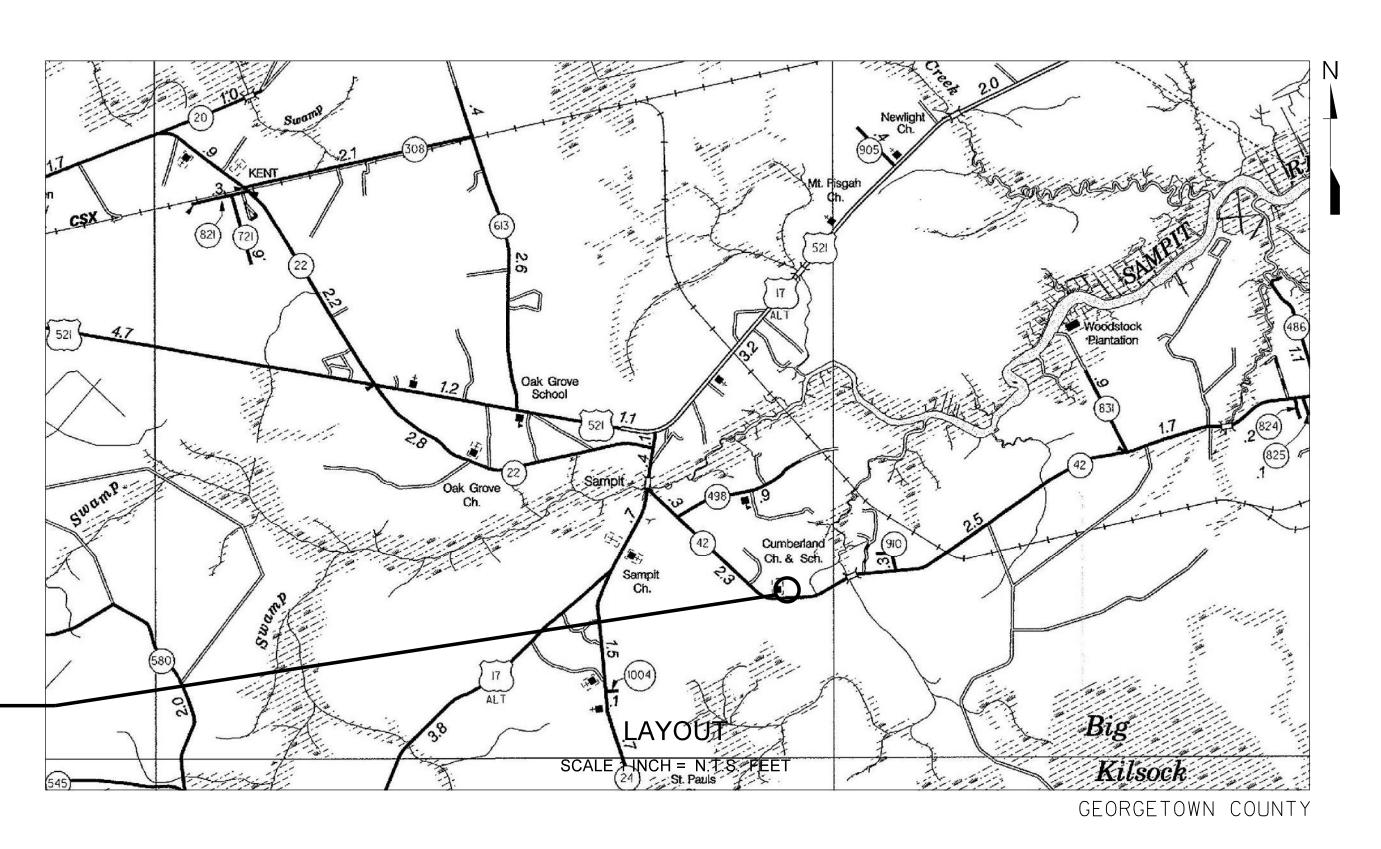

PLOVER DRIVE
BEGIN CONSTRUCTION STA. 10+14.00
END CONSTRUCTION STA. 23+75.10

3 DAYS BEFORE DIGGING IN SOUTH CAROLINA

CALL 811

SOUTH CAROLINA 811 (SC811)

www.SC811.COM

ALL UTILITIES MAY NOT BE A MEMBER OF SC811

RAILROAD INVOLVEMENT? YES / NO

PLOVER DRIVE TOTAL NET LENGTH OF ROADWAY 0.25 0.25 MILES NET LENGTH OF BRIDGES 0.000 0.000 MILES NET LENGTH OF PROJECT 0.25 0.25 MILES LENGTH OF EXCEPTIONS 0.000 0.000 MILES GROSS LENGTH OF PROJECT 0.25 0.25 MILES


EQUALITIES IN STATIONING NONE

NOTE: EXCEPT AS MAY OTHERWISE BE SPECIFIED ON THE PLANS OR IN THE SPECIAL PROVISIONS, ALL MATERIALS AND WORKMANSHIP ON THIS PROJECT SHALL CONFORM TO THE SOUTH CAROLINA DEPARTMENT OF TRANSPORTATION STANDARD SPECIFICATIONS FOR HIGHWAY CONSTRUCTION (2007 EDITION) AND THE STANDARD DRAWINGS FOR ROAD CONSTRUCTION IN EFFECT AT THE TIME OF LETTING.

CONSULTING ENGINEERING FIRM



Stantec Consulting Services 4969 Centre Pointe Drive, Suite 200 North Charleston, SC 29418 Tel: 843.740.7700 Fax: 843.740.7707 www.stantec.com

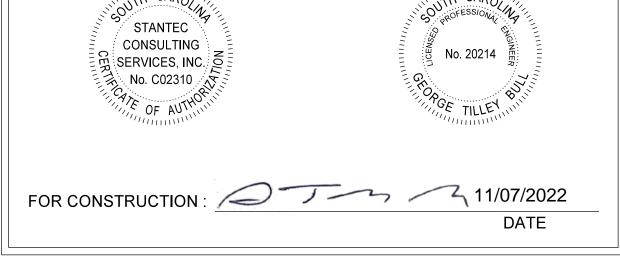

ENGINEER OF RECORD

GEORGETOWN COUNTY

PLOVER DRIVE

PAVING IMPROVEMENTS

TYPICAL SECTIONS

RTE. PLOVER DRIVE


6/01/22 ADDED SCDOT PAVEMENT SECTION

DESCRIPTION OF REVISION

GROUP ____ - ___

SCALE:

TYPICAL SECTION OF IMPROVEMENT FOR PLOVER DRIVE

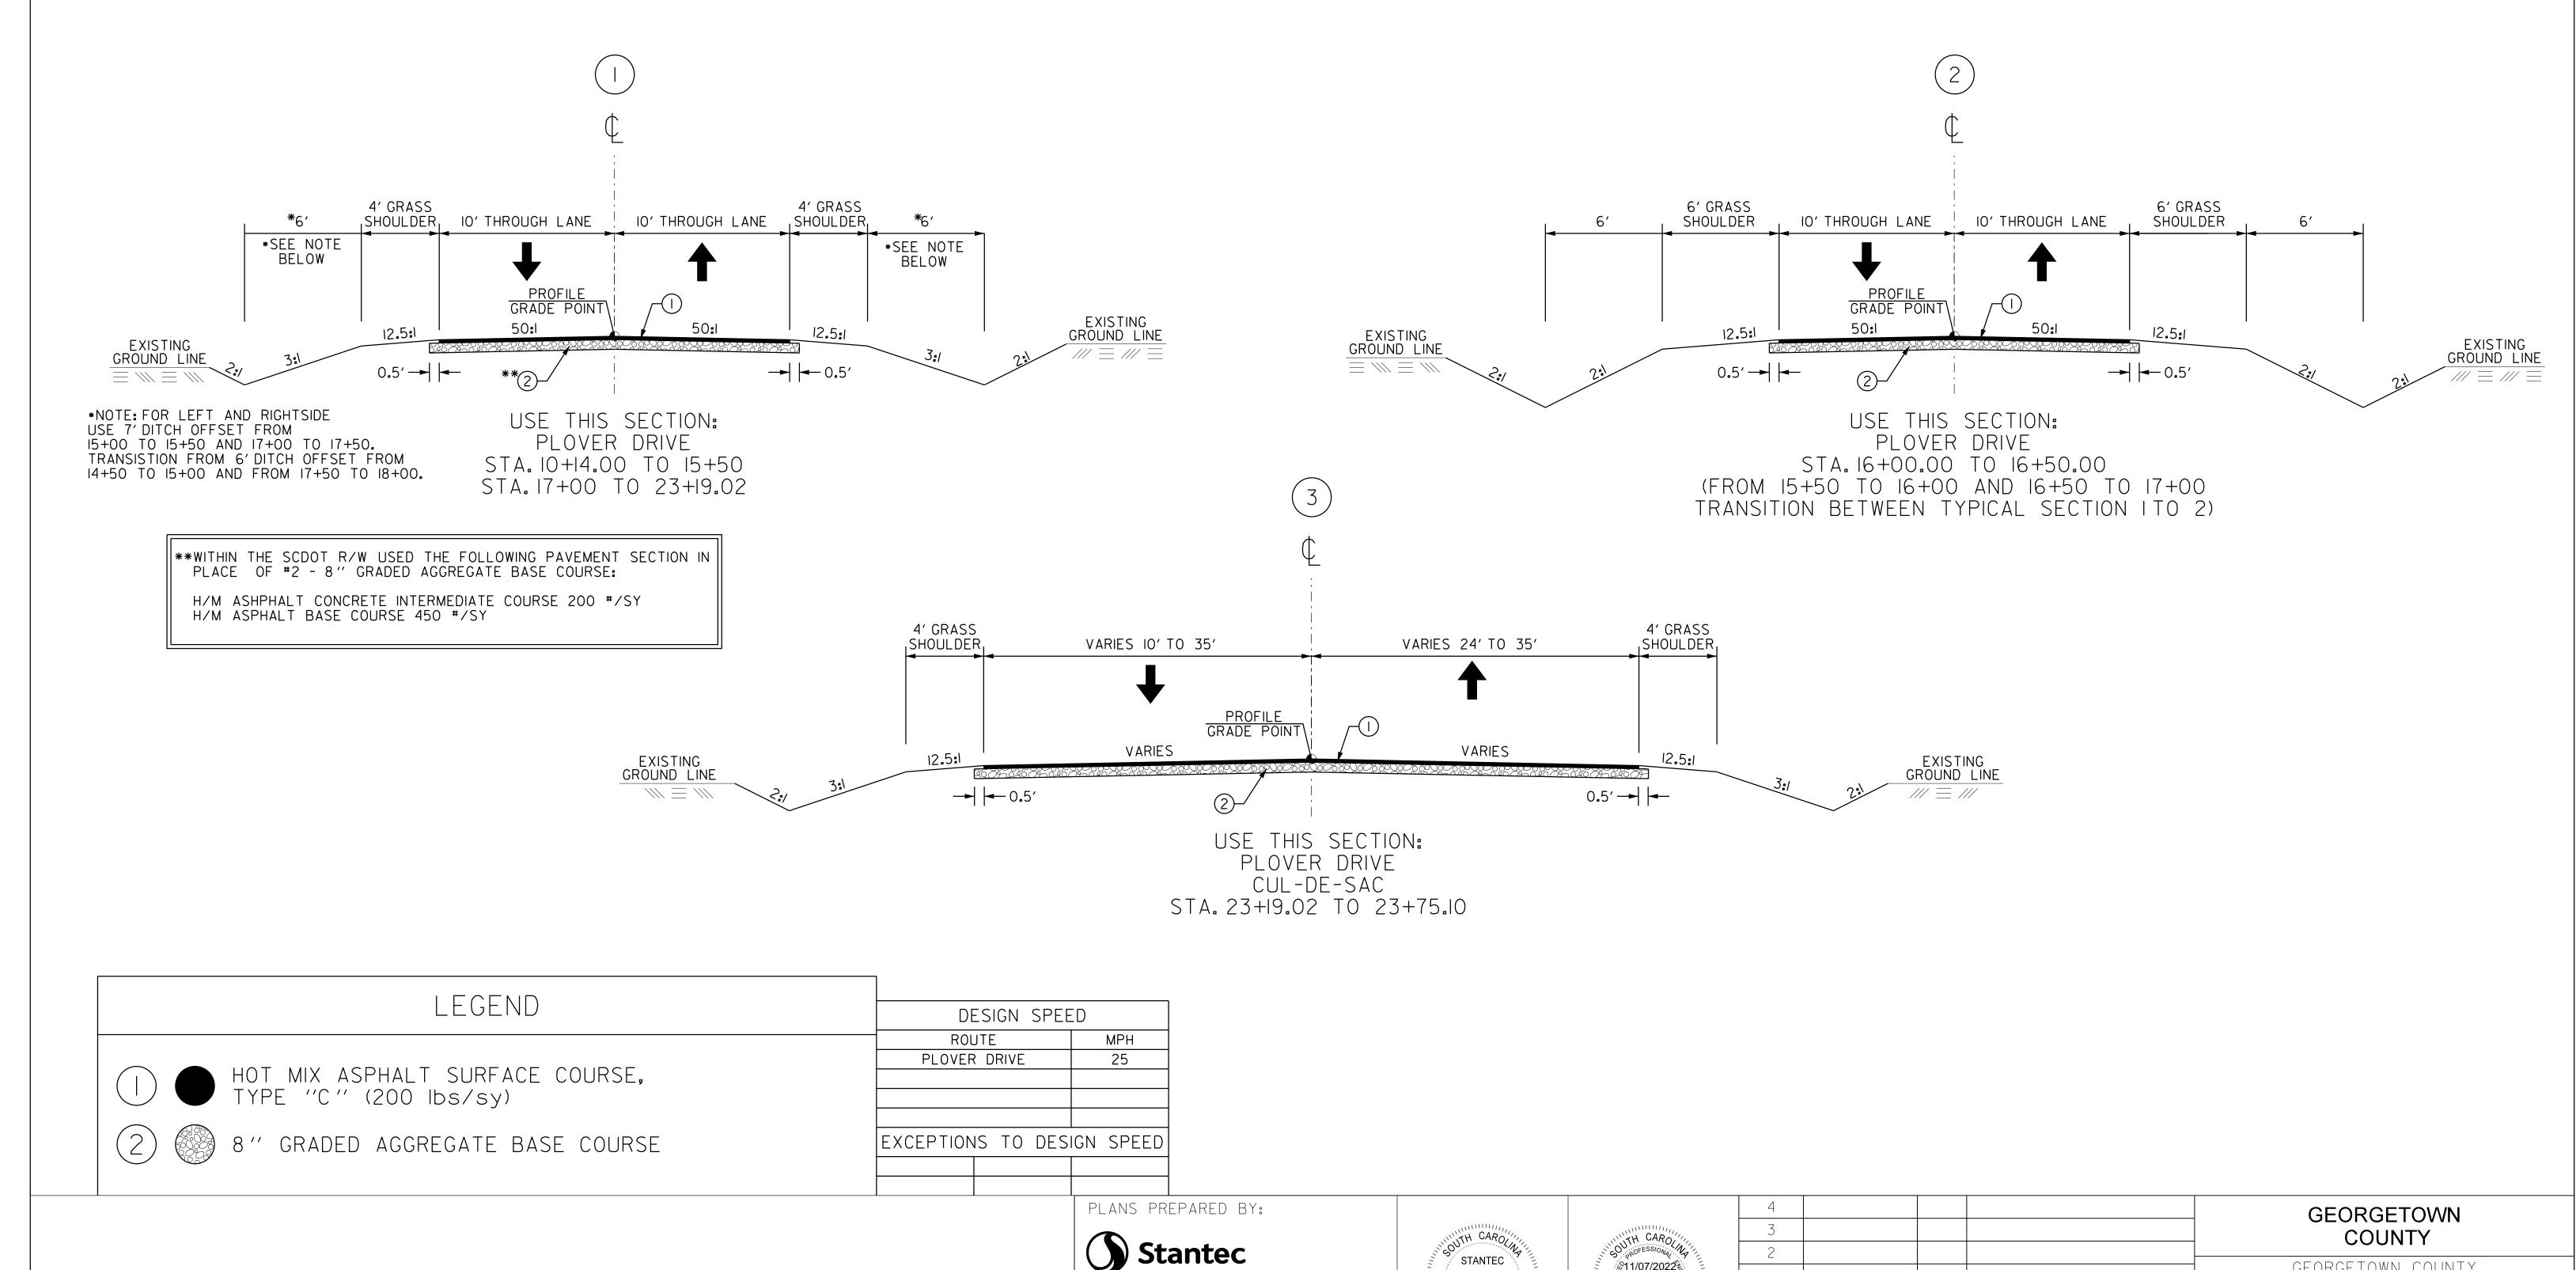

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North Charleston, SC 29418

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CONSULTING

į̇̃ SERVICES, INC. į́

No C02310

£11/07/2022

No. 20214

REV. NO.

BY

DWG. _____ DATE ____

SEE INDIVIDUAL CURVES ON REFERENCE DATA SHEET FOR SUPERELEVATION RATE AND DESIGN SPEED, AS APPLICABLE.

THE FOLLOWING QUANTITIES ARE NOT SHOWN IN DETAIL ON THE PLANS BUT ARE INCLUDED IN THE SUMMARY OF ESTIMATED QUANTITIES AND MAY BE ADJUSTED DURING CONSTRUCTION AS DIRECTED BY THE ENGINEER.

GENERAL INCLUSIONS

ITEM	QUANTITY	UNIT	COMMENTS
MOBILIZATION	1.000	LS	PER CONTRACT DOCUMENTS
BONDS AND INSURANCE	1.000	LS	PER CONTRACT DOCUMENTS
CONSTRUCTION STAKES, LINES & GRADES	1.000	EA	PER CONTRACT DOCUMENTS
PERMANENT CONSTRUCTION SIGNS	152.000	SF	FOR TRAFFIC CONTROL
UNCLASSIFIED EXCAVATION (STRIPPING)	215.000	СҮ	FOR COUNTY APPROVED MUCKING AND REPLACEMENT
BORROW EXCAVATION	280.000	СҮ	REPLACING STRIPPED MATERIAL (ESTIMATED)
#57 STONE FOR BEDDING OF 24" RCP (INCLUDE WRAPPING STONE WITH FABRIC)	30.000	TON	STONE PIPE BEDDING 12" MINIMUM WITH FABRIC
THESE TWO QUANTITIES BELOW ARE EXCLUDED FROM THE LUMP SUM BID. SEE CONTRACT PROVISIONS.			
MUCK EXCAVATION	100.000	СҮ	FOR COUNTY APPROVED MUCKING AND REPLACEMENT
MAINTENACE STONE	100.000	TONS	WHERE DIRECTED BY ENGINEER / RCM

EROSION CONTROL INCLUSIONS

ITEM	QUANTITY	UNIT	COMMENTS
PERMANENT COVER	0.900	ACRE	FOR ALL DISTURBED AREAS
TEMPORARY COVER	0.900	ACRE	FOR ALL DISTURBED AREAS
FERTILIZER (NITROGEN)	90.000	LB	FOR ALL DISTURBED AREAS
FERTILIZER (PHOSPHORIC ACID)	90.000	LB	FOR ALL DISTURBED AREAS
FERTILIZER (POTASH)	90.000	LB	FOR ALL DISTURBED AREAS
AGRICULTURAL GRANULAR LIME	1800.000	LB	FOR ALL DISTURBED AREAS
MOWING	1.800	MSY	WHERE DIRECTED BY ENGINEER
SELECTIVE WATERING	53,400.000	ACRE	WHERE DIRECTED BY ENGINEER
HECP TYPE 3	1.800	ACRE	WHERE DIRECTED BY ENGINEER



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GEORGETOWN

ROUTE NO. SHEET NO

PLOVER DRIVE

S.C. GEORGETOWN

GEORGETOWN COUNTY PLOVER DRIVE PAVING IMPROVEMENTS GENERAL CONSTRUCTION NOTE

COUNTY

PROJECT NOTES

I. PROJECT DESCRIPTION

THE PROJECT IS SITUATED IN GEORGETOWN COUNTY, SOUTH CAROLINA ON PLOVER DRIVE OFF OF PENNYROYAL ROAD (S-18-42).

MAJOR WORK ITEMS INCLUDE: INSTALLING BASE COURSE AND PAVING AN EXISTING 1400-FOOT SLAG/GRAVEL ROAD.

2. SURVEY AND DESIGN INFORMATION

CONTROL AND SURVEYS WERE PROVIDED BY PARKER LAND SURVEYING.

3. EROSION CONTROL

EROSION CONTROL MEASURES ON THIS PROJECT SHOULD BE IMPLEMENTED AS DETAILED BY S.C.D.O.T. STANDARD DRAWINGS FOR EROSION CONTROL. SILT FENCE SHALL BE PLACED WHERE SEDIMENT LEAVES THE PROJECT LIMITS, ESPECIALLY AT THE TOE OF FILL SLOPES THAT SLOPE AWAY FROM THE PROJECT. EROSION CONTROL MEASURES SHALL BE IMPLEMENTED BEFORE GROUND DISTURBING ACTIVITY BEGINS AND SHOULD BE MAINTAINED UNTIL FINAL STABILIZATION HAS OCCURRED.

Stantec STANTEC CONSULTING SERVICES, INC. Stantec Consulting Services Inc. No C02310 🔨 4969 Centre Pointe Drive Suite 200


PLANS PREPARED BY:


North Charleston, SC 29418

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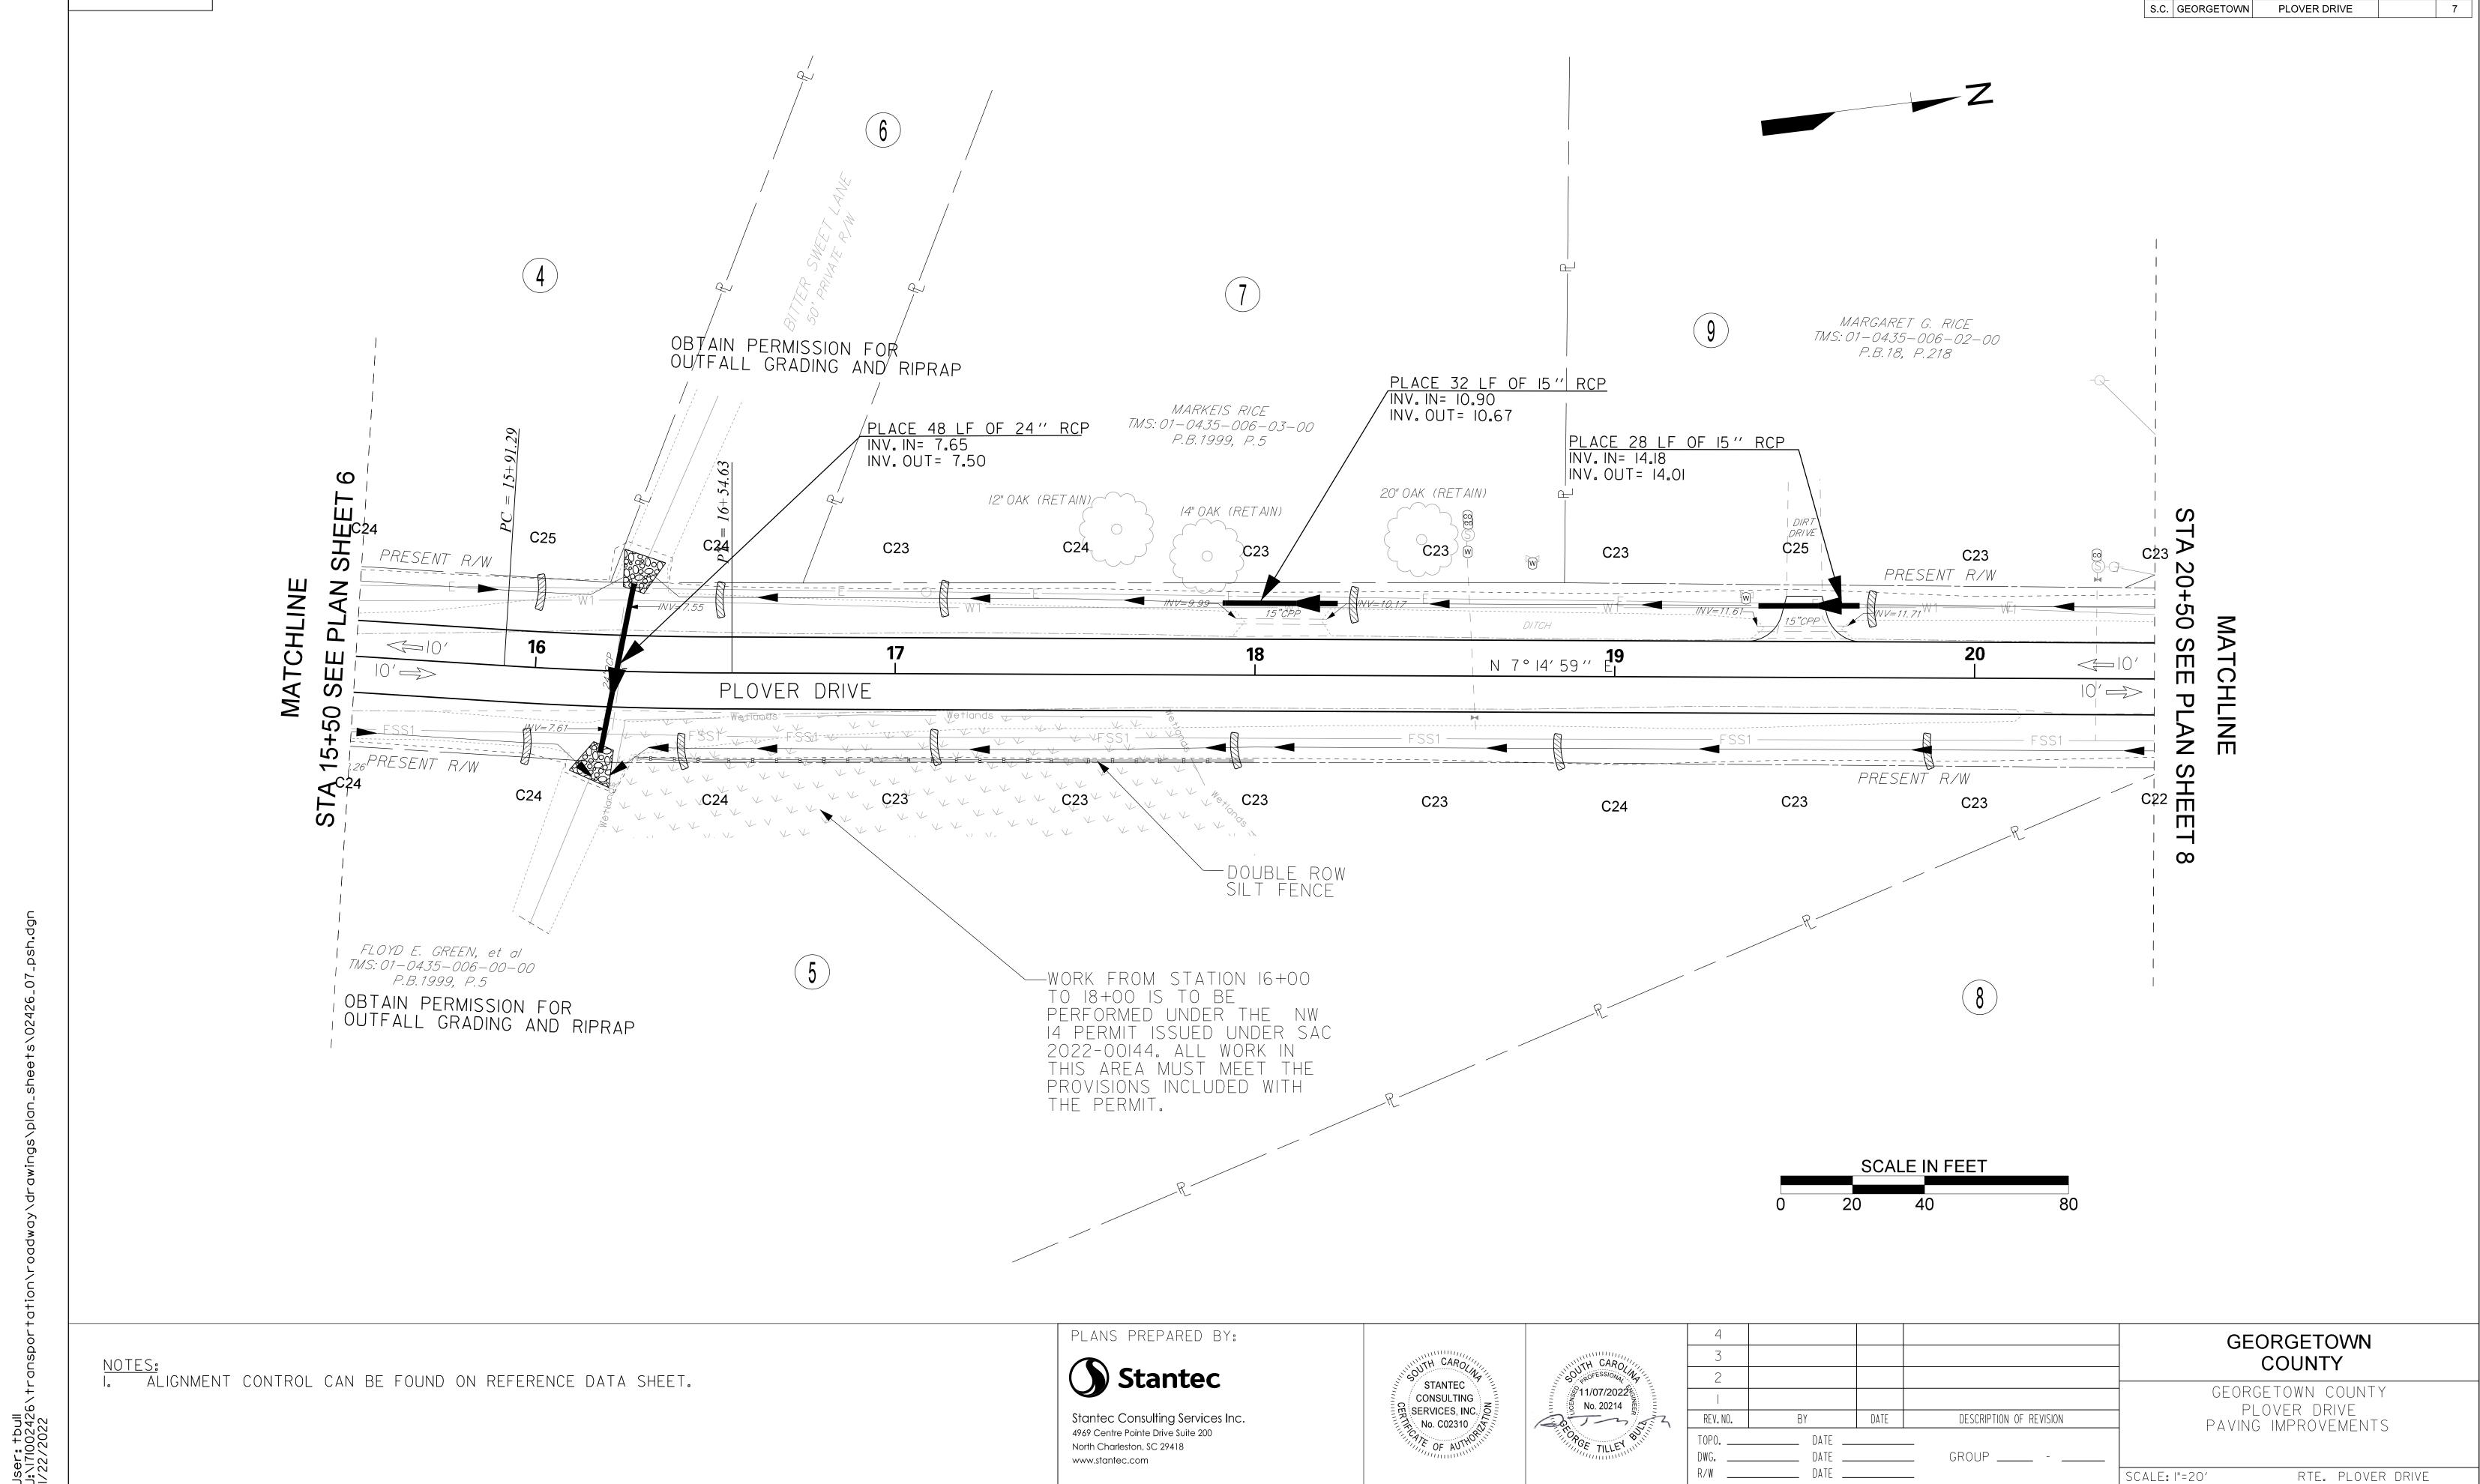
DATE DESCRIPTION OF REVISION GROUP _____ - ____

RTE. PLOVER DRIVE SCALE: N/A



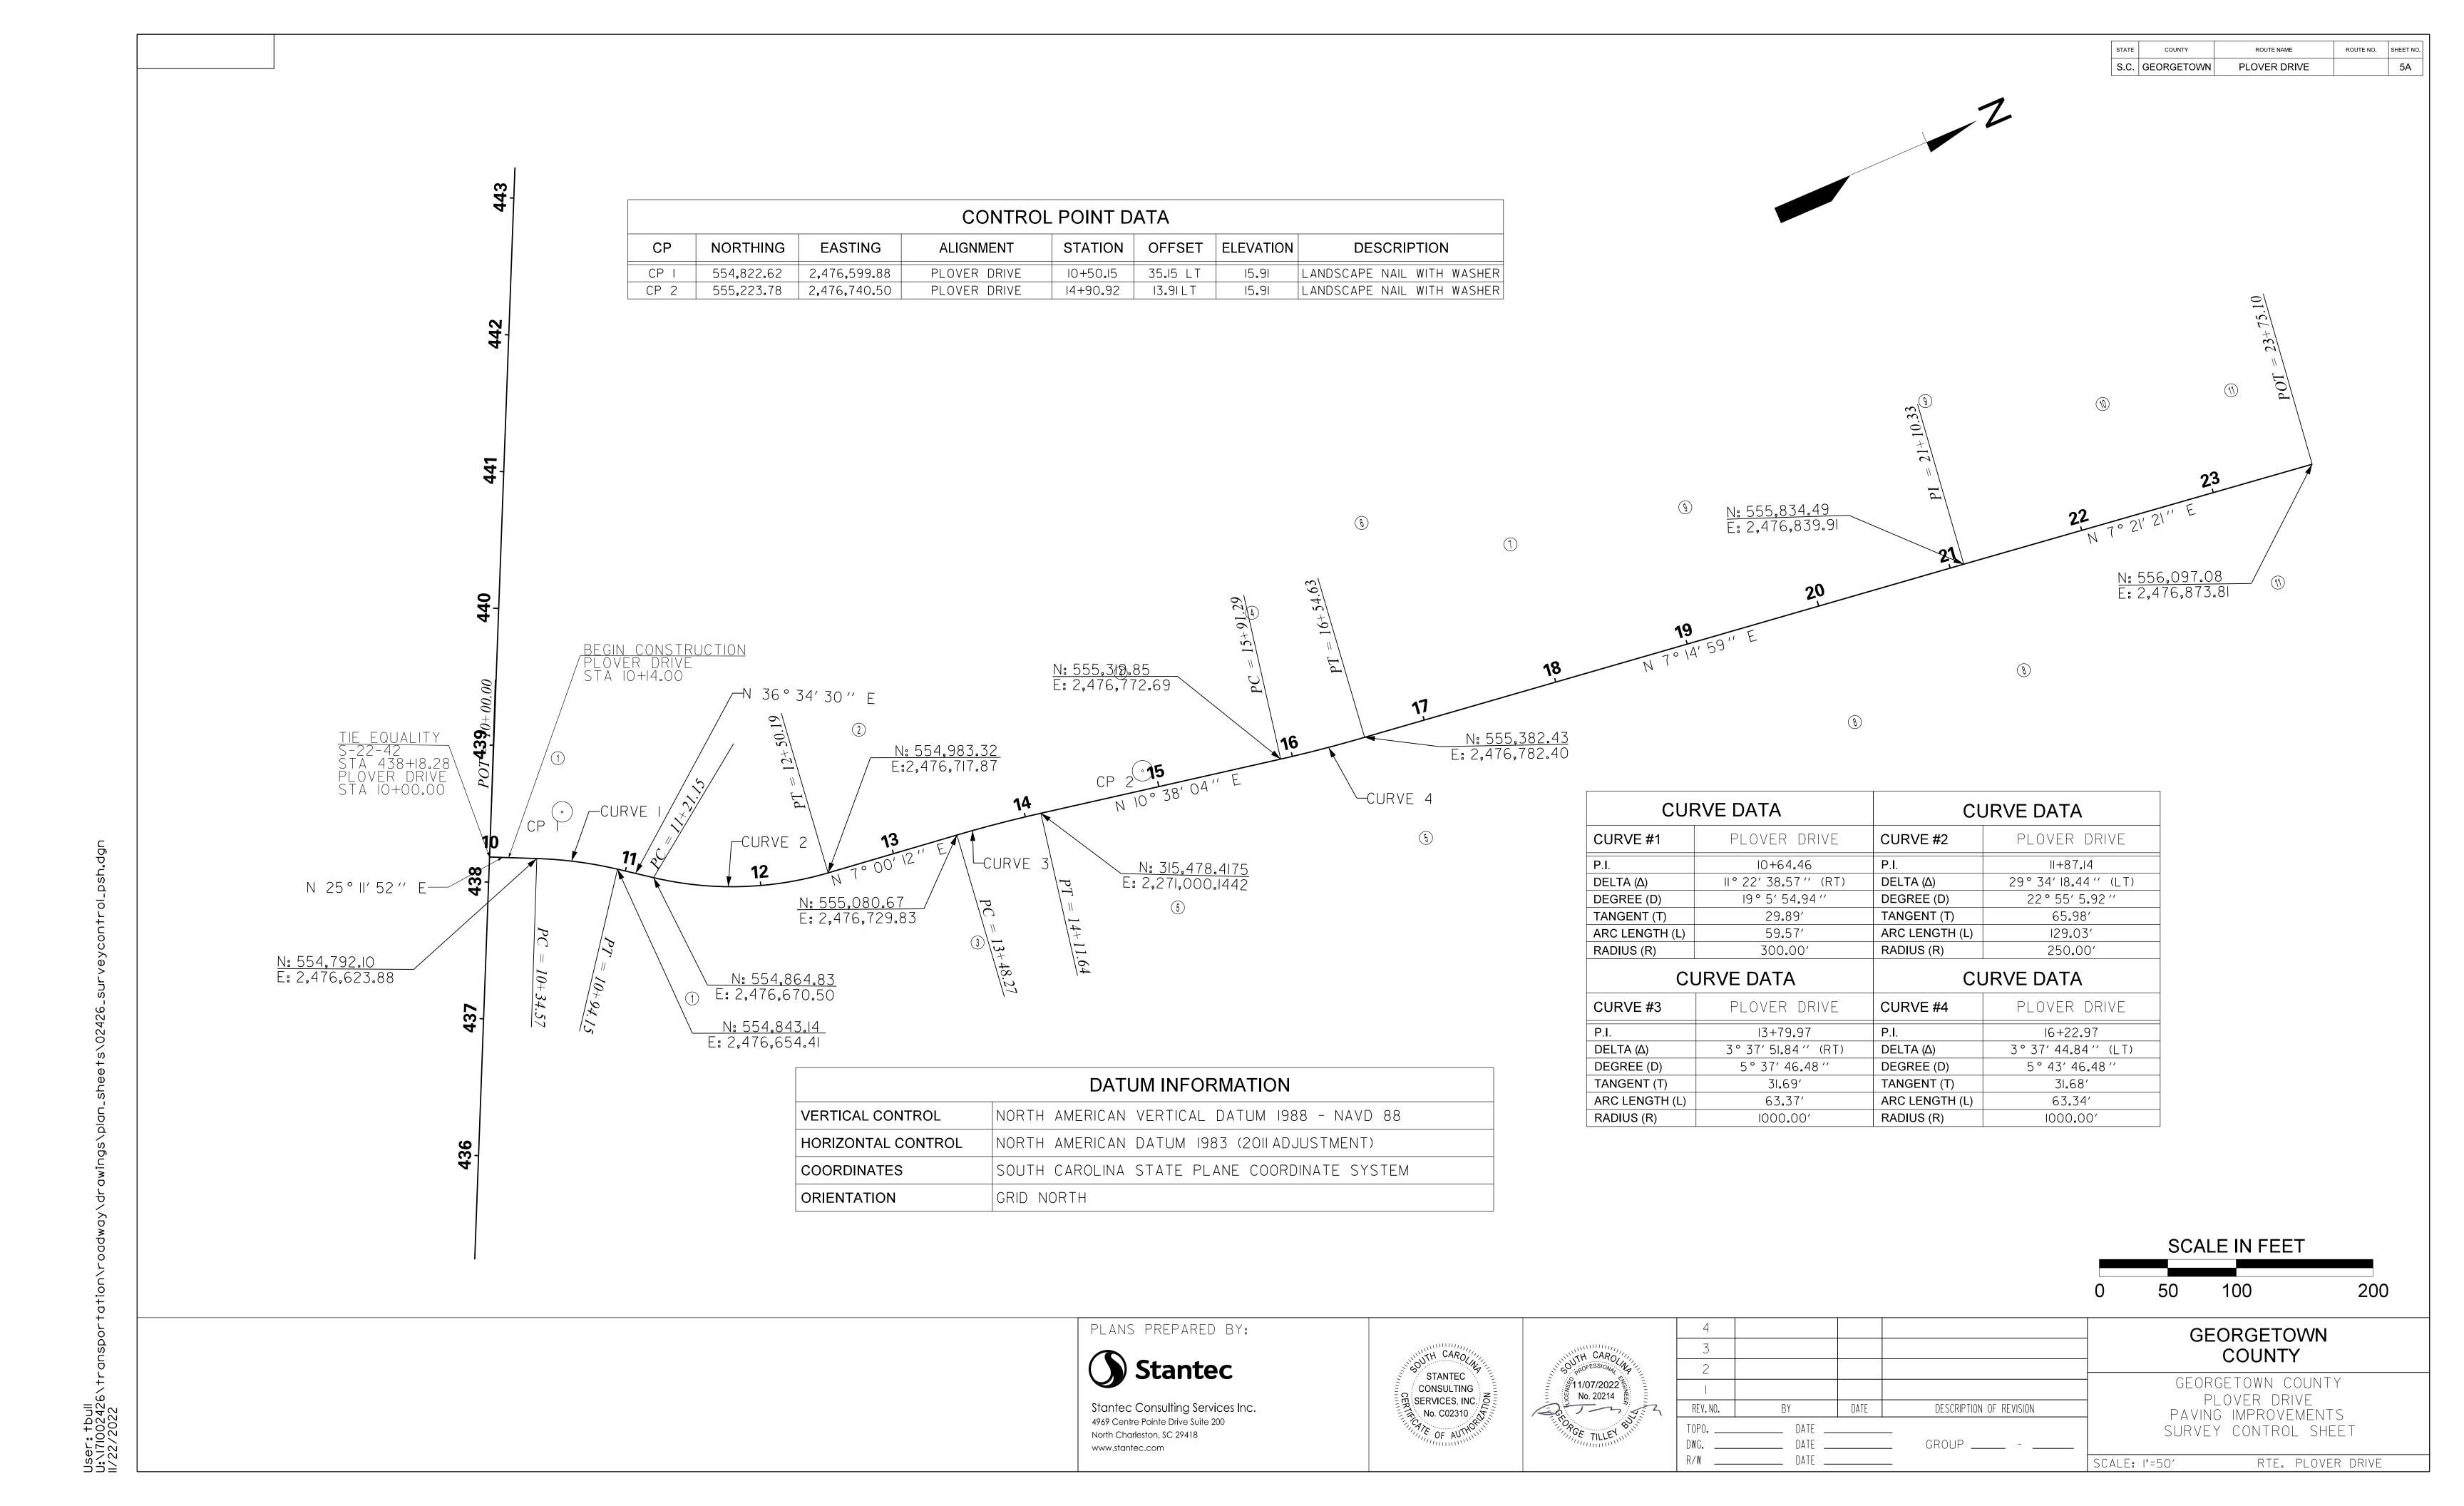

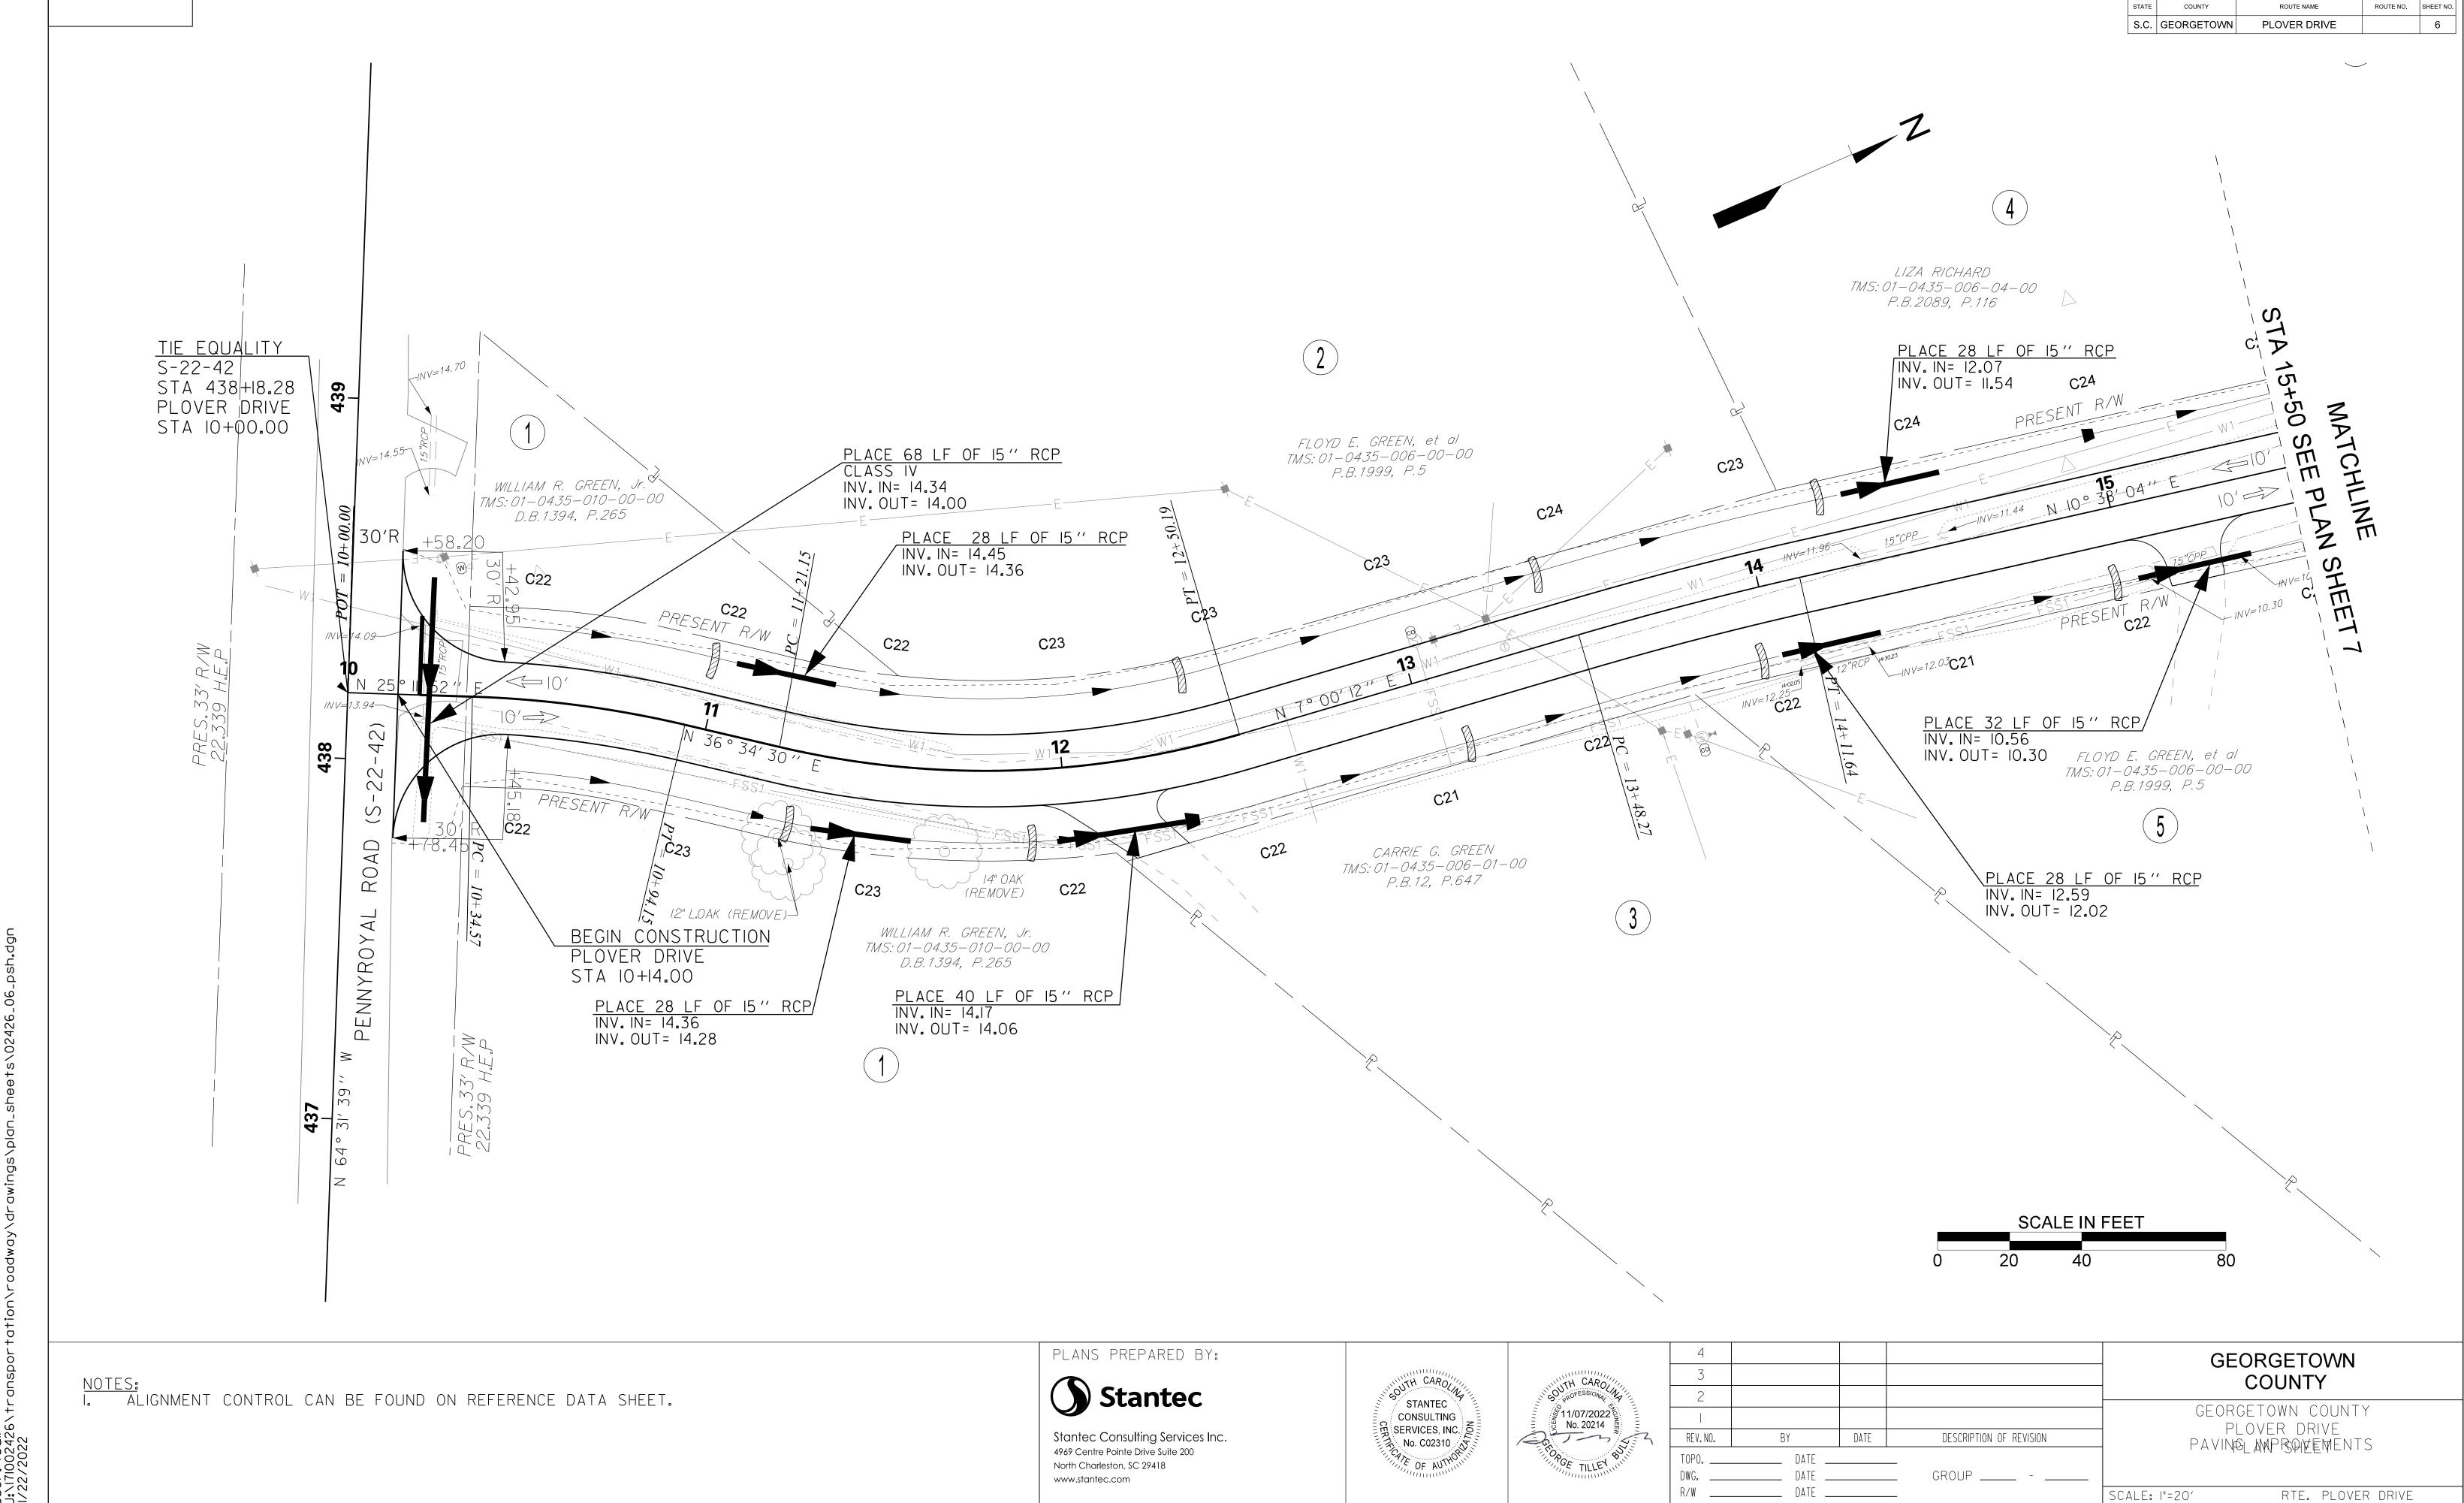
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ROUTE NO. SHEET NO.

ROUTE NAME



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ROUTE NO. SHEET NO.

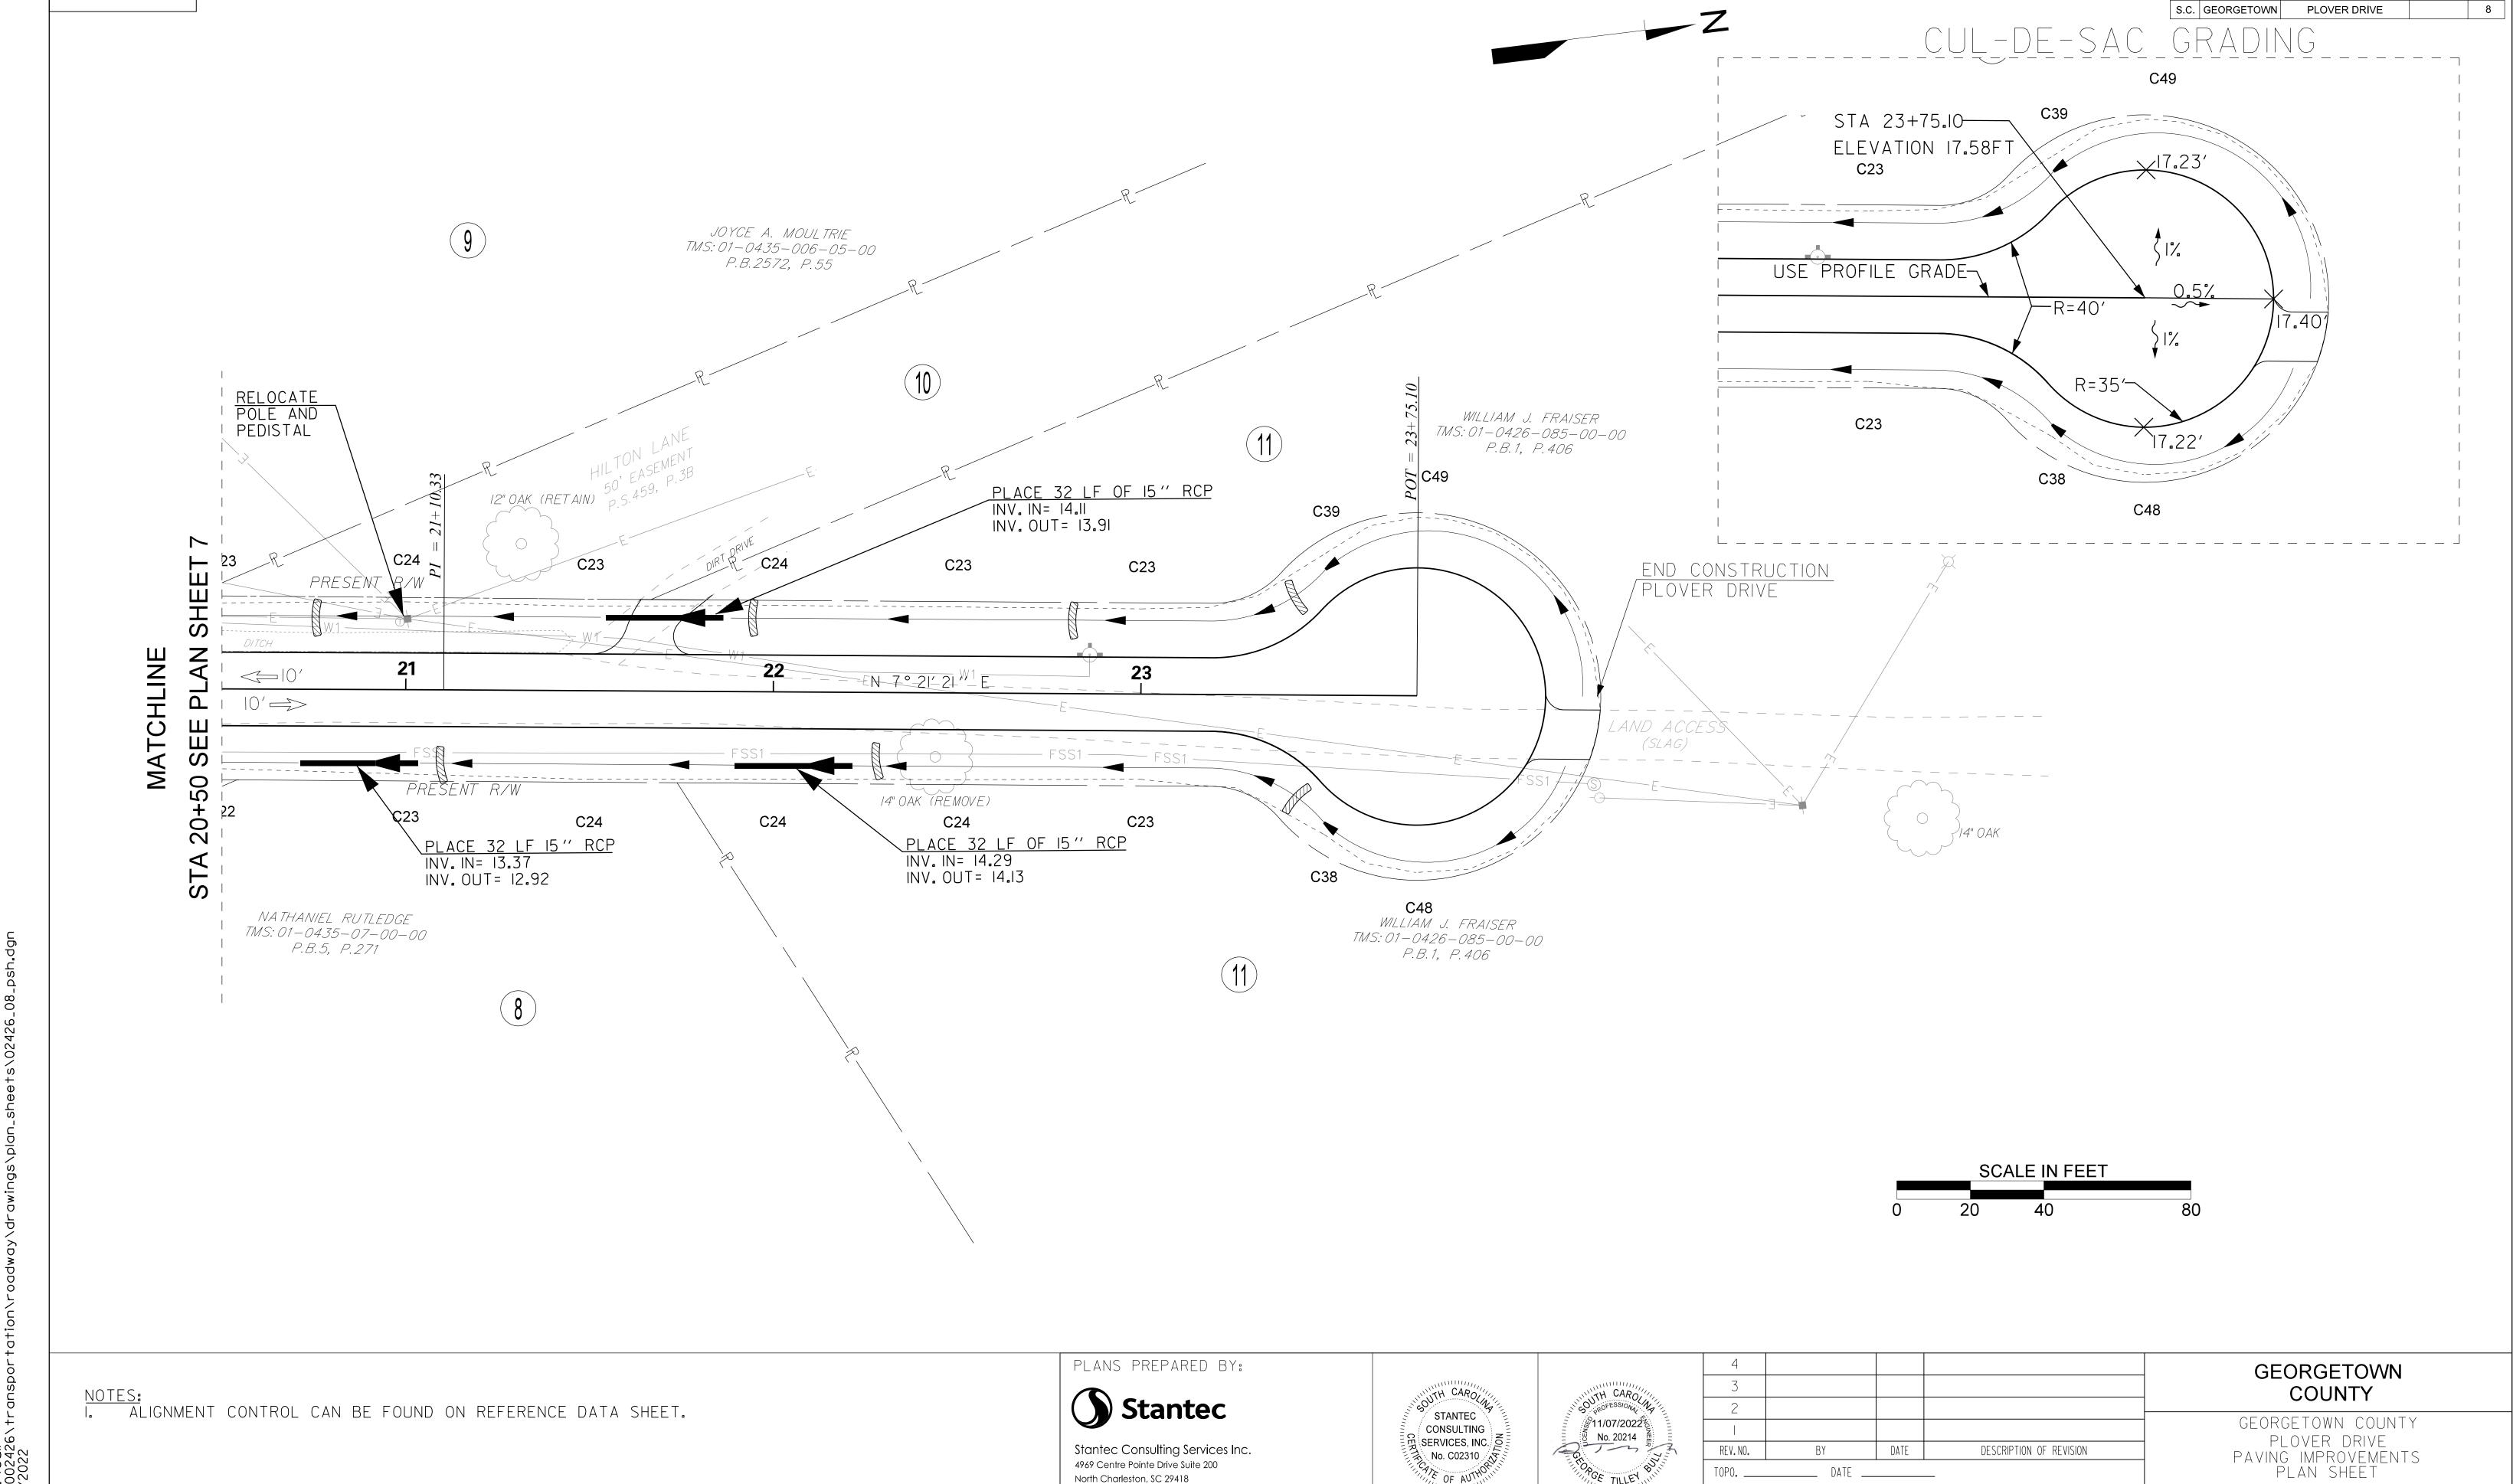
GROUP ____ - ___


SCALE: I"=20'

RTE. PLOVER DRIVE

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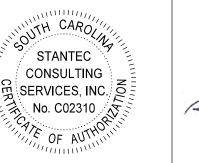


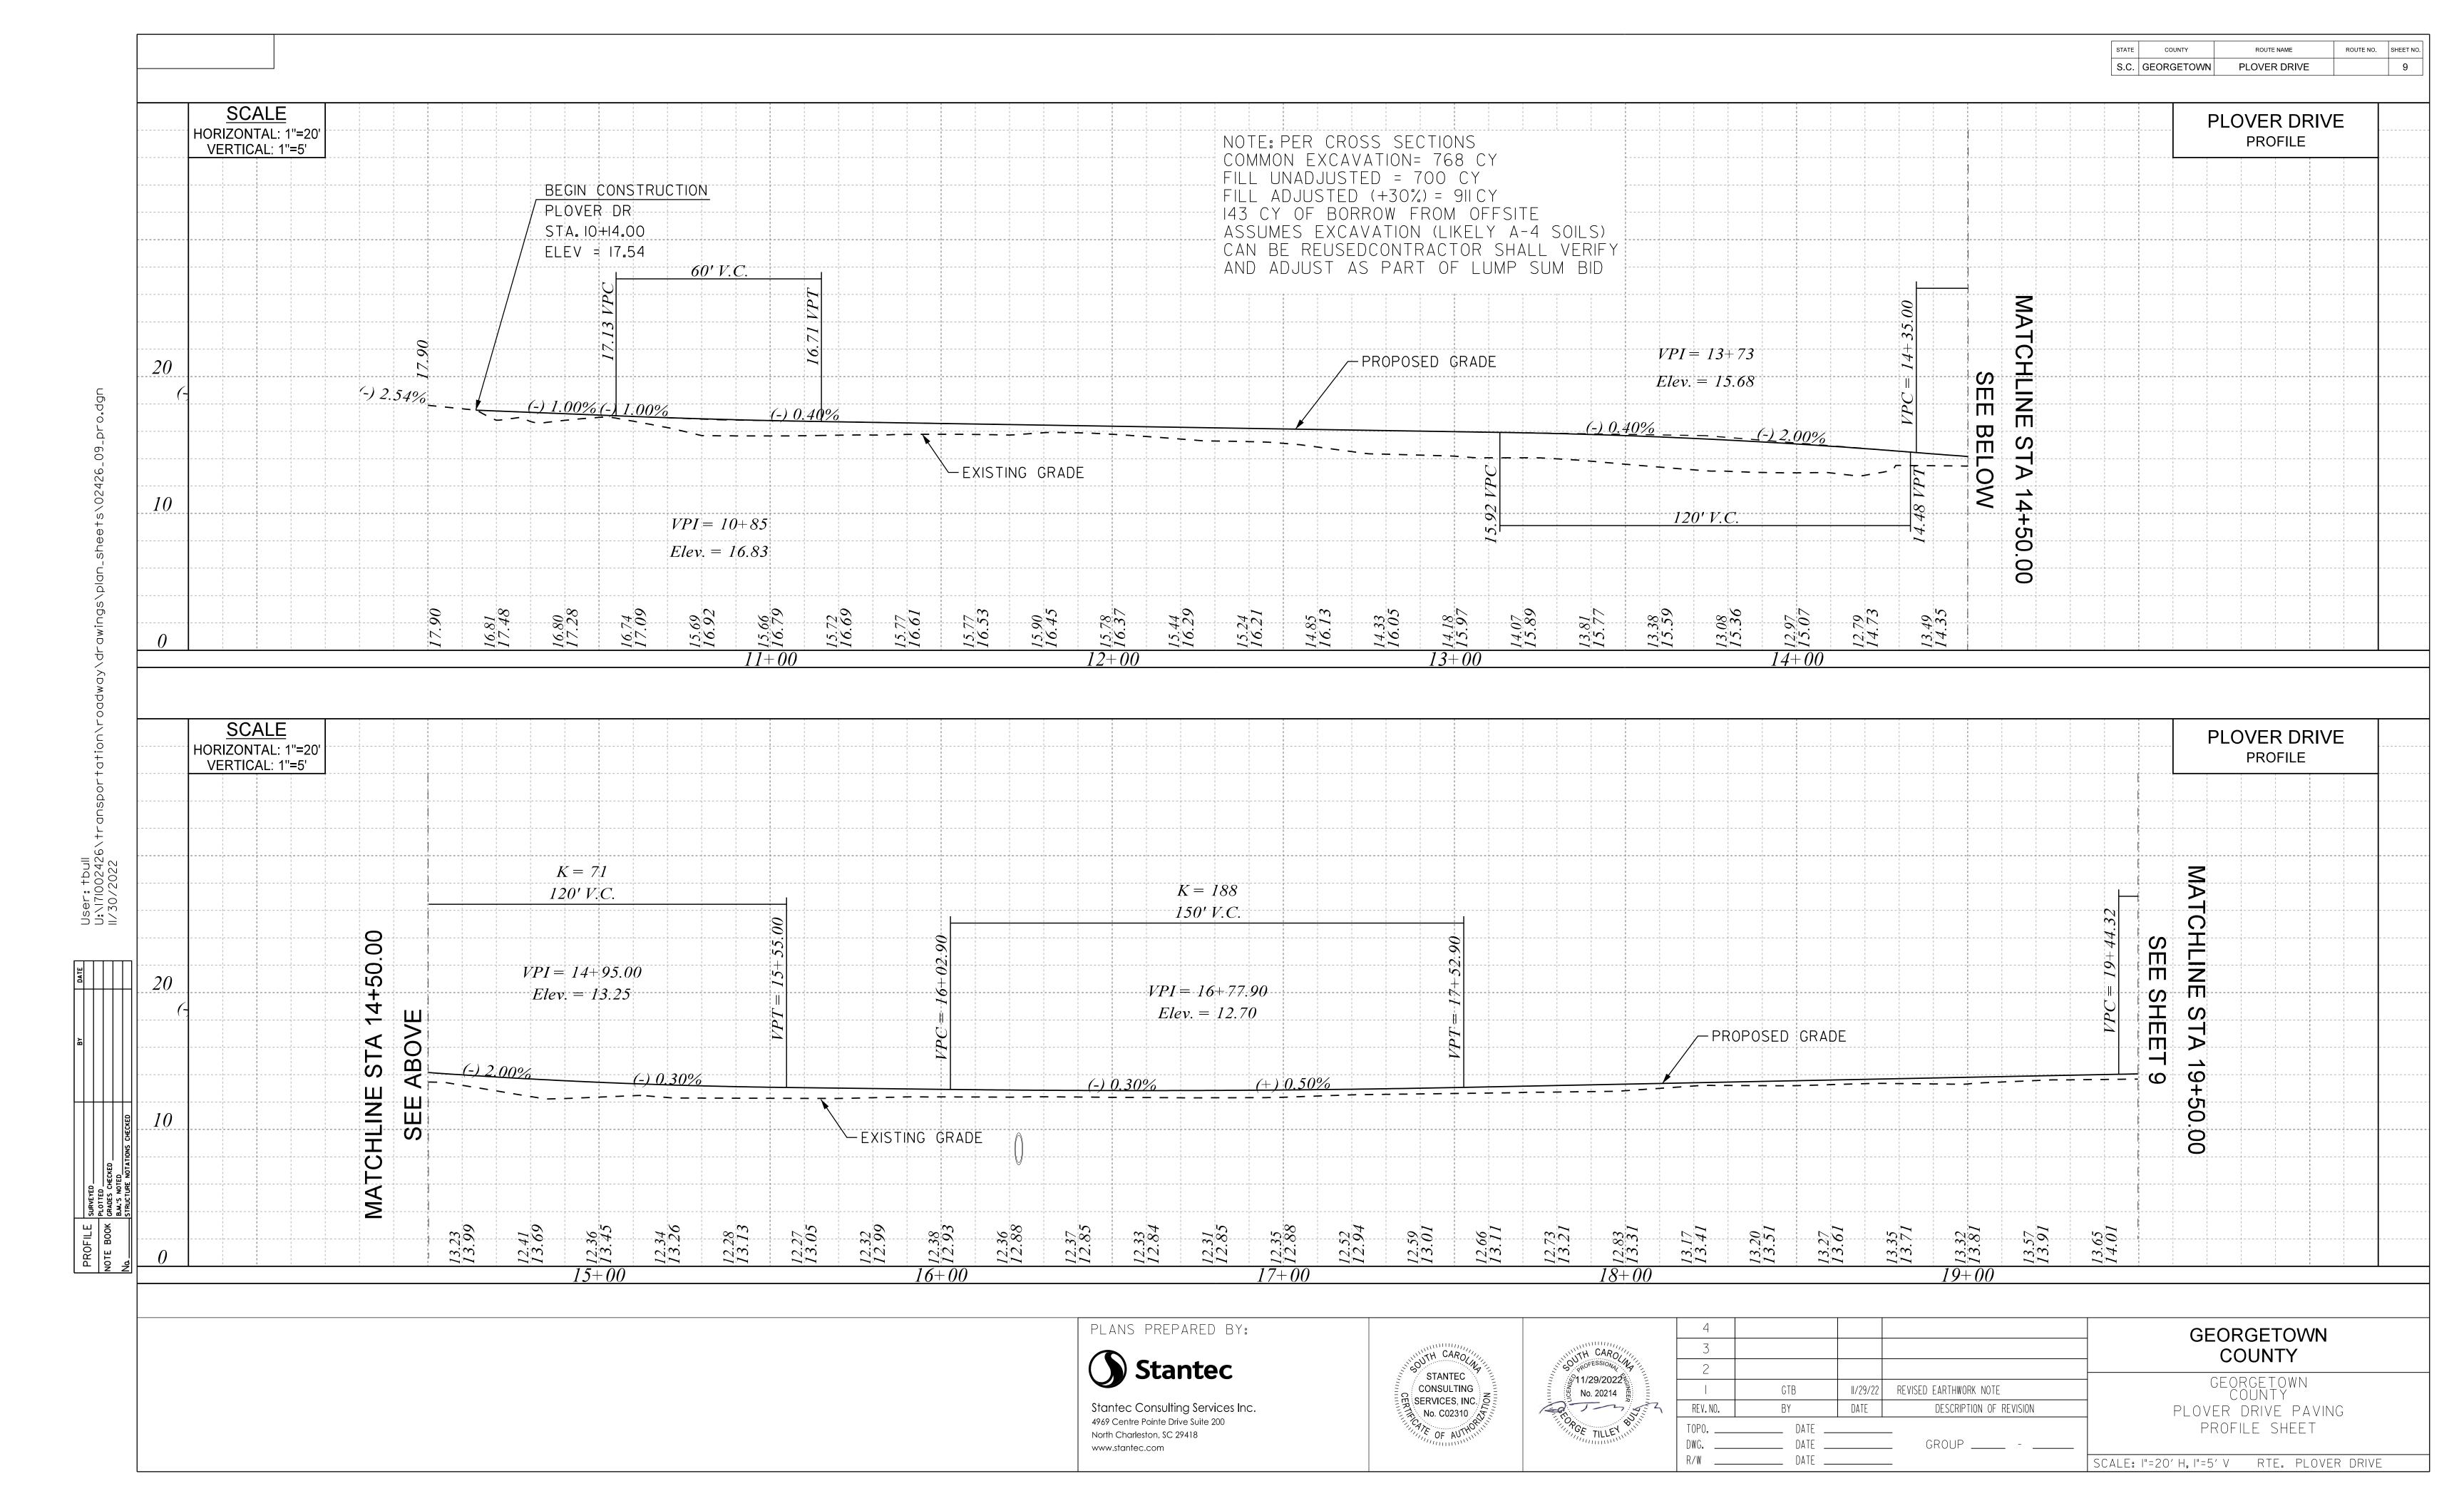

<u>notes:</u> I. Alignment control can be found on reference data sheet.

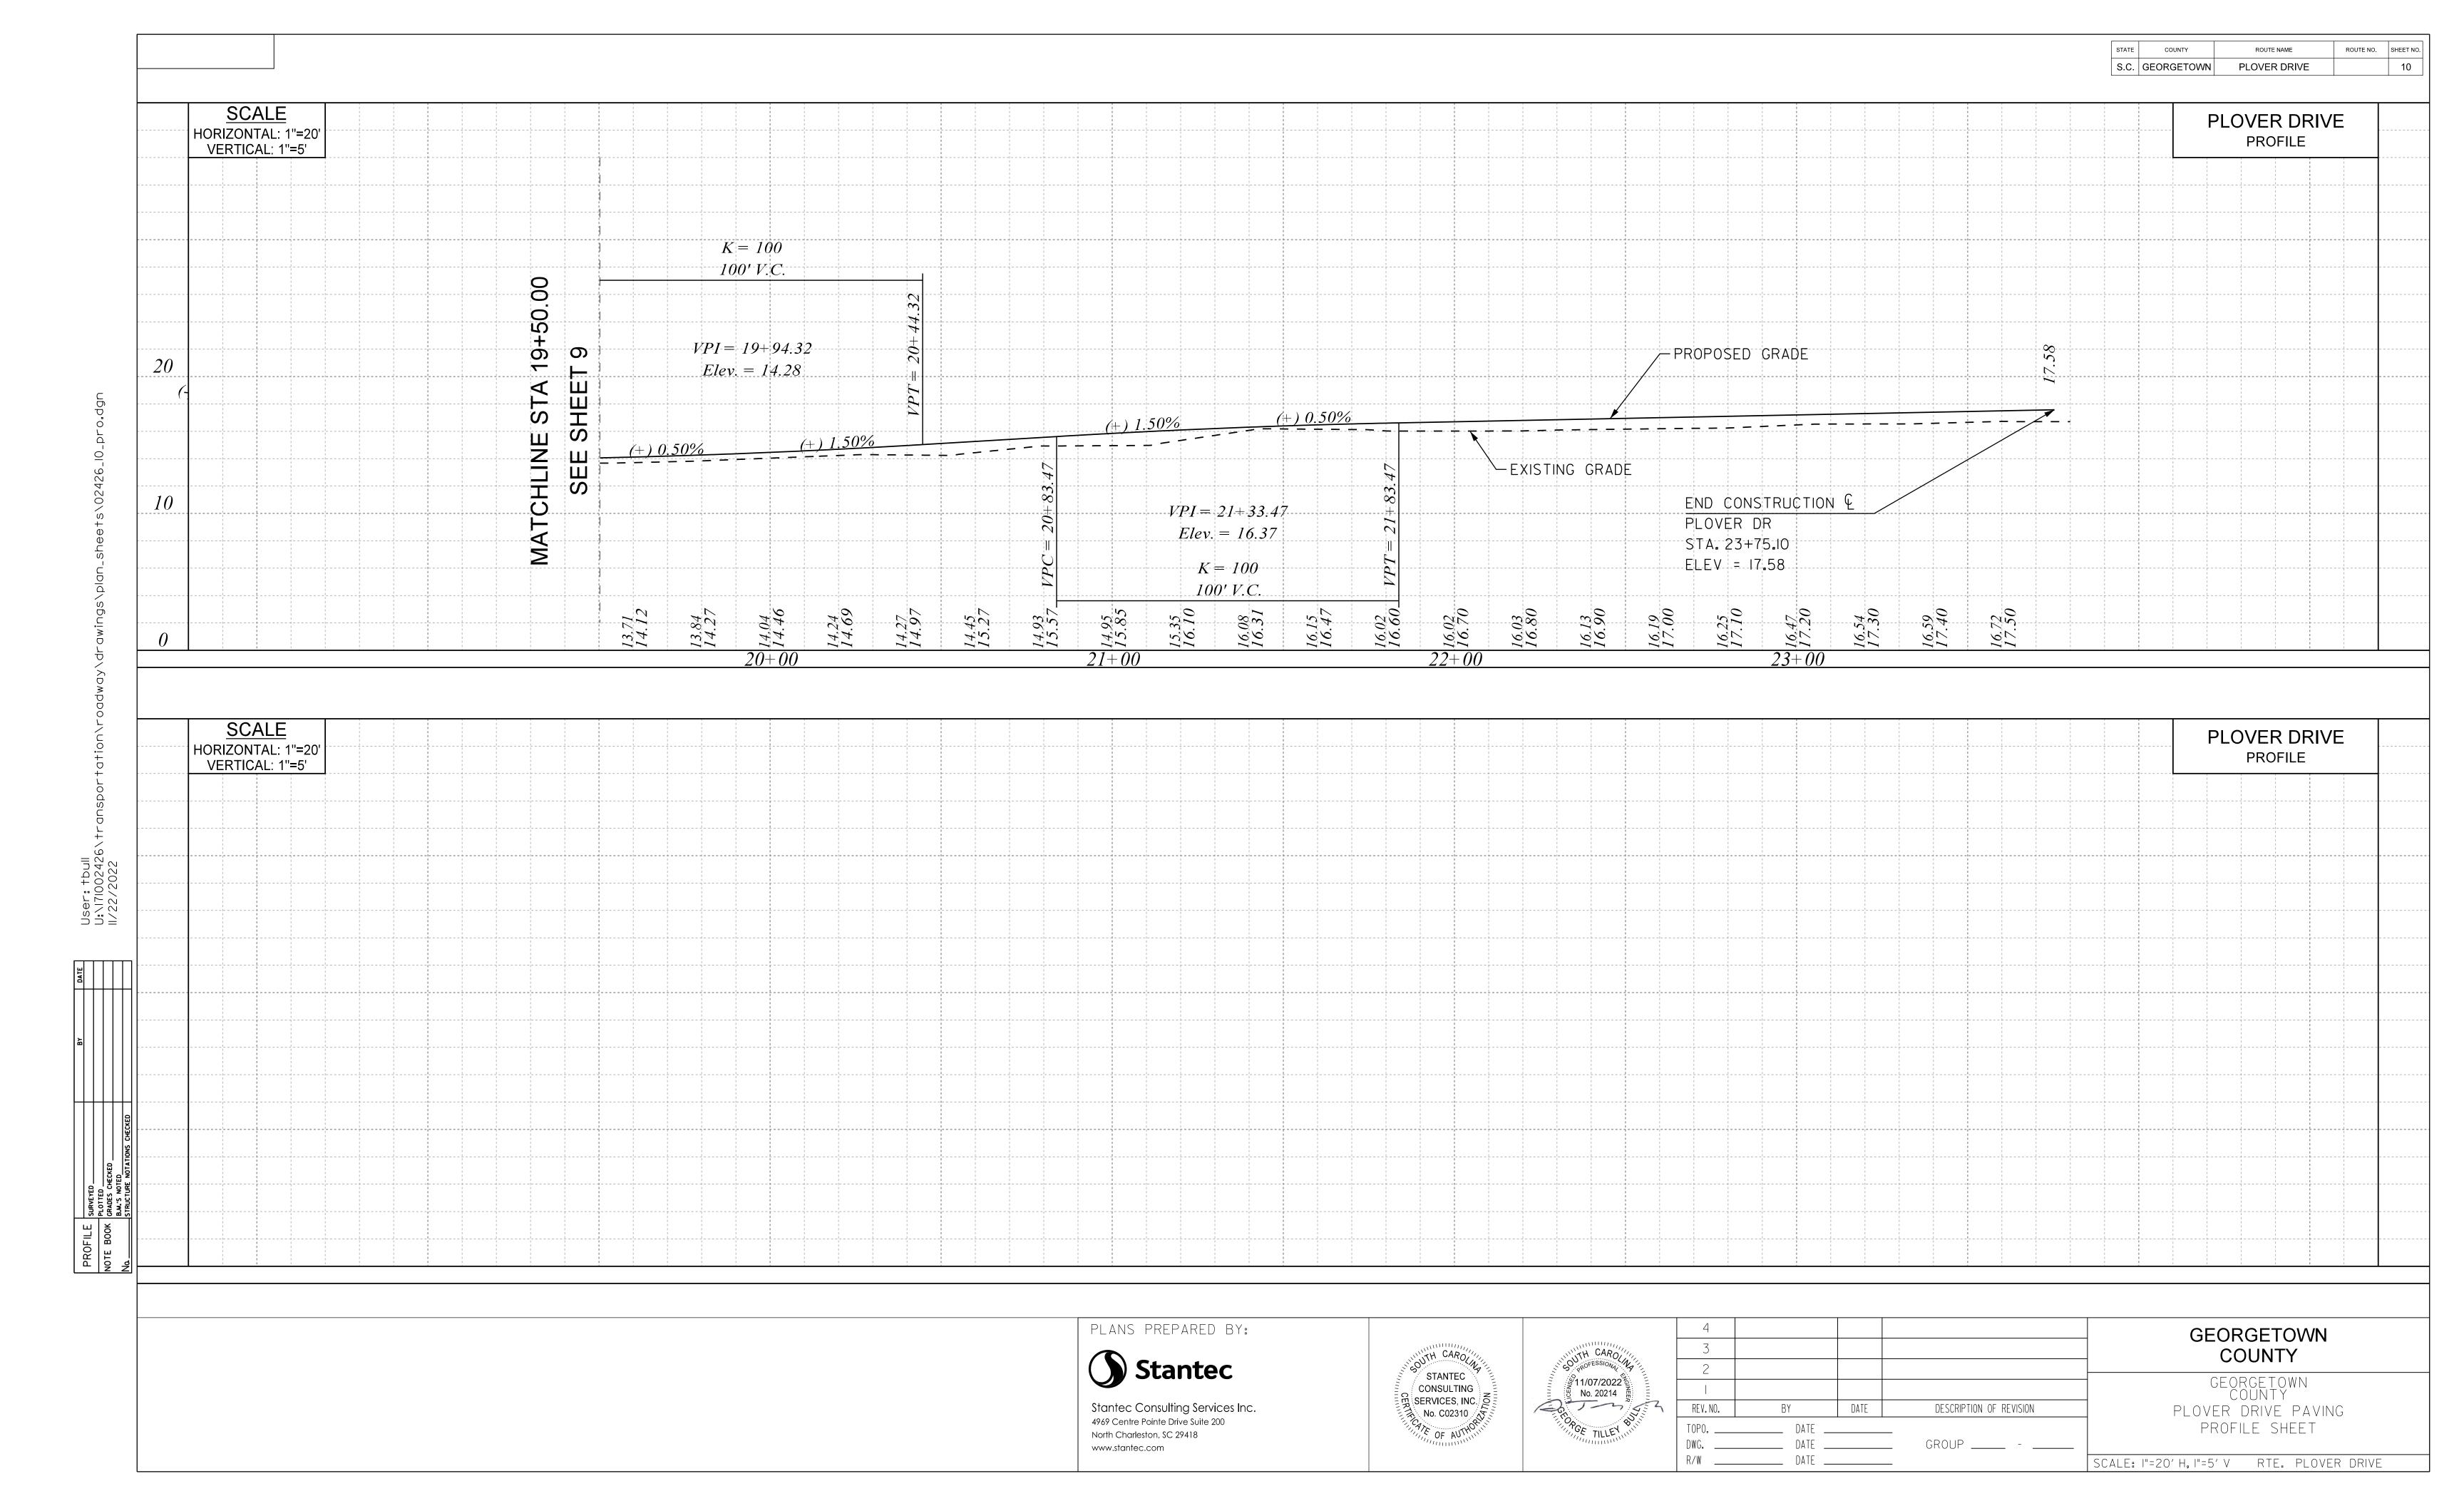

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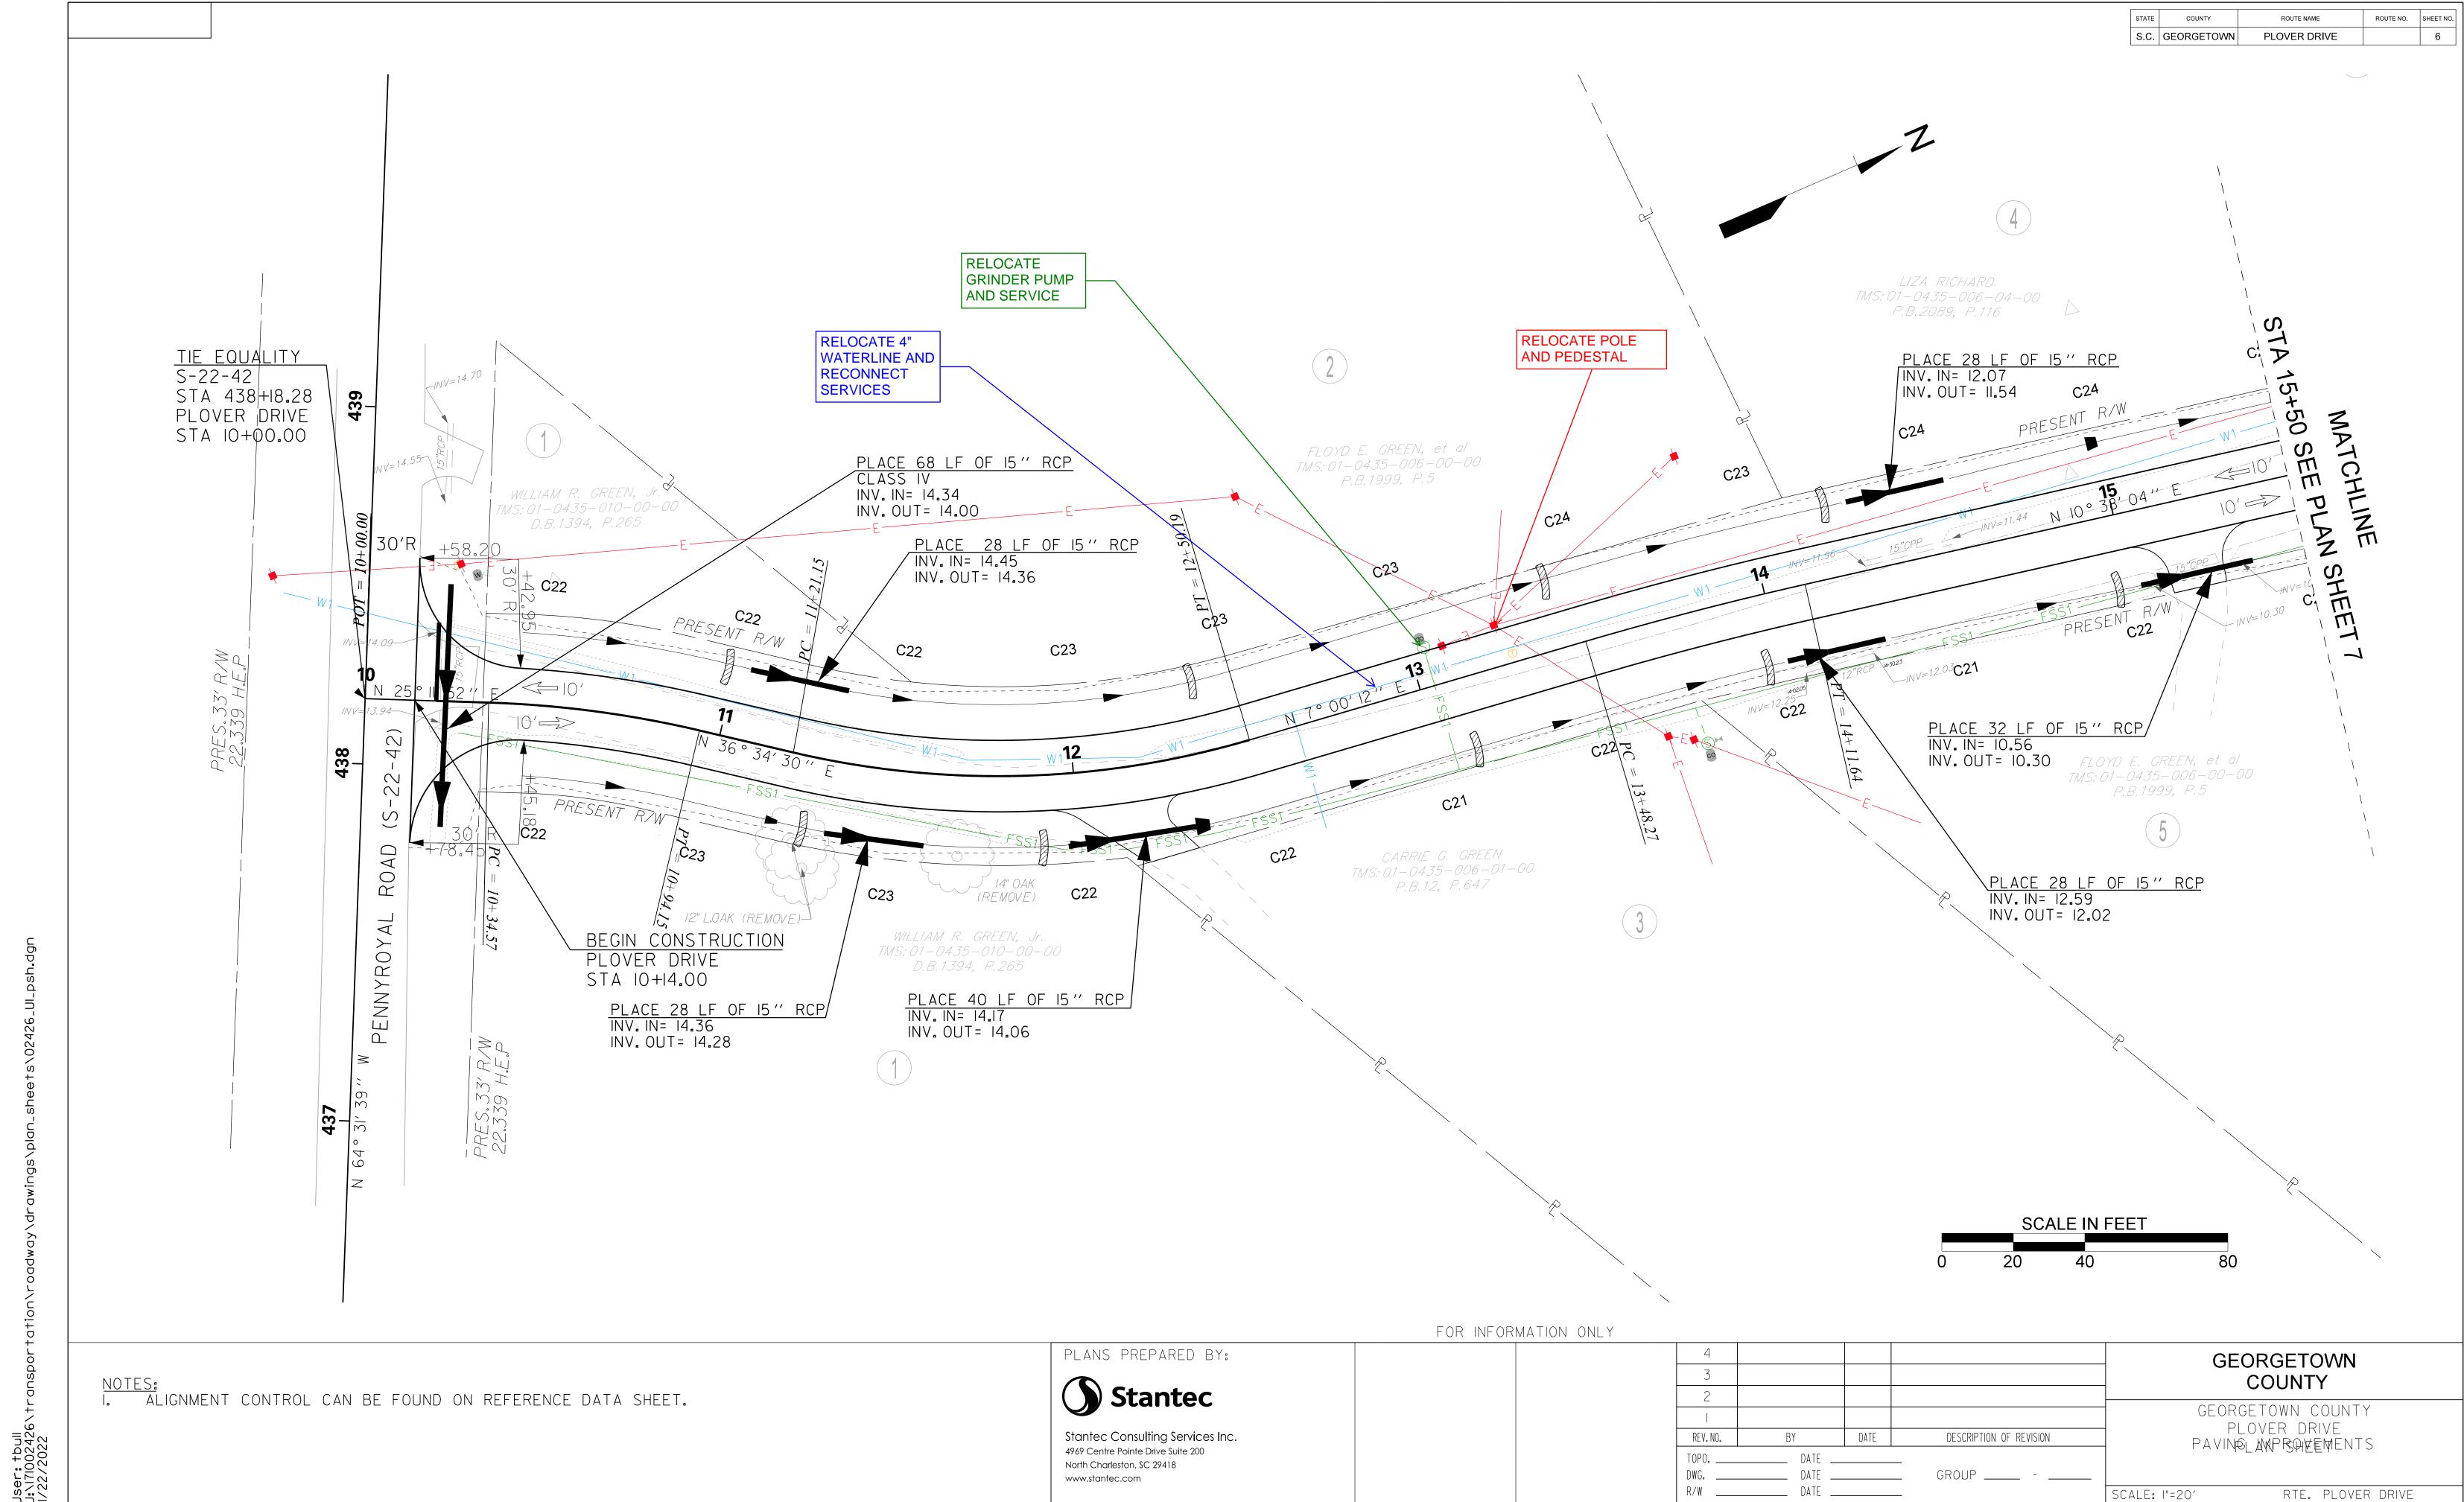
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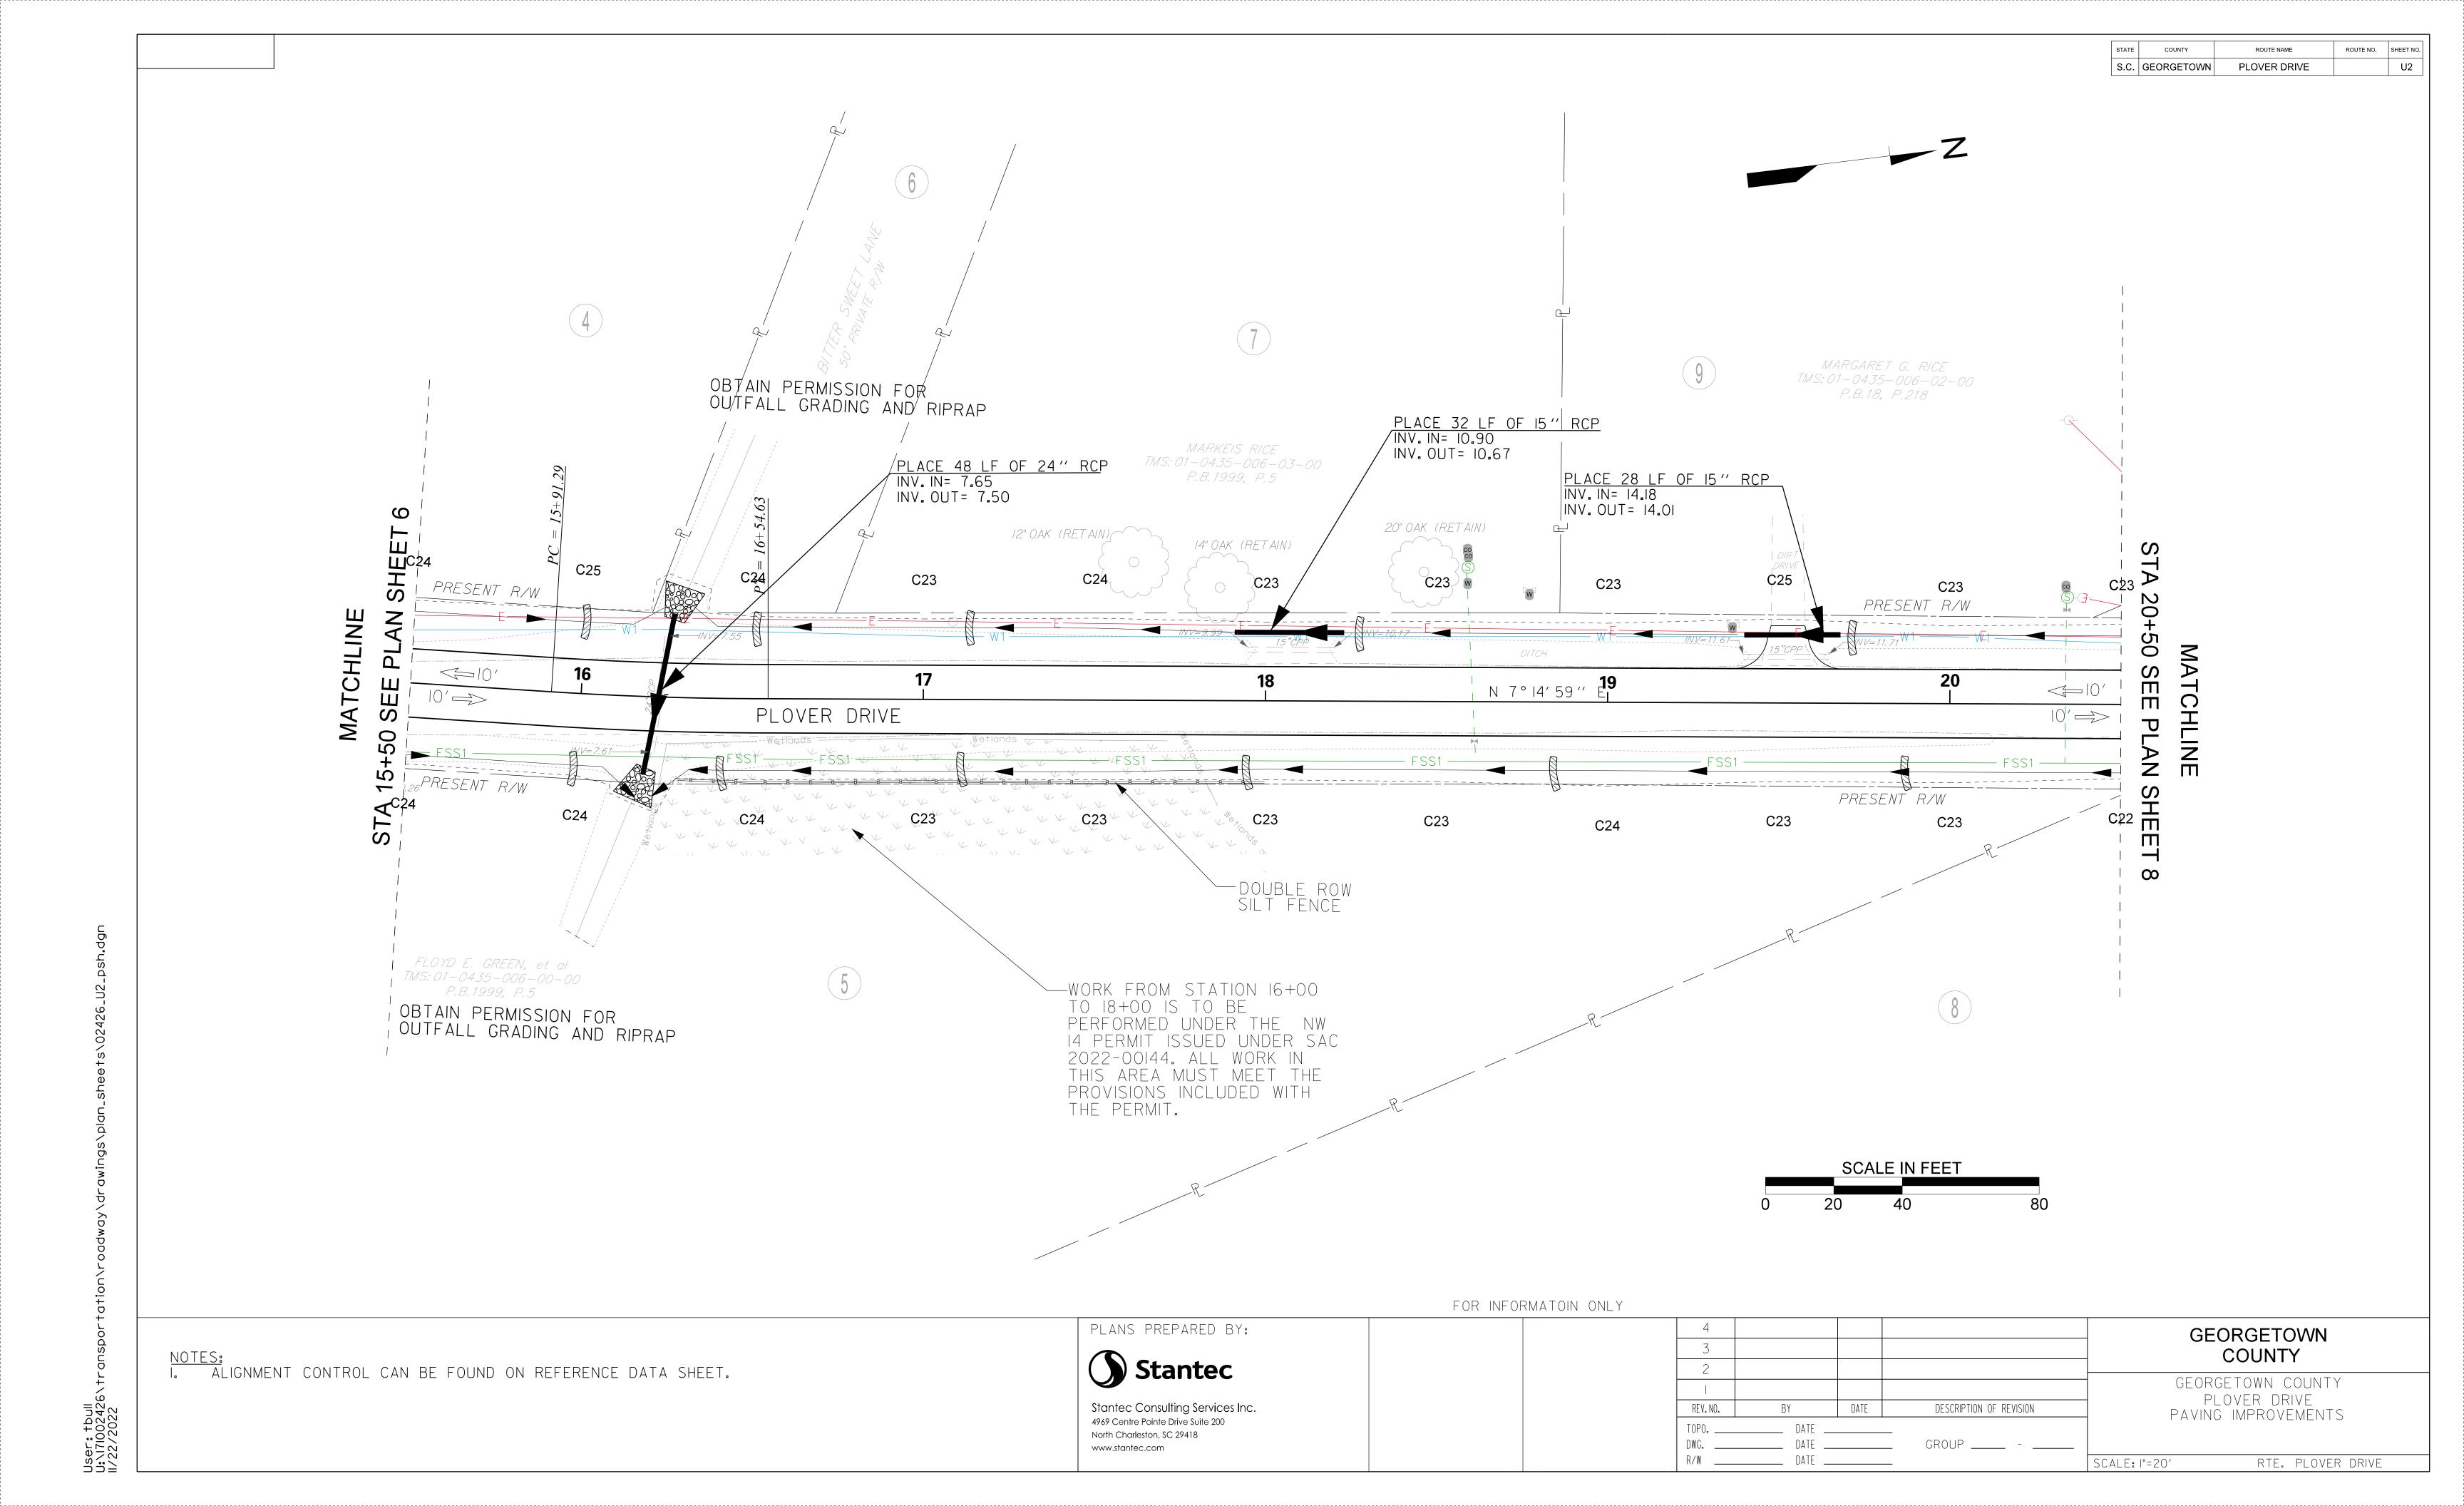
GEORGETOWN COUNTY

GEORGETOWN COUNTY
PLOVER DRIVE
PAVING IMPROVEMENTS
SIGNING AND PAVEMENT MARKING SHEET

SCALE: I"=20' RTE. PLOVER DRIVE

User: tbull





SCALE: I"=20'

RTE. PLOVER DRIVE

				RECEIVING	G	WATE	RS			
ROAD / OUTFALL DITCH			NAME OF RECEIVING	NAME OF ULTIMATE		ROAD /	OUTFALL DITCH		NAME OF RECEIVING	NAME OF ULTIMAT
ROUTE	STATION	SIDE	WATERS	RECEIVING WATERS		ROUTE	STATION	SIDE	WATERS	RECEIVING WATER
S-10-1766	40+30	RT	TRIB. OF BOHICKET	BOHICKET CREEK						
			CREEK							

		SOIL I	YPES			
ROAD / ROUTE	STAT TO STAT	0	SOIL PARTICLE SIZE (COARSE / FINE)	ZONE		
CHARLES	10+00	15+60	FINE	COASTAL		
BROWN RD						

TE	EMPOR	ARY El	ROS	SION CO	ONTROL	BLA	NKET	
ROAD / ROUTE	T	TATION TO SIDE		DEPTH OF BLANKET	DITCH BOTTOM	SLO x	MSY	
KOUIL	STA	ΓΙΟΝ		(FT)	WIDTH (FT)	FRONT	BACK	
							TOTAL	0.000
							IUIAL	0.000

S.C. GEORGETOWN PLOVER DRIVE

ROUTE NO. SHEET NO.

EC1

				TURF R	EINFOR	CED MATT	TNG (TRM)		
ROAD / ROUTE	STATION TO	SIDE	DEPTH OF MAT	(x	PES : 1)	DITCH BOTTOM	TYPE 1 (MSY)	TYPE 2 (MSY)	TYPE 3 (MSY)
ROOTE	STATION		(FT)	FRONT	BACK	WIDTH (FT)	(14151)	(MOT)	(1416 1)
						TOTALO	0.000	0.000	0.000
						TOTALS	0.000	0.000	0.000

	SEDIMENT DAM														
NO	ROAD / ROUTE	STATION SIDE	DRAINED OR NOT DRAINED	LENGTH OF SILT BASIN	WIDTH OF SILT BASIN	DAM HEIGHT	SIDE SLOPE OF SILT BASIN	SPILLWAY BOTTOM WIDTH	DAM BOTTOM WIDTH	RIP RAP CLASS	TOTAL STORAGE VOLUME	SEDIMENT STORAGE HEIGHT	OUTFALL CHANNEL WIDTH	OUTFALL CHANNEL DEPTH	OUTFALL CHANNEL LENGTH

	SEDIMENT TUBES IN DITCHES											
ROAD / ROUTE	STAT TO STAT	0	SIDE	AVERAGE LENGTH	SPACING (FT)	TOTAL	COMMENTS					
PLOVER	10+49	10+49	LT	12	0	12						
PLOVER	10+93	10+93	LT	12	150	36						
PLOVER	12+62	12+62	LT	12	150	36						
PLOVER	13+72	13+72	LT									
PLOVER	14+12	14+12	LT									
PLOVER	14+71	14+71	LT									
PLOVER	15+95	15+95	LT									
PLOVER	16+54	16+54	LT									
PLOVER	17+71	17+71	LT									
PLOVER	18+43	18+43	LT									
PLOVER	19+17	19+17	LT									
PLOVER	19+88	19+88	LT									
PLOVER	20+91	20+91	LT									
PLOVER	21+44	21+44	LT									
PLOVER	22+03	22+03	LT									
PLOVER	22+95	22+95	LT									
PLOVER	10+63	10+63	LT									
PLOVER	11+21	11+21	LT									
PLOVER	11+70	11+70	LT									
PLOVER	11+88	11+88	LT									
PLOVER	12+50	12+50	LT									
PLOVER	13+10	13+10	LT									
PLOVER	13+85	13+85	LT									
PLOVER	14+45	14+45	LT									
PLOVER	15+47	15+47	LT									
PLOVER	20+91	20+91	LT									
PLOVER	20+91	20+91	LT									
PLOVER	20+91	20+91	LT									
PLOVER	20+91	20+91	LT									
	GRAND TOTAL 84.000											

PLANS PREPARED BY:

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GEORGETOWN COUNTY

GEORGETOWN COUNTY
PLOVER DRIVE
PAVING IMPROVEMENTS
EROSION CONTROL DATA SHEET

SCALE: N/A RTE. PLOVER DRIVE

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North Charleston, SC 29418

STATE COUNTY ROUTE NAME ROUTE NO. SHEET NO. S.C. GEORGETOWN PLOVER DRIVE EC2

(EROSION CONTROL PLANS)

SCDHEC STANDARD NOTES

- I. IF NECESSARY, SLOPES, WHICH EXCEED EIGHT (8) VERTICAL FEET SHOULD BE STABILIZED WITH SYNTHETIC OR VEGETATIVE MATS, IN ADDITION TO HYDROSEEDING.IT
 MAY BE NECESSARY TO INSTALL TEMPORARY SLOPE DRAINS DURING CONSTRUCTION. TEMPORARY BERMS MAY BE NEEDED UNTIL THE SLOPE IS BROUGHT TO GRADE.
- 2. STABILIZATION MEASURES SHALL BE INITIATED AS SOON AS PRACTICABLE IN PORTIONS OF THE SITE WHERE CONSTRUCTION ACTIVITIES HAVE TEMPORARILY OR PERMANENTLY CEASED, BUT IN NO CASE MORE THAN FOURTEEN (14) DAYS AFTER WORK HAS CEASED, EXCEPT AS STATED BELOW.
 WHERE STABILIZATION BY THE 14TH DAY IS PRECLUDED BY SNOW COVER OR FROZEN GROUND CONDITIONS STABILIZATION MEASURES MUST BE INITIATED AS SOON
 - AS PRACTICABLE.
 WHERE CONSTRUCTION ACTIVITY ON A PORTION OF THE SITE IS TEMPORARILY CEASED, AND EARTH-DISTURBING ACTIVITIES WILL BE RESUMED WITHIN 14 DAYS, TEMPORARY STABILIZATION MEASURES DO NOT HAVE TO BE INITIATED ON THAT PORTION OF THE SITE.
- 3. ALL SEDIMENT AND EROSION CONTROL DEVICES SHALL BE INSPECTED ONCE EVERY CALENDAR WEEK.IF PERIODIC INSPECTION OR OTHER INFORMATION INDICATES THAT A BMP HAS BEEN INAPPROPRIATELY OR INCORRECTLY INSTALLED, THE PERMITTEE MUST ADDRESS THE NECESSARY REPLACEMENT OR MODIFICATION REQUIRED TO CORRECT THE BMP WITHIN 48 HOURS OF IDENTIFICATION.
- 4. PROVIDE SILT FENCE AND/OR OTHER CONTROL DEVICES, AS MAY BE REQUIRED, TO CONTROL SOIL EROSION DURING UTILITY CONSTRUCTION. ALL DISTURBED AREAS SHALL BE CLEANED, GRADED, AND STABILIZED WITH GRASSING IMMEDIATELY AFTER THE UTILITY INSTALLATION. FILL, COVER, AND TEMPORARY SEEDING AT THE END OF EACH DAY ARE RECOMMENDED. IF WATER IS ENCOUNTERED WHILE TRENCHING, THE WATER SHOULD BE FILTERED TO REMOVE SEDIMENT BEFORE BEING PUMPED BACK INTO ANY WATERS OF THE STATE.
- 5. ALL EROSION CONTROL DEVICES SHALL BE PROPERLY MAINTAINED DURING ALL PHASES OF CONSTRUCTION UNTIL THE COMPLETION OF ALL CONSTRUCTION ACTIVITIES AND ALL DISTURBED AREAS HAVE BEEN STABILIZED. ADDITIONAL CONTROL DEVICES MAY BE REQUIRED DURING CONSTRUCTION IN ORDER TO CONTROL EROSION AND/OR OFFSITE SEDIMENTATION. ALL TEMPORARY CONTROL DEVICES SHALL BE REMOVED ONCE CONSTRUCTION IS COMPLETE AND THE SITE IS STABILIZED.
- 6. THE CONTRACTOR MUST TAKE NECESSARY ACTION TO MINIMIZE THE TRACKING OF MUD ONTO PAVED ROADWAY(S) FROM CONSTRUCTION AREAS AND THE GENERATION OF DUST. THE CONTRACTOR SHALL DAILY REMOVE MUD/SOIL FROM PAVEMENT, AS MAY BE REQUIRED.
- 7. RESIDENTIAL SUBDIVISIONS REQUIRE EROSION CONTROL FEATURES FOR INFRASTRUCTURE AS WELL AS FOR INDIVIDUAL LOT CONSTRUCTION. INDIVIDUAL PROPERTY OWNERS SHALL FOLLOW THESE PLANS DURING CONSTRUCTION OR OBTAIN APPROVAL OF AN INDIVIDUAL PLAN IN ACCORDANCE WITH S.C REG. 72-300 ET SEQ. AND SCRIOOOOO.
- 8. TEMPORARY DIVERSION BERMS AND/OR DITCHES WILL BE PROVIDED AS NEEDED DURING CONSTRUCTION TO PROTECT WORK AREAS FROM UPSLOPE RUNOFF AND/OR TO DIVERT SEDIMENT-LADEN WATER TO APPROPRIATE TRAPS OR STABLE OUTLETS.
- 9. ALL WATERS OF THE STATE (WOS), INCLUDING WETLANDS, ARE TO BE FLAGGED OR OTHERWISE CLEARLY MARKED IN THE FIELD. A DOUBLE ROW OF SILT FENCE IS TO BE INSTALLED IN ALL AREAS WHERE A 50-FOOT BUFFER CAN'T BE MAINTAINED BETWEEN THE DISTURBED AREA AND ALL WOS. A 10-FOOT BUFFER SHOULD BE MAINTAINED BETWEEN THE LAST ROW OF SILT FENCE AND ALL WOS.
- IO. LITTER, CONSTRUCTION DEBRIS, OILS, FUELS, AND BUILDING PRODUCTS WITH SIGNIFICANT POTENTIAL FOR IMPACT (SUCH AS STOCKPILES OF FRESHLY TREATED LUMBER) AND CONSTRUCTION CHEMICALS THAT COULD BE EXPOSED TO STORM WATER MUST BE PREVENTED FROM BECOMING A POLLUTANT SOURCE IN STORM WATER DISCHARGES.
- II. A COPY OF THE SWPPP, INSPECTIONS RECORDS, AND RAINFALL DATA MUST BE RETAINED AT THE CONSTRUCTION SITE OR A NEARBY LOCATION EASILY ACCESSIBLE DURING NORMAL BUSINESS HOURS, FROM THE DATE OF COMMENCEMENT OF CONSTRUCTION ACTIVITIES TO THE DATE THAT FINAL STABILIZATION IS REACHED.
- 12. INITIATE STABILIZATION MEASURES ON ANY EXPOSED STEEP SLOPE (3H:IV OR GREATER) WHERE LAND-DISTURBING ACTIVITIES HAVE PERMANENTLY OR TEMPORARILY CEASED, AND WILL NOT RESUME FOR A PERIOD OF 7 CALENDAR DAYS.
- 13. MINIMIZE SOIL COMPACTION AND, UNLESS INFEASIBLE, PRESERVE TOPSOIL.
- 4. MINIMIZE THE DISCHARGE OF POLLUTANTS FROM EQUIPMENT AND VEHICLE WASHING, WHEEL WASH WATER, AND OTHER WASH WATERS. WASH WATERS MUST BE TREATED IN A SEDIMENT BASIN OR ALTERNATIVE CONTROL THAT PROVIDES EQUIVALENT OR BETTER TREATMENT PRIOR TO DISCHARGE;
- MINIMIZE THE DISCHARGE OF POLLUTANTS FROM DEWATERING OF TRENCHES AND EXCAVATED AREAS. THESE DISCHARGES ARE TO BE ROUTED THROUGH APPROPRIATE BMPS (SEDIMENT BASIN. FILTER BAG. ETC.).

SCDHEC STANDARD NOTES (CONTINUED)

- 16. THE FOLLOWING DISCHARGES FROM SITES ARE PROHIBITED:
 - -WASTEWATER FROM WASHOUT OF CONCRETE, UNLESS MANAGED BY AN APPROPRIATE CONTROL;
 -WASTEWATER FROM WASHOUT AND CLEANOUT OF STUCCO, PAINT, FORM RELEASE OILS, CURING COMPOUNDS AND OTHER CONSTRUCTION MATERIALS;
 - -FUELS, OILS, OR OTHER POLLUTANTS USED IN VEHICLE AND EQUIPMENT OPERATION AND MAINTENANCE; AND -SOAPS OR SOLVENTS USED IN VEHICLE AND EQUIPMENT WASHING.
- I7. AFTER CONSTRUCTION ACTIVITIES BEGIN, INSPECTIONS MUST BE CONDUCTED AT A MINIMUM OF AT LEAST ONCE EVERY CALENDAR WEEK AND MUST BE CONDUCTED UNTIL FINAL STABILIZATION IS REACHED ON ALL AREAS OF THE CONSTRUCTION SITE.
- IF EXISTING BMPS NEED TO BE MODIFIED OR IF ADDITIONAL BMPS ARE NECESSARY TO COMPLY WITH THE REQUIREMENTS OF THIS PERMIT AND/OR SCDHEC'S WATER QUALITY STANDARDS, IMPLEMENTATION MUST BE COMPLETED BEFORE THE NEXT STORM EVENT WHENEVER PRACTICABLE. IF IMPLEMENTATION BEFORE THE NEXT STORM EVENT IS IMPRACTICABLE, THE SITUATION MUST BE DOCUMENTED IN THE SWPPP AND ALTERNATIVE BMPS MUST BE IMPLEMENTED AS SOON AS REASONABLY POSSIBLE.
- 19. A PRE-CONSTRUCTION CONFERENCE MUST BE HELD FOR EACH CONSTRUCTION SITE WITH AN APPROVED ON-SITE SWPPP PRIOR TO THE IMPLEMENTATION OF CONSTRUCTION ACTIVITIES. FOR NON-LINEAR PROJECTS THAT DISTURB 10 ACRES OR MORE THIS CONFERENCE MUST BE HELD ON-SITE UNLESS THE DEPARTMENT HAS APPROVED OTHERWISE.

GENERAL CONSTRUCTION NOTES

- I. CONTACT GEORGETOWN COUNTY AND SCDOT 48 HOURS PRIOR TO COMMENCEMENT OF CONSTRUCTION.
- 2. CLEARING AND GRUBBING
 THE CONTRACTOR WILL BE REQUIRED TO CLEAR ALL AREAS NECESSARY FOR THE CONSTRUCTION OF ANY
 SEDIMENT DAMS AND INSTALL THE SEDIMENT DAMS AND ALL OTHER PERIMETER EROSION CONTROL
 MEASURES PRIOR TO CLEARING AND GRUBBING ACTIVITIES. ALSO, THE CONTRACTOR SHALL STAGE HIS
 CLEARING AND GRUBBING WORK ALONG WITH HIS ROADWAY CONSTRUCTION WORK TO MINIMIZE THE
 AMOUNT OF EROSION AND SEDIMENTATION. EROSION CONTROL MEASURES SHALL BE IMPLEMENTED
 DURING ALL STAGES OF CONSTRUCTION.
- 3. SEEDING
 SEEDING SHALL BE ACCOMPLISHED ACCORDING TO S.C.D.O.T. STANDARD SPECIFICATIONS FOR HIGHWAY CONSTRUCTION 2007 EDITION, SECTION 810.
- 4. EROSION CONTROL MEASURES
 ALL EROSION CONTROL MEASURES SHALL COMPLY WITH S.C.D.O.T. STANDARD DRAWINGS, STANDARD
 SPECIFICATIONS FOR HIGHWAY CONSTRUCTION, 2007 EDITION, AND THE SUPPLEMENTAL SPECIFICATIONS.
- STABILIZED CONSTRUCTION ENTRANCES
 STABILIZED CONSTRUCTION ENTRANCES SHALL BE LOCATED BY THE FIELD ENGINEER. STABILIZED
 CONSTRUCTION ENTRANCES SHALL BE LOCATED IN ANY AREAS WHERE CONSTRUCTION TRAFFIC WILL ENTER
 THE LIMITS OF DISTURBANCE. STABILIZED CONSTRUCTION ENTRANCES SHALL BE MAINTAINED THROUGHOUT
 THE PROJECT.

SEDIMENT AND EROSION CONTROL CONSTRUCTION SEQUENCE

- I. CONTACT GEORGETOWN COUNTY AND SCDOT 48 HOURS PRIOR TO COMMENCEMENT OF CONSTRUCTION.
- 2. CONSTRUCT STABILIZED CONSTRUCTION ENTRANCES.
- 3. CLEAR OUTER CONSTRUCTION LIMITS.
- 4. INSTALL PERIMETER EROSION CONTROL DEVICES.
 5. BEGIN GRADING AND STORM DRAINAGE CONSTRUCTION.
- 6. INSTALL INTERNAL TEMPORARY EROSION CONTROL DEVICES AS NEEDED DURING GRADING ACTIVITIES.
- 7. REMOVE BUILT- UP SEDIMENT AS NEEDED.
- 8. PLACE PERMANENT VEGETATION AS GRADING IS COMPLETED.
 9. REMOVE INTERNAL TEMPORARY EROSION CONTROL DEVICES FOR STABILIZED AREAS.
- IO. REMOVE INTERNAL TEMPORART EROSION CONTROL DEVICES.

R/W _____ DATE ____

II. CONTACT GEORGETOWN COUNTY AND SCOOT FOR FINAL INSPECTION AND CLOSEOUT.

PLANS PREPARED BY:

Stantec

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4969 Centre Pointe Drive Suite 200

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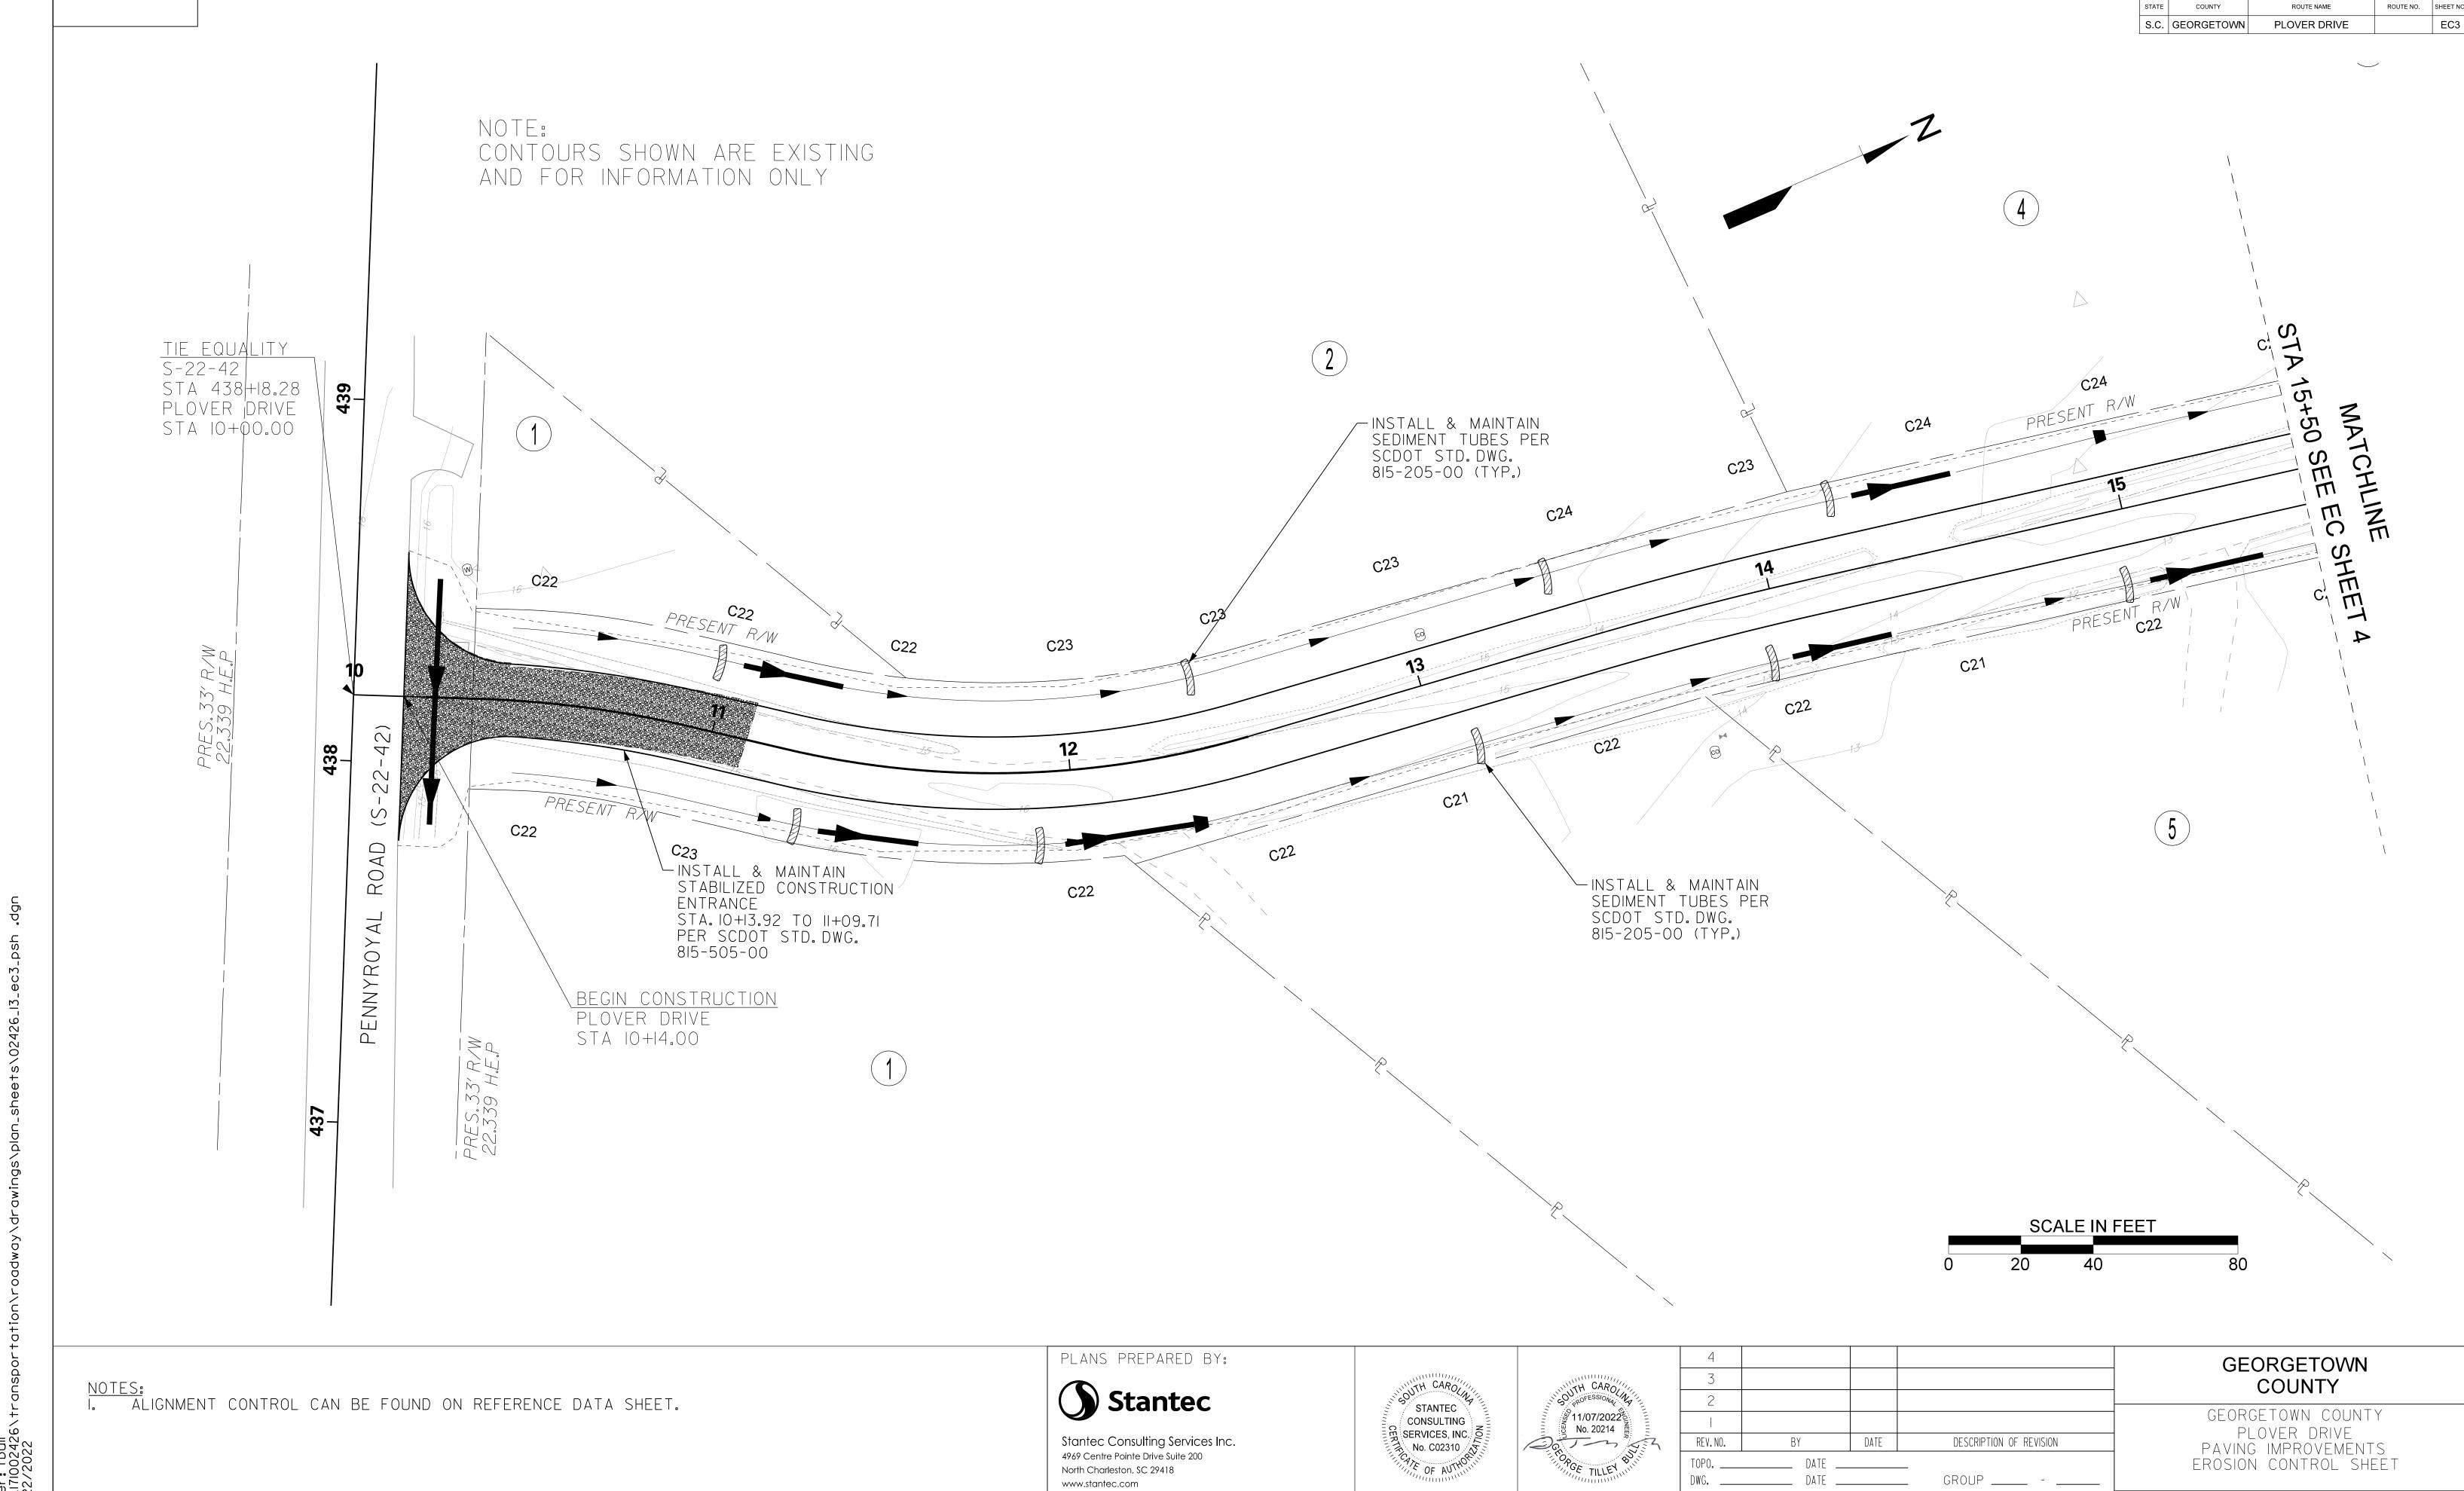
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GEORGETOWN COUNTY

GEORGETOWN COUNTY
PLOVER DRIVE
PAVING IMPROVEMENTS
EROSION CONTROL NOTES


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SCALE: I"=20'


RTE. PLOVER DRIVE



SCALE: I"=20'

RTE. PLOVER DRIVE

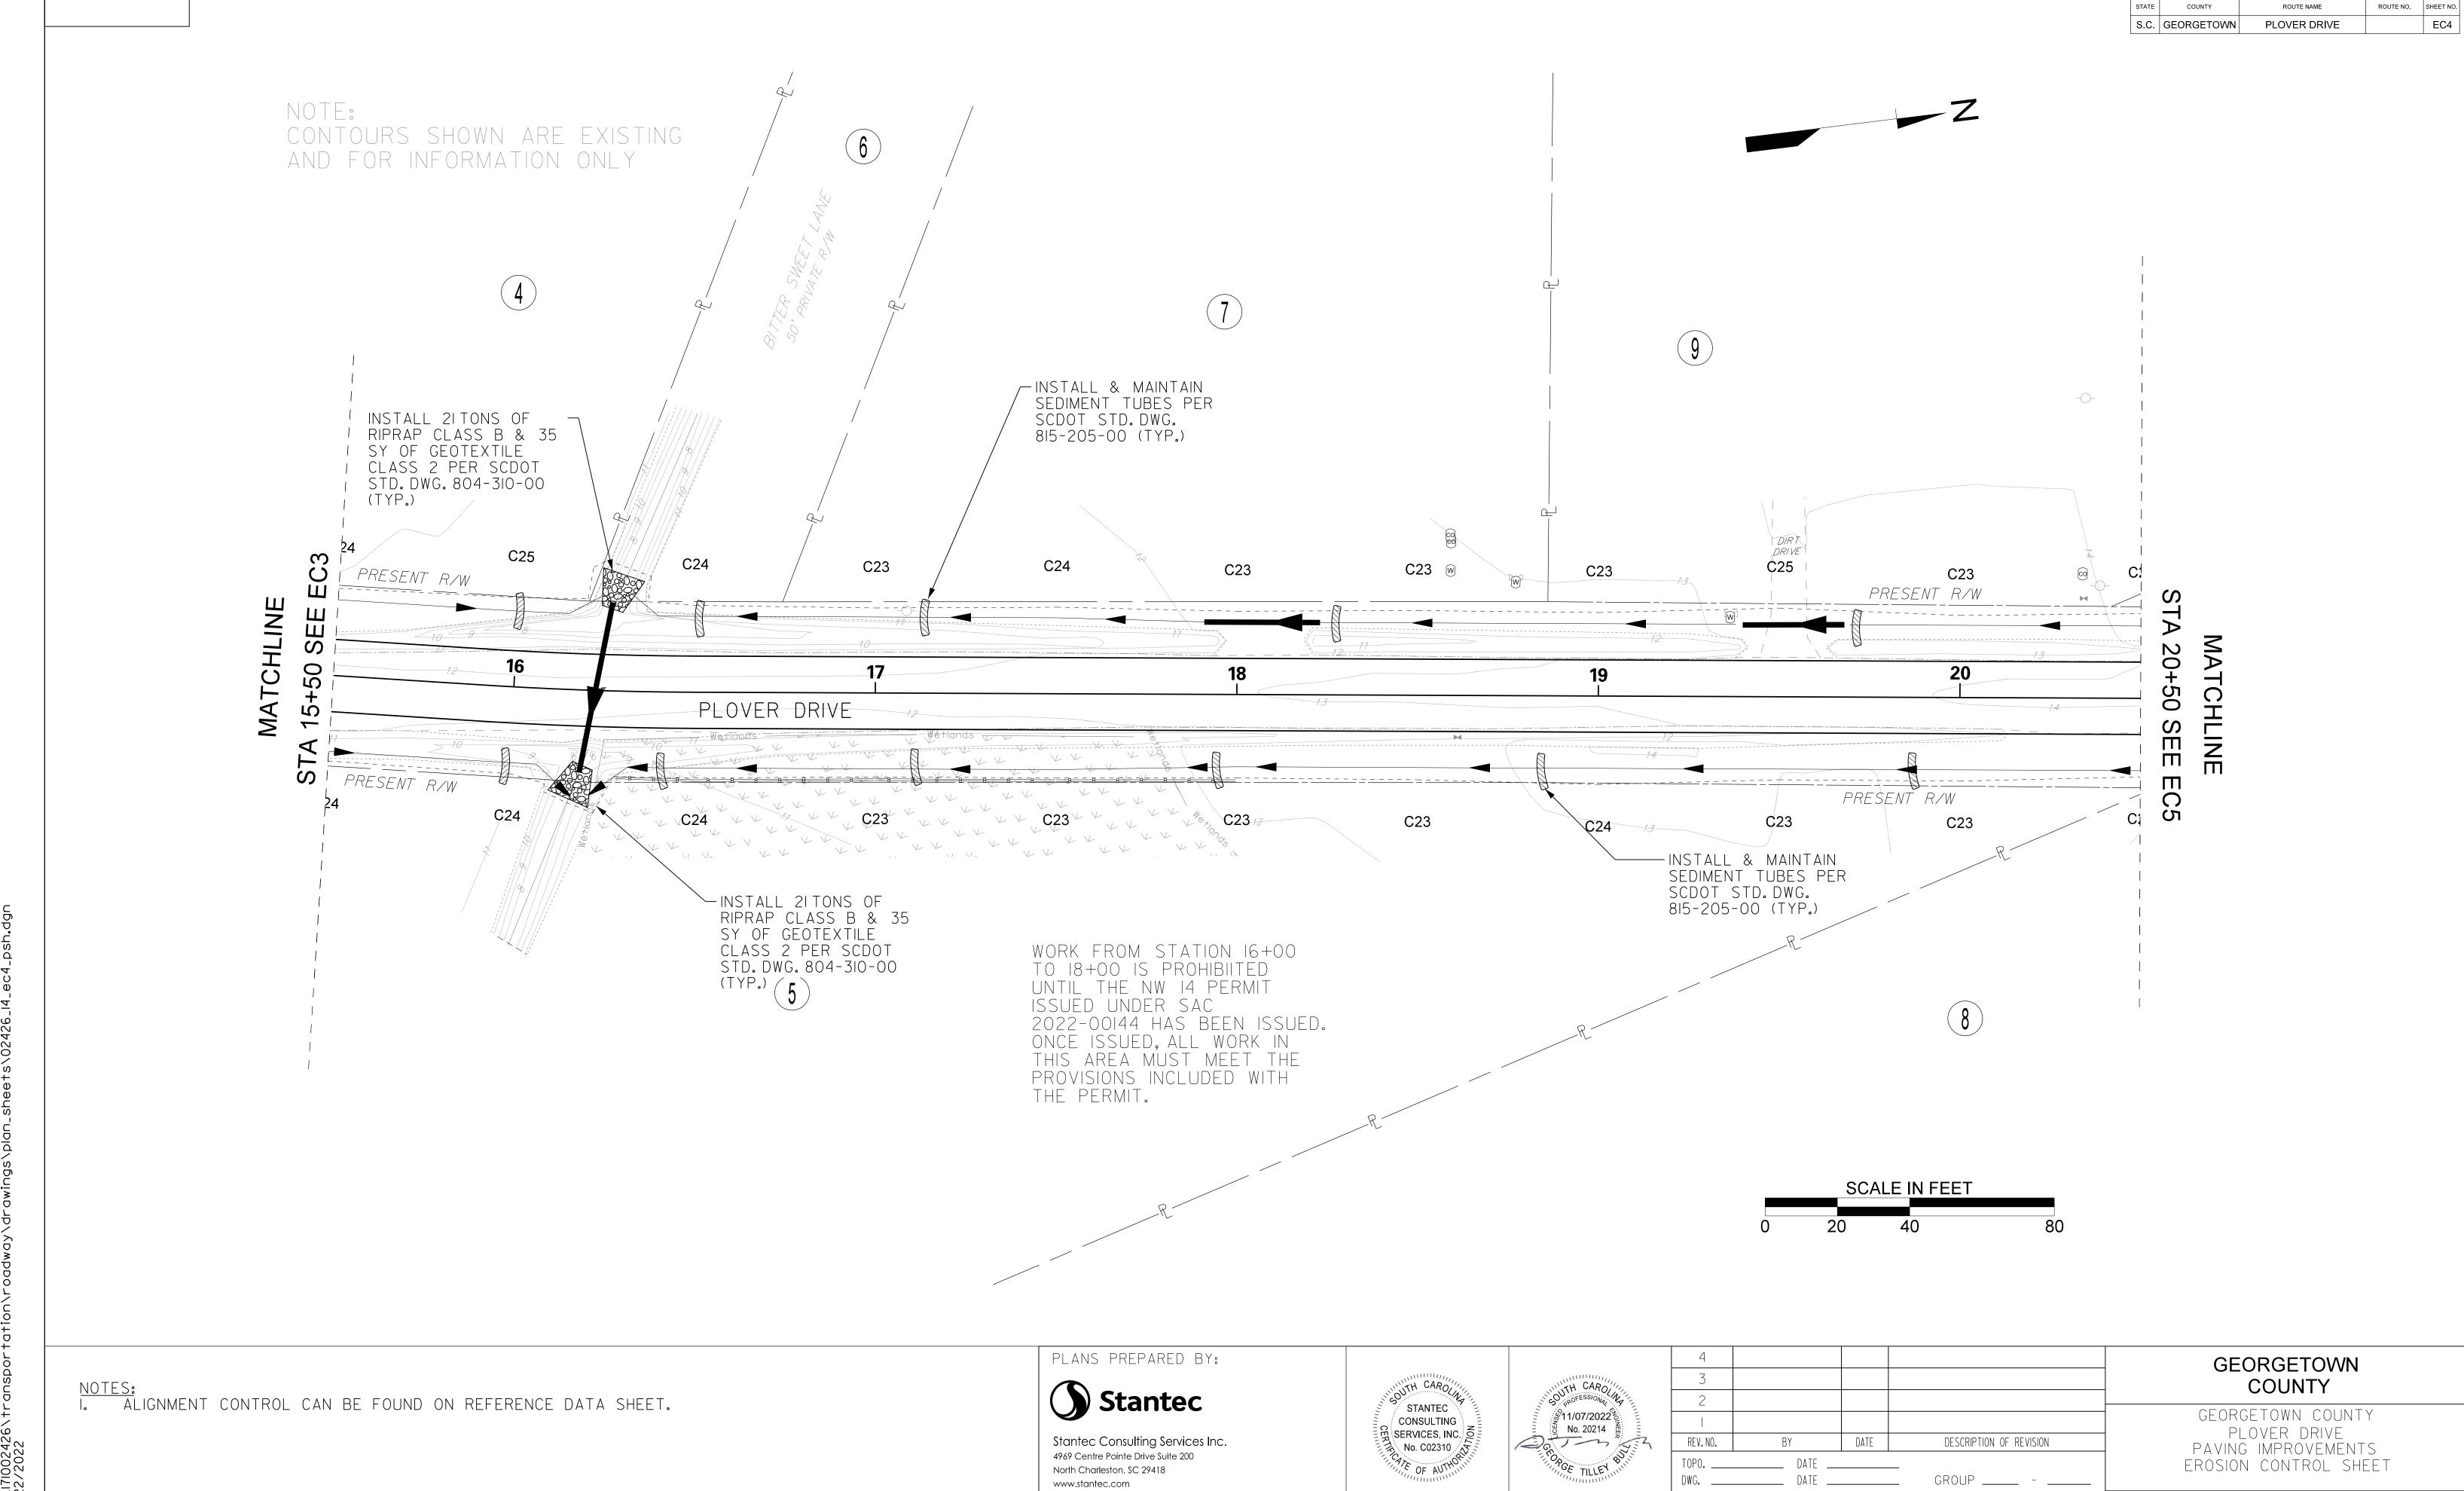User: †bull

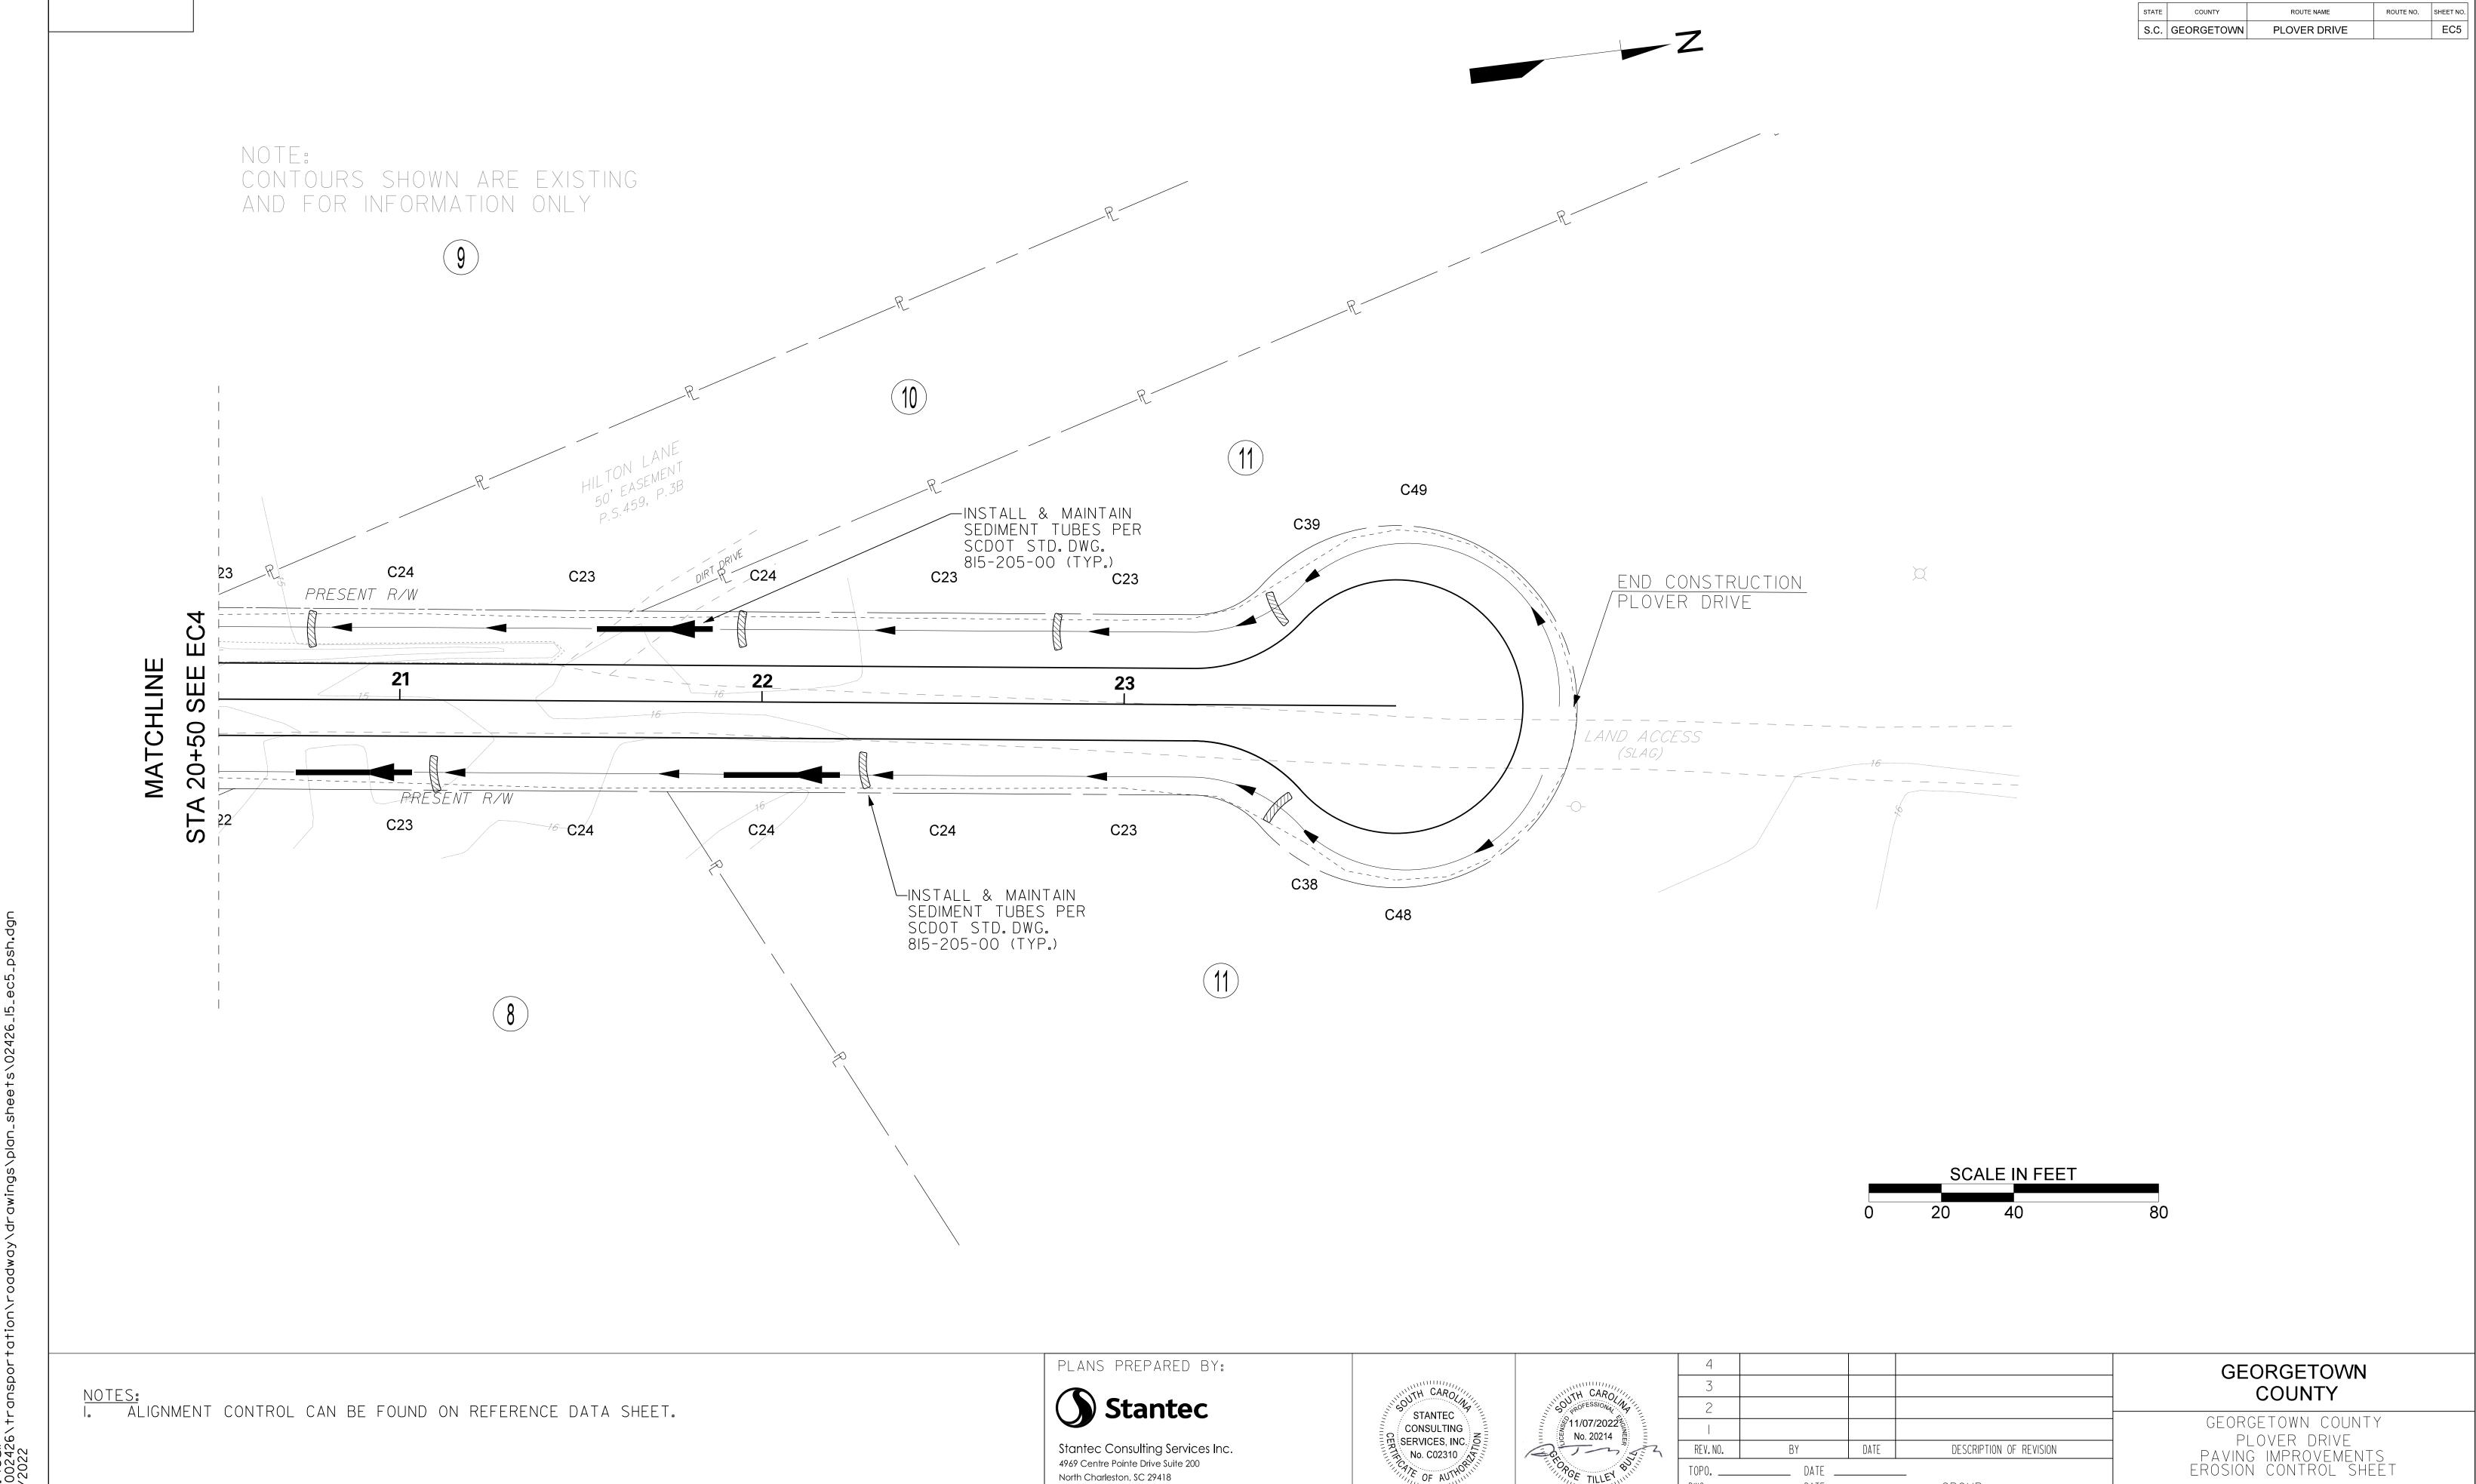

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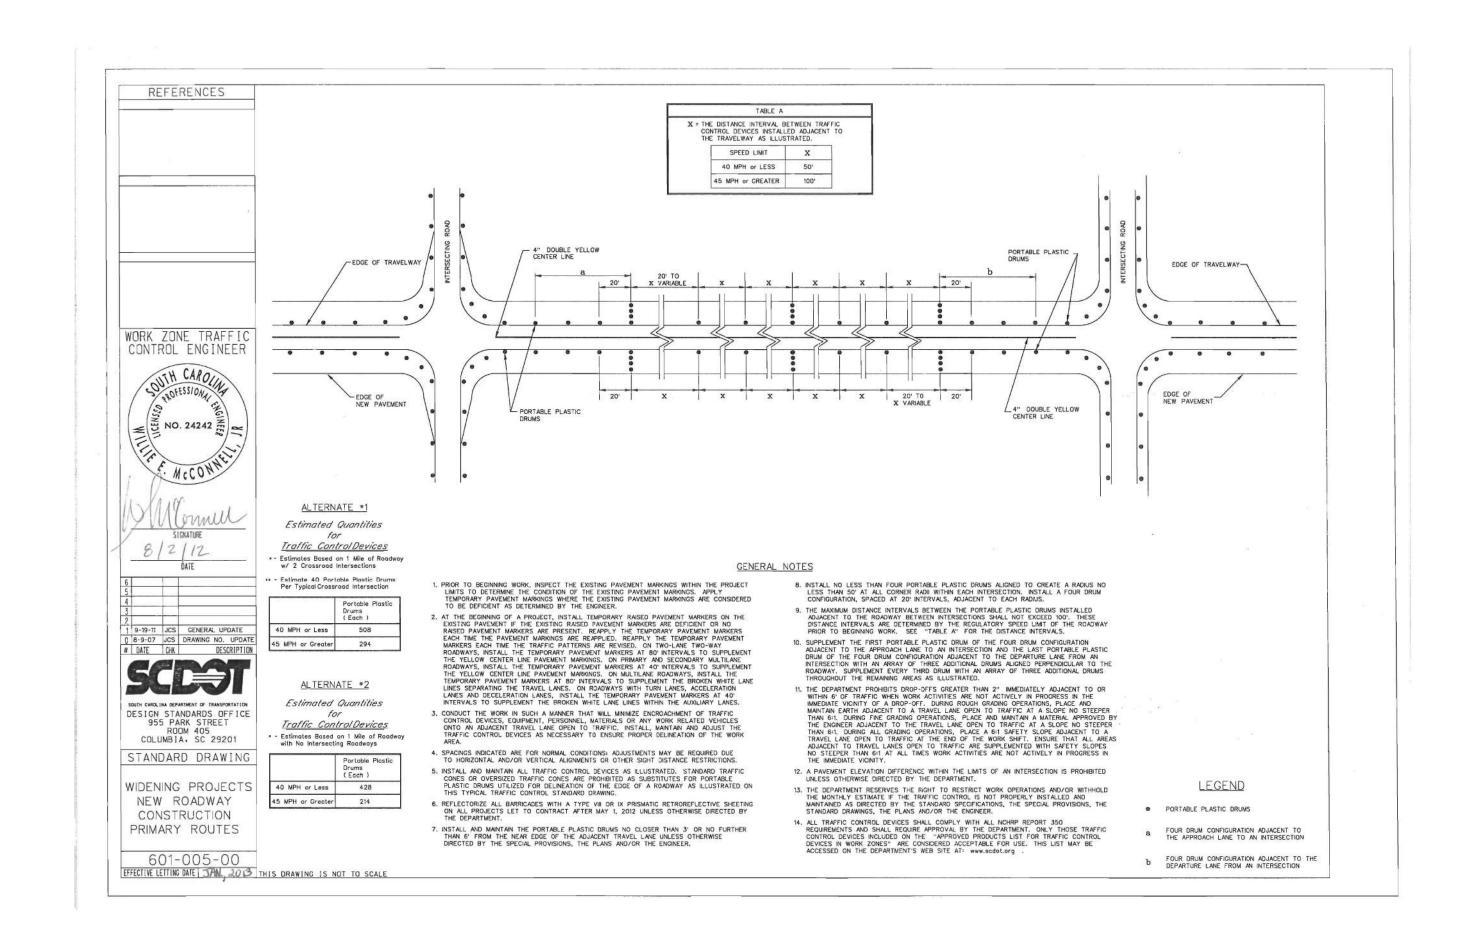
DWG. _____ DATE ____


GROUP ____ - ___

SCALE: I"=20'

RTE. PLOVER DRIVE





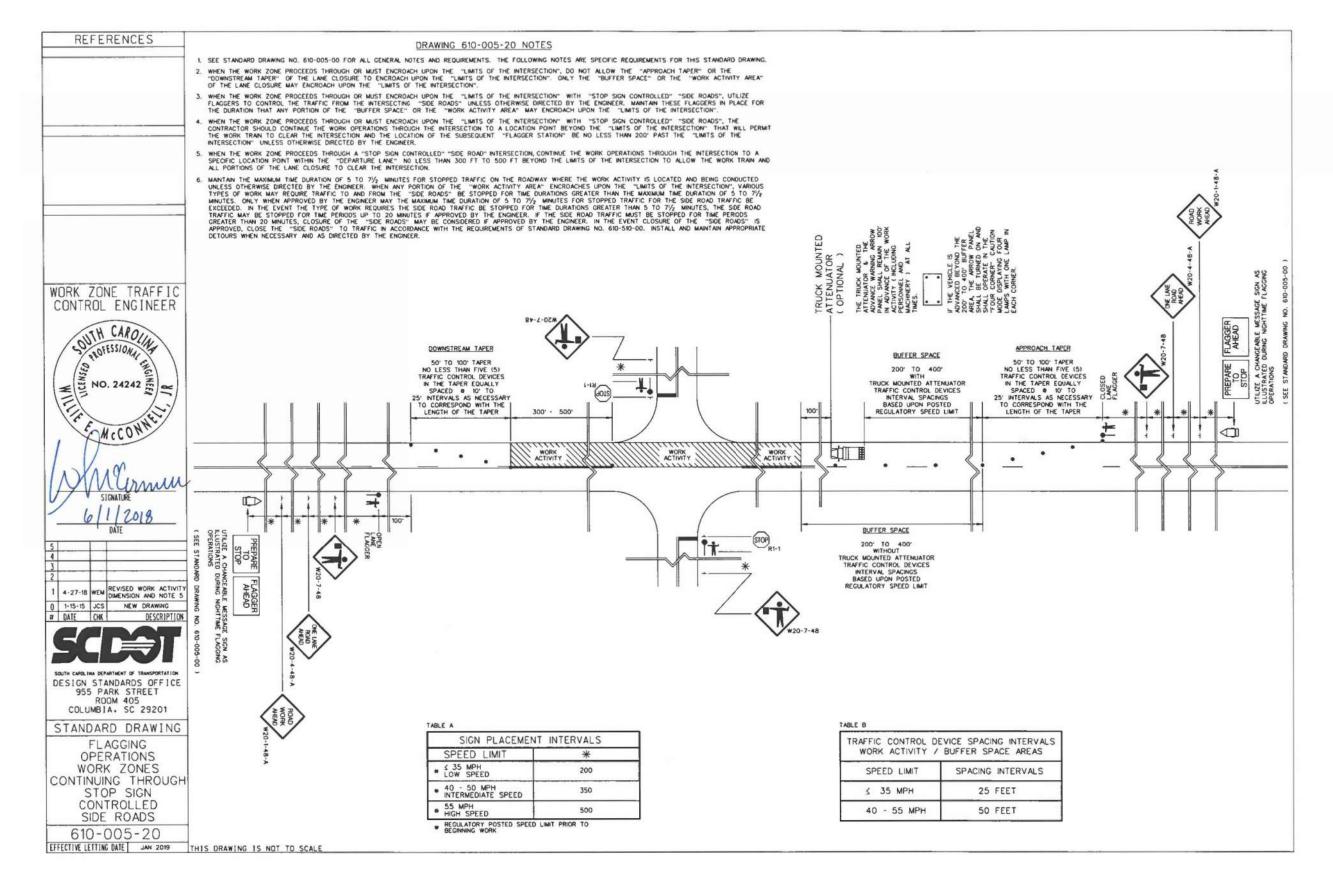



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WITH CAROLINATION No. 20214
TILLEY BUTTER


4			
3			
2			
REV. NO.	BY	DATE	DESCRIPTION OF REVISION
			GROUP

GEORGETOWN COUNTY

GEORGETOWN COUNTY
PLOVER DRIVE
PAVING IMPROVEMENTS
CONSTRUCTION DETAILS

SCALE: N.T.S. RTE. PLOVER DRIVE

User: tbull U:\171002426\transportation\roadway\drawings\plan_

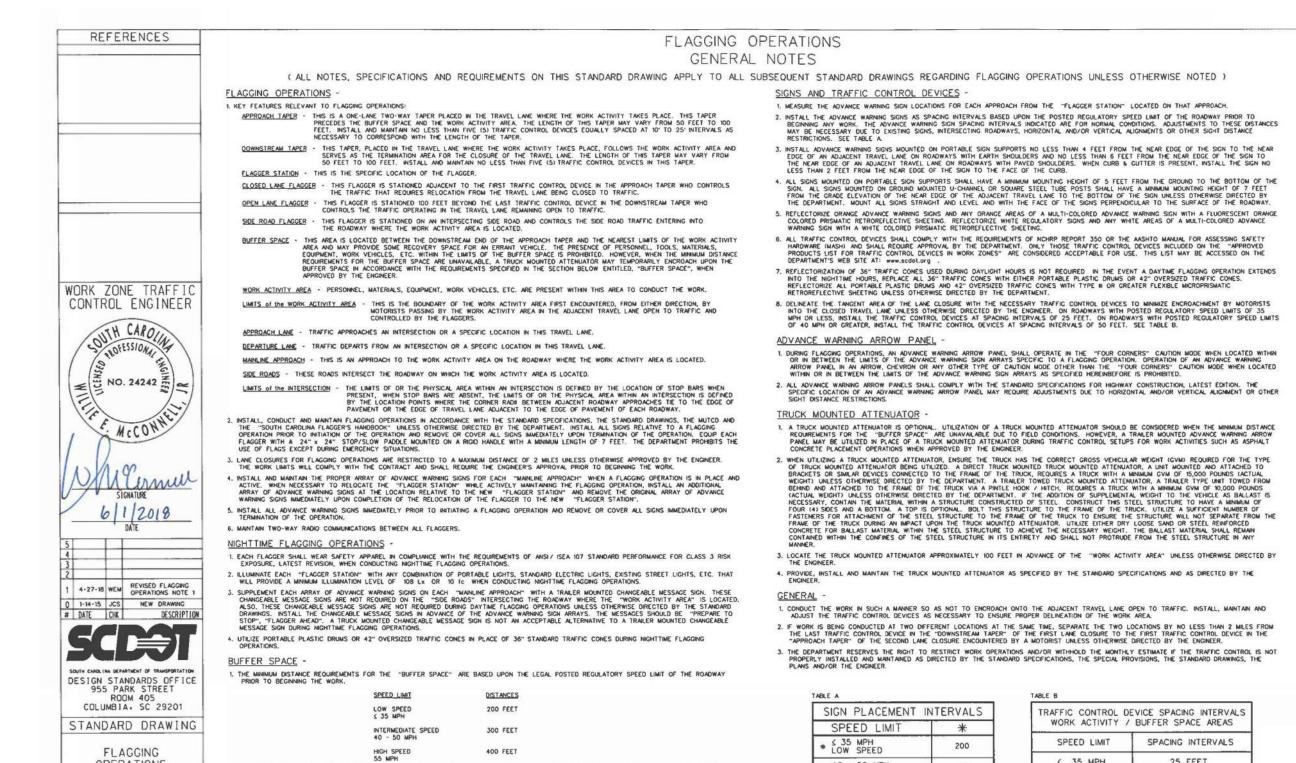

THE PRESENCE OF PERSONNEL, TOOLS, MATERIALS, EQUIPMENT, WORK VEHICLES, ETC. WITHIN THE LIMITS OF THE "BUFFER SPACE" IS PROHIBITED. A TRUCK MOUNTED ATTENUATOR IS THE ONLY WORK VEHICLE THAT MAY TEMPORARILY ENCROACH UPON THE "BUFFER SPACE" IN ACCORDANCE WITH THE CONDITIONS SPECIFED IN THE FOLLOWING NOTE WHEN APPROVED BY THE REGISTER. SEE NOTE NO. 3.


SUBJECT OF THE MINIMUM DISTANCE REQUIREMENTS FOR THE "BUFFER SPACE" ARE UNAVAILABLE DUE TO FELD CONDITIONS, IT MAY BE NECESSARY FOR A TRUCK MOUNTED ATTENUATOR TO TEMPORARILY ENCROACH UPON THE "BUFFER SPACE" WHEN APPROVED BY THE ENGINEER. A TRUCK MOUNTED ATTENUATOR IS THE ONLY VEHICLE PREMITTED TO TEMPORARILY ENCROACH UPON THE "BUFFER SPACE" MY THIS ENCROACHMENT IS ONLY PERMITTED WHEN ALL REASONABLE OPTIONS TO AVOID DOING SO HAVE BEEN EXHAUSTED. WHEN ENCROACHMENT UPON THE "BUFFER SPACE" IS APPROVED BY THE ENCROACHMENT BY REMOVAL OF THE RUCK MOUNTED ATTENUATION FOR THE ENCROACHMENT BY REMOVAL OF THE RUCK MOUNTED ATTENUATION FOR THE ENCROACHMENT BY REMOVAL OF THE RUCK MOUNTED ATTENUATION FROM THE "BUFFER SPACE" AT THE FIRST OPPORTUNITY THE MINIMUM DISTANCE REQUIREMENTS FOR THE "BUFFER SPACE" BECOME AVAILABLE.

40 - 50 MPH INTERMEDIATE SPEED

REGULATORY POSTED SPEED LIMIT PRIOR TO BEGINNING WORK

350

500

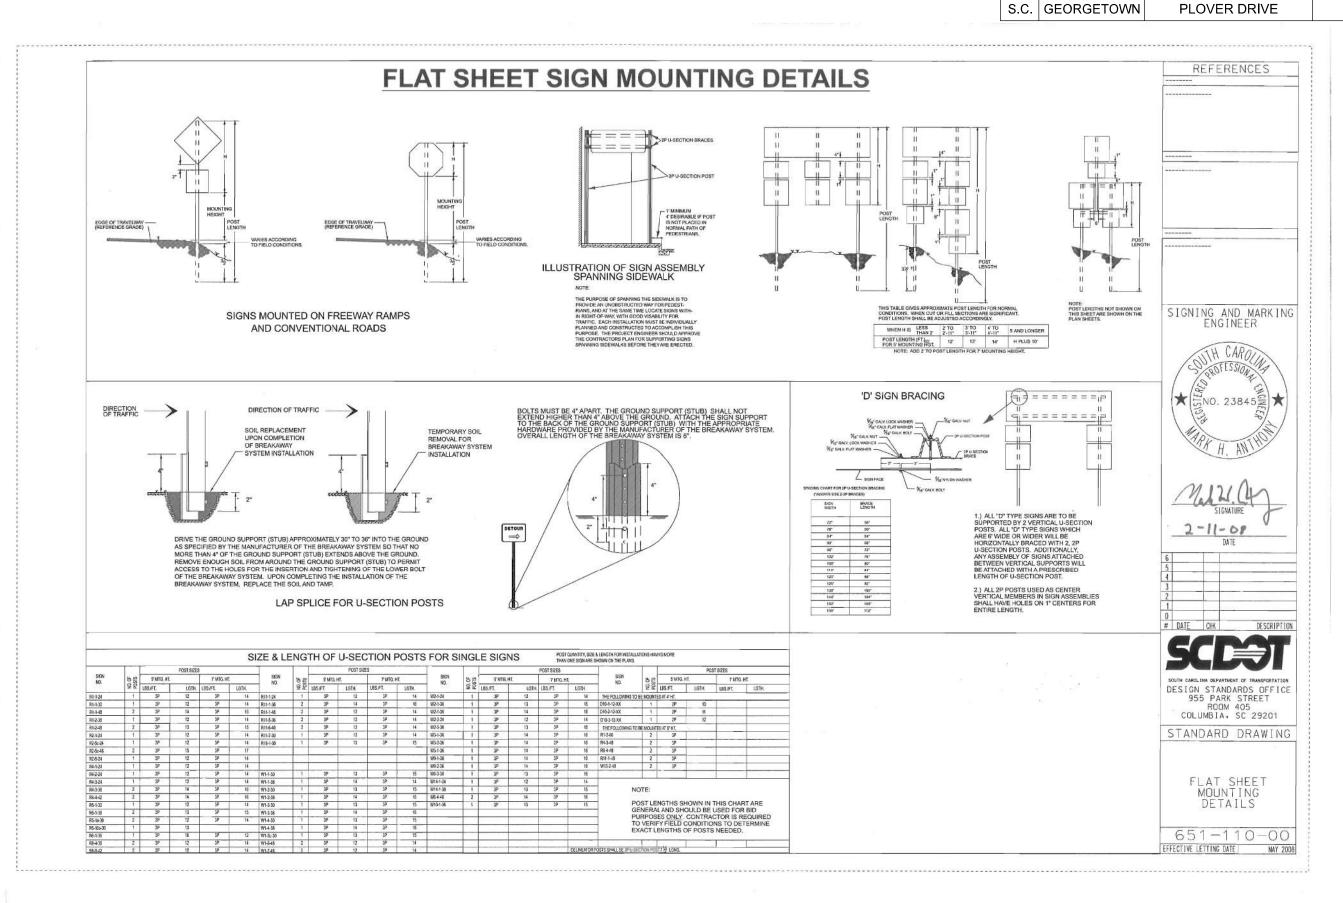


STATE

COUNTY

ROUTE NAME

ROUTE NO. SHEET NO

D2

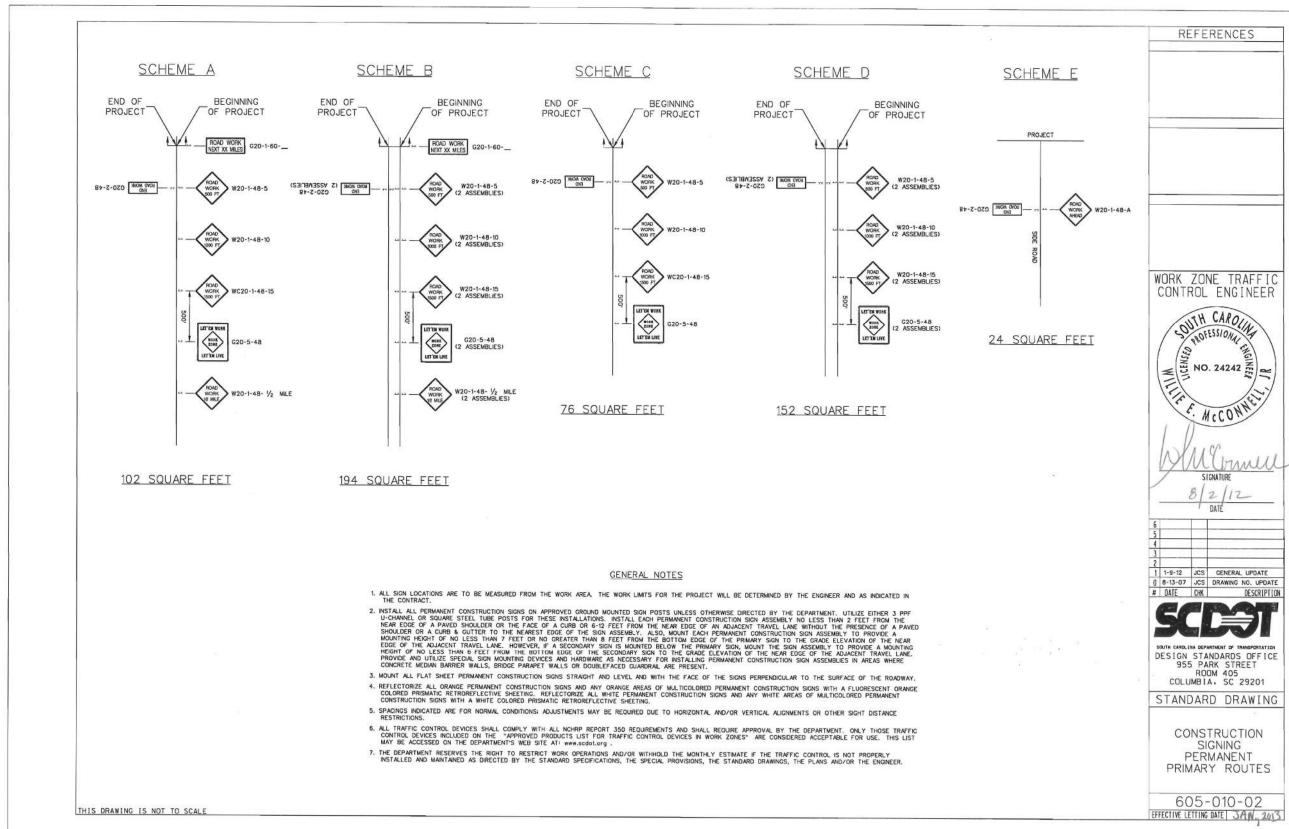



25 FEET

50 FEET

40 - 55 MPH

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REV. NO.	BY	DATE	DESCRIPTION OF REVISION	
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DWG	DATE		GROUP	

____ DATE _____

GEORGETOWN COUNTY

GEORGETOWN COUNTY PLOVER DRIVE PAVING IMPROVEMENTS CONSTRUCTION DETAILS

SCALE: N.T.S. RTE. PLOVER DRIVE

OPERATIONS


TWO-LANE TWO-WAY


PRIMARY &

SECONDARY ROUTES


610-005-00


EFFECTIVE LETTING DATE | JAN 2019 | THIS DRAWING IS NOT TO SCALE

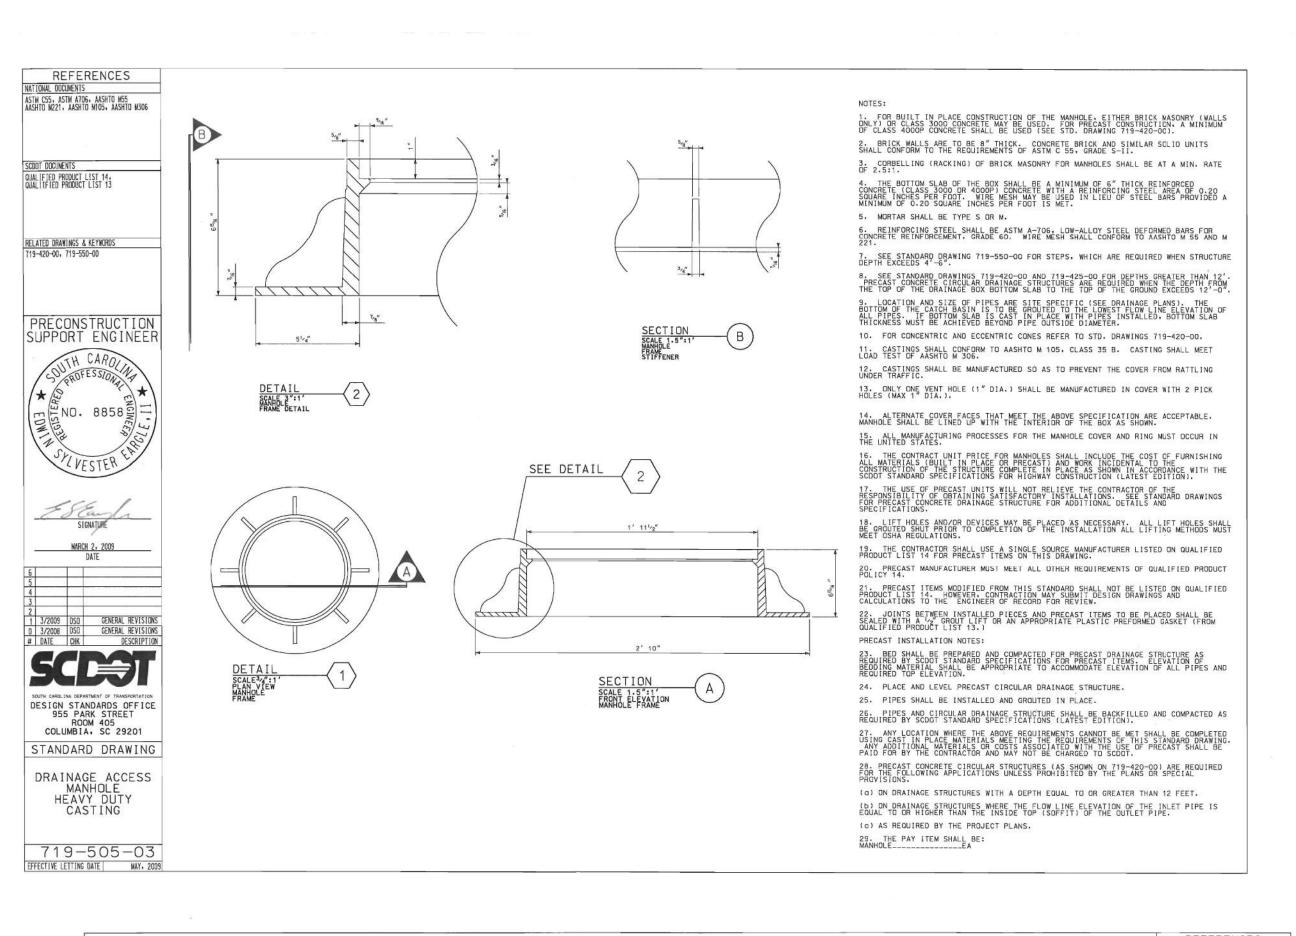

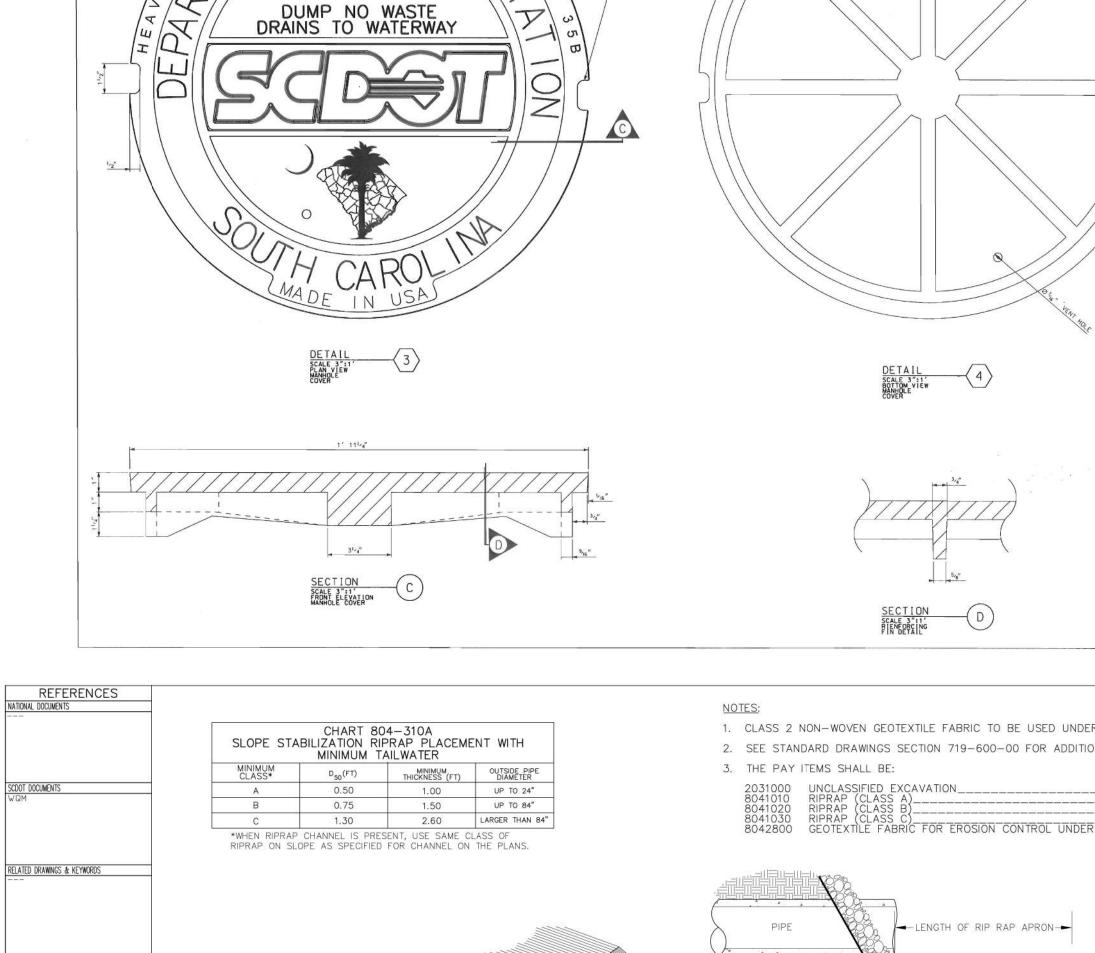

(2) OPEN PICK HOLES

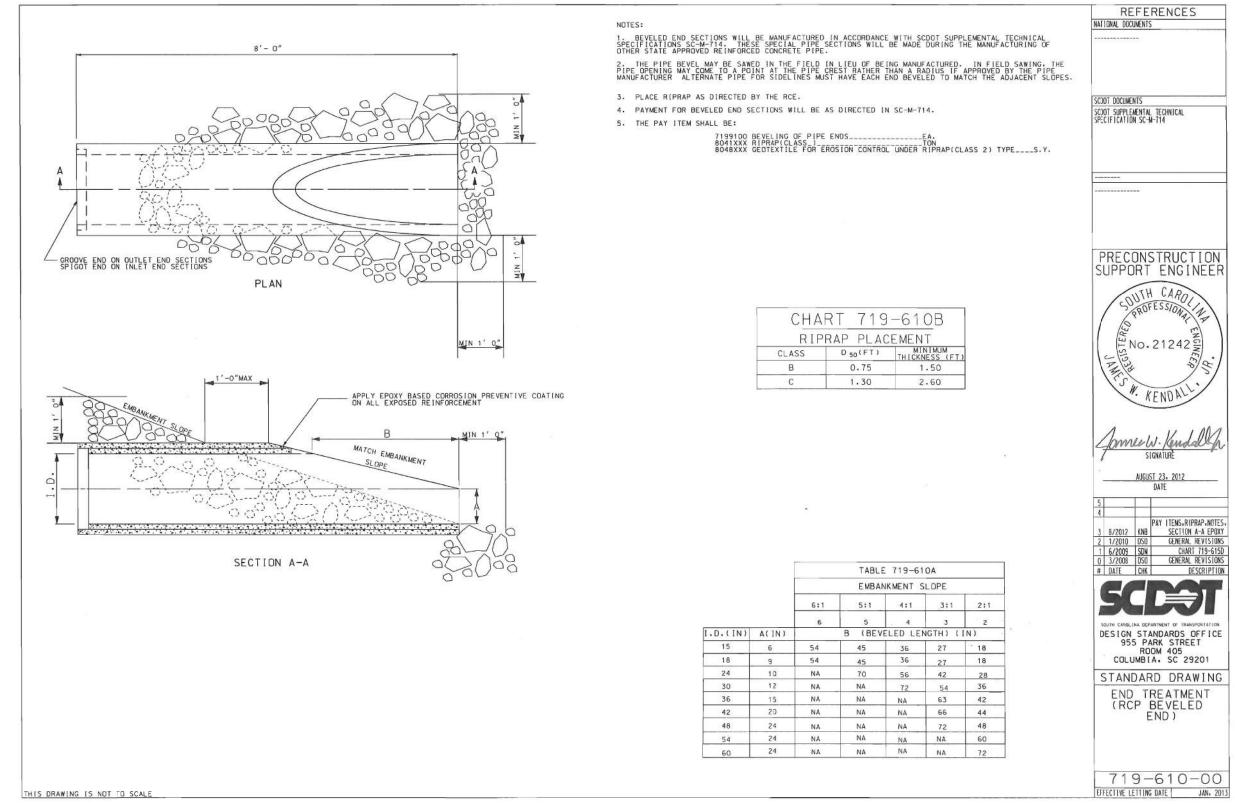

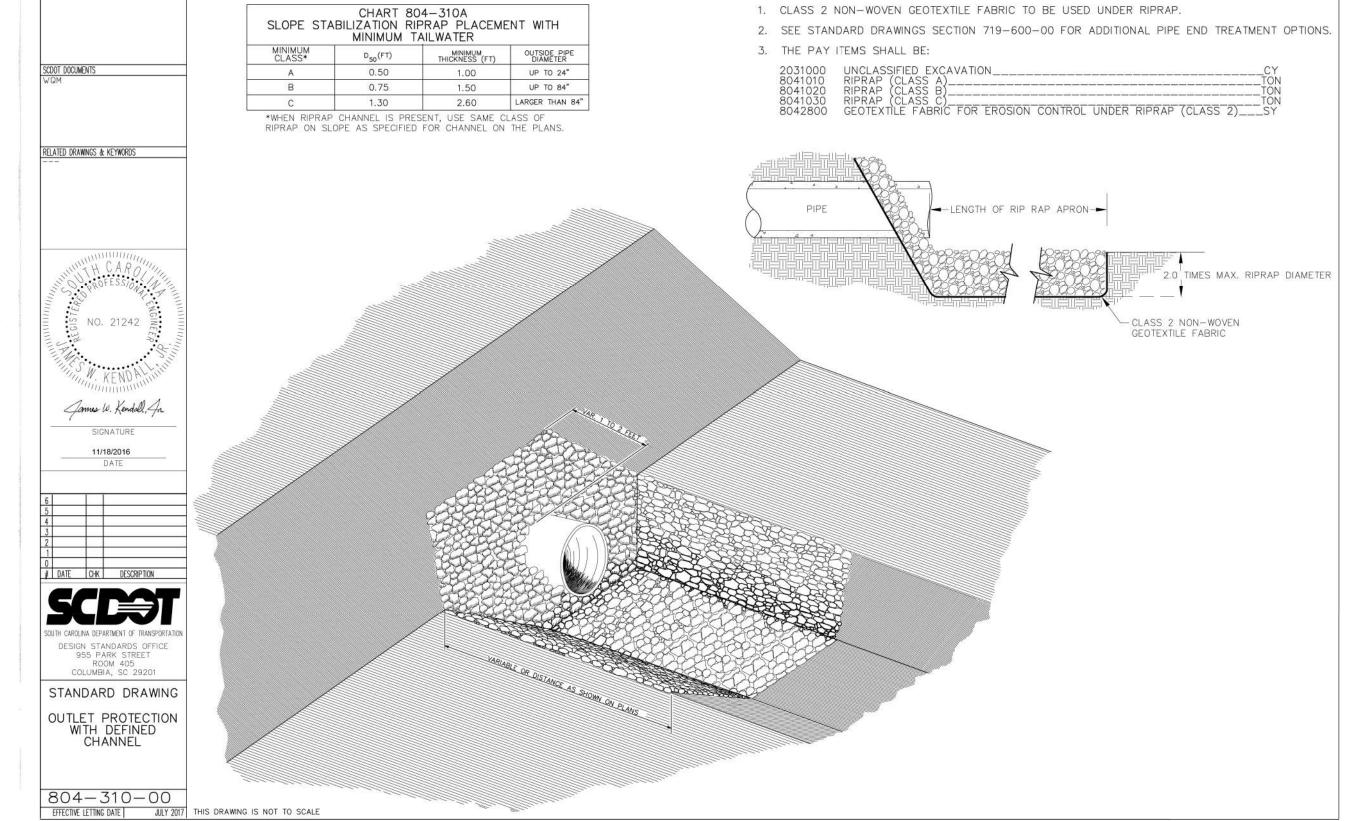



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REV. NO.	BY	DATE	DESCRIPTION OF REVISION	
TOPO	DATE			
DWG	DATE		GROUP	

___ DATE ___

GEORGETOWN COUNTY

STATE

COUNTY

PLOVER DRIVE

S.C. GEORGETOWN

REFERENCES
NATIONAL DOCUMENTS

ASTN C55, ASTM A706, AASHTO M55 AASHTO M221, AASHTO M105, AASHTO M306

SCOOT DOCUMENTS

CUALIFIED PRODUCT LIST 14.

QUALIFIED PRODUCT LIST 13

RELATED DRAWINGS & KEYMORDS 719-420-00, 719-550-00

PRECONSTRUCTION SUPPORT ENGINEER

ENo. 21242€

AUGUST 23, 2012 DATE

DESIGN STANDARDS OFFICE
955 PARK STREET
ROOM 405
COLUMBIA, SC 29201

STANDARD DRAWING


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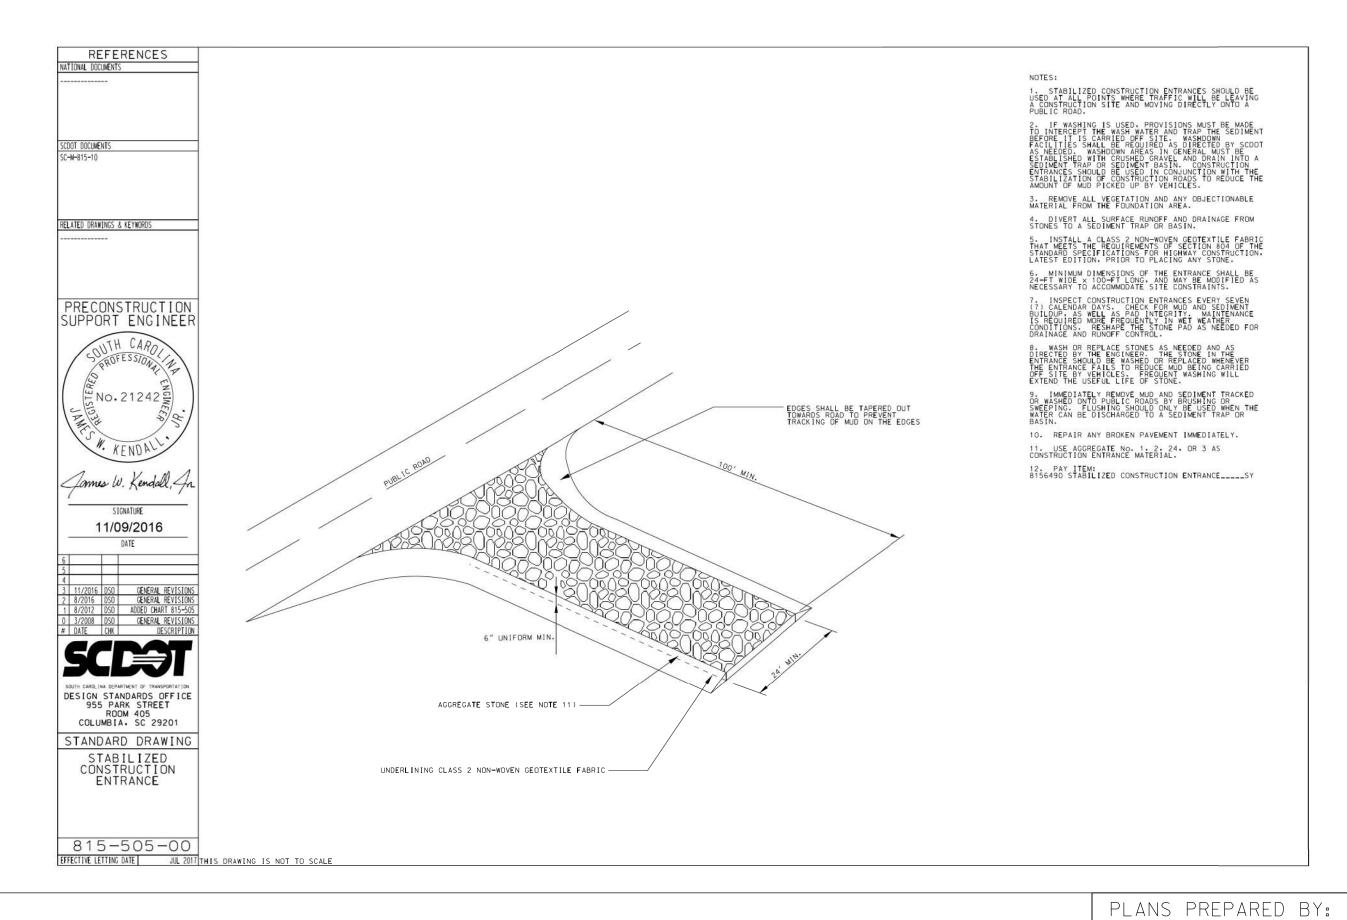
719-505-04 EFFECTIVE LETTING DATE JAN.. 2013


ROUTE NO. SHEET NO.

GEORGETOWN COUNTY PLOVER DRIVE PAVING IMPROVEMENTS CONSTRUCTION DETAILS

SCALE: N.T.S. RTE. PLOVER DRIVE



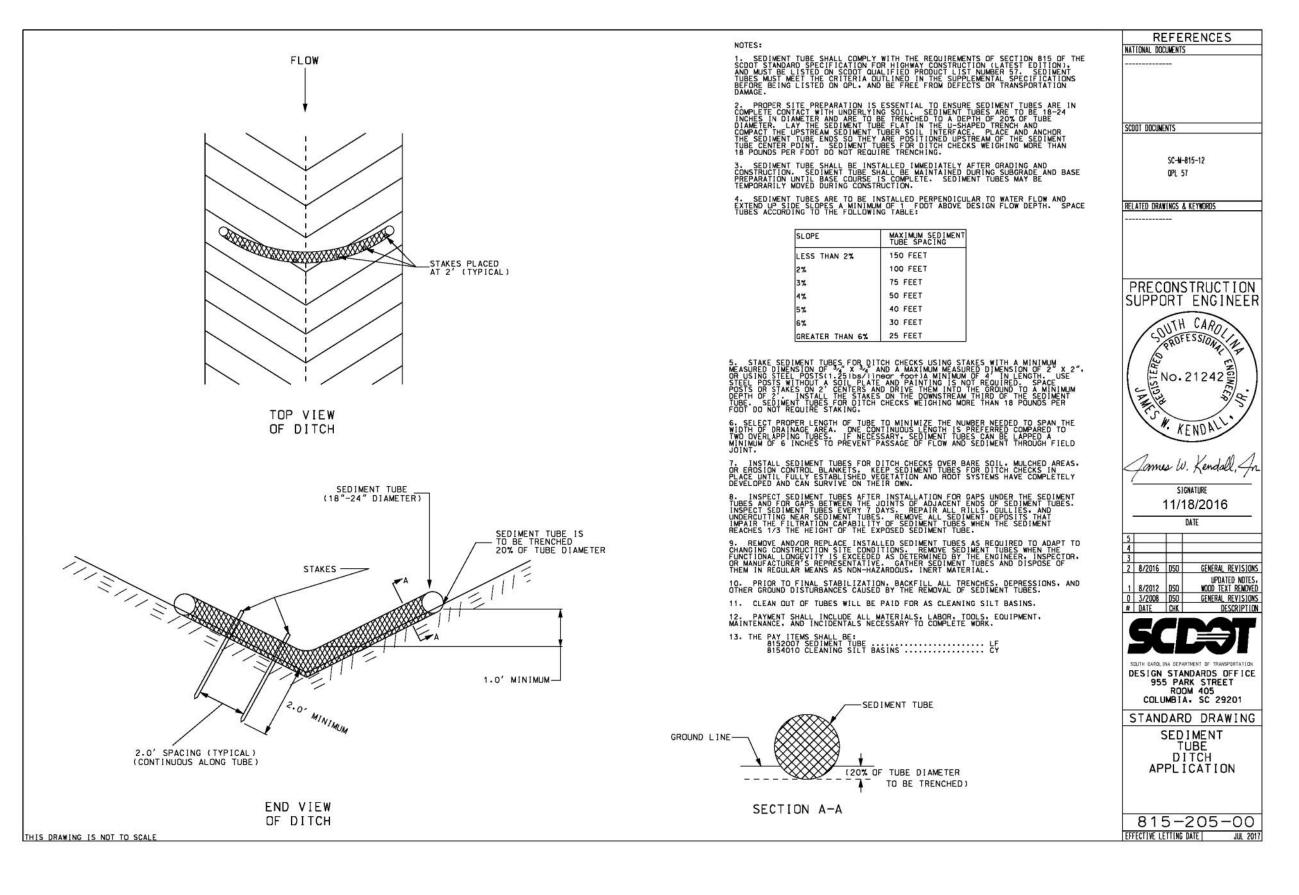

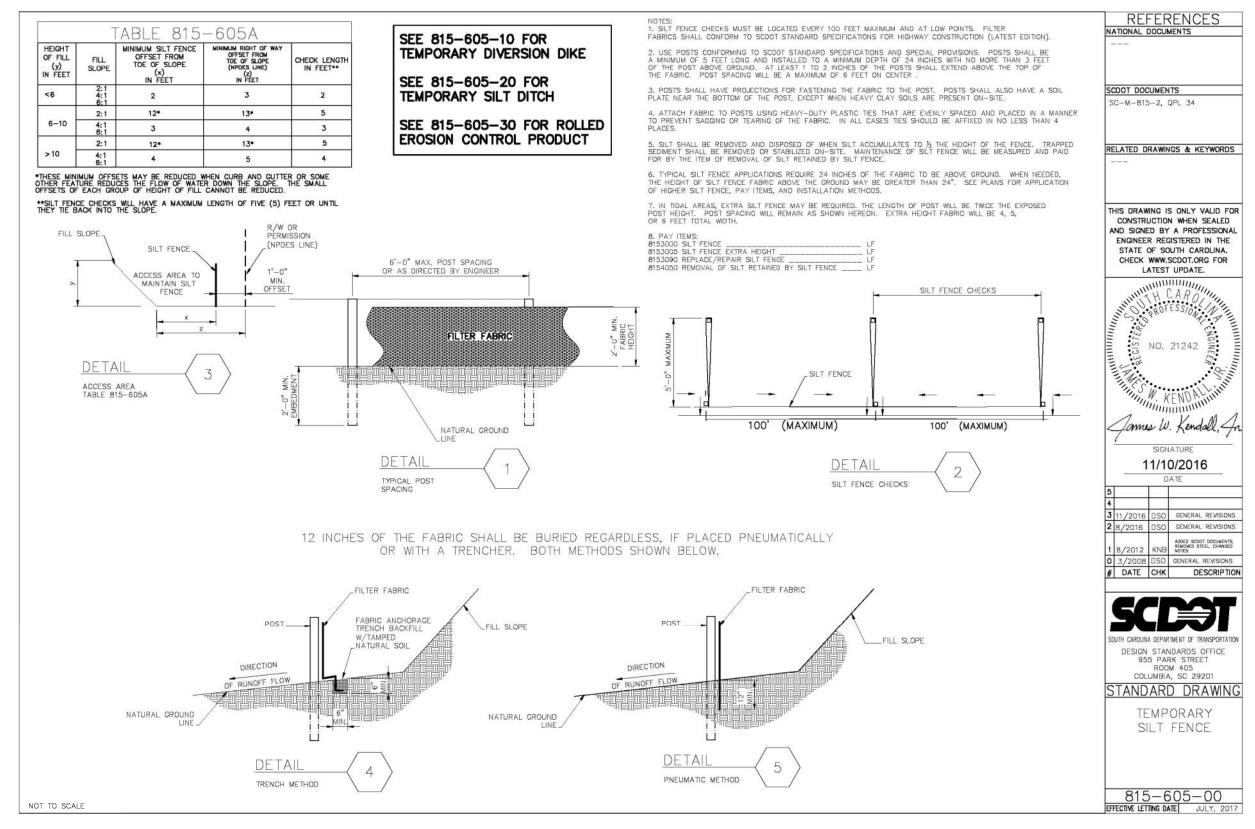



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REV. NO.	BY	DATE	DESCRIPTION OF REVISION	
TOPO	DATE			
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GEORGETOWN COUNTY

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