PROJECT MANUAL

Campus Wide Painting Project @ Matilija Middle School PROJECT NO. 2021-1600

Bid Opening: July 12, 2021, 11:00 A.M.

for

OJAI UNIFIED SCHOOL DISTRICT

June 24, 2021

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DOCUMENT 00020

NOTICE TO CONTRACTORS CALLING FOR BIDS

NOTICE IS HEREBY GIVEN that <u>Ojai Unified School District</u> of Ventura County, California, acting by and through its Governing Board, hereinafter referred to as the DISTRICT will receive up to, but not later than <u>11:00</u> o'clock a.m. of the 12th day of July, 2021, sealed bids for the award of a contract for:

Campus Wide Painting Project @ Matilija Middle School

Project Number: 2021-1600

Bids shall be received in the office of the Business Department, OJAI UNIFIED SCHOOL DISTRICT located at 414 E Ojai Ave, Ojai, CA 93023 and shall be opened and publicly read aloud at the above-stated time and place.

A <u>mandatory pre-bid Conference</u> will be held on <u>July 6, 2021 at 9:00am</u> for the purpose of acquainting all prospective bidders with the bid documents and the work sites. The pre-bid conference will be held at:

Matilija Middle School: 703 El Paseo Rd., Ojai 93023

Any Contractor bidding on the Project who fails to attend the entire mandatory job walk and conference will be deemed a non-responsive bidder and will have its bid returned unopened. Each bidder submitting a bid shall evidence attending the mandatory job walk by providing the following information on the District's sign-in sheet that will be made available at the job walk: name of the person attending, the company's name, and the CSLB license number of the bidder. The person attending the mandatory job walk shall be an employee, officer or other legally authorized representative of the bidder and this person shall provide a pre-printed business card identifying the bidder and the name of the person attending the job walk. Failure to meet these requirements will render a bidder's bid non-responsive and the bid will be returned unopened.

Each bid must conform and be responsive to the contract documents, copies of which are now on file and may be obtained after <u>June 24, 2021</u> on the Ojai Unified School District Website here.

Each bid shall be accompanied by the security referred to in the contract documents, the non-

NOTICE TO CONTRACTORS

collusion affidavit, the list of proposed subcontractors, and all additional documentation required by the Instructions to Bidders.

In contracts involving an expenditure in excess of \$25,000.00, the successful bidder shall file a payment bond issued by an admitted Surety approved to conduct business in the State of California approved by the District in the form set forth in the contract documents.

The District reserves the right to reject any or all bids or to waive any irregularities or informalities in any bids or in the bidding.

The Director of Industrial Relations has determined the general prevailing rate of per diem wages in the locality in which this work is to be performed for each craft or type of worker needed to execute the contract which will be awarded to the successful bidder. The prevailing rate of per diem wages as determined by the State Director of Industrial Relations are AVAILABLE ON THE INTERNET at the World Wide Website of the State Department of Industrial Relations at www.dir.ca.gov under Statistics and Research.

It shall be mandatory upon the Contractor to whom the contract is awarded, and upon any subcontractor under him, to pay not less than the said specified rates to all workers employed by them in the execution of the contract.

Minority, women, and disabled veteran contractors are encouraged to submit bids. This bid **is not** subject to Disabled Veteran Business Enterprise requirements.

This contract **is** subject to a labor compliance program, as described in subdivision (b) of Section 1771.5 of the Labor Code.

Each bidder shall be a licensed contractor pursuant to the Business and Professions Code and shall be licensed in one of the following classifications: <u>California Contractors B License</u> (with C-33 License for subcontractor) or C-33 Painting License. Said experience can noted on contractor questionnaire. No bidder may withdraw a bid for a period of <u>sixty</u> (60) days after the date set for the opening of bids.

Dated this June 24, 2021

Adam Dutter
Bond Manager
OJAI UNIFIED SCHOOL DISTRICT
of Ventura County, California

END OF DOCUMENT

NOTICE TO CONTRACTORS

DOCUMENT 00100 INFORMATION FOR BIDDERS

1. **Preparation of Bid Form**

The District invites bids on the **attached** form to be submitted at such time and place as is stated in the Notice to Contractors Calling for Bids, not later than 11:00 o'clock am of the 6th day of July, 2021. Bids shall be received in the Business Office located at Ojai Unified School District, 414 E Ojai Ave, Ojai, CA 93023. All blanks in the bid form must be appropriately filled in, and all prices must be stated in both words and figures. If a different price is stated in words than is stated in figures, the price stated in words shall be the price bid. All bids must be submitted in sealed envelopes bearing on the outside the name of the bidder, their address, and the name of the project for which the bid is submitted. It is the sole responsibility of the bidder to see that his bid is received in proper time. All bids received after the scheduled closing time for receipt of bids will be returned to the bidder unopened.

2. Bid Security

Each bid shall be accompanied by a certified or cashier's check payable to District, or a satisfactory bid bond in favor of District executed by the bidder as principal and an admitted surety approved to conduct business in the State of California as surety, in an amount specified in the Special Conditions hereof. The check or bid bond shall be given as a guarantee that the bidder shall execute the contract if it be awarded to him in conformity with the contract documents and shall provide the surety bond or bonds as specified therein within five (5) days after notification of the award of the contract to the bidder.

3. Faxed and Electronic Mail Bids

All bids must be under sealed cover. District will not accept any bids or bid modifications submitted by facsimile or electronic mail transmission.

4. Signature

The bid must be signed in the name of the bidder and must bear the signature in longhand of the person or persons duly authorized to sign the bid.

5. Modifications

Changes in or additions to the bid form, recapitulations of the work bid upon, alternative proposals, or any other modification of the bid form which is not specifically called for in the contract documents may result in the District's rejection of the bid as not being responsive to the invitation to bid. No oral or telephonic modification of any bid submitted will be considered and a telegraphic modification may be considered only if

the postmark evidences that a confirmation of the telegram duly signed by the bidder was placed in the mail prior to the opening of bids.

6. Erasures/Mutilation of Bid Documents

The bid submitted must not contain any erasures, interlineations, or other corrections unless each such correction is suitably authenticated by affixing in the margin immediately opposite the correction the surname or surnames of the person or persons signing the bid.

Contractors should not deface or mutilate the bid documents to the extent that they may not be usable for construction purposes. Bid documents obtained under deposit shall be returned within 10 days after bid opening.

7. Examination of Site and Contract Documents

Each bidder shall be required to visit the site of the proposed work and fully acquaint himself with the conditions relating to the construction and labor so that he may fully understand the facilities, difficulties, and restrictions attending the execution of the work under the contract. Bidders shall thoroughly examine and be familiar with the drawings and specifications. The failure or omission of any bidder to receive or examine any contract documents, form, instrument, addendum, or other document or to visit the site and acquaint himself with conditions there existing shall in no way relieve any bidder from obligations with respect to his bid or to the contract

- 7.1 Each bidder, by making his bid represents that he has read and understands the Contract and Bid Documents and any and all related reports and information. After executing the Agreement, no consideration will be given to any claim of misunderstanding of the documents.
- 7.2 Each bidder, by making his bid, represents that he has visited the site, inspected the area of the work, and familiarized himself with the local conditions under which the work is to be performed. Such inspection shall specifically consider requirements for accessing the site and determining the work can be completed as required by, and as shown in, the Contract Documents.
- 7.3 With District's approval, including provision of insurance as required, and after scheduling access with the District, each bidder may conduct additional site investigations at the bidder's sole cost.

Withdrawal of Bids

8.

Any bidder may withdraw his bid either personally, by written request, or by telegraphic request confirmed in the manner specified above at any time prior to the scheduled closing time for receipt of bids.

9. Agreements and Bonds

The Agreement form which the successful bidder, as Contractor, will be required to execute, and the forms and amounts of surety bonds which he will be required to furnish at the time of execution of the Agreement, are included in the contract documents and shall be carefully examined by the bidder. The required number of executed copies of the Agreement, the Performance Bond, and the Payment Bond for Public Works is as specified in the Special Conditions.

The Performance Bond must be executed by an admitted Surety approved to conduct business in the State of California which meets the highest standards the District is legally permitted to establish and which it has established.

The Payment Bond must be in the amount of 100 percent of the total amount payable. The Payment Bond must be executed by an admitted Surety approved to conduct business in the State of California which meets the highest standards the District is legally permitted to establish.

Bonds shall be in the form set forth in the contract documents.

10. Interpretation of Plans and Documents

If any person contemplating submitting a bid for the proposed contract is in doubt as to the true meaning of any part of the drawings, specifications, or other contract documents, or other information pertaining to the site (including any available soils or geotechnical report) or finds discrepancies in, or omissions from the drawings and specifications, he is hereby required in accordance with Public Contract Code section 1104 to submit to the Architect a written request for an interpretation or correction thereof. The person submitting the request will be responsible for its prompt delivery. Any interpretation or correction of the contract documents or other available information will be made only by addendum duly issued and a copy of such addendum will be mailed or delivered to each person receiving a set of the contract documents. At the option of the District, all addenda may be mailed, delivered, faxed, made available for pick-up or sent via electronic mail. District shall have the option to send a hard copy via regular mail or overnight delivery, at the option of District. No oral interpretation of any provision in the contract documents will be made to any bidder. Numbers spelled out in words will take precedence over numerals / figures. The last date to submit a request for information shall be July 8, 2021.

11. Bidders Interested in More Than One Bid and Bidders Not Qualified to Bid

No person, firm, or corporation shall be allowed to make, or file, or be interested in more than one bid for the same work unless alternate bids are specifically called for. A person, firm, or corporation that has submitted a subproposal to a bidder, or that has quoted prices of materials to a bidder, is not thereby disqualified from submitting a subproposal or quoting prices to other bidders or making a prime proposal. No person, firm, or corporation shall be allowed to bid who has participated in the preparation of contract specifications; a bid by such a person, firm or corporation shall be determined to be nonresponsive.

12. Award of Contract

The District reserves the right to reject any or all bids, or to waive any irregularities or informalities in any bids or in the bidding. The award of the contract, if made by the District, will be to the lowest responsible bidder therefore.

13. Additive and Deductive Items: Method of Determining Lowest Bid

Pursuant to Public Contract Code section 20103.8, should this bid solicitation include additive and/or deductive items, the checked [X] method shall be used to determine the lowest bid:

lowest bid:
X (a) The lowest bid shall be the lowest bid price on the base contract
without consideration of the prices on the additive or deductive items.
(b) The lowest bid shall be the lowest total of the bid prices on the base
contract and those additive or deductive items taken in the numerical order set forth in
the bid form.
(c) The lowest bid shall be the lowest total of the bid prices on the base
contract and those additive or deductive items taken in order from a specifically identified
list of those items that, when in the bid form and added to, or subtracted from, the base
contract, are less than, or equal to, a funding amount publicly disclosed by the District
before the first bid is opened.
(d) The lowest bid shall be determined in a manner that prevents any
information that would identify any of the bidders from being revealed to the public entity
before the ranking of all bidders from lowest to highest has been determined.

If no method is checked, sub-paragraph (a) shall be used to determine the lowest bid. Notwithstanding the method used by the District to determine the lowest responsible bidder, the District retains the right to add to or deduct from the contract any of the additive or deductive items included in the bid solicitation.

14. Evidence of Responsibility

Upon the request of the District, a bidder whose bid is under consideration for the award of the contract shall submit promptly to the District satisfactory evidence showing the bidder's financial resources, his construction experience in the type of work being required by the District, and his organization available for the performance of the contract and any other required evidence of the bidder's qualifications to perform the proposed contract. The District may consider such evidence before making its decision awarding the proposed contract. Failure to submit requested evidence of a bidder's responsibility to perform the proposed contract may result in rejection of the bid.

15. Listing Subcontractors

Each bidder shall submit with his sealed bid a list of the proposed subcontractors on this project as required by the Subletting and Subcontracting Fair Practices Act (Public Contract Code section 4100 and following). Forms for this purpose are furnished with the contract documents. In addition to these requirements, within one business day after the bid opening, Contractor shall provide the address, phone number, and license number of each listed subcontractor. If the bidder fails to provide information within one business day, District may in its discretion, reject the bid as nonresponsive.

16. Workers' Compensation

In accordance with the provisions of section 3700 of the Labor Code, Contractor shall secure the payment of compensation to his employees. Contractor shall sign and file with District the following certificate prior to performing the work under this contract:

I am aware of the provisions of section 3700 of the Labor Code which require every employer to be insured against liability for workers' compensation or to undertake self-insurance in accordance with the provisions of that code, and I will comply with such provisions before commencing the performance of the work of this contract.

The form of such certificate is included as part of the contract documents.

17. Substitution of Security

Monies withheld by the District to ensure performance under the contract may be released in accordance with Public Contract Code section 22300 and the contract documents.

18. Contractor's License

If, at the time the bids are opened, bidder is not licensed to perform the project in accordance with division 3, chapter 9 of the Business and Professions Code of the State

of California (Section 7028.15) and the Notice to Contractors Calling for Bids, the bid will not be considered.

19. Storm Water Permit for Construction Activity

As applicable, it shall be the responsibility of the successful bidder to file a Notice of Intent and procure a State Water Resources Control Board (State Water Board) National Pollutant Discharge Elimination System General Permit for Waste Discharge Requirements for Discharges of Storm Water Runoff Associated with Construction Activity (Permit). The successful bidder shall be solely responsible for preparing and implementing a Storm Water Pollution Prevention Plan (SWPPP) prior to initiating work. The successful bidder shall be responsible for procuring, implementing and complying with the provisions of the Permit and the SWPPP, including the standard provisions, monitoring and reporting requirements as required by Permit and as required by Article 69 of the General Conditions It shall be the responsibility of all bidders to evaluate and include in the bid the cost of procuring the Permit and preparing the SWPPP as well as complying with the SWPPP and any necessary revisions to the SWPPP. The successful bidder shall also include in his bid the cost of monitoring as required by the Permit.

As applicable, it shall be the responsibility of the successful bidder to comply with the County of Ventura Low Impact Development techniques as outlined in the County of Ventura Low Impact Development Handbook and Appendices, available through the County of Ventura Department of Planning and Land Use, copy on file with the District.

Successful bidders will submit a weekly storm water observation and illicit discharge report to District's facilities department, attention Executive Director of Operations.

20. Ethics in Bidding.

The District expects the bidders to maintain high ethical standards in engaging in the competitive bidding process. The bid amount of one bidder should not be divulged to another before the award of the subcontract or order, nor should it be used by Contractor to secure a lower proposal from another bidder on that project (bid shopping). Subcontractors or Suppliers should not request information for the Contractor regarding any sub-bid in order to submit a lower proposal on that project (bid peddling). District will consider any bidder found to be engaging in such practices to be a non-responsible bidder and may reject its bid on that ground.

21. Substitutions and Special Brand Names

In accordance with Public Contract Code section 3400 "prior to or after the award of the contract", district must provide for "submission of data substantiating a request for a substitution of 'an equal' item." Therefore, if the bidder is submitting "an equal" item

or product or work, the make and grade of the item, product or work which is to be substituted shall be provided to the District in the sealed bid submittal package. The documentation submitted must include any and all illustrations, specifications, and other relevant data including catalogue information which describes the substituted item or product or work and substantiates that it is an "or equal" to the specified item or product or work. In addition, the submittal documentation must also include a statement of the cost implications of the substitution being requested stating whether and why the substitution will reduce or increase the contract price. The documentation submitted must also include information regarding the durability and life cycle cost of the substituted item, product or work. Substantiating data shall include a signed affidavit from the Contractor stating that the substituted item or product or work is equivalent to the specified item or product or work in every way except as listed on the affidavit. Failure to submit all the needed substantiating data, including the signed affidavit, may result in a determination that the bid is nonresponsive. BIDDERS ARE SPECIFICALLY NOTIFIED THAT THE SUBMISSION OF THIS DOCUMENTATION IN NO WAY OBLIGATES THE DISTRICT OR ITS REPRESENTATIVE TO REVIEW SUCH DOCUMENTATION PRIOR TO CONTRACT AWARD. FURTHERMORE. IF A PROPOSED SUBSTITUTION IS REJECTED, BIDDER SHALL BE RESPONSIBLE TO PROVIDE THE ITEM OR PRODUCT OR WORK AS ORIGINALLY SPECIFIED AT NO ADDITIONAL COST TO THE DISTRICT. DISTRICT HAS THE COMPLETE AND SOLE DISCRETION TO DETERMINE IF AN ITEM OR ARTICLE IS AN EQUAL ITEM.

22. Fingerprinting

By law it is the District's responsibility to determine whether a contractor must provide fingerprint certification. Pursuant to Education Code section 45125.2, the District considers the totality of the circumstances in order to determine if fingerprinting of employees of a contractor working on a school site is required. Factors to be considered include the length of time the contractor's employees are on school grounds, whether students are in proximity with the location where the contractor's employees are working, and whether the contractor's employees are working alone or with others. A determination regarding whether fingerprint certification is required is contained in the special conditions.

23. Labor Compliance Program.

This contract is subject to a labor compliance program, as described in subdivision (b) of Section 1771.5 of the Labor Code. If this contract is subject to the requirements of Section 1771.7 of the Labor Code, the District to is required initiate and enforce a labor compliance program, as described in subdivision (b) of Section 1771.5 of the Labor Code. The law requires that District's labor compliance program shall include, but not be limited to, the following requirements:

(a) All bid invitations and public works contracts shall contain appropriate language concerning the requirements of this chapter.

- (b) A pre-job conference shall be conducted with the contractor and subcontractors to discuss federal and state labor law requirements applicable to the contract.
- (c) Project contractors and subcontractors shall maintain and furnish, at a designated time, a certified copy of each weekly payroll containing a statement of compliance signed under penalty of perjury.
- (d) The District shall review, and, if appropriate, audit payroll records to verify compliance with this chapter.
- (e) The District shall withhold contract payments when payroll records are delinquent or inadequate.
- (f) The District shall withhold contract payments equal to the amount of underpayment and applicable penalties when, after investigation, it is established that underpayment has occurred.

The District shall enforce a labor compliance program. A copy of the labor compliance program as currently adopted by the District is included with these bid documents. The labor compliance program which is approved by the Director of the Department of Industrial Relations (the "Labor Compliance Program") is incorporated by reference into the Contract and it will be enforced as required by state law and regulations and the Director of the Department of Industrial Relations.

In accordance with subdivision (b)(1) of Section 1771.5 of the Labor Code, the following notice is given: Contractor and any subcontractors are required to review and comply with the provisions of the California Labor Code, Part 7, Chapter 1, beginning with Section 1720, and the regulations of the Department of Industrial Relations implementing those provisions as more fully discussed in the Contract Documents and the labor compliance program as currently adopted by the District which is included with the bid documents. These statutory and regulatory provisions contain specific requirements, for example, concerning the determination and payment of prevailing wages, retention, inspection and auditing of payroll records, use of apprentices, payment of overtime compensation, securing of workers compensation insurance, and various criminal penalties or fines which may be imposed for violations of the requirements of the chapter. Submission of a bid constitutes Contractor's representation that it has thoroughly reviewed these requirements.

24. Disabled Veterans Participation Goals.

In accordance with Education Code section 17076.11, this District has a participation

goal for disabled veteran business enterprises ("DVBE") of at least 3 percent per year of the overall dollar amount of funds allocated to the District by the State Allocation Board pursuant to the Leroy F. Greene School Facilities Act of 1998 for construction or modernization and expended each year by the District. Prior to, and as a condition precedent for final payment under any contract for such project, the Contractor shall provide appropriate documentation to the District identifying the amount paid to disabled veteran business enterprises in conjunction with the contract, so that the District can assess its success at meeting this goal.

The Office of Small Business and DVBE Certification (OSDC), (916) 375-4940, www.osmb.dgs.ca.gov/BIS/bis_queries/bis_queries_menu.asp,

is an information resource to assist bidders in locating Disabled Veteran Business Enterprises. (Please note: while the OSDC may be used as a resource, the DVBE Program administered by OSDC applies to state contracts not local agency (school district) contracts.)

25. Bid Protests.

Any bidder having submitted a bid on the project may file a protest against the proposed contract award or challenging the validity of other bids. The protest must meet all of the following requirements:

The protest shall be submitted in writing and shall contain all the materials required by these provisions; one that does not contain all the required material shall not be recognized.

The protest shall be received by the Owner no later than the close of business on the second business day after bid opening; one received after that time shall not be recognized.

Each protest shall contain the following:

- (a) Identification by name, address, and telephone number of the protesting person(s) company and/or organization and identification of the project to which the protest pertains.
- (b) The protest shall set forth in detail all grounds for the protest, including without limitation all facts, identification by name of any other bids or bidders involved with the protest, all supporting documentation, together with any legal authorities and/or argument in support of the grounds for the protest. Any matters not set forth in the written protest shall be deemed waived. All factual contentions must be supported by content, admissible, and credible evidence.

Any protest not conforming to the requirements of this section shall be rejected as invalid.

Where a protest is filed in conformity with this section, the Owner's staff, or such individual(s) as may be designated by the Owner, shall review and evaluate the basis of protest and provide a written decision to the protesting bidder. The written decision shall either concur with or deny the protest.

Submission of a written protest to and receipt of a written decision from the Owner's staff shall be considered an administrative remedy, and failure to follow this procedure shall be a bar to any legal action.

The written decision by the Owner's staff may be appealed to the Owner. The appeal must be filed with the Owner's governing board or other governing body within two business days of the protesting bidder's receipt of the written decision of the Owner's staff.

The appeal must clearly state the reasons and basis for appealing the decision of the Owner's staff, making specific reference to any portions of the material submitted with the protest required.

A hearing on the appeal shall be held before the Owner's governing board or other governing body within 45 days of receipt of the appeal.

The owner's governing board or other governing body will make a decision within seven days following the hearing. The decision of the Owner's governing board or other governing body is not subject to arbitration, mediation, reconsideration, or further appeal.

Submission of an appeal to and receipt of a decision from the Owner's governing board or other governing body shall be considered an administrative remedy, and failure to follow this procedure shall be a bar to any legal action.

26. Procedure for Protesting Being Deemed a Non-Responsive Bidder.

Any bidder or prospective bidder deemed non-responsive after having submitted a bid may file an appeal of the action to the Owner's governing body or other governing body. The protest must meet all of the following requirements.

- (a) The appeal shall be submitted in writing, and shall contain all the materials required by these provisions; one that does not contain all the required material shall not be recognized.
- (b) The appeal must be received by the Owner's governing board or other governing body within two business days of the action by the Owner giving rise to the protest; one received after that time shall not be recognized.
- (c) A hearing on the appeal shall be held before the Owner's governing board or other governing body prior to the award of contract.

- (d) The decision of the Owner's governing board or other governing body is not subject to arbitration, mediation, reconsideration, or further appeal.
- (e) Submission of a protest to and receipt of a decision from the Owner's governing board or other governing body shall be considered an administrative remedy, and failure to follow this procedure shall be a bar to any legal action.

END OF DOCUMENT

DOCUMENT 00300 BID FORM

TO: Ojai Unified School District, acting by and through its Governing Board, herein called the "District":

1. Pursuant to and in compliance with your Notice to Contractors Calling for Bids and the other documents relating thereto, the undersigned bidder, having thoroughly examined and familiarized himself with the terms of the contract, the local conditions affecting the performance of the contract and the cost of the work at the place where the work is to be done, and with the drawings and specifications and other contract documents, hereby proposes and agrees to perform, within the time stipulated, the contract, including all of its component parts, and everything required to be performed, and to provide and furnish any and all of the labor, materials, tools, expendable equipment, and all utility and transportation services necessary to perform the contract and complete in a workmanlike manner all of the work required in connection with (complete all that apply):

Campus Wide Painting Project @ Matilija Middle School

Project Number: 2021-1600

amount of	Dollars (\$).
the office of the Director of Purchasing of said Dis	trict for the base bid		
documents, including addenda numbers	<u>,</u> , and	_, on file at	
all in strict conformity with the drawings and specif	ications and other contr	act	

- It is understood that the District reserves the right to reject this bid and that this bid shall remain open and not be withdrawn for the period specified in the Notice to Contractors Calling for Bids.
- 3. The required bid security is attached hereto.
- 4. The required unit prices form is attached hereto.
- 5. The required contractor registration certifications form is attached hereto.
- Non-collusion affidavit is attached hereto.
- 7. The required list of proposed subcontractors is attached hereto.
- 8. It is understood and agreed that bidder shall provide the addresses, telephone numbers, and license numbers of all listed subcontractors within one business day of bid opening or bidder's bid may be rejected as nonresponsive.
- 9. It is understood and agreed that if written notice of the acceptance of this bid is mailed, telegraphed, or delivered to the undersigned after the opening of the bid, and within the time this bid is required to remain open, or at any time thereafter before this bid is withdrawn, the undersigned will execute and deliver to the District a contract in the form attached hereto in accordance with the bid as accepted. The undersigned will also furnish and deliver to the District the Performance Bond and Payment Bond for Public Works as specified, all within five (5) days after receipt of notification of award. The work under the contract shall be commenced by the undersigned bidder, if awarded the contract, on the date to be stated in the District's Notice to the Contractor to Proceed, and shall be completed by the Contractor in the time specified in the contract documents.
- 10. Notice of acceptance or requests for additional information should be addressed to the undersigned at the address stated below.

11. The names of a follows:	all persons interested in t	the foregoing prop	posal as principals are as
(IMPORTANT name of corpoi thereof; if a co-	ration, also names of the partnership, state true namprising the firm; if bidde	president, secret ame of firm, also	son is a corporation, state legal cary, treasurer, and manager names of all individual ted person is an individual, state
registration of (that he is licensed in ac Contractors, License No.		e law providing for the Expiration Date,
I,	, the		of the bidder, hereby
	by the bidder in connecti		of the bidder, hereby lifornia, that all of the nd all of the representations
	day of	at	County,
	P	roper Name of Bio	dder
	•		
together with the signa corporate seal; if bidde together with the signa	atures of authorized office or is a partnership, the tru ature of the partner or pa	e of the corporatiers or agents and ue name of the fir thers authorized	ure of Bidder on shall be set forth above the document shall bear the m shall be set forth above to sign contracts on behalf of e shall be placed above.
Business Address:			
Place of Residence: _			
Telephone: ()			

END OF DOCUMENT



Prevailing Wage Certification

AGREEMENT FOR CONSTRUCTION

SERVICES AGREEMENT NUMBER_2021-1600

THIS betwe	CONTRACT is made and entered into this een	day of , 20, by and ("Contractor") and
	School D	District ("District") ("Contract").
1.	The Contractor shall furnish to the District (\$) ("Cas provided in the project specifictions of: following services ("Services" or "Work"):	for a total price of Dollars Contract Price"), including a contingency allowance Fifteen Thousand Dollars (\$ 15,000.00) the
[LI	ST SERVICES OR ATTACH SCOPE OF WORK AI	ND DESIGNATE AS EXHIBIT "A"]
2.	Contractor shall perform the Work at Mati Project is the scope of Work performed at	ilija Middle School ("Premises" or "Site"). The the Site.
3.		with limited access (after hours, weekends) after first 30 cified in the District's Notice to Proceed. This includes
4.	the completion schedule, construction schedule, rousing schedule, construction schedule, construction schedule, schedule, construction schedule, s	completed within the Contract Time and/or pursuant to nedule, or project milestones developed pursuant to d, acknowledged, and agreed that the District will suffer culated. Pursuant to Government Code section rict, as fixed and liquidated damages for these thousand Dollars dar day of delay beyond the Contract Time or beyond hedule, or project milestones established pursuant to
5.	The Contract Documents include only theNotice to Bidders	Asbestos & Other Hazardous Materials
	Instructions to Bidders	Certification
	Bid Form and Proposal	Lead-Product (s) Certification Roofing Project Certification
	Bid Bond	X Insurance Certification & Endorsements
	Designated Subcontractors List Notice to Proceed	X Performance Bond
	Terms and Conditions to Contract	_X Payment Bond
	Noncollusion Declaration	Specifications

	Workers' Compensation Certification	Plans
	Criminal Background Investigation Certification	Scope of Work
	Drug-Free Workplace Certification	
	Tobacco-Free Environment Certification	
	Certification of Contractor and Subcontractor	
	PWC 100 submitted on Dept. of Industrial Relations website	
	Certification of Financial Relationships –AB 635	
	Certification of Financial Relationships in Regard to Roofing Projection	ect
6.	Contractor shall not commence the Work under and the District has approved the performance be certificate(s) and affidavit(s), and the endorsement and Conditions and the District has issued a Not	ond, payment (labor and material) bond, the ent(s) of insurance required under the Terms
7.	Payment for the Work shall be made in accordar	nce with the Terms and Conditions.
8.	The architect for the Project is the Project is on the Project is acknowledges that the Architect, the Project Marthe State Architect have authority to approve and not comply with the requirements of the Contract Regulations, and all applicable laws. No work shand under the inspection of said Project Inspects any or all parts of work at any time. Contractor stopportunities for obtaining such information as minformed respecting progress, manner of work, a be liable for any delay caused by its non-compliantification for inspection.	("Project Inspector"). Contractor hereby nager, the Project Inspector, and the Division of d/or stop Work if the Contractor's Work does t Documents, Title 24 of the California Code of all be carried on except with the knowledge or. Project Inspector shall have free access to hall furnish Project Inspector reasonable hay be necessary to keep Project Inspector fully and character of materials. The Contractor shall
9.	Inspection and acceptance of the Work shall be	performed by representative of the District.
10.	Any notice required or permitted to be given und given, served, and received if given in writing an United States mail, registered or certified mail, p by overnight delivery service, or facsimile transm	d either personally delivered or deposited in the ostage prepaid, return receipt required, or sent
	<u>District</u>	Contractor
	School District	Name:
	ATTN:	ATTN:
	[ADDRESS]	[ADDRESS]
	[E - MAIL]	[E - MAIL]

Any notice personally given or sent by facsimile transmission shall be effective upon receipt. Any notice sent by overnight delivery service shall be effective the business day next following delivery to the overnight delivery service. Any notice given by mail shall be effective three (3) days after deposit in the United States mail.

- 11. Contractor shall guarantee all labor and material used in the performance of this Contract for a period of one year from the date of the District's written approval of the Work or as provided in the job specifications.
- 12. This Contract incorporates by this reference the Terms and Conditions attached hereto. Contractor, by executing this Contract, agrees to comply with all the Terms and Conditions.
- 13. Each party has the full power and authority to enter into and perform this Contract, and the person signing this Contract on behalf of each party has been properly authority and empowered to enter into this Contract.
- 14. By signing this Agreement, Contractor certifies, under penalty of perjury, that all the information provided in the Contract Documents is true, complete, and correct.

AC	CEP	TED	AND	AGREED	on the	date	indicated	below
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Dated:	, 20	Dated:	20
	School District	Contractor:	
Signature:		Signature:	
Print Name:		Print Name:	
Print Title:		Print Title:	
Address:		Address:	
Telephone:		Telephone:	
Facsimile:		Facsimile:	
E-Mail:		E-Mail:	
Information regarding Con	tractor:		
License No.:		·	:
Address:		Employer Identification a Social Security Number	
Telephone:		NOTE: Section 6041 o Revenue Code (26 U.S Section 1.6041-1 of Tit	S.C. 6041) and
Facsimile:		Code of Federal Regu C.F.R. 1.6041-1) requir	es the
E-Mail:		recipients of \$600.00 of furnish their taxpayer to the payer. In order to with these requirements	information to comply

District requires the Contractor to furnish the information requested in this

section.

Type of Business Entity:	
Individual	Other:
Sole Proprietorship	
Partnership	
Limited Partnership	
Corporation, State:	
Limited Liability Comp	any

TERMS AND CONDITIONS TO CONTRACT

- 1. **NOTICE TO PROCEED:** District shall provide a Notice to Proceed to Contractor pursuant to the Contract at which time Contractor shall proceed with the Work.
- 2. **STANDARD OF CARE:** Contractor shall perform, diligently prosecute and complete the Work in a good and workmanlike manner within the Contract Time, and in strict conformity with all Contract Documents.
- 3. **SITE EXAMINATION:** Contractor has examined the Site and certifies that it accepts all measurements, specifications and conditions affecting the Work to be performed at the Site. By submitting its quote, Contractor warrants that it has made all Site examination(s) that it deems necessary as to the condition of the Site, its accessibility for materials, workers and utilities, and Contractor's ability to protect existing surface and subsurface improvements. No claim for allowance of time or money will be allowed as to any other undiscovered condition on the Site.
- 4. **PERMITS. LICENSES AND REGISTRATION:** Contractor and all of its employees, agents, and subcontractors shall secure and maintain in force, at Contractor's sole cost and expense, all licenses, registration and permits as are required by law, in connection with the furnishing of materials, supplies, or services herein listed.
- 5. **PROJECT INSPECTION CARD:** Contractor shall verify that forms DSA 152 Project Inspection Card (or current version) are issued for the Project prior to commencement of construction.
- 6. **NOTIFICATION:** Contractor shall notify the Architect and Project Inspector, in writing, of the commencement and completion of construction of each and every aspect of the work at least 48 hours in advance by submitting form DSA 156 (or the most current version) to the Project Inspector. Forms are available on the DSA's website at: http://www.dgs.ca.gov/dsa/Forms.aspx.
- 7. **EQUIPMENT AND LABOR:** Contractor shall furnish all tools, equipment, apparatus, facilities, transportation, labor, and material necessary to furnish the services herein described, the services to be performed at such times and places as directed by and subject to the approval of the authorized District representative indicated in the Work specifications attached hereto.
- 8. **SUBSTITUTIONS**: No substitutions of material from those specified in the Work Specifications shall be made without the prior written approval of the District. Contractor shall be responsible for any re-design costs occasioned by District's acceptance and/or approval of any substitute, as well as any costs that the District incurs for professional services, including DSA fees. District may deduct those costs from any amounts owing to Contractor for the review of the request for substitution, even if the request for substitution is not approved. Contractor shall, in the event that a substitute is less costly than that specified, credit the District with one-hundred percent (100%) of the net difference between the substitute and the originally specified material.

- 9. **INDEPENDENT CONTRACTOR STATUS:** While engaged in carrying out the Services of this Contract, the Contractor is an independent contractor, and not an officer, employee, agent, partner, or joint venture of the District. Contractor shall be solely responsible for its own Worker's Compensation insurance, taxes, and other similar charges or obligations. Contractor shall be liable for its own actions, including its negligence or gross negligence, and shall be liable for the acts, omissions, or errors of its agents or employees.
- 10. **CONTRACTOR SUPERVISION:** Contractor shall provide competent supervision of personnel employed on the job Site, use of equipment, and quality of workmanship.
- 11. **WORKERS:** Contractor shall at all times enforce strict discipline and good order among its employees and the employees of its subcontractors and shall not employ or work any unfit person or anyone not skilled in work assigned to him or her. Any person in the employ of the Contractor or a subcontractor whom the District may deem incompetent or unfit shall be dismissed from the Site and shall not again be employed at Site without written consent from the District.
- 12. **SUBCONTRACTORS:** Subcontractors, if any, engaged by the Contractor for any Service or Work under this Contract shall be subject to the approval of the District. Contractor agrees to bind every subcontractor by the terms of the Contract as far as such terms are applicable to subcontractor's work, including, without limitation, all indemnification, insurance, bond, and warranty requirements. If Contractor shall subcontract any part of this Contract, Contractor shall be fully responsible to the District for acts and omissions of its subcontractor and of persons either directly or indirectly employed by itself. Nothing contained in the Contract Documents shall create any contractual relations between any subcontractor and the District.
- 13. **SAFETY AND SECURITY:** Contractor is responsible for maintaining safety in the performance of this Contract. Contractor shall be responsible to ascertain from the District the rules and regulations pertaining to safety, security, and driving on school grounds, particularly when children are present.
- 14. **FINGERPRINTING OF EMPLOYEES**: Contractor shall comply with the provisions of Education Code section 45125.1 regarding the submission of employee fingerprints to the California Department of Justice and the completion of criminal background investigations of its employees. Contractor shall not permit any employee to have any contact with District pupils until such time as the Contractor has verified in writing to the governing board of the District that the employee has not been convicted of a felony, as defined in Education Code section 45122.1. Contractor's responsibility shall extend to all employees, subcontractors, agents, and employees or agents of subcontractors regardless of whether those individuals are paid or unpaid, concurrently employed by the District, or acting as independent contractors of the Contractor. Unless the District determines that the Contractor will have limited contact with students, verification of compliance with this section and the Criminal Background Investigation Certification required with this Contract shall be provided to the District prior to Contractor performing any portion of the Work.
- 15. **TRENCH SHORING:** If this Contract is in excess of \$25,000 and is for the excavation of any trench deeper than five (5) feet, Contractor must submit and obtain District acceptance, in advance of excavation, of a detailed plan showing the design of shoring, bracing, sloping, or other provisions to be made for worker protection from the hazard of caving ground during the excavation of such trench or trenches. If the plan varies from the shoring system standards, the plan shall be prepared by a registered civil or structural engineer.
- 16. **EXCAVATIONS OVER FOUR FEET**: If this Contract includes excavations over four (4) feet,

Contractor shall promptly, and before the following conditions are disturbed, notify the District, in writing, of any: (1) Material that the Contractor believes may be material that is hazardous waste, as defined in Section 25117 of the Health and Safety Code, that is required to be removed to a Class I, Class II, or Class III disposal site in accordance with provisions of existing law; (2) Subsurface or latent physical conditions at the site differing from those indicated; or (3) Unknown physical conditions at the site of any unusual nature, different materially from those ordinarily encountered and generally recognized as inherent in work of the character provided for in the Contract. The District shall promptly investigate the conditions, and if it finds that the conditions do materially so differ, or do involve hazardous waste, and cause a decrease or increase in the Contractor's cost of, or the time required for, performance of any part of the Work shall issue a change order under the procedures described in the Contract. In the event that a dispute arises between the District and the Contractor whether the conditions materially differ, or involve hazardous waste, or cause a decrease or increase in the Contractor's cost of, or time required for, performance of any part of the work, the Contractor shall not be excused from any scheduled completion date provided for by the contract, but shall proceed with all Work to be performed under the contract. The Contractor shall retain any and all rights provided either by Contract or by law which pertain to the resolution of disputes and protests between the contracting parties.

- 17. **LEAD-BASED PAINT:** Pursuant to the Lead-Safe Schools Protection Act (Education Code Section 32240 et seq.) and other applicable law, no lead-based paint, lead plumbing and solders, or other potential sources of lead contamination shall be utilized on this Project, and only trained and state-certified contractors, inspectors and workers shall undertake any action to abate existing risk factors for lead. Pursuant to the Renovation, Repair and Painting Rule (title 40 of the Code of Federal Regulations part 745 (40 CFR 745)), all contractors who disturb lead-based paint in a sixsquare-foot area or greater indoors or a 20-square-foot area outdoors must be trained by an EPAaccredited provider and certified by the EPA. Contractor must execute the Lead-Based Paint Certification, if applicable.
- 18. **CLEAN UP:** Debris shall be removed from the Premises. The Site shall be in order at all times when work is not actually being performed and shall be maintained in a reasonably clean condition.
- 19. **PROTECTION OF WORK AND PROPERTY:** Contractor shall erect and properly maintain at all times, as required by conditions and progress of the Work, all necessary safeguards, signs, barriers, lights, and security persons for protection of workers and the public, and shall post danger signs warning against hazards created by the Work. In an emergency affecting life and safety of life or of Work or of adjoining property, Contractor, without special instruction or authorization from District, is permitted to act at his discretion to prevent such threatened loss or injury.
- 20. **FORCE MAJEURE:** The Contractor shall be excused from performance hereunder during the time and to the extent that it is prevented from obtaining delivery, or performing by act of God, fire, strike, loss, or shortage of transportation facilities, lock-out, commandeering of materials, product, plant, or facilities by the government, when satisfactory evidence thereof is presented to the District, provided that it is satisfactorily established that the non-performance is not due to the fault or neglect of the Contractor.
- 21. **CORRECTION OF ERRORS:** Contractor shall perform, at its own cost and expense and without reimbursement from the District, any work necessary to correct errors or omissions which are caused by the Contractor's failure to comply with the standard of care required herein.

- 22. **ACCESS TO WORK:** District representatives, Architect, and Project Inspector shall at all time have access to the Work wherever it is in preparation or in progress. Contractor shall provide safe and proper facilities for such access.
- 23. **OCCUPANCY:** District reserves the right to occupy buildings at any time before formal Contract completion and such occupancy shall not constitute final acceptance or approval of any part of the Work covered by this Contract, nor shall such occupancy extend the date specified for completion of the Work.
- 24. **PAYMENT:** On a monthly basis, Contractor shall submit an application for payment based upon the estimated value for materials delivered or services performed under the Contract as of the date of submission ("Application for Payment"). Within thirty (30) days after District's approval of the Application for Payment, Contractor shall be paid a sum equal to ninety-five percent (95%) of the value of the Work performed (as verified by Architect and Inspector and certified by Contractor) up to the last day of the previous month, less the aggregate of previous payments and amount to be withheld. The District may withhold or deduct from any payment an amount necessary to protect the District from loss because of: (1) liquidated damages which have accrued as of the date of the application for payment; (2) any sums expended by the District in performing any of Contractor's obligations under the Contract which Contractor has failed to perform or has performed inadequately; (3) defective Work not remedied; (4) stop payment notices as allowed by state law; (5) reasonable doubt that the Work can be completed for the unpaid balance of the Total Contract price or by the scheduled completion date; (6) unsatisfactory prosecution of the Work by Contractor; (7) unauthorized deviations from the Contract; (8) failure of the Contractor to maintain or submit on a timely basis proper and sufficient documentation as required by the Contract or by District during the prosecution of the Work; (9) erroneous or false estimates by the Contractor of the value of the Work performed; (10) any sums representing expenses, losses, or damages, as determined by the District, incurred by the District for which Contractor is liable under the Contract; and (11) any other sums which the District is entitled to recover from Contractor under the terms of the Contract or pursuant to state law, including section 1727 of the California Labor Code. The failure by the District to deduct any of these sums from a progress payment shall not constitute a waiver of the District's right to such sums. The District shall retain five percent (5%) from all amounts owing as retention. Retention shall be paid pursuant to Public Contract Code sections 7107, 7200 and 7201.
- 25. **CHANGE IN SCOPE OF WORK:** Any change in the scope of the Work, method of performance, nature of materials or price thereof, or any other matter materially affecting the performance or nature of the Work shall not be paid for or accepted unless such change, addition, or deletion is approved in advance and in writing by a valid change order executed by the District. Contractor specifically understands, acknowledges, and agrees that the District shall have the right to request any alterations, deviations, reductions, or additions to the Project or Work, and the cost thereof shall be added to or deducted from the amount of the Contract Price by fair and reasonable valuations. Contractor also agrees to provide the District with all information requested to substantiate the cost of the change order and to inform the District whether the Work will be done by the Contractor or a subcontractor. In addition to any other information requested, Contractor shall submit, prior to approval of the change order, its request for a time extension (if any), as well as all information necessary to substantiate its belief that such change will delay the completion of the Work. If Contractor fails to submit its request for a time extension or the necessary supporting information, it shall be deemed to have waived its right to request such extension.
- 26. **INDEMNIFICATION:** To the furthest extent permitted by California law, Contractor agrees to defend, indemnify, and hold harmless District, its officers, agents, employees, and/or volunteers

from any and all claims, demands, losses, damages and expenses, including legal fees and costs, or other obligations or claims arising out of any liability or damage to person or property, or any other loss, sustained or claimed to have been sustained arising out of activities of the Contractor or those of any of its officers, agents, employees, or subcontractors of Contractor, whether such act or omission is authorized by this Agreement or not. Contractor shall also pay for any and all damage to the Real and Personal Property of the District, or loss or theft of such Property, done or caused by such persons. District assumes no responsibility whatsoever for any property placed on District premises by Contractor, Contractor's agents, employees or subcontractors. Contractor further hereby waives any and all rights of subrogation that it may have against the District. The District shall have the right to accept or reject any legal representation that Contractor proposes to defend the District. The provisions of this Indemnification do not apply to any damage or losses caused solely by the negligence of the District or any of its officers, agents, employees, and/or volunteers.

- 27. **CONTRACTOR'S INSURANCE:** Contractor, at its own cost and expense, shall procure and maintain during the term of this Contract, policies of insurance for the following types of coverage
 - 27.1 Workers' Compensation and Employers' Liability Insurance. Contractor shall procure and maintain, during the term of this Agreement, Workers' Compensation Insurance, as required by California law, on all of its employees engaged in work related to the performance of this Agreement. In the case of any such work which is subcontracted, Contractor shall require all subcontractors to provide Workers' Compensation Insurance for all of the subcontractor's employees to be engaged in such work unless such employees are covered by the protection afforded by the Contractor's Workers' Compensation Insurance.

Contractor and all subcontractors shall procure and maintain, during the term of this Agreement Employers' Liability insurance of \$1,000,000.

27.2 Commercial General Liability Insurance. Contractor shall procure and maintain, during the term of this Agreement, not less than the following General Liability Insurance coverage:

	Each Occurrence	<u>Aggregate</u>
Low Risk Projects	\$ 1,000,000.00	\$ 2,000,000.00
Intermediate Risk	\$- 2,000,000.00	\$ 4,000,000.00
High Risk	\$ 5,000,000.00	\$ 10,000,000.00

Commercial General Liability insurance shall include products/completed operations, broad form property damage, and personal and advertising injury coverage.

Any and all subcontractors hired by Contractor in connection with the Services described in this Contract shall maintain such insurance unless the Contractor's insurance covers the subcontractor and its employees.

27.3 Automobile Liability. If vehicles will be driven on district property, Contractor shall procure and maintain, during the full term of this Agreement following Automobile Liability Insurance with the following minimum coverage limits:

Personal vehicles: \$500,000.00 combined single limit or

\$ 100,000.00 per person / \$300,000.00 per accident

Commercial vehicles: \$1,000,000.00 combined single limit

Contractor's and any and all subcontractor's Commercial Automobile Liability Insurance shall name the District, its employees, and school board members as additional insureds.

- 27.4 <u>Builder's Risk.</u> District shall procure and maintain, during the term of this Contract, Builders' Risk coverage.
- 27.5 Other Coverage as Dictated by the District. Contractor shall procure and maintain, during the term of this Agreement, the following other Insurance coverage:

	Each Occurrence	Aggregate
☐ Pollution Liability	\$-1,000,000.00	\$ 2,000,000.00
□ Other:	\$	\$

27.6 Certificates of Insurance. Contractor and any and all subcontractors working for Contractor shall provide certificates of insurance to the District as evidence of the insurance coverage required herein, not less than fifteen (15) days prior to commencing work for the District, and at any other time upon the request of the District. Certificates of such insurance shall be filed with the District on or before commencement of the services under this Agreement.

Contractor's and any and all Contractor subcontractor's Commercial General Liability insurance shall name the District, its employees, and school board members; the Architect; and the Project Manager as additional insureds. The Contractor's policy(ies) shall be primary; any insurance carried by the District, other than Builder's Risk, shall only be secondary and supplemental.

Insurance written on a "claims made" basis is to be renewed by the Contractor and all Contractor subcontractors for a period of five (5) years following termination of this Agreement. Such insurance must have the same coverage and limits as the policy that was in effect during the term of this agreement, and will cover the Contractor for all claims made.

The policy(ies) shall not be amended or modified and the coverage amounts shall not be reduced without thirty (30) days written notice to the District prior to cancellation.

27.7 Failure to Procure Insurance. Failure on the part of Contractor, or any of its subcontractors, to procure or maintain required insurance shall constitute a material breach of contract under which the District may immediately terminate this Contract.

28. **PAYMENT BOND AND PERFORMANCE BOND:** Contractor shall not commence the Work until it has provided to the District, in a form acceptable to the District, a Payment (Labor and Material)

Bond and a Performance Bond, each in an amount equivalent to one hundred percent (100%) of the Contract Price issued by a surety admitted to issue bonds in the State of California and otherwise acceptable to the District.

- 29. **WARRANTY/QUALITY:** Unless a longer warranty is called for elsewhere in the Contract Documents, the Contractor, manufacturer, or their assigned agents shall guarantee the workmanship, product or service performed against defective workmanship, defects or failures of materials for a minimum period of one (1) year from filing the Notice of Completion with the county in which the Site is located. All workmanship and merchandise must be warranted to be in compliance with applicable California energy, conservation, environmental, and educational standards.
- 30. **CONFIDENTIALITY:** The Contractor shall maintain the confidentiality of all information, documents, programs, procedures, and all other items that Contractor encounters while performing the Contractor's Services to the extent allowed by law. This requirement shall be ongoing and shall survive the expiration or termination of this Contract and specifically includes all student, parent, and disciplinary information.
- 31. **COMPLIANCE WITH LAWS:** Contractor shall give all notices and comply with all laws, ordinance, rules and regulations bearing on conduct of the Work as indicated or specified. If Contractor observes that any of the Work required by this Contract is at variance with any such laws, ordinance, rules or regulations, Contractor shall notify the District, in writing, and, at the sole option of the District, any necessary changes to the scope of the Work shall be made and this Contract shall be appropriately amended in writing, or this Contract shall be terminated effective upon Contractor's receipt of a written termination notice from the District. If Contractor performs any work that is in violation of any laws, ordinances, rules or regulations, without first notifying the District of the violation, Contractor shall bear all costs arising therefrom.
- 32. **LABOR CODE REQUIREMENTS**: The Contractor shall comply with all applicable provisions of the California Labor Code, Division 3, Part 7, Chapter 1, Articles 1 5, including, without limitation, the payment of the general prevailing per diem wage rates for public work projects of more than one thousand dollars (\$1,000). Copies of the prevailing rate of per diem wages are on file with the District. In addition, the Contractor and each subcontractor shall comply with Chapter 1 of Division 2, Part 7 of the California Labor Code, beginning with Section 1720, and including Section 1735, 1777.5 and 1777.6, forbidding discrimination, and Sections 1776, 1777.5 and 1777.6 concerning the employment of apprentices by Contractor or subcontractors. Willful failure to comply may result in penalties, including loss of the right to bid on or receive public works contracts.
 - 32.1 **State Labor Compliance**: Contractor shall perform the Work of the Project while complying with all the applicable regulations, including section 16000, et seq., of Title 8 of the California Code of Regulations and is subject to State labor compliance monitoring and enforcement by the Compliance Monitoring Unit of the Department of Industrial Relations.
 - 32.2 **Certified Payroll Records**: Contractor and its subcontractor(s) shall keep accurate certified payroll records of employees and shall electronically submit certified payroll records directly to the Labor Commissioner weekly and within ten (10) days of any request by the District or the Labor Commissioner in accordance with section 16461 of Title 8 of the California Code of Regulations.
- 33. **ANTI-DISCRIMINATION:** It is the policy of the District that in connection with all work performed under Contracts there be no discrimination against any employee engaged in the work

because of race, color, ancestry, national origin, religious creed, physical disability, medical condition, marital status, sexual orientation, gender, or age and therefore the Contractor agrees to comply with applicable Federal and California laws including, but not limited to the California Fair Employment Practice Act beginning with Government Code Section 12900 and Labor Code Section 1735. In addition, the Contractor agrees to require like compliance by all its subcontractor(s).

- 34. **DISABLED VETERAN BUSINESS ENTERPRISES:** Section 17076.11 of the Education Code requires school districts using funds allocated pursuant to the State of California School Facility Program for the construction or modernization of a school building (SFP Funds) to have a participation of at least three percent (3%), per year, of the overall dollar amount expended each year by the school district, for disabled veteran business enterprises (DVBE). If this Contract uses SFP Funds, Contractor must submit, with its executed Contract, appropriate documentation to the District identifying the steps Contractor has taken to solicit DVBE participation in conjunction with this Contract.
- 35. **ANTI-TRUST CLAIM**: Contractor and its subcontractor(s) agree to assign to the District all rights, title, and interest in and to all causes of action they may have under Section 4 of the Clayton Act (15 U.S.C. Sec. 15) or under the Cartwright Act (Chapter 2 (commencing with Section 16700) of Part 2 of Division 7 of the Business and Professions Code), arising from purchases of goods, services, or materials pursuant to the Contract or a subcontract. This assignment shall be made and become effective at the time the District tenders final payment to the Contractor, without further acknowledgment by the parties.
- 36. **DISPUTES**: In the event of a dispute between the parties as to performance of the Work, the interpretation of this Contract, or payment or nonpayment for work performed or not performed. the parties shall attempt to resolve the dispute by those procedures set forth in Public Contract Code section 20104, et seq., if applicable. Pending resolution of the dispute, Contractor agrees it will neither rescind the Contract nor stop the progress of the Work, but will allow determination by the court of the State of California, in the county in which the District's administration office is located, having competent jurisdiction of the dispute. All claims of over \$375,000, which are outside the scope of Public Contract Code section 20104, et seg., may be determined by mediation if mutually agreeable, otherwise by litigation. Notice of the demand for mediation of a dispute shall be filed in writing with the other party to the Contract. The demand for mediation of any claim of over \$375,000 shall be made within a reasonable time after written notice of the dispute has been provided to the other party, but in no case longer than ninety (90) days after initial written notice, and the demand shall not be made later than the time of Contractor submission of the request for final payment. If a claim, or any portion thereof, remains in dispute upon satisfaction of all applicable dispute resolution requirements, the Design-Builder shall comply with all claims presentation requirements as provided in Chapter 1 (commencing with section 900) and Chapter 2 (commencing with section 910) of Part 3 of Division 3.6 of Title 1 of Government Code as a condition precedent to the Contractor's right to bring a civil action against the District. For purposes of those provisions, the running of the time within which a claim must be presented to the District shall be tolled from the time the claimant submits its written claim until the time the claim is denied, including any time utilized by any applicable meet and confer process.
- 37. **ATTORNEY FEES/COSTS:** Should litigation be necessary to enforce any terms or provisions of this Agreement, then each party shall bear its own litigation and collection expenses, witness fees, court costs and attorney's fees.
- 38. **TERMINATION:** If Contractor fails to perform the Services and Contractor's duties to the satisfaction of the District, or if Contractor fails to fulfill in a timely and professional manner Contractor's obligations under this Contract, or if Contractor violates any of the terms or

provisions of this Contract, District shall have the right to terminate this Contract effective immediately upon the District giving written notice thereof to the Contractor. The Contractor and its performance bond surety, if any, shall be liable for all damages caused to the District by reason of the Contractor's failure to perform and complete the Contract. District shall also have the right in its sole discretion to terminate the Contract for its own convenience upon District giving three (3) days written notice thereof to the Contractor. In case of a termination for convenience, Contractor shall be paid for the actual cost for labor, materials, and services performed that is unpaid and can be documented through timesheets, invoices, receipts, or otherwise, and five percent (5%) of the total cost of Work performed as of the date of termination, or five percent (5%) of the value of the Work yet to be performed, whichever is less. This five percent (5%) shall be full compensation for all of Contractor's and its subcontractor(s)' mobilization and/or demobilization costs and any anticipated loss profits resulting from termination of the Contractor for convenience. Termination shall have no effect upon any of the rights and obligations of the parties arising out of any transaction occurring prior to the effective date of termination.

- 39. **ASSIGNMENT OF CONTRACT:** Contractor shall not assign or transfer in any way any or all of its rights, burdens, duties, or obligations under this Contract without the prior written consent of the District.
- 40. **TIME IS OF THE ESSENCE:** Time is of the essence in the performance of and compliance with each of the provisions and conditions of this Contract.
- 41. **CALCULATION OF TIME:** For the purposes of this Contract, "days" refers to calendar days unless otherwise specified.
- 42. **GOVERNING LAW AND VENUE:** Contractor hereby acknowledges and agrees that District is a public entity, which is subject to certain requirements and limitations. This Contract and the obligations of District hereunder are subject to all applicable federal, state and local laws, rules, and regulations, as currently written or as they may be amended from time to time. This Contract shall be interpreted in accordance with the laws of the State of California. If any action is brought to interpret or enforce any term of this Contract, the action shall be brought in state or federal court situated in the County of Ventura, State of California. Contractor hereby waives and expressly agrees not to assert, claim or allege, in any way, that it is not subject to the personal jurisdiction of the courts named above. Contractor further agrees to waive any claim or allegation that the suit, action, or proceeding is either brought in an inconvenient forum or that the related venue is improper.
- 43. **BINDING CONTRACT:** This Contract shall be binding upon the parties hereto and upon their successors and assigns, and shall inure to the benefit of said parties and their successors and assigns.
- 44. **DISTRICT WAIVER:** District's waiver of any term, condition, covenant or waiver of a breach of any term, condition or covenant shall not constitute the waiver of any other term, condition or covenant or the waiver of a breach of any other term, condition or covenant.
- 45. **CAPTIONS AND INTERPRETATIONS:** Paragraph headings in this Contract are used solely for convenience, and shall be wholly disregarded in the construction of this Contract. No provision of this Contract shall be interpreted for or against a party because that party or its legal representative drafted such provision, and this Contract shall be construed as if jointly prepared by the parties.
- 46. **INVALID TERM:** If any provision of this Contract is declared or determined by any court of

competent jurisdiction to be illegal, invalid or unenforceable, the legality, validity or enforceability of the remaining parts, terms and provisions shall not be affected thereby, and said illegal, unenforceable or invalid part, term or provision will be deemed not to be a part of this Contract.

- 47. **PROVISIONS REQUIRED BY LAW DEEMED INSERTED:** Each and every provision of law and clause required by law to be inserted in this Contract shall be deemed to be inserted herein and this Contract shall be read and enforced as though it were included therein.
- 48. **ENTIRE CONTRACT:** This Contract sets forth the entire Contract between the parties hereto and fully supersedes any and all prior agreements, understanding, written or oral, between the parties hereto pertaining to the subject matter thereof. This Contract may be modified only by a writing upon mutual consent.



DOCUMENT 00410

BID BOND

KNOW ALL MEN BY THESE PRESENTS: THAT we,, as
Principal, and
THE CONDITION OF THIS OBLIGATION IS SUCH that whereas the Principal has submitted the accompanying bid dated, 20 for
NOW, THEREFORE, if the Principal shall not withdraw said bid within the period specified therein after the opening of the same, or, if no period be specified, within sixty (60) days after said opening; and, if the Principal be awarded the contract, and shall within the period specified therefore, or, if no period be specified, within five (5) days after the prescribed forms are presented to him for signature, enter into a written contract with the District, in accordance with the bid as accepted and give bond with good and sufficient surety or sureties, as may be required, for the faithful performance and proper fulfillment of such contract and for the payment for labor and materials used for the performance of the contract, or in the event of the withdrawal of said bid within the period specified or the failure to enter into such contract and give such bonds within the time specified, if the Principal shall pay the District the difference between the amount specified in said bid and the amount for which the District may procure the required work and/or supplies, if the latter amount be in excess of the former, together with all costs incurred by the District in again calling for bids, then the above obligation shall be void and of no effect, otherwise to remain in full force and virtue.
Surety, for value received, hereby stipulates and agrees that no change, extension of time, alteration or addition to the terms of the contract on the call for bids, or to the work to be performed thereunder, or the specifications accompanying the same, shall in anywise affect its obligation under this bond, and it does hereby waive notice of any such change, extension of time, alteration or addition to the terms of said contract or the call for bids, or to the work, or to the specifications.
In the event suit is brought upon this bond by the District and judgment is recovered, the Surety shall pay all litigation expenses incurred by the District in such suit, including reasonable attorneys' fees, court costs, expert witness fees and investigation expenses.
IN WITNESS WHEREOF, the above-bound parties have executed this instrument under their several seals this day of, 20, the name and corporate seal of each corporate party being hereto affixed and these presents duly assigned by its undersigned representative, pursuant to authority of its governing body.
(Corporate Seal)
PRINCIPAL
By: Title:
SURETY:
By:
Attorney-in Fact
(Attach Attorney-in-Fact Certificate)



DOCUMENT 00430 DESIGNATION OF SUBCONTRACTORS

In compliance with the Subletting and Subcontracting Fair Practices Act (chapter 4 (commencing at section 4100), part 1, division 2 of the Public Contract Code of the State of California) and any amendments thereof, each bidder shall set forth below: (a) the name and the location of the place of business of each subcontractor who will perform work or labor or render service to the prime contractor in or about the construction of the work or improvement to be performed under this contract or a subcontractor licensed by the State of California who, under subcontract to the prime contractor, specially fabricates and installs a portion of the work or improvement according to detailed drawings contained in the plans and specifications in an amount in excess of one-half of one percent of the prime contractor's total bid and (b) the portion of the work which will be done by each subcontractor under this contract. The prime contractor shall list only one subcontractor for each such portion as is defined by the prime contractor in this bid.

If a prime contractor fails to specify a subcontractor or if a prime contractor specifies more than one subcontractor for the same portion of work to be performed under the contract in excess of one-half of one percent of the prime contractor's total bid, he shall be deemed to have agreed that he is fully qualified to perform that portion himself, and that he shall perform that portion himself.

No prime contractor whose bid is accepted shall (a) substitute any subcontractor, (b) permit any subcontract to be voluntarily assigned or transferred or allow it to be performed by any one other than the original subcontractor listed in the original bid, or (c) sublet or subcontract any portion of the work in excess of one-half of one percent of the prime contractor's total bid as to which his original bid did not designate a subcontractor, except as authorized in the Subletting and Subcontracting Fair Practices Act. Subletting or subcontracting of any portion of the work in excess of one-half of one percent of the prime contractor's total bid as to which no subcontractor was designated in the original bid shall only be permitted in cases of public emergency or necessity, and then only after a finding reduced to writing as a public record of the authority awarding this contract setting forth the facts constituting the emergency or necessity.

In addition to providing the information required by this form prior to the bid opening, bidder shall be required to submit the addresses, telephone numbers, and license numbers of all listed subcontractors within one business day of the bid opening. Failure to provide the foregoing information within the time limit specified may result in the rejection of the bid as nonresponsive.

Subcontractor Name	Portion of Work	Location and Place of Business
Proper Name of Bidder		
By		




SECTION 00431

CERTIFICATION OF CONTRACTOR AND SUBCONTRACTOR DIVISION OF INDUSTRIAL RELATIONS REGISTRATION (DIR)

I	(Name)	, (Title)	certify that
	(Name)	(Title)	•
	(Contractor Name)	is currently registered as a contractor with the De	epartment of Industrial
Polation	ns (DIR):		
Kelatioi	15 (DIK).		
	Contractor's DIR Registration Nu	umber	
	Expiration date June 30, 20		
Contrac	et further acknowledges:		
1. 2. 3. 4. 5.	Contractor shall note in its invital subcontractors. Contractor shall ensure that all status for the duration of the proj Contractor is to furnish DIR Reg bid opening. Contractor shall substitute any unable to perform the work.	subcontractor with a DIR registered contractor if li	bcontractors and their nd maintain registered within 24 hours of the
Failure	to comply with any of the above m	nay result in a determination of non-responsiveness.	
I declar	e under penalty of perjury under C	California law that the foregoing is true and correct.	
Signatu	re		

Date

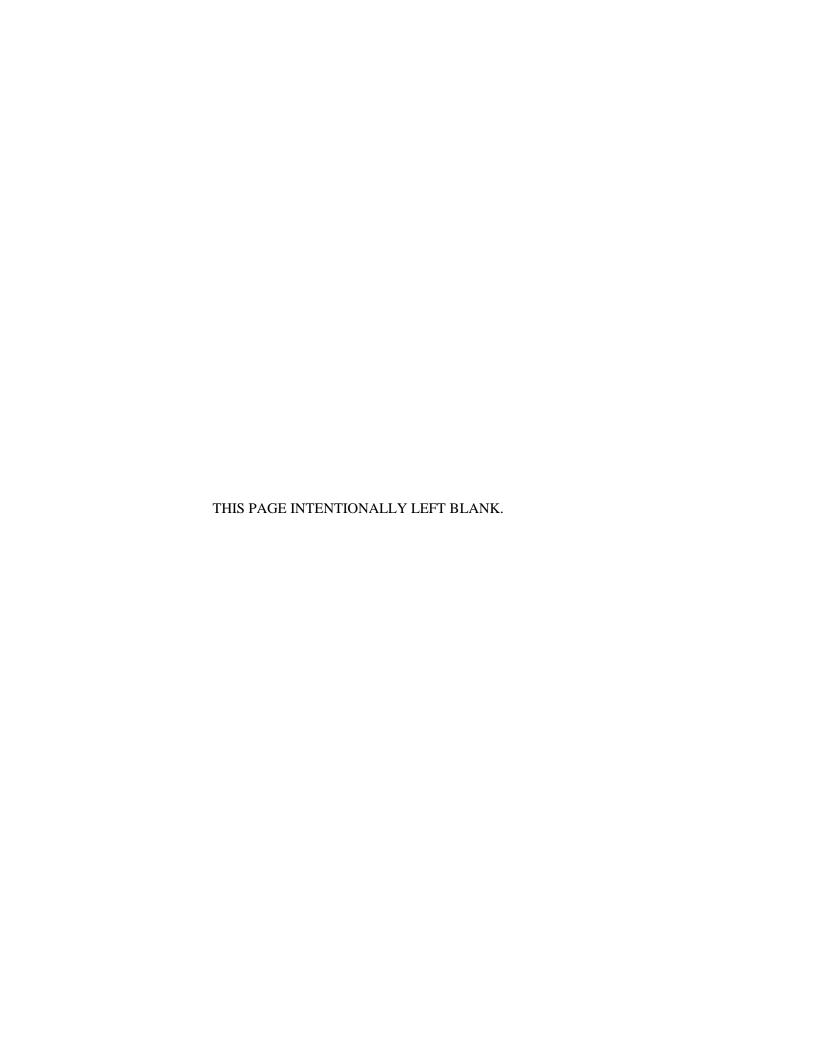

DOCUMENT 00480 NONCOLLUSION AFFIDAVIT

(To be executed by Bidder and submitted with bid)

State of California)			
County of)			
	(Name), being fi	rst duly swor	n, deposes and s	says that he is
the		_ (Title) of the	e	(Name)
party making the attache undisclosed person, part bid is genuine and not co	nership, company, as	ssociation, or	ganization, or co	rporation; that the
solicited any other bidde			-	•
colluded, conspired, con	nived, or agreed with	any bidder o	or anyone else to	put in a sham bid, or
that anyone shall refrain	•		•	•
indirectly, sought by agre			-	•
of the bidder or any othe		•		•
or of that of any other bid	lder, or to secure any	advantage a	against the public	body awarding the
contract of anyone intere	sted in the proposed	contract; tha	t all statements o	contained in the bid
are true; and, further, that	t the bidder has not, o	directly or ind	directly, submitted	d his or her bid price
or any breakdown thereo	f, or the contents the	reof, or divul	ged information c	or data relative
thereto, or paid, and will organization, bid deposit sham bid.		•	• • • • • • • • • • • • • • • • • • • •	
I certify (or declare) und foregoing is true and corr		under the la	aws of the State	of California that the
Executed this day California.	of	, 20	_ at	,
Date:	Signature of Bio	lder		

NONCOLLUSION AFFIDAVIT



PREVAILING WAGE CERTIFICATION

I hereby certify that I will conform to the State of California Public Works Contract requirements regarding prevailing wages, benefits, on-site audits with 48-hours notice, payroll records, and apprentice and trainee employment requirements, for all Work on the above Project, including, without limitation, the State labor compliance monitoring and enforcement by the Compliance Monitoring Unit of the Department of Industrial Relations.

Date:	
Name of Contractor:	
Signature:	
Print Name:	
Title:	



WORKERS' COMPENSATION CERTIFICATION

Labor Code section 3700 in relevant part provides:

Every employer except the State shall secure the payment of compensation in one or more of the following ways:

- a. By being insured against liability to pay compensation by one or more insurers duly authorized to write compensation insurance in this state.
- b. By securing from the Director of Industrial Relations a certificate of consent to self-insure, which may be given upon furnishing proof satisfactory to the Director of Industrial Relations of ability to self-insure and to pay any compensation that may become due to his employees.

I am aware of the provisions of section 3700 of the Labor Code which require every employer to be insured against liability for workers' compensation or to undertake selfinsurance in accordance with the provisions of that code, and I will comply with such provisions before commencing the performance of the Work of this Contract.

Date:	
Name of Contractor:	
Signature:	
Print Name:	
Title:	

(In accordance with Article 5 - commencing at section 1860, chapter 1, part 7, division 2 of the Labor Code, the above certificate must be signed and filed with the awarding body prior to performing any Work under this Contract.)



CRIMINAL BACKGROUND INVESTIGATION CERTIFICATION

The undersigned does hereby certify to the governing board of the District as follows:

- That I am a representative of the Contractor under contract with the District;
- That I am familiar with the facts herein certified; and
- That I am authorized and qualified to execute this certificate on behalf of Contractor.

Contractor certifies that it has taken at least one of the following actions with respect to the construction Project that is the subject of the Contract (check all that applies):

The Contractor has complied with the fingerprinting requirements of Education Code section 45125.1 with respect to all Contractor's employees and all of its Subcontractors' employees who may have contact with District pupils in the course of providing services pursuant to the Contract, and the California Department of Justice has determined that none of those employees has been convicted of a felony, as that term is defined in Education Code section 45122.1. A complete and accurate list of Contractor's employees and of all of its subcontractors' employees who may come in contact with District pupils during the course and scope of the Contract is attached hereto; and/or

Pursuant to Education Code section 45125.2, Contractor has installed or will install, prior to commencement of Work, a physical barrier at the Work Site, that will limit contact between Contractor's employees and District pupils at all times; and/or

Pursuant to Education Code section 45125.2, Contractor certifies that all employees will be under the continual supervision of, and monitored by, an employee of the Contractor who the California Department of Justice has ascertained has not been convicted of a violent or serious felony. The name and title of the employee who will be supervising Contractor's employees and its subcontractors' employees is

Name	:		
Title:			

The Work on the Contract is at an unoccupied school site and no employee and/or subcontractor or supplier of any tier of Contract shall come in contact with the District pupils.

Contractor's responsibility for background clearance extends to all of its employees, Subcontractors, and employees of Subcontractors coming into contact with District pupils regardless of whether they are designated as employees or acting as independent contractors of the Contractor.

Date:	 	
Name of Contractor:	 	
Signature:		
Print Name:		
Title:		



DOCUMENT 00845

CONTRACTOR'S CERTIFICATE REGARDING DRUG-FREE WORKPLACE

This Drug-Free Workplace Certification form is required from all successful bidders pursuant to the requirements mandated by Government Code sections 8350 et seq., the Drug-Free Workplace Act of 1990. The Drug-Free Workplace Act of 1990 requires that every person or organization awarded a contract or grant for the procurement of any property or service from any State agency must certify that it will provide a drug-free workplace by doing certain specified acts. In addition, the Act provides that each contract or grant awarded by a State agency may be subject to suspension of payment or termination of the contract or grant, and the Contractor or grantee may be subject to debarment from future contracting, if the contracting agency determines that specified acts have occurred.

Pursuant to Government Code section 8355, every person or organization awarded a contract or grant from a State agency shall certify that it will provide a drug-free workplace by doing all of the following:

- a) Publishing a statement notifying employees that the unlawful manufacture, distribution, dispensation, possession or use of a controlled substance is prohibited in the person's or organization's workplace and specifying actions which will be taken against employees for violations of the prohibition;
- b) Establishing a drug-free awareness program to inform employees about all of the following:
 - 1) The dangers of drug abuse in the workplace.
 - 2) The person's or organization's policy of maintaining a drug-free workplace.
 - 3) The availability of drug counseling, rehabilitation and employee-assistance programs.
 - 4) The penalties that may be imposed upon employees for drug abuse violations.
- c) Requiring that each employee engaged in the performance of the contract or grant be given a copy of the statement required by subdivision (a) and that, as a condition of employment on the contract or grant, the employee agrees to abide by the terms of the statement.

I, the undersigned, agree to fulfill the terms and requirements of Government Code section 8355 listed above and will publish a statement notifying employees concerning (a) the prohibition of controlled substance at the workplace, (b) establishing a drug-free awareness program, and (c) requiring that each employee engaged in the performance of the contract be given a copy of the statement required by section 8355(a) and requiring that the employee agrees to abide by the terms of that statement.

I also understand that if the District determines that I have either (a) made a false certification herein; or (b) violated this certification by failing to carry out the requirements of section 8355, that the contract awarded herein is subject to termination, suspension of payments, or both. I further understand that, should I violate the terms of the Drug-Free Workplace Act of 1990, I may be subject to debarment in accordance with the requirements of sections 8350 et seq.

I acknowledge that I am aware of the provisions of Government Code sections 8350 et seq. and hereby certify that I will adhere to the requirements of the Drug-Free Workplace Act of 1990.

Date:		
	Contractor	
	Signature	



CONTRACTOR'S CERTIFICATE REGARDING ALCOHOLIC BEVERAGE AND TOBACCO-FREE CAMPUS POLICY

Project Name

The CONTRACTOR agrees that it will abide by and implement the DISTRICT's Alcoholic Beverage and Tobacco-Free Campus Policy, which prohibits the use of alcoholic beverages and tobacco products, at any time, on DISTRICT-owned or leased buildings, on DISTRICT property and in DISTRICT vehicles. The CONTRACTOR shall procure signs stating "ALCOHOLIC BEVERAGE AND TOBACCO USE IS PROHIBITED" and shall ensure that these signs are prominently displayed in all entrances to school property at all times.

DATE:		
	CONTRACTOR	
		•
	By:	
•	Signature	



ASBESTOS-FREE MATERIALS CERTIFICATION

The undersigned declares (Hereinafter referred to as DISTRICT (hereinafter refethe "Contractor").					
To the best of my kn the Project, no material furn composed of, any materials a hazardous material.	ished, installe	ed or incorpora	ted into the F	Project will conta	in, or in itself be
I declare under pensis true and correct.	alty of perjury	under the laws	of the State	of California the	at the foregoing
Executed on this		day of			
20 at					,
			·		
	Name of C	Contractor (Prin	nt or Type)		
		701111111111111111111111111111111111111			
	Ву:				
	Sig	gnature			
mak dinik 4 kada				Print Name	
JURAT					
	Tit	le	•		
State of California					
County of	,				
Subscribed and sworn to by	(or affirmed)	before me or	this	day of	, 20,
byperson(s) who appeared b	efore me.	a to me on the	Dasis Oi Sai	isiaciory evider	ice to be the
Notary Public in and for the State of California				Seal	
	•	, v	• •		
My Commission Expires: _					

AGREEMENT CERTIFICATION: ASB. - 4



DOCUMENT 00600

PERFORMANCE BOND

KNOW ALL MEN BY THESE PRESENTS:	That
WHEREAS, the	School District (hereinafter designated as "Public Entity"), by action , 20, has awarded to, hereinafter the work described as follows (check those that apply):
□Campus Wide Painting F □PROJECT NO. 2021-1600	Project @ Matilija Middle School
(the "Project"); and	
WHEREAS, said Principal is required unde said contract,	r the terms of said contract to furnish a bond for the faithful performance of
the Public Entity in the penal sum of money of the United States of America, for	as (surety name) Surety, are held and firmly bound unto Dollars (\$) lawful r the payment of which sum well and truly to be made, we bind ourselves, asors and assigns, jointly and severally, firmly by these presents.

THE CONDITION OF THIS OBLIGATION IS SUCH that if the above bounded Principal, his or its heirs, executors, administrators, successors or assigns, shall in all things stand to and abide by and well and truly keep and perform, the covenants, conditions, and agreements in the said contract and any alteration thereof made as therein provided, on his or their part, to be kept and performed at the time and in the manner therein specified, and in all respects according to their true intent and meaning, and shall indemnify and save harmless the Public Entity, its officers and agents, as therein stipulated, then this obligation shall become null and void, otherwise, it shall be and remain in full force and virtue.

And the said Surety, for value received, hereby stipulates and agrees that no change, extension of time, alteration or addition to the terms of the contract or to the work to be performed thereunder, or the specifications accompanying the same, shall in anywise affect its obligation on this bond, and does hereby waive notice of any such change, extension of time, alteration, or addition to the terms of the contract, or to the work, or to the specifications.

In the event suit is brought upon this bond by the District and judgment is recovered, the Surety shall pay all litigation expenses incurred by the District in such suit, including attorneys' fees, court costs, expert witness fees and investigation expenses.

IN WITNESS WHEREOF, this instrument haday of, 20	is been duly executed by the Principal and Surety above named, on the
PRINCIPAL	_
By:	_
SURETY	[Attach required acknowledgments
By:Attorney-in-Fact	-



DOCUMENT 00610 PAYMENT BOND

KNOW ALL MEN BY THESE PRESENTS: That

WHEREAS, the	School District (hereinafter de	esignated as "Public Entity"), by action
WHEREAS, the taken or a resolution passed designated as the "Principal," a contract	, 20, has awarded to	, hereinafter
designated as the "Principal," a contract	for the work described as follows (chec	k those that apply):
Compus Wide Baintine	a Project @ Matilija Middle Se	haal
□ PROJECT NO. 2021-16	g Project @ Matilija Middle Sc	11001
□PROJECT NO. 2021-16	300	
(d. 11 - 1 11)		
(the "Project"); and		
WHEREAS, said Principal is required by	v Chapter 5 (commencing at Section :	3225) and Chapter 7 (commencing at
Section 3247), Title 15, Part 4, Division		
contract;		
NOW THEREFORE we the Principal or	nd.	as Surety, are hold and
NOW THEREFORE, we, the Principal ar firmly bound unto the Public Entity in the	penal sum of	, as Surety, are field and Dollars (\$
lawful money of the United States of Amo	erica, for the payment of which sum we	Il and truly to be made, we bind
ourselves, our heirs, executors, administ		
presents.		
THE CONDITION OF THIS OBLIGATION	N IS SUCH that if said Principal his o	or its subcontractors, heirs, executors

THE CONDITION OF THIS OBLIGATION IS SUCH that if said Principal, his or its subcontractors, heirs, executors, administrators, successors or assigns, shall fail to pay (1) any of the persons named in Section 3181 of the California Civil Code, (2) amounts due under the Unemployment Insurance Code with respect to work or labor performed under the contract, or (3) for any amounts required to be deducted, withheld, and paid over to the Employment Development Department from the wages of employees of the contractor and his subcontractors pursuant to Section 13020 of the Unemployment Insurance Code, with respect to such work and labor the surety or sureties will pay for the same, in an amount not exceeding the sum hereinabove specified, and also, in case suit is brought upon this bond, all litigation expenses incurred by the Public Entity in such suit, including reasonable attorneys' fees, court costs, expert witness fees and investigation expenses.

This bond shall inure to the benefit of any of the persons named in Section 3181 of the California Civil Code so as to give a right of action to such persons or their assigns in any suit brought upon this bond.

Payment Bond p. 1 of 2

It is further stipulated and agreed that the Surety on this bond shall not be exonerated or released from the obligation of this bond by any change, extension of time for performance, addition, alteration or modification in, to, or of any contract, plans, specifications, or agreement pertaining or relating to any scheme or work of improvement hereinabove described, nor by any fraud practiced by any person other than the claimant seeking to recover on the bond and that this bond be construed most strongly against the Surety and in favor of all persons for whose benefit such bond is given, and under no circumstances shall Surety be released from liability to those for whose benefit such bond has been given, by reason of any breach of contract between the owner or Public Entity and original contractor or on the part of any obligee named in such bond, but the sole conditions of recovery shall be that claimant is a person described in Section 3110 or 3112 of the California Civil Code, and has not been paid the full amount of his claim and that Surety does hereby waive notice of any such change, extension of time, addition, alteration or modification herein mentioned.


IN WITNESS WHEREOF, this instrument has beday of, 20	een duly executed by the Principal and Surety above named, on the
Principal	
By Surety	[Attach required acknowledgments]
By Attorney-in- Fact	



Scope of Work:

Matilija Middle School (PROJ#-1600) 703 El Paseo Rd., Ojai, CA 93023

1. CAMPUS-WIDE PAINTING OF EXISTING BUILDINGS AND SITE STRUCTURES AT A MIDDLE SCHOOL AND ASSOCIATED MINOR CARPENTRY AND PLASTER REPAIR. PROVIDE AND INSTALL NEW EXTERIOR RESTROOM DOOR SIGNAGE.

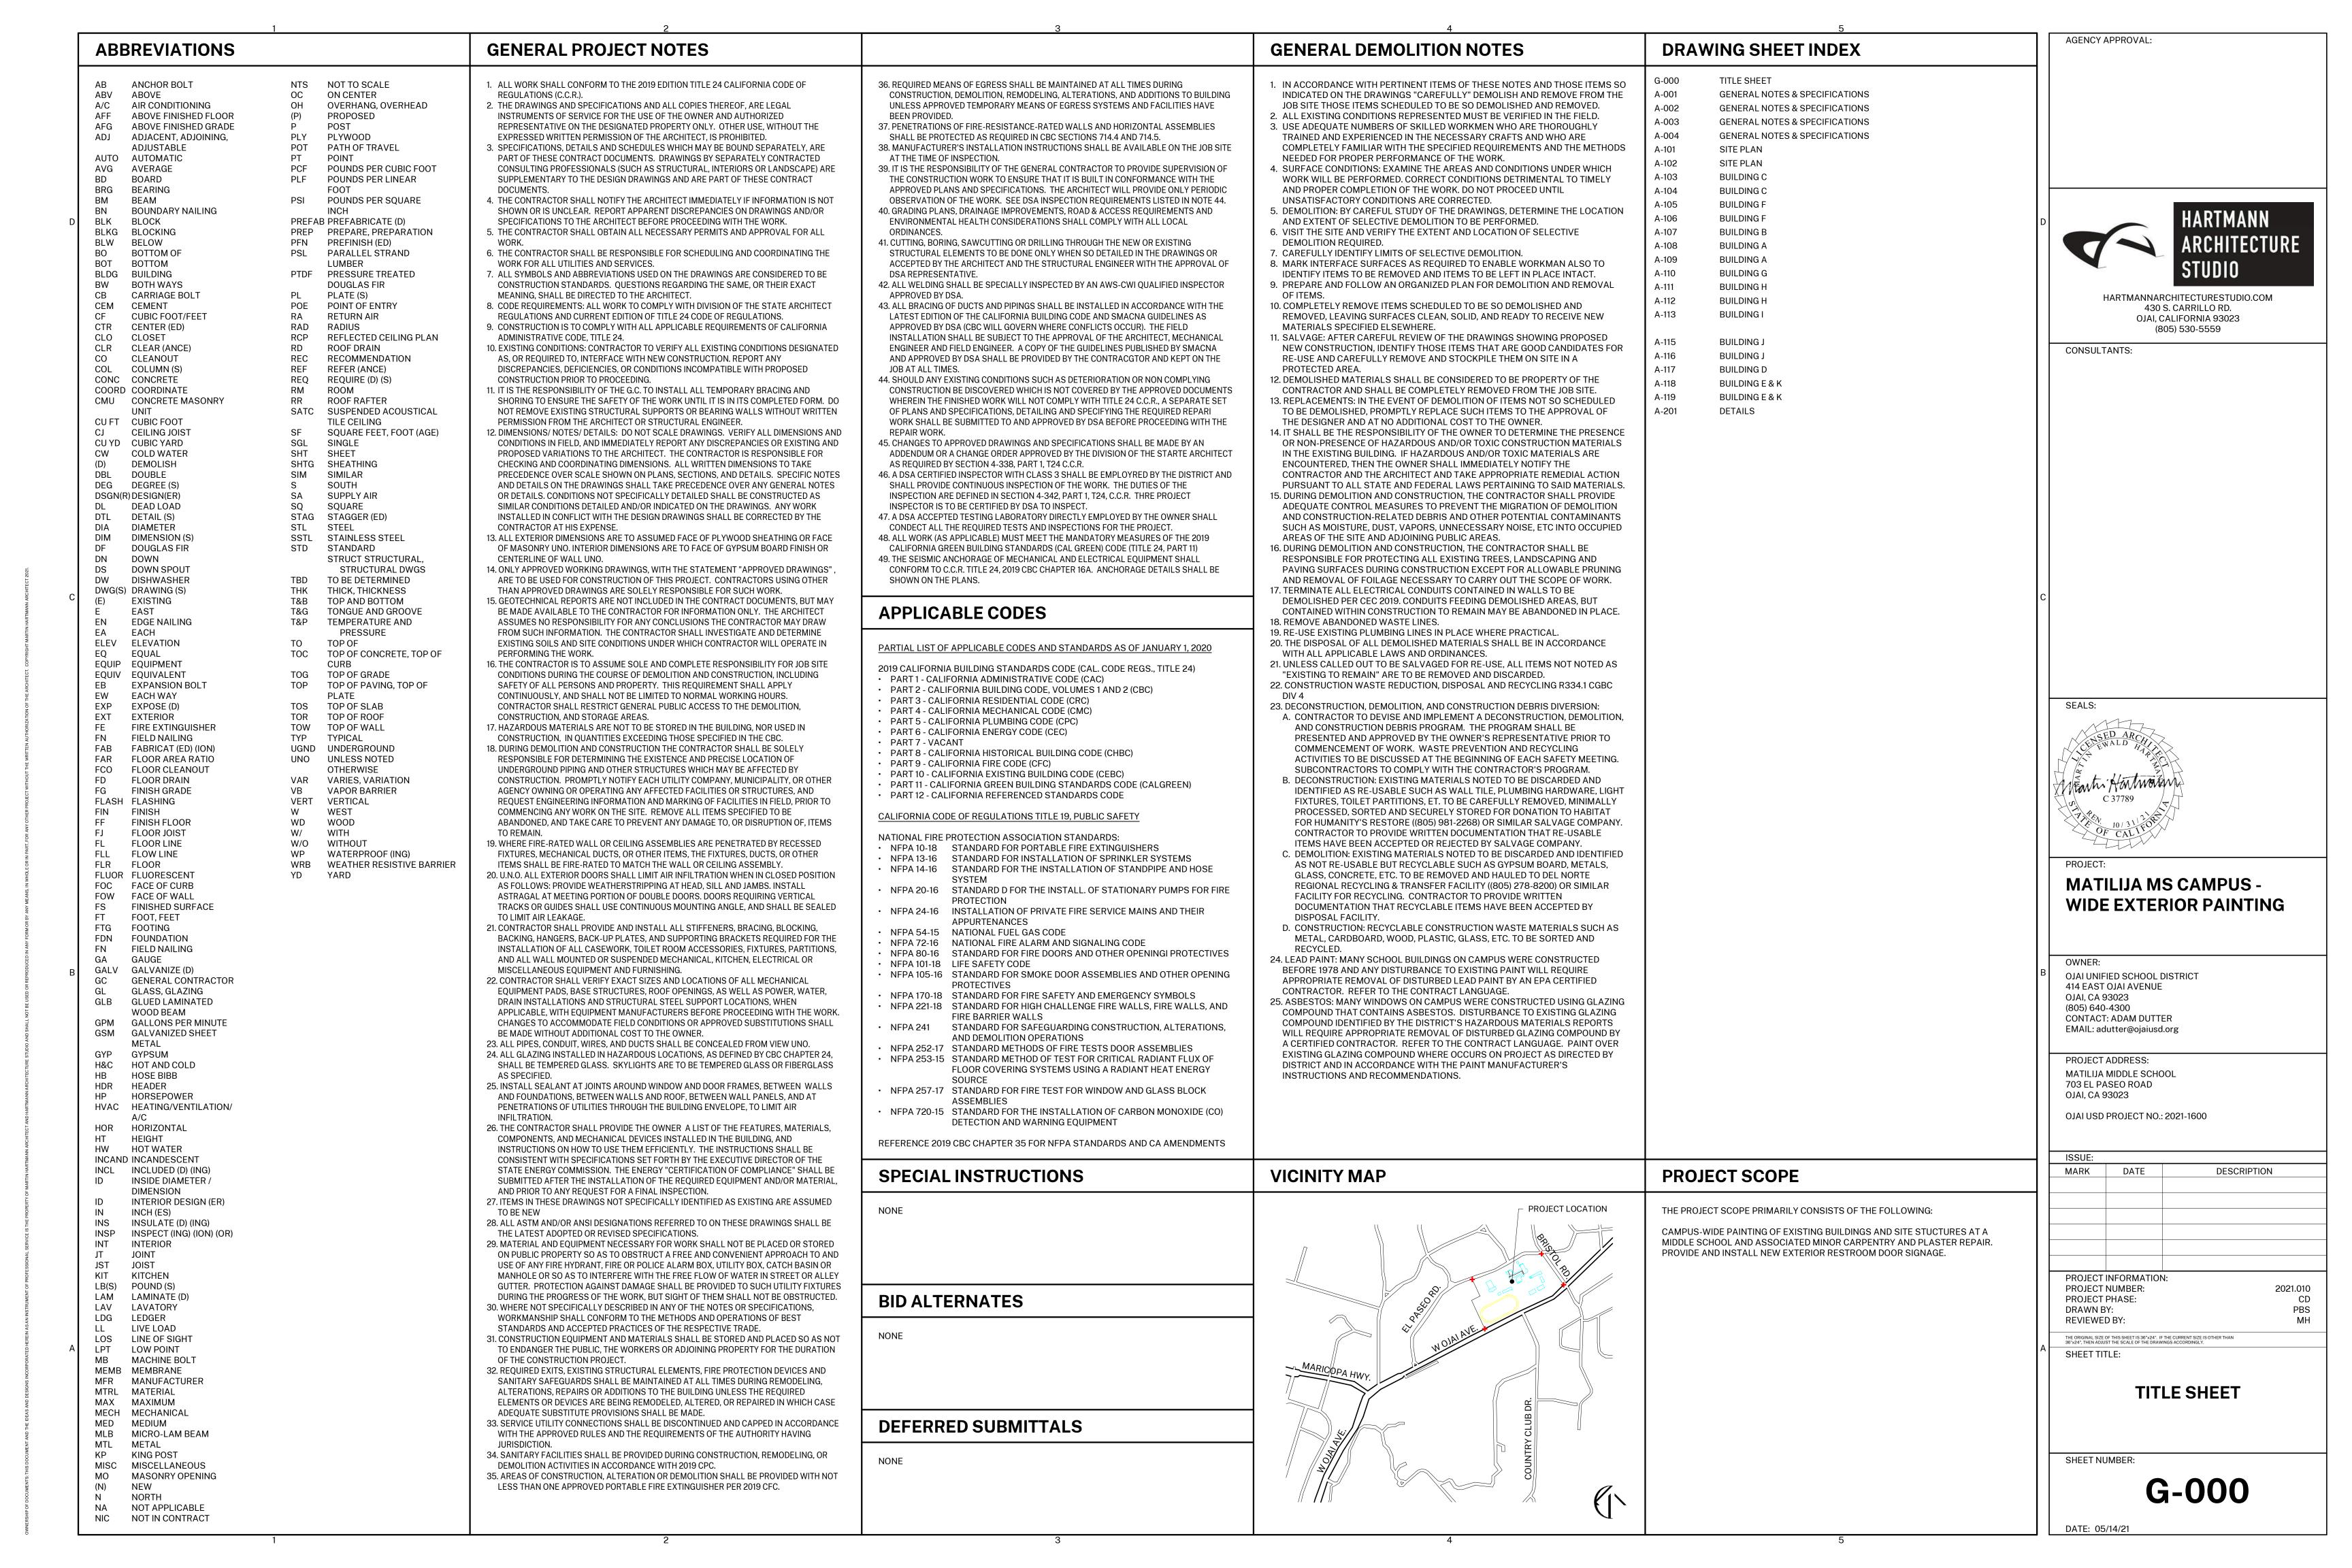

B. Contract Documents, were prepared by: HARTMANN ARCHITECTURE STUDIO 430 S. CARRILLO RD OJAI, CA 93023

C. Summary of Work: 1. Matilija Middle School (OJAI USD PROJ# 2021-1600) 730 El Paseo Rd., Ojai, CA

a. Repaint: (1) Building A (2) Building B (3) Building C (4) Building D (5) Building E (6) Building F (7) Building G (8) Building H (9) Building I (10) Building J

(11) Building K (12) Accessory Structures as Indicated D. Bid Documents are available online at the Ojai Unified School District's

Website (https://www.ojaiusd.org/page/construction-projects) 1.1 OCCUPATIONAL SAFETY AND HEALTH ACT REQUIREMENTS: A. During the entire construction period, it shall be the responsibility of the Contractor to maintain conditions at the Project site so as to meet in all respects

the requirements of the Federal Occupational Safety and Health Administration (OSHA) and the California Occupational Safety and Health Administration (CAL-OSHA). These provisions shall cover the Contractor's employees and all other persons working upon or visiting the site. To this end, the Contractor shall inform himself and his representatives of Federal OSHA and California OSHA standards.

1.2 COORDINATION REQUIREMENTS:

A. It is the Contractor's responsibility to coordinate the Work so as to minimize conflicts and optimize efficiency.

B. Coordinate scheduling, submittals, and Work of the various Sections of Specifications to assure efficient and orderly sequence of installation of interdependent construction elements, with provisions for accommodating items installed later.

1.3 BUILDING SYSTEM COORDINATION:

A. Notify Architect if conditions are uncovered which would prevent the completed project from conforming to the requirements of the Work. B. Materials/Systems: As specified. Verify compatibility with District-wide standard systems

C. "NIC" construction is indicated and specified herein as an aid to the Contractor in scheduling the amount of time and materials necessary for the completion of the Contract.

1.4 DISTRICT OCCUPANCY:

A. The District will occupy the campus during the entire period of construction. Cooperate with the District in all construction operations including the following to minimize conflict and to facilitate District usage.

B. If and when it should be necessary for the Contractor to impact the day-to-day operations of District's functions in order to pursue the Work, the Contractor shall furnish at least 14 days notice to the District and coordinate the means and timing to avoid, minimize, or circumvent such impacts. The District reserves the right to assess and anticipate such impacts and the

right to stop or postpone the Work until a mutually satisfactory time and means can be agreed upon. The Contractor shall include costs for delays caused by normal school operations and scheduled special events.

1.5 CONTRACTOR'S USE OF THE PREMISES:

A. The Contractor shall limit his use of the premises for construction activities and for storage, to allow for District occupancy. B. The Contractor shall be responsible for the following:

1. Coordinate the use of the premises under the direction of the District.

2. Assume full responsibility for the protection and safekeeping of products under this Contract which are stored at the site. 3. Move stored products that are under the Contractor's control, which

interfere with operations of the District. 4. Obtain and pay for the use of additional storage or construction areas needed for operations.

1.6 COORDINATION OTHER DISTRICT CONTRACTORS:

A. The District may have separate contractors or vendors working on the site at the time of this project. The Contractor shall coordinate work activities to not interfere with other District work.

PART 2 - PRODUCTS (Not Applicable)

PART 3 - EXECUTION (Not Applicable)

SECTION 01 21 00 - ALLOWANCES

PART 1 - GENERAL

1.1 SUMMARY A. Section Includes: Allowances which the Contractor shall provide for designated construction activities in the Work and in his/her bid. B. Related Documents

1. Section 01 26 00: Modification procedures

1.2 DESCRIPTION OF REQUIREMENTS

A. Definitions and Explanations: Certain requirements of the construction related to each allowance are indicated and specified. The allowance has been established instead of additional requirements for that construction, and further requirements thereof will be issued by Change Order.

B. Contingency Allowance: Contingency allowance shall be used only as directed for District's purposes, and only by change orders which designate amounts to be charged to contingency allowance. Contractor's related costs are not included in the Contract sum (other than allowance itself) for construction so ordered to be charged to contingency allowance. The

change orders will include costs and reasonable overhead/profit margins. At time of project closeout, unused amounts remaining in contingency allowance shall be credited to the District by change order.

A PART 2 - PRODUCTS (Not Applicable)

PART 3 - EXECUTION

3.1 SCHEDULE OF ALLOWANCES A. Allowance No. 1: The Contractor shall include in the bid an allowance of \$15,000 for repair of miscellaneous existing conditions, including, but not limited to the replacement of existing stucco, plywood paneling, unsatisfactory dimensional lumber not otherwise identified in the drawings.

SECTION 01 26 00 - MODIFICATION PROCEDURES

PART 1 - GENERAL

1.1 SUMMARY:

A. Section Includes: Procedures for processing Change Orders.

1.2 CHANGE INITIATION PROCEDURES:

A. The Contractor may initiate a change by submittal of a request to the Architect describing the proposed change with a statement of the reasons or the change and the effect on the Contract Sum and the Contract Time with full documentation. B. The Architect may issue a Price Modification Request (PMR), signed by the District, instructing the Contractor to proceed with a change in the Work, for

subsequent inclusion in a Change Order. The directive will describe changes in the Work, and will designate method of determining changes in Contract Sum and/or Contract Time. C. The Architect may issue Supplemental Instructions for minor changes that will not affect Contract Sum or Contract Time. The Contractor shall sign and return the

original copy of the form to the Architect 1.3 CONTRACTOR'S PROPOSALS AND DOCUMENTATION: A. In response to each PMR issued by the Architect, submit an itemized quotation detailing all changes in Contract Sum and Contract Time. Upon request, the Contractor shall provide additional data, including the following, to support the

1. Quantities of products, labor, and equipment.

2. Taxes, insurance, and bonds. 3. Overhead and profit.

4. Justification for change in Contract Time.

5. Credit for deletions from the Contract, similarly documented. 6. Quotation shall include all components necessary, whether or not

specifically described, to complete the work, such as, but is not cutting, patching and painting, additional power supply required for equipment, etc. By failing to provide quotation for component(s) of the work without prior notification to the District that additional quotation(s) to be furnished at a later Contractor waives all claims for extra costs for such component(s)

required to complete the work. B. If additional costs necessitated by a Construction Change Directive are indicated to be paid on a time and materials basis, provide additional data,

including the following, after completing the Change. 1. Date and number of Change Authorization. 2. Dates and times work was performed and by whom.

3. Time records and wage rates paid. 4. Invoices and receipts for products, equipment, and subcontracts. 1.4 EXECUTION OF CHANGE ORDERS:

A. The Architect will issue Change Orders on AIA Form G701 for signatures of parties as provided in the Conditions of the Contract.

B. On fixed price Change Orders, changes in Contract Sum and Contract Time will be based on the PMR and the Contractor's quotation as accepted by the District. C. On time and material Change Orders, changes in Contract Sum and Contract Time will be determined by the District and Architect from the Contractor's data. 1.5 CORRELATION OF CONTRACTOR SUBMITTALS:

A. Promptly revise the Schedule of Values, and Application for Payment forms to record each authorized Change Order as a separate line item and adjust the Contract Sum as shown on the Change Order.

B. Promptly revise Progress Schedules to reflect changes in Contract Time, revise subschedules to adjust times for other items of Work affected by the change and resubmit. C. Promptly enter changes on the Project Record Documents.

PART 2 - PRODUCTS (Not Applicable)

PART 3 - EXECUTION (Not Applicable)

SECTION 09 01 90.52 - MAINTENANCE REPAINTING

PART 1 - GENERAL

A. Section includes maintenance repainting as follows:

1. Patching substrates. 2. Repainting.

a. Concrete b. Metal, galvanized and ungalvanized

c. Wood, dimensional and panel d. Portland cement plaster (stucco) – existing

A. Work of this Section contributes to the amount specified in Section 012100

1.3 DEFINITIONS

"Allowances."

A. Gloss Level 1: Not more than 5 units at 60 degrees and 10 units at 85 degrees, according to ASTM D523.

B. Gloss Level 2: Not more than 10 units at 60 degrees and 10 to 35 units at 85 degrees, according to ASTM D523.

C. Gloss Level 3: 10 to 25 units at 60 degrees and 10 to 35 units at 85 degrees, according to ASTM D523. D. Gloss Level 4: 20 to 35 units at 60 degrees and not less than 35 units at 85

degrees, according to ASTM D523. E. Gloss Level 5: 35 to 70 units at 60 degrees, according to ASTM D523. F. Gloss Level 6: 70 to 85 units at 60 degrees, according to ASTM D523.

G. Gloss Level 7: More than 85 units at 60 degrees, according to ASTM D523. 1.4 PREINSTALLATION MEETINGS A. Preinstallation Conference: Conduct conference at Project site.

1.5 ACTION SUBMITTALS

A. Product Data: For each type of product. B. Samples: For each type of paint system and each pattern, color, and gloss. 1. Label each Sample for location and application.

C. Product List: Printout of current "MPI Approved Products List" for each MPIproduct category specified in paint systems, with the proposed product highlighted.

1.6 INFORMATIONAL SUBMITTALS A. Color Matching Certificate: For computer-matched colors.

PART 2 - PRODUCTS

2.1 PREPARATORY CLEANING MATERIALS A. Water: Potable.

B. Hot Water: Water heated to a temperature of 140 to 160 deg F (60 to 71 deg C). C. Detergent Solution: Solution prepared by mixing 2 cups (0.5 L) of tetrasodium pyrophosphate (TSPP), 1/2 cup (125 mL) of laundry detergent that contains no ammonia, 5 quarts (5 L) of 5 percent sodium hypochlorite bleach, and 15 quarts (15 L) of warm water for every 5 gal. (20 L) of solution required. Or, apply Jasco TSP No-Rinse Substitute. Follow manufacturer's instructions for mixing and application.

D. Mildewcide: Commercial proprietary mildewcide or a job-mixed solution prepared by mixing 1/3 cup (80 mL) of household detergent that contains no ammonia, 1 quart (1 L) of 5 percent sodium hypochlorite bleach, and 3 quarts (3

L) of warm water. E. Abrasives for Ferrous Metal Cleaning: Aluminum oxide paper, emery paper, fine steel wool, steel scrapers, and steel-wire brushes of various sizes. F. Rust Remover: Manufacturer's standard phosphoric acid-based gel

formulation, also called "naval jelly," for removing corrosion from iron and steel.

A. Low-Odor, water based paste paint remover: Manufacturer's standard low odor, water-rinsable, water based paste, gel, or foamed emulsion formulation for removing paint from masonry, stone, wood, plaster, or metal as required to suit Project; and containing no methanol or methylene chloride.

2.3 PAINT, GENERAL A. Material Compatibility:

1. Provide materials for use within each paint system that are conditions compatible with one another and substrates indicated, under of service and application as demonstrated by manufacturer, based on testing and field experience. 2. For each coat in a paint system, provide products recommended in

indicated. B. Colors: Match District-standard paint manufacturer and Campus-standard colors as indicated in drawings:

writing by manufacturers of topcoat for use in paint system and on substrate

COLOR 1 - "WHITE" - DEW341 - Swiss Coffee COLOR 2 - "GRAY" - Match existing door and trim color

COLOR 3 - "RED" - SW7583 Wild Currant COLOR 4 - "TERRA COTTA" - Match existing clay roof tiles

2.4 PAINT MATERIALS, GENERAL A. MPI Standards: Provide products that comply with MPI standards indicated and that are listed in its "MPI Approved Products List." B. Transition Coat: Paint manufacturer's recommended coating for use where a

residual existing coating is incompatible with the paint system. 2.5 PAINT MATERIALS

A. Primers and Sealers: 1. Primer Sealer, Latex, Alkali Resistant, Exterior: MPI #3.

B. Metal Primers: 1. Primer, Rust-Inhibitive, Water Based: MPI #107. 2. Primer, Galvanized, Water Based: MPI #134.

C. Wood Primers: 1. Primer, Latex for Exterior Wood: MPI #6. D. Water-Based Paints:

1. Latex, Exterior Low Sheen (Gloss Levels 3-4): MPI #15. E. Floor Coatings: 1. Floor Paint, Latex, Low Gloss (Maximum Gloss Level 3): MPI #60.

2.6 PATCHING MATERIALS

A. Wood-Patching Compound: Two-part, epoxy-resin, wood-patching compound; knife-grade formulation as recommended in writing by manufacturer for type of wood repair indicated, tooling time required for the detail of work, and site conditions. Compound shall be designed for filling voids in damaged wood materials that have deteriorated from weathering and decay. Compound shall be capable of filling deep holes and spreading to feather edge.

B. Metal-Patching Compound: Two-part, polyester-resin, metal-patching compound; knife-grade formulation as recommended in writing by manufacturer for type of metal repair indicated, tooling time required for the detail of work, and site conditions. Compound shall be produced for filling metal that has deteriorated from corrosion. Filler shall be capable of filling deep holes and

spreading to feather edge. C. Cementitious Patching Compounds: Cementitious patching compounds and repair materials specifically manufactured for filling cementitious substrates and for sanding or tooling prior to repainting; formulation as recommended in writing by manufacturer for type of cementitious substrate indicated, exposure to weather and traffic, the detail of work, and site conditions.

PART 3 - EXECUTION

3.1 MAINTENANCE REPAINTING, GENERAL A. Execution of the Work: In repainting surfaces, disturb them as minimally as

possible and as follows: 1. Remove failed coatings and corrosion and repaint. a. Lead Paint: Many school buildings on campus were constructed before 1978 and any disturbance to existing paint will require appropriate

testing for existing lead paint and appropriate removal of disturbed lead paint by an EPA certified contractor. Refer to the contract language. 2. Verify that substrate surface conditions are suitable for 3. Allow other trades to repair items in place before repainting. B. Mechanical Abrasion: Where mechanical abrasion is needed for the work, use

gentle methods, such as scraping and lightly hand sanding, that will not abrade softer substrates, reducing clarity of detail. C. Heat Processes: Do not use torches, heat guns, or heat plates.

3.2 EXAMINATION A. Examine substrates and conditions, with Installer present, for compliance with requirements for maximum moisture content and other conditions affecting performance of painting work. Comply with paint manufacturer's written instructions for inspection.

B. Maximum Moisture Content of Substrates: Do not begin application of coatings unless moisture content of exposed surface is below the maximum value recommended in writing by paint manufacturer and not greater than the following maximum values when measured with an electronic moisture meter

appropriate to the substrate material: 1. Concrete or Fiber Cement: 12 percent. 2. Masonry (Clay and CMU): 12 percent.

3. Portland Cement Plaster: 12 percent. 4. Wood: 15 percent. C. Alkalinity: Do not begin application of coatings unless surface alkalinity is within range recommended in writing by paint manufacturer. Conduct alkali testing with litmus paper on exposed plaster, cementitious, and masonry

surfaces.

3.3 PREPARATORY CLEANING A. General: Use the gentlest, appropriate method necessary to clean surfaces in preparation for painting. Clean all surfaces, corners, contours, and interstices. B. Detergent Cleaning: Wash surfaces by hand using clean rags, sponges, and bristle brushes. Scrub surface with detergent solution and bristle brush until soil is thoroughly dislodged and can be removed by rinsing. Use small brushes to remove soil from joints and crevices. Dip brush in solution often to ensure that adequate fresh detergent is used and that surface remains wet. Rinse with water applied by

clean rags or sponges. C. Solvent Cleaning: Use solvent cleaning to remove oil, grease, smoke, tar, and asphalt from painted or unpainted surfaces before other preparation work. Wipe surfaces with solvent using clean rags and sponges. If necessary, spot-solvent cleaning may be employed just prior to commencement of paint application, provided enough time is allowed for complete evaporation. Use clean solvent and clean rags for the final wash to ensure that all foreign materials have been removed. Do not use solvents, including primer thinner and turpentine, that leave

residue. D. Mildew: Clean off existing mildew, algae, moss, plant material, loose paint, grease, dirt, and other debris by scrubbing with bristle brush or sponge and detergent solution. Scrub mildewed areas with mildewcide. Rinse with water applied by clean rags or sponges.

E. Chemical Rust Removal: 1. Remove loose rust scale with specified abrasives for ferrous-metal

cleaning. 2. Apply rust remover with brushes or as recommended in writing by manufacturer. 3. Allow rust remover to remain on surface for period recommended writing by manufacturer or as determined by preconstruction testing. Do not

allow extended dwell time. 4. Wipe off residue with mineral spirits and either steel wool or soft rags, or clean with method recommended in writing by manufacturer to remove

5. Dry immediately with clean, soft cloths. Follow direction of grain in metal. 6. Prime immediately to prevent rust. Do not touch cleaned metal surface until primed.

F. Mechanical Rust Removal: 1. Remove rust with specified abrasives for ferrous-metal cleaning. to bright metal. 2. Wipe off residue with mineral spirits and either steel wool or soft rags.

3. Dry immediately with clean, soft cloths. Follow direction of grain in

metal. 4. Prime immediately to prevent rust. Do not touch cleaned metal surface until primed.

3.4 PAINT REMOVAL

A. General: Remove paint where existing paint adherence or surface integrity has failed. Where cleaning methods have been attempted and further removal of the paint is required because of incompatible or unsatisfactory surfaces for repainting, remove paint to extent required by conditions.

1. Brushes: Use brushes that are resistant to chemicals being used. a. Metal Substrates: If using wire brushes on metal, use of same metal composition as metal being treated. b. Wood Substrates: Do not use wire brushes 2. Spray Equipment: Use spray equipment that provides controlled

application at volume and pressure indicated, measured at nozzle. pressure and volume to ensure that spray methods do not damage surfaces. a. Equip units with pressure gages. b. Unless otherwise indicated, hold spray nozzle at least 6 inches (150 mm) from surface and apply material in horizontal, back-and-forth

c. For chemical spray application, use low-pressure tank or chemical pump suitable for chemical indicated, equipped with nozzle having a coned. For water-spray application, use fan-shaped spray tip that

sweeping motion, overlapping previous strokes to produce uniform

disperses water at an angle of 25 to 50 degrees. e. For heated water-spray application, use equipment maintaining temperature between 140 and 160 deg F (60 and 71 deg C) at flow rates indicated. B. Paint Removal with Hand Tools: Remove paint manually using hand-held scrapers, wire brushes, sandpaper, and metallic wool as appropriate for the

substrate material. C. Paint Removal with Low-Odor, water based paste paint remover: 1. Apply thick coating of paint remover to dry, painted surface with natural-fiber cleaning brush, deep-nap roller, or large paintbrush. Apply in one

4. Use mechanical methods recommended in writing by

manufacturer to remove chemicals and paint residue.

5. Repeat process if necessary to remove all paint.

or two coats according to manufacturer's written instructions. 2. Allow paint remover to remain on surface for period recommended writing by manufacturer or as determined by preconstruction 3. Rinse with water applied by low-pressure spray to remove chemicals and paint residue.

3.5 SUBSTRATE REPAIR A. General: Repair substrate surface defects that are inconsistent with the surface appearance of adjacent materials and finishes.

B. Wood Substrate: 1. Repair wood defects including dents and gouges more than 1/8 inch (3 mm) in size and all holes and cracks by filling with woodand sanding smooth. Reset or remove protruding fasteners. 2. Where existing paint is allowed to remain, sand irregular buildup of paint, runs, and sags to achieve a uniformly smooth surface.

C. Cementitious Material Substrate: 1. General: Repair defects including dents and chips more than 1/4 mm) in size and all holes and cracks by filling with cementitious patching compound and sanding smooth. Remove protruding fasteners. 2. New and Bare Plaster: Neutralize surface of plaster with mild acid solution as recommended in writing by paint manufacturer. In lieu of acid neutralization, follow manufacturer's written instruction for primer or

transition coat over alkaline plaster surfaces. 3. Concrete, Cement Plaster, and Other Cementitious Products: Remove efflorescence, chalk, dust, dirt, grease, oils, and release agents. If surfaces are too alkaline to paint, correct this condition before painting. D. Metal Substrate:

1. Preparation: Treat repair locations by wire-brushing and solvent cleaning. Use chemical or mechanical rust removal method to clean off rust. 2. Defects in Metal Surfaces: Repair non-load-bearing defects in existing metal surfaces, including dents and gouges more than 1/8 inch (3 mm) deep or 1/2 inch (13 mm) across and all holes and cracks by filling with metal-patching compound and sanding smooth. Remove burrs and protruding fasteners. 3. Priming: Prime iron and steel surfaces immediately after repair to

edges. Apply two coats to surfaces that are inaccessible after completion of the 3.6 PAINT APPLICATION, GENERAL A. Prepare surfaces to be painted according to the Surface-Preparation Schedule

and with manufacturer's written instructions for each substrate condition.

B. Apply a transition coat over incompatible existing coatings.

prevent flash rusting. Stripe paint corners, crevices, bolts, welds, and sharp

C. Metal Substrate: Stripe coat corners, crevices, bolts, welds, and sharp edges before applying full coat. Apply two coats to surfaces that are inaccessible after completion of the Work. Tint stripe coat different than the main coating and apply D. Blending Painted Surfaces: When painting new substrates patched into existing surfaces or touching up missing or damaged finishes, apply coating

system specified for the specific substrate. Apply final finish coat over entire

3.7 FIELD QUALITY CONTROL

surface from edge to edge and corner to corner.

A. Manufacturer's Field Service: Engage paint-remover manufacturer's factoryauthorized service representative for consultation and Project-site inspection and to provide on-site assistance when requested by Architect.

3.8 CLEANING AND PROTECTION

damaged or defaced painted surfaces.

A. At end of each workday, remove rubbish, empty cans, rags, and other discarded materials from Project site. B. Protect work of other trades against damage from paint application. Correct damage to work of other trades by cleaning, repairing, replacing, and refinishing, as approved by Architect, and leave in an undamaged condition.

C. At completion of construction activities of other trades, touch up and restore

3.9 SURFACE-PREPARATION SCHEDULE A. General: Before painting, prepare surfaces for painting according to applicable requirements specified in this schedule.

1. Examine surfaces to evaluate each surface condition according to 2. Where existing degree of soiling prevents examination, preclean surface and allow it to dry before making an evaluation. 3. Repair substrate defects according to "Substrate Repair" Article. B. Surface Preparation for MPI DSD 0 Degree of Surface Degradation: 1. Surface Condition: Existing paint film in good condition and tightly

adhered. 2. Paint Removal: Not required. 3. Preparation for Painting: Wash surface by detergent cleaning; use solvent cleaning where needed. Roughen or degloss cleaned ensure paint adhesion according to paint manufacturer's written instructions. C. Surface Preparation for MPI DSD 1 Degree of Surface Degradation:

1. Surface Condition: Paint film cracked or broken but adhered. 2. Paint Removal: Scrape by hand-tool cleaning methods to remove paint until only tightly adhered paint remains. 3. Preparation for Painting: Wash surface by detergent cleaning; use other cleaning methods for small areas of bare substrate if required. Roughen, degloss, and sand the cleaned surfaces to ensure paint adhesion and a smooth finish

according to paint manufacturer's written instructions.

D. Surface Preparation for MPI DSD 2 Degree of Surface Degradation: 1. Surface Condition: Paint film loose, flaking, or peeling. 2. Paint Removal: Remove loose, flaking, or peeling paint film by hand-tool or chemical paint-removal methods.

3. Preparation for Painting: Wash surface by detergent cleaning; use solvent cleaning where needed. Use other cleaning methods for small areas of bare substrate if required. Sand surfaces to smooth remaining paint film edges. Prepare bare cleaned surface to be painted according to paint manufacturer's written instructions for substrate construction materials. E. Surface Preparation for MPI DSD 3 Degree of Surface Degradation: 1. Surface Condition: Paint film severely deteriorated. 2. Paint Removal: Completely remove paint film by hand-tool or chemical paint-removal methods. Remove rust. 3. Preparation for Painting: Prepare bare cleaned surface according to

paint manufacturer's written instructions for substrate F. Surface Preparation for MPI DSD 4 Degree of Surface Degradation: 1. Surface Condition: Missing material, small holes and openings, and deteriorated or corroded substrate. 2. Substrate Preparation: Repair, replace, and treat substrate according

to "Substrate Repair" Article. 3. Preparation for Painting: Sand substrate surfaces to smooth remaining paint film edges and prepare according to paint manufacturer's written instructions for substrate construction materials. Remove rust. 4. Painting: Paint as required for MPI DSD 2 degree of surface

3.10 EXTERIOR MAINTENANCE REPAINTING SCHEDULE A. Cementitious Substrates Horizontal: 1. Latex System: MPI REX 3.1 system: a. Prime Coat: For MPI DSD 1 degree of surface degradation, touch up with topcoat. b. Prime Coat: For MPI DSD 2 degree of surface degradation, spot prime with Primer, Alkali Resistant, Water Based, c. Prime Coat: For MPI DSD 3 degree of surface degradation, fully prime coat with Primer, Alkali Resistant, Water Based, d. Intermediate Coat: Latex, exterior, matching topcoat.

e. Topcoat: Floor Paint, Latex, exterior, low sheen (Gloss f. Color: Match colors indicated on Drawings. B. Cementitious/composite Substrates Vertical: 1. Latex System: MPI REX 3.2 system: a. Prime Coat: For MPI DSD 1 degree of surface degradation, touch up with topcoat. b. Prime Coat: For MPI DSD 2 degree of surface degradation, prime with Primer, Alkali Resistant, Water Based, c. Prime Coat: For MPI DSD 3 degree of surface degradation, fully prime coat with Primer, Alkali Resistant, Water Based, d. Intermediate Coat: Latex, exterior, matching topcoat. e. Topcoat: Latex, Exterior, low sheen (Gloss Level 3),

C. Ferrous Metal Substrates:: 1. Latex System: MPI REX 5.1 system over a transition coat where a. Prime Coat: For MPI DSD 1 degree of surface degradation, up with topcoat. b. Prime Coat: For MPI DSD 2 degree of surface degradation, spot prime with Primer, Rust-Inhibitive, Water Based, c. Prime Coat: For MPI DSD 3 degree of surface degradation, fully prime coat with Primer, Rust-Inhibitive, Water Based. MPI #107. d. Intermediate Coat: Latex, exterior, matching topcoat. e. Topcoat: Latex, Exterior, low sheen (Gloss Level 3),

1. Latex System: MPI REX 5.3 system over a transition coat where required. a. Prime Coat: For MPI DSD 1 degree of surface degradation, up with topcoat. b. Prime Coat: For MPI DSD 2 degree of surface degradation, prime with Primer, Galvanized, Water Based, MPI #134. c. Prime Coat: For MPI DSD 3 degree of surface degradation, prime coat with Primer, Galvanized, Water Based,

e. Topcoat: Latex, Exterior, low sheen (Gloss Level 3), E. Wood Paneling and Plywood:

b. Prime Coat: For MPI DSD 2 degree of surface degradation, prime with Primer, Latex for Exterior Wood, MPI #6. c. Prime Coat: For MPI DSD 3 degree of surface degradation, prime coat with Primer, Latex for Exterior Wood,

e. Topcoat: Latex, Exterior, low sheen (Gloss Level 3), f. Color: Match colors indicated on Drawings. F. Dimensional Wood: 1. Latex System: MPI REX 6.3A system. a. Prime Coat: For MPI DSD 1 degree of surface degradation,

prime with Primer, Latex for Exterior Wood, MPI #6. prime coat with Primer, Latex for Exterior Wood, d. Intermediate Coat: Latex, exterior, matching topcoat. e. Topcoat: Latex, Exterior, low sheen (Gloss Level 3),

f. Color: Match colors indicated on Drawings. G. Portland Cement Plaster: 1. Latex System: MPI REX 9.1 system: a. Prime Coat: For MPI DSD 1 degree of surface degradation, b. Prime Coat: For MPI DSD 2 degree of surface degradation, prime with Primer, Alkali Resistant, Water Based.

c. Prime Coat: For MPI DSD 3 degree of surface degradation, prime coat with Primer, Alkali Resistant, Water Based, d. Intermediate Coat: Latex, exterior, matching topcoat. e. Topcoat: Latex, Exterior, low sheen (Gloss Level 3),

f. Color: Match colors indicated on Drawings.



430 S. CARRILLO RD.

OJAI, CALIFORNIA 93023

(805) 530-5559

CONSULTANTS:

AGENCY APPROVAL:

MATILIJA MS CAMPUS -WIDE EXTERIOR PAINTING

OWNER: OJAI UNIFIED SCHOOL DISTRICT 414 EAST OJAI AVENUE OJAI. CA 93023 (805) 640-4300 **CONTACT: ADAM DUTTER** EMAIL: adutter@ojaiusd.org

PROJECT ADDRESS:

touch

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fully

MATILIJA MIDDLE SCHOOL 703 EL PASEO ROAD OJAI, CA 93023 OJAI USD PROJECT NO.: 2021-1600

ISSUE: MARK DATE DESCRIPTION

PROJECT INFORMATION: PROJECT NUMBER: 2021.010

PBS

THE ORIGINAL SIZE OF THIS SHEET IS 36"x24". IF THE CURRENT SIZE IS OTHER THAN 36"x24". THEN ADJUST THE SCALE OF THE DRAWINGS ACCORDINGLY. SHEET TITLE:

SHEET NUMBER:

DATE: 05/14/21

Level 3), MPI

f. Color: Match colors indicated on Drawings.

MPI #15. f. Color: Match colors indicated on Drawings. D. Galvanized Ferrous Metal Substrates::

MPI #134. d. Intermediate Coat: Latex, exterior, matching topcoat.

b. Color: Match colors indicated on Drawings. 1. Latex System: MPI REX 6.4 system. a. Prime Coat: For MPI DSD 1 degree of surface degradation, up with topcoat.

up with topcoat.

MPI #15.

d. Intermediate Coat: Latex, exterior, matching topcoat.

b. Prime Coat: For MPI DSD 2 degree of surface degradation, c. Prime Coat: For MPI DSD 3 degree of surface degradation,

REVIEWED BY:

DRAWN BY:

PROJECT PHASE:

GENERAL NOTES & SPECIFICATIONS

A. Work In This Section: Principal items include:

1. Preparation of surfaces. 2. Painting of interior surfaces, except as otherwise specified.

3. Painting of exterior surfaces, except as otherwise specified. B. Related Work Not In This Section:

1. Shop prime coats and factory finishes. 2. Painting specified as work of other sections.

3. Caulking and sealants. C. Surfaces Not To Be Painted:

1. Non-ferrous metal work (other than zinc-coated surfaces) and plated metal, unless particular items are specified to be painted. 2. Stone surfaces.

3. Exterior concrete walls and surfaces unless particular items are specified to be painted.. 4. Surfaces concealed in walls and above solid ceilings.

5. Non-metallic walking surfaces unless specifically shown or specified to be painted. 6. Factory finished surfaces.

7. Ceramic tile and plastic surfaces.

8. Resilient base.

9. Galvanized fencing. 10. Galvanized gratings.

11. Surfaces indicated not to be painted.

12. Surfaces specified to be finish painted under other sections.

1.02 COMPLIANCE WITH REGULATIONS: All materials shall comply with the current rules and regulations of the local air quality management district, with the rules regarding volatile organic compounds, and with FDA rules and regulations for dangerous materials in

1.03 SUBMITTALS

A. List of Paint Materials: Prior to submittal of samples, submit a complete list of proposed paint materials, identifying each material by manufacturer's name, product name and number, including primers, thinners, and coloring agents, together with manufacturers' catalog data fully describing each material as to contents, recommended usage, and preparation and application methods. Identify surfaces to receive various paint materials. Do not deviate from approved list.

B, Color Samples: Prior to preparing samples, obtain color and gloss selections and instructions. Using materials from approved list, prepare and submit 8-1/2" by 11" samples of each complete opaque paint finish. C. Natural or Stain Finish Samples: Prepare samples on 12" squares of the same species

and appearance of wood as used in the work. D. Job Samples: Apply minimum 100 square foot samples on site, on actual surfaces to be finished with each material, color, and gloss, in locations as directed. Prime and

intermediate coats shall extend one foot beyond finish coat on each sample in at least 2 directions. Obtain approval of each sample prior to proceeding with the work. Leave the samples in place, with removable tags, until completion of the work. All work shall match approved samples.

E. Certificates: Submit certificate showing that all products meet the requirements of paragraph "Compliance with Regulations" above. 1.04 JOB CONDITIONS

A. Protection: Protect all painting while in progress and cover and protect adjoining surfaces and property of others from damage. Exercise care to prevent paint from contacting surfaces not to be painted. During painting of exterior work, cover windows, doors, concrete, and other surfaces not to be painted.

B. Examination of Surfaces: Examine surfaces to be painted or finished under this Section and verify satisfactory condition. Unsatisfactory conditions shall be corrected before application of the first coat of paint. C. Weather Conditions: Apply paint to clean, dry, prepared surfaces. Do not apply

exterior paint during rainy, damp, foggy, or excessively hot and/or windy weather. Arrange for temporary heat and ventilation for interior painting. D. Precaution: Place rags and waste in self-closing metal containers, removed from site at

the end of each day. Do not let rags and waste accumulate. A. Provide a one gallon container of each paint color and surface texture to Owner at

B. Label each container with color, texture, and original application locations, in addition to the manufacturer's label.

PART 2 - PRODUCTS 2.01 ACCEPTABLE MANUFACTURERS:

Dunn-Edwards Corp. (Basis of Design) 4885 E. 52nd Place Los Angeles CA, 90058 (323) 771-3330

The Sherwin-Williams Company, Inc. 101 W. Prospect Ave. Cleveland, OH 44115 (216) 566-2000 FAX (216) 566-2947

Benjamin Moore & Co. 51 Chestnut Ridge Road Montvale NJ 07645 (888) 236-6667

Vista Paint Corporation 2020 Orangethorpe Avenue, Suite 210 Fullerton CA 92831 (323) 397-9000 FAX (323) 883-0273

PART 3 - EXECUTION

3.01 WORKMANSHIP: Apply painting materials in accordance with manufacturer's instructions by brush or roller; spray painting is not allowed without specific approval in each case unless noted otherwise. For this project, spray painting and backrolling is acceptable at exterior walls and exterior ceilings. Apply each coat at the proper consistency, free of brush or roller marks, sags, runs, or other evidence of poor workmanship. Do not lap paint on glass, hardware, and other surfaces not to be painted: apply masking as required. Sand between enamel coats. Apply painting materials in accordance with manufacturer's

3.02 PREPARATION OF SURFACES: Properly prepare surfaces to receive finishes. A. Concrete: Fill cracks, holes, and other blemishes with Portland cement patching plaster or a stiff paste mixed of finish paint and fine sand, finished to match adjoining surfaces. Remove glaze by sanding, wire brushing, or light brush-off sandblasting. Neutralize all alkali conditions according to the paint manufacturer's directions. Dry surfaces to receive breathing type latex paints at least two weeks, free of visible moisture. Dry the surfaces to receive oil, alkyd, or epoxy based paint until the moisture content does not exceed 8% when tested with an electronic moisture-measuring instrument.

B. Masonry: Repair minor holes and cracks with a stiff paste of finish paint and fine sand or vinyl type block filler. Report major or unsightly defects for correction. Neutralize all alkali and efflorescence according to paint manufacturer's directions, and allow to dry. C. Exterior Plaster: Fill hairline cracks with Portland cement patching material; report larger cracks for correction. Test and ensure plaster is sufficiently dry to receive the paint

D. Gypsum Wallboard: Touch-up minor defects with spackle and sand smooth and flush. Report other defects as specified. Verify that skim coat specified in Section 09250 is properly applied. If not, apply one heavy coat of skim coat material specified in Section 09250, over entire surface by brush or roller.

E. Shop Coated Metal: Degrease and clean of foreign matter. Clean and spot prime field connections, welds, soldered joints, burned, or abraded portions with same material used in shop coats. After complete hardening, sand entire surfaces for coat to follow. F. Uncoated Ferrous Metal: Degrease and clean of dirt, rust, mill scale, and all other foreign matter using power tool rotary brushes to achieve a clean surface consistent with SSPC-SP3. Remove pits and welding slag, and clean surfaces to bright metal before

priming. Apply metal primer not more than three hours after preparation. G. Galvanized Metal: Eliminate contaminants and stabilize zinc film by solvent wiping or sweep blasting, as appropriate, followed by not less than one coat of wash primer of type specified in Paint Schedule hereafter, to provide suitable surface for finish painting. Allow to dry. Prepare a representative surface, not smaller than 24" square, or 36" by length of

section, as applicable, and obtain approval prior to proceeding. 1. Solvent wiping: Remove oil and grease with rags or brushes saturated in trisodium phosphate or similar alkaline detergent. For heavier soil, use MEK, or equivalent proprietary cleaner. Do not use vinegar or acetic acid.

2. Sweep blasting: Use aluminum/magnesiumsilicate, limestone or other non-metallic

blast media to expose pure zinc. 3. Wash primer: Spray apply one coat of specified wash primer after other preparation is complete, to thickness of 0.5 mils. Allow to dry 60 minutes, and apply top coating in not more than 4 hours, If this time is exceeded for any reason, reapply wash primer prior to applying finish paint.

H.Enameled Woodwork: Remove handling marks and effects of exposure to moisture with a thorough sanding overall surfaces of the exposed portions, using at least 150 grit of finer sandpaper and thoroguhly clean all surfaces before applying sealer. After priming, putty nail holes, cracks, or other defects with putty matching color of finish paint. Cover knots and sappy areas with shallac or approved knot sealer. Sand each base coat smooth when dry.

I. Transparent Finished Woodwork: Remove handling marks and effects of exposure to moisture with a thorough sanding parallel to the grain of the wood, over all surfaces of the exposed portions, including interiors of cases and drawers, using at least 150 grit or finer sandpaper and thoroughly clean all surfaces before applying sealer. Repair all defects with filler tinted to match stain or wood color, as required, after first coat of sanding sealer and remove all smears. J. Fixtures, Equipment, and Flardware Items: Coordinate with the work of other

sections, and coordinate removal of fixtures, equipment, and hardware as required to perform painting. Items to be removed include, without limitation: signs and graphics; switch and receptacle plates; escutcheons and plates; all surface-mounted equipment; free-standing equipment blocking access; grilles and louvers at ducts opening into finished spaces; and other items as required and directed. Surfaces Not Mentioned: Prepare surfaces according to recommendations of the paint manufacturer and as approved.

K. Surfaces Not Mentioned: Prepare surfaces according to recommendations of the paint manufacturer and as approved.

L. Moisture Content: Measure moisture at surfaces using an electronic moisture

Do not apply finishes unless moisture is below the following maximums: 1. Exterior Plaster and Concrete: 15 percent

2. Exterior Wood: 19 percent 3. Interior Gypsum Wallboard: 12 percent Interior Wood:4. 15 percent measured in accordance with ASTM D2016

3.03 COATS: The number of paint coats specified to be applied are minimum. Apply additional coats if required to obtain complete hiding and approved results. Ensure acceptable paint finishes of uniform color, free from cloudy or mottled areas and evident thinness on arises. "Spot" or undercoat surfaces as necessary to produce such results. Tint each coat a slightly different shade of finish color to permit identification. Conform to the approved Samples. Obtain approval of each coat before applying next coat; otherwise, apply an additional coat over entire surface involved at no additional contract cost.

3.04 COLORS: The numbers given in the following schedule indicate the types of paints required for each surface, identified by their number in white. The actual paint to be applied on each surface shall be the same material in the color or colors as selected, and as approved on submitted samples. Allow for the use of several colors in each room or space, and for doors, frames, dadoes, trim and other items to be finished in different colors.

3.05 DEGREE OF GLOSS: Degrees of gloss shown on drawings and herein specified are approximate only. The exact degree of gloss required for each surface will be determined. Materials shall meet the following requirements for degree of gloss, when tested according to ASTM D523, using Gardner Laboratory 60 degree gloss meter after 14 days.

NOMENCLATURE	PERCENTAGE OF GLOSS
FLAT	LESS THAN 10
SUEDE OR EGGSHELL	25 - 55
SATIN OR SEMI-GLOSS	55 - 70
GLOSS OR HIGH GLOSS	MORE THAN 70

3.06 MISCELLANEOUS PAINTING: A. Fire Extinguisher and Fire Hose Cabinets and Fire Alarm Bells: Apply 2 coats of paint finish, inside and out, matching finish and color of adjoining areas, unless otherwise noted or directed.

B. Weatherstripping and Sound Seals. Paint exposed metal surfaces to match the door frame, whether or not unfinished, furnished with factory prime coat, or factory treated for paint adhesion. C. Doors: Seal top and bottom edges after cleaning with coat of primer. Where the faces of the doors differ in color or finish, finish the edges to match the face visible

when the door is open. Coat cutouts for hinges, edges of lockset holes and strikes

same as for first coat. D. Access doors and panels: Generally, paint same color as surrounding walls and

E. Louvers and glazed frames in wood and metal doors: Unless otherwise directed. paint 3 coats, colors to match doors.

G. Door Trim and Prime Coated Hinges: Paint trim to match door and paint hinges to match frame only where hinges are currently painted. Do not paint unfinished hinges. H. Speaker Grilles: Paint to match surrounding surfaces unless specified otherwise. I. Miscellaneous. For any items not specifically indicated or specified that require a paint finish, apply 3 coats of paint as directed.

3.07 CLEANING AND TOUCH-UP WORK. Make a detailed inspection of paint finishes after all painting is completed, remove spatterings of paint from the adjoining surfaces, and make good all damage that may be caused by cleaning operations. Carefully touch-up all abraded, stained, or otherwise disfigured painting, as approved, and leave entire painting in first-class condition.

LATERIORIA	INTING SCHEDU	PER TABLE BELOW	<u>. </u>	RIME & APPLY (2) COATS OF
SURFACE, COATS	DUNN-EDWARDS	BENJAMIN MOORE	VISTA PAINT	SHERWIN WILLIAMS
PLASTER & CONCRETE (100% ACRYLIC EGGSHELL/SATIN) FIRST COAT SECOND COAT THIRD COAT	ESPROO - EFF-STOP PREMIUM EVSH10 - EVERSHIELD10 EVSH10 - EVERSHIELD10	N023 FRESH START PRIMER 631 AURA SATIN 631 AURA SATIN	4600 UNIPRIME 2000 DURATONE 2000 DURATONE	LOXON LX02W0050 SUPERPAINT SATIN A89 SUPERPAINT SATIN A89
CONC. UNIT MASONRY (100% ACRYLIC EGGSHELL/SATIN) FIRST COAT SECOND COAT THIRD COAT	SBSL00-SMOOTHBLOC-FIL SELECT EVSH10 - EVERSHIELD10 EVSH10 - EVERSHIELD10	571 LATEX BLOCK FILL 631 AURA SATIN 631 AURA SATIN	040 BLOCK KOTE 2000 DURATONE 2000 DURATONE	HVY DUTY FILLER B42W4 SUPERPAINT SATIN A89 SUPERPAINT SATIN A89
FERROUS METAL ALKYD URETHNE SEMIGLOS ENAMEL FIRST COAT SECOND COAT THIRD COAT	BRPR00-BLOC-RUST PREMIUM ASHL50 - ARISTOSHIELD50 ASHL50 - ARISTOSHIELD50	OR EQUAL FROM OTHER MFRS	9600 PROTEC METAL PRIME 9800 PROTEC SEMIGLOSS 9800 PROTEC SEMIGLOSS	PROCRYL PRIMER B66 SE PI WB ALKYD URETHANE PI WB ALKYD URETHANE
GALVANIZED METAL, ALKYD URETHNE SEMIGLOS ENAMEL PRETREAT FIRST COAT SECOND COAT THIRD COAT	SC-ME01 - KRUD KUTTER METAL CLEAN AND ETCH UGPR00 - ULTRAGRIP PREMIUM ASHL50 - ARISTOSHIELD50 ASHL50 - ARISTOSHIELD50	OR EQUAL FROM OTHER MFRS	JASCO PREP N'PRIME 9600 PROTEC METAL PRIME 9800 PROTEC SEMIGLOSS 9800 PROTEC SEMIGLOSS	DTM WASH PRIMER PROCRYL PRIMER B66 SE PI WB ALKYD URETHANE PI WB ALKYD URETHANE
WOOD - PAINTED, 100% ACRYLIC SEMI-GLOSS ENAMEL FIRST COAT SECOND COAT THIRD COAT	EZPROO - E-Z PRIME PREMIUM ASHL50 - ARISTOSHIELD50 ASHL50 - ARISTOSHIELD50	N023 FRESH START PRIMER W096 MOORGLO W096 MOORGLO	4200 TERMINATOR 8400 CAREFREE 8400 CAREFREE	PREPRITE PROBLOCK B51 SOLO A76 SERIES SOLO A76 SERIES
WOOD, SEMI-TRANSPARENT STAIN FIRST COAT SECOND COAT (IF REQ'D)	CABOT STAIN SEMI-SOLID	C329 SEMI-SOLID STAIN C329 SEMI-SOLID STAIN	OLYMPIC ST STAIN OLYMPIC ST STAIN	WOODSCAPES A15T5 WOODSCAPES A15T5
	INTERIO	TABLE 2 R ENAMEL MATI	ERIALS	
SURFACE, COATS	DUNN-EDWARDS	BENJAMIN MOORE	VISTA PAINT	SHERWIN WILLIAMS
100% ACRYLIC FINISH, GLOSS	SWLL50 SPARTAWALL60	309 IMPERVEX	8500 CAREFREE	SOLO A77 GLOSS SERIES
100% ACRYLIC FINISH, SEMI- GLOSS WALLS AND CEILINGS ONLY NON-BLICKING, FOR DOORS AND WINDOWS	W6160E VERBAGLO SWLL50 SPARTAWALL60	276 MOORCRAFT 333 REGAL AQUAGLO	7000 ACRIGLO 8400 CAREFREE	SOLO A76 SEMI-GLOSS SERIES
100% ACRYLIC FINISH, EGGSHELL	W6Z50E VERSASATIN	277 SUPER SPEC PEARL	1700 COVERALL	SOLO EGGSHELL A75 SEF
	INTERIO	TABLE 3 R PAINTING SCH	<u>IEDULE</u>	
SURFACE, COATS	DUNN-EDWARDS	BENJAMIN MOORE	VISTA PAINT	SHERWIN WILLIAMS
WOOD, SEMI-TRANSPARENT STAIN FIRST COAT SECOND COAT	SWLL50 SPARTAWALL60 SWLL50 SPARTAWALL60	215 REGAL WALL SATIN 215 REGAL WALL SATIN	8100 CAREFREE 8100 CAREFREE	PROMAR 200HP EGGSHEL B20-1900 PROMAR 200HP EGGSHEL B20-1900
CONCRETE UNIT MASONRY, ACRYLIC FLAT FINISH FIRST COAT SECOND COAT THIRD COAT	SB5L00 - SMOOTH BLOCK- FIL SELECT ENAMEL FINISH ENAMEL FINISH	205 BLOCK FILLER 215 REGAL WALL SATIN 215 REGAL WALL SATIN	040 BLOCK KOTE 8100 CAREFREE 8100 CAREFREE	BLOCK FILLER B42W46 PROMAR 200HP EGGSHEI B20-1900 PROMAR 200HP EGGSHEI B20-1900
GYPSUM BOARD, ENAMEL FINISH FIRST COAT SECOND COAT THIRD COAT	VNSL00 - VINYLASTIC SELECT ENAMEL FINISH ENAMEL FINISH	216 FIRST COAT ENAMEL FINISH ENAMEL FINISH	110 HI BUILD SEALER ENAMEL FINISH ENAMEL FINISH	PROMAR 200 B28W2600 PROMAR 200HP EGGSHEI B20-1900 PROMAR 200HP EGGSHEI B20-1900
WOOD, ENAMEL FINISH FIRST COAT SECOND COAT THIRD COAT	BIPROO - BLOCK-IT PREMIUM ENAMEL FINISH	023 FRESH START ENAMEL FINISH ENAMEL FINISH	188 ACRYLIC UNDERCOATER ENAMEL FINISH ENAMEL FINISH	PREPRITE B51 SERIES SOLO A76 SERIES SOLO A76 SERIES

WOOD, SATIN CLEAR VARNISH 3 COATS

FERROUS METAL, ENAME FINISH

MCCLOSKEY'S 6701

UGPR00 - ULTRA-GRIP PREMIUM ENAMEL FINISH ENAMEL FINISH

SECTION 08 11 13 - HOLLOW METAL DOORS AND FRAMES

PART 1 - GENERAL

1.1 RELATED DOCUMENTS A. Drawings and general provisions of the Contract, including General and Supplementary Conditions and Division 01 Specification Sections, apply to this

1.2 SUMMARY

Section.

A. Section Includes: 1. Standard and custom hollow metal doors and frames.

2. Steel sidelight, borrowed lite and transom frames. 3. Louvers installed in hollow metal doors.

4. Light frames and glazing installed in hollow metal doors. B. Related Sections: 1. Division 04 Section "Unit Masonry" for embedding anchors for hollow metal work into masonry construction.

2. Division 08 Section "Glazing" for glass view panels in hollow metal doors. 3. Division 08 Section "Door Hardware".

4. Division 08 Section "Access Control Hardware". 5. Division 09 Sections "Exterior Painting" and "Interior Painting" for field

painting hollow metal doors and frames. C. Codes and References: Comply with the version year adopted by the Authority Having Jurisdiction

1. ANSI/SDI A250.8 - Recommended Specifications for Standard Steel Doors and Frames. 2. ANSI/SDI A250.4 - Test Procedure and Acceptance Criteria for Physical Endurance for Steel Doors, Frames, Frames Anchors and Hardware Reinforcing.

3. ANSI/SDI A250.6 - Recommended Practice for Hardware Reinforcing on Standard Steel Doors and Frames. 4. ANSI/SDI A250.10 - Test Procedure and Acceptance Criteria for Prime Painted

Steel Surfaces for Steel Doors and Frames. 5. ANSI/SDI A250.11 - Recommended Erection Instructions for Steel Frames. 6. ASTM A1008 - Standard Specification for Steel Sheet, Cold-Rolled, Carbon, Structural, High-Strength Low-Alloy and High-Strength Low-Alloy with Improved Formability.

7. ASTM A653 - Standard Specification for Steel Sheet, Zinc-Coated (Galvanized) or Zinc-Iron Alloy-Coated (Galvannealed) by the Hot-Dip Process. 8. ASTM A924 - Standard Specification for General Requirements for Steel

Sheet, Metallic-Coated by the Hot-Dip Process. 9. ASTM C 1363 - Standard Test Method for Thermal Performance of Building

Assemblies by Means of a Hot Box Apparatus. 10. ANSI/BHMA A156.115 - Hardware Preparation in Steel Doors and Frames. 11. ANSI/SDI 122 - Installation and Troubleshooting Guide for Standard Steel Doors

12. ANSI/NFPA 80 - Standard for Fire Doors and Fire Windows; National Fire Protection Association 13. ANSI/NFPA 105: Standard for the Installation of Smoke Door Assemblies.

14. NFPA 252 - Standard Methods of Fire Tests of Door Assemblies; National Fire Protection Association. 15. UL 10C - Positive Pressure Fire Tests of Door Assemblies.

16. UL 1784 - Standard for Air Leakage Tests of Door Assemblies. .3 SUBMITTALS A. Product Data: For each type of product indicated. Include construction details, material descriptions, core descriptions, hardware reinforcements, profiles,

anchors, fire-resistance rating, and finishes. B. Door hardware supplier is to furnish templates, template reference number and/or physical hardware to the steel door and frame supplier in order to prepare the doors and frames to receive the finish hardware items.

C. Shop Drawings: Include the following: 1. Elevations of each door design.

2. Details of doors, including vertical and horizontal edge details and metal thicknesses.

3. Frame details for each frame type, including dimensioned profiles and metal thicknesses.

4. Locations of reinforcement and preparations for hardware. 5. Details of anchorages, joints, field splices, and connections.

6. Details of accessories. 7. Details of moldings, removable stops, and glazing.

from a single manufacturer wherever possible.

8. Details of conduit and preparations for power, signal, and control systems. D. Samples for Verification: 1. Samples are only required by request of the architect and for manufacturers

that are not current members of the Steel Door Institute. Source Limitations: Obtain hollow metal doors and frames through one source

B. Quality Standard: In addition to requirements specified, comply with ANSI/SDI A250.8, latest edition, "Recommended Specifications for Standard Steel Doors and Frames". C. Fire-Rated Door Assemblies: Assemblies complying with NFPA 80 that are listed

and labeled by a qualified testing agency, for fire-protection ratings indicated, based on testing at positive pressure according to NFPA 252 (neutral pressure at 40" above sill) or UL 10C. 1. Oversize Fire-Rated Door Assemblies Construction: For units exceeding sizes of tested assemblies, attach construction label certifying doors are built to

standard construction requirements for tested and labeled fire rated door assemblies except for size. 2. Temperature-Rise Limit: Where indicated and at vertical exit enclosures (stairwell openings) and exit passageways, provide doors that have a maximum

transmitted temperature end point of not more than 450 deg F (250 deg C) above ambient after 30 minutes of standard fire-test exposure. 3. Smoke Control Door Assemblies: Comply with NFPA 105. a. Smoke "S" Label: Doors to bear "S" label, and include smoke and draft

control gasketing applied to frame and on meeting stiles of pair doors. D. Fire-Rated, Borrowed-Light Frame Assemblies: Assemblies complying with NFPA 80 that are listed and labeled, by a testing and inspecting agency

acceptable to authorities having jurisdiction, for fire-protection ratings indicated. based on testing according to NFPA 257. Provide labeled glazing material. E. Energy Efficient Exterior Openings: Comply with minimum thermal ratings, based on ASTM C1363. Openings to be fabricated and tested as fully operable, thermal

insulating door and frame assemblies. 1. Thermal Performance (Exterior Openings): Independent testing laboratory certification for exterior door assemblies being tested in accordance with

ASTM C1363 and meet or exceed the following requirements: a. Door Assembly Operable U-Factor and R-Value Ratings: U-Factor 0.29, R-Value 3.4, including insulated door, thermal-break frame and threshold. 2. Air Infiltration (Exterior Openings): Independent testing laboratory certification

for exterior door assemblies being tested in accordance with ASTM E283 to meet or exceed the following requirements: a. Rate of leakage of the door assembly shall not exceed 0.25 cfm per square foot of static differential air pressure of 1.567 psf (equivalent to 25 mph

wind velocity). F. Pre-Submittal Conference: Conduct conference in compliance with requirements in Division 01 Section "Project Meetings" with attendance by representatives of Supplier, Installer, and Contractor to review proper methods and procedures for installing hollow metal doors and frames and to verify installation of electrical knockout boxes and conduit at frames with electrified or access control hardware.

1.5 DELIVERY, STORAGE, AND HANDLING A. Deliver hollow metal work palletized, wrapped, or crated to provide protection during transit and Project site storage. Do not use non-vented plastic. B. Deliver welded frames with two removable spreader bars across bottom of frames,

tack welded to jambs and mullions. C. Store hollow metal work under cover at Project site. Place in stacks of five units maximum in a vertical position with heads up, spaced by blocking, on minimum 4inch high wood blocking. Do not store in a manner that traps excess humidity. 1. Provide minimum 1/4-inch space between each stacked door to permit air

A. Field Measurements: Verify actual dimensions of openings by field measurements before fabrication. 1.7 COORDINATION

A. Coordinate installation of anchorages for hollow metal frames. Furnish setting

circulation. Door and frames to be stacked in a vertical upright position.

drawings, templates, and directions for installing anchorages, including sleeves, concrete inserts, anchor bolts, and items with integral anchors. Deliver such items to Project site in time for installation. 1.8 WARRANTY

repair or replace doors that fail in materials or workmanship within specified warranty period. B. Warranty includes installation and finishing that may be required due to repair or replacement of defective doors.

A. Special Warranty: Manufacturer's standard form in which manufacturer agrees to

PART 2 - PRODUCTS

2.1 MANUFACTURERS A. Manufacturers: Subject to compliance with requirements, provide products by one

of the following: 1. CECO Door Products.

2. Curries Company. 3. Security Metal Products.

2.2 MATERIALS A. Cold-Rolled Steel Sheet: ASTM A 1008/A 1008M. Commercial Steel (CS), Type B: suitable for exposed applications.

B. Metallic-Coated Steel Sheet: ASTM A 653/A 653M, Commercial Steel (CS), Type B; with minimum G60 (Z180) or A60 (ZF180) metallic coating.

C. Frame Anchors: ASTM A 653/A 653M, Commercial Steel (CS), Commercial Steel (CS), Type B; with minimum G60 (Z180) or A60 (ZF180) metallic coating. 2.3 STANDARD HOLLOW METAL DOORS

A. General: Provide 1-3/4 inch doors of design indicated, not less than thickness indicated; fabricated with smooth surfaces, without visible joints or seams on exposed faces unless otherwise indicated. Comply with ANSI/SDI A250.8. B. Exterior Doors: Face sheets fabricated of commercial quality hot-dipped zinc coated steel that complies with ASTM A 653/A 653M, Coating Designation A60.

Provide doors complying with requirements indicated below by referencing

ANSI/SDI A250.8 for level and model and ANSI/SDI A250.4 for physical

performance level: 1. Design: Flush panel.

2. Core Construction: Manufacturer's standard polystyrene. Where indicated, provide doors fabricated as thermal-rated assemblies with a minimum R-value

3. Top and Bottom Edges: Reinforce tops and bottoms of doors with a continuous steel channel not less than 16 gauge, extending the full width of the door and welded to the face sheet. Doors with an inverted top channel to include a steel closure channel, screw attached, with the web of the channel flush with the face sheets of the door. Plastic or composite channel fillers are not acceptable. 4. Hinge Reinforcement: Minimum 7 gauge (3/16") plate 1-1/4" x 9" or minimum 14

gauge continuous channel with pierced holes, drilled and tapped. 5. Hardware Reinforcements: Fabricate according to ANSI/SDI A250.6 with

reinforcing plates from same material as door face sheets. C. Interior Doors: Face sheets fabricated of commercial quality cold rolled steel that complies with ASTM A 1008/A 1008M. Provide doors complying with requirements indicated below by referencing ANSI/SDI A250.8 for level and model and ANSI/SDI A250.4 for physical performance level: 1. Design: Flush panel.

2. Core Construction: Manufacturer's standard kraft-paper honeycomb, or onepiece polystyrene core, securely bonded to both faces.

a. Fire Door Core: As required to provide fire-protection and temperature-rise ratings indicated. 3. Top and Bottom Edges: Reinforce tops and bottoms of doors with a continuous

steel channel not less than 16 gauge, extending the full width of the door and welded to the face sheet. 4. Hinge Reinforcement: Minimum 7 gauge (3/16") plate 1-1/4" x 9" or minimum 14

gauge continuous channel with pierced holes, drilled and tapped. 5. Hardware Reinforcements: Fabricate according to ANSI/SDI A250.6 with reinforcing plates from same material as door face sheets.

D. Manufacturers Basis of Design: 2.4 ENERGY-EFFICIENT HOLLOW METAL DOORS

A. General: Provide 1-3/4 inch doors of design specified, not less than thickness indicated; fabricated with smooth surfaces, without visible joints or seams on exposed faces unless otherwise indicated. Comply with ANSI/SDI A250.8 and ANSI/NAAMM HMMA 867.

B. Energy Efficient Exterior Doors: Face sheets fabricated of commercial quality hotdipped zinc coated steel that complies with ASTM A924 A60. Provide doors complying with requirements indicated below by referencing ANSI/SDI A250.8 for level and model, ANSI/SDI A250.4 for physical performance level, and HMMA 867 for door construction. 1. Design: Flush panel.

core with no stiffener face welds, in compliance with HMMA 867 "Laminated a. Provide 22 gauge steel stiffeners at 6 inches on-center internally welded at 5" on- center to integral core assembly, foamed in place polyurethane core

2. Core Construction: Foamed in place polyurethane and steel stiffened laminated

chemically bonded to all interior surfaces. No stiffener face welding is b. Thermal properties to rate at a fully operable minimum U-Factor 0.29 and R-Value 3.4, including insulated door, thermal-break frame and threshold. 1 Kerf Type Frames: Thermal properties to rate at a fully operable minimum

U-Factor 0.36 and R-Value 2.7, including insulated door, kerf type frame, and threshold. 3. Level/Model: Level 2 and Physical Performance Level A (Heavy Duty), Minimum 18 gauge (0.042 inch - 1.1-mm) thick steel, Model 2.

4. Vertical Edges: Vertical edges to be mechanically interlocked with hairline seam. Beveled Lock Edge, 1/8 inch in 2 inches (3 mm in 50 mm). 5. Top and Bottom Edges: Reinforce tops and bottoms of doors with a continuous steel channel not less than 16 gauge, extending the full width of the door and welded to the face sheet. Doors with an inverted top channel to include a steel closure channel, screw attached, with the web of the channel flush with the

face sheets of the door. Plastic or composite channel fillers are not acceptable. 6. Hinge Reinforcement: Minimum 7 gauge (3/16") plate 1-1/4" x 9". 7. Hardware Reinforcements: Fabricate according to ANSI/SDI A250.6 with

reinforcing plates from same material as door face sheets. C. Manufacturers Basis of Design: 1. CECO Door Products Trio-E/Trio Series. 2. Curries Company 777 Trio-E/Trio Series.

2.5 STANDARD HOLLOW METAL FRAMES A. General: Comply with ANSI/SDI A250.8 and with details indicated for type and

B. Exterior Frames: Fabricated of hot-dipped zinc coated steel that complies with ASTM A 653/A 653M, Coating Designation A60. 1. Fabricate frames with mitered or coped corners. 2. Fabricate frames, with the exception of knock down types, with "closed and

tight" miter seams continuously welded on face, finished smooth with no visible seam unless otherwise indicated. 3. Frames for Level 3 Steel Doors (up to 48 inches in width): Minimum 14 gauge

(0.067-inch -1.7-mm) thick steel sheet. 4. Frames for Level 3 Steel Doors (48 inches and up in width): Minimum 12 gauge (0.081-inch -2.7-mm) thick steel sheet. 5. Frames for Level 2 Steel Doors: Minimum 16 gauge (0.053-inch -1.3-mm) thick

6. Manufacturers Basis of Design: a. CECO Door Products SQ/SU/SR Series. b. Curries Company M/G Series. C. Interior Frames: Fabricated from cold-rolled steel sheet that complies with

ASTM A 1008/A 1008M. 1. Fabricate frames with mitered or coped corners. 2. Fabricate frames, with the exception of slip-on drywall types, with "closed and tight" miter seams continuously welded on face, finished smooth with no

visible seam unless otherwise indicated. 3. Frames for Steel Doors: Minimum 16 gauge (0.053-inch -1.3-mm) thick steel

inch -1.3-mm) thick steel sheet.] 5. Frames for openings 48 inches and wider in width: Minimum 14 gauge (0.067inch -1.7-mm) thick steel sheet.]

4. Frames for openings up to 48 inches in width: Minimum 16 gauge (0.053-

6. Frames for Wood Doors: Minimum 16 gauge (0.053-inch-1.3-mm-) thick steel 7. Frames for Borrowed Lights: Minimum 16 gauge (0.053-inch-1.3-mm-) thick steel sheet

a. CECO Door Products BQ/BU/DQ/DU/BR/DR Series (Drywall Profile). b. CECO Door Products SQ/SU/SR Series (Masonry Profile). c. Curries Company C/CM/CG Series (Drywall Profile). d. Curries Company M/G Series (Masonry Profile).

D. Fire rated frames: Fabricate frames in accordance with NFPA 80, listed and

8. Manufacturers Basis of Design:

A. Jamb Anchors:

labeled by a qualified testing agency, for fire-protection ratings indicated. E. Hardware Reinforcement: Fabricate according to ANSI/SDI A250.6 Table 4 with reinforcement plates from same material as frames. 2.6 FRAME ANCHORS

Masonry Type: Adjustable strap-and-stirrup or T-shaped anchors to suit frame size. formed from A60 metallic coated material, not less than 0.042 inch thick, with corrugated or perforated straps not less than 2 inches wide by 10 inches long; or wire anchors not less than 0.177 inch thick.

1. Stud Wall Type: Designed to engage stud and not less than 0.042 inch thick. 2. Compression Type for Drywall Slip-on (Knock-Down) Frames: Adjustable

compression anchors. 3. Windstorm Opening Anchors: Types as tested and required for indicated wall types to meet specified wind load design criteria.

4. FEMA 361 Storm Shelter Anchors: Masonry T-shaped, wire masonry type, or existing opening type anchors.

B. Floor Anchors: Floor anchors to be provided at each jamb, formed from A60 metallic coated material, not less than 0.042 inches thick.

C. Mortar Guards: Formed from same material as frames, not less than 0.016 inches 2.7 HOLLOW METAL PANELS A. Provide hollow metal panels of same materials, construction, and finish as

specified for adjoining hollow metal work. A. Metal Louvers: Door manufacturer's standard metal louvers unless otherwise indicated.

1. Blade Type: Vision proof inverted V or inverted Y. 2. Metal and Finish: Galvanized steel, 0.040 inch thick, factory primed for paint finish with baked enamel or powder coated finish. Match pre-finished door

paint color where applicable. B. Louvers for Fire Rated Doors: Metal louvers with fusible link and closing device, listed and labeled for use in doors with fire protection rating of 1-1/2 hours and

1. Manufacturers: Subject to compliance with requirements, provide door

manufacturers standard louver to meet rating indicated. 2. Metal and Finish: Galvanized steel, 0.040 inch thick, factory primed for paint finish with baked enamel or powder coated finish. Match pre-finished door

paint color where applicable. 2.9 LIGHT OPENINGS AND GLAZING

mechanical anchors

A. Stops and Moldings: Provide stops and moldings around glazed lites where indicated. Form corners of stops and moldings with butted or mitered hairline joints at fabricator's shop. Fixed and removable stops to allow multiple glazed lites each to be removed independently. Coordinate frame rabbet widths between fixed and removable stops with the type of glazing and installation indicated. B. Moldings for Glazed Lites in Doors and Loose Stops for Glazed Lites in Frames: Minimum 20 gauge thick, fabricated from same material as door face sheet in which they are installed.

C. Fixed Frame Moldings: Formed integral with hollow metal frames, a minimum of 5/8 inch (16 mm) high unless otherwise indicated. Provide fixed frame moldings and stops on outside of exterior and on secure side of interior doors and frames D. Preformed Metal Frames for Light Openings: Manufacturer's standard frame

formed of 0.048-inch-thick, cold rolled steel sheet; with baked enamel or powder

coated finish; and approved for use in doors of fire protection rating indicated.

Match pre-finished door paint color where applicable. E. Glazing: Comply with requirements in Division 08 Section "Glazing" and with the hollow metal door manufacturer's written instructions.

1. Factory Glazing: Factory install glazing in doors as indicated. Doors with

B. Grout Guards: Formed from same material as frames, not less than 0.016 inches

factory installed glass to include all of the required glazing material. A. Mullions and Transom Bars: Join to adjacent members by welding or rigid

2.11 FABRICATION A. Fabricate hollow metal work to be rigid and free of defects, warp, or buckle. Accurately form metal to required sizes and profiles, with minimum radius for thickness of metal. Where practical, fit and assemble units in manufacturer's plant. When shipping limitations so dictate, frames for large openings are to be

fabricated in sections for splicing or splining in the field by others. B. Tolerances: Fabricate hollow metal work to tolerances indicated in ANSI/SDI A250.8.

C. Hollow Metal Doors: 1. Exterior Doors: Provide optional weep-hole openings in bottom of exterior doors to permit moisture to escape where specified.

2. Glazed Lites: Factory cut openings in doors with applied trim or kits to fit. Factory install glazing where indicated. 3. Astragals: Provide overlapping astragals as noted in door hardware sets in Division 08 Section "Door Hardware" on one leaf of pairs of doors where required by NFPA 80 for fire-performance rating or where indicated. Extend

minimum 3/4 inch beyond edge of door on which astragal is mounted. 4. Continuous Hinge Reinforcement: Provide welded continuous 12 gauge strap for continuous hinges specified in hardware sets in Division 08 Section "Door D. Hollow Metal Frames:

1. Shipping Limitations: Where frames are fabricated in sections due to shipping or handling limitations, provide alignment plates or angles at each joint, fabricated of same thickness metal as frames.

2. Welded Frames: Weld flush face joints continuously; grind, fill, dress, and make

smooth, flush, and invisible. a. Welded frames are to be provided with two steel spreaders temporarily attached to the bottom of both jambs to serve as a brace during shipping and handling. Spreader bars are for bracing only and are not to be used to

size the frame opening. 3. Sidelight and Transom Bar Frames: Provide closed tubular members with no visible face seams or joints, fabricated from same material as door frame.

Fasten members at crossings and to jambs by butt welding.

4. High Frequency Hinge Reinforcement: Provide high frequency hinge reinforcements at door openings 48-inches and wider with mortise butt type hinges at top hinge locations. 5. Continuous Hinge Reinforcement: Provide welded continuous 12 gauge straps

for continuous hinges specified in hardware sets in Division 08 Section "Door

6. Provide countersunk, flat- or oval-head exposed screws and bolts for exposed fasteners unless otherwise indicated for removable stops, provide security screws at exterior locations.

all hinges and strike preps regardless of grouting requirements. 8. Floor Anchors: Weld anchors to bottom of jambs and mullions with at least four spot welds per anchor.

9. Jamb Anchors: Provide number and spacing of anchors as follows:

1. Three anchors per jamb up to 60 inches high.

inches or fraction thereof above 96 inches high.

7. Mortar Guards: Provide guard boxes at back of hardware mortises in frames at

a. Masonry Type: Locate anchors not more than 18 inches from top and bottom of frame. Space anchors not more than 32 inches o.c. and as follows: 1. Two anchors per jamb up to 60 inches high. 2. Three anchors per jamb from 60 to 90 inches high.

3. Four anchors per jamb from 90 to 120 inches high. 4. Four anchors per jamb plus 1 additional anchor per jamb for each 24 inches or fraction thereof above 120 inches high. b. Stud Wall Type: Locate anchors not more than 18 inches from top and

bottom of frame. Space anchors not more than 32 inches o.c. and as follows:

2. Four anchors per jamb from 60 to 90 inches high. 3. Five anchors per jamb from 90 to 96 inches high. 4. Five anchors per jamb plus 1 additional anchor per jamb for each 24

5. Two anchors per head for frames above 42 inches wide and mounted in metal stud partitions 10. Door Silencers: Except on weatherstripped or gasketed doors, drill stops to receive door silencers. Silencers to be supplied by frame manufacturer

mortised hardware; include cutouts, reinforcement, mortising, drilling, and tapping according to the Door Hardware Schedule and templates furnished as specified in Division 08 Section "Door Hardware."

3. Comply with applicable requirements in ANSI/SDI A250.6 and

with Division 26 Sections.

E. Hardware Preparation: Factory prepare hollow metal work to receive template

regardless if specified in Division 08 Section "Door Hardware".


1. Locate hardware as indicated, or if not indicated, according to ANSI/SDI A250.8. 2. Reinforce doors and frames to receive non-template, mortised and surface mounted door hardware.

ANSI/DHI A115 Series specifications for preparation of hollow metal work for 4. Coordinate locations of conduit and wiring boxes for electrical connections

HARTMANNARCHITECTURESTUDIO.COM 430 S. CARRILLO RD. OJAI, CALIFORNIA 93023 (805) 530-5559

CONSULTANTS:

AGENCY APPROVAL

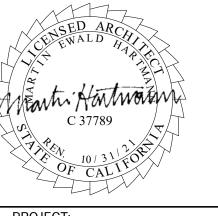

MATILIJA MS CAMPUS -WIDE EXTERIOR PAINTING

OWNER:

OJAI UNIFIED SCHOOL DISTRICT 414 EAST OJAI AVENUE OJAI, CA 93023 (805) 640-4300 **CONTACT: ADAM DUTTER** EMAIL: adutter@ojaiusd.org

PROJECT ADDRESS:

MATILIJA MIDDLE SCHOOL 703 EL PASEO ROAD OJAI, CA 93023

OJAI USD PROJECT NO.: 2021-1600

ISSUE: MARK DATE DESCRIPTION

DRAWN BY: REVIEWED BY: THE ORIGINAL SIZE OF THIS SHEET IS 36"x24". IF THE CURRENT SIZE IS OTHER THAN 36"x24". THEN ADJUST THE SCALE OF THE DRAWINGS ACCORDINGLY.

SHEET TITLE:

PROJECT INFORMATION:

PROJECT NUMBER:

PROJECT PHASE:

SHEET NUMBER:

2021.010

PBS

DATE: 05/14/21

GENERAL NOTES & SPECIFICATIONS

A. General: Install hollow metal work plumb, rigid, properly aligned, and securely fastened

B. Hollow Metal Frames: Install hollow metal frames of size and profile indicated. Comply

permanent anchors are set. After wall construction is complete and frames properly

2. Floor Anchors: Provide floor anchors for each jamb and mullion that extends to floor,

3. Masonry Walls: Coordinate installation of frames to allow for solidly filling space

4. Grout Requirements: Do not grout head of frames unless reinforcing has been

C. Hollow Metal Doors: Fit hollow metal doors accurately in frames, within clearances

d. Between Bottom of Door and Top of Finish Floor (No Threshold): Maximum 3/4

D. Field Glazing: Comply with installation requirements in Division 08 Section "Glazing"

A. Final Adjustments: Check and readjust operating hardware items immediately before

replace defective work, including hollow metal work that is warped, bowed, or

C. Prime-Coat and Painted Finish Touchup: Immediately after erection, sand smooth

rusted or damaged areas of prime coat, or painted finishes, and apply touchup of

compatible air drying, rust-inhibitive primer, zinc rich primer (exterior and galvanized

A. Schedule installation to keep gypsum sheathing exposure to ultraviolet (UV) rays within

B. Preinstallation Meeting: Conduct a preinstallation meeting one week prior to the start

of the work of this section; require attendance by all affected installers.

A. Product Data: Provide Manufacturer product data for sheathing and fasteners.

B B. Test Reports: For all stud framing products that do not comply with ASTM C645 or C

A. Manufacturer Qualifications: Company specializing in manufacturing products

specified in this section, with not less than three years of documented experience.

B. Installer Qualifications: Company specializing in performing the work of this section

A. Delivery: Comply with Gypsum Association (GA) publication GA-801 "Handling Gypsum

certification, packaging, marking, shipping, handling, and storage of gypsum panel

A. Manufacturer's Warranty: Provide specific protection against problems resulting from

A. Gypsum sheathing: One of the following 1/2-inch thick, or equal complying with ASTM C

1. Dens-Glass Gold (Standard and Type X) sheathing board by G-P Gypsum Products

B. Screws: Steel drill screws with organic-polymer or other corrosion-protective coating

1. For steel framing less than 0.0329-inch thick, attach sheathing in compliance with

2. For steel framing from 0.033 to 0.112-inch thick, attach sheathing in compliance with

having a salt-spray resistance of more than 800 hours according to ASTM B 117.

A. Gypsum sheathing tape: Use only tapes approved by the sheathing manufacturers.

A. Basis of Design: G-P Gypsum Products Dens-Glass Gold (Type X) sheathing board

Board" and applicable requirements of ASTM C 1264 for sampling, inspection, rejection,

1. Submit a list of proposed products and accessories to be used on this project.

754, provide independent laboratory reports showing maximum stud heights at

C. Warranty: Submit manufacturer warranty and ensure that forms have been completed

B. Remove grout and other bonding material from hollow metal work immediately after

final inspection. Leave work in complete and proper operating condition. Remove and

b. Between Edges of Pairs of Doors: 1/8 inch plus or minus 1/16 inch.

2. Fire-Rated Doors: Install doors with clearances according to NFPA 80.

c. Between Bottom of Door and Top of Threshold: Maximum 3/8 inch.

installed in head of frame. Do not grout vertical or horizontal closed mullion

1. Set frames accurately in position, plumbed, aligned, and braced securely until

set and secured, remove temporary braces, leaving surfaces smooth and

undamaged. Shim as necessary to comply with installation tolerances.

in place; comply with Drawings and manufacturer's written instructions.

with ANSI/SDI A250.11 and NFPA 80 at fire rated openings.

and secure with post-installed expansion anchors.

a. Jambs and Head: 1/8 inch plus or minus 1/16 inch.

and with hollow metal manufacturer's written instructions.

between frames and masonry with mortar.

specified below. Shim as necessary.

otherwise unacceptable.

openings) or finish paint.

SECTION 06 16 43 - GYPSUM SHEATHING

A. Gypsum sheathing board on exterior face of exterior stud

B. See section 01 81 22 Acoustical Performance Requirements

in College District's name and registered with manufacturer.

defective materials for 5 years after Substantial completion.

B. National Gypsum Goldbond E2 XP, www.nationalgypsum.com

F. Substitutions: See Section 01 60 00 - Product Requirements.

complying with ASTM C 1177, www.gpgypsum.com.

C. USG Securock Glass-Mat Sheathing, www.usg.com

D. Temple Inland GreenGlass, www.templeinland.com.

E. CertainTeed GlasRoc Sheathing, www.certainteed.com.

complying with ASTM C 1177 (basis of design).

1. 3M" contractor sheathing tape NO.8086-inch by 3M

2. Perm-A-Barrier" wall seam tape by WR Grace &CO.

2. National Gypsum "Goldbond E2 XP."

3. 108JTN" by Royston Laboratories.

4. Temple Inland "GreenGlass."

ASTM C 954.

2.03 ACCESSORIES

3. USG "Securock Glass-Mat Sheathing."

D. Sustainable Design Submittals: Provide the following information:

C. See section 09 21 16 Gypsum Board Assemblies

1.03 ADMINISTRATIVE REQUIREMENTS

manufacturer's recommended limits.

required spacings and deflections.

with minimum 5 years of experience.

1.06 DELIVERY, STORAGE, AND HANDLING

Low Emitting Materials

2. Local/Regional Materials

3. Recycled Materials

1.05 QUALITY ASSURANCE

products.

1.07 WARRANTY

2.02 MATERIALS

PART 2 - PRODUCTS

2.01 MANUFACTURERS

END OF SECTION 08 11 13

1.02 RELATED SECTIONS

PART 1 - GENERAL

A. See Division 01

1.04 SUBMITTALS

1. Non-Fire-Rated Standard Steel Doors:

4. Polyken 610" by Polyken Technologies.

5. Substitutions: See Section 01 60 00 - Product Requirements. B. Joint compound: As recommended by panel manufacturer.

C. Nails, wood framing: 11-gauge galvanized roofing nails with 7/16" head, 1-1/2" min. length for 1/2" panel and 1-3/4" length for 5/8" panel.

D. Screws, metal framing per manufacturers recommendations:

1. Bugle or wafer head, self-tapping, rust-resistant, fine thread for heavy-steel 2. Bugle or wafer head, rust-resistant sharp point, fine thread for light-gauge

metal framing or furring. E. Screws, wood framing: 1. Rust-resistant, bugle or wafer head, coarse thread, 1-1/4" length sharp point for

2. Attachment to Wood Members: ASTM C 514. PART 3 - EXECUTION

3.01 EXAMINATION A. Examine framing to support sheathing board and verify that the surface of any framing or furring member does not vary more than 1/8-inch from the plane of faces of adjacent members.

B. Verify that studs, blocking and supporting materials are in place and ready for sheathing attachment prior to starting work. C. Coordinate the exterior placement of electrical, mechanical and plumbing wall

devices, accessories and access panels, wall signage and other type wall construction with other trades before proceeding with work and during installation.

D. Correct detrimental conditions before proceeding with installation. 3.02 INSTALLATION

1. Sheathing must be installed in accordance with the instructions in Gypsum Association document GA-253 and ASTM C1280. Sheathing can be attached parallel or perpendicular to wood or metal framing. Use appropriate board orientation for specific fire assemblies and shear wall applications within this document, other reference documents or as required by designing authority. The framing width shall not be less than 1-1/2" (38 mm) wide for wood framing and 1-1/4" (32 mm) for steel framing. Framing members shall not vary more than 1/8" (3 mm) from the plane of the faces of adjacent framing.

2. Fasteners should be driven flush with the panel surface (not countersunk) and into the framing system. Locate fasteners at least 3/8" (9 mm) from the ends and edges of the sheathing. Nails or screws, as listed in the fastener chart, may be used to attach Sheathing to framing. When a pneumatic fastening system into metal is used to attach Sheathing, consult with manufacturer for application specifications and shear resistance data. Sheathing is not to be used as a base for nailing or other fastening.

3. Install Sheathing with joints staggered. Sheathing shall be properly flashed at openings and preferably located so that no joint will align with an edge of the opening. Ends and edges of the sheathing should fit tightly. Sheathing panels shall not be less than 7" (178 mm) from the finish grade in fully weather- and water-protected siding systems, and not less than 12" (305 mm) from the ground for properly drained and ventilated crawl spaces.

a. Install sheathing board with correct face out. b. Use maximum lengths possible to minimize number of joints.

4. Provide sheathing board where indicated on drawings.

c. Attach sheathing board to wood and metal framing per manufacturers installation guide. d. Ceilings and Soffits

1. Soffits must be dried in and protected from the elements during and after installation. Install per manufacturers installation recommendations. 2. Apply fiberglass mesh joint tape over joints and embed in setting-type joint compound specified.

3. Skim coat surface with setting-type joint compound for smooth 4. Prime and paint with exterior grade, high quality paint.

A. Protect sheathing panels in place during the construction period against exposure UV rays, to weather, and to other sources of moisture in excess of manufacturer's recommended limits by covering exposed sheathing surfaces with products acceptable to manufacturer for accomplishing these goals.

END OF SECTION

SECTION 09 22 00 - PORTLAND CEMENT PLASTER

PART 1 - GENERAL 1.1 RELATED DOCUMENTS

A. Drawings and general provisions of the Contract, including General and Supplementary Conditions and Division 1 Specification Sections, apply to this Section.

1.2 SUMMARY A. This Section includes the following: 1. Plaster work on concrete or masonry.

2. Integral colored finish coat and field painted finish. B. Related Sections include the following:

1. Division 7 Section "Flexible Sheet Flashing" for flashing windows, door, and other openings.

2. Division 7 Section "Joint Sealants" for acoustical sealants and sealants installed with exterior portland cement plaster (stucco). 3. Division 9 Section "Painting" for field painting of plaster.

1.3 SUBMITTALS A. Product Data: For each type of product indicated.

B. Shop Drawings: 1. Showing details of construction for framing, reinforcement, and trims; including locations where each type material, mix, coating thickness, material sizes and thicknesses, and fastenings will be used.

2. Show locations and installation of control and expansion joints including plans, elevations, sections, details of components, and attachments to other work. 3. Include details of penetration and termination, flashing details, joint locations and configurations, fastening and anchorage details including mechanical

fasteners, and connections to other work. 4. Show locations and extent of weather-barrier (building paper and flashing sheet). Include details for substrate joints and cracks, counterflashing strip,

penetrations, inside and outside corners, terminations, and tie-ins with adjoining construction. a. Include details of interfaces with other materials that form part of weather

b. Include details of mockups.

C. Coordination Drawings:

A. Reference Standards:

1. Comprehensive, completely integrated set of plans, sections, elevations, and details, drawn to scale, of separate trades work, indicating interface support/connections, and relationships between materials, and products, on which the following items are shown and coordinated with each other, based on input from fabricators and installers of the items involved: a. Framing, including backing, blocking, strapping, and similar accessory/subframing materials.

b. Sheathing, including building paper. c. Portland cement plaster, including trim and self-adhering flashing sheet. d. Other materials and products that occur in, on, adjacent to, or contiguous

with above work. 2. At a minimum, indicate the following a. Locations/spacing of plaster trim moldings.

b. Locations/dimensions of self-adhering flashing sheet (underlying trim moldings).

c. Locations/spacings of connections/fastenings of: Plaster trim moldings

d. Sequence of installation of: Plaster trim moldings. D. Samples for Initial Selection: For each type of factory-prepared finish coat

indicated with texture and color. E. Samples for Verification: For each type of factory-prepared finish coat indicated; 12 by 12 inches, and prepared on rigid backing with color selected. 1.4 OUALITY ASSURANCE

1. 2019 Building Standards Administrative Code, Part 1, CBSC. 2. 2019 California Building Code (CBC), Part 2, CBSC (2015 IBC & California 3. 2019 California Electrical Code (CEC), Part 3, CBSC (2014 National Electrical

Code & California Amendments). 4. 2019 California Mechanical Code (CMC), Part 4, CBSC (2015 Uniform Mechanical Code & California Amendments)

6. 2019 California Plumbing Code (CPC), Part 5, CBSC (2015 Uniform Plumbing

Code & California Amendments). 7. 2019 California Energy Code, Part 6, CBSC. 8. 2019 California Historical Building Code, Part 8, CBSC.

12. Title 19 C.C.R., Public Safety, SFM Regulations.

B. Comply with requirements of 2019 CBC Chapter 25.

and inspecting agency acceptable to DSA.

but is not limited to, the following:

time of Substantial Completion.

1.5 DELIVERY, STORAGE, AND HANDLING

construction traffic, and other causes.

Comply with ASTM C 926 requirements.

plaster coat has occurred.

1. Warranty Period: 3 years.

1. Warranty Period: 3 years.

D. Installer's Warranty: 2 years.

PART 2 - PRODUCTS

2. LaHabra Stucco.

2. Fry Reglet Corp.

5. Dietrich Industries, Inc.

Merlex.

Or equal.

6. Or equal.

specified.

b. Gordon, Inc.

d. Or equal.

c. Pittcon Industries.

E. Water Resistive Barrier

2.2 ACCESSORIES

4. Cornerbeads.

9. Stucco Reglet:

11. Flashing System:

B. Thickness: 24 gage.

10. Surface Mounted Reglet:

B. Thickness: 24 gage.

B. Thickness: 24 gage.

13. Termination Screed: J Mold.

with UBC Standard 14-1.

1. Foundation Weep Screed.

3. External-Corner Reinforcement.

at exterior columns.

on plaster face of control joint.

configuration; with expanded flanges.

A. Product: "ST" Stucco Reglet by Fry Reglet.

B. Vent Width: As indicated on Drawings.

A. Product: "SM" Surface Mount Reglet by Fry Reglet.

A. Product: Springlok Flashing System by Fry Reglet.

12. Continuous Soffit Vents: Perforated screeds, with expanded flanges.

A. Product: Model SRS Superior Reveal Screed by Superior Metal Trim.

2. Cornerite: Fabricated.

4. Sto.

C. Weather Resistive Barriers: 10 years.

one of the following manufacturers.

other manufacturers specified.

1. ColorTek by Omega. (Basis of Design)

1. Superior Metal Trim. (Basis of Design)

a. Fry Reglet Corp. (Basis of Design)

3. Alabama Metal Industries Corporation (AMICO).

4. California Expanded Metal Products Company (CEMCO).

building paper complying with UBC Standard 14-1.

with thicknesses and number of plaster coats required.

steel sheet, ASTM A 653 G90 zinc coating.

for environmental conditions for applying finishes.

c. Sheathing, including building paper.

2. Install mockups for each type of finish indicated.

e. Penetrations of portland cement plaster assemblies.

a. Work of this Section.

framing materials.

d. Sealants.

1.6 PROJECT CONDITIONS

B. Exterior Plasterwork:

1.7 WARRANTY

defects.

execution.

13. Americans with Disabilities Act (ADA), Title II or Title III.

9. 2019 California Fire Code, Part 9, CBSC (2015 International Fire Code & California Amendments). 10. 2019 California referenced Standards, Part 12 CBSC. 11. Title 8 C.C.R. Chapter 4, Sub-Ch. 6 – Elevator Safety Orders.

C. Fire-Test-Response Characteristics: For portland cement plaster assemblies with

D. Mockups: Before plastering, install mockups of at least 100 sq. ft. in surface area

to demonstrate aesthetic effects and set quality standards for materials and

1. Comprehensive, completely integrated mockups of separate trades work,

tested in assembly indicated according to ASTM E 119 by an independent testing

indicating interface connections, transitions, relationships between materials

and finishes, and quality of workmanship. Coordinated mockups shall include,

b. Framing, including backing, blocking, strapping, and similar accessory/sub-

f. Other materials and finishes that are within indicated area of coordinated

3. Approved mockups may become part of the completed Work if undisturbed at

4. Use of self-furring lath is subject to satisfactory jobsite demonstration for each

mockups, including barrier/backing/support for above work.

project of lath installation, with approval by Inspector of Record.

E. Preinstallation Conference: Conduct conference at Project site to comply with

requirements in Division 1 Section "Project Management and Coordination."

1. Apply and cure plaster to prevent plaster drying out during curing period. Use

3. Protect plaster coats from freezing for not less than 48 hours after set of

C. Factory-Prepared Finishes: Comply with manufacturer's written recommendations

A. Manufacturer's Warranty: Manufacturer's standard form in which manufacturer

agrees to repair or replace components of cement plaster system that fail in

blistering, peeling, flaking, delaminating, rusting, checking, crazing, fading

B. Special Waterproof Warranty: Submit cement plaster system manufacturer's

warranty certifying that work of this Section has been properly applied in strict

accordance with system manufacturer's recommended procedures, instructions,

and systems current applicable specifications; has been properly integrated into

practices; and will remain resistant to water penetration for specified warranty

building construction in accordance with sound design and building construction

Finish-Coat Plaster: Subject to compliance with requirements, provide products by

requirements, provide either the named product or an equal product by one of the

C. Aluminum Trim and Reveals: Subject to compliance with requirements, provide

either the named product or an equal product by one of the other manufacturers

D. Expanded Lath: Nominal 3.4 lb/yd2 weight, galvanized steel complying with ASTM

a. Over Open Framing and non-Wood-based Sheathing: One layer of D kraft

b. Over Wood-based Sheathing: Two layers of D kraft building paper complying

A. General: Comply with ASTM C 1063 and coordinate depth of trim and accessories

B. Zinc-Coated (Galvanized) Steel Accessories: Fabricated from hot-dip galvanized

a. Small nose cornerbead with expanded flanges; use unless otherwise

stiffening rib; use on columns and for finishing masonry corners.

6. Control Joints: One-piece-type, folded pair of unperforated screeds in M-

8. Two-Piece Expansion Joints: Formed to produce slip-joint and square-edged

reveal that is adjustable from 1/4-to-5/8-inch wide; with perforated flanges.

7. Expansion Joints: Folded pair of unperforated screeds in M-shaped

a. Internal Corners: Double-V, narrow reveal type ("No. 30").

5. Casing Beads: Square-edged style; with expanded flanges.

b. Small nose cornerbead with perforated flanges; use on curved corners.

c. Small nose cornerbead with expanded flanges reinforced by perforated

d. Bull nose cornerbead, radius 3/4 inch minimum, with expanded flanges; use

shaped configuration; with perforated flanges and removable protective tape

B. Zinc-Coated (Galvanized) Steel Accessories: Subject to compliance with

materials within specified warranty period. Failure includes, but is not limited to.

beyond manufacturer's published limits, or chipping as a result of manufacturing

procedures required by climatic conditions, including moist curing, providing

A. Store materials inside under cover and keep them dry and protected against

damage from weather, direct sunlight, surface contamination, corrosion,

coverings, and providing barriers to deflect sunlight and wind.

2. Apply plaster when ambient temperature is greater than 40 deg F.

fire-resistance ratings, provide materials and construction identical to those

15. Drip Screed: Stucco Drip Soffit.

a. Product: SSC Superior Soffit Corner by Superior Metal Trim. A. Aluminum Trim and Reveals:

a. Product: SJB Superior "J" Bead by Superior Metal Trim.

a. Product: SWD Superior Window Drip by Superior Metal Trim.

14. Window /Door Drip: Door Drip Screed.

1. Aluminum shall be extruded alloy 6063 T5, with clear anodized finish. a. Size: As indicated on Drawings.

2.3 MISCELLANEOUS MATERIALS A. Water for Mixing: Potable and free of substances capable of affecting plaster set or of damaging plaster, lath, or accessories. B. Bonding Compound: ASTM C 932.

C. Fasteners for Attaching Metal Lath to Substrates: Complying with ASTM C 1063 and CBC Section 2507. 1. Nails, screws, and staples as specified in CBC. 2. Per CBC 2510.7.1 - Bonding agents shall conform with the provisions of United

States Government Military Specifications MIL-B-19235. 3. Masonry Applications: Galvanized steel fasteners of furring type and length suitable for at least 1/2 inch penetration of the brick or block substrate.

4. Wood Stud Applications: Galvanized steel furring nails and or screws, of type and length suitable for at least a 5/8 inch penetration of the wood stud system. D. Sheathing: Comply with requirements of Division 6 Section "Rough Carpentry". E. Isolation Strip at Exterior Walls: Comply with requirements of Division 7 Section "Flexible Sheet Flashing" for flashing windows, door, and other openings.

F. Thermal Insulation: Comply with requirements of Division 7 Section "Building G. Acoustical Sealant for Exposed and Concealed Joints: Comply with requirements of Division 7 Section "Joint Sealants".

2.4 PLASTER MATERIALS A. Scratch and Brown Coat: 1. Portland Cement: ASTM C 150, Type I or II. 2. Sand Aggregate: ASTM C 897.

3. Lime: ASTM C 206, Type S; or ASTM C 207, Type S. B. Ready-Mixed Finish-Coat Plaster: Mill-mixed portland cement, aggregates, coloring agents, and proprietary ingredients. Finish Texture:

a. Exterior: Sand 30/30 finish 2. Colorant: Match color of field finish coating specified in Division 9 Section 2.5 PLASTER MIXES

A. General: Comply with ASTM C 926 for applications indicated. B. Factory-Prepared Finish-Coat Mixes: For ready-mixed finish-coat plasters,

comply with manufacturer's written instructions.

PART 3 - EXECUTION 3.1 EXAMINATION

A. Examine areas and substrates, with Installer present, and including welded hollow-metal frames, cast-in anchors, and structural framing, for compliance with requirements and other conditions affecting performance.

1. Proceed with installation only after unsatisfactory conditions have been corrected 3.2 PREPARATION

A. Protect adjacent work from soiling, spattering, moisture deterioration, and other

harmful effects caused by plastering. B. Prepare solid-plaster bases that are smooth or that do not have the suction capability required to bond with plaster according to ASTM C 926. A. Fire-Resistance-Rated Assemblies: Install components according to requirements

for design designations from listing organization and publication indicated on B. Thermal Insulation: As specified in Division 7 Section "Building Insulation". C. Sound Attenuation Blankets: Where required, install blankets before installing

lath unless blankets are readily installed after lath has been installed on one side. D. Acoustical Sealant: Where required, seal joints between edges of plasterwork and abutting construction with acoustical sealant. 3.4 INSTALLING METAL LATH AND WEATHER-RESISTANT BARRIER INSTALLATION

A. General: Comply with requirements of Title 24. 1. Use of self-furring lath is subject to satisfactory jobsite demonstration for each project of lath installation, with approval by Inspector of Record. B. Expanded-Metal Lath: Install according to ASTM C 1063.

1. Lath shall be attached to framing members at spacing of not more than 6 inches o.c., 2 inches maximum from longitudinal edges, in accordance with C. Weather-Resistant Barrier: Install 2 layers over sheathing.

3.5 INSTALLING ACCESSORIES A. Install according to ASTM C 1063 and at locations indicated on Drawings. B. Reinforcement for External Corners:

1. Install lath-type external-corner reinforcement at exterior locations. C. Weep screed: Install at foundation plate line on all exterior stud walls per CBC. 1. Minimum 4 inches above earth.

2. Minimum 2 inches above paved areas. D. Control Joints: Install control joints in specific locations approved by Architect for

E. As required to delineate plasterwork into areas (panels) of the following maximum a. Vertical Surfaces: 144 sq. ft.

b. Horizontal and other Nonvertical Surfaces: 100 sq. ft. F. At distances between control joints of not greater than 18 feet o.c.

G. As required to delineate plasterwork into areas (panels) with length-to-width ratios of not greater than 2-1/2:1. H. Where control joints occur in surface of construction directly behind plaster.

I. Where plasterwork areas change dimensions, to delineate rectangular-shaped areas (panels) and to relieve the stress that occurs at the corner formed by the dimension change.

3.6 PLASTER APPLICATION A. General: Comply with ASTM C 926.

1. Do not deviate more than plus or minus 1/4 inch in 10 feet from a true plane in finished plaster surfaces, as measured by a 10-foot straightedge placed on

2. Grout hollow-metal frames, bases, and similar work occurring in plastered areas, with base-coat plaster material, before lathing where necessary. Except where full grouting is indicated or required for fire-resistance rating, grout at least 6 inches at each jamb anchor.

3. Finish plaster flush with metal frames and other built-in metal items or accessories that act as a plaster ground, unless otherwise indicated. Where casing bead does not terminate plaster at metal frame, cut base coat free from metal frame before plaster sets and groove finish coat at junctures with metal.

4. Provide plaster surfaces that are ready to receive field-applied finishes indicated.

B. Three-Coat System: Total minimum thickness of 7/8 inch for lathing base. C. Curing Time: Comply with CBC, or longer as needed to insure compliance with manufacturer's recommendations for quality stucco installation.

 Portland cement plaster: 2. Minimum period moist curing:

a. First Coat: 48 hours. b. Second Coat: 48 hours 3. Minimum interval between coats:

a. First Coat: 48 hours. b. Second Coat: 7 days. D. Bonding Compound: Apply on concrete plaster bases.

E. Plaster Finish Coats: Apply to provide finish to match texture, finish, and color of Architect approved sample. 3.7 ASSEMBLY

A. Exterior Side from framing out: Sheathing. 2. Weather-Resistive Barrier.

4. 3-coat portland cement plaster.

3. Metal Lath.

B. Exterior Side from Masonry/Concrete: 1. 2-coat portland cement plaster. 3.8 CUTTING AND PATCHING A. Cut, patch, replace, and repair plaster as necessary to accommodate other work and to restore cracks, dents, and imperfections. Repair or replace work to eliminate blisters, buckles, crazing and check cracking, dry outs, efflorescence,

sweat outs, and similar defects and where bond to substrate has failed. 3.9 CLEANING AND PROTECTION A. Remove temporary protection and enclosure of other work. Promptly remove plaster from doorframes, windows, and other surfaces not indicated to be plastered. Repair floors, walls, and other surfaces stained, marred, or otherwise

damaged during plastering. END OF SECTION 09 22 00

SECTION 06 10 00 - ROUGH CARPENTRY

PART 1 – GENERAL

1.4 REFERENCES

1.1 RELATED DOCUMENTS A. Drawings and general provisions of the Contract, including General and Supplementary Conditions and Division 1 Specification Sections, apply to this

1.2 SECTION INCLUDES A. Provide all labor, material, equipment and installation to complete framing and sheathing of interior walls and partitions as shown and specified. 1.3 RELATED SECTIONS 06 16 00 – Sheathing

A. The latest editions of specifications and standards referenced herein and published by the following organizations apply to the Work of this Section only to the extent specified by the reference. American Plywood Association - Visual Inspection ASTM American Society for Testing and Materials.

American Wood Preservers Association DFPA Douglas Plywood Association ICC International Code Council PS Public Standards of the U.S. Department of Commerce, Bureau of

Standards CBC STDS 2019 California Building Code Standards WCLIB West Coast Lumber Inspection Bureau WWPA Western Wood Products Association

A. General: Submit the following according to Conditions of Contract and Division 1 Specifications Sections. 1. Product data and current ICC Evaluation Service Reports for attachment

accessories. a. Framing Devices and framing connectors b. Gun nails

.6 QUALITY ASSURANCE A. Codes and Standards: Perform Work in compliance with applicable requirements of governing authorities having jurisdiction.

1. Chapter 23A of the 2019 California Building Code (CBC). 2. ANSI/AF&PA NDS-2012 National Design Specification for Wood Construction. 3. Standard Grading Rules No. 17 of the WCLIB or the Standard Grading Rules of the WWPA. Lumber to have visible grade stamp of an agency certified by the 1.7 COORDINATION

A. Coordinate Work of this Section with Work of other Sections to be attached to, or built into, wood framing.

PART 2 - PRODUCTS 2.11 UMBFR

A. Moisture content: The maximum moisture content of framing lumber shall not exceed 19% just prior to enclosing or covering framing with plywood, gypsum wallboard and/or plaster. To ensure compliance, lumber up to 2 inch thick should be seasoned to a moisture content of 19% or less and be stamped "S-Dry". Lumber over 2 inch thick may be shipped unseasoned and stamped "S-Green".

B. Structural lumber shall be S4S stress-marked Douglas Fir-Larch, manufactured and graded in accordance with WCLIB or WWPA, with minimum grades as follows unless noted otherwise:

 Joists & Rafters 2. 4x & 6x Beams/Headers No. 1 or better 3. Wall Studs 4. Blocking, stripping & misc. No. 2

C. Grade stamp: Provide lumber with each piece factory-marked with grade stamp of inspection agency evidencing compliance with grading rule requirements and identifying grading agency, grade species, moisture content at time of surfacing, and mill.

2.2ACCESSORY MATERIALS A. All Nails shall be common wire nails with dimensions complying with CBC Table 2304.9.1, manufacture shall conform to Fed. Spec, FF-N-1-1 and shall be hotdipped galvanized for exterior locations, high humidity locations and for treated wood; plain finish for other interior locations; size and type to suit application. 1. Box nails and/or "Sinker" nails are not acceptable for Work shown and/or

detailed on the Structural Drawings. B. Bolts, Nuts and Washers conforming to ASTM A-307 shall be hot-dipped galvanized for exterior locations, high humidity locations and treated wood; plain finish for other interior locations.

C. Anchor Bolts: ASTM A 307, non-headed type. D. Lag Screws, Lag Bolts, Pins and Wood Screws; Sized to suit application; hotdipped galvanized for exterior locations, high humidity locations and treated wood; plain finish for other interior locations. Comply with NDS Section 11.1.3.

E. Framing connectors: current ICC Evaluation Services Report, sized and profiled to suit application; hot-dipped galvanized finish, manufactured by Simpson Strong-Tie Company, KC Metals, or approved equal. F. Gun Nails: Use Common Nails or current ICC Evaluation Services Report special

gun nails of the same wire diameter and length as common nails specified on the Drawings. Box nails and/or "Sinker" nails are not acceptable for Work shown on the Structural Drawings.

G. Drypack: Cement/sand drypack composed of one part cement to 3 parts sand. Dry mix first then add with only enough water to hold the mix together. Drypack required under sills as noted on the Drawings.

2.3 WOOD TREATMENT A. Wood Preservative (Pressure Treatment): Chromated zinc chloride or Wolman salts for pressure treated members.

B. Pressure treatment of Douglas Fir-Larch plates, nailers, ledgers and other exposed wood structures, shall be in accordance with the AWPA's standards for the purchase and preservation of treated timber, with a retention of a least 0.35 lb. Wolman salts, 0.75 lb chromated zinc chloride per cubic feet of lumber, or 0.30 lb. per cubic foot of Pentachlorophenol type "C" light solvent. In exposed conditions, the incising of the lumber shall be waived.

1. See Architectural Drawings for treatment of trellis members. C. Wood Preservative (Surface Application): Clear, manufactured by Woodlife, "Res"

PART 3 – EXECUTION

3.1 WOOD TREATMENT A. Shop pressure treat and deliver to the site ready for installation all wood materials requiring pressure impregnated preservatives. B. Treat site-sawn ends and holes in pressure treated lumber.

1. Apply preservative treatment in accordance with manufacturer's instruction.

2. Allow site applied preservative to cure prior to erecting members. 3.2 FRAMING A. Layout, cutting and installation of framing shall be under the continuous

supervision of a full-time carpenter foreman experienced in all phases of framing construction and exposed architectural framing required for the Work of this Section and on the Contract Drawings.

B. Structural members shall not be cut for pipes, conduits, ducts, etc., unless specifically noted or detailed on the Structural Drawings. C. Erect wood framing members true to lines and levels. Do not deviate from true

alignment more than 1/4 inch. Install simple span members with crown up.

D. Space framing members at 16 inches on center unless otherwise noted on the E. Construct members of continuous pieces of longest possible lengths except as

noted on the Drawings. F. Holes in wood for bolts shall be drilled 1/32" to 1/16" larger than the diameter of G. Number of fasteners shall be as indicated on the Drawings or as noted in the ICC

Evaluation Report where number of fasteners are not shown on the Drawings. H. Sheet metal framing connectors shown on the Drawings shall be Simpson connectors as manufactured by the Simpson Strong-Tie Company, Inc.,

Superspeed Connectors as manufactured by the KC Metals company or equal. I. Bolts shall have standard cut washers under heads and/or nuts where in contact with wood. Bolt threads shall not bear on wood.

J. Lag bolts, lag screws and wood screws shall be screwed (not driven) into wood members. In placing lag screws or wood screws in wood, a hole of the same diameter and depth of "the solid shank" shall be bored after which the hole with a diameter equal to the diameter of the screw at the root of the thread shall be continued to a depth equal to the threaded screw length portion. Provide cut

washers under the heads of lag bolts/lag screws where in contact with wood. K. Bolts, lag screws and wood screws shall be re-tightened prior to the application of drywall, plywood, plaster, etc. L. Drive nails perpendicular to grain of wood in lieu of toenailing, where feasible.

M. For conditions not covered on the Drawings, provide penetration into the piece receiving the point of not less than 1/2 the length of the common nail or spike, provided, however, that 16d nails may be used to connect two pieces of two inch (nominal) thickness.

430 S. CARRILLO RD. OJAI, CALIFORNIA 93023 (805) 530-5559

HARTMANNARCHITECTURESTUDIO.COM

CONSULTANTS:

AGENCY APPROVAL

SEALS:

MATILIJA MS CAMPUS -WIDE EXTERIOR PAINTING

OWNER: OJAI UNIFIED SCHOOL DISTRICT 414 EAST OJAI AVENUE OJAI, CA 93023 (805) 640-4300

CONTACT: ADAM DUTTER

EMAIL: adutter@ojaiusd.org

PROJECT ADDRESS: MATILIJA MIDDLE SCHOOL 703 EL PASEO ROAD

OJAI, CA 93023 OJAI USD PROJECT NO.: 2021-1600

ISSUE: MARK DESCRIPTION DATE

PROJECT INFORMATION: PROJECT NUMBER: 2021.010

DRAWN BY: REVIEWED BY:

THE ORIGINAL SIZE OF THIS SHEET IS 36"x24". IF THE CURRENT SIZE IS OTHER THAN 36"x24". THEN ADJUST THE SCALE OF THE DRAWINGS ACCORDINGLY SHEET TITLE:

SPECIFICATIONS

SHEET NUMBER:

PROJECT PHASE:

GENERAL NOTES &

DATE: 05/14/21

PBS

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N. Provide fire blocking in furred spaces, stud spaces and other concealed cavities as
                                                                                             C. Control Expansion, and Soft Joints in Masonry, and Between Masonry and
   indicated and as follows:
                                                                                             D. Lap Joints in Exterior Sheet Metal Work: Type SJ-4.
   1. Fire block furred spaces of walls at each floor level, at ceiling, and at not more than
      96 inches o.c. with 2-inch nominal thickness solid wood blocking or noncombustible
                                                                                            E. Joints Between Exterior Metal Frames and Adjacent Work (except masonry): Type
      materials accurately fitted to close furred spaces.
 3.4 CLEAN-UP
 A. Clean up leftover materials of this Section and legally dispose off site. Dispose of
   pressure- treated wood in an authorized disposal area. Burning of materials on the Site
   is prohibited. Do not bury material and/or wood of any type on the job site.
 END OF SECTION 06 10 00
 SECTION 07 92 00 JOINT SEALANTS
 PART 1 - GENERAL
  1.1 SECTION INCLUDES
A. Sealants and joint backing.
 1.2 RELATED SECTIONS
 1.3 DEFINITIONS
 A. Based on ASTM C 920 Substrates:
  1. M type substrates: Concrete, concrete masonry units, brick, mortar, natural stone.
      The term "masonry" means brick, stone, and concrete masonry work.
   2. G type substrates: Glass and transparent plastic glazing sheets.
   3. A type substrates: Metals, porcelain, glazed tile, and smooth plastics.
   4. 0 type substrates: Wood, unglazed tile; substrates not included under other
      categories
 1.4 SUBMITTALS
 A. See Section 01 33 00 - Submittal Procedures.
 B. Product Data: Provide data indicating sealant chemical characteristics, performance
   criteria, substrate preparation, limitations, and color availability.
 C. Samples: Submit two samples, 6 inch long illustrating sealant colors for selection.
 D. Color selection: Color selection shall be made from manufacturers standard color
   selection. Selection shall be made by Architect.
 E. Manufacturer's Installation Instructions: Indicate special procedures.
 F. Sustainable Design Submittals: Provide the following information

    Low Emitting Materials

 1.5 QUALITY ASSURANCE
 A. Maintain one copy of each referenced document covering installation requirements on
 B. Manufacturer Qualifications: Company specializing in manufacturing the Products
   specified in this section with minimum three years documented experience.
 C. Applicator Qualifications: Company specializing in performing the work of this section
    with minimum three years of experience.
 1.6 FIELD CONDITIONS
 A. Maintain temperature and humidity recommended by the sealant manufacturer during
   and after installation.
 A. See Section 01 77 00 - Closeout Procedures, for additional warranty requirements.
 B. Correct defective work within a five year period after Date of Substantial Completion.
 C. Warranty: Include coverage for installed sealants and accessories which fail to achieve
   airtight seal, exhibit loss of adhesion or cohesion, or do not cure.
PART 2 - PRODUCTS
  2.1 SEALANTS
 A. Sealants and Primers - General: Provide only products having lower volatile organic
   compound (VOC) content than required by South Coast Air Quality Management District
 B. Type SJ-1 - General Purpose Exterior Sealant: Silicone, nonstaining, S, NS, 50, NT.
   1. Applications: Use for:
      a. Control, expansion, and soft joints in masonry.
      b. Joints between concrete and other materials.
      c. Joints between metal frames and other materials.
      d. Other exterior joints for which no other sealant is indicated.
 C. Type SJ-2 - Exterior Expansion Joint Sealer: Multi-component self-leveling
    polyurethane sealant, ASTM C 920, Type M, Grade P, Class 25, Use T.
    1. Size as indicated on drawings, if not detailed, then per manufacturer's
      recommendation to provide weathertight seal when installed.
   2. Provide product recommended by manufacturer for traffic-bearing use.
   3. Applications: Use for:
      a. Exterior horizontal joints in concrete flatwork and extruded curbs.
 D. Type SJ-3 - Silicone Sealant: ASTM C 920, Type S, Grade NS, Class 100/50, Uses NT, A,
   G; single component, solvent curing, non-sagging, non-staining, non-bleeding.
   1. Color: Match adjacent finished surfaces.
    2. Movement Capability: Plus 100 percent, minus 50 percent.
   3. Service Temperature Range: -65 to 180 degrees F.
   4. Shore A Hardness Range: 15 to 35
   5. Applications: Use for:
      a. Glazing at aluminum frames.
 E. Type SJ-4 - Exterior Metal Lap Joint Sealant: One-part non-sag silyl terminated
   polyether sealant: ASTM C-920, Type S. Grade NS, Class 25, Use NT, T, M, G, A, O.
    1. Applications: Use for:
      a. Concealed sealant bead in sheet metal work.
 F. Type SJ-5 - General Purpose Interior Sealant: Acrylic emulsion latex; ASTM C834, Type
   OP, Grade NF single component, paintable.
    1. Color: To be selected by Architect from manufacturer's standard range.
   2. Applications: Use for:
      A. Interior wall and ceiling control joints.
      B. Joints between door and window frames and wall surfaces.
     C. Interior joint sealant between window frames and wall or curb below
      D. Other interior joints for which no other type of sealant is indicated.
 G. Type SJ-6 - BathtublTile Sealant: White silicone; ASTM C920, Uses I, M and A; single
   component, mildew resistant.
   1. Applications: Use for:
      A. Joints between plumbing fixtures and floor and wall surfaces.
      B. Joints between countertops with faucets and wall surfaces and backsplash.
 H. Type SJ-7 - Acoustical Sealant: Non-skinning, sound dampering; single component,
   solvent release curing, non-skinning.
     A. Applications: Use for concealed locations only:
        a. Sealant bead between top stud runner and structure and between bottom
            stud track and floor.
 A. Primer: Non-staining type, recommended by sealant manufacturer to suit application.
 B. Joint Cleaner: Non-corrosive and non-staining type, recommended by sealant
   manufacturer; compatible with joint forming materials.
 C. Joint Backing: Round foam rod compatible with sealant; ASTM 01667, closed cell PVC;
   oversized 30 to 50 percent larger than joint width; Backer Rod manufactured by Backer
   Rod Manufacturing, Inc., Denver, CO.
 D. Bond Breaker: Pressure sensitive tape recommended by sealant manufacturer to suit
   application.
 PART 3 - EXECUTION
 3.1 EXAMINATION
 A. Verify that substrate surfaces are ready to receive work.
 B. Verify that joint backing and release tapes are compatible with sealant.
 3.2 PREPARATION
 A. Remove loose materials and foreign matter that could impair adhesion of sealant.
 B. Clean and prime joints in accordance with manufacturer's instructions.
 C. Perform preparation in accordance with manufacturer's instructions and ASTM C1193.
 D. Protect elements surrounding the work of this section from damage or disfigurement.
 3.3INSTALLATION
 A. Perform work in accordance with sealant manufacturer's requirements for preparation
   of surfaces and material installation instructions.
 B. Perform installation in accordance with ASTM C1193.
C. Perform acoustical sealant application work in accordance with ASTM C919.
D. Install bond breaker where joint backing is not used.
 E. Install sealant free of air pockets, foreign embedded matter, ridges, and sags.
F. Apply sealant within recommended application temperature ranges. Consult
   manufacturer when sealant cannot be applied within these temperature ranges.
```

G. Tool joints concave.

A. Clean adjacent soiled surfaces.

A. Control and Expansion Joints in Paving: Type SJ-2.

A. Protect sealants until cured.

3.4 CLEANING

3.5 PROTECTION

3.6 SCHEDULE

H. Precompressed Foam Sealant: Do not stretch; avoid joints except at corners, ends, and

I. Compression Gaskets: Avoid joints except at ends, corners, and intersections; seal all joints with adhesive; install with face 1/8 to 1/4 inch below adjoining surface.

B. Joints Between Concrete Panels and Between Panels and Adjacent Work: Type SJ-1.

intersections; install with face 1/8 to 1/4 inch below adjoining surface.

Adjacent Work: Type SJ-1.

and Walls: Type SJ-6.

END OF SECTION

Construction: Type SJ- 7.

F. Joints Between Interior Metal Frames and Adjacent Work (except masonry): Type G. Under Exterior Door Thresholds: Type SJ-4. H. Interior Joints for Which No Other Sealant is Indicated: Type SJ-5; None; N/A. I. Control and Expansion Joints in Interior Concrete Slabs and Floors: Type SJ-2. J. Joints Between Plumbing Fixtures and Walls and Floors, and Between Countertops K. In Sound Rated Walls, Between Metal Stud Track/Runner and Adjacent

AGENCY APPROVAL: HARTMANNARCHITECTURESTUDIO.COM (805) 530-5559 CONSULTANTS: OWNER: OJAI UNIFIED SCHOOL DISTRICT 414 EAST OJAI AVENUE OJAI. CA 93023 (805) 640-4300 CONTACT: ADAM DUTTER EMAIL: adutter@ojaiusd.org PROJECT ADDRESS: MATILIJA MIDDLE SCHOOL 703 EL PASEO ROAD OJAI, CA 93023 OJAI USD PROJECT NO.: 2021-1600 ISSUE: MARK PROJECT INFORMATION: PROJECT NUMBER: PROJECT PHASE: DRAWN BY: REVIEWED BY: THE ORIGINAL SIZE OF THIS SHEET IS 36"x24". IF THE CURRENT SIZE IS OTHER THAN 36"x24", THEN ADJUST THE SCALE OF THE DRAWINGS ACCORDING! Y. SHEET TITLE: **GENERAL NOTES & SPECIFICATIONS** SHEET NUMBER:



430 S. CARRILLO RD. OJAI, CALIFORNIA 93023

MATILIJA MS CAMPUS -WIDE EXTERIOR PAINTING

DESCRIPTION

2021.010

PBS

DATE: 05/14/21

CAMPUS BUILDING INFO						
BUILDING NAME	DSA APP. NOS. / A#'s	USE	OCCUPANCY	CONSTRUCTON TYPE	BUILDING AREA	FIRE SPRINKLERS
BUILDING A	9320 / 5155 / 03-107896	CLASSROOMS	E	III-B	4880 +/-	NO
BUILDING B	03-119638	DINING HALL / KITCHEN	А	V-B	2270 +/-	YES
BUILDING C	1926 / 9388 / 51555 / 03-107301	CLASSROOMS / ADMINISTRATION	E	III-B	8610 +/-	NO
BUILDING D	9230 / 51555	CLASSROOM	E	V-B	1110 +/-	NO
BUILDING E	9231 / 03-118467	LOCKER ROOM	Е	V-B	3790 +/-	NO
BUILDING F	1926 / 51555 / 104381 / 03-107301	AUDITORIUM / CLASSROOMS	E	III-B	6230 +/-	PARTIALLY
BUILDING G	37821 / 03-107896	CLASSROOMS	E	V-B	2602 +/-	NO
BUILDING H	26247	CLASSROOMS	Е	V-B	5280 +/-	NO
BUILDING I	28247	CLASSROOMS	Е	V-B	5280 +/-	NO
BUILDING J	28346	CLASSROOMS	Е	V-B	4200 +/-	NO
BUILDING K	3294 / 5346 / 51555 / 12116 / 03-118467	GYMNASIUM	E	V-B	7030 +/-	NO
PAVILION	03-118002	ASSEMBLY	Е	V-B	690 +/-	YES


1. SITE PLAN IS SCHEMATIC TO ONLY SHOW APPROXIMATE BUILDING LOCATIONS. FOR DETAILS OF SITE PAINTING SCOPE, SEE REFERENCED PHOTOS AND KEYNOTES ON

AGENCY APPROVAL:



HARTMANNARCHITECTURESTUDIO.COM 430 S. CARRILLO RD. OJAI, CALIFORNIA 93023 (805) 530-5559

CONSULTANTS:

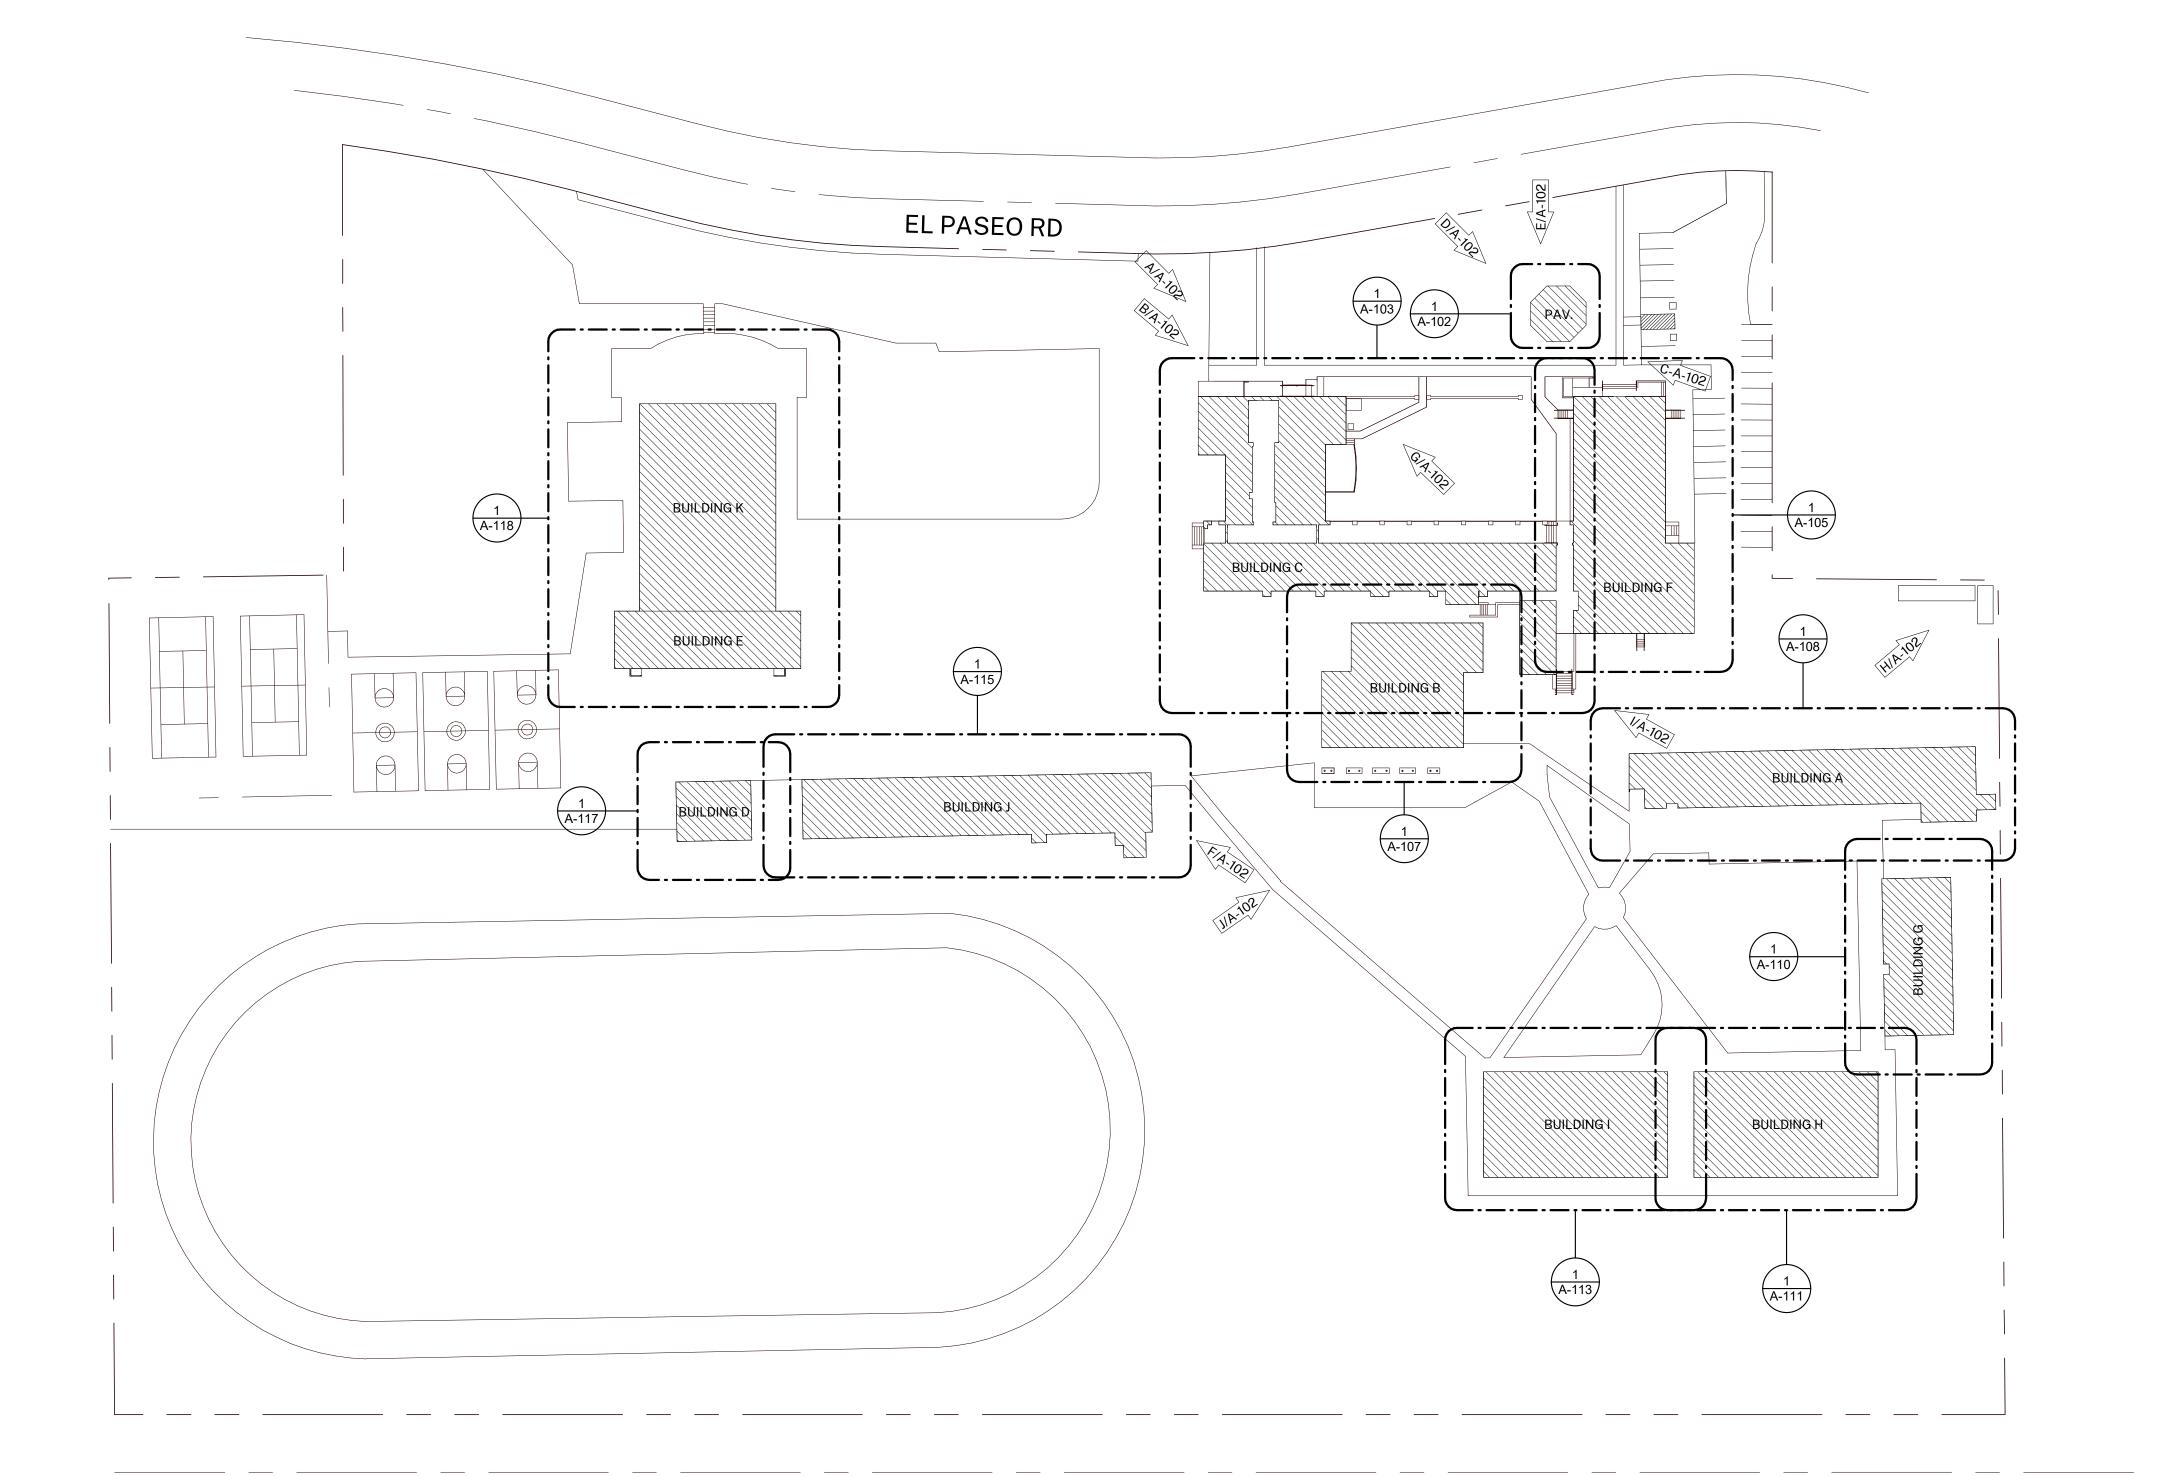

MATILIJA MS CAMPUS -WIDE EXTERIOR PAINTING

OWNER:

PROJECT:

SEALS:

OJAI UNIFIED SCHOOL DISTRICT
414 EAST OJAI AVENUE
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(805) 640-4300
CONTACT: ADAM DUTTER EMAIL: adutter@ojaiusd.org

PROJECT ADDRESS: MATILIJA MIDDLE SCHOOL 703 EL PASEO ROAD OJAI, CA 93023

OJAI USD PROJECT NO.: 2021-1600

ISSUE: MARK DATE DESCRIPTION PROJECT INFORMATION: 2021.010 CD PBS MH

PROJECT NUMBER: PROJECT PHASE: DRAWN BY:

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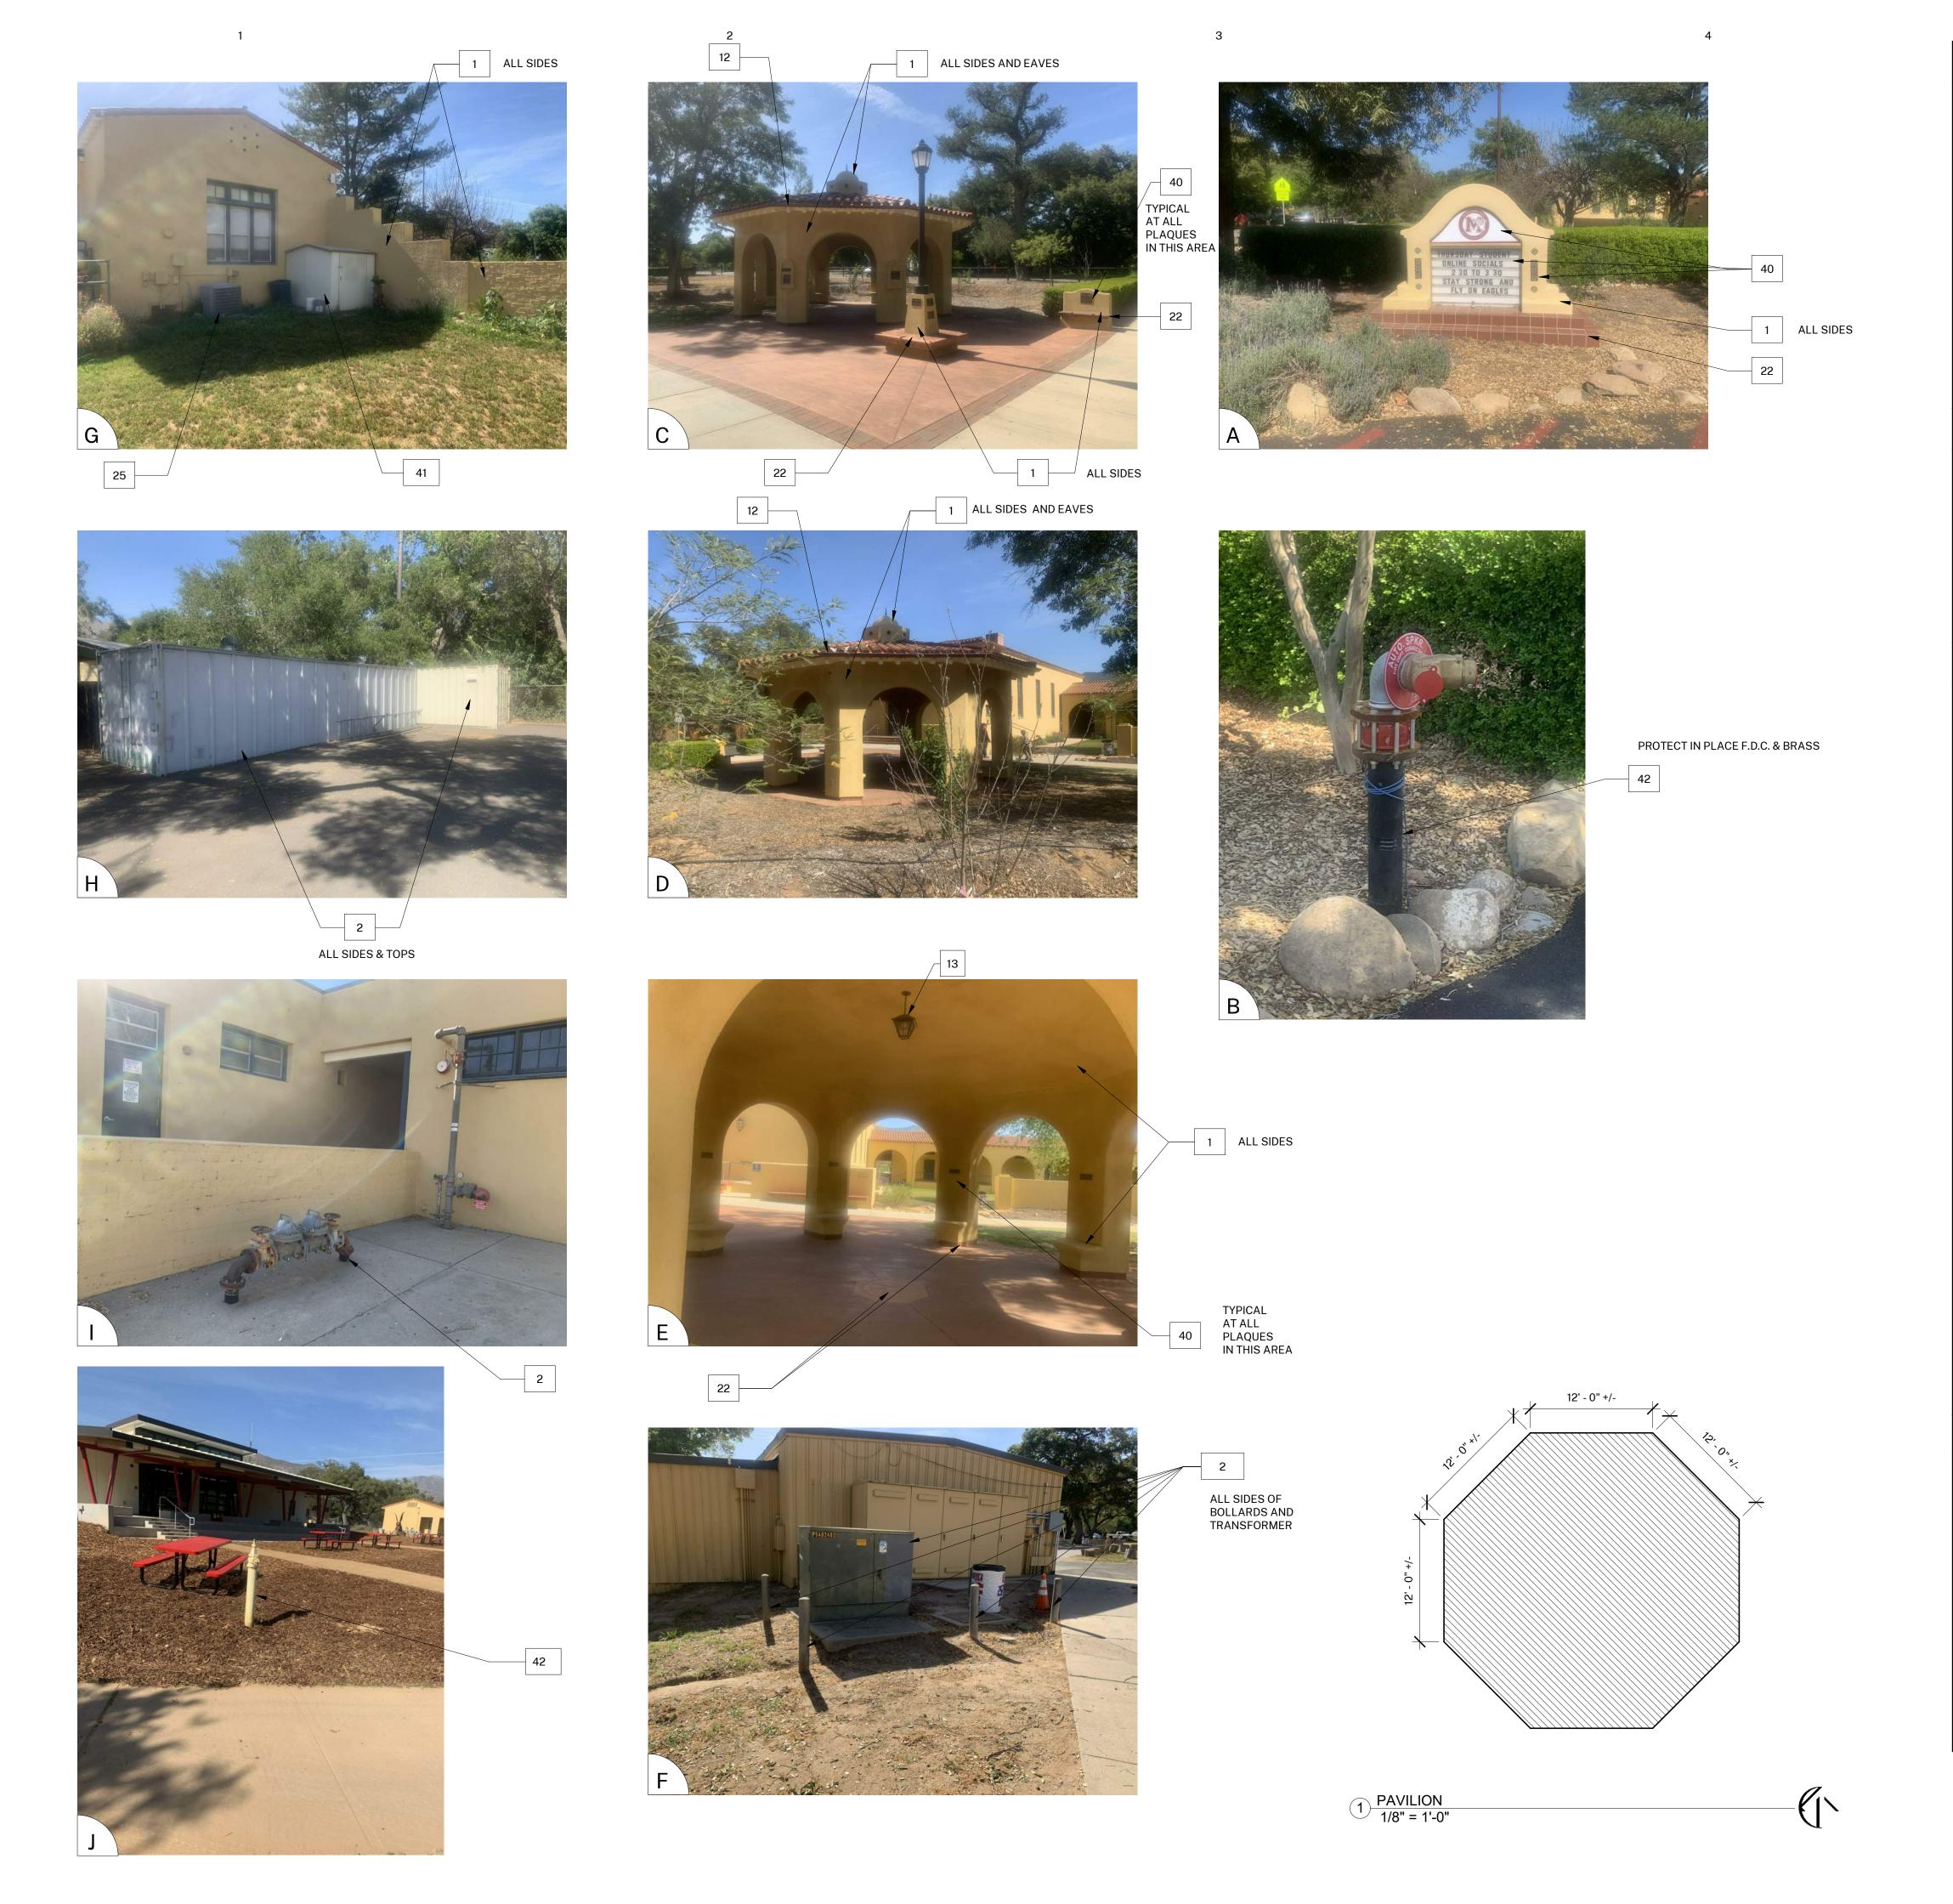
SITE PLAN

SHEET NUMBER:

DATE: 05/14/21

A-101

1" = 50'-0"



- 1. BUILDING PLANS ARE SCHEMATIC TO ONLY SHOW APPROXIMATE OVERALL BUILDING DIMENSIONS, DOOR QUANTITIES AND APPROXIMATE DOOR LOCATIONS AND ARE PROVIDED AS A CONVENIENCE FOR BIDDING. FIELD VERIFY CONDITIONS PRIOR TO BID. REFER TO SHEET KEYNOTES, PHOTOS, AND LEGENDS FOR ADDITIONAL INFORMATION.
- 2. ALL EXISTING PAINTED EXTERIOR WALLS OF BUILDING, PAINTED ROOF EAVES, OVERHANGS, CONDUITS, CABINTES, LOUVERS, VENTS, DUCTS AND ROOF EAVES AND GABLES INCLUDED IN THE SCOPE OF WORK ARE TO BE REPAINTED COLORS AS LISTED AND AS DETAILED IN THESE DRAWINGS AND SPECIFICATIONS UNLESS NOTED OTHERWISE.
- 3. ALL EXISTING UNPAINTED EXTERIOR SURFACES ARE TO REMAIN UNPAINTED UNLESS NOTED OTHERWISE. PROTECT IN PLACE ALL UNPAINTED SURFACES. 4. CAREFULLY PRUNE SHRUBS AND PLANTS AND REMOVE WEEDS AND PLANTINGS AT BASE OF WALL TO BARE EARTH TO ALLOW FOR COMPLETE WALL COVERAGE. 5. EXISTING PAINTED DOORS, DOOR FRAMES, DOOR TRIM, WINDOW FRAMES, MULLIONS, AND SEALANTS TO REMAIN UNLESS NOTED OTHERWISE. DO NOT PAINT
- ALUMINUM WINDOWS. PROTECT IN PLACE. 6. TYPICAL WORK AT EXISTING SIGNS TO REMAIN: REMOVE SIGN, PAINT BEHIND SIGN, CLEAN SIGN, REINSTALL SIGN UNLESS NOTED OTHERWISE.

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CONSULTANTS:

AGENCY APPROVAL:

COLOR LEGEND AND NOTES

COLOR 1 - SWISS COFFEE **DUNN EDWARDS DEW341** COLOR 2 - ROYAL GREY DUNN EDWARDS, MATCH EXISTING COLOR 3 - WILD CURRANT SHERWIN WILLIAMS SW7583

COLOR 4 - MATCH TERRA COTTA ROOF TILE, FIELD VERIFY

1. PHOTOS WITH KEYNOTES ARE CREATED ELECTRONICALLY AND ARE INTENDED TO BE VIEWED IN COLOR TO SEE LOCATIONS OF COLORS ON THE BUILDINGS. CONTRACTOR SHALL FIELD VERIFY ACTUAL LOCATIONS AND DIMENSIONS OF COLORS PRIOR TO BID.

SHEET KEYNOTES

NOTE: NOT ALL KEYNOTES **USED ON EVERY SHEET**

1. PAINT COLOR 1

2. PAINT COLOR 2

3. PAINT COLOR 3 4. PAINT COLOR 4

5. REMOVE / PAINT WALL / REINSTALL: EXISTING SIGN

6. PROTECT IN PLACE: EXISTING SECURITY CAMERA TYPICAL AT ALL LOCATIONS

7. PREP / PAINT: UTILITY CONDUITS, CABINETS & HVAC TO MATCH WALL BEYOND. 8. PREP / PAINT: EXISTING SIGNAGE IN PLACE

9. PREP / PAINT: EXISTING LOUVERS AND/OR VENTS, TYPICAL

10. REMOVE / PAINT WALL / REINSTALL: LIGHT FIXTURE ESCUTCHEON PLATE OR LIGHT FIXTURE ITSELF TO WALL SURFACE BEHIND. TYPICAL AT ALL LIGHT FIXTURES U.N.O. 11. PREP / PAINT: EXISTING GUTTERS AND DOWNSPOUTS. PAINT COLOR 4 12. PROTECT IN PLACE: EXISTING GUTTERS AND LEADERHEADS

13. PROTECT IN PLACE: EXISTING LIGHT FIXTURE / SPEAKER / FIRE ALARM DEVICE 14. PREP / PAINT: EXISTING HVAC DUCTWORK WHERE ALREADY PAINTED. 15. PROTECT IN PLACE: EXISTING MURAL. PAINT WALLS AROUND MURAL TO MATCH EXISTING BUILDING COLOR SCHEME. TOUCH-UP/REPAINT MURALS WHERE PAINTED

TO MATCH EXISTING. 16. PROTECT IN PLACE: EXISTING DRINKING FOUNTAIN

17. PREP / PAINT: EXISTING PAINTED DRINKING FOUNTAIN CANE DETECTION RAILS 18. PREP/STAIN/SEAL: EXISTING WOOD DISPLAY CASES, FIELD VERIFY STAIN COLOR +

SEALER SHEEN 19. REMOVE / DISCARD: EXISTING SIGN

20. REMOVE / SALVAGE TO ARCHITECT: EXISTING SIGN 21. REMOVE ACCESSIBLE SIGN / PAINT WALL / REINSTALL

22. PROTECT IN PLACE: EXISTING CONCRETE, CMU OR TILE

23. PREP / PAINT: EXISTING CONCRETE / CMU WALL 24. PREP / PAINT: EXISTING METAL FENCE & GATE

25. PROTECT IN PLACE: EXISTING MECHANICAL EQUIPMENT

26. PREP / PAINT: EXISTING ROLL-UP DOOR

27. PREP / PAINT: EXISTING STORAGE CONTAINER, ALL SIDES AND TOP, PAINT COLOR 2 28. PREP / PAINT: EXISTING WOOD BENCH / SEATS AND SLEEERS.

29. PREP / PAINT: EXISTING CMU WALLS. PAINT INSIDE AND OUTSIDE OF ENCLOSURE AND DOORS.

30. PREP / PRIME / PAINT: PAVILION PLASTERED SURFACES & EAVES 31. PREP / PAINT: EXISTING DOOR OR WINDOW METAL SECURITY GRATING 32. PATCH / REPAIR / PREP / PRIME / PAINT: EXISTING PLASTER. SEE 1&3/A-201

33. PREP / PAINT: METAL PARAPET WALL CAP 34. PREP / PAINT: PLASTERED ROOF TOP EQUIPMENT SCREEN WALLS INSIDE AND OUT 35. CONTINUE WAINSCOAT AROUND ENTIRE PERIMETER OF BUILDING INCLUDING RECESSED DOOR AND WINDOW RETURNS

39. REMOVE AND REPLACE EXISTING EQUIPMENT CLOSET DOOR, FRAME, HARDWARE

36. PREP / PAINT: EXISTING RAIL 37. REMOVE / REPLACE CEILING LIGHTS, OWNER PROVIDED 38. EXISTING MURAL, PAINT OVER MURAL

AND LOUVER, PAINT COLOR 2 40. PROTECT IN PLACE: EXISTING SIGN/PLAQUE


41. REMOVE EXISTING STRUCTURE 42. PREP/PAINT SAFETY YELLOW

43. REMOVE/PAINT/REINSTALL EQUIPMENT


44. REPAIR/REPLACE/PAINT: DAMAGED WOOD EAVE 45. PREP/PAINT: EXISTING WINDOW FRAMES & MUNTINS

46. REMOVE/DISCARD AS NOTED 47. PROTECT IN PLACE AS NOTED

SYMBOL LEGEND

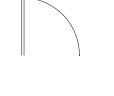

EXISTING DOOR: FIELD VERIFY SIZES AND CONDITIONS, PAINT DOOR WARNING STRIPING ON LANDING AT ALL OUTSWINGING EXTERIOR DOORS U.N.O.

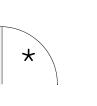

EXISTING RESTROOM DOOR: FIELD VERIFY SIZES AND CONDITIONS, PAINT DOOR WARNING STRIPING ON LANDING AT ALL OUTSWINGING EXTERIOR DOORS U.N.O. PAINT EXTERIOR DOOR FACE, FRAME EXTERIOR AND INTERIOR JAMB TO FACE OF DOOR STOP. APPLY RESTROOM IDENTIFICATION DOOR SIGNAGE ON EXTERIOR AND INTERIOR WHERE DOORS ARE PROPPED OPEN. SEE



EXISTING CLASSROOM DOOR, PAINT WARNING STRIPING ON LANDING AT ALL OUTSWINGING EXTERIOR DOORS U.N.O., REMOVE AND REPLACE TRANSOM DOOR LOUVERS AND INFILL WITH 2x LUMBER, INSULTATION, AND GYPSUM SHEATHING, PAINT ENTIRE DOOR AND FRAME COLOR 2

MATILIJA MS CAMPUS -

WIDE EXTERIOR PAINTING

OWNER:

OJAI UNIFIED SCHOOL DISTRICT 414 EAST OJAI AVENUE OJAI, CA 93023 (805) 640-4300 CONTACT: ADAM DUTTER EMAIL: adutter@ojaiusd.org

PROJECT ADDRESS:

MATILIJA MIDDLE SCHOOL 703 EL PASEO ROAD OJAI, CA 93023

MARK DATE

OJAI USD PROJECT NO.: 2021-1600

PROJECT	INFORMATION	\ :	
PROJECT NUMBER:			2021.010
PROJECT PHASE:			CD
DRAWN BY:			PBS
REVIEWED BY:			MH

DESCRIPTION

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SITE PLAN

SHEET NUMBER:

A-102

DATE: 05/14/21



- 1. BUILDING PLANS ARE SCHEMATIC TO ONLY SHOW APPROXIMATE OVERALL BUILDING DIMENSIONS, DOOR QUANTITIES AND APPROXIMATE DOOR LOCATIONS AND ARE PROVIDED AS A CONVENIENCE FOR BIDDING. FIELD VERIFY CONDITIONS PRIOR TO BID. REFER TO SHEET KEYNOTES, PHOTOS, AND LEGENDS FOR ADDITIONAL INFORMATION.
- 2. ALL EXISTING PAINTED EXTERIOR WALLS OF BUILDING, PAINTED ROOF EAVES, OVERHANGS, CONDUITS, CABINTES, LOUVERS, VENTS, DUCTS AND ROOF EAVES AND GABLES INCLUDED IN THE SCOPE OF WORK ARE TO BE REPAINTED COLORS AS LISTED AND AS DETAILED IN THESE DRAWINGS AND SPECIFICATIONS UNLESS NOTED OTHERWISE.
- 3. ALL EXISTING UNPAINTED EXTERIOR SURFACES ARE TO REMAIN UNPAINTED UNLESS NOTED OTHERWISE. PROTECT IN PLACE ALL UNPAINTED SURFACES. 4. CAREFULLY PRUNE SHRUBS AND PLANTS AND REMOVE WEEDS AND PLANTINGS AT BASE OF WALL TO BARE EARTH TO ALLOW FOR COMPLETE WALL COVERAGE. 5. EXISTING PAINTED DOORS, DOOR FRAMES, DOOR TRIM, WINDOW FRAMES, MULLIONS, AND SEALANTS TO REMAIN UNLESS NOTED OTHERWISE. DO NOT PAINT
- 6. TYPICAL WORK AT EXISTING SIGNS TO REMAIN: REMOVE SIGN, PAINT BEHIND SIGN,

NOTE: NOT ALL KEYNOTES **USED ON EVERY SHEET**

7. PREP / PAINT: UTILITY CONDUITS. CABINETS & HVAC TO MATCH WALL BEYOND.

12. PROTECT IN PLACE: EXISTING GUTTERS AND LEADERHEADS 13. PROTECT IN PLACE: EXISTING LIGHT FIXTURE / SPEAKER / FIRE ALARM DEVICE 14. PREP / PAINT: EXISTING HVAC DUCTWORK WHERE ALREADY PAINTED.

15. PROTECT IN PLACE: EXISTING MURAL. PAINT WALLS AROUND MURAL TO MATCH EXISTING BUILDING COLOR SCHEME. TOUCH-UP/REPAINT MURALS WHERE PAINTED TO MATCH EXISTING.

17. PREP / PAINT: EXISTING PAINTED DRINKING FOUNTAIN CANE DETECTION RAILS 18. PREP/STAIN/SEAL: EXISTING WOOD DISPLAY CASES, FIELD VERIFY STAIN COLOR +


27. PREP / PAINT: EXISTING STORAGE CONTAINER, ALL SIDES AND TOP, PAINT COLOR 2 28. PREP / PAINT: EXISTING WOOD BENCH / SEATS AND SLEEERS.

AND DOORS. 30. PREP / PRIME / PAINT: PAVILION PLASTERED SURFACES & EAVES

33. PREP / PAINT: METAL PARAPET WALL CAP 34. PREP / PAINT: PLASTERED ROOF TOP EQUIPMENT SCREEN WALLS INSIDE AND OUT 35. CONTINUE WAINSCOAT AROUND ENTIRE PERIMETER OF BUILDING INCLUDING

39. REMOVE AND REPLACE EXISTING EQUIPMENT CLOSET DOOR, FRAME, HARDWARE AND LOUVER, PAINT COLOR 2 40. PROTECT IN PLACE: EXISTING SIGN/PLAQUE


OJAI, CA 93023

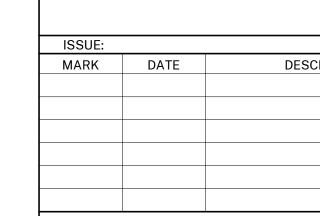

PROJECT PHASE: DRAWN BY: REVIEWED BY:

A-103

DATE: 05/14/21

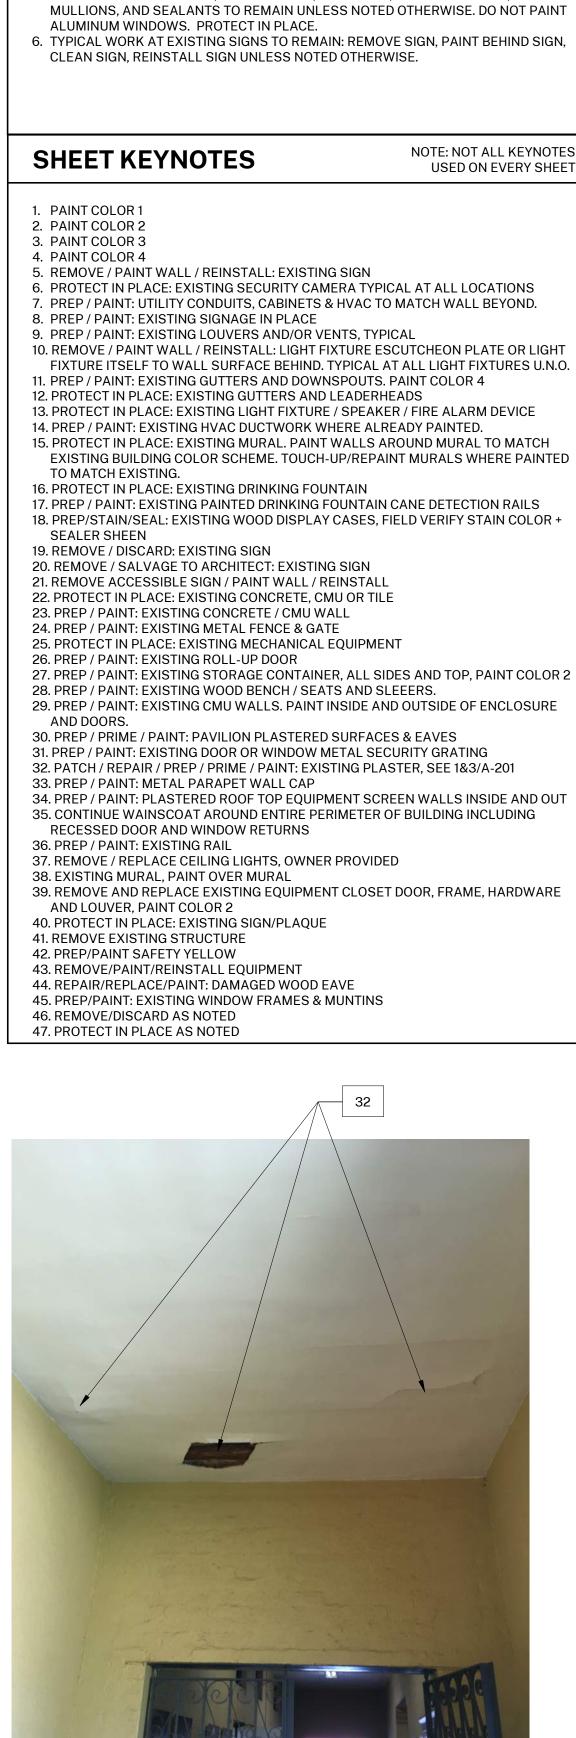

HARTMANNARCHITECTURESTUDIO.COM 430 S. CARRILLO RD. OJAI, CALIFORNIA 93023 (805) 530-5559

CONSULTANTS:

AGENCY APPROVAL:

SEALS:

MATILIJA MS CAMPUS -WIDE EXTERIOR PAINTING

OJAI UNIFIED SCHOOL DISTRICT

414 EAST OJAI AVENUE OJAI, CA 93023 (805) 640-4300 **CONTACT: ADAM DUTTER** EMAIL: adutter@ojaiusd.org

PROJECT ADDRESS: MATILIJA MIDDLE SCHOOL 703 EL PASEO ROAD

OJAI USD PROJECT NO.: 2021-1600

DESCRIPTION


2021.010


PROJECT INFORMATION: PROJECT NUMBER:

THE ORIGINAL SIZE OF THIS SHEET IS 36"x24". IF THE CURRENT SIZE IS OTHER THAN 36"x24", THEN ADJUST THE SCALE OF THE DRAWINGS ACCORDING! Y. SHEET TITLE:

BUILDING C

SHEET NUMBER:

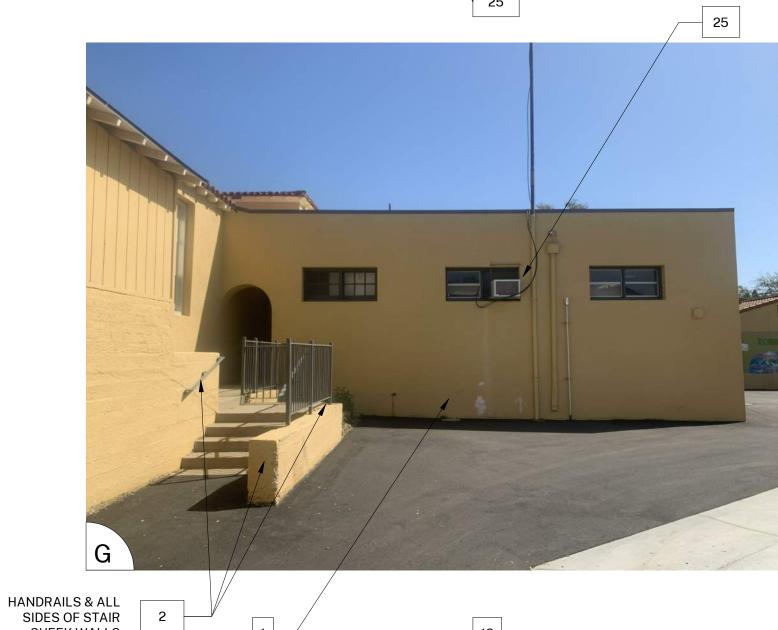

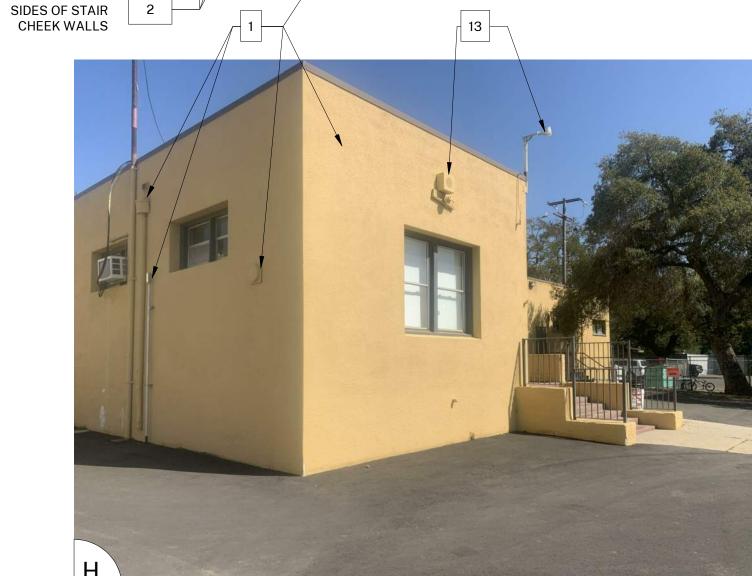


COLOR LEGEND AND NOTES

DUNN EDWARDS DEW341 COLOR 1 - SWISS COFFEE DUNN EDWARDS, MATCH EXISTING COLOR 2 - ROYAL GREY WILD CURRANT SHERWIN WILLIAMS SW7583

- MATCH TERRA COTTA ROOF TILE, FIELD VERIFY

1. PHOTOS WITH KEYNOTES ARE CREATED ELECTRONICALLY AND ARE INTENDED TO BE VIEWED IN COLOR TO SEE LOCATIONS OF COLORS ON THE BUILDINGS. CONTRACTOR SHALL FIELD VERIFY ACTUAL LOCATIONS AND DIMENSIONS OF COLORS PRIOR TO BID.

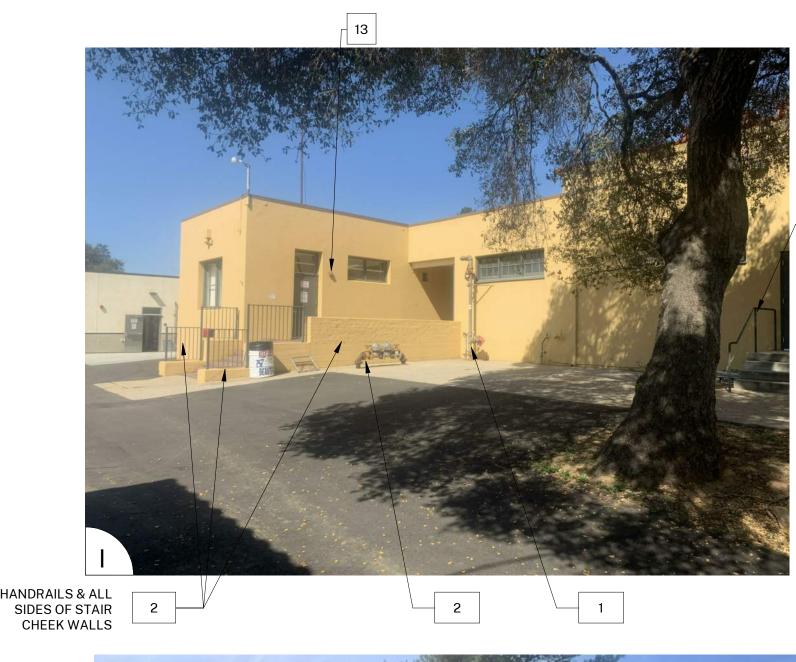

PAINT (2)

NOT

TYP AT

CONC


BEAMS IN

CORRIDOR

HANDRAILS

PICTURED



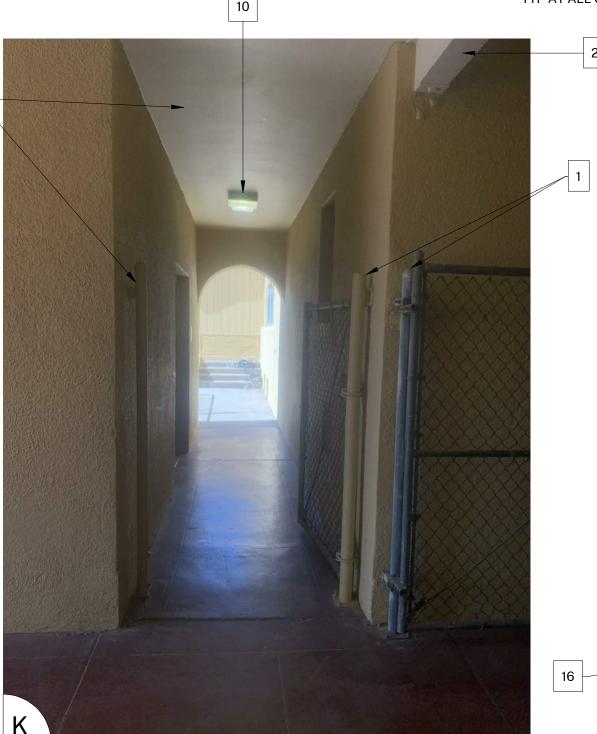



GENERAL NOTE: REMOVAL OF PHOTOGRAPHIC ARTWORK BY

GENERAL NOTES

1. BUILDING PLANS ARE SCHEMATIC TO ONLY SHOW APPROXIMATE OVERALL BUILDING DIMENSIONS, DOOR QUANTITIES AND APPROXIMATE DOOR LOCATIONS AND ARE PROVIDED AS A CONVENIENCE FOR BIDDING. FIELD VERIFY CONDITIONS PRIOR TO BID. REFER TO SHEET KEYNOTES, PHOTOS, AND LEGENDS FOR ADDITIONAL INFORMATION.

2. ALL EXISTING PAINTED EXTERIOR WALLS OF BUILDING, PAINTED ROOF EAVES, OVERHANGS, CONDUITS, CABINTES, LOUVERS, VENTS, DUCTS AND ROOF EAVES AND GABLES INCLUDED IN THE SCOPE OF WORK ARE TO BE REPAINTED COLORS AS LISTED AND AS DETAILED IN THESE DRAWINGS AND SPECIFICATIONS UNLESS NOTED OTHERWISE.

3. ALL EXISTING UNPAINTED EXTERIOR SURFACES ARE TO REMAIN UNPAINTED UNLESS NOTED OTHERWISE. PROTECT IN PLACE ALL UNPAINTED SURFACES. 4. CAREFULLY PRUNE SHRUBS AND PLANTS AND REMOVE WEEDS AND PLANTINGS AT BASE OF WALL TO BARE EARTH TO ALLOW FOR COMPLETE WALL COVERAGE. 5. EXISTING PAINTED DOORS, DOOR FRAMES, DOOR TRIM, WINDOW FRAMES, MULLIONS, AND SEALANTS TO REMAIN UNLESS NOTED OTHERWISE. DO NOT PAINT ALUMINUM WINDOWS. PROTECT IN PLACE.

6. TYPICAL WORK AT EXISTING SIGNS TO REMAIN: REMOVE SIGN, PAINT BEHIND SIGN, CLEAN SIGN, REINSTALL SIGN UNLESS NOTED OTHERWISE.

SHEET KEYNOTES

NOTE: NOT ALL KEYNOTES **USED ON EVERY SHEET**

1. PAINT COLOR 1 2. PAINT COLOR 2 3. PAINT COLOR 3

4. PAINT COLOR 4 5. REMOVE / PAINT WALL / REINSTALL: EXISTING SIGN

6. PROTECT IN PLACE: EXISTING SECURITY CAMERA TYPICAL AT ALL LOCATIONS 7. PREP / PAINT: UTILITY CONDUITS, CABINETS & HVAC TO MATCH WALL BEYOND.

9. PREP / PAINT: EXISTING LOUVERS AND/OR VENTS, TYPICAL 10. REMOVE / PAINT WALL / REINSTALL: LIGHT FIXTURE ESCUTCHEON PLATE OR LIGHT

8. PREP / PAINT: EXISTING SIGNAGE IN PLACE

FIXTURE ITSELF TO WALL SURFACE BEHIND. TYPICAL AT ALL LIGHT FIXTURES U.N.O. 11. PREP / PAINT: EXISTING GUTTERS AND DOWNSPOUTS. PAINT COLOR 4 12. PROTECT IN PLACE: EXISTING GUTTERS AND LEADERHEADS

13. PROTECT IN PLACE: EXISTING LIGHT FIXTURE / SPEAKER / FIRE ALARM DEVICE 14. PREP / PAINT: EXISTING HVAC DUCTWORK WHERE ALREADY PAINTED. 15. PROTECT IN PLACE: EXISTING MURAL. PAINT WALLS AROUND MURAL TO MATCH

EXISTING BUILDING COLOR SCHEME. TOUCH-UP/REPAINT MURALS WHERE PAINTED TO MATCH EXISTING. 16. PROTECT IN PLACE: EXISTING DRINKING FOUNTAIN

17. PREP / PAINT: EXISTING PAINTED DRINKING FOUNTAIN CANE DETECTION RAILS 18. PREP/STAIN/SEAL: EXISTING WOOD DISPLAY CASES, FIELD VERIFY STAIN COLOR +

SEALER SHEEN 19. REMOVE / DISCARD: EXISTING SIGN 20. REMOVE / SALVAGE TO ARCHITECT: EXISTING SIGN

21. REMOVE ACCESSIBLE SIGN / PAINT WALL / REINSTALL 22. PROTECT IN PLACE: EXISTING CONCRETE, CMU OR TILE 23. PREP / PAINT: EXISTING CONCRETE / CMU WALL

24. PREP / PAINT: EXISTING METAL FENCE & GATE

25. PROTECT IN PLACE: EXISTING MECHANICAL EQUIPMENT 26. PREP / PAINT: EXISTING ROLL-UP DOOR

27. PREP / PAINT: EXISTING STORAGE CONTAINER, ALL SIDES AND TOP, PAINT COLOR 2 28. PREP / PAINT: EXISTING WOOD BENCH / SEATS AND SLEEERS.

29. PREP / PAINT: EXISTING CMU WALLS. PAINT INSIDE AND OUTSIDE OF ENCLOSURE 30. PREP / PRIME / PAINT: PAVILION PLASTERED SURFACES & EAVES

31. PREP / PAINT: EXISTING DOOR OR WINDOW METAL SECURITY GRATING 32. PATCH / REPAIR / PREP / PRIME / PAINT: EXISTING PLASTER, SEE 1&3/A-201

33. PREP / PAINT: METAL PARAPET WALL CAP 34. PREP / PAINT: PLASTERED ROOF TOP EQUIPMENT SCREEN WALLS INSIDE AND OUT 35. CONTINUE WAINSCOAT AROUND ENTIRE PERIMETER OF BUILDING INCLUDING RECESSED DOOR AND WINDOW RETURNS

36. PREP / PAINT: EXISTING RAIL 37. REMOVE / REPLACE CEILING LIGHTS, OWNER PROVIDED

38. EXISTING MURAL, PAINT OVER MURAL 39. REMOVE AND REPLACE EXISTING EQUIPMENT CLOSET DOOR, FRAME, HARDWARE AND LOUVER, PAINT COLOR 2


40. PROTECT IN PLACE: EXISTING SIGN/PLAQUE 41. REMOVE EXISTING STRUCTURE

42. PREP/PAINT SAFETY YELLOW 43. REMOVE/PAINT/REINSTALL EQUIPMENT

44. REPAIR/REPLACE/PAINT: DAMAGED WOOD EAVE 45. PREP/PAINT: EXISTING WINDOW FRAMES & MUNTINS

46. REMOVE/DISCARD AS NOTED

47. PROTECT IN PLACE AS NOTED

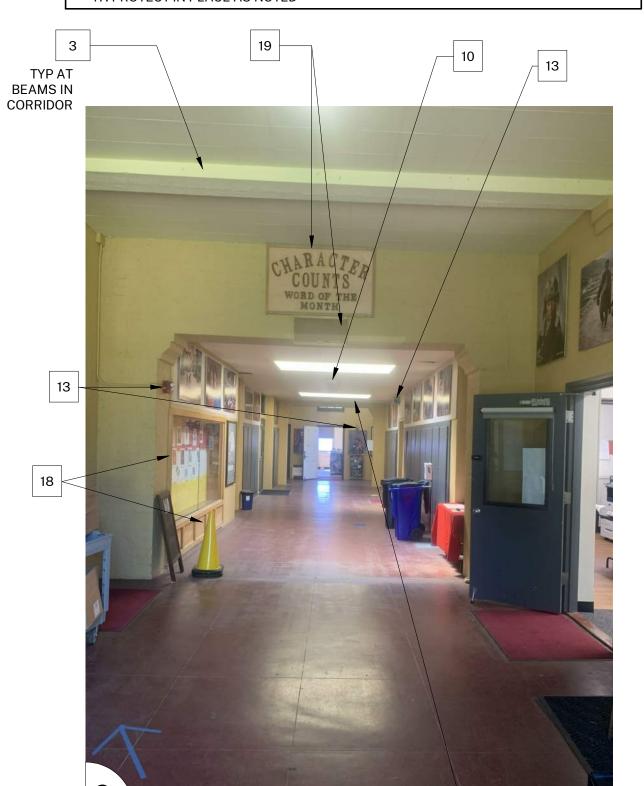




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CONSULTANTS:

AGENCY APPROVAL:

SEALS:

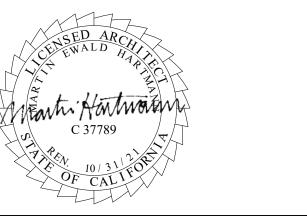

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OWNER:

OJAI UNIFIED SCHOOL DISTRICT 414 EAST OJAI AVENUE OJAI, CA 93023 (805) 640-4300 CONTACT: ADAM DUTTER EMAIL: adutter@ojaiusd.org

PROJECT ADDRESS:

MATILIJA MIDDLE SCHOOL 703 EL PASEO ROAD OJAI, CA 93023

OJAI USD PROJECT NO.: 2021-1600

ISSUE: MARK DATE DESCRIPTION PROJECT INFORMATION:

2021.010

PROJECT NUMBER: PROJECT PHASE: DRAWN BY:

REVIEWED BY:

THE ORIGINAL SIZE OF THIS SHEET IS 36"x24". IF THE CURRENT SIZE IS OTHER THAN 36"x24", THEN ADJUST THE SCALE OF THE DRAWINGS ACCORDINGLY. SHEET TITLE:

BUILDING C

SHEET NUMBER:

A-104


COLOR 1

REPAIR LOOSE, DAMAGED, OR BROKEN


CEILING TILE, PAINT ENTIRE CEILING


32 AT SKYLIGHT WELL

DATE: 05/14/21

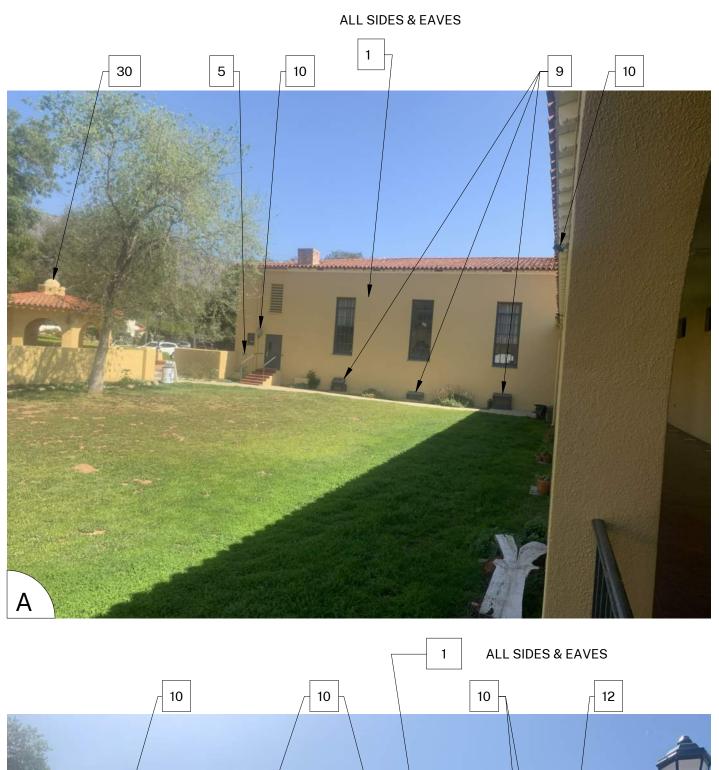



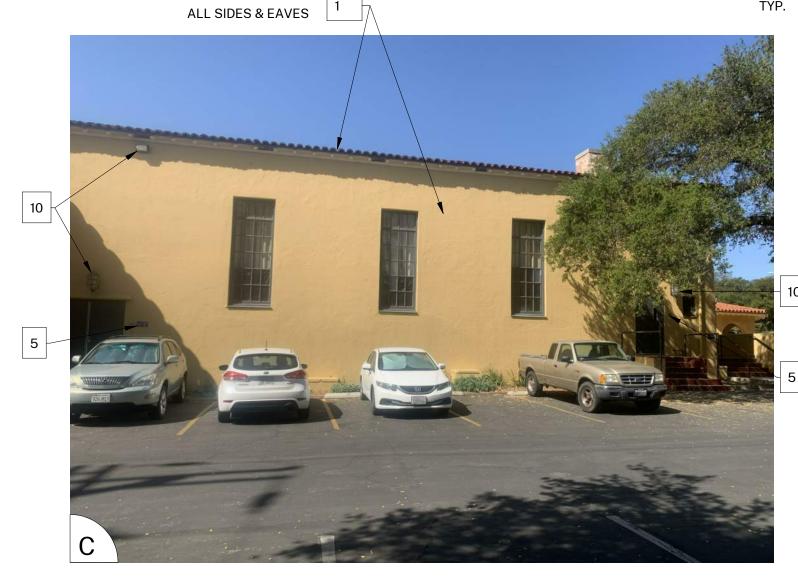

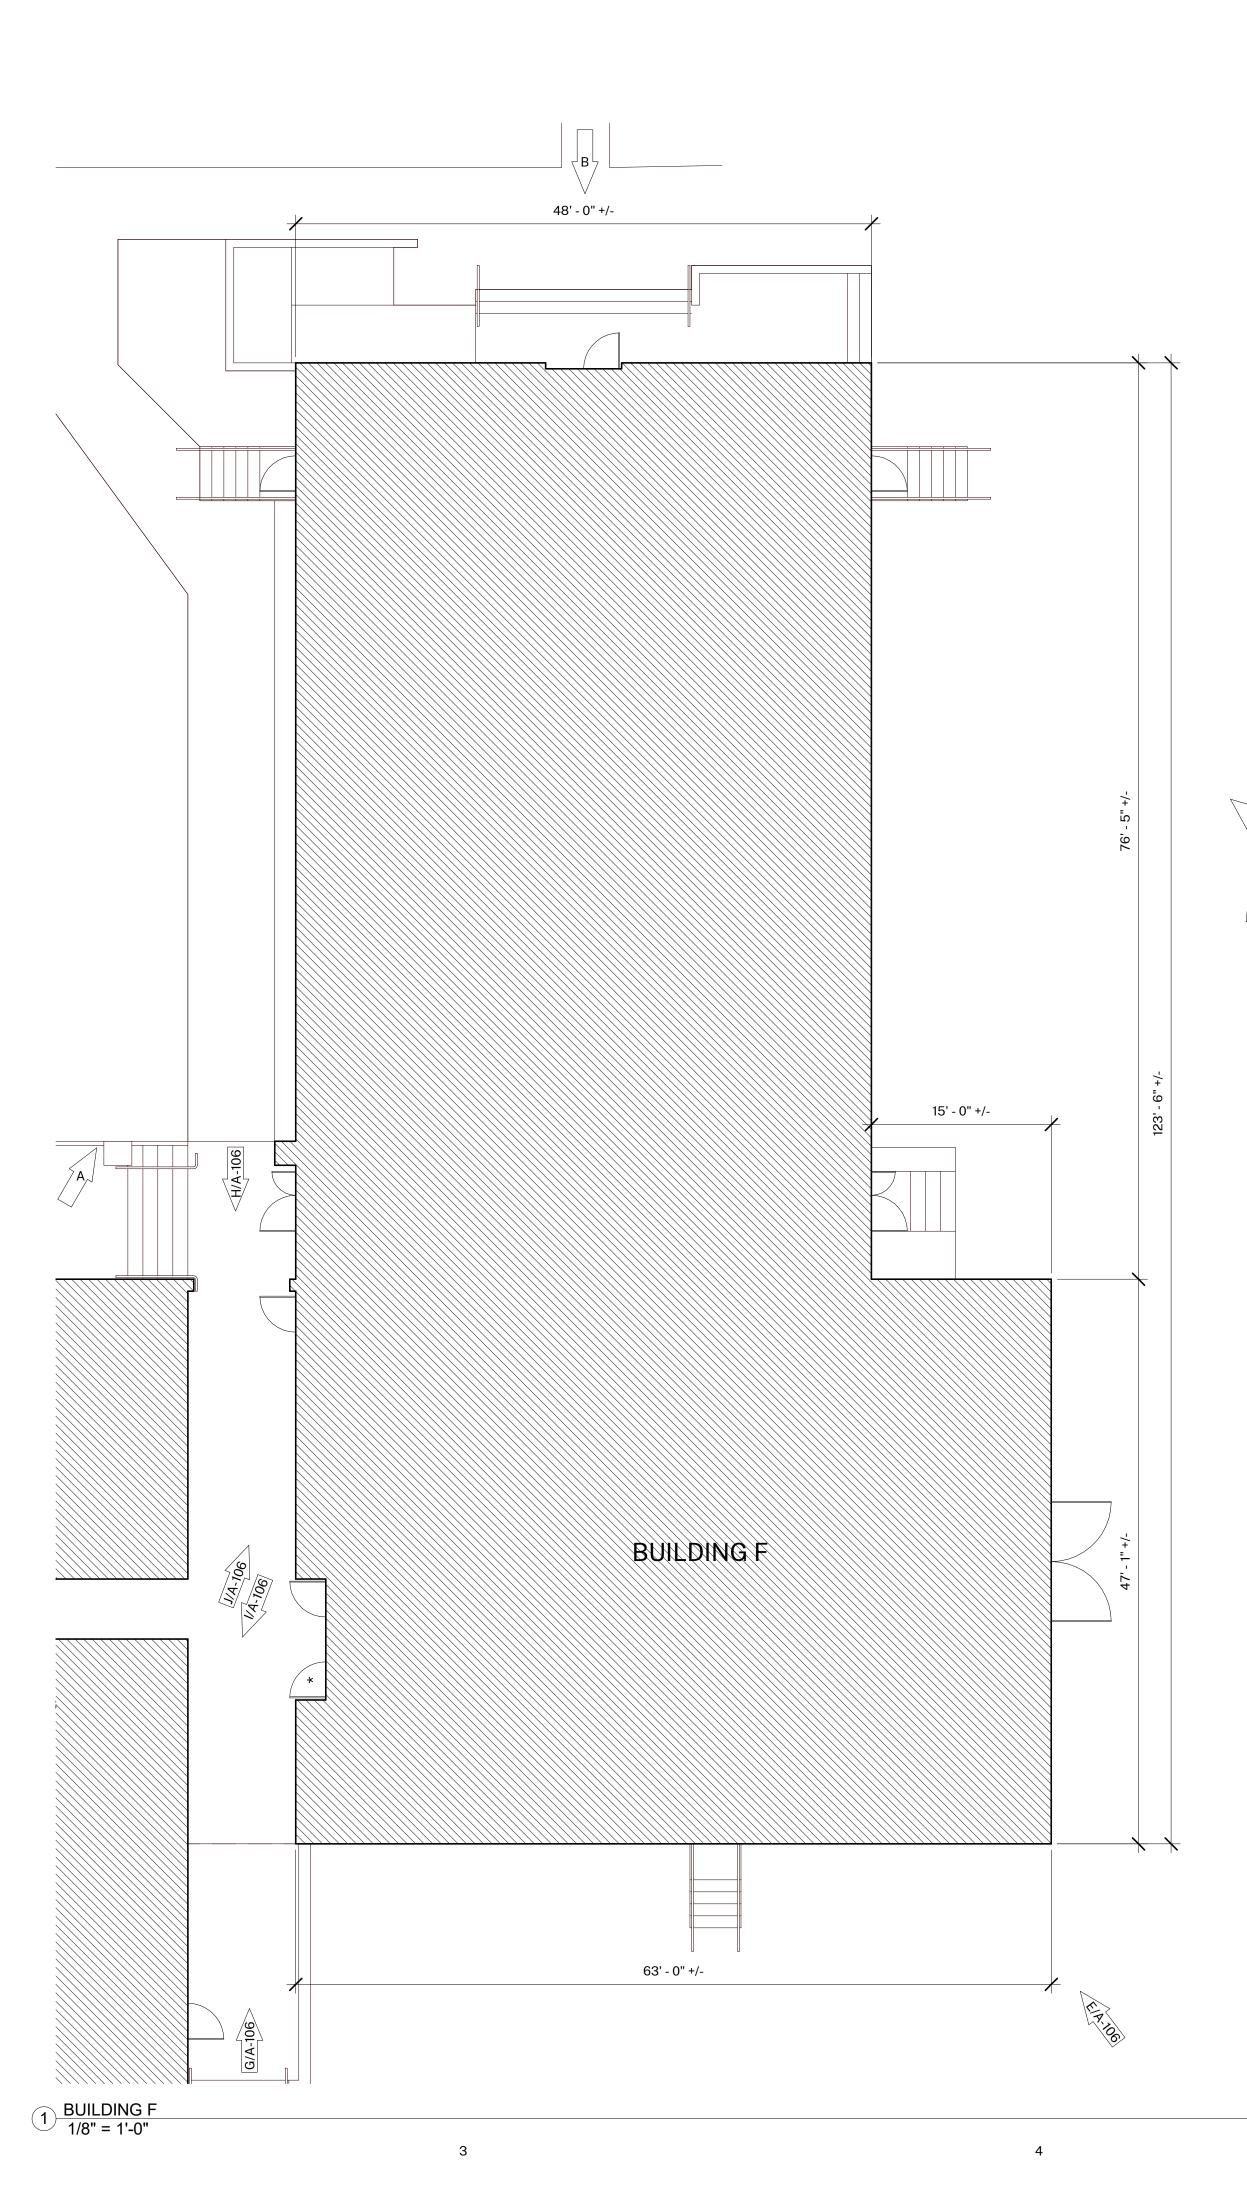

1. BUILDING PLANS ARE SCHEMATIC TO ONLY SHOW APPROXIMATE OVERALL BUILDING DIMENSIONS, DOOR QUANTITIES AND APPROXIMATE DOOR LOCATIONS AND ARE PROVIDED AS A CONVENIENCE FOR BIDDING. FIELD VERIFY CONDITIONS PRIOR TO BID. REFER TO SHEET KEYNOTES, PHOTOS, AND LEGENDS FOR ADDITIONAL INFORMATION.

2. ALL EXISTING PAINTED EXTERIOR WALLS OF BUILDING, PAINTED ROOF EAVES, OVERHANGS, CONDUITS, CABINTES, LOUVERS, VENTS, DUCTS AND ROOF EAVES AND GABLES INCLUDED IN THE SCOPE OF WORK ARE TO BE REPAINTED COLORS AS LISTED AND AS DETAILED IN THESE DRAWINGS AND SPECIFICATIONS UNLESS NOTED OTHERWISE.

3. ALL EXISTING UNPAINTED EXTERIOR SURFACES ARE TO REMAIN UNPAINTED UNLESS NOTED OTHERWISE. PROTECT IN PLACE ALL UNPAINTED SURFACES. 4. CAREFULLY PRUNE SHRUBS AND PLANTS AND REMOVE WEEDS AND PLANTINGS AT BASE OF WALL TO BARE EARTH TO ALLOW FOR COMPLETE WALL COVERAGE. 5. EXISTING PAINTED DOORS, DOOR FRAMES, DOOR TRIM, WINDOW FRAMES, MULLIONS, AND SEALANTS TO REMAIN UNLESS NOTED OTHERWISE. DO NOT PAINT ALUMINUM WINDOWS. PROTECT IN PLACE.

6. TYPICAL WORK AT EXISTING SIGNS TO REMAIN: REMOVE SIGN, PAINT BEHIND SIGN,

CLEAN SIGN, REINSTALL SIGN UNLESS NOTED OTHERWISE.

COLOR LEGEND AND NOTES

COLOR 1 - SWISS COFFEE DUNN EDWARDS DEW341 DUNN EDWARDS, MATCH EXISTING COLOR 2 - ROYAL GREY

COLOR 3 - WILD CURRANT SHERWIN WILLIAMS SW7583

COLOR 4 - MATCH TERRA COTTA ROOF TILE, FIELD VERIFY

1. PHOTOS WITH KEYNOTES ARE CREATED ELECTRONICALLY AND ARE INTENDED TO BE VIEWED IN COLOR TO SEE LOCATIONS OF COLORS ON THE BUILDINGS. CONTRACTOR SHALL FIELD VERIFY ACTUAL LOCATIONS AND DIMENSIONS OF COLORS PRIOR TO BID.

SHEET KEYNOTES

NOTE: NOT ALL KEYNOTES **USED ON EVERY SHEET**

1. PAINT COLOR 1 2. PAINT COLOR 2

3. PAINT COLOR 3

4. PAINT COLOR 4

5. REMOVE / PAINT WALL / REINSTALL: EXISTING SIGN

6. PROTECT IN PLACE: EXISTING SECURITY CAMERA TYPICAL AT ALL LOCATIONS 7. PREP / PAINT: UTILITY CONDUITS, CABINETS & HVAC TO MATCH WALL BEYOND.

8. PREP / PAINT: EXISTING SIGNAGE IN PLACE

9. PREP / PAINT: EXISTING LOUVERS AND/OR VENTS, TYPICAL 10. REMOVE / PAINT WALL / REINSTALL: LIGHT FIXTURE ESCUTCHEON PLATE OR LIGHT FIXTURE ITSELF TO WALL SURFACE BEHIND. TYPICAL AT ALL LIGHT FIXTURES U.N.O.

11. PREP / PAINT: EXISTING GUTTERS AND DOWNSPOUTS. PAINT COLOR 4 12. PROTECT IN PLACE: EXISTING GUTTERS AND LEADERHEADS 13. PROTECT IN PLACE: EXISTING LIGHT FIXTURE / SPEAKER / FIRE ALARM DEVICE

14. PREP / PAINT: EXISTING HVAC DUCTWORK WHERE ALREADY PAINTED. 15. PROTECT IN PLACE: EXISTING MURAL. PAINT WALLS AROUND MURAL TO MATCH EXISTING BUILDING COLOR SCHEME. TOUCH-UP/REPAINT MURALS WHERE PAINTED TO MATCH EXISTING.

16. PROTECT IN PLACE: EXISTING DRINKING FOUNTAIN 17. PREP / PAINT: EXISTING PAINTED DRINKING FOUNTAIN CANE DETECTION RAILS 18. PREP/STAIN/SEAL: EXISTING WOOD DISPLAY CASES, FIELD VERIFY STAIN COLOR +

SEALER SHEEN 19. REMOVE / DISCARD: EXISTING SIGN 20. REMOVE / SALVAGE TO ARCHITECT: EXISTING SIGN

21. REMOVE ACCESSIBLE SIGN / PAINT WALL / REINSTALL 22. PROTECT IN PLACE: EXISTING CONCRETE, CMU OR TILE 23. PREP / PAINT: EXISTING CONCRETE / CMU WALL

24. PREP / PAINT: EXISTING METAL FENCE & GATE 25. PROTECT IN PLACE: EXISTING MECHANICAL EQUIPMENT

26. PREP / PAINT: EXISTING ROLL-UP DOOR

27. PREP / PAINT: EXISTING STORAGE CONTAINER, ALL SIDES AND TOP, PAINT COLOR 2 28. PREP / PAINT: EXISTING WOOD BENCH / SEATS AND SLEEERS. 29. PREP / PAINT: EXISTING CMU WALLS. PAINT INSIDE AND OUTSIDE OF ENCLOSURE

AND DOORS. 30. PREP / PRIME / PAINT: PAVILION PLASTERED SURFACES & EAVES 31. PREP / PAINT: EXISTING DOOR OR WINDOW METAL SECURITY GRATING

32. PATCH / REPAIR / PREP / PRIME / PAINT: EXISTING PLASTER, SEE 1&3/A-201 33. PREP / PAINT: METAL PARAPET WALL CAP 34. PREP / PAINT: PLASTERED ROOF TOP EQUIPMENT SCREEN WALLS INSIDE AND OUT 35. CONTINUE WAINSCOAT AROUND ENTIRE PERIMETER OF BUILDING INCLUDING

RECESSED DOOR AND WINDOW RETURNS 36. PREP / PAINT: EXISTING RAIL 37. REMOVE / REPLACE CEILING LIGHTS, OWNER PROVIDED

38. EXISTING MURAL, PAINT OVER MURAL 39. REMOVE AND REPLACE EXISTING EQUIPMENT CLOSET DOOR, FRAME, HARDWARE


AND LOUVER, PAINT COLOR 2 40. PROTECT IN PLACE: EXISTING SIGN/PLAQUE 41. REMOVE EXISTING STRUCTURE 42. PREP/PAINT SAFETY YELLOW

43. REMOVE/PAINT/REINSTALL EQUIPMENT 44. REPAIR/REPLACE/PAINT: DAMAGED WOOD EAVE 45. PREP/PAINT: EXISTING WINDOW FRAMES & MUNTINS


46. REMOVE/DISCARD AS NOTED 47. PROTECT IN PLACE AS NOTED

SYMBOL LEGEND

EXISTING DOOR: FIELD VERIFY SIZES AND CONDITIONS, PAINT DOOR WARNING STRIPING ON LANDING AT ALL OUTSWINGING EXTERIOR DOORS U.N.O.

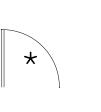

EXISTING RESTROOM DOOR: FIELD VERIFY SIZES AND CONDITIONS, PAINT DOOR WARNING STRIPING ON LANDING AT ALL OUTSWINGING EXTERIOR DOORS U.N.O. PAINT EXTERIOR DOOR FACE, FRAME EXTERIOR AND INTERIOR JAMB TO FACE OF DOOR STOP. APPLY RESTROOM IDENTIFICATION DOOR SIGNAGE ON EXTERIOR AND INTERIOR WHERE DOORS ARE PROPPED OPEN. SEE

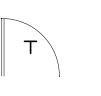

EXISTING CLASSROOM DOOR, PAINT WARNING STRIPING ON LANDING AT ALL OUTSWINGING EXTERIOR DOORS U.N.O., REMOVE AND REPLACE TRANSOM DOOR LOUVERS AND INFILL WITH 2x LUMBER, INSULTATION, AND GYPSUM SHEATHING, PAINT ENTIRE DOOR AND FRAME COLOR 2

AGENCY APPROVAL:



HARTMANNARCHITECTURESTUDIO.COM 430 S. CARRILLO RD. OJAI, CALIFORNIA 93023 (805) 530-5559

CONSULTANTS:



MATILIJA MS CAMPUS -WIDE EXTERIOR PAINTING

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OJAI UNIFIED SCHOOL DISTRICT 414 EAST OJAI AVENUE OJAI, CA 93023 (805) 640-4300 **CONTACT: ADAM DUTTER** EMAIL: adutter@ojaiusd.org

PROJECT ADDRESS: MATILIJA MIDDLE SCHOOL 703 EL PASEO ROAD

OJAI, CA 93023

OJAI USD PROJECT NO.: 2021-1600

ISSUE:		
MARK	DATE	DESCRIPTION

PROJECT INFORMATION:

PROJECT NUMBER: PROJECT PHASE: DRAWN BY:

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SHEET TITLE:

BUILDING F

2021.010

SHEET NUMBER:

A-105

DATE: 05/14/21

REMOVE AND REPLACE DAMAGED


SHEET METAL ACCESS DOOR MATCH EXISTING, PAINT COLOR 1


TYP AT

BEAMS IN

CORRIDOR



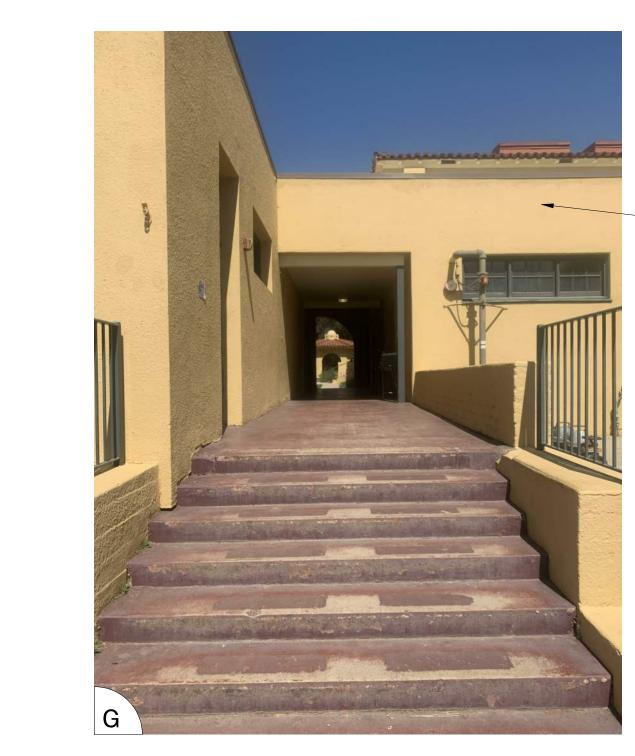

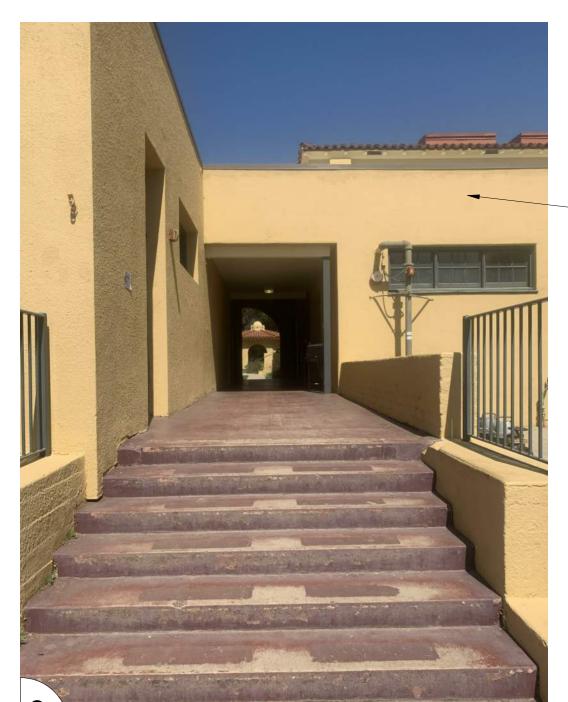

NOTE: NOT ALL KEYNOTES **GENERAL NOTES** USED ON EVERY SHEET

1. PAINT COLOR 1

2. PAINT COLOR 2 3. PAINT COLOR 3

4. PAINT COLOR 4

SHEET KEYNOTES

5. REMOVE / PAINT WALL / REINSTALL: EXISTING SIGN 6. PROTECT IN PLACE: EXISTING SECURITY CAMERA TYPICAL AT ALL LOCATIONS

7. PREP / PAINT: UTILITY CONDUITS, CABINETS & HVAC TO MATCH WALL BEYOND. 8. PREP / PAINT: EXISTING SIGNAGE IN PLACE

9. PREP / PAINT: EXISTING LOUVERS AND/OR VENTS, TYPICAL

10. REMOVE / PAINT WALL / REINSTALL: LIGHT FIXTURE ESCUTCHEON PLATE OR LIGHT FIXTURE ITSELF TO WALL SURFACE BEHIND. TYPICAL AT ALL LIGHT FIXTURES U.N.O. 11. PREP / PAINT: EXISTING GUTTERS AND DOWNSPOUTS. PAINT COLOR 4

12. PROTECT IN PLACE: EXISTING GUTTERS AND LEADERHEADS 13. PROTECT IN PLACE: EXISTING LIGHT FIXTURE / SPEAKER / FIRE ALARM DEVICE

14. PREP / PAINT: EXISTING HVAC DUCTWORK WHERE ALREADY PAINTED. 15. PROTECT IN PLACE: EXISTING MURAL. PAINT WALLS AROUND MURAL TO MATCH EXISTING BUILDING COLOR SCHEME. TOUCH-UP/REPAINT MURALS WHERE PAINTED TO MATCH EXISTING.

16. PROTECT IN PLACE: EXISTING DRINKING FOUNTAIN 17. PREP / PAINT: EXISTING PAINTED DRINKING FOUNTAIN CANE DETECTION RAILS

18. PREP/STAIN/SEAL: EXISTING WOOD DISPLAY CASES, FIELD VERIFY STAIN COLOR + SEALER SHEEN

19. REMOVE / DISCARD: EXISTING SIGN 20. REMOVE / SALVAGE TO ARCHITECT: EXISTING SIGN

21. REMOVE ACCESSIBLE SIGN / PAINT WALL / REINSTALL 22. PROTECT IN PLACE: EXISTING CONCRETE, CMU OR TILE 23. PREP / PAINT: EXISTING CONCRETE / CMU WALL

24. PREP / PAINT: EXISTING METAL FENCE & GATE 25. PROTECT IN PLACE: EXISTING MECHANICAL EQUIPMENT

26. PREP / PAINT: EXISTING ROLL-UP DOOR 27. PREP / PAINT: EXISTING STORAGE CONTAINER, ALL SIDES AND TOP, PAINT COLOR 2 28. PREP / PAINT: EXISTING WOOD BENCH / SEATS AND SLEEERS.

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37. REMOVE / REPLACE CEILING LIGHTS, OWNER PROVIDED 38. EXISTING MURAL, PAINT OVER MURAL

39. REMOVE AND REPLACE EXISTING EQUIPMENT CLOSET DOOR, FRAME, HARDWARE AND LOUVER, PAINT COLOR 2 40. PROTECT IN PLACE: EXISTING SIGN/PLAQUE

41. REMOVE EXISTING STRUCTURE 42. PREP/PAINT SAFETY YELLOW

43. REMOVE/PAINT/REINSTALL EQUIPMENT 44. REPAIR/REPLACE/PAINT: DAMAGED WOOD EAVE

45. PREP/PAINT: EXISTING WINDOW FRAMES & MUNTINS 46. REMOVE/DISCARD AS NOTED

47. PROTECT IN PLACE AS NOTED

1. BUILDING PLANS ARE SCHEMATIC TO ONLY SHOW APPROXIMATE OVERALL BUILDING DIMENSIONS, DOOR QUANTITIES AND APPROXIMATE DOOR LOCATIONS AND ARE PROVIDED AS A CONVENIENCE FOR BIDDING. FIELD VERIFY CONDITIONS PRIOR TO BID. REFER TO SHEET KEYNOTES, PHOTOS, AND LEGENDS FOR ADDITIONAL INFORMATION.

2. ALL EXISTING PAINTED EXTERIOR WALLS OF BUILDING, PAINTED ROOF EAVES, OVERHANGS, CONDUITS, CABINTES, LOUVERS, VENTS, DUCTS AND ROOF EAVES AND GABLES INCLUDED IN THE SCOPE OF WORK ARE TO BE REPAINTED COLORS AS LISTED AND AS DETAILED IN THESE DRAWINGS AND SPECIFICATIONS UNLESS

NOTED OTHERWISE. 3. ALL EXISTING UNPAINTED EXTERIOR SURFACES ARE TO REMAIN UNPAINTED UNLESS NOTED OTHERWISE. PROTECT IN PLACE ALL UNPAINTED SURFACES.

4. CAREFULLY PRUNE SHRUBS AND PLANTS AND REMOVE WEEDS AND PLANTINGS AT

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6. TYPICAL WORK AT EXISTING SIGNS TO REMAIN: REMOVE SIGN, PAINT BEHIND SIGN, CLEAN SIGN, REINSTALL SIGN UNLESS NOTED OTHERWISE.

COLOR LEGEND AND NOTES

DUNN EDWARDS DEW341 COLOR 1 - SWISS COFFEE COLOR 2 - ROYAL GREY DUNN EDWARDS, MATCH EXISTING COLOR 3 - WILD CURRANT SHERWIN WILLIAMS SW7583

COLOR 4 - MATCH TERRA COTTA ROOF TILE, FIELD VERIFY


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AGENCY APPROVAL:



MATILIJA MS CAMPUS -WIDE EXTERIOR PAINTING

OWNER:

OJAI UNIFIED SCHOOL DISTRICT 414 EAST OJAI AVENUE OJAI, CA 93023 (805) 640-4300 CONTACT: ADAM DUTTER EMAIL: adutter@ojaiusd.org

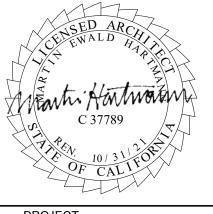PROJECT ADDRESS: MATILIJA MIDDLE SCHOOL 703 EL PASEO ROAD

OJAI, CA 93023

OJAI USD PROJECT NO.: 2021-1600

ISSUE: MARK DESCRIPTION

2021.010

PROJECT INFORMATION: PROJECT NUMBER:

PROJECT PHASE: DRAWN BY: REVIEWED BY:

THE ORIGINAL SIZE OF THIS SHEET IS 36"x24". IF THE CURRENT SIZE IS OTHER THAN 36"x24", THEN ADJUST THE SCALE OF THE DRAWINGS ACCORDINGLY.

SHEET TITLE:

BUILDING F


A-106

SIGNS AND REPLACE

46 BRACKETS 1 ALL SIDES & EAVES

DATE: 05/14/21

SHEET NUMBER:

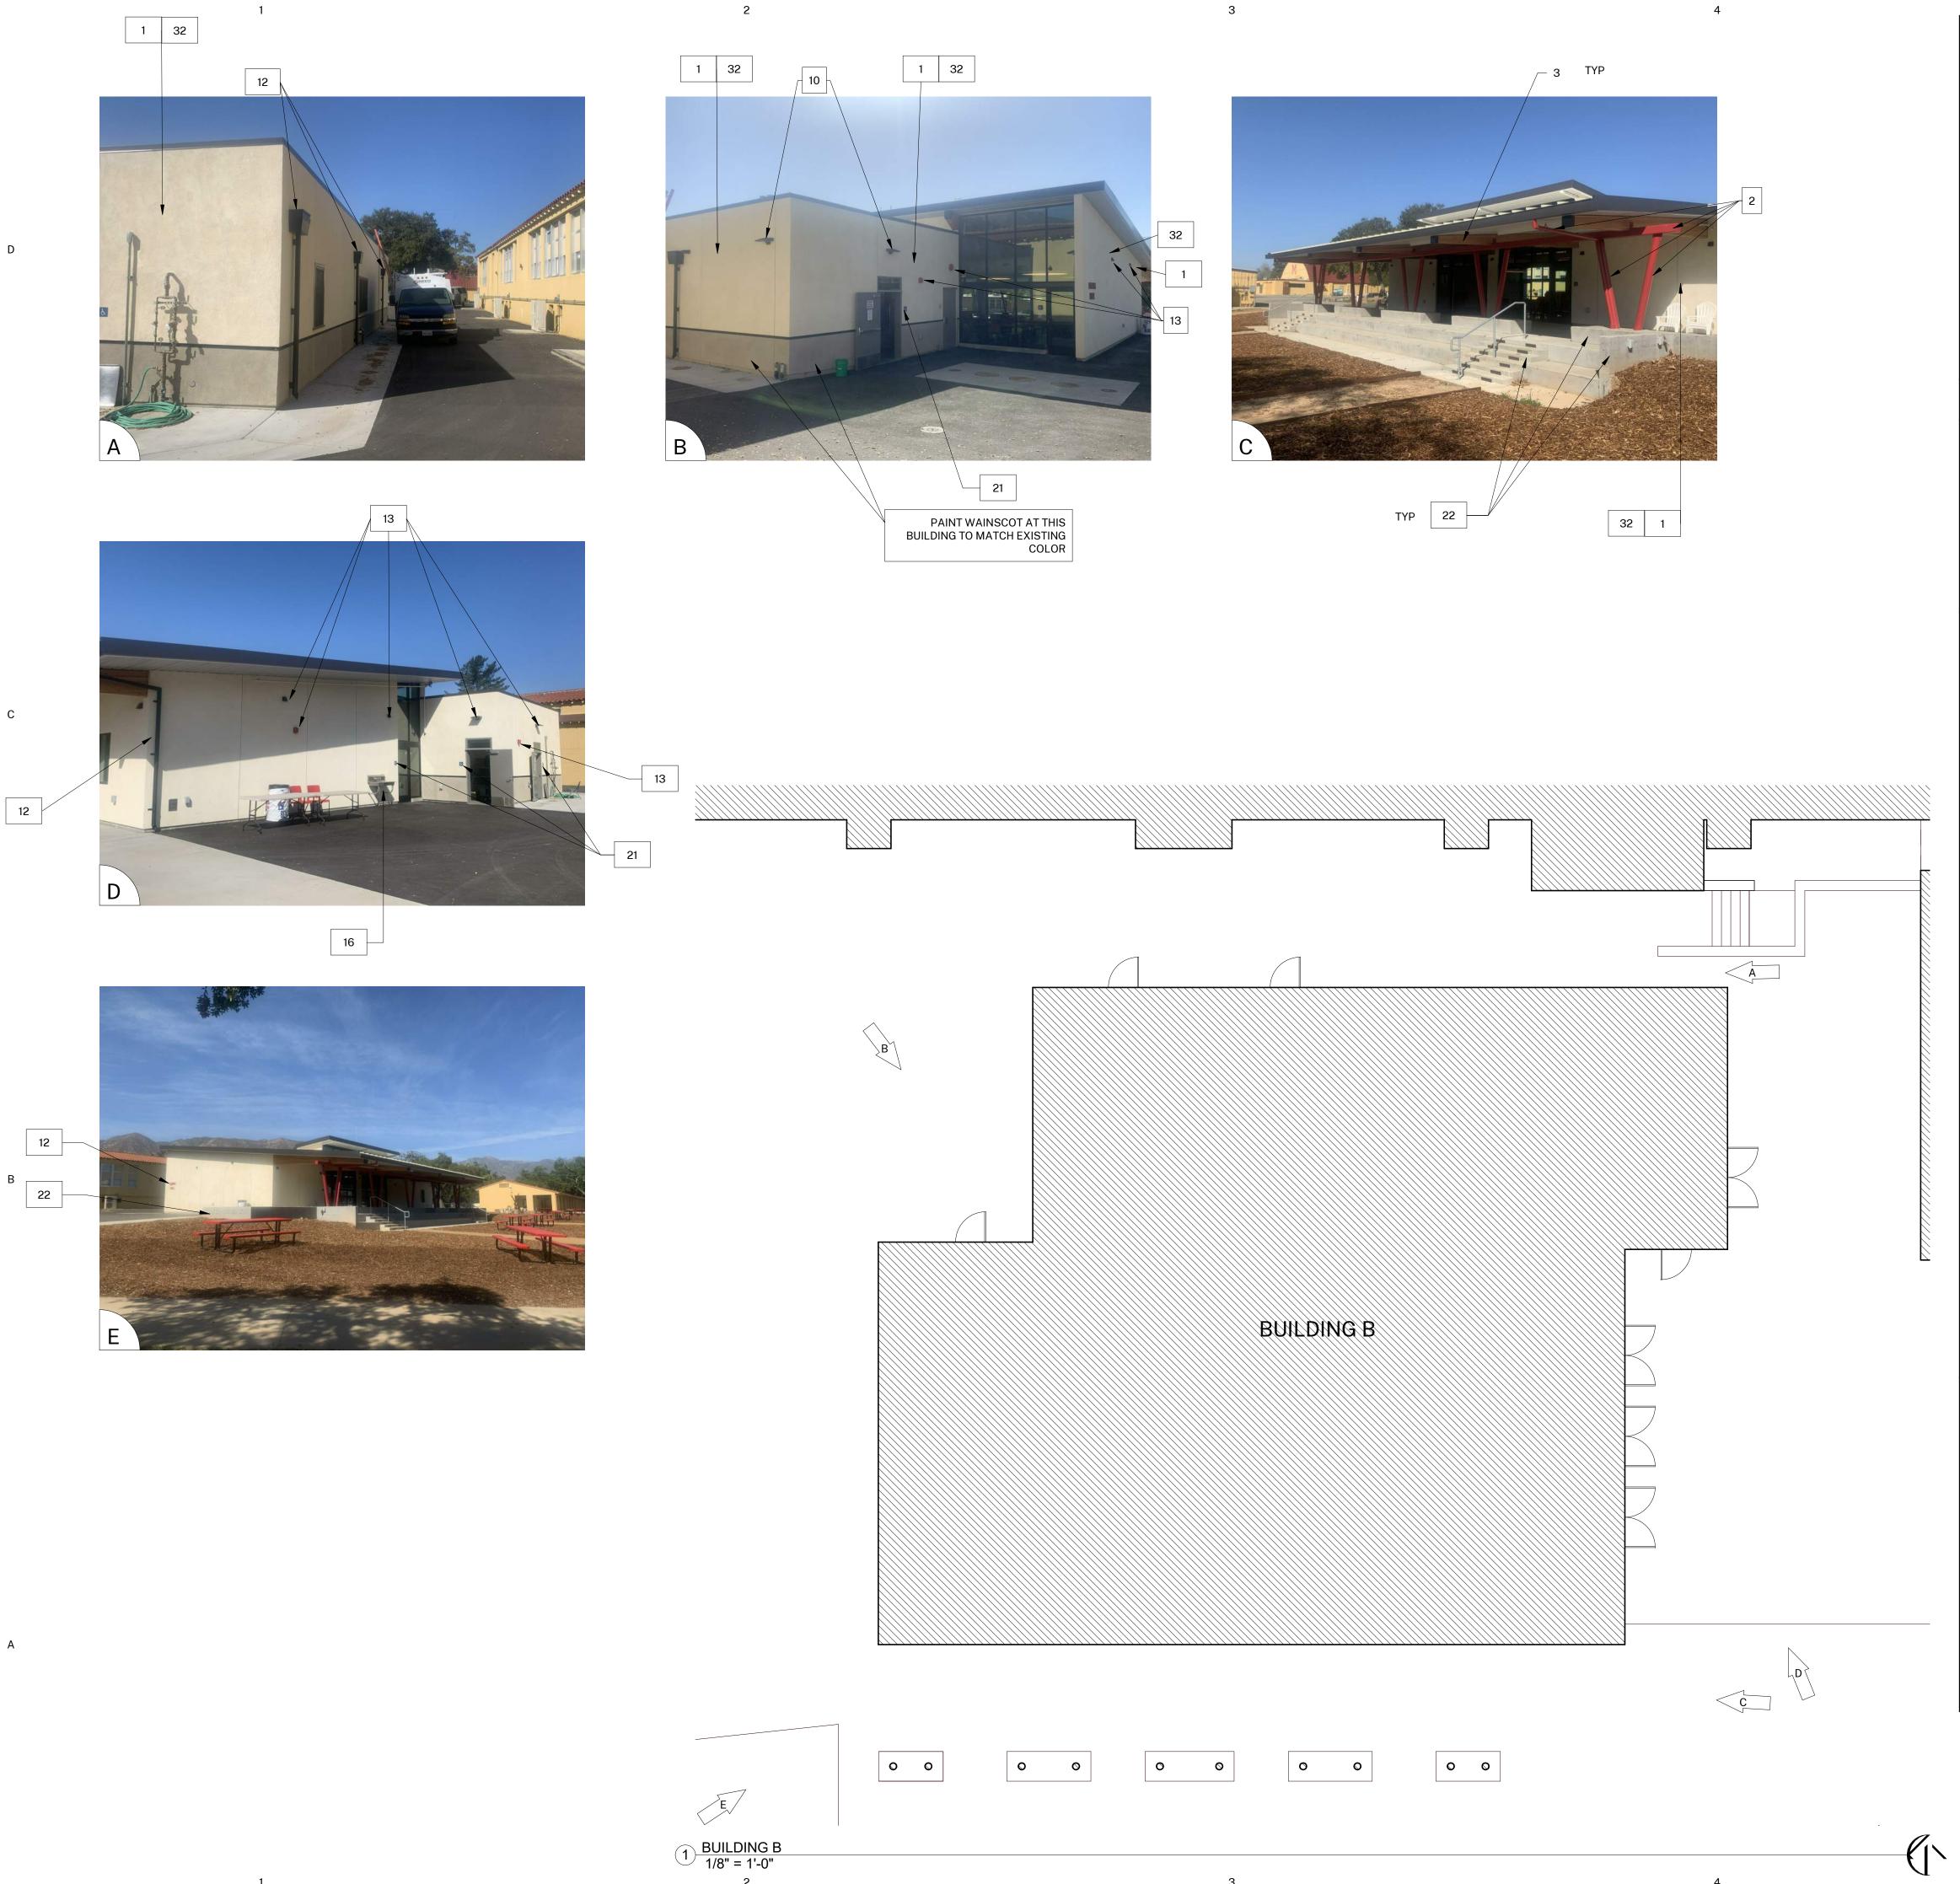

- 1. BUILDING PLANS ARE SCHEMATIC TO ONLY SHOW APPROXIMATE OVERALL BUILDING DIMENSIONS, DOOR QUANTITIES AND APPROXIMATE DOOR LOCATIONS AND ARE PROVIDED AS A CONVENIENCE FOR BIDDING. FIELD VERIFY CONDITIONS PRIOR TO BID. REFER TO SHEET KEYNOTES, PHOTOS, AND LEGENDS FOR ADDITIONAL INFORMATION.
- 2. ALL EXISTING PAINTED EXTERIOR WALLS OF BUILDING, PAINTED ROOF EAVES, OVERHANGS, CONDUITS, CABINTES, LOUVERS, VENTS, DUCTS AND ROOF EAVES AND GABLES INCLUDED IN THE SCOPE OF WORK ARE TO BE REPAINTED COLORS AS LISTED AND AS DETAILED IN THESE DRAWINGS AND SPECIFICATIONS UNLESS NOTED OTHERWISE.
- ALL EXISTING UNPAINTED EXTERIOR SURFACES ARE TO REMAIN UNPAINTED UNLESS NOTED OTHERWISE. PROTECT IN PLACE ALL UNPAINTED SURFACES.
 CAREFULLY PRUNE SHRUBS AND PLANTS AND REMOVE WEEDS AND PLANTINGS AT BASE OF WALL TO BARE EARTH TO ALLOW FOR COMPLETE WALL COVERAGE.
 EXISTING PAINTED DOORS, DOOR FRAMES, DOOR TRIM, WINDOW FRAMES, MULLIONS, AND SEALANTS TO REMAIN UNLESS NOTED OTHERWISE. DO NOT PAINT
- ALUMINUM WINDOWS. PROTECT IN PLACE.

 6. TYPICAL WORK AT EXISTING SIGNS TO REMAIN: REMOVE SIGN, PAINT BEHIND SIGN, CLEAN SIGN, REINSTALL SIGN UNLESS NOTED OTHERWISE.

COLOR LEGEND AND NOTES

COLOR 1 - SWISS COFFEE DUNN EDWARDS DEW341

COLOR 2 - ROYAL GREY DUNN EDWARDS, MATCH EXISTING

COLOR 3 - WILD CURRANT SHERWIN WILLIAMS SW7583

COLOR 4 - MATCH TERRA COTTA ROOF TILE, FIELD VERIFY

 PHOTOS WITH KEYNOTES ARE CREATED ELECTRONICALLY AND ARE INTENDED TO BE VIEWED IN COLOR TO SEE LOCATIONS OF COLORS ON THE BUILDINGS. CONTRACTOR SHALL FIELD VERIFY ACTUAL LOCATIONS AND DIMENSIONS OF COLORS PRIOR TO BID.

SHEET KEYNOTES

NOTE: NOT ALL KEYNOTES USED ON EVERY SHEET

1. PAINT COLOR 1

2. PAINT COLOR 2

3. PAINT COLOR 34. PAINT COLOR 4

5. REMOVE / PAINT WALL / REINSTALL: EXISTING SIGN

6. PROTECT IN PLACE: EXISTING SECURITY CAMERA TYPICAL AT ALL LOCATIONS

7. PREP / PAINT: UTILITY CONDUITS, CABINETS & HVAC TO MATCH WALL BEYOND.

PREP / PAINT: EXISTING SIGNAGE IN PLACE
 PREP / PAINT: EXISTING LOUVERS AND/OR VENT

9. PREP / PAINT: EXISTING LOUVERS AND/OR VENTS, TYPICAL
10. REMOVE / PAINT WALL / REINSTALL: LIGHT FIXTURE ESCUTCHEON PLATE OR LIGHT FIXTURE ITSELF TO WALL SURFACE BEHIND. TYPICAL AT ALL LIGHT FIXTURES U.N.O.

11. PREP / PAINT: EXISTING GUTTERS AND DOWNSPOUTS. PAINT COLOR 4
12. PROTECT IN PLACE: EXISTING GUTTERS AND LEADERHEADS
13. PROTECT IN PLACE: EXISTING LIGHT FIXTURE / SPEAKER / FIRE ALARM DEVICE

14. PREP / PAINT: EXISTING HVAC DUCTWORK WHERE ALREADY PAINTED.
15. PROTECT IN PLACE: EXISTING MURAL. PAINT WALLS AROUND MURAL TO MATCH EXISTING BUILDING COLOR SCHEME. TOUCH-UP/REPAINT MURALS WHERE PAINTED TO MATCH EXISTING.

16. PROTECT IN PLACE: EXISTING DRINKING FOUNTAIN
17. PREP / PAINT: EXISTING PAINTED DRINKING FOUNTAIN CANE DETECTION RAILS

18. PREP/STAIN/SEAL: EXISTING WOOD DISPLAY CASES, FIELD VERIFY STAIN COLOR + SEALER SHEEN
19. REMOVE / DISCARD: EXISTING SIGN

20. REMOVE / SALVAGE TO ARCHITECT: EXISTING SIGN 21. REMOVE ACCESSIBLE SIGN / PAINT WALL / REINSTALL

22. PROTECT IN PLACE: EXISTING CONCRETE, CMU OR TILE 23. PREP / PAINT: EXISTING CONCRETE / CMU WALL

24. PREP / PAINT: EXISTING METAL FENCE & GATE

25. PROTECT IN PLACE: EXISTING MECHANICAL EQUIPMENT 26. PREP / PAINT: EXISTING ROLL-UP DOOR

27. PREP / PAINT: EXISTING STORAGE CONTAINER, ALL SIDES AND TOP, PAINT COLOR 2 28. PREP / PAINT: EXISTING WOOD BENCH / SEATS AND SLEEERS.

29. PREP / PAINT: EXISTING CMU WALLS. PAINT INSIDE AND OUTSIDE OF ENCLOSURE AND DOORS.

30. PREP / PRIME / PAINT: PAVILION PLASTERED SURFACES & EAVES
31. DRED / DAINT: EXISTING DOOD OF WINDOW METAL SECURITY CRATING

31. PREP / PAINT: EXISTING DOOR OR WINDOW METAL SECURITY GRATING

32. PATCH / REPAIR / PREP / PRIME / PAINT: EXISTING PLASTER, SEE 1&3/A-201
33. PREP / PAINT: METAL PARAPET WALL CAP
34. PREP / PAINT: PLASTERED ROOF TOP EQUIPMENT SCREEN WALLS INSIDE AND OUT

34. PREP / PAINT: PLASTERED ROOF TOP EQUIPMENT SCREEN WALLS INSIDE AND OU 35. CONTINUE WAINSCOAT AROUND ENTIRE PERIMETER OF BUILDING INCLUDING RECESSED DOOR AND WINDOW RETURNS

36. PREP / PAINT: EXISTING RAIL
37. REMOVE / REPLACE CEILING LIGHTS, OWNER PROVIDED

39. REMOVE AND REPLACE EXISTING EQUIPMENT CLOSET DOOR, FRAME, HARDWARE AND LOUVER, PAINT COLOR 2

40. PROTECT IN PLACE: EXISTING SIGN/PLAQUE
41. REMOVE EXISTING STRUCTURE

38. EXISTING MURAL, PAINT OVER MURAL

42. PREP/PAINT SAFETY YELLOW
43. REMOVE/PAINT/REINSTALL EQUIPMENT

44. REPAIR/REPLACE/PAINT: DAMAGED WOOD EAVE


45. PREP/PAINT: EXISTING WINDOW FRAMES & MUNTINS

46. REMOVE/DISCARD AS NOTED 47. PROTECT IN PLACE AS NOTED


SYMBOL LEGEND



EXISTING DOOR: FIELD VERIFY SIZES AND CONDITIONS, PAINT DOOR WARNING STRIPING ON LANDING AT ALL OUTSWINGING EXTERIOR DOORS U.N.O.

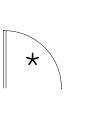

EXISTING RESTROOM DOOR: FIELD VERIFY SIZES AND CONDITIONS, PAINT DOOR WARNING STRIPING ON LANDING AT ALL OUTSWINGING EXTERIOR DOORS U.N.O. PAINT EXTERIOR DOOR FACE, FRAME EXTERIOR AND INTERIOR JAMB TO FACE OF DOOR STOP. APPLY RESTROOM IDENTIFICATION DOOR SIGNAGE ON EXTERIOR AND INTERIOR WHERE DOORS ARE PROPPED OPEN. SEE 1/A-201.

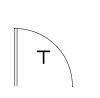

EXISTING CLASSROOM DOOR, PAINT WARNING STRIPING ON LANDING AT ALL OUTSWINGING EXTERIOR DOORS U.N.O., REMOVE AND REPLACE TRANSOM DOOR LOUVERS AND INFILL WITH 2x LUMBER, INSULTATION, AND GYPSUM SHEATHING, PAINT ENTIRE DOOR AND FRAME COLOR 2



HARTMANNARCHITECTURESTUDIO.COM 430 S. CARRILLO RD. OJAI, CALIFORNIA 93023 (805) 530-5559

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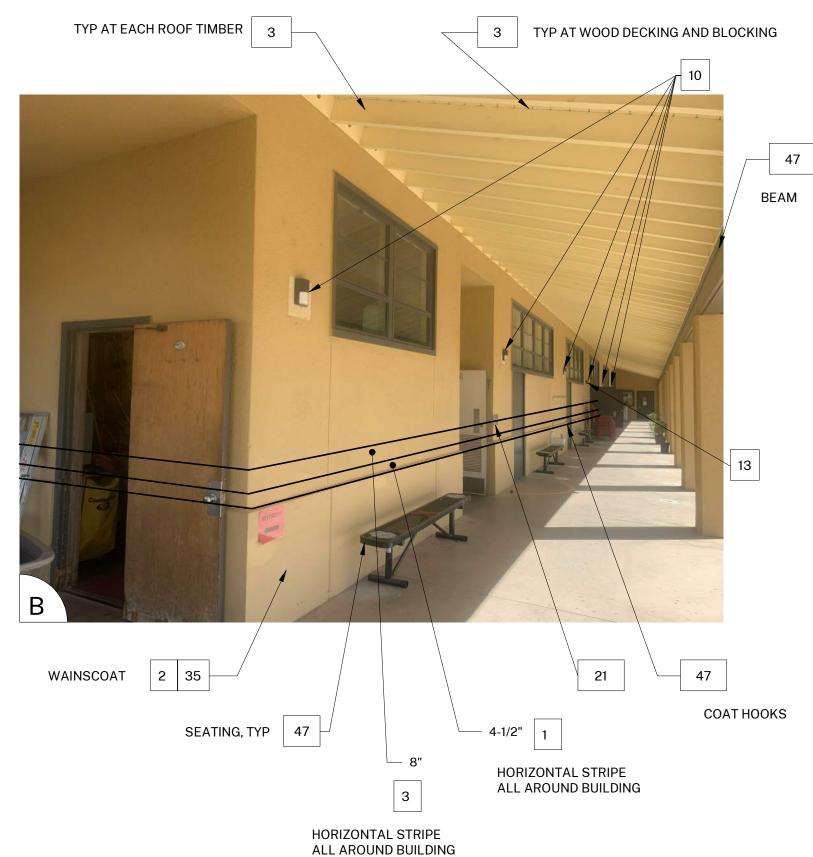
SHEET TITLE:

BUILDING B

SHEET NUMBER:

A-107





NOTE: NOT ALL KEYNOTES USED ON EVERY SHEET

PAINT COLOR 1

2. PAINT COLOR 2

3. PAINT COLOR 3

4. PAINT COLOR 4

SHEET KEYNOTES

5. REMOVE / PAINT WALL / REINSTALL: EXISTING SIGN 6. PROTECT IN PLACE: EXISTING SECURITY CAMERA TYPICAL AT ALL LOCATIONS 7. PREP / PAINT: UTILITY CONDUITS, CABINETS & HVAC TO MATCH WALL BEYOND.

8. PREP / PAINT: EXISTING SIGNAGE IN PLACE

9. PREP / PAINT: EXISTING LOUVERS AND/OR VENTS, TYPICAL

10. REMOVE / PAINT WALL / REINSTALL: LIGHT FIXTURE ESCUTCHEON PLATE OR LIGHT FIXTURE ITSELF TO WALL SURFACE BEHIND. TYPICAL AT ALL LIGHT FIXTURES U.N.O. 11. PREP / PAINT: EXISTING GUTTERS AND DOWNSPOUTS. PAINT COLOR 4

12. PROTECT IN PLACE: EXISTING GUTTERS AND LEADERHEADS 13. PROTECT IN PLACE: EXISTING LIGHT FIXTURE / SPEAKER / FIRE ALARM DEVICE 14. PREP / PAINT: EXISTING HVAC DUCTWORK WHERE ALREADY PAINTED.

15. PROTECT IN PLACE: EXISTING MURAL. PAINT WALLS AROUND MURAL TO MATCH EXISTING BUILDING COLOR SCHEME. TOUCH-UP/REPAINT MURALS WHERE PAINTED TO MATCH EXISTING.

16. PROTECT IN PLACE: EXISTING DRINKING FOUNTAIN

17. PREP / PAINT: EXISTING PAINTED DRINKING FOUNTAIN CANE DETECTION RAILS 18. PREP/STAIN/SEAL: EXISTING WOOD DISPLAY CASES, FIELD VERIFY STAIN COLOR + SEALER SHEEN

19. REMOVE / DISCARD: EXISTING SIGN 20. REMOVE / SALVAGE TO ARCHITECT: EXISTING SIGN 21. REMOVE ACCESSIBLE SIGN / PAINT WALL / REINSTALL

22. PROTECT IN PLACE: EXISTING CONCRETE, CMU OR TILE 23. PREP / PAINT: EXISTING CONCRETE / CMU WALL 24. PREP / PAINT: EXISTING METAL FENCE & GATE

25. PROTECT IN PLACE: EXISTING MECHANICAL EQUIPMENT

26. PREP / PAINT: EXISTING ROLL-UP DOOR 27. PREP / PAINT: EXISTING STORAGE CONTAINER, ALL SIDES AND TOP, PAINT COLOR 2 28. PREP / PAINT: EXISTING WOOD BENCH / SEATS AND SLEEERS.

29. PREP / PAINT: EXISTING CMU WALLS. PAINT INSIDE AND OUTSIDE OF ENCLOSURE AND DOORS. 30. PREP / PRIME / PAINT: PAVILION PLASTERED SURFACES & EAVES

31. PREP / PAINT: EXISTING DOOR OR WINDOW METAL SECURITY GRATING

32. PATCH / REPAIR / PREP / PRIME / PAINT: EXISTING PLASTER, SEE 1&3/A-201 33. PREP / PAINT: METAL PARAPET WALL CAP 34. PREP / PAINT: PLASTERED ROOF TOP EQUIPMENT SCREEN WALLS INSIDE AND OUT

35. CONTINUE WAINSCOAT AROUND ENTIRE PERIMETER OF BUILDING INCLUDING RECESSED DOOR AND WINDOW RETURNS 36. PREP / PAINT: EXISTING RAIL

37. REMOVE / REPLACE CEILING LIGHTS, OWNER PROVIDED 38. EXISTING MURAL, PAINT OVER MURAL

39. REMOVE AND REPLACE EXISTING EQUIPMENT CLOSET DOOR, FRAME, HARDWARE AND LOUVER, PAINT COLOR 2

40. PROTECT IN PLACE: EXISTING SIGN/PLAQUE 41. REMOVE EXISTING STRUCTURE 42. PREP/PAINT SAFETY YELLOW 43. REMOVE/PAINT/REINSTALL EQUIPMENT

44. REPAIR/REPLACE/PAINT: DAMAGED WOOD EAVE 45. PREP/PAINT: EXISTING WINDOW FRAMES & MUNTINS

46. REMOVE/DISCARD AS NOTED 47. PROTECT IN PLACE AS NOTED **GENERAL NOTES**

1. BUILDING PLANS ARE SCHEMATIC TO ONLY SHOW APPROXIMATE OVERALL BUILDING DIMENSIONS, DOOR QUANTITIES AND APPROXIMATE DOOR LOCATIONS AND ARE PROVIDED AS A CONVENIENCE FOR BIDDING. FIELD VERIFY CONDITIONS PRIOR TO BID. REFER TO SHEET KEYNOTES, PHOTOS, AND LEGENDS FOR ADDITIONAL INFORMATION.

2. ALL EXISTING PAINTED EXTERIOR WALLS OF BUILDING, PAINTED ROOF EAVES, OVERHANGS, CONDUITS, CABINTES, LOUVERS, VENTS, DUCTS AND ROOF EAVES AND GABLES INCLUDED IN THE SCOPE OF WORK ARE TO BE REPAINTED COLORS AS

LISTED AND AS DETAILED IN THESE DRAWINGS AND SPECIFICATIONS UNLESS NOTED OTHERWISE. 3. ALL EXISTING UNPAINTED EXTERIOR SURFACES ARE TO REMAIN UNPAINTED UNLESS NOTED OTHERWISE. PROTECT IN PLACE ALL UNPAINTED SURFACES.

BASE OF WALL TO BARE EARTH TO ALLOW FOR COMPLETE WALL COVERAGE. 5. EXISTING PAINTED DOORS, DOOR FRAMES, DOOR TRIM, WINDOW FRAMES, MULLIONS, AND SEALANTS TO REMAIN UNLESS NOTED OTHERWISE. DO NOT PAINT ALUMINUM WINDOWS. PROTECT IN PLACE.

6. TYPICAL WORK AT EXISTING SIGNS TO REMAIN: REMOVE SIGN, PAINT BEHIND SIGN, CLEAN SIGN, REINSTALL SIGN UNLESS NOTED OTHERWISE.

4. CAREFULLY PRUNE SHRUBS AND PLANTS AND REMOVE WEEDS AND PLANTINGS AT

COLOR LEGEND AND NOTES

COLOR 1 - SWISS COFFEE DUNN EDWARDS DEW341 DUNN EDWARDS, MATCH EXISTING COLOR 2 - ROYAL GREY SHERWIN WILLIAMS SW7583 COLOR 3 - WILD CURRANT

COLOR 4 - MATCH TERRA COTTA ROOF TILE, FIELD VERIFY

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SYMBOL LEGEND



EXISTING DOOR: FIELD VERIFY SIZES AND CONDITIONS, PAINT DOOR WARNING STRIPING ON LANDING AT ALL OUTSWINGING EXTERIOR DOORS U.N.O.

EXISTING RESTROOM DOOR: FIELD VERIFY SIZES AND CONDITIONS, PAINT DOOR WARNING STRIPING ON LANDING AT ALL OUTSWINGING EXTERIOR DOORS U.N.O. PAINT EXTERIOR DOOR FACE, FRAME EXTERIOR AND INTERIOR JAMB TO FACE OF DOOR STOP. APPLY RESTROOM IDENTIFICATION DOOR SIGNAGE ON EXTERIOR AND INTERIOR WHERE DOORS ARE PROPPED OPEN. SEE 1/A-201.



EXISTING CLASSROOM DOOR, PAINT WARNING STRIPING ON LANDING AT ALL OUTSWINGING EXTERIOR DOORS U.N.O., REMOVE AND REPLACE TRANSOM DOOR LOUVERS AND INFILL WITH 2x LUMBER, INSULTATION, AND GYPSUM SHEATHING, PAINT ENTIRE DOOR AND FRAME COLOR 2



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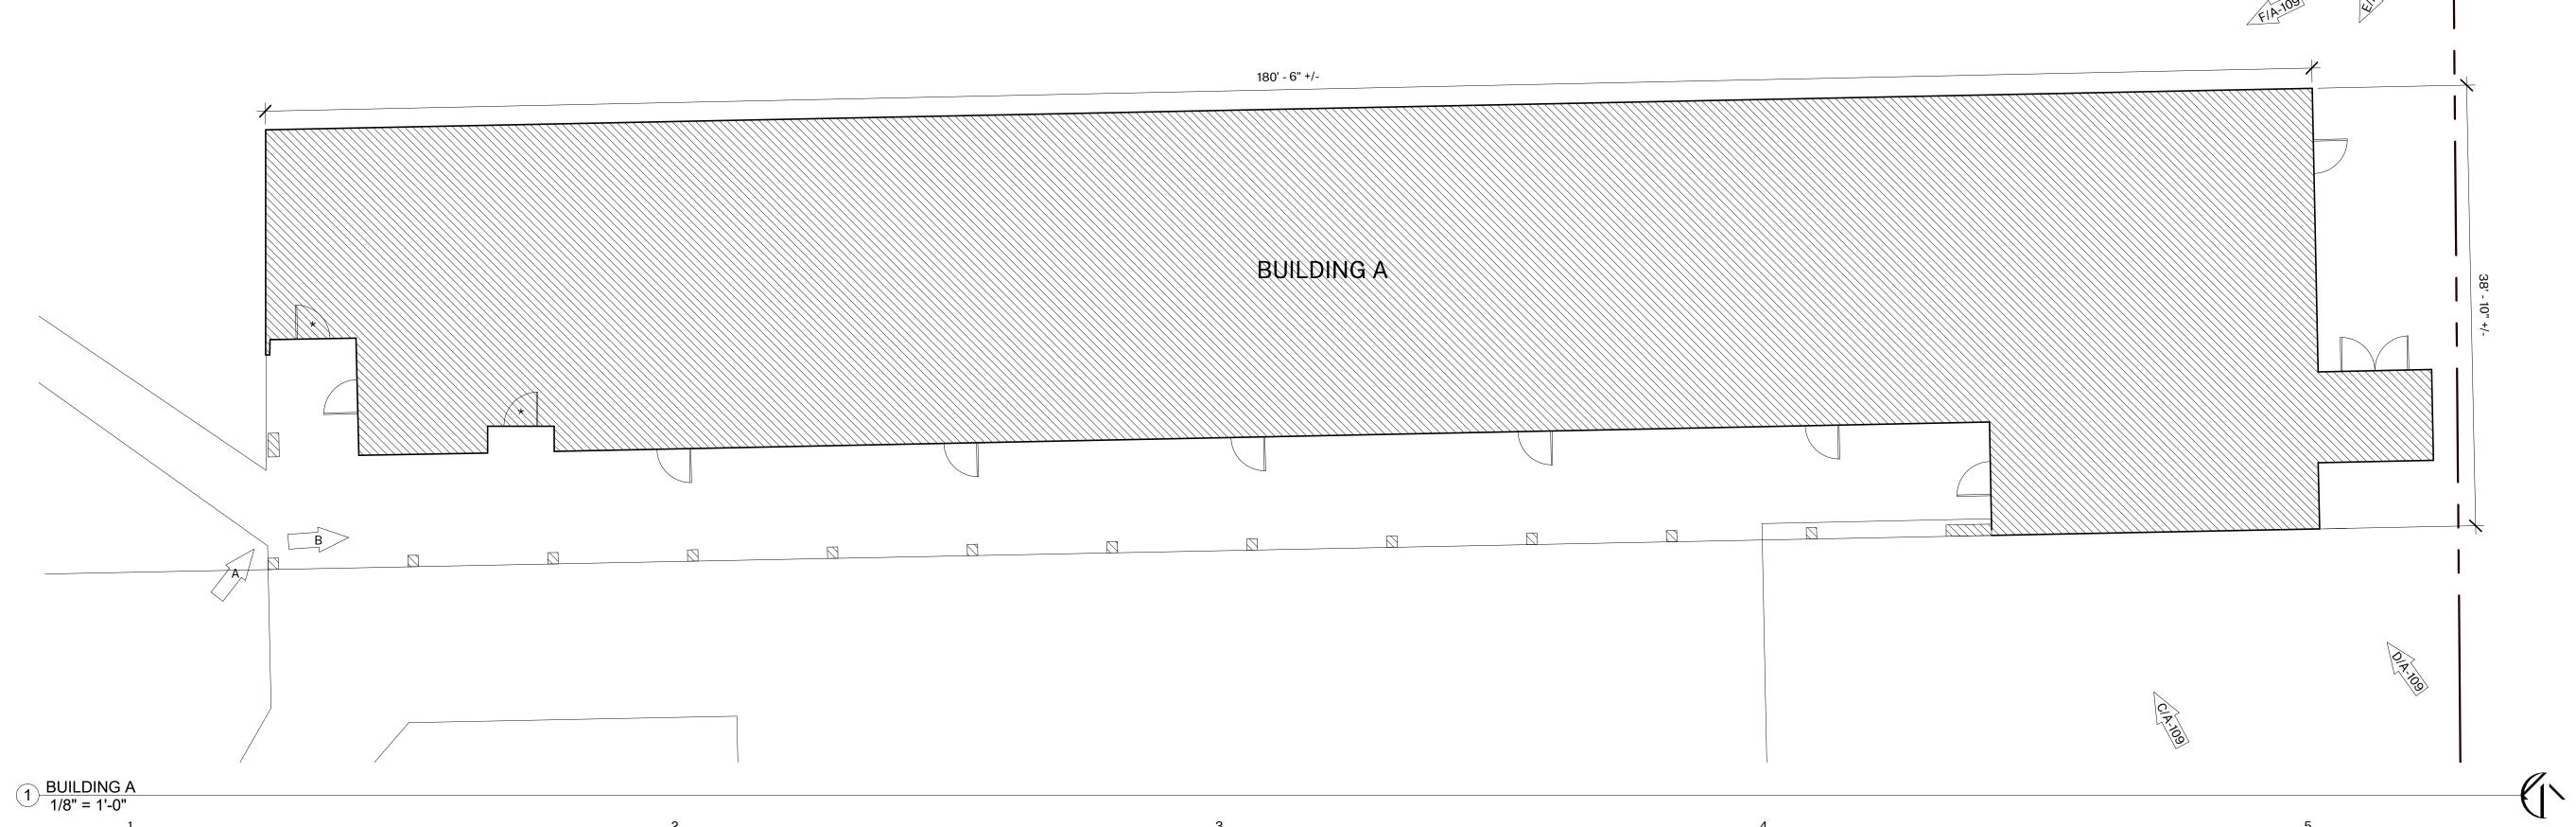
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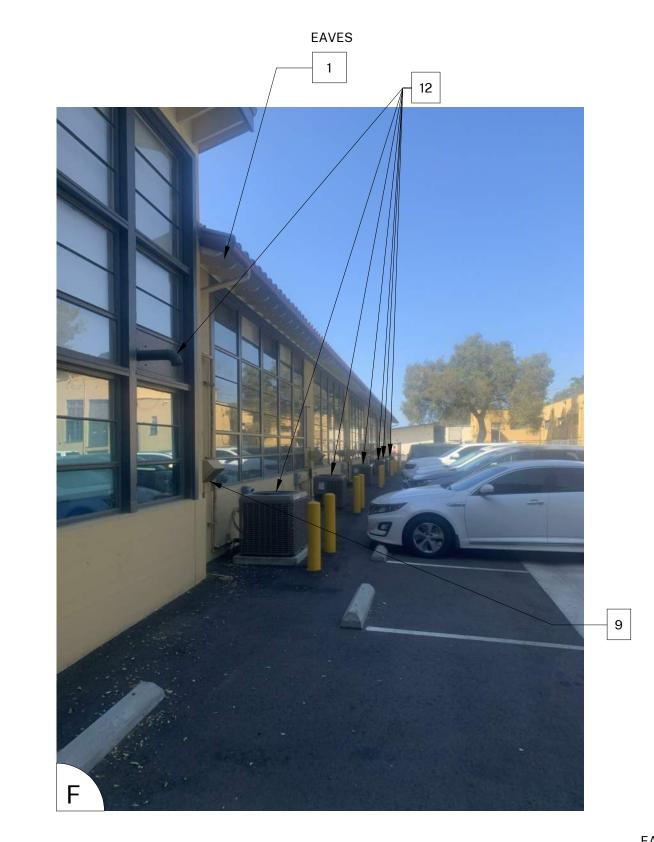
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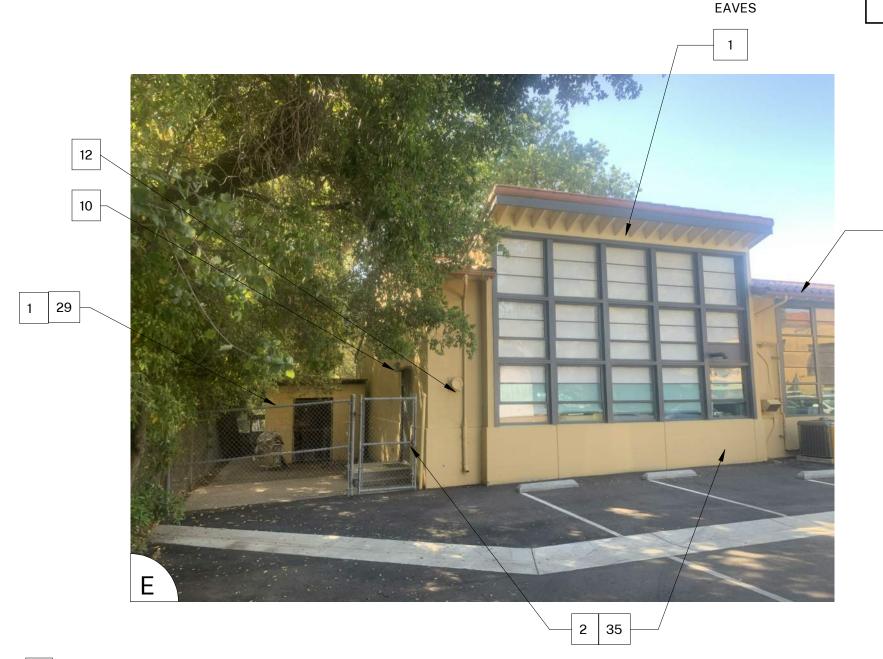
BUILDING A


SHEET NUMBER:

A-108







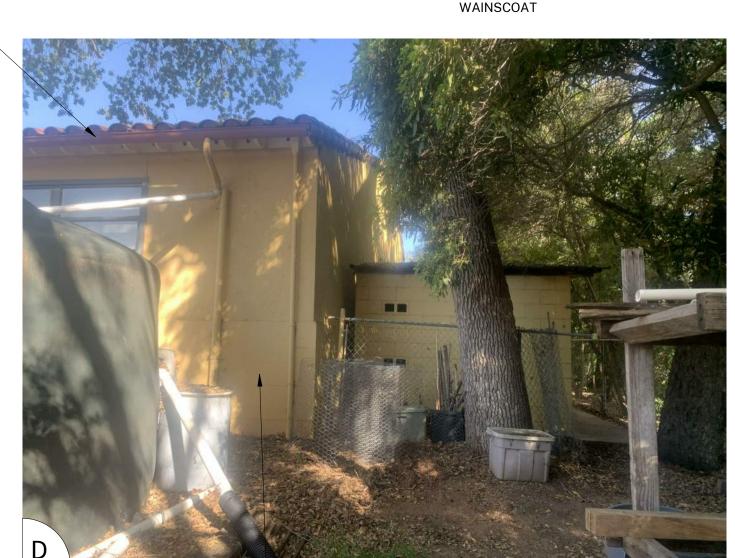

2 35 WAINSCOAT

NOTE: NOT ALL KEYNOTES **SHEET KEYNOTES** USED ON EVERY SHEET

PAINT COLOR 1

2. PAINT COLOR 2

3. PAINT COLOR 3 4. PAINT COLOR 4

5. REMOVE / PAINT WALL / REINSTALL: EXISTING SIGN 6. PROTECT IN PLACE: EXISTING SECURITY CAMERA TYPICAL AT ALL LOCATIONS

7. PREP / PAINT: UTILITY CONDUITS, CABINETS & HVAC TO MATCH WALL BEYOND. 8. PREP / PAINT: EXISTING SIGNAGE IN PLACE 9. PREP / PAINT: EXISTING LOUVERS AND/OR VENTS, TYPICAL

10. REMOVE / PAINT WALL / REINSTALL: LIGHT FIXTURE ESCUTCHEON PLATE OR LIGHT FIXTURE ITSELF TO WALL SURFACE BEHIND. TYPICAL AT ALL LIGHT FIXTURES U.N.O.

11. PREP / PAINT: EXISTING GUTTERS AND DOWNSPOUTS. PAINT COLOR 4 12. PROTECT IN PLACE: EXISTING GUTTERS AND LEADERHEADS 13. PROTECT IN PLACE: EXISTING LIGHT FIXTURE / SPEAKER / FIRE ALARM DEVICE

14. PREP / PAINT: EXISTING HVAC DUCTWORK WHERE ALREADY PAINTED. 15. PROTECT IN PLACE: EXISTING MURAL. PAINT WALLS AROUND MURAL TO MATCH EXISTING BUILDING COLOR SCHEME. TOUCH-UP/REPAINT MURALS WHERE PAINTED

TO MATCH EXISTING. 16. PROTECT IN PLACE: EXISTING DRINKING FOUNTAIN 17. PREP / PAINT: EXISTING PAINTED DRINKING FOUNTAIN CANE DETECTION RAILS 18. PREP/STAIN/SEAL: EXISTING WOOD DISPLAY CASES, FIELD VERIFY STAIN COLOR +

SEALER SHEEN 19. REMOVE / DISCARD: EXISTING SIGN

20. REMOVE / SALVAGE TO ARCHITECT: EXISTING SIGN 21. REMOVE ACCESSIBLE SIGN / PAINT WALL / REINSTALL 22. PROTECT IN PLACE: EXISTING CONCRETE, CMU OR TILE 23. PREP / PAINT: EXISTING CONCRETE / CMU WALL

24. PREP / PAINT: EXISTING METAL FENCE & GATE 25. PROTECT IN PLACE: EXISTING MECHANICAL EQUIPMENT 26. PREP / PAINT: EXISTING ROLL-UP DOOR

27. PREP / PAINT: EXISTING STORAGE CONTAINER, ALL SIDES AND TOP, PAINT COLOR 2 28. PREP / PAINT: EXISTING WOOD BENCH / SEATS AND SLEEERS.

29. PREP / PAINT: EXISTING CMU WALLS. PAINT INSIDE AND OUTSIDE OF ENCLOSURE AND DOORS. 30. PREP / PRIME / PAINT: PAVILION PLASTERED SURFACES & EAVES

31. PREP / PAINT: EXISTING DOOR OR WINDOW METAL SECURITY GRATING 32. PATCH / REPAIR / PREP / PRIME / PAINT: EXISTING PLASTER, SEE 1&3/A-201 33. PREP / PAINT: METAL PARAPET WALL CAP

34. PREP / PAINT: PLASTERED ROOF TOP EQUIPMENT SCREEN WALLS INSIDE AND OUT 35. CONTINUE WAINSCOAT AROUND ENTIRE PERIMETER OF BUILDING INCLUDING RECESSED DOOR AND WINDOW RETURNS

36. PREP / PAINT: EXISTING RAIL 37. REMOVE / REPLACE CEILING LIGHTS, OWNER PROVIDED 38. EXISTING MURAL, PAINT OVER MURAL

39. REMOVE AND REPLACE EXISTING EQUIPMENT CLOSET DOOR, FRAME, HARDWARE AND LOUVER, PAINT COLOR 2 40. PROTECT IN PLACE: EXISTING SIGN/PLAQUE

41. REMOVE EXISTING STRUCTURE 42. PREP/PAINT SAFETY YELLOW 43. REMOVE/PAINT/REINSTALL EQUIPMENT

44. REPAIR/REPLACE/PAINT: DAMAGED WOOD EAVE 45. PREP/PAINT: EXISTING WINDOW FRAMES & MUNTINS

46. REMOVE/DISCARD AS NOTED 47. PROTECT IN PLACE AS NOTED

GENERAL NOTES

1. BUILDING PLANS ARE SCHEMATIC TO ONLY SHOW APPROXIMATE OVERALL BUILDING DIMENSIONS, DOOR QUANTITIES AND APPROXIMATE DOOR LOCATIONS AND ARE PROVIDED AS A CONVENIENCE FOR BIDDING. FIELD VERIFY CONDITIONS PRIOR TO BID. REFER TO SHEET KEYNOTES, PHOTOS, AND LEGENDS FOR ADDITIONAL INFORMATION.

2. ALL EXISTING PAINTED EXTERIOR WALLS OF BUILDING, PAINTED ROOF EAVES, OVERHANGS, CONDUITS, CABINTES, LOUVERS, VENTS, DUCTS AND ROOF EAVES AND GABLES INCLUDED IN THE SCOPE OF WORK ARE TO BE REPAINTED COLORS AS LISTED AND AS DETAILED IN THESE DRAWINGS AND SPECIFICATIONS UNLESS

NOTED OTHERWISE. 3. ALL EXISTING UNPAINTED EXTERIOR SURFACES ARE TO REMAIN UNPAINTED UNLESS NOTED OTHERWISE. PROTECT IN PLACE ALL UNPAINTED SURFACES. 4. CAREFULLY PRUNE SHRUBS AND PLANTS AND REMOVE WEEDS AND PLANTINGS AT

BASE OF WALL TO BARE EARTH TO ALLOW FOR COMPLETE WALL COVERAGE. 5. EXISTING PAINTED DOORS, DOOR FRAMES, DOOR TRIM, WINDOW FRAMES, MULLIONS, AND SEALANTS TO REMAIN UNLESS NOTED OTHERWISE. DO NOT PAINT ALUMINUM WINDOWS. PROTECT IN PLACE.

6. TYPICAL WORK AT EXISTING SIGNS TO REMAIN: REMOVE SIGN, PAINT BEHIND SIGN, CLEAN SIGN, REINSTALL SIGN UNLESS NOTED OTHERWISE.

COLOR LEGEND AND NOTES

COLOR 1 - SWISS COFFEE DUNN EDWARDS DEW341 COLOR 2 - ROYAL GREY DUNN EDWARDS, MATCH EXISTING COLOR 3 - WILD CURRANT SHERWIN WILLIAMS SW7583

COLOR 4 - MATCH TERRA COTTA ROOF TILE, FIELD VERIFY

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SYMBOL LEGEND



EXISTING DOOR: FIELD VERIFY SIZES AND CONDITIONS, PAINT DOOR WARNING STRIPING ON LANDING AT ALL OUTSWINGING EXTERIOR DOORS U.N.O.



EXISTING RESTROOM DOOR: FIELD VERIFY SIZES AND CONDITIONS, PAINT DOOR WARNING STRIPING ON LANDING AT ALL OUTSWINGING EXTERIOR DOORS U.N.O. PAINT EXTERIOR DOOR FACE, FRAME EXTERIOR AND INTERIOR JAMB TO FACE OF DOOR STOP. APPLY RESTROOM IDENTIFICATION DOOR SIGNAGE ON EXTERIOR AND INTERIOR WHERE DOORS ARE PROPPED OPEN. SEE 1/A-201.



EXISTING CLASSROOM DOOR, PAINT WARNING STRIPING ON LANDING AT ALL OUTSWINGING EXTERIOR DOORS U.N.O., REMOVE AND REPLACE TRANSOM DOOR LOUVERS AND INFILL WITH 2x LUMBER, INSULTATION, AND GYPSUM SHEATHING, PAINT ENTIRE DOOR AND FRAME COLOR 2



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A-109

BUILDING A

TYP COLUMNS THIS WING 3

DATE: 05/14/21

SHEET NUMBER:



BUILDING G [/] 1/8" = 1'-0"

GENERAL NOTES

1. BUILDING PLANS ARE SCHEMATIC TO ONLY SHOW APPROXIMATE OVERALL BUILDING DIMENSIONS, DOOR QUANTITIES AND APPROXIMATE DOOR LOCATIONS AND ARE PROVIDED AS A CONVENIENCE FOR BIDDING. FIELD VERIFY CONDITIONS PRIOR TO BID. REFER TO SHEET KEYNOTES, PHOTOS, AND LEGENDS FOR ADDITIONAL INFORMATION.

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3. ALL EXISTING UNPAINTED EXTERIOR SURFACES ARE TO REMAIN UNPAINTED UNLESS NOTED OTHERWISE. PROTECT IN PLACE ALL UNPAINTED SURFACES. 4. CAREFULLY PRUNE SHRUBS AND PLANTS AND REMOVE WEEDS AND PLANTINGS AT BASE OF WALL TO BARE EARTH TO ALLOW FOR COMPLETE WALL COVERAGE. 5. EXISTING PAINTED DOORS, DOOR FRAMES, DOOR TRIM, WINDOW FRAMES, MULLIONS, AND SEALANTS TO REMAIN UNLESS NOTED OTHERWISE. DO NOT PAINT ALUMINUM WINDOWS. PROTECT IN PLACE.

6. TYPICAL WORK AT EXISTING SIGNS TO REMAIN: REMOVE SIGN, PAINT BEHIND SIGN, CLEAN SIGN, REINSTALL SIGN UNLESS NOTED OTHERWISE.

COLOR LEGEND AND NOTES

COLOR 1 - SWISS COFFEE **DUNN EDWARDS DEW341** COLOR 2 - ROYAL GREY DUNN EDWARDS, MATCH EXISTING

COLOR 3 - WILD CURRANT SHERWIN WILLIAMS SW7583

COLOR 4 - MATCH TERRA COTTA ROOF TILE, FIELD VERIFY

1. PHOTOS WITH KEYNOTES ARE CREATED ELECTRONICALLY AND ARE INTENDED TO BE VIEWED IN COLOR TO SEE LOCATIONS OF COLORS ON THE BUILDINGS. CONTRACTOR SHALL FIELD VERIFY ACTUAL LOCATIONS AND DIMENSIONS OF COLORS PRIOR TO BID.

SHEET KEYNOTES

NOTE: NOT ALL KEYNOTES

USED ON EVERY SHEET

1. PAINT COLOR 1 2. PAINT COLOR 2

3. PAINT COLOR 3

4. PAINT COLOR 4

5. REMOVE / PAINT WALL / REINSTALL: EXISTING SIGN

6. PROTECT IN PLACE: EXISTING SECURITY CAMERA TYPICAL AT ALL LOCATIONS

7. PREP / PAINT: UTILITY CONDUITS, CABINETS & HVAC TO MATCH WALL BEYOND. 8. PREP / PAINT: EXISTING SIGNAGE IN PLACE

9. PREP / PAINT: EXISTING LOUVERS AND/OR VENTS, TYPICAL

10. REMOVE / PAINT WALL / REINSTALL: LIGHT FIXTURE ESCUTCHEON PLATE OR LIGHT FIXTURE ITSELF TO WALL SURFACE BEHIND. TYPICAL AT ALL LIGHT FIXTURES U.N.O.

11. PREP / PAINT: EXISTING GUTTERS AND DOWNSPOUTS. PAINT COLOR 4 12. PROTECT IN PLACE: EXISTING GUTTERS AND LEADERHEADS

13. PROTECT IN PLACE: EXISTING LIGHT FIXTURE / SPEAKER / FIRE ALARM DEVICE 14. PREP / PAINT: EXISTING HVAC DUCTWORK WHERE ALREADY PAINTED. 15. PROTECT IN PLACE: EXISTING MURAL. PAINT WALLS AROUND MURAL TO MATCH

EXISTING BUILDING COLOR SCHEME. TOUCH-UP/REPAINT MURALS WHERE PAINTED

TO MATCH EXISTING. 16. PROTECT IN PLACE: EXISTING DRINKING FOUNTAIN

17. PREP / PAINT: EXISTING PAINTED DRINKING FOUNTAIN CANE DETECTION RAILS 18. PREP/STAIN/SEAL: EXISTING WOOD DISPLAY CASES, FIELD VERIFY STAIN COLOR +

SEALER SHEEN

19. REMOVE / DISCARD: EXISTING SIGN 20. REMOVE / SALVAGE TO ARCHITECT: EXISTING SIGN

21. REMOVE ACCESSIBLE SIGN / PAINT WALL / REINSTALL

22. PROTECT IN PLACE: EXISTING CONCRETE, CMU OR TILE 23. PREP / PAINT: EXISTING CONCRETE / CMU WALL

24. PREP / PAINT: EXISTING METAL FENCE & GATE

25. PROTECT IN PLACE: EXISTING MECHANICAL EQUIPMENT

26. PREP / PAINT: EXISTING ROLL-UP DOOR 27. PREP / PAINT: EXISTING STORAGE CONTAINER, ALL SIDES AND TOP, PAINT COLOR 2

28. PREP / PAINT: EXISTING WOOD BENCH / SEATS AND SLEEERS. 29. PREP / PAINT: EXISTING CMU WALLS. PAINT INSIDE AND OUTSIDE OF ENCLOSURE

AND DOORS. 30. PREP / PRIME / PAINT: PAVILION PLASTERED SURFACES & EAVES

31. PREP / PAINT: EXISTING DOOR OR WINDOW METAL SECURITY GRATING

32. PATCH / REPAIR / PREP / PRIME / PAINT: EXISTING PLASTER, SEE 1&3/A-201

33. PREP / PAINT: METAL PARAPET WALL CAP 34. PREP / PAINT: PLASTERED ROOF TOP EOUIPMENT SCREEN WALLS INSIDE AND OUT

35. CONTINUE WAINSCOAT AROUND ENTIRE PERIMETER OF BUILDING INCLUDING RECESSED DOOR AND WINDOW RETURNS 36. PREP / PAINT: EXISTING RAIL

37. REMOVE / REPLACE CEILING LIGHTS, OWNER PROVIDED 38. EXISTING MURAL, PAINT OVER MURAL

39. REMOVE AND REPLACE EXISTING EQUIPMENT CLOSET DOOR, FRAME, HARDWARE

AND LOUVER, PAINT COLOR 2 40. PROTECT IN PLACE: EXISTING SIGN/PLAQUE

41. REMOVE EXISTING STRUCTURE

42. PREP/PAINT SAFETY YELLOW 43. REMOVE/PAINT/REINSTALL EQUIPMENT


44. REPAIR/REPLACE/PAINT: DAMAGED WOOD EAVE

45. PREP/PAINT: EXISTING WINDOW FRAMES & MUNTINS 46. REMOVE/DISCARD AS NOTED


47. PROTECT IN PLACE AS NOTED SYMBOL LEGEND



EXISTING DOOR: FIELD VERIFY SIZES AND CONDITIONS, PAINT DOOR WARNING STRIPING ON LANDING AT ALL OUTSWINGING EXTERIOR DOORS U.N.O.

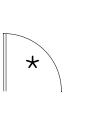

EXISTING RESTROOM DOOR: FIELD VERIFY SIZES AND CONDITIONS, PAINT DOOR WARNING STRIPING ON LANDING AT ALL OUTSWINGING EXTERIOR DOORS U.N.O. PAINT EXTERIOR DOOR FACE, FRAME EXTERIOR AND INTERIOR JAMB TO FACE OF DOOR STOP. APPLY RESTROOM IDENTIFICATION DOOR SIGNAGE ON EXTERIOR AND INTERIOR WHERE DOORS ARE PROPPED OPEN. SEE

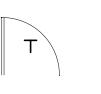

EXISTING CLASSROOM DOOR, PAINT WARNING STRIPING ON LANDING AT ALL OUTSWINGING EXTERIOR DOORS U.N.O., REMOVE AND REPLACE TRANSOM DOOR LOUVERS AND INFILL WITH 2x LUMBER, INSULTATION, AND GYPSUM SHEATHING, PAINT ENTIRE DOOR AND FRAME COLOR 2

HARTMANNARCHITECTURESTUDIO.COM 430 S. CARRILLO RD. OJAI, CALIFORNIA 93023 (805) 530-5559

CONSULTANTS:

AGENCY APPROVAL:

SEALS:



MATILIJA MS CAMPUS -WIDE EXTERIOR PAINTING

OWNER:

OJAI UNIFIED SCHOOL DISTRICT 414 EAST OJAI AVENUE OJAI, CA 93023 (805) 640-4300 **CONTACT: ADAM DUTTER**

EMAIL: adutter@ojaiusd.org

PROJECT ADDRESS:

MATILIJA MIDDLE SCHOOL 703 EL PASEO ROAD OJAI, CA 93023

OJAI USD PROJECT NO.: 2021-1600

ISSUE: MARK DATE DESCRIPTION

PROJECT INFORMATION:

PROJECT NUMBER: PROJECT PHASE: DRAWN BY:

REVIEWED BY:

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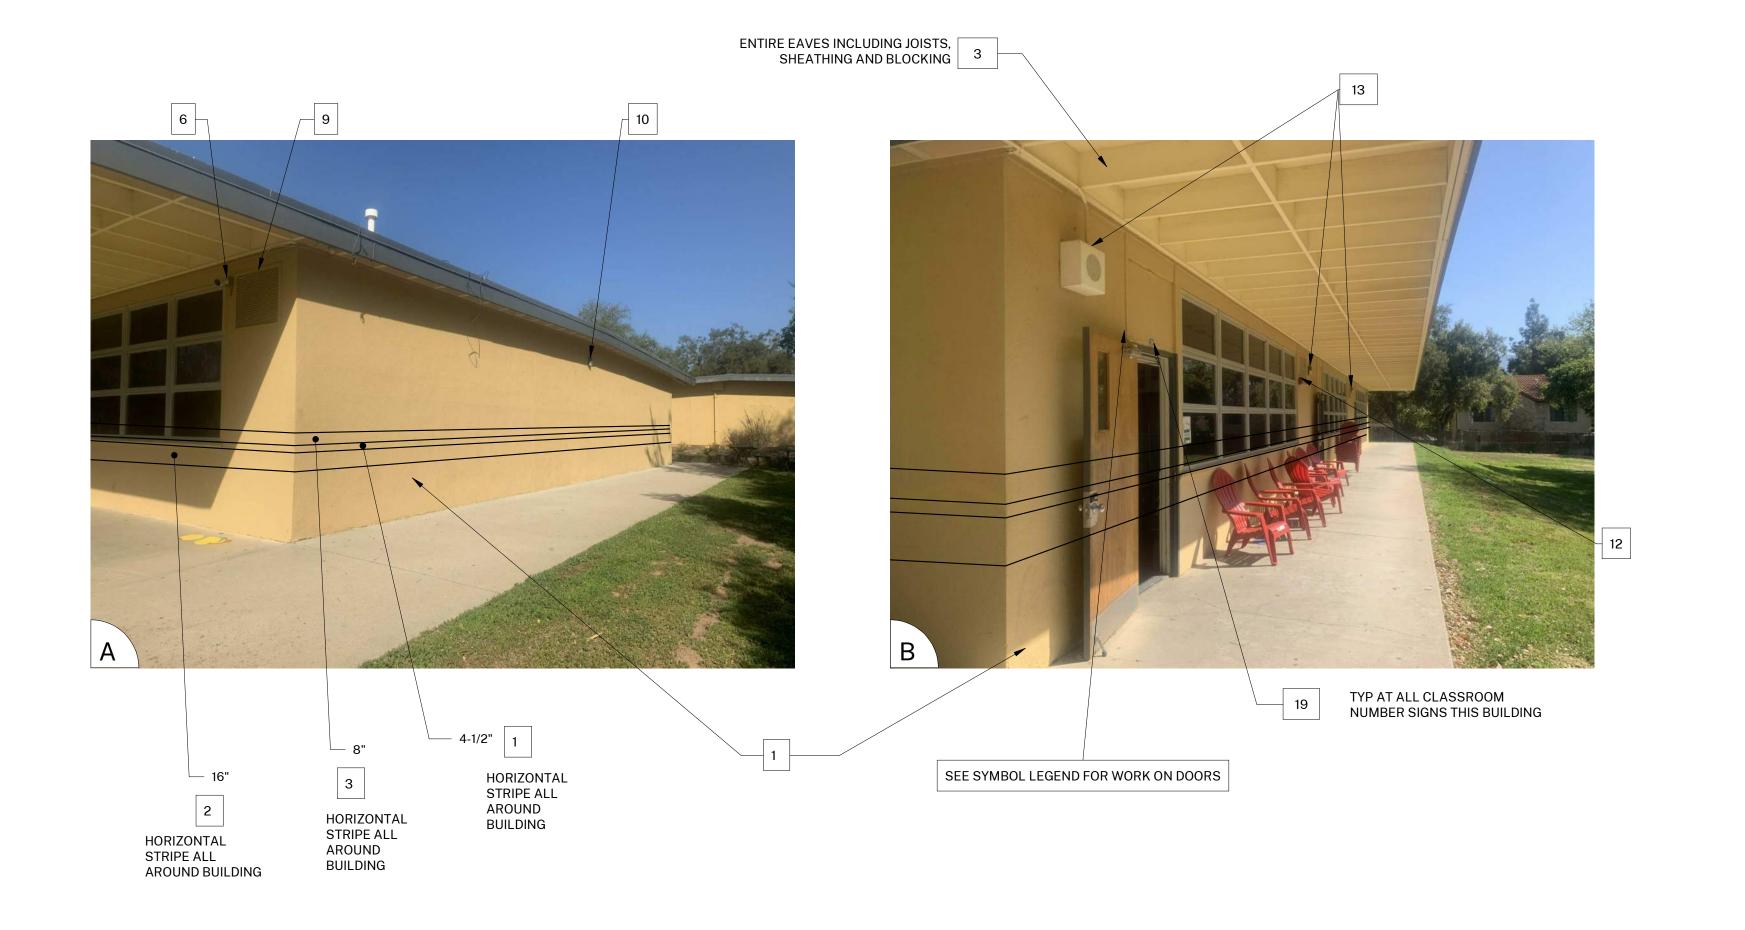
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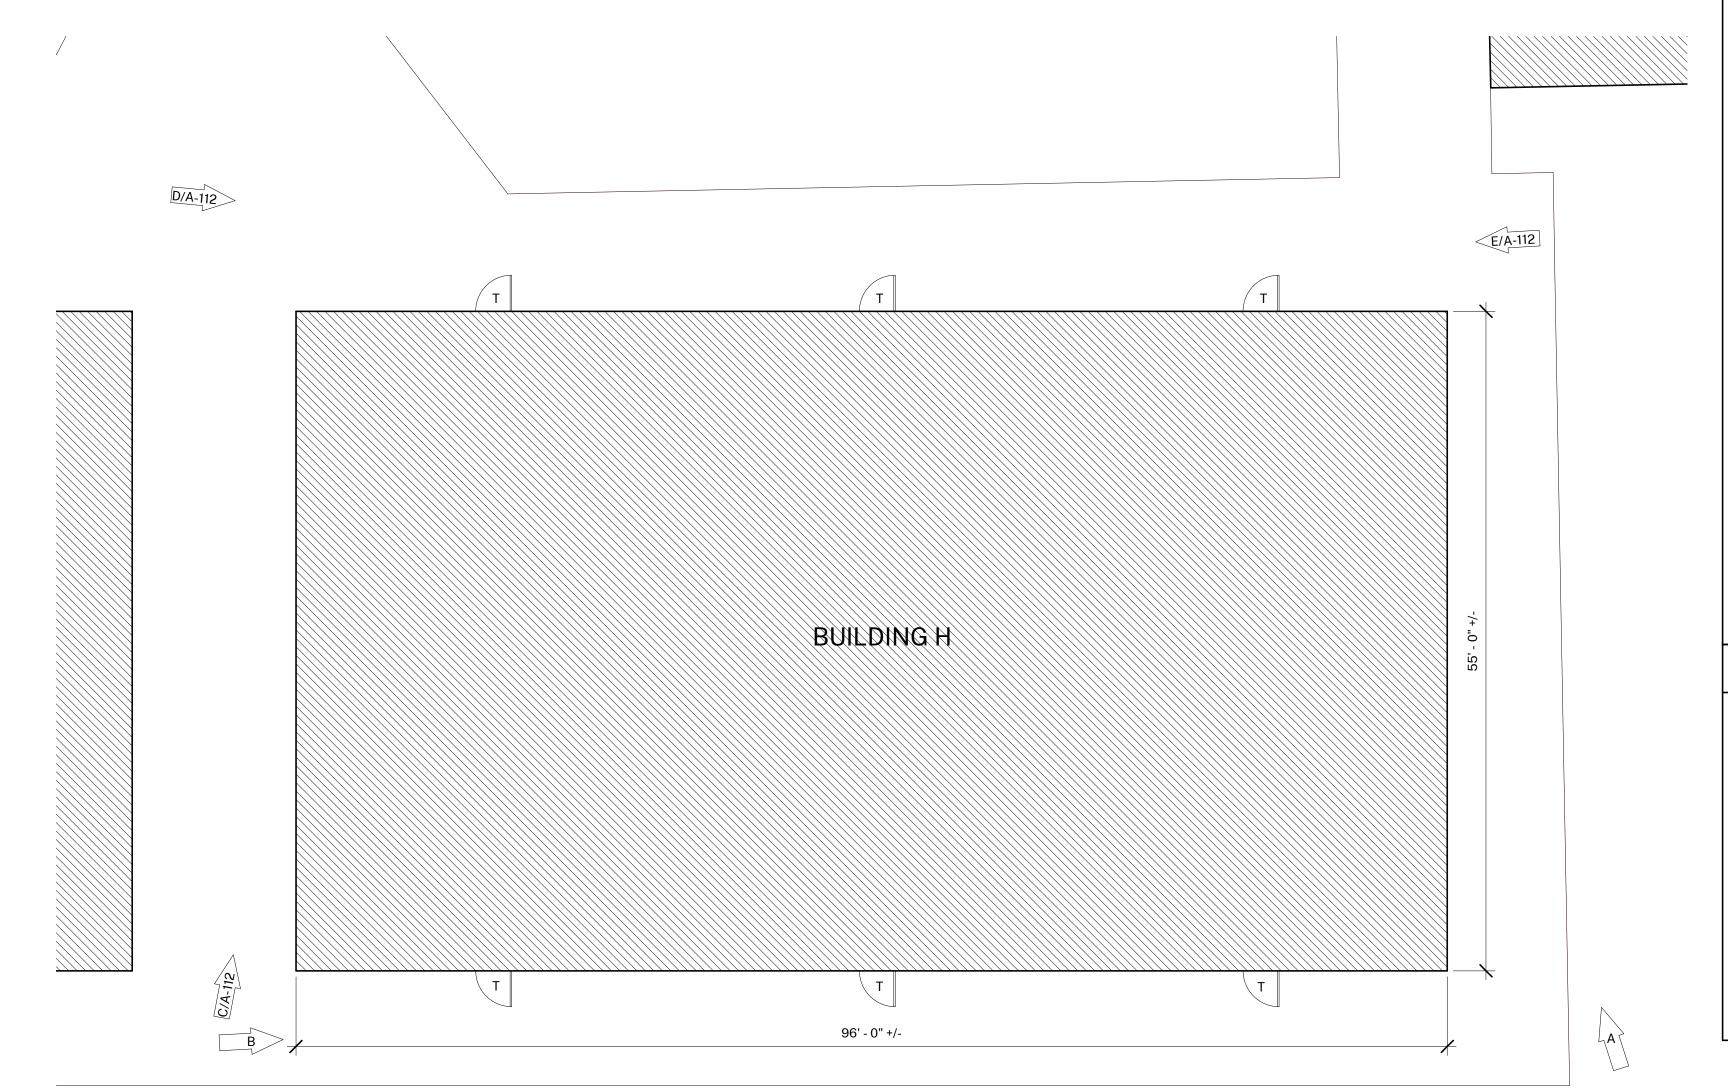
BUILDING G

SHEET NUMBER:

A-110

2021.010





1. BUILDING PLANS ARE SCHEMATIC TO ONLY SHOW APPROXIMATE OVERALL BUILDING DIMENSIONS, DOOR QUANTITIES AND APPROXIMATE DOOR LOCATIONS AND ARE PROVIDED AS A CONVENIENCE FOR BIDDING. FIELD VERIFY CONDITIONS PRIOR TO BID. REFER TO SHEET KEYNOTES, PHOTOS, AND LEGENDS FOR ADDITIONAL INFORMATION.

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ALUMINUM WINDOWS. PROTECT IN PLACE. 6. TYPICAL WORK AT EXISTING SIGNS TO REMAIN: REMOVE SIGN, PAINT BEHIND SIGN, CLEAN SIGN, REINSTALL SIGN UNLESS NOTED OTHERWISE.

HARTMANNARCHITECTURESTUDIO.COM 430 S. CARRILLO RD. OJAI, CALIFORNIA 93023 (805) 530-5559

CONSULTANTS:

AGENCY APPROVAL:

COLOR LEGEND AND NOTES

COLOR 1 - SWISS COFFEE DUNN EDWARDS DEW341 DUNN EDWARDS, MATCH EXISTING COLOR 2 - ROYAL GREY COLOR 3 - WILD CURRANT SHERWIN WILLIAMS SW7583

COLOR 4 - MATCH TERRA COTTA ROOF TILE, FIELD VERIFY

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SHEET KEYNOTES

NOTE: NOT ALL KEYNOTES **USED ON EVERY SHEET**

1. PAINT COLOR 1

2. PAINT COLOR 2

3. PAINT COLOR 3

4. PAINT COLOR 4 5. REMOVE / PAINT WALL / REINSTALL: EXISTING SIGN

6. PROTECT IN PLACE: EXISTING SECURITY CAMERA TYPICAL AT ALL LOCATIONS 7. PREP / PAINT: UTILITY CONDUITS, CABINETS & HVAC TO MATCH WALL BEYOND.

8. PREP / PAINT: EXISTING SIGNAGE IN PLACE

9. PREP / PAINT: EXISTING LOUVERS AND/OR VENTS, TYPICAL 10. REMOVE / PAINT WALL / REINSTALL: LIGHT FIXTURE ESCUTCHEON PLATE OR LIGHT FIXTURE ITSELF TO WALL SURFACE BEHIND. TYPICAL AT ALL LIGHT FIXTURES U.N.O.

11. PREP / PAINT: EXISTING GUTTERS AND DOWNSPOUTS. PAINT COLOR 4 12. PROTECT IN PLACE: EXISTING GUTTERS AND LEADERHEADS 13. PROTECT IN PLACE: EXISTING LIGHT FIXTURE / SPEAKER / FIRE ALARM DEVICE

14. PREP / PAINT: EXISTING HVAC DUCTWORK WHERE ALREADY PAINTED. 15. PROTECT IN PLACE: EXISTING MURAL. PAINT WALLS AROUND MURAL TO MATCH EXISTING BUILDING COLOR SCHEME. TOUCH-UP/REPAINT MURALS WHERE PAINTED TO MATCH EXISTING.

16. PROTECT IN PLACE: EXISTING DRINKING FOUNTAIN

17. PREP / PAINT: EXISTING PAINTED DRINKING FOUNTAIN CANE DETECTION RAILS 18. PREP/STAIN/SEAL: EXISTING WOOD DISPLAY CASES, FIELD VERIFY STAIN COLOR + SEALER SHEEN 19. REMOVE / DISCARD: EXISTING SIGN

20. REMOVE / SALVAGE TO ARCHITECT: EXISTING SIGN 21. REMOVE ACCESSIBLE SIGN / PAINT WALL / REINSTALL 22. PROTECT IN PLACE: EXISTING CONCRETE, CMU OR TILE

23. PREP / PAINT: EXISTING CONCRETE / CMU WALL 24. PREP / PAINT: EXISTING METAL FENCE & GATE

25. PROTECT IN PLACE: EXISTING MECHANICAL EQUIPMENT

26. PREP / PAINT: EXISTING ROLL-UP DOOR 27. PREP / PAINT: EXISTING STORAGE CONTAINER, ALL SIDES AND TOP, PAINT COLOR 2

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30. PREP / PRIME / PAINT: PAVILION PLASTERED SURFACES & EAVES 31. PREP / PAINT: EXISTING DOOR OR WINDOW METAL SECURITY GRATING 32. PATCH / REPAIR / PREP / PRIME / PAINT: EXISTING PLASTER, SEE 1&3/A-201

33. PREP / PAINT: METAL PARAPET WALL CAP 34. PREP / PAINT: PLASTERED ROOF TOP EQUIPMENT SCREEN WALLS INSIDE AND OUT 35. CONTINUE WAINSCOAT AROUND ENTIRE PERIMETER OF BUILDING INCLUDING RECESSED DOOR AND WINDOW RETURNS

36. PREP / PAINT: EXISTING RAIL 37. REMOVE / REPLACE CEILING LIGHTS, OWNER PROVIDED 38. EXISTING MURAL, PAINT OVER MURAL

39. REMOVE AND REPLACE EXISTING EQUIPMENT CLOSET DOOR, FRAME, HARDWARE AND LOUVER, PAINT COLOR 2

40. PROTECT IN PLACE: EXISTING SIGN/PLAQUE 41. REMOVE EXISTING STRUCTURE 42. PREP/PAINT SAFETY YELLOW 43. REMOVE/PAINT/REINSTALL EQUIPMENT


44. REPAIR/REPLACE/PAINT: DAMAGED WOOD EAVE 45. PREP/PAINT: EXISTING WINDOW FRAMES & MUNTINS 46. REMOVE/DISCARD AS NOTED

47. PROTECT IN PLACE AS NOTED

SYMBOL LEGEND



EXISTING DOOR: FIELD VERIFY SIZES AND CONDITIONS, PAINT DOOR WARNING STRIPING ON LANDING AT ALL OUTSWINGING EXTERIOR DOORS U.N.O.

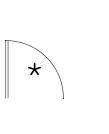

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MATILIJA MS CAMPUS -

WIDE EXTERIOR PAINTING

OWNER:

OJAI UNIFIED SCHOOL DISTRICT 414 EAST OJAI AVENUE OJAI, CA 93023 (805) 640-4300 CONTACT: ADAM DUTTER EMAIL: adutter@ojaiusd.org

PROJECT ADDRESS: MATILIJA MIDDLE SCHOOL 703 EL PASEO ROAD OJAI, CA 93023

ISSUE:

OJAI USD PROJECT NO.: 2021-1600

IARK	DATE	DESCRIPTION

2021.010

PBS

PROJECT INFORMATION: PROJECT NUMBER: PROJECT PHASE:

DRAWN BY: REVIEWED BY:

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BUILDING H

SHEET NUMBER: **A-111**

DATE: 05/14/21

SHEET TITLE:

1 BUILDING H 1/8" = 1'-0"

ENTIRE EAVES INCLUDING JOISTS, SHEATHING AND BLOCKING SEE SYMBOL LEGEND FOR WORK ON DOORS HORIZONTAL 16" 2 HORIZONTAL STRIPE STRIPE ALL ALL AROUND BUILDING AROUND BUILDING HORIZONTAL STRIPE ALL AROUND BUILDING

TYP AT ALL CLASSROOM

SIGNS THIS

NUMBER

BUILDING

GENERAL NOTES

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6. TYPICAL WORK AT EXISTING SIGNS TO REMAIN: REMOVE SIGN, PAINT BEHIND SIGN, CLEAN SIGN, REINSTALL SIGN UNLESS NOTED OTHERWISE.

COLOR LEGEND AND NOTES

DUNN EDWARDS DEW341 COLOR 1 - SWISS COFFEE COLOR 2 - ROYAL GREY DUNN EDWARDS, MATCH EXISTING COLOR 3 - WILD CURRANT SHERWIN WILLIAMS SW7583

COLOR 4 - MATCH TERRA COTTA ROOF TILE, FIELD VERIFY

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SHEET KEYNOTES

NOTE: NOT ALL KEYNOTES

USED ON EVERY SHEET

3. PAINT COLOR 3

1. PAINT COLOR 1 2. PAINT COLOR 2

4. PAINT COLOR 4

5. REMOVE / PAINT WALL / REINSTALL: EXISTING SIGN

6. PROTECT IN PLACE: EXISTING SECURITY CAMERA TYPICAL AT ALL LOCATIONS

7. PREP / PAINT: UTILITY CONDUITS, CABINETS & HVAC TO MATCH WALL BEYOND. 8. PREP / PAINT: EXISTING SIGNAGE IN PLACE

9. PREP / PAINT: EXISTING LOUVERS AND/OR VENTS, TYPICAL

10. REMOVE / PAINT WALL / REINSTALL: LIGHT FIXTURE ESCUTCHEON PLATE OR LIGHT FIXTURE ITSELF TO WALL SURFACE BEHIND. TYPICAL AT ALL LIGHT FIXTURES U.N.O. 11. PREP / PAINT: EXISTING GUTTERS AND DOWNSPOUTS. PAINT COLOR 4

12. PROTECT IN PLACE: EXISTING GUTTERS AND LEADERHEADS 13. PROTECT IN PLACE: EXISTING LIGHT FIXTURE / SPEAKER / FIRE ALARM DEVICE 14. PREP / PAINT: EXISTING HVAC DUCTWORK WHERE ALREADY PAINTED.

15. PROTECT IN PLACE: EXISTING MURAL. PAINT WALLS AROUND MURAL TO MATCH EXISTING BUILDING COLOR SCHEME. TOUCH-UP/REPAINT MURALS WHERE PAINTED TO MATCH EXISTING.

18. PREP/STAIN/SEAL: EXISTING WOOD DISPLAY CASES, FIELD VERIFY STAIN COLOR +

16. PROTECT IN PLACE: EXISTING DRINKING FOUNTAIN 17. PREP / PAINT: EXISTING PAINTED DRINKING FOUNTAIN CANE DETECTION RAILS

SEALER SHEEN 19. REMOVE / DISCARD: EXISTING SIGN

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25. PROTECT IN PLACE: EXISTING MECHANICAL EQUIPMENT

26. PREP / PAINT: EXISTING ROLL-UP DOOR

27. PREP / PAINT: EXISTING STORAGE CONTAINER, ALL SIDES AND TOP, PAINT COLOR 2 28. PREP / PAINT: EXISTING WOOD BENCH / SEATS AND SLEEERS.

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32. PATCH / REPAIR / PREP / PRIME / PAINT: EXISTING PLASTER, SEE 1&3/A-201 33. PREP / PAINT: METAL PARAPET WALL CAP 34. PREP / PAINT: PLASTERED ROOF TOP EQUIPMENT SCREEN WALLS INSIDE AND OUT 35. CONTINUE WAINSCOAT AROUND ENTIRE PERIMETER OF BUILDING INCLUDING RECESSED DOOR AND WINDOW RETURNS

36. PREP / PAINT: EXISTING RAIL 37. REMOVE / REPLACE CEILING LIGHTS, OWNER PROVIDED

38. EXISTING MURAL, PAINT OVER MURAL 39. REMOVE AND REPLACE EXISTING EQUIPMENT CLOSET DOOR, FRAME, HARDWARE

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43. REMOVE/PAINT/REINSTALL EQUIPMENT 44. REPAIR/REPLACE/PAINT: DAMAGED WOOD EAVE 45. PREP/PAINT: EXISTING WINDOW FRAMES & MUNTINS

46. REMOVE/DISCARD AS NOTED

47. PROTECT IN PLACE AS NOTED

ENTIRE EAVES INCLUDING JOISTS, SHEATHING AND BLOCKING

HARTMANNARCHITECTURESTUDIO.COM

430 S. CARRILLO RD. OJAI, CALIFORNIA 93023 (805) 530-5559

CONSULTANTS:

AGENCY APPROVAL:

MATILIJA MS CAMPUS -

WIDE EXTERIOR PAINTING

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OJAI USD PROJECT NO.: 2021-1600

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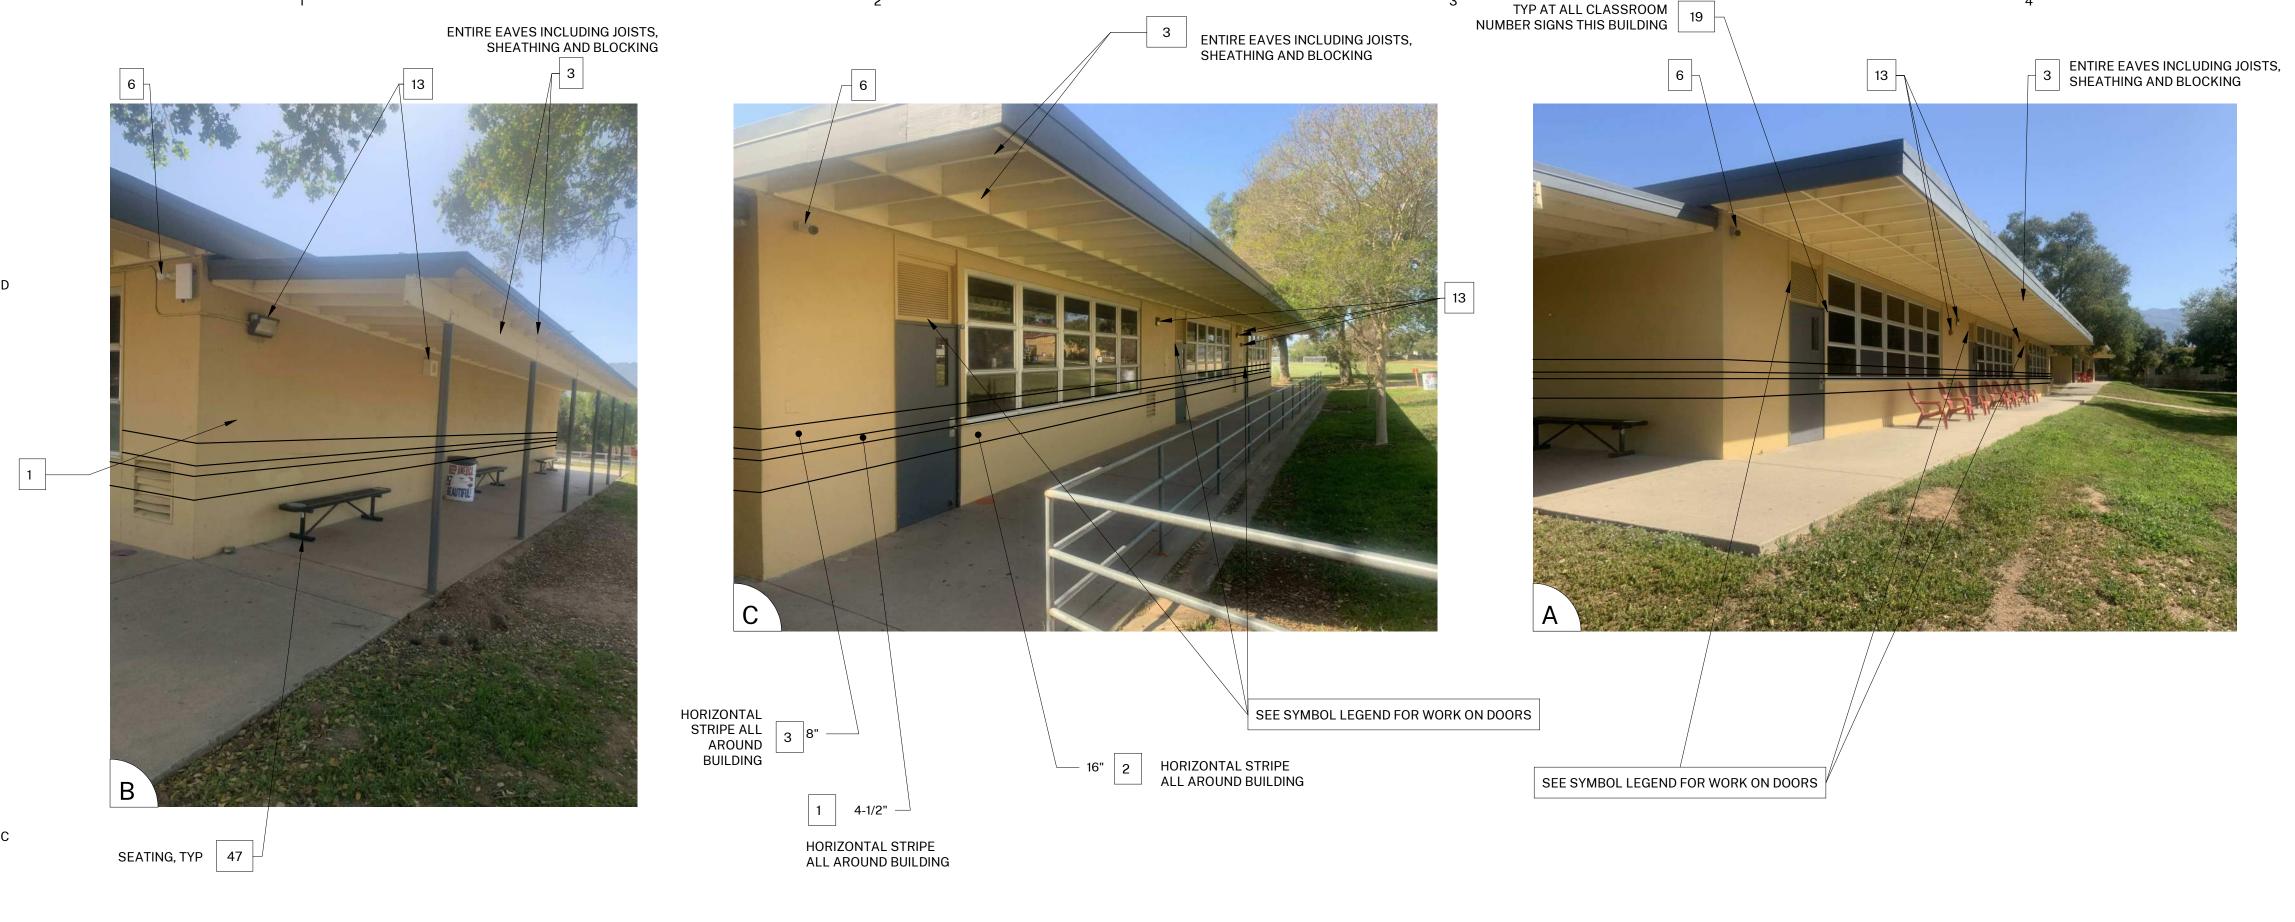
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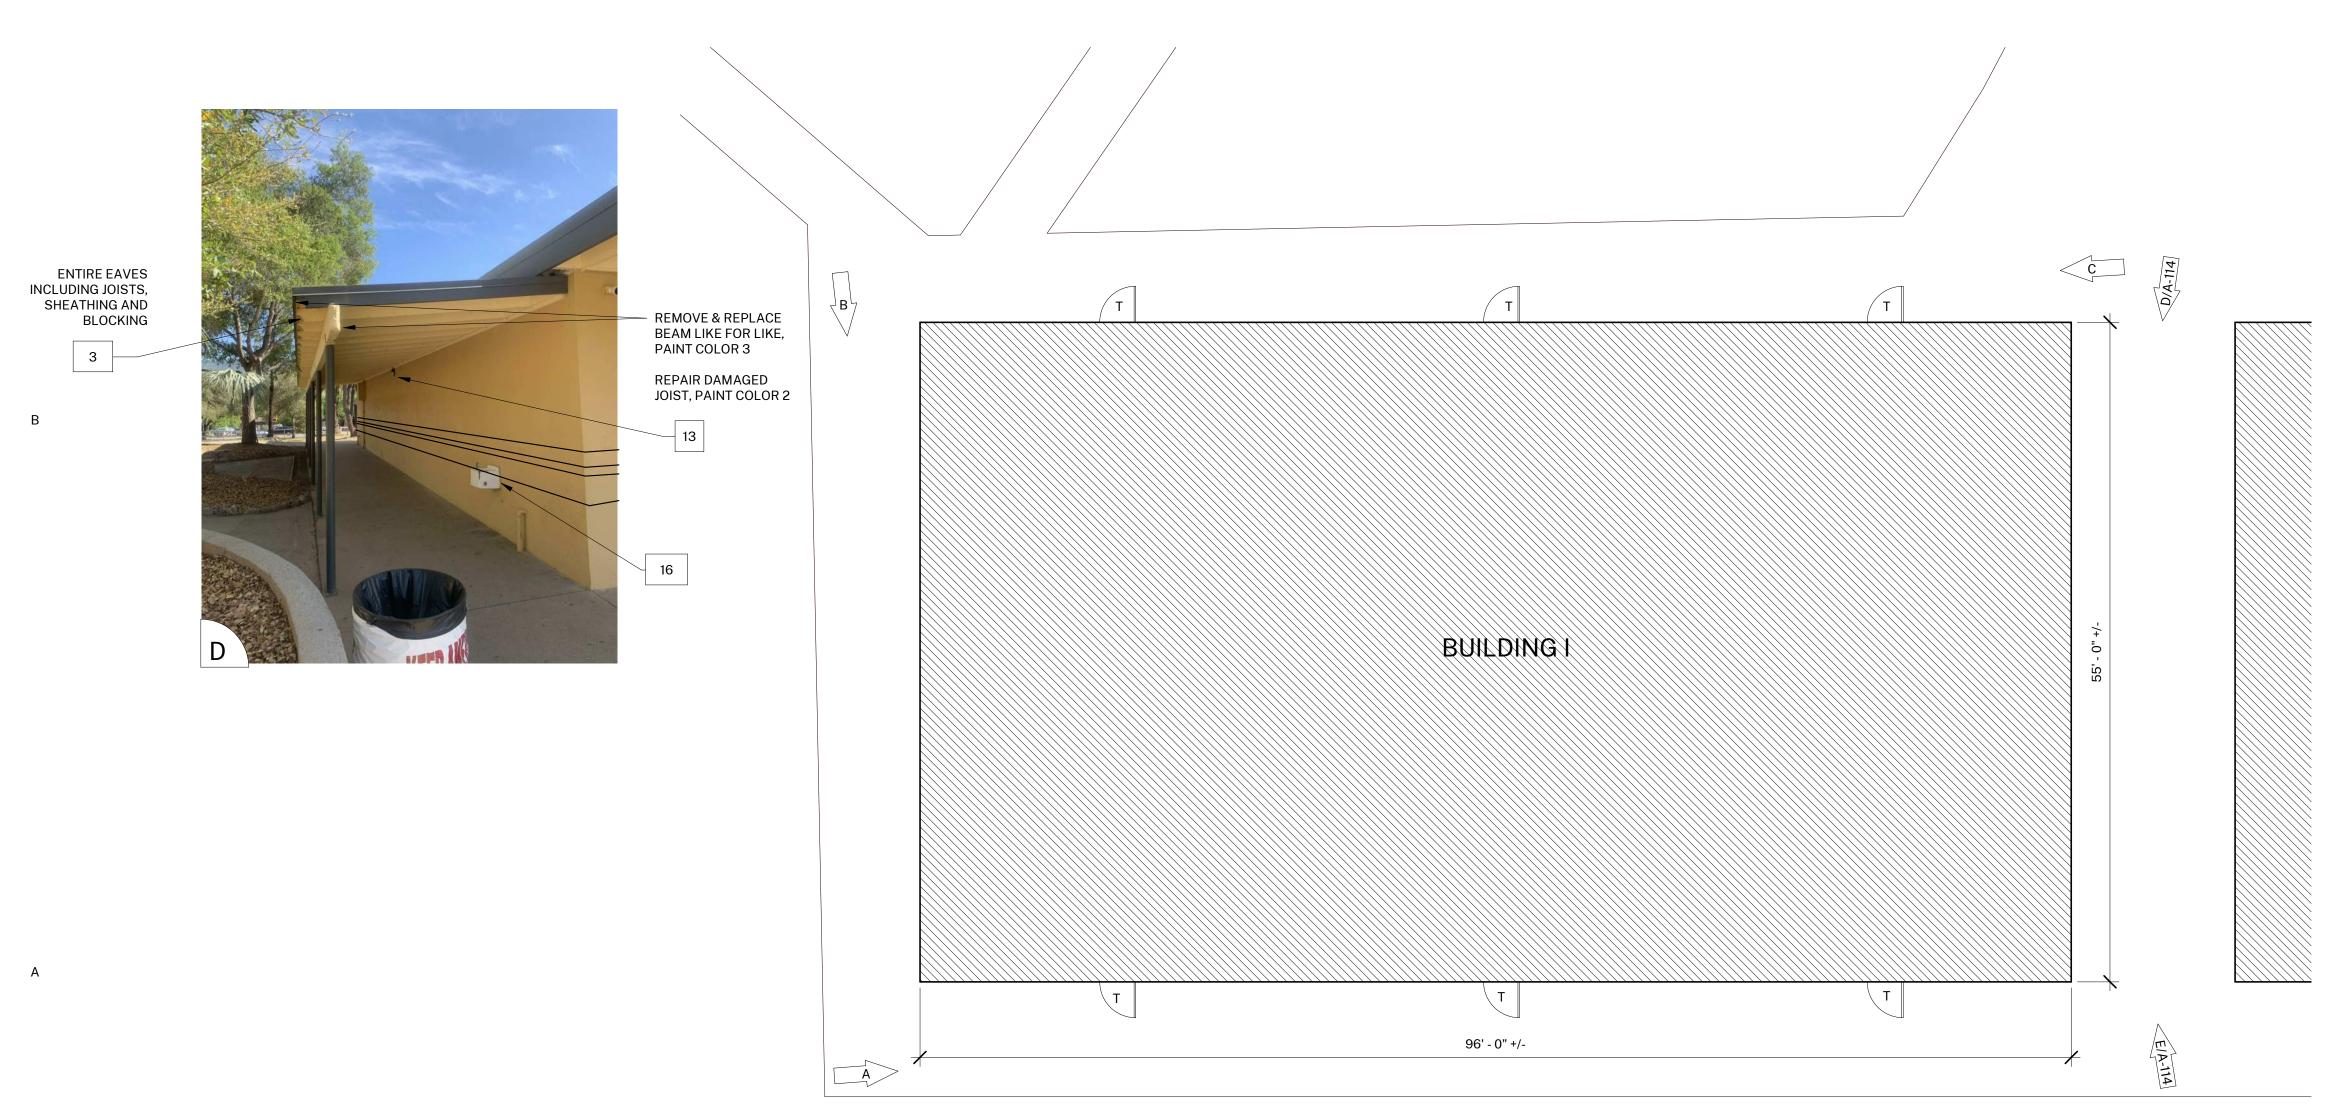
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SHEET TITLE:

BUILDING H

SHEET NUMBER:





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- ALUMINUM WINDOWS. PROTECT IN PLACE. 6. TYPICAL WORK AT EXISTING SIGNS TO REMAIN: REMOVE SIGN, PAINT BEHIND SIGN, CLEAN SIGN, REINSTALL SIGN UNLESS NOTED OTHERWISE.

COLOR LEGEND AND NOTES

COLOR 1 - SWISS COFFEE **DUNN EDWARDS DEW341** COLOR 2 - ROYAL GREY DUNN EDWARDS, MATCH EXISTING SHERWIN WILLIAMS SW7583

COLOR 3 - WILD CURRANT COLOR 4 - MATCH TERRA COTTA ROOF TILE, FIELD VERIFY

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3. PAINT COLOR 3 4. PAINT COLOR 4

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6. PROTECT IN PLACE: EXISTING SECURITY CAMERA TYPICAL AT ALL LOCATIONS 7. PREP / PAINT: UTILITY CONDUITS, CABINETS & HVAC TO MATCH WALL BEYOND.

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9. PREP / PAINT: EXISTING LOUVERS AND/OR VENTS, TYPICAL 10. REMOVE / PAINT WALL / REINSTALL: LIGHT FIXTURE ESCUTCHEON PLATE OR LIGHT FIXTURE ITSELF TO WALL SURFACE BEHIND. TYPICAL AT ALL LIGHT FIXTURES U.N.O.

11. PREP / PAINT: EXISTING GUTTERS AND DOWNSPOUTS. PAINT COLOR 4 12. PROTECT IN PLACE: EXISTING GUTTERS AND LEADERHEADS 13. PROTECT IN PLACE: EXISTING LIGHT FIXTURE / SPEAKER / FIRE ALARM DEVICE

14. PREP / PAINT: EXISTING HVAC DUCTWORK WHERE ALREADY PAINTED. 15. PROTECT IN PLACE: EXISTING MURAL. PAINT WALLS AROUND MURAL TO MATCH EXISTING BUILDING COLOR SCHEME. TOUCH-UP/REPAINT MURALS WHERE PAINTED

TO MATCH EXISTING. 16. PROTECT IN PLACE: EXISTING DRINKING FOUNTAIN

17. PREP / PAINT: EXISTING PAINTED DRINKING FOUNTAIN CANE DETECTION RAILS 18. PREP/STAIN/SEAL: EXISTING WOOD DISPLAY CASES, FIELD VERIFY STAIN COLOR + SEALER SHEEN

19. REMOVE / DISCARD: EXISTING SIGN 20. REMOVE / SALVAGE TO ARCHITECT: EXISTING SIGN

21. REMOVE ACCESSIBLE SIGN / PAINT WALL / REINSTALL 22. PROTECT IN PLACE: EXISTING CONCRETE, CMU OR TILE

23. PREP / PAINT: EXISTING CONCRETE / CMU WALL

24. PREP / PAINT: EXISTING METAL FENCE & GATE 25. PROTECT IN PLACE: EXISTING MECHANICAL EQUIPMENT

26. PREP / PAINT: EXISTING ROLL-UP DOOR

27. PREP / PAINT: EXISTING STORAGE CONTAINER, ALL SIDES AND TOP, PAINT COLOR 2 28. PREP / PAINT: EXISTING WOOD BENCH / SEATS AND SLEEERS.

29. PREP / PAINT: EXISTING CMU WALLS. PAINT INSIDE AND OUTSIDE OF ENCLOSURE AND DOORS.

30. PREP / PRIME / PAINT: PAVILION PLASTERED SURFACES & EAVES 31. PREP / PAINT: EXISTING DOOR OR WINDOW METAL SECURITY GRATING

32. PATCH / REPAIR / PREP / PRIME / PAINT: EXISTING PLASTER. SEE 1&3/A-201 33. PREP / PAINT: METAL PARAPET WALL CAP 34. PREP / PAINT: PLASTERED ROOF TOP EOUIPMENT SCREEN WALLS INSIDE AND OUT

35. CONTINUE WAINSCOAT AROUND ENTIRE PERIMETER OF BUILDING INCLUDING RECESSED DOOR AND WINDOW RETURNS 36. PREP / PAINT: EXISTING RAIL

37. REMOVE / REPLACE CEILING LIGHTS, OWNER PROVIDED

38. EXISTING MURAL, PAINT OVER MURAL 39. REMOVE AND REPLACE EXISTING EQUIPMENT CLOSET DOOR, FRAME, HARDWARE

AND LOUVER, PAINT COLOR 2 40. PROTECT IN PLACE: EXISTING SIGN/PLAQUE 41. REMOVE EXISTING STRUCTURE

42. PREP/PAINT SAFETY YELLOW 43. REMOVE/PAINT/REINSTALL EQUIPMENT 44. REPAIR/REPLACE/PAINT: DAMAGED WOOD EAVE

45. PREP/PAINT: EXISTING WINDOW FRAMES & MUNTINS 46. REMOVE/DISCARD AS NOTED 47. PROTECT IN PLACE AS NOTED

SYMBOL LEGEND

EXISTING DOOR: FIELD VERIFY SIZES AND CONDITIONS, PAINT DOOR WARNING STRIPING ON LANDING AT ALL OUTSWINGING EXTERIOR DOORS U.N.O.

EXISTING RESTROOM DOOR: FIELD VERIFY SIZES AND CONDITIONS, PAINT DOOR WARNING STRIPING ON LANDING AT ALL OUTSWINGING EXTERIOR DOORS U.N.O. PAINT EXTERIOR DOOR FACE, FRAME EXTERIOR AND INTERIOR JAMB TO FACE OF DOOR STOP. APPLY RESTROOM IDENTIFICATION DOOR SIGNAGE ON EXTERIOR AND INTERIOR WHERE DOORS ARE PROPPED OPEN. SEE 1/A-201.

EXISTING CLASSROOM DOOR, PAINT WARNING STRIPING ON LANDING AT ALL OUTSWINGING EXTERIOR DOORS U.N.O., REMOVE AND REPLACE TRANSOM DOOR LOUVERS AND INFILL WITH 2x LUMBER, INSULTATION, AND GYPSUM SHEATHING, PAINT ENTIRE DOOR AND FRAME COLOR 2

HARTMANNARCHITECTURESTUDIO.COM 430 S. CARRILLO RD. OJAI, CALIFORNIA 93023 (805) 530-5559

CONSULTANTS:

AGENCY APPROVAL:

SEALS:



MATILIJA MS CAMPUS -WIDE EXTERIOR PAINTING

OWNER:

OJAI UNIFIED SCHOOL DISTRICT 414 EAST OJAI AVENUE OJAI, CA 93023 (805) 640-4300 **CONTACT: ADAM DUTTER** EMAIL: adutter@ojaiusd.org

PROJECT ADDRESS: MATILIJA MIDDLE SCHOOL 703 EL PASEO ROAD

OJAI, CA 93023

OJAI USD PROJECT NO.: 2021-1600

ISSUE: MARK DATE DESCRIPTION

PROJECT INFORMATION: PROJECT NUMBER: PROJECT PHASE:

DRAWN BY: REVIEWED BY:

THE ORIGINAL SIZE OF THIS SHEET IS 36"x24". IF THE CURRENT SIZE IS OTHER THAN 36"x24", THEN ADJUST THE SCALE OF THE DRAWINGS ACCORDINGLY.

SHEET TITLE:

BUILDING I

SHEET NUMBER:

A-113

2021.010


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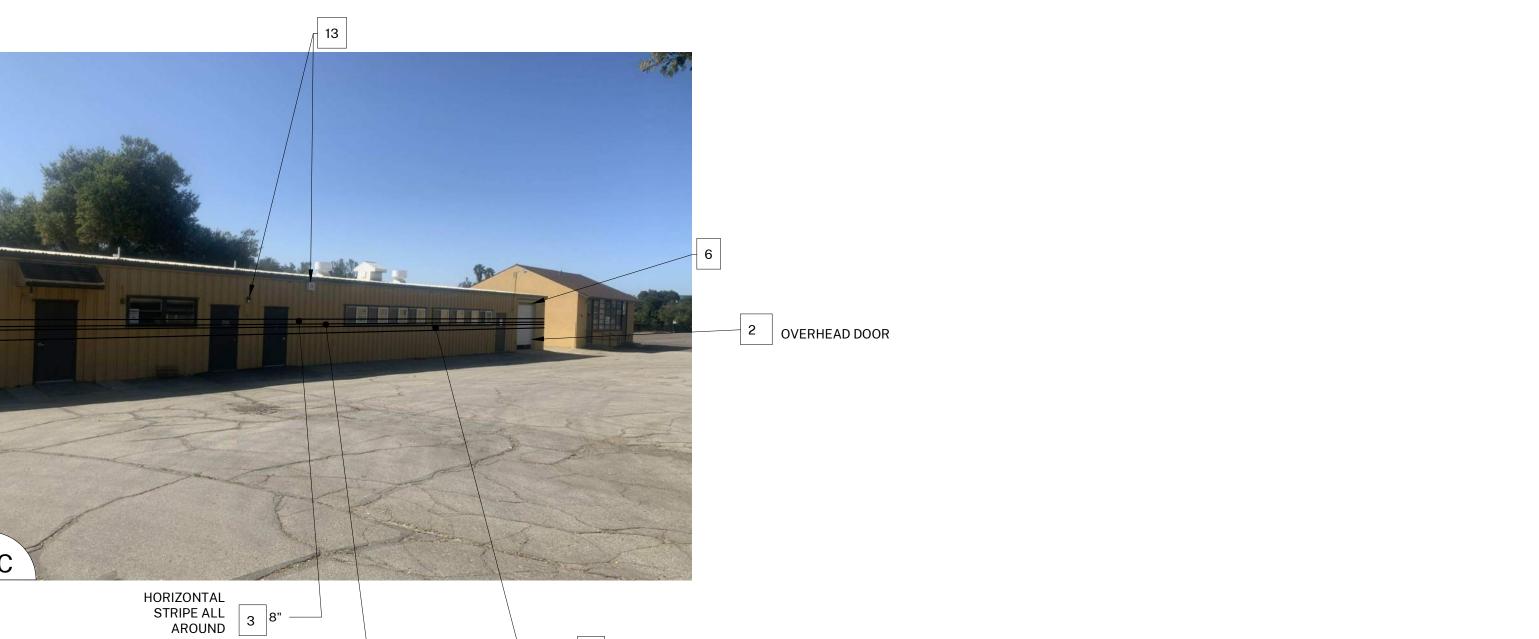
1 BUILDING I 1/8" = 1'-0"




BUILDING

1 BUILDING J 1/8" = 1'-0"



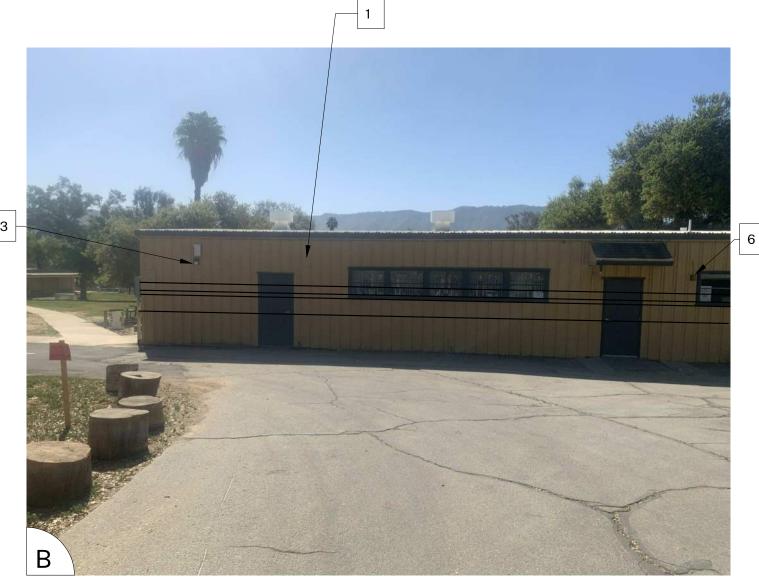

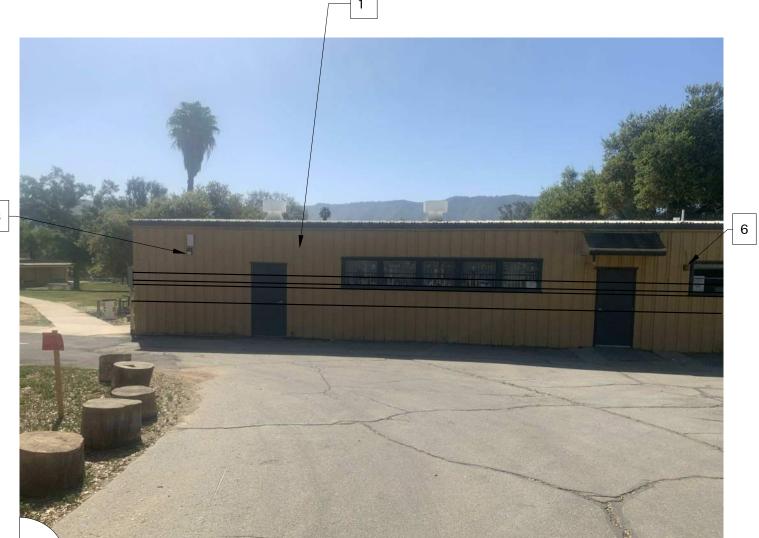

NOTE: NOT ALL KEYNOTES USED ON EVERY SHEET

 PAINT COLOR 1 2. PAINT COLOR 2

3. PAINT COLOR 3 4. PAINT COLOR 4

SHEET KEYNOTES

5. REMOVE / PAINT WALL / REINSTALL: EXISTING SIGN

6. PROTECT IN PLACE: EXISTING SECURITY CAMERA TYPICAL AT ALL LOCATIONS 7. PREP / PAINT: UTILITY CONDUITS, CABINETS & HVAC TO MATCH WALL BEYOND. 8. PREP / PAINT: EXISTING SIGNAGE IN PLACE

9. PREP / PAINT: EXISTING LOUVERS AND/OR VENTS, TYPICAL

10. REMOVE / PAINT WALL / REINSTALL: LIGHT FIXTURE ESCUTCHEON PLATE OR LIGHT FIXTURE ITSELF TO WALL SURFACE BEHIND. TYPICAL AT ALL LIGHT FIXTURES U.N.O. 11. PREP / PAINT: EXISTING GUTTERS AND DOWNSPOUTS. PAINT COLOR 4

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14. PREP / PAINT: EXISTING HVAC DUCTWORK WHERE ALREADY PAINTED. 15. PROTECT IN PLACE: EXISTING MURAL, PAINT WALLS AROUND MURAL TO MATCH EXISTING BUILDING COLOR SCHEME. TOUCH-UP/REPAINT MURALS WHERE PAINTED

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17. PREP / PAINT: EXISTING PAINTED DRINKING FOUNTAIN CANE DETECTION RAILS 18. PREP/STAIN/SEAL: EXISTING WOOD DISPLAY CASES, FIELD VERIFY STAIN COLOR +

SEALER SHEEN 19. REMOVE / DISCARD: EXISTING SIGN 20. REMOVE / SALVAGE TO ARCHITECT: EXISTING SIGN 21. REMOVE ACCESSIBLE SIGN / PAINT WALL / REINSTALL

22. PROTECT IN PLACE: EXISTING CONCRETE, CMU OR TILE 23. PREP / PAINT: EXISTING CONCRETE / CMU WALL 24. PREP / PAINT: EXISTING METAL FENCE & GATE

25. PROTECT IN PLACE: EXISTING MECHANICAL EQUIPMENT 26. PREP / PAINT: EXISTING ROLL-UP DOOR

27. PREP / PAINT: EXISTING STORAGE CONTAINER, ALL SIDES AND TOP, PAINT COLOR 2 28. PREP / PAINT: EXISTING WOOD BENCH / SEATS AND SLEEERS.

29. PREP / PAINT: EXISTING CMU WALLS. PAINT INSIDE AND OUTSIDE OF ENCLOSURE AND DOORS. 30. PREP / PRIME / PAINT: PAVILION PLASTERED SURFACES & EAVES 31. PREP / PAINT: EXISTING DOOR OR WINDOW METAL SECURITY GRATING

32. PATCH / REPAIR / PREP / PRIME / PAINT: EXISTING PLASTER, SEE 1&3/A-201 33. PREP / PAINT: METAL PARAPET WALL CAP 34. PREP / PAINT: PLASTERED ROOF TOP EQUIPMENT SCREEN WALLS INSIDE AND OUT 35. CONTINUE WAINSCOAT AROUND ENTIRE PERIMETER OF BUILDING INCLUDING

RECESSED DOOR AND WINDOW RETURNS 36. PREP / PAINT: EXISTING RAIL

37. REMOVE / REPLACE CEILING LIGHTS, OWNER PROVIDED 38. EXISTING MURAL, PAINT OVER MURAL 39. REMOVE AND REPLACE EXISTING EQUIPMENT CLOSET DOOR, FRAME, HARDWARE

AND LOUVER, PAINT COLOR 2

40. PROTECT IN PLACE: EXISTING SIGN/PLAQUE 41. REMOVE EXISTING STRUCTURE 42. PREP/PAINT SAFETY YELLOW

43. REMOVE/PAINT/REINSTALL EQUIPMENT 44. REPAIR/REPLACE/PAINT: DAMAGED WOOD EAVE

45. PREP/PAINT: EXISTING WINDOW FRAMES & MUNTINS 46. REMOVE/DISCARD AS NOTED

47. PROTECT IN PLACE AS NOTED

GENERAL NOTES

1. BUILDING PLANS ARE SCHEMATIC TO ONLY SHOW APPROXIMATE OVERALL BUILDING DIMENSIONS, DOOR QUANTITIES AND APPROXIMATE DOOR LOCATIONS AND ARE PROVIDED AS A CONVENIENCE FOR BIDDING. FIELD VERIFY CONDITIONS PRIOR TO BID. REFER TO SHEET KEYNOTES, PHOTOS, AND LEGENDS FOR ADDITIONAL INFORMATION.

2. ALL EXISTING PAINTED EXTERIOR WALLS OF BUILDING, PAINTED ROOF EAVES, OVERHANGS, CONDUITS, CABINTES, LOUVERS, VENTS, DUCTS AND ROOF EAVES AND GABLES INCLUDED IN THE SCOPE OF WORK ARE TO BE REPAINTED COLORS AS LISTED AND AS DETAILED IN THESE DRAWINGS AND SPECIFICATIONS UNLESS

NOTED OTHERWISE. 3. ALL EXISTING UNPAINTED EXTERIOR SURFACES ARE TO REMAIN UNPAINTED UNLESS NOTED OTHERWISE. PROTECT IN PLACE ALL UNPAINTED SURFACES.

BASE OF WALL TO BARE EARTH TO ALLOW FOR COMPLETE WALL COVERAGE. 5. EXISTING PAINTED DOORS, DOOR FRAMES, DOOR TRIM, WINDOW FRAMES, MULLIONS, AND SEALANTS TO REMAIN UNLESS NOTED OTHERWISE. DO NOT PAINT ALUMINUM WINDOWS. PROTECT IN PLACE.

6. TYPICAL WORK AT EXISTING SIGNS TO REMAIN: REMOVE SIGN, PAINT BEHIND SIGN, CLEAN SIGN, REINSTALL SIGN UNLESS NOTED OTHERWISE.

4. CAREFULLY PRUNE SHRUBS AND PLANTS AND REMOVE WEEDS AND PLANTINGS AT

COLOR LEGEND AND NOTES

COLOR 1 - SWISS COFFEE DUNN EDWARDS DEW341 COLOR 2 - ROYAL GREY DUNN EDWARDS, MATCH EXISTING

COLOR 3 - WILD CURRANT SHERWIN WILLIAMS SW7583

COLOR 4 - MATCH TERRA COTTA ROOF TILE, FIELD VERIFY

1. PHOTOS WITH KEYNOTES ARE CREATED ELECTRONICALLY AND ARE INTENDED TO BE VIEWED IN COLOR TO SEE LOCATIONS OF COLORS ON THE BUILDINGS. CONTRACTOR SHALL FIELD VERIFY ACTUAL LOCATIONS AND DIMENSIONS OF

SYMBOL LEGEND

COLORS PRIOR TO BID.



EXISTING DOOR: FIELD VERIFY SIZES AND CONDITIONS, PAINT DOOR WARNING STRIPING ON LANDING AT ALL OUTSWINGING EXTERIOR DOORS U.N.O.

EXISTING RESTROOM DOOR: FIELD VERIFY SIZES AND CONDITIONS, PAINT DOOR WARNING STRIPING ON LANDING AT ALL OUTSWINGING EXTERIOR DOORS U.N.O. PAINT EXTERIOR DOOR FACE, FRAME EXTERIOR AND INTERIOR JAMB TO FACE OF DOOR STOP. APPLY RESTROOM IDENTIFICATION DOOR SIGNAGE ON EXTERIOR AND INTERIOR WHERE DOORS ARE PROPPED OPEN. SEE 1/A-201.



EXISTING CLASSROOM DOOR, PAINT WARNING STRIPING ON LANDING AT ALL OUTSWINGING EXTERIOR DOORS U.N.O., REMOVE AND REPLACE TRANSOM DOOR LOUVERS AND INFILL WITH 2x LUMBER, INSULTATION, AND GYPSUM SHEATHING, PAINT ENTIRE DOOR AND FRAME COLOR 2



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PROJECT ADDRESS: MATILIJA MIDDLE SCHOOL 703 EL PASEO ROAD OJAI, CA 93023

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PROJECT INFORMATION: PROJECT NUMBER: PROJECT PHASE:


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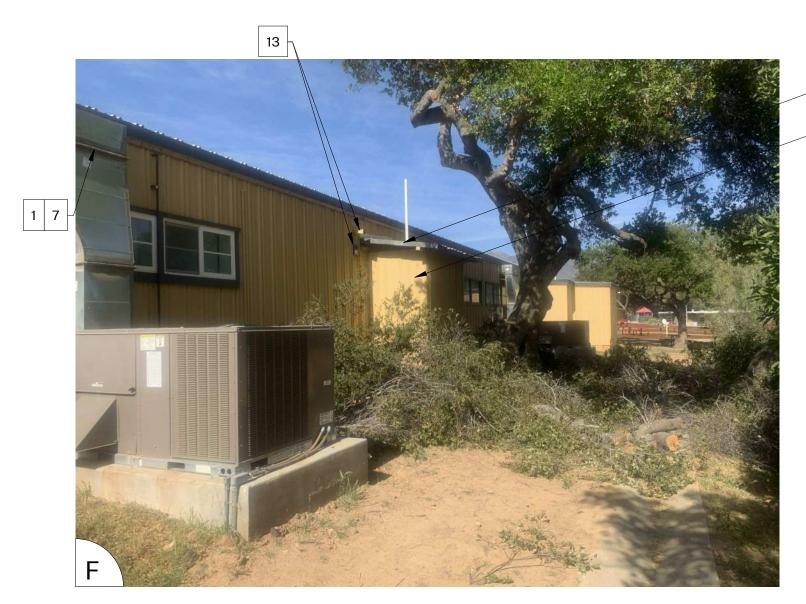
SHEET TITLE:

BUILDING J

SHEET NUMBER:


A-115



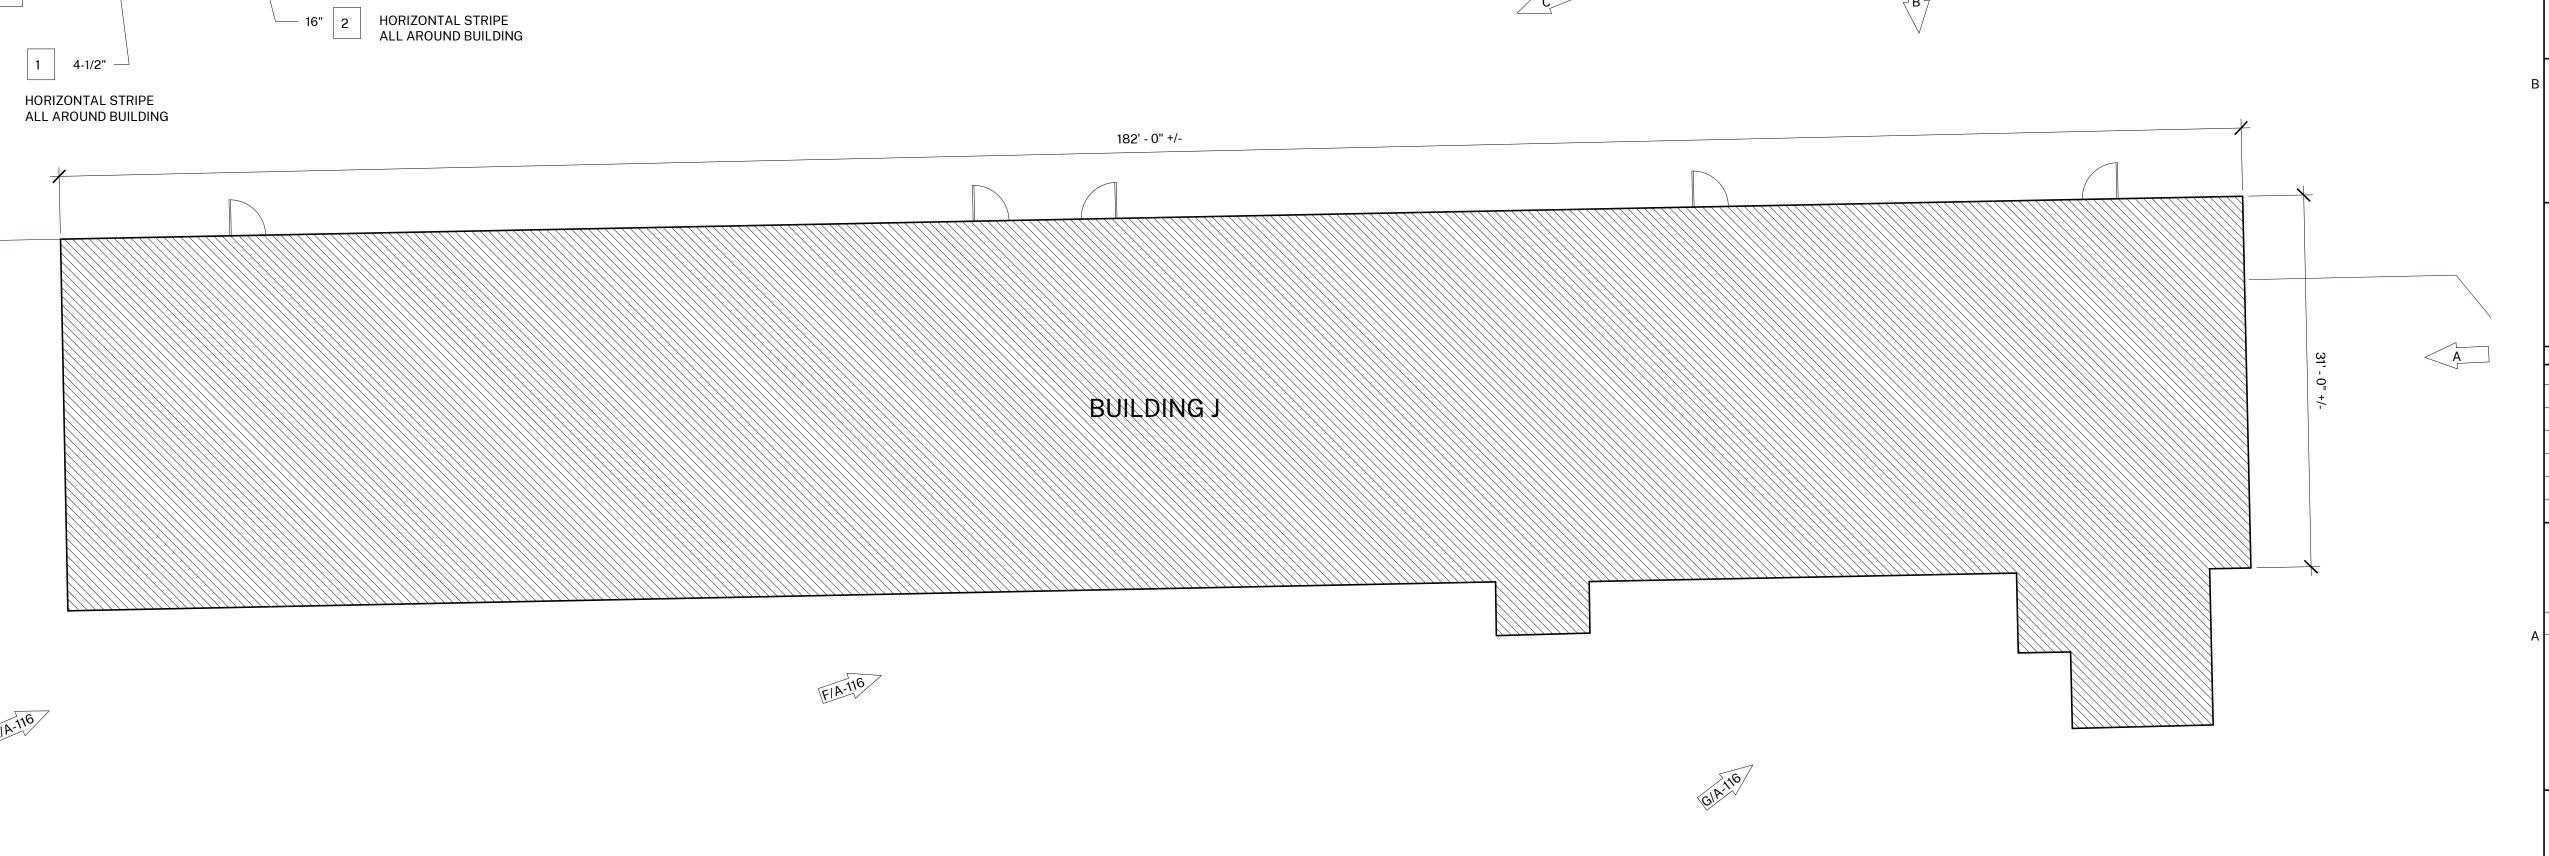

NOTE: DISTRICT TO REPLACE THIS ROOF STRUCTURE WITH NEW



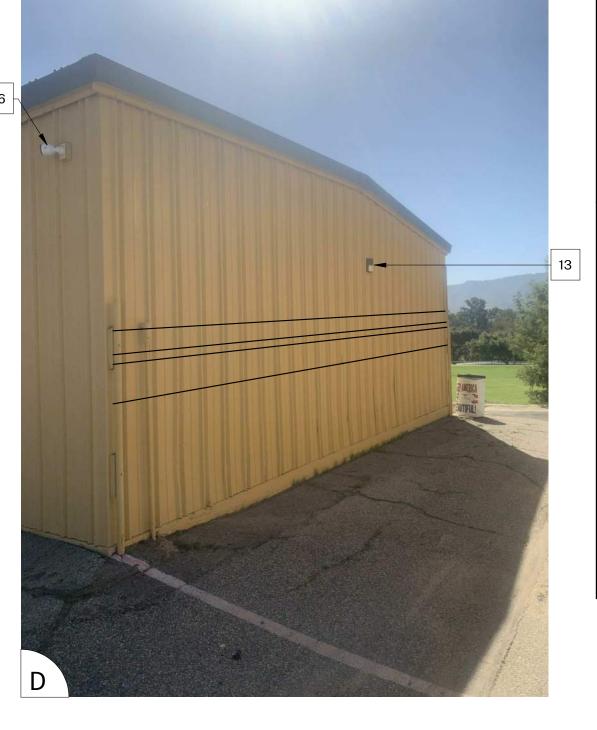

GENERAL NOTES

1. BUILDING PLANS ARE SCHEMATIC TO ONLY SHOW APPROXIMATE OVERALL BUILDING DIMENSIONS, DOOR QUANTITIES AND APPROXIMATE DOOR LOCATIONS AND ARE PROVIDED AS A CONVENIENCE FOR BIDDING. FIELD VERIFY CONDITIONS PRIOR TO BID. REFER TO SHEET KEYNOTES, PHOTOS, AND LEGENDS FOR ADDITIONAL INFORMATION.

2. ALL EXISTING PAINTED EXTERIOR WALLS OF BUILDING, PAINTED ROOF EAVES, OVERHANGS, CONDUITS, CABINTES, LOUVERS, VENTS, DUCTS AND ROOF EAVES AND GABLES INCLUDED IN THE SCOPE OF WORK ARE TO BE REPAINTED COLORS AS LISTED AND AS DETAILED IN THESE DRAWINGS AND SPECIFICATIONS UNLESS NOTED OTHERWISE.

3. ALL EXISTING UNPAINTED EXTERIOR SURFACES ARE TO REMAIN UNPAINTED UNLESS NOTED OTHERWISE. PROTECT IN PLACE ALL UNPAINTED SURFACES. 4. CAREFULLY PRUNE SHRUBS AND PLANTS AND REMOVE WEEDS AND PLANTINGS AT BASE OF WALL TO BARE EARTH TO ALLOW FOR COMPLETE WALL COVERAGE. 5. EXISTING PAINTED DOORS, DOOR FRAMES, DOOR TRIM, WINDOW FRAMES, MULLIONS, AND SEALANTS TO REMAIN UNLESS NOTED OTHERWISE. DO NOT PAINT ALUMINUM WINDOWS. PROTECT IN PLACE.

6. TYPICAL WORK AT EXISTING SIGNS TO REMAIN: REMOVE SIGN, PAINT BEHIND SIGN, CLEAN SIGN, REINSTALL SIGN UNLESS NOTED OTHERWISE.

AGENCY APPROVAL:

COLOR LEGEND AND NOTES

COLOR 1 - SWISS COFFEE **DUNN EDWARDS DEW341** DUNN EDWARDS, MATCH EXISTING COLOR 2 - ROYAL GREY COLOR 3 - WILD CURRANT SHERWIN WILLIAMS SW7583

COLOR 4 - MATCH TERRA COTTA ROOF TILE, FIELD VERIFY

1. PHOTOS WITH KEYNOTES ARE CREATED ELECTRONICALLY AND ARE INTENDED TO BE VIEWED IN COLOR TO SEE LOCATIONS OF COLORS ON THE BUILDINGS. CONTRACTOR SHALL FIELD VERIFY ACTUAL LOCATIONS AND DIMENSIONS OF COLORS PRIOR TO BID.

SHEET KEYNOTES

NOTE: NOT ALL KEYNOTES **USED ON EVERY SHEET**

1. PAINT COLOR 1 2. PAINT COLOR 2

3. PAINT COLOR 3 4. PAINT COLOR 4

5. REMOVE / PAINT WALL / REINSTALL: EXISTING SIGN

6. PROTECT IN PLACE: EXISTING SECURITY CAMERA TYPICAL AT ALL LOCATIONS 7. PREP / PAINT: UTILITY CONDUITS, CABINETS & HVAC TO MATCH WALL BEYOND.

8. PREP / PAINT: EXISTING SIGNAGE IN PLACE

9. PREP / PAINT: EXISTING LOUVERS AND/OR VENTS, TYPICAL

10. REMOVE / PAINT WALL / REINSTALL: LIGHT FIXTURE ESCUTCHEON PLATE OR LIGHT FIXTURE ITSELF TO WALL SURFACE BEHIND. TYPICAL AT ALL LIGHT FIXTURES U.N.O. 11. PREP / PAINT: EXISTING GUTTERS AND DOWNSPOUTS. PAINT COLOR 4

12. PROTECT IN PLACE: EXISTING GUTTERS AND LEADERHEADS 13. PROTECT IN PLACE: EXISTING LIGHT FIXTURE / SPEAKER / FIRE ALARM DEVICE 14. PREP / PAINT: EXISTING HVAC DUCTWORK WHERE ALREADY PAINTED. 15. PROTECT IN PLACE: EXISTING MURAL. PAINT WALLS AROUND MURAL TO MATCH

EXISTING BUILDING COLOR SCHEME. TOUCH-UP/REPAINT MURALS WHERE PAINTED TO MATCH EXISTING. 16. PROTECT IN PLACE: EXISTING DRINKING FOUNTAIN

17. PREP / PAINT: EXISTING PAINTED DRINKING FOUNTAIN CANE DETECTION RAILS 18. PREP/STAIN/SEAL: EXISTING WOOD DISPLAY CASES, FIELD VERIFY STAIN COLOR + SEALER SHEEN 19. REMOVE / DISCARD: EXISTING SIGN

20. REMOVE / SALVAGE TO ARCHITECT: EXISTING SIGN 21. REMOVE ACCESSIBLE SIGN / PAINT WALL / REINSTALL 22. PROTECT IN PLACE: EXISTING CONCRETE, CMU OR TILE

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29. PREP / PAINT: EXISTING CMU WALLS. PAINT INSIDE AND OUTSIDE OF ENCLOSURE AND DOORS. 30. PREP / PRIME / PAINT: PAVILION PLASTERED SURFACES & EAVES

31. PREP / PAINT: EXISTING DOOR OR WINDOW METAL SECURITY GRATING 32. PATCH / REPAIR / PREP / PRIME / PAINT: EXISTING PLASTER. SEE 1&3/A-201 33. PREP / PAINT: METAL PARAPET WALL CAP 34. PREP / PAINT: PLASTERED ROOF TOP EOUIPMENT SCREEN WALLS INSIDE AND OUT

35. CONTINUE WAINSCOAT AROUND ENTIRE PERIMETER OF BUILDING INCLUDING RECESSED DOOR AND WINDOW RETURNS 36. PREP / PAINT: EXISTING RAIL 37. REMOVE / REPLACE CEILING LIGHTS, OWNER PROVIDED


38. EXISTING MURAL, PAINT OVER MURAL 39. REMOVE AND REPLACE EXISTING EQUIPMENT CLOSET DOOR, FRAME, HARDWARE AND LOUVER, PAINT COLOR 2 40. PROTECT IN PLACE: EXISTING SIGN/PLAQUE

41. REMOVE EXISTING STRUCTURE 42. PREP/PAINT SAFETY YELLOW 43. REMOVE/PAINT/REINSTALL EQUIPMENT


44. REPAIR/REPLACE/PAINT: DAMAGED WOOD EAVE 45. PREP/PAINT: EXISTING WINDOW FRAMES & MUNTINS 46. REMOVE/DISCARD AS NOTED

SYMBOL LEGEND


47. PROTECT IN PLACE AS NOTED

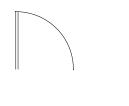

EXISTING DOOR: FIELD VERIFY SIZES AND CONDITIONS, PAINT DOOR WARNING STRIPING ON LANDING AT ALL OUTSWINGING EXTERIOR DOORS U.N.O.

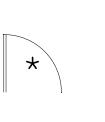

EXISTING RESTROOM DOOR: FIELD VERIFY SIZES AND CONDITIONS, PAINT DOOR WARNING STRIPING ON LANDING AT ALL OUTSWINGING EXTERIOR DOORS U.N.O. PAINT EXTERIOR DOOR FACE, FRAME EXTERIOR AND INTERIOR JAMB TO FACE OF DOOR STOP. APPLY RESTROOM IDENTIFICATION DOOR SIGNAGE ON EXTERIOR AND INTERIOR WHERE DOORS ARE PROPPED OPEN. SEE

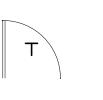

EXISTING CLASSROOM DOOR, PAINT WARNING STRIPING ON LANDING AT ALL OUTSWINGING EXTERIOR DOORS U.N.O., REMOVE AND REPLACE TRANSOM DOOR LOUVERS AND INFILL WITH 2x LUMBER, INSULTATION, AND GYPSUM SHEATHING, PAINT ENTIRE DOOR AND FRAME COLOR 2

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SHEET TITLE:

BUILDING J

2021.010

SHEET NUMBER:

A-116



1 BUILDING D ′ 1/8" = 1'-0"

GENERAL NOTES

1. BUILDING PLANS ARE SCHEMATIC TO ONLY SHOW APPROXIMATE OVERALL BUILDING DIMENSIONS, DOOR QUANTITIES AND APPROXIMATE DOOR LOCATIONS AND ARE PROVIDED AS A CONVENIENCE FOR BIDDING. FIELD VERIFY CONDITIONS PRIOR TO BID. REFER TO SHEET KEYNOTES, PHOTOS, AND LEGENDS FOR ADDITIONAL INFORMATION.

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6. TYPICAL WORK AT EXISTING SIGNS TO REMAIN: REMOVE SIGN, PAINT BEHIND SIGN, CLEAN SIGN, REINSTALL SIGN UNLESS NOTED OTHERWISE.

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AGENCY APPROVAL:

CONSULTANTS:

COLOR LEGEND AND NOTES

COLOR 1 - SWISS COFFEE **DUNN EDWARDS DEW341** DUNN EDWARDS, MATCH EXISTING COLOR 2 - ROYAL GREY

COLOR 3 - WILD CURRANT SHERWIN WILLIAMS SW7583

COLOR 4 - MATCH TERRA COTTA ROOF TILE, FIELD VERIFY

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SHEET KEYNOTES

NOTE: NOT ALL KEYNOTES **USED ON EVERY SHEET**

1. PAINT COLOR 1

2. PAINT COLOR 2

3. PAINT COLOR 3 4. PAINT COLOR 4

SEALER SHEEN

5. REMOVE / PAINT WALL / REINSTALL: EXISTING SIGN

6. PROTECT IN PLACE: EXISTING SECURITY CAMERA TYPICAL AT ALL LOCATIONS 7. PREP / PAINT: UTILITY CONDUITS, CABINETS & HVAC TO MATCH WALL BEYOND.

8. PREP / PAINT: EXISTING SIGNAGE IN PLACE

9. PREP / PAINT: EXISTING LOUVERS AND/OR VENTS, TYPICAL

10. REMOVE / PAINT WALL / REINSTALL: LIGHT FIXTURE ESCUTCHEON PLATE OR LIGHT FIXTURE ITSELF TO WALL SURFACE BEHIND. TYPICAL AT ALL LIGHT FIXTURES U.N.O. 11. PREP / PAINT: EXISTING GUTTERS AND DOWNSPOUTS. PAINT COLOR 4

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25. PROTECT IN PLACE: EXISTING MECHANICAL EQUIPMENT 26. PREP / PAINT: EXISTING ROLL-UP DOOR

27. PREP / PAINT: EXISTING STORAGE CONTAINER, ALL SIDES AND TOP, PAINT COLOR 2 28. PREP / PAINT: EXISTING WOOD BENCH / SEATS AND SLEEERS.

29. PREP / PAINT: EXISTING CMU WALLS. PAINT INSIDE AND OUTSIDE OF ENCLOSURE AND DOORS. 30. PREP / PRIME / PAINT: PAVILION PLASTERED SURFACES & EAVES

31. PREP / PAINT: EXISTING DOOR OR WINDOW METAL SECURITY GRATING

32. PATCH / REPAIR / PREP / PRIME / PAINT: EXISTING PLASTER, SEE 1&3/A-201 33. PREP / PAINT: METAL PARAPET WALL CAP 34. PREP / PAINT: PLASTERED ROOF TOP EOUIPMENT SCREEN WALLS INSIDE AND OUT

35. CONTINUE WAINSCOAT AROUND ENTIRE PERIMETER OF BUILDING INCLUDING RECESSED DOOR AND WINDOW RETURNS 36. PREP / PAINT: EXISTING RAIL

37. REMOVE / REPLACE CEILING LIGHTS, OWNER PROVIDED 38. EXISTING MURAL, PAINT OVER MURAL

39. REMOVE AND REPLACE EXISTING EQUIPMENT CLOSET DOOR, FRAME, HARDWARE AND LOUVER, PAINT COLOR 2

40. PROTECT IN PLACE: EXISTING SIGN/PLAQUE 41. REMOVE EXISTING STRUCTURE 42. PREP/PAINT SAFETY YELLOW


43. REMOVE/PAINT/REINSTALL EQUIPMENT 44. REPAIR/REPLACE/PAINT: DAMAGED WOOD EAVE 45. PREP/PAINT: EXISTING WINDOW FRAMES & MUNTINS

SYMBOL LEGEND


46. REMOVE/DISCARD AS NOTED

47. PROTECT IN PLACE AS NOTED

EXISTING DOOR: FIELD VERIFY SIZES AND CONDITIONS, PAINT DOOR WARNING STRIPING ON LANDING AT ALL OUTSWINGING EXTERIOR DOORS U.N.O.

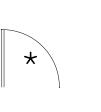


EXISTING RESTROOM DOOR: FIELD VERIFY SIZES AND CONDITIONS, PAINT DOOR WARNING STRIPING ON LANDING AT ALL OUTSWINGING EXTERIOR DOORS U.N.O. PAINT EXTERIOR DOOR FACE, FRAME EXTERIOR AND INTERIOR JAMB TO FACE OF DOOR STOP. APPLY RESTROOM IDENTIFICATION DOOR SIGNAGE ON EXTERIOR AND INTERIOR WHERE DOORS ARE PROPPED OPEN. SEE 1/A-201.

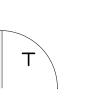

EXISTING CLASSROOM DOOR, PAINT WARNING STRIPING ON LANDING AT ALL OUTSWINGING EXTERIOR DOORS U.N.O., REMOVE AND REPLACE TRANSOM DOOR LOUVERS AND INFILL WITH 2x LUMBER, INSULTATION, AND GYPSUM SHEATHING, PAINT ENTIRE DOOR AND FRAME COLOR 2

SEALS:

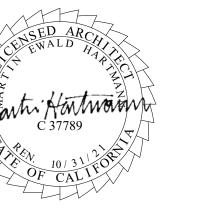

MATILIJA MS CAMPUS -WIDE EXTERIOR PAINTING

OWNER:

OJAI UNIFIED SCHOOL DISTRICT 414 EAST OJAI AVENUE OJAI, CA 93023 (805) 640-4300 CONTACT: ADAM DUTTER EMAIL: adutter@ojaiusd.org

PROJECT ADDRESS:

ISSUE:

MATILIJA MIDDLE SCHOOL 703 EL PASEO ROAD OJAI, CA 93023

MARK DATE

OJAI USD PROJECT NO.: 2021-1600

PROJECT INFORMATION PROJECT NUMBER: PROJECT PHASE:		NUMBER: PHASE:	021.010 CD
ח	RAWNR	· ·	DRS

DESCRIPTION

REVIEWED BY:


THE ORIGINAL SIZE OF THIS SHEET IS 36"x24". IF THE CURRENT SIZE IS OTHER THAN 36"x24", THEN ADJUST THE SCALE OF THE DRAWINGS ACCORDINGLY. SHEET TITLE:

BUILDING D

A-117


DATE: 05/14/21

SHEET NUMBER:

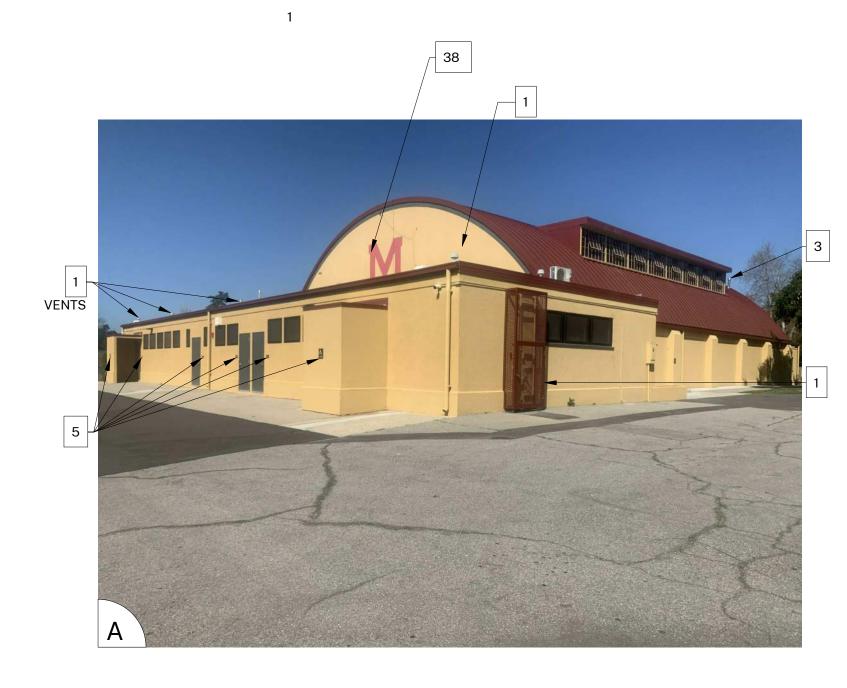





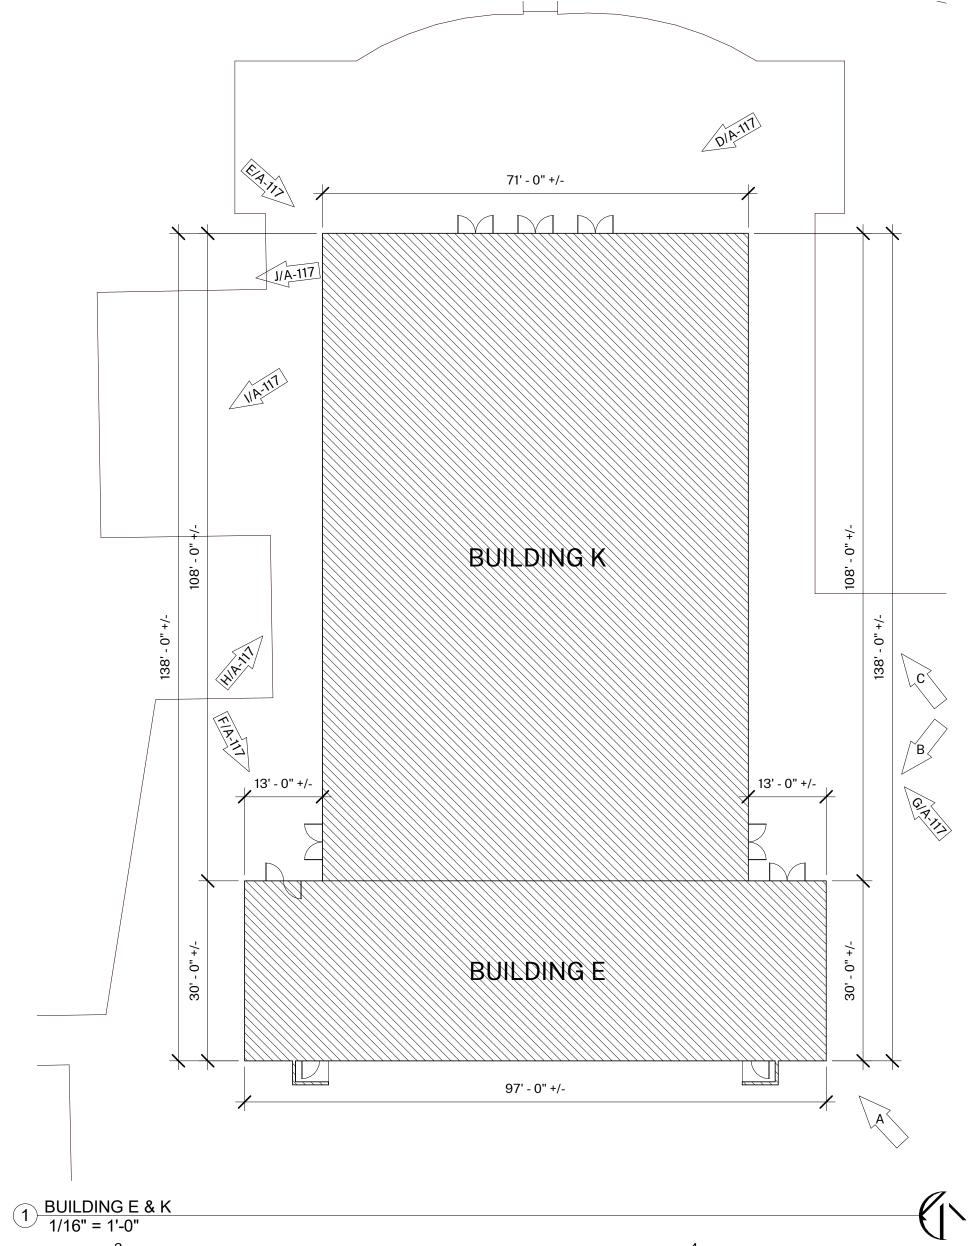

1. BUILDING PLANS ARE SCHEMATIC TO ONLY SHOW APPROXIMATE OVERALL BUILDING DIMENSIONS, DOOR QUANTITIES AND APPROXIMATE DOOR LOCATIONS AND ARE PROVIDED AS A CONVENIENCE FOR BIDDING. FIELD VERIFY CONDITIONS PRIOR TO BID. REFER TO SHEET KEYNOTES, PHOTOS, AND LEGENDS FOR ADDITIONAL INFORMATION.

2. ALL EXISTING PAINTED EXTERIOR WALLS OF BUILDING, PAINTED ROOF EAVES, OVERHANGS, CONDUITS, CABINTES, LOUVERS, VENTS, DUCTS AND ROOF EAVES AND GABLES INCLUDED IN THE SCOPE OF WORK ARE TO BE REPAINTED COLORS AS LISTED AND AS DETAILED IN THESE DRAWINGS AND SPECIFICATIONS UNLESS NOTED OTHERWISE.

ALL EXISTING UNPAINTED EXTERIOR SURFACES ARE TO REMAIN UNPAINTED UNLESS NOTED OTHERWISE. PROTECT IN PLACE ALL UNPAINTED SURFACES.
 CAREFULLY PRUNE SHRUBS AND PLANTS AND REMOVE WEEDS AND PLANTINGS AT BASE OF WALL TO BARE EARTH TO ALLOW FOR COMPLETE WALL COVERAGE.
 EXISTING PAINTED DOORS, DOOR FRAMES, DOOR TRIM, WINDOW FRAMES, MULLIONS, AND SEALANTS TO REMAIN UNLESS NOTED OTHERWISE. DO NOT PAINT ALUMINUM WINDOWS. PROTECT IN PLACE.

6. TYPICAL WORK AT EXISTING SIGNS TO REMAIN: REMOVE SIGN, PAINT BEHIND SIGN, CLEAN SIGN, REINSTALL SIGN UNLESS NOTED OTHERWISE.

HARTMANN ARCHITECTUR STUDIO

> HARTMANNARCHITECTURESTUDIO.COM 430 S. CARRILLO RD. OJAI, CALIFORNIA 93023 (805) 530-5559

AGENCY APPROVAL:

CONSULTANTS:

COLOR LEGEND AND NOTES

COLOR 1 - SWISS COFFEE DUNN EDWARDS DEW341

COLOR 2 - ROYAL GREY DUNN EDWARDS, MATCH EXISTING

COLOR 3 - WILD CURRANT SHERWIN WILLIAMS SW7583

COLOR 4 - MATCH TERRA COTTA ROOF TILE, FIELD VERIFY

 PHOTOS WITH KEYNOTES ARE CREATED ELECTRONICALLY AND ARE INTENDED TO BE VIEWED IN COLOR TO SEE LOCATIONS OF COLORS ON THE BUILDINGS. CONTRACTOR SHALL FIELD VERIFY ACTUAL LOCATIONS AND DIMENSIONS OF COLORS PRIOR TO BID.

SHEET KEYNOTES

NOTE: NOT ALL KEYNOTES USED ON EVERY SHEET

1. PAINT COLOR 1

2. PAINT COLOR 2

3. PAINT COLOR 3

4. PAINT COLOR 45. REMOVE / PAINT WALL / REINSTALL: EXISTING SIGN

6. PROTECT IN PLACE: EXISTING SECURITY CAMERA TYPICAL AT ALL LOCATIONS

7. PREP / PAINT: UTILITY CONDUITS, CABINETS & HVAC TO MATCH WALL BEYOND.
8. PREP / PAINT: EXISTING SIGNAGE IN PLACE

9. PREP / PAINT: EXISTING LOUVERS AND/OR VENTS, TYPICAL

10. REMOVE / PAINT WALL / REINSTALL: LIGHT FIXTURE ESCUTCHEON PLATE OR LIGHT FIXTURE ITSELF TO WALL SURFACE BEHIND. TYPICAL AT ALL LIGHT FIXTURES U.N.O. 11. PREP / PAINT: EXISTING GUTTERS AND DOWNSPOUTS. PAINT COLOR 4

12. PROTECT IN PLACE: EXISTING GUTTERS AND LEADERHEADS
13. PROTECT IN PLACE: EXISTING LIGHT FIXTURE / SPEAKER / FIRE ALARM DEVICE
14. PREP / PAINT: EXISTING HVAC DUCTWORK WHERE ALREADY PAINTED.
15. PROTECT IN PLACE: EXISTING MURAL. PAINT WALLS AROUND MURAL TO MATCH

EXISTING BUILDING COLOR SCHEME. TOUCH-UP/REPAINT MURALS WHERE PAINTED TO MATCH EXISTING.

16. PROTECT IN PLACE: EXISTING DRINKING FOUNTAIN
17. PREP / PAINT: EXISTING PAINTED DRINKING FOUNTAIN CANE DETECTION RAILS
18. PREP/STAIN/SEAL: EXISTING WOOD DISPLAY CASES, FIELD VERIFY STAIN COLOR +

SEALER SHEEN

19. REMOVE / DISCARD: EXISTING SIGN

20. REMOVE / SALVAGE TO ARCHITECT: EXISTING SIGN 21. REMOVE ACCESSIBLE SIGN / PAINT WALL / REINSTALL

22. PROTECT IN PLACE: EXISTING CONCRETE, CMU OR TILE

23. PREP / PAINT: EXISTING CONCRETE / CMU WALL
24. PREP / PAINT: EXISTING METAL FENCE & GATE

25. PROTECT IN PLACE: EXISTING METAL FENCE & GATE

25. PROTECT IN PLACE: EXISTING MECHANICAL EQUIPMENT

26. PREP / PAINT: EXISTING ROLL-UP DOOR

27. PREP / PAINT: EXISTING STORAGE CONTAINER, ALL SIDES AND TOP, PAINT COLOR 2
28. PREP / PAINT: EXISTING WOOD BENCH / SEATS AND SLEEERS.
29. PREP / PAINT: EXISTING CMILWALLS, PAINT INSIDE AND OUTSIDE OF ENGLOSURE

29. PREP / PAINT: EXISTING WOOD BENCH / SEATS AND SLEEERS.

29. PREP / PAINT: EXISTING CMU WALLS. PAINT INSIDE AND OUTSIDE OF ENCLOSURE AND DOORS.

30. PREP / PRIME / PAINT: PAVILION PLASTERED SURFACES & EAVES 31. PREP / PAINT: EXISTING DOOR OR WINDOW METAL SECURITY GRATING

31. PREP / PAINT: EXISTING DOOR OR WINDOW METAL SECURITY GRATING
32. PATCH / REPAIR / PREP / PRIME / PAINT: EXISTING PLASTER, SEE 1&3/A-201

33. PREP / PAINT: METAL PARAPET WALL CAP
34. PREP / PAINT: PLASTERED ROOF TOP EQUIPMENT SCREEN WALLS INSIDE AND OUT
35. CONTINUE WAINSCOAT AROUND ENTIRE PERIMETER OF BUILDING INCLUDING

RECESSED DOOR AND WINDOW RETURNS
36. PREP / PAINT: EXISTING RAIL
37. REMOVE / REPLACE CEILING LIGHTS, OWNER PROVIDED

38. EXISTING MURAL, PAINT OVER MURAL
39. REMOVE AND REPLACE EXISTING EQUIPMENT CLOSET DOOR, FRAME, HARDWARE


AND LOUVER, PAINT COLOR 2 40. PROTECT IN PLACE: EXISTING SIGN/PLAQUE 41. REMOVE EXISTING STRUCTURE

42. PREP/PAINT SAFETY YELLOW
43. REMOVE/PAINT/REINSTALL EQUIPMENT

44. REPAIR/REPLACE/PAINT: DAMAGED WOOD EAVE

45. PREP/PAINT: EXISTING WINDOW FRAMES & MUNTINS 46. REMOVE/DISCARD AS NOTED

47. PROTECT IN PLACE AS NOTED SYMBOL LEGEND

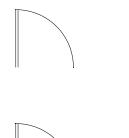

EXISTING DOOR: FIELD VERIFY SIZES AND CONDITIONS, PAINT DOOR WARNING STRIPING ON LANDING AT ALL OUTSWINGING EXTERIOR DOORS U.N.O.

EXISTING RESTROOM DOOR: FIELD VERIFY SIZES AND CONDITIONS, PAINT DOOR WARNING STRIPING ON LANDING AT ALL OUTSWINGING EXTERIOR DOORS U.N.O. PAINT EXTERIOR DOOR FACE, FRAME EXTERIOR AND INTERIOR JAMB TO FACE OF DOOR STOP. APPLY RESTROOM IDENTIFICATION DOOR SIGNAGE ON EXTERIOR AND INTERIOR WHERE DOORS ARE PROPPED OPEN. SEE 1/A-201.

T

EXISTING CLASSROOM DOOR, PAINT WARNING STRIPING ON LANDING AT ALL OUTSWINGING EXTERIOR DOORS U.N.O., REMOVE AND REPLACE TRANSOM DOOR LOUVERS AND INFILL WITH 2x LUMBER, INSULTATION, AND GYPSUM SHEATHING, PAINT ENTIRE DOOR AND FRAME COLOR 2

OJAI USD PROJECT NO.: 2021-1600

MATILIJA MS CAMPUS -

OJAI UNIFIED SCHOOL DISTRICT

414 EAST OJAI AVENUE

CONTACT: ADAM DUTTER

PROJECT ADDRESS:

703 EL PASEO ROAD

OJAI, CA 93023

ISSUE:

EMAIL: adutter@ojaiusd.org

MATILIJA MIDDLE SCHOOL

OJAI, CA 93023

(805) 640-4300

OWNER:

WIDE EXTERIOR PAINTING

MARK DATE DESCRIPTION

PROJECT INFORMATION:
PROJECT NUMBER:
PROJECT PHASE:

DRAWN BY:
REVIEWED BY:

THE ORIGINAL SIZE OF THIS SHEET IS 36"x24". IF THE CURRENT SIZE IS OTHER THAN 36"x24", THEN ADJUST THE SCALE OF THE DRAWINGS ACCORDINGLY.


SHEET TITLE:

BUILDING E & K

2021.010


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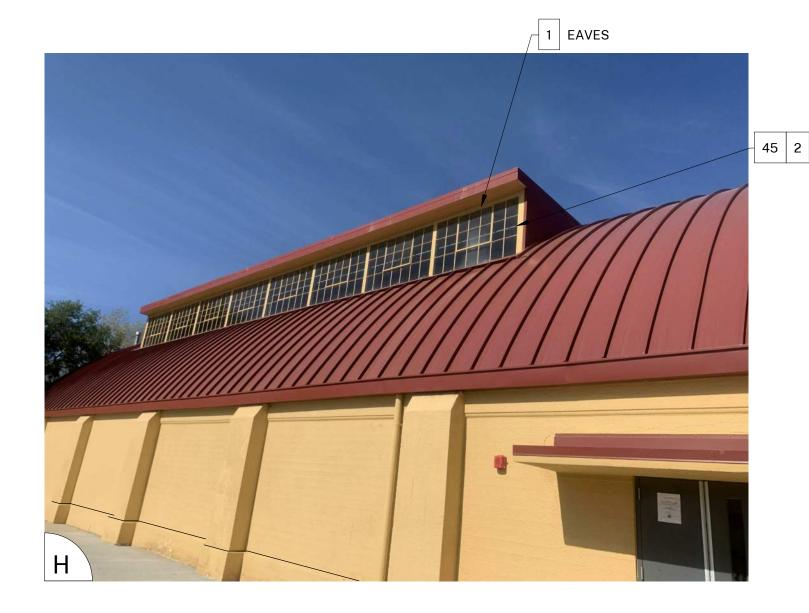
A-118




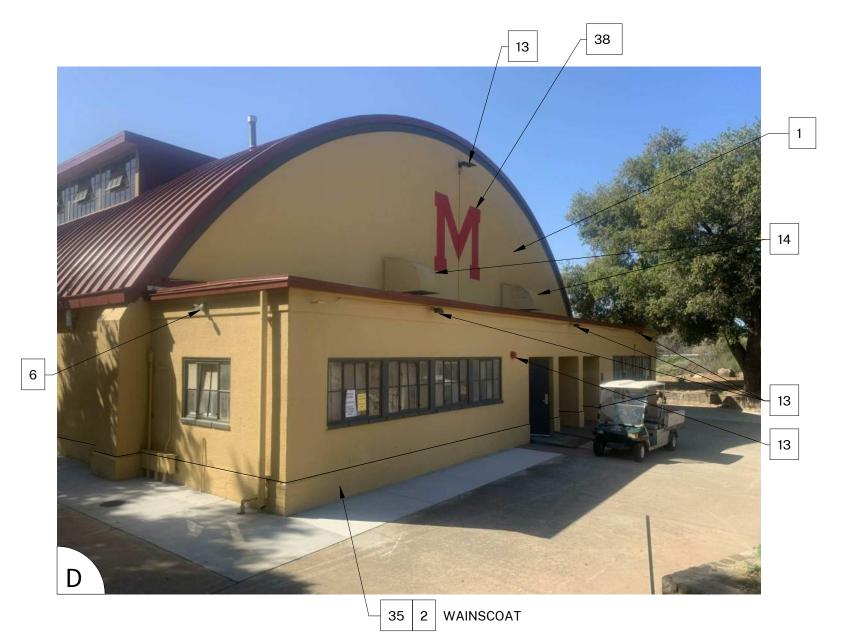


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GENERAL NOTES

- 1. BUILDING PLANS ARE SCHEMATIC TO ONLY SHOW APPROXIMATE OVERALL BUILDING DIMENSIONS, DOOR QUANTITIES AND APPROXIMATE DOOR LOCATIONS AND ARE PROVIDED AS A CONVENIENCE FOR BIDDING. FIELD VERIFY CONDITIONS PRIOR TO BID. REFER TO SHEET KEYNOTES, PHOTOS, AND LEGENDS FOR ADDITIONAL INFORMATION.
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- 3. ALL EXISTING UNPAINTED EXTERIOR SURFACES ARE TO REMAIN UNPAINTED UNLESS NOTED OTHERWISE. PROTECT IN PLACE ALL UNPAINTED SURFACES. 4. CAREFULLY PRUNE SHRUBS AND PLANTS AND REMOVE WEEDS AND PLANTINGS AT BASE OF WALL TO BARE EARTH TO ALLOW FOR COMPLETE WALL COVERAGE. 5. EXISTING PAINTED DOORS, DOOR FRAMES, DOOR TRIM, WINDOW FRAMES, MULLIONS, AND SEALANTS TO REMAIN UNLESS NOTED OTHERWISE. DO NOT PAINT ALUMINUM WINDOWS. PROTECT IN PLACE.
- 6. TYPICAL WORK AT EXISTING SIGNS TO REMAIN: REMOVE SIGN, PAINT BEHIND SIGN, CLEAN SIGN, REINSTALL SIGN UNLESS NOTED OTHERWISE.

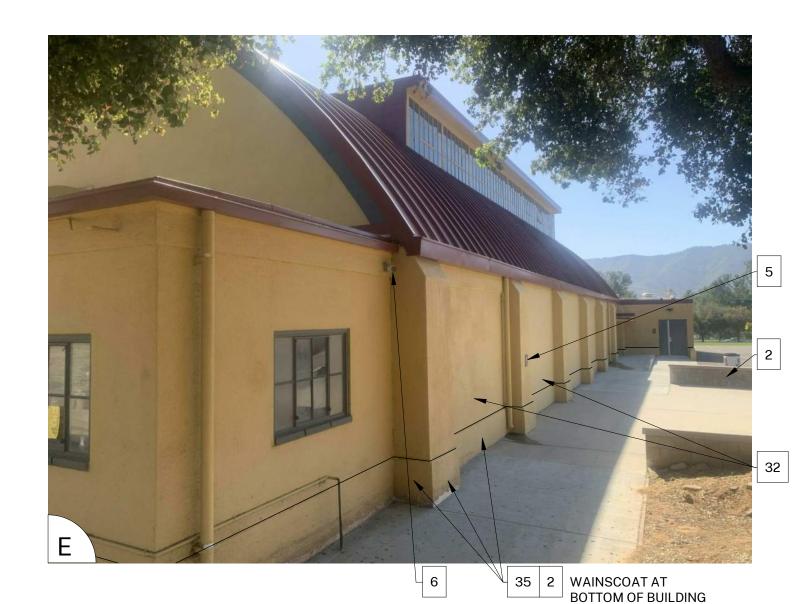COLOR LEGEND AND NOTES

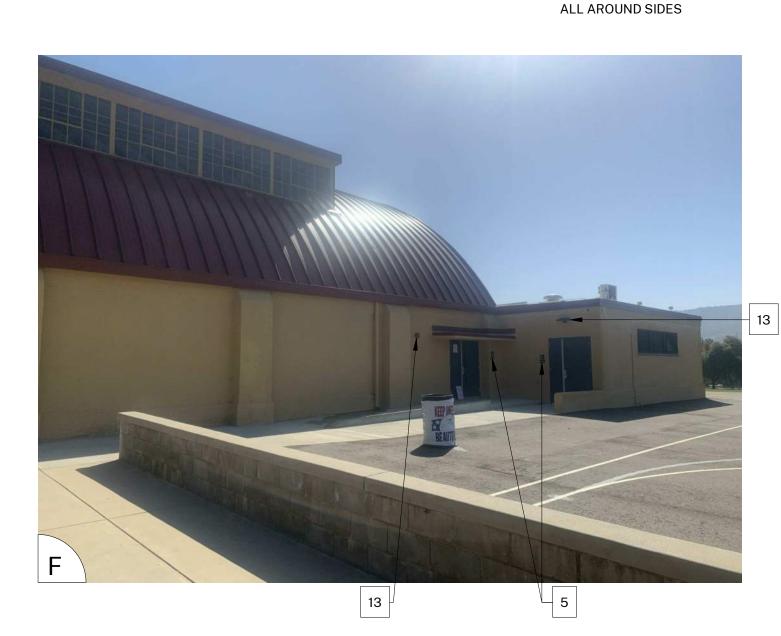DUNN EDWARDS DEW341 COLOR 1 - SWISS COFFEE COLOR 2 - ROYAL GREY DUNN EDWARDS, MATCH EXISTING COLOR 3 - WILD CURRANT SHERWIN WILLIAMS SW7583

COLOR 4 - MATCH TERRA COTTA ROOF TILE, FIELD VERIFY

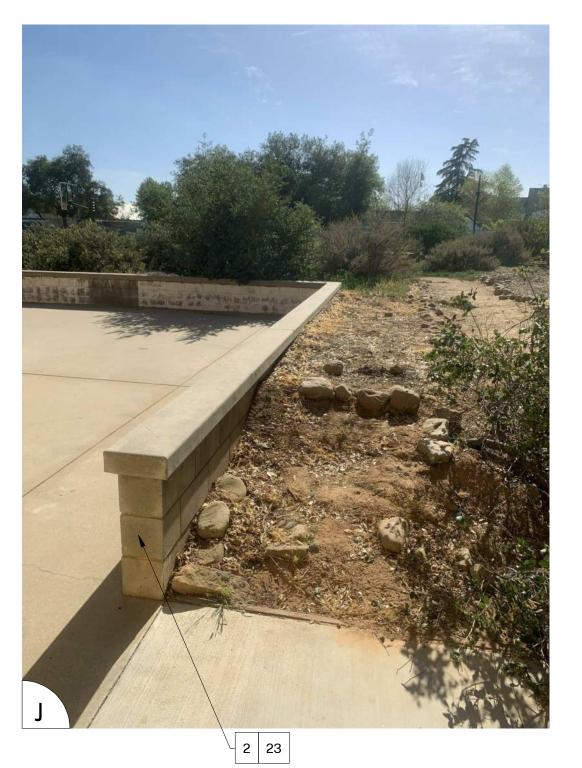1. PHOTOS WITH KEYNOTES ARE CREATED ELECTRONICALLY AND ARE INTENDED TO BE VIEWED IN COLOR TO SEE LOCATIONS OF COLORS ON THE BUILDINGS. CONTRACTOR SHALL FIELD VERIFY ACTUAL LOCATIONS AND DIMENSIONS OF COLORS PRIOR TO BID.

SHEET KEYNOTES

NOTE: NOT ALL KEYNOTES **USED ON EVERY SHEET**

1. PAINT COLOR 1

2. PAINT COLOR 2

3. PAINT COLOR 3

4. PAINT COLOR 4

5. REMOVE / PAINT WALL / REINSTALL: EXISTING SIGN 6. PROTECT IN PLACE: EXISTING SECURITY CAMERA TYPICAL AT ALL LOCATIONS

7. PREP / PAINT: UTILITY CONDUITS, CABINETS & HVAC TO MATCH WALL BEYOND. 8. PREP / PAINT: EXISTING SIGNAGE IN PLACE

9. PREP / PAINT: EXISTING LOUVERS AND/OR VENTS, TYPICAL

10. REMOVE / PAINT WALL / REINSTALL: LIGHT FIXTURE ESCUTCHEON PLATE OR LIGHT FIXTURE ITSELF TO WALL SURFACE BEHIND. TYPICAL AT ALL LIGHT FIXTURES U.N.O. 11. PREP / PAINT: EXISTING GUTTERS AND DOWNSPOUTS. PAINT COLOR 4

12. PROTECT IN PLACE: EXISTING GUTTERS AND LEADERHEADS 13. PROTECT IN PLACE: EXISTING LIGHT FIXTURE / SPEAKER / FIRE ALARM DEVICE 14. PREP / PAINT: EXISTING HVAC DUCTWORK WHERE ALREADY PAINTED.

15. PROTECT IN PLACE: EXISTING MURAL. PAINT WALLS AROUND MURAL TO MATCH EXISTING BUILDING COLOR SCHEME. TOUCH-UP/REPAINT MURALS WHERE PAINTED TO MATCH EXISTING.

16. PROTECT IN PLACE: EXISTING DRINKING FOUNTAIN 17. PREP / PAINT: EXISTING PAINTED DRINKING FOUNTAIN CANE DETECTION RAILS

18. PREP/STAIN/SEAL: EXISTING WOOD DISPLAY CASES, FIELD VERIFY STAIN COLOR + SEALER SHEEN 19. REMOVE / DISCARD: EXISTING SIGN

20. REMOVE / SALVAGE TO ARCHITECT: EXISTING SIGN 21. REMOVE ACCESSIBLE SIGN / PAINT WALL / REINSTALL

22. PROTECT IN PLACE: EXISTING CONCRETE, CMU OR TILE

23. PREP / PAINT: EXISTING CONCRETE / CMU WALL 24. PREP / PAINT: EXISTING METAL FENCE & GATE

25. PROTECT IN PLACE: EXISTING MECHANICAL EQUIPMENT

26. PREP / PAINT: EXISTING ROLL-UP DOOR

27. PREP / PAINT: EXISTING STORAGE CONTAINER, ALL SIDES AND TOP, PAINT COLOR 2

28. PREP / PAINT: EXISTING WOOD BENCH / SEATS AND SLEEERS. 29. PREP / PAINT: EXISTING CMU WALLS. PAINT INSIDE AND OUTSIDE OF ENCLOSURE AND DOORS.

30. PREP / PRIME / PAINT: PAVILION PLASTERED SURFACES & EAVES 31. PREP / PAINT: EXISTING DOOR OR WINDOW METAL SECURITY GRATING

32. PATCH / REPAIR / PREP / PRIME / PAINT: EXISTING PLASTER, SEE 1&3/A-201 33. PREP / PAINT: METAL PARAPET WALL CAP 34. PREP / PAINT: PLASTERED ROOF TOP EQUIPMENT SCREEN WALLS INSIDE AND OUT

35. CONTINUE WAINSCOAT AROUND ENTIRE PERIMETER OF BUILDING INCLUDING RECESSED DOOR AND WINDOW RETURNS 36. PREP / PAINT: EXISTING RAIL

37. REMOVE / REPLACE CEILING LIGHTS, OWNER PROVIDED 38. EXISTING MURAL, PAINT OVER MURAL

39. REMOVE AND REPLACE EXISTING EQUIPMENT CLOSET DOOR, FRAME, HARDWARE AND LOUVER, PAINT COLOR 2

40. PROTECT IN PLACE: EXISTING SIGN/PLAQUE 41. REMOVE EXISTING STRUCTURE

42. PREP/PAINT SAFETY YELLOW

43. REMOVE/PAINT/REINSTALL EQUIPMENT 44. REPAIR/REPLACE/PAINT: DAMAGED WOOD EAVE

45. PREP/PAINT: EXISTING WINDOW FRAMES & MUNTINS

46. REMOVE/DISCARD AS NOTED


47. PROTECT IN PLACE AS NOTED

HARTMANNARCHITECTURESTUDIO.COM 430 S. CARRILLO RD. OJAI, CALIFORNIA 93023 (805) 530-5559

CONSULTANTS:

AGENCY APPROVAL:

SEALS:

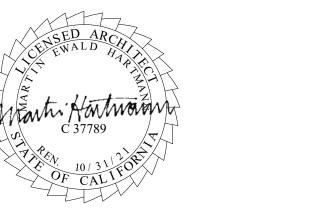

MATILIJA MS CAMPUS -WIDE EXTERIOR PAINTING

OWNER:

ISSUE: MARK

REVIEWED BY:

OJAI UNIFIED SCHOOL DISTRICT 414 EAST OJAI AVENUE OJAI, CA 93023 (805) 640-4300 CONTACT: ADAM DUTTER EMAIL: adutter@ojaiusd.org

PROJECT ADDRESS:

MATILIJA MIDDLE SCHOOL 703 EL PASEO ROAD OJAI, CA 93023

OJAI USD PROJECT NO.: 2021-1600

PROJECT INFORMATION: PROJECT NUMBER: 2021.010 PROJECT PHASE: DRAWN BY:

DESCRIPTION

THE ORIGINAL SIZE OF THIS SHEET IS 36"x24". IF THE CURRENT SIZE IS OTHER THAN 36"x24", THEN ADJUST THE SCALE OF THE DRAWINGS ACCORDINGLY.

SHEET TITLE:

BUILDING E & K


A-119

DATE: 05/14/21

SHEET NUMBER:


(E) SUBSTRATE WEATHER RESISTIVE BARRIER, 2 LAYERS OF GARDE 'D' PAPER EXPANDED MTL. LATH, V-GROOVE SHELF-FURRING, 2.5 LBS/SQ YD MIN, HAND WITH 6d STAINLESS NAILS 7/8" THREE-COAT PORTLAND CEMENT PLASTER-MATCH (E) FINISH-PAINT APPLY CASING BEADS WHERE PLASTER TERMINATES AT UNDERSIDE OF ROOF AND PENETRATIONS CORNER AID SHALL BE USED AT THE VERTICAL EDGE OF INTERSECTING WALL SURFACES SELF-FURRING WOVEN-WIRE MAY BE SUBSTITUTED FOR MTL. LATH SCRATCH COAT SHALL BE MOIST CURED FOR SECTION VIEW 48 HOURS MIN.

1 EXTERIOR CEMENT PLASTER
3" = 1'-0"

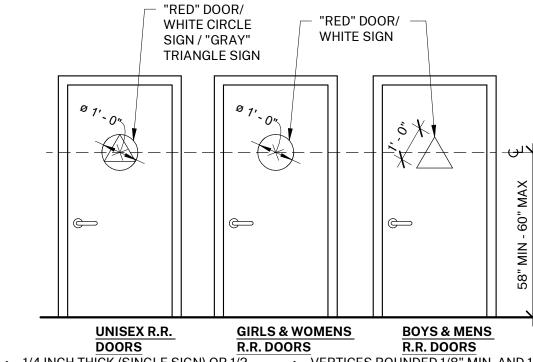

- 1/4 INCH THICK (SINGLE SIGN) OR 1/2 VERTICES ROUNDED 1/8" MIN. AND 1/4" INCH THICK OVERALL (UNISEX SIGN).
- NON-STATIC, FIRE-RETARDANT, AND SELF-EXTINGUISHING. SYMBOLS SHALL CONTRAST WITH
- BACKGROUND. ROUNDED EDGES 1/16" MIN OR 1/8" CHAMFERED.
- COLOR OF PLASTIC: AS SELECTED FROM MANUFACTURER'S STANDARD COLORS. FINISH OF PLASTIC: MATTE.
- SUBMIT FOR APPROVAL: 1. SHOP DRAWINGS 2. MANUFACTURER'S PRODUCT INFO 3. SAMPLE

2 TOILET FACILITY GEOMETRIC SYMBOLS
3/8" = 1'-0"

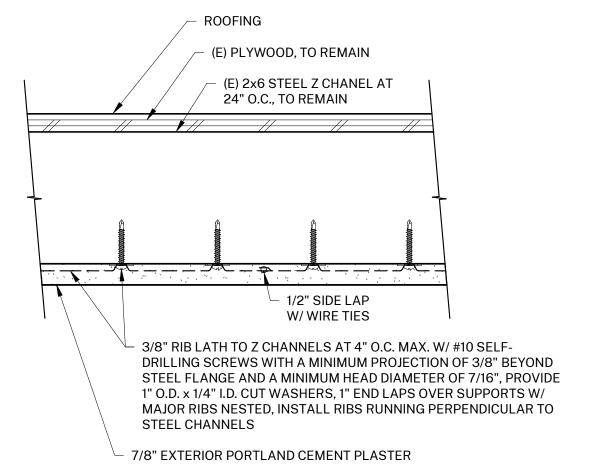

HORIZONTAL EXTERIOR PLASTER AT 3 CANOPY 3" = 1'-0"

HARTMANNARCHITECTURESTUDIO.COM 430 S. CARRILLO RD. OJAI, CALIFORNIA 93023

(805) 530-5559

CONSULTANTS:

AGENCY APPROVAL:



MATILIJA MS CAMPUS -WIDE EXTERIOR PAINTING

OWNER: OJAI UNIFIED SCHOOL DISTRICT 414 EAST OJAI AVENUE OJAI, CA 93023 (805) 640-4300 CONTACT: ADAM DUTTER EMAIL: adutter@ojaiusd.org

PROJECT ADDRESS: MATILIJA MIDDLE SCHOOL 703 EL PASEO ROAD OJAI, CA 93023

OJAI USD PROJECT NO.: 2021-1600

ISSUE: MARK DESCRIPTION

2021.010

PBS MH

PROJECT INFORMATION: PROJECT NUMBER: PROJECT PHASE:

DRAWN BY: REVIEWED BY: THE ORIGINAL SIZE OF THIS SHEET IS 36"x24". IF THE CURRENT SIZE IS OTHER THAN 36"x24", THEN ADJUST THE SCALE OF THE DRAWINGS ACCORDINGLY.

SHEET TITLE:

DETAILS

SHEET NUMBER:

A-201