

B. Contract Documents, were prepared by: HARTMANN ARCHITECTURE STUDIO 430 S. CARRILLO RD OJAI, CA 93023

C. Summary of Work: 1. Matilija Middle School (OJAI USD PROJ# 2021-1600) 730 El Paseo Rd., Ojai, CA

a. Repaint: (1) Building A (2) Building B (3) Building C (4) Building D (5) Building E (6) Building F (7) Building G (8) Building H (9) Building I (10) Building J

(11) Building K (12) Accessory Structures as Indicated D. Bid Documents are available online at the Ojai Unified School District's

Website (https://www.ojaiusd.org/page/construction-projects) 1.1 OCCUPATIONAL SAFETY AND HEALTH ACT REQUIREMENTS: A. During the entire construction period, it shall be the responsibility of the Contractor to maintain conditions at the Project site so as to meet in all respects

the requirements of the Federal Occupational Safety and Health Administration (OSHA) and the California Occupational Safety and Health Administration (CAL-OSHA). These provisions shall cover the Contractor's employees and all other persons working upon or visiting the site. To this end, the Contractor shall inform himself and his representatives of Federal OSHA and California OSHA standards.

1.2 COORDINATION REQUIREMENTS:

A. It is the Contractor's responsibility to coordinate the Work so as to minimize conflicts and optimize efficiency.

B. Coordinate scheduling, submittals, and Work of the various Sections of Specifications to assure efficient and orderly sequence of installation of interdependent construction elements, with provisions for accommodating items installed later.

1.3 BUILDING SYSTEM COORDINATION:

A. Notify Architect if conditions are uncovered which would prevent the completed project from conforming to the requirements of the Work. B. Materials/Systems: As specified. Verify compatibility with District-wide standard systems

C. "NIC" construction is indicated and specified herein as an aid to the Contractor in scheduling the amount of time and materials necessary for the completion of the Contract.

1.4 DISTRICT OCCUPANCY:

A. The District will occupy the campus during the entire period of construction. Cooperate with the District in all construction operations including the following to minimize conflict and to facilitate District usage.

B. If and when it should be necessary for the Contractor to impact the day-to-day operations of District's functions in order to pursue the Work, the Contractor shall furnish at least 14 days notice to the District and coordinate the means and timing to avoid, minimize, or circumvent such impacts. The District reserves the right to assess and anticipate such impacts and the

right to stop or postpone the Work until a mutually satisfactory time and means can be agreed upon. The Contractor shall include costs for delays caused by normal school operations and scheduled special events.

1.5 CONTRACTOR'S USE OF THE PREMISES:

A. The Contractor shall limit his use of the premises for construction activities and for storage, to allow for District occupancy. B. The Contractor shall be responsible for the following:

1. Coordinate the use of the premises under the direction of the District.

2. Assume full responsibility for the protection and safekeeping of products under this Contract which are stored at the site. 3. Move stored products that are under the Contractor's control, which

interfere with operations of the District. 4. Obtain and pay for the use of additional storage or construction areas needed for operations.

1.6 COORDINATION OTHER DISTRICT CONTRACTORS:

A. The District may have separate contractors or vendors working on the site at the time of this project. The Contractor shall coordinate work activities to not interfere with other District work.

PART 2 - PRODUCTS (Not Applicable)

PART 3 - EXECUTION (Not Applicable)

SECTION 01 21 00 - ALLOWANCES

PART 1 - GENERAL

1.1 SUMMARY A. Section Includes: Allowances which the Contractor shall provide for designated construction activities in the Work and in his/her bid. B. Related Documents

1. Section 01 26 00: Modification procedures

1.2 DESCRIPTION OF REQUIREMENTS

A. Definitions and Explanations: Certain requirements of the construction related to each allowance are indicated and specified. The allowance has been established instead of additional requirements for that construction, and further requirements thereof will be issued by Change Order.

B. Contingency Allowance: Contingency allowance shall be used only as directed for District's purposes, and only by change orders which designate amounts to be charged to contingency allowance. Contractor's related costs are not included in the Contract sum (other than allowance itself) for construction so ordered to be charged to contingency allowance. The

change orders will include costs and reasonable overhead/profit margins. At time of project closeout, unused amounts remaining in contingency allowance shall be credited to the District by change order.

A PART 2 - PRODUCTS (Not Applicable)

PART 3 - EXECUTION

3.1 SCHEDULE OF ALLOWANCES A. Allowance No. 1: The Contractor shall include in the bid an allowance of \$15,000 for repair of miscellaneous existing conditions, including, but not limited to the replacement of existing stucco, plywood paneling, unsatisfactory dimensional lumber not otherwise identified in the drawings.

SECTION 01 26 00 - MODIFICATION PROCEDURES

PART 1 - GENERAL

1.1 SUMMARY:

A. Section Includes: Procedures for processing Change Orders.

1.2 CHANGE INITIATION PROCEDURES:

A. The Contractor may initiate a change by submittal of a request to the Architect describing the proposed change with a statement of the reasons or the change and the effect on the Contract Sum and the Contract Time with full documentation. B. The Architect may issue a Price Modification Request (PMR), signed by the

the Work, and will designate method of determining changes in Contract Sum and/or Contract Time.

1.3 CONTRACTOR'S PROPOSALS AND DOCUMENTATION: A. In response to each PMR issued by the Architect, submit an itemized quotation detailing all changes in Contract Sum and Contract Time. Upon request, the

1. Quantities of products, labor, and equipment.

5. Credit for deletions from the Contract, similarly documented. 6. Quotation shall include all components necessary, whether or not

specifically described, to complete the work, such as, but is not cutting, patching and painting, additional power supply required for equipment, etc. By failing to provide quotation for component(s) of the work without prior notification to the District that additional quotation(s) to be furnished at a later Contractor waives all claims for extra costs for such component(s)

B. If additional costs necessitated by a Construction Change Directive are indicated to be paid on a time and materials basis, provide additional data,

1. Date and number of Change Authorization. 2. Dates and times work was performed and by whom.

4. Invoices and receipts for products, equipment, and subcontracts. 1.4 EXECUTION OF CHANGE ORDERS:

A. The Architect will issue Change Orders on AIA Form G701 for signatures of

B. On fixed price Change Orders, changes in Contract Sum and Contract Time will be based on the PMR and the Contractor's quotation as accepted by the District. C. On time and material Change Orders, changes in Contract Sum and Contract Time will be determined by the District and Architect from the Contractor's data. 1.5 CORRELATION OF CONTRACTOR SUBMITTALS:

A. Promptly revise the Schedule of Values, and Application for Payment forms to record each authorized Change Order as a separate line item and adjust the Contract Sum as shown on the Change Order.

B. Promptly revise Progress Schedules to reflect changes in Contract Time, revise subschedules to adjust times for other items of Work affected by the change and resubmit.

PART 2 - PRODUCTS (Not Applicable)

PART 3 - EXECUTION (Not Applicable)

SECTION 09 01 90.52 - MAINTENANCE REPAINTING

PART 1 - GENERAL

A. Section includes maintenance repainting as follows:

1. Patching substrates. 2. Repainting.

a. Concrete c. Wood, dimensional and panel

d. Portland cement plaster (stucco) – existing

A. Work of this Section contributes to the amount specified in Section 012100

"Allowances."

according to ASTM D523. B. Gloss Level 2: Not more than 10 units at 60 degrees and 10 to 35 units at 85

C. Gloss Level 3: 10 to 25 units at 60 degrees and 10 to 35 units at 85 degrees, according to ASTM D523.

degrees, according to ASTM D523. E. Gloss Level 5: 35 to 70 units at 60 degrees, according to ASTM D523.

1.4 PREINSTALLATION MEETINGS

A. Product Data: For each type of product. B. Samples: For each type of paint system and each pattern, color, and gloss.

1. Label each Sample for location and application. C. Product List: Printout of current "MPI Approved Products List" for each MPIproduct category specified in paint systems, with the proposed product highlighted.

1.6 INFORMATIONAL SUBMITTALS A. Color Matching Certificate: For computer-matched colors.

2.1 PREPARATORY CLEANING MATERIALS

A. Water: Potable. B. Hot Water: Water heated to a temperature of 140 to 160 deg F (60 to 71 deg C). C. Detergent Solution: Solution prepared by mixing 2 cups (0.5 L) of tetrasodium pyrophosphate (TSPP), 1/2 cup (125 mL) of laundry detergent that contains no ammonia, 5 quarts (5 L) of 5 percent sodium hypochlorite bleach, and 15 quarts (15 L) of warm water for every 5 gal. (20 L) of solution required. Or, apply Jasco TSP No-

D. Mildewcide: Commercial proprietary mildewcide or a job-mixed solution prepared by mixing 1/3 cup (80 mL) of household detergent that contains no ammonia, 1 quart (1 L) of 5 percent sodium hypochlorite bleach, and 3 quarts (3

L) of warm water. E. Abrasives for Ferrous Metal Cleaning: Aluminum oxide paper, emery paper, fine steel wool, steel scrapers, and steel-wire brushes of various sizes.

F. Rust Remover: Manufacturer's standard phosphoric acid-based gel formulation, also called "naval jelly," for removing corrosion from iron and steel.

A. Low-Odor, water based paste paint remover: Manufacturer's standard low removing paint from masonry, stone, wood, plaster, or metal as required to suit

2.3 PAINT, GENERAL A. Material Compatibility: 1. Provide materials for use within each paint system that are

conditions compatible with one another and substrates indicated, under of service and application as demonstrated by manufacturer, based on testing and field experience. 2. For each coat in a paint system, provide products recommended in

writing by manufacturers of topcoat for use in paint system and on substrate indicated. B. Colors: Match District-standard paint manufacturer and Campus-standard

colors as indicated in drawings: COLOR 1 - "WHITE" - DEW341 - Swiss Coffee COLOR 2 - "GRAY" - Match existing door and trim color

COLOR 3 - "RED" - SW7583 Wild Currant

COLOR 4 - "TERRA COTTA" - Match existing clay roof tiles 2.4 PAINT MATERIALS, GENERAL A. MPI Standards: Provide products that comply with MPI standards indicated

B. Transition Coat: Paint manufacturer's recommended coating for use where a residual existing coating is incompatible with the paint system.

2.5 PAINT MATERIALS A. Primers and Sealers:

1. Primer Sealer, Latex, Alkali Resistant, Exterior: MPI #3. B. Metal Primers: 1. Primer, Rust-Inhibitive, Water Based: MPI #107. 2. Primer, Galvanized, Water Based: MPI #134.

and that are listed in its "MPI Approved Products List."

C. Wood Primers: 1. Primer, Latex for Exterior Wood: MPI #6. D. Water-Based Paints:

1. Latex, Exterior Low Sheen (Gloss Levels 3-4): MPI #15. E. Floor Coatings:

1. Floor Paint, Latex, Low Gloss (Maximum Gloss Level 3): MPI #60.

2.6 PATCHING MATERIALS

A. Wood-Patching Compound: Two-part, epoxy-resin, wood-patching compound; knife-grade formulation as recommended in writing by manufacturer for type of wood repair indicated, tooling time required for the detail of work, and site conditions. Compound shall be designed for filling voids in damaged wood materials that have deteriorated from weathering and decay. Compound shall be capable of filling deep holes and spreading to feather edge.

B. Metal-Patching Compound: Two-part, polyester-resin, metal-patching compound; knife-grade formulation as recommended in writing by manufacturer for type of metal repair indicated, tooling time required for the detail of work, and site conditions. Compound shall be produced for filling metal that has deteriorated from corrosion. Filler shall be capable of filling deep holes and

spreading to feather edge. C. Cementitious Patching Compounds: Cementitious patching compounds and repair materials specifically manufactured for filling cementitious substrates and for sanding or tooling prior to repainting; formulation as recommended in writing by manufacturer for type of cementitious substrate indicated, exposure to weather and traffic, the detail of work, and site conditions.

PART 3 - EXECUTION

3.1 MAINTENANCE REPAINTING, GENERAL A. Execution of the Work: In repainting surfaces, disturb them as minimally as

possible and as follows: 1. Remove failed coatings and corrosion and repaint. a. Lead Paint: Many school buildings on campus were constructed before 1978 and any disturbance to existing paint will require appropriate testing for existing lead paint and appropriate removal of disturbed lead

paint by an EPA certified contractor. Refer to the contract language. 2. Verify that substrate surface conditions are suitable for 3. Allow other trades to repair items in place before repainting. B. Mechanical Abrasion: Where mechanical abrasion is needed for the work, use gentle methods, such as scraping and lightly hand sanding, that will not abrade

softer substrates, reducing clarity of detail. C. Heat Processes: Do not use torches, heat guns, or heat plates.

3.2 EXAMINATION

A. Examine substrates and conditions, with Installer present, for compliance with requirements for maximum moisture content and other conditions affecting performance of painting work. Comply with paint manufacturer's written instructions for inspection.

B. Maximum Moisture Content of Substrates: Do not begin application of coatings unless moisture content of exposed surface is below the maximum value recommended in writing by paint manufacturer and not greater than the following maximum values when measured with an electronic moisture meter

appropriate to the substrate material: 1. Concrete or Fiber Cement: 12 percent.

2. Masonry (Clay and CMU): 12 percent. 3. Portland Cement Plaster: 12 percent. 4. Wood: 15 percent.

C. Alkalinity: Do not begin application of coatings unless surface alkalinity is within range recommended in writing by paint manufacturer. Conduct alkali testing with litmus paper on exposed plaster, cementitious, and masonry surfaces.

3.3 PREPARATORY CLEANING

A. General: Use the gentlest, appropriate method necessary to clean surfaces in preparation for painting. Clean all surfaces, corners, contours, and interstices. B. Detergent Cleaning: Wash surfaces by hand using clean rags, sponges, and bristle brushes. Scrub surface with detergent solution and bristle brush until soil is thoroughly dislodged and can be removed by rinsing. Use small brushes to remove soil from joints and crevices. Dip brush in solution often to ensure that adequate fresh detergent is used and that surface remains wet. Rinse with water applied by

clean rags or sponges. C. Solvent Cleaning: Use solvent cleaning to remove oil, grease, smoke, tar, and asphalt from painted or unpainted surfaces before other preparation work. Wipe surfaces with solvent using clean rags and sponges. If necessary, spot-solvent cleaning may be employed just prior to commencement of paint application, provided enough time is allowed for complete evaporation. Use clean solvent and clean rags for the final wash to ensure that all foreign materials have been removed. Do not use solvents, including primer thinner and turpentine, that leave

residue. D. Mildew: Clean off existing mildew, algae, moss, plant material, loose paint, grease, dirt, and other debris by scrubbing with bristle brush or sponge and detergent solution. Scrub mildewed areas with mildewcide. Rinse with water applied by clean rags or sponges.

E. Chemical Rust Removal: 1. Remove loose rust scale with specified abrasives for ferrous-metal cleaning.

2. Apply rust remover with brushes or as recommended in writing by manufacturer. 3. Allow rust remover to remain on surface for period recommended writing by manufacturer or as determined by preconstruction testing. Do not

allow extended dwell time. 4. Wipe off residue with mineral spirits and either steel wool or soft rags, or clean with method recommended in writing by manufacturer to remove

5. Dry immediately with clean, soft cloths. Follow direction of grain in metal. 6. Prime immediately to prevent rust. Do not touch cleaned metal surface

until primed. F. Mechanical Rust Removal: 1. Remove rust with specified abrasives for ferrous-metal cleaning. to bright metal.

metal. 4. Prime immediately to prevent rust. Do not touch cleaned metal surface until primed.

3. Dry immediately with clean, soft cloths. Follow direction of grain in

2. Wipe off residue with mineral spirits and either steel wool or soft rags.

3.4 PAINT REMOVAL

A. General: Remove paint where existing paint adherence or surface integrity has failed. Where cleaning methods have been attempted and further removal of the paint is required because of incompatible or unsatisfactory surfaces for repainting, remove paint to extent required by conditions.

1. Brushes: Use brushes that are resistant to chemicals being used. a. Metal Substrates: If using wire brushes on metal, use of same metal composition as metal being treated. b. Wood Substrates: Do not use wire brushes 2. Spray Equipment: Use spray equipment that provides controlled

application at volume and pressure indicated, measured at nozzle. pressure and volume to ensure that spray methods do not damage surfaces. a. Equip units with pressure gages. b. Unless otherwise indicated, hold spray nozzle at least 6 inches (150 mm) from surface and apply material in horizontal, back-and-forth

c. For chemical spray application, use low-pressure tank or chemical pump suitable for chemical indicated, equipped with nozzle having a coned. For water-spray application, use fan-shaped spray tip that

sweeping motion, overlapping previous strokes to produce uniform

disperses water at an angle of 25 to 50 degrees. e. For heated water-spray application, use equipment maintaining temperature between 140 and 160 deg F (60 and 71 deg C) at flow rates indicated. B. Paint Removal with Hand Tools: Remove paint manually using hand-held scrapers, wire brushes, sandpaper, and metallic wool as appropriate for the

substrate material. C. Paint Removal with Low-Odor, water based paste paint remover: 1. Apply thick coating of paint remover to dry, painted surface with

natural-fiber cleaning brush, deep-nap roller, or large paintbrush. Apply in one or two coats according to manufacturer's written instructions. 2. Allow paint remover to remain on surface for period recommended writing by manufacturer or as determined by preconstruction 3. Rinse with water applied by low-pressure spray to remove chemicals and paint residue.

5. Repeat process if necessary to remove all paint. 3.5 SUBSTRATE REPAIR A. General: Repair substrate surface defects that are inconsistent with the

4. Use mechanical methods recommended in writing by

manufacturer to remove chemicals and paint residue.

surface appearance of adjacent materials and finishes. B. Wood Substrate: 1. Repair wood defects including dents and gouges more than 1/8 inch (3 mm) in size and all holes and cracks by filling with woodand sanding smooth. Reset or remove protruding fasteners. 2. Where existing paint is allowed to remain, sand irregular buildup of paint, runs, and sags to achieve a uniformly smooth surface.

C. Cementitious Material Substrate: 1. General: Repair defects including dents and chips more than 1/4 mm) in size and all holes and cracks by filling with cementitious patching compound and sanding smooth. Remove protruding fasteners. 2. New and Bare Plaster: Neutralize surface of plaster with mild acid solution as recommended in writing by paint manufacturer. In lieu of acid neutralization, follow manufacturer's written instruction for primer or

transition coat over alkaline plaster surfaces. 3. Concrete, Cement Plaster, and Other Cementitious Products: Remove efflorescence, chalk, dust, dirt, grease, oils, and release agents. If surfaces are too alkaline to paint, correct this condition before painting. D. Metal Substrate:

1. Preparation: Treat repair locations by wire-brushing and solvent cleaning. Use chemical or mechanical rust removal method to clean off rust. 2. Defects in Metal Surfaces: Repair non-load-bearing defects in existing metal surfaces, including dents and gouges more than 1/8 inch (3 mm) deep or 1/2 inch (13 mm) across and all holes and cracks by filling with metal-patching compound and sanding smooth. Remove burrs and protruding fasteners.

3. Priming: Prime iron and steel surfaces immediately after repair to prevent flash rusting. Stripe paint corners, crevices, bolts, welds, and sharp edges. Apply two coats to surfaces that are inaccessible after completion of the

3.6 PAINT APPLICATION, GENERAL A. Prepare surfaces to be painted according to the Surface-Preparation Schedule and with manufacturer's written instructions for each substrate condition. B. Apply a transition coat over incompatible existing coatings. C. Metal Substrate: Stripe coat corners, crevices, bolts, welds, and sharp edges before applying full coat. Apply two coats to surfaces that are inaccessible after completion of the Work. Tint stripe coat different than the main coating and apply

system specified for the specific substrate. Apply final finish coat over entire surface from edge to edge and corner to corner. 3.7 FIELD QUALITY CONTROL

A. Manufacturer's Field Service: Engage paint-remover manufacturer's factory-

authorized service representative for consultation and Project-site inspection and

D. Blending Painted Surfaces: When painting new substrates patched into

existing surfaces or touching up missing or damaged finishes, apply coating

to provide on-site assistance when requested by Architect.

3.9 SURFACE-PREPARATION SCHEDULE

3.8 CLEANING AND PROTECTION A. At end of each workday, remove rubbish, empty cans, rags, and other discarded materials from Project site. B. Protect work of other trades against damage from paint application. Correct damage to work of other trades by cleaning, repairing, replacing, and refinishing,

as approved by Architect, and leave in an undamaged condition. C. At completion of construction activities of other trades, touch up and restore damaged or defaced painted surfaces.

applicable requirements specified in this schedule. 1. Examine surfaces to evaluate each surface condition according to 2. Where existing degree of soiling prevents examination, preclean surface and allow it to dry before making an evaluation. 3. Repair substrate defects according to "Substrate Repair" Article. B. Surface Preparation for MPI DSD 0 Degree of Surface Degradation:

A. General: Before painting, prepare surfaces for painting according to

1. Surface Condition: Existing paint film in good condition and tightly adhered. 2. Paint Removal: Not required. 3. Preparation for Painting: Wash surface by detergent cleaning; use solvent cleaning where needed. Roughen or degloss cleaned ensure paint adhesion according to paint manufacturer's written instructions.

2. Paint Removal: Scrape by hand-tool cleaning methods to remove paint until only tightly adhered paint remains. 3. Preparation for Painting: Wash surface by detergent cleaning; use other cleaning methods for small areas of bare substrate if required. Roughen, degloss, and sand the cleaned surfaces to ensure paint adhesion and a smooth finish according to paint manufacturer's written instructions.

C. Surface Preparation for MPI DSD 1 Degree of Surface Degradation:

1. Surface Condition: Paint film cracked or broken but adhered.

D. Surface Preparation for MPI DSD 2 Degree of Surface Degradation: 1. Surface Condition: Paint film loose, flaking, or peeling. 2. Paint Removal: Remove loose, flaking, or peeling paint film by hand-tool or chemical paint-removal methods.

3. Preparation for Painting: Wash surface by detergent cleaning; use solvent cleaning where needed. Use other cleaning methods for small areas of bare substrate if required. Sand surfaces to smooth remaining paint film edges. Prepare bare cleaned surface to be painted according to paint manufacturer's written instructions for substrate construction materials. E. Surface Preparation for MPI DSD 3 Degree of Surface Degradation: 1. Surface Condition: Paint film severely deteriorated. 2. Paint Removal: Completely remove paint film by hand-tool or chemical paint-removal methods. Remove rust. 3. Preparation for Painting: Prepare bare cleaned surface according to

paint manufacturer's written instructions for substrate F. Surface Preparation for MPI DSD 4 Degree of Surface Degradation: 1. Surface Condition: Missing material, small holes and openings, and deteriorated or corroded substrate. 2. Substrate Preparation: Repair, replace, and treat substrate according

to "Substrate Repair" Article. 3. Preparation for Painting: Sand substrate surfaces to smooth remaining paint film edges and prepare according to paint manufacturer's written instructions for substrate construction materials. Remove rust. 4. Painting: Paint as required for MPI DSD 2 degree of surface

3.10 EXTERIOR MAINTENANCE REPAINTING SCHEDULE A. Cementitious Substrates Horizontal: 1. Latex System: MPI REX 3.1 system: a. Prime Coat: For MPI DSD 1 degree of surface degradation, touch up with topcoat. b. Prime Coat: For MPI DSD 2 degree of surface degradation, spot prime with Primer, Alkali Resistant, Water Based, c. Prime Coat: For MPI DSD 3 degree of surface degradation, fully prime coat with Primer, Alkali Resistant, Water Based, d. Intermediate Coat: Latex, exterior, matching topcoat.

e. Topcoat: Floor Paint, Latex, exterior, low sheen (Gloss Level 3), MPI f. Color: Match colors indicated on Drawings. B. Cementitious/composite Substrates Vertical: 1. Latex System: MPI REX 3.2 system: a. Prime Coat: For MPI DSD 1 degree of surface degradation, touch up with topcoat. b. Prime Coat: For MPI DSD 2 degree of surface degradation, prime with Primer, Alkali Resistant, Water Based, c. Prime Coat: For MPI DSD 3 degree of surface degradation, fully prime coat with Primer, Alkali Resistant, Water Based, d. Intermediate Coat: Latex, exterior, matching topcoat. e. Topcoat: Latex, Exterior, low sheen (Gloss Level 3),

f. Color: Match colors indicated on Drawings. C. Ferrous Metal Substrates:: 1. Latex System: MPI REX 5.1 system over a transition coat where a. Prime Coat: For MPI DSD 1 degree of surface degradation, up with topcoat. b. Prime Coat: For MPI DSD 2 degree of surface degradation, spot prime with Primer, Rust-Inhibitive, Water Based, c. Prime Coat: For MPI DSD 3 degree of surface degradation, fully prime coat with Primer, Rust-Inhibitive, Water Based. MPI #107. d. Intermediate Coat: Latex, exterior, matching topcoat. e. Topcoat: Latex, Exterior, low sheen (Gloss Level 3), MPI #15.

f. Color: Match colors indicated on Drawings. D. Galvanized Ferrous Metal Substrates:: 1. Latex System: MPI REX 5.3 system over a transition coat where required. a. Prime Coat: For MPI DSD 1 degree of surface degradation, up with topcoat. b. Prime Coat: For MPI DSD 2 degree of surface degradation, prime with Primer, Galvanized, Water Based, MPI #134. c. Prime Coat: For MPI DSD 3 degree of surface degradation,

prime coat with Primer, Galvanized, Water Based, MPI #134. d. Intermediate Coat: Latex, exterior, matching topcoat. e. Topcoat: Latex, Exterior, low sheen (Gloss Level 3), b. Color: Match colors indicated on Drawings.

1. Latex System: MPI REX 6.4 system. a. Prime Coat: For MPI DSD 1 degree of surface degradation, up with topcoat. b. Prime Coat: For MPI DSD 2 degree of surface degradation, prime with Primer, Latex for Exterior Wood, MPI #6. c. Prime Coat: For MPI DSD 3 degree of surface degradation, prime coat with Primer, Latex for Exterior Wood,

E. Wood Paneling and Plywood:

MPI #15.

d. Intermediate Coat: Latex, exterior, matching topcoat. e. Topcoat: Latex, Exterior, low sheen (Gloss Level 3), f. Color: Match colors indicated on Drawings. F. Dimensional Wood: 1. Latex System: MPI REX 6.3A system.

a. Prime Coat: For MPI DSD 1 degree of surface degradation, up with topcoat. b. Prime Coat: For MPI DSD 2 degree of surface degradation, prime with Primer, Latex for Exterior Wood, MPI #6. c. Prime Coat: For MPI DSD 3 degree of surface degradation, prime coat with Primer, Latex for Exterior Wood,

f. Color: Match colors indicated on Drawings. G. Portland Cement Plaster: 1. Latex System: MPI REX 9.1 system: a. Prime Coat: For MPI DSD 1 degree of surface degradation, b. Prime Coat: For MPI DSD 2 degree of surface degradation, prime with Primer, Alkali Resistant, Water Based.

d. Intermediate Coat: Latex, exterior, matching topcoat.

e. Topcoat: Latex, Exterior, low sheen (Gloss Level 3),

c. Prime Coat: For MPI DSD 3 degree of surface degradation, prime coat with Primer, Alkali Resistant, Water Based, d. Intermediate Coat: Latex, exterior, matching topcoat. e. Topcoat: Latex, Exterior, low sheen (Gloss Level 3),



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CONSULTANTS:

AGENCY APPROVAL:

MATILIJA MS CAMPUS -WIDE EXTERIOR PAINTING

OWNER: OJAI UNIFIED SCHOOL DISTRICT 414 EAST OJAI AVENUE OJAI. CA 93023 (805) 640-4300 **CONTACT: ADAM DUTTER** EMAIL: adutter@ojaiusd.org

PROJECT ADDRESS:

MATILIJA MIDDLE SCHOOL 703 EL PASEO ROAD OJAI, CA 93023 OJAI USD PROJECT NO.: 2021-1600

ISSUE: MARK DATE DESCRIPTION

2021.010

PBS

REVIEWED BY: THE ORIGINAL SIZE OF THIS SHEET IS 36"x24". IF THE CURRENT SIZE IS OTHER THAN 36"x24". THEN ADJUST THE SCALE OF THE DRAWINGS ACCORDINGLY. SHEET TITLE:

SPECIFICATIONS

PROJECT INFORMATION:

PROJECT NUMBER:

PROJECT PHASE:

DRAWN BY:

SHEET NUMBER:

District, instructing the Contractor to proceed with a change in the Work, for subsequent inclusion in a Change Order. The directive will describe changes in

C. The Architect may issue Supplemental Instructions for minor changes that will not affect Contract Sum or Contract Time. The Contractor shall sign and return the original copy of the form to the Architect

Contractor shall provide additional data, including the following, to support the

2. Taxes, insurance, and bonds. 3. Overhead and profit.

4. Justification for change in Contract Time.

required to complete the work.

including the following, after completing the Change.

3. Time records and wage rates paid.

parties as provided in the Conditions of the Contract.

C. Promptly enter changes on the Project Record Documents.

b. Metal, galvanized and ungalvanized

1.3 DEFINITIONS A. Gloss Level 1: Not more than 5 units at 60 degrees and 10 units at 85 degrees,

degrees, according to ASTM D523. D. Gloss Level 4: 20 to 35 units at 60 degrees and not less than 35 units at 85

F. Gloss Level 6: 70 to 85 units at 60 degrees, according to ASTM D523. G. Gloss Level 7: More than 85 units at 60 degrees, according to ASTM D523.

A. Preinstallation Conference: Conduct conference at Project site. 1.5 ACTION SUBMITTALS

PART 2 - PRODUCTS

Rinse Substitute. Follow manufacturer's instructions for mixing and application.

odor, water-rinsable, water based paste, gel, or foamed emulsion formulation for Project; and containing no methanol or methylene chloride.

f. Color: Match colors indicated on Drawings.

touch

spot

fully

touch

spot

fully

touch

spot

fully

GENERAL NOTES &

A. Work In This Section: Principal items include:

1. Preparation of surfaces. 2. Painting of interior surfaces, except as otherwise specified.

3. Painting of exterior surfaces, except as otherwise specified.

B. Related Work Not In This Section: 1. Shop prime coats and factory finishes. 2. Painting specified as work of other sections.

3. Caulking and sealants.

C. Surfaces Not To Be Painted:

1. Non-ferrous metal work (other than zinc-coated surfaces) and plated metal, unless particular items are specified to be painted. 2. Stone surfaces.

3. Exterior concrete walls and surfaces unless particular items are specified to be painted... 4. Surfaces concealed in walls and above solid ceilings.

5. Non-metallic walking surfaces unless specifically shown or specified to be painted. 6. Factory finished surfaces.

7. Ceramic tile and plastic surfaces.

8. Resilient base.

9. Galvanized fencing. 10. Galvanized gratings.

11. Surfaces indicated not to be painted.

12. Surfaces specified to be finish painted under other sections.

1.02 COMPLIANCE WITH REGULATIONS: All materials shall comply with the current rules and regulations of the local air quality management district, with the rules regarding volatile organic compounds, and with FDA rules and regulations for dangerous materials in

1.03 SUBMITTALS

A. List of Paint Materials: Prior to submittal of samples, submit a complete list of proposed paint materials, identifying each material by manufacturer's name, product name and number, including primers, thinners, and coloring agents, together with manufacturers' catalog data fully describing each material as to contents, recommended usage, and preparation and application methods. Identify surfaces to receive various paint materials. Do not deviate from approved list.

B, Color Samples: Prior to preparing samples, obtain color and gloss selections and instructions. Using materials from approved list, prepare and submit 8-1/2" by 11" samples of each complete opaque paint finish.

C. Natural or Stain Finish Samples: Prepare samples on 12" squares of the same species and appearance of wood as used in the work. D. Job Samples: Apply minimum 100 square foot samples on site, on actual surfaces to

be finished with each material, color, and gloss, in locations as directed. Prime and intermediate coats shall extend one foot beyond finish coat on each sample in at least 2 directions. Obtain approval of each sample prior to proceeding with the work. Leave the samples in place, with removable tags, until completion of the work. All work shall match approved samples. E. Certificates: Submit certificate showing that all products meet the requirements of

paragraph "Compliance with Regulations" above. 1.04 JOB CONDITIONS

B. Examination of Surfaces: Examine surfaces to be painted or finished under this Section

A. Protection: Protect all painting while in progress and cover and protect adjoining surfaces and property of others from damage. Exercise care to prevent paint from contacting surfaces not to be painted. During painting of exterior work, cover windows, doors, concrete, and other surfaces not to be painted.

and verify satisfactory condition. Unsatisfactory conditions shall be corrected before application of the first coat of paint. C. Weather Conditions: Apply paint to clean, dry, prepared surfaces. Do not apply exterior paint during rainy, damp, foggy, or excessively hot and/or windy weather. Arrange

for temporary heat and ventilation for interior painting. D. Precaution: Place rags and waste in self-closing metal containers, removed from site at the end of each day. Do not let rags and waste accumulate.

A. Provide a one gallon container of each paint color and surface texture to Owner at B. Label each container with color, texture, and original application locations, in addition

PART 2 - PRODUCTS 2.01 ACCEPTABLE MANUFACTURERS:

Dunn-Edwards Corp. (Basis of Design) 4885 E. 52nd Place Los Angeles CA, 90058

(323) 771-3330

Benjamin Moore & Co.

to the manufacturer's label.

The Sherwin-Williams Company, Inc. 101 W. Prospect Ave. Cleveland, OH 44115 (216) 566-2000 FAX (216) 566-2947

51 Chestnut Ridge Road Montvale NJ 07645 (888) 236-6667 Vista Paint Corporation

2020 Orangethorpe Avenue, Suite 210 Fullerton CA 92831 (323) 397-9000 FAX (323) 883-0273

PART 3 - EXECUTION

3.01 WORKMANSHIP: Apply painting materials in accordance with manufacturer's instructions by brush or roller; spray painting is not allowed without specific approval in each case unless noted otherwise. For this project, spray painting and backrolling is acceptable at exterior walls and exterior ceilings. Apply each coat at the proper consistency, free of brush or roller marks, sags, runs, or other evidence of poor workmanship. Do not lap paint on glass, hardware, and other surfaces not to be painted: apply masking as required. Sand between enamel coats. Apply painting materials in accordance with manufacturer's

3.02 PREPARATION OF SURFACES: Properly prepare surfaces to receive finishes. A. Concrete: Fill cracks, holes, and other blemishes with Portland cement patching plaster or a stiff paste mixed of finish paint and fine sand, finished to match adjoining surfaces. Remove glaze by sanding, wire brushing, or light brush-off sandblasting. Neutralize all alkali conditions according to the paint manufacturer's directions. Dry surfaces to receive breathing type latex paints at least two weeks, free of visible moisture. Dry the surfaces to receive oil, alkyd, or epoxy based paint until the moisture content does not exceed 8% when tested with an electronic moisture-measuring instrument.

B. Masonry: Repair minor holes and cracks with a stiff paste of finish paint and fine sand or vinyl type block filler. Report major or unsightly defects for correction. Neutralize all alkali and efflorescence according to paint manufacturer's directions, and allow to dry. C. Exterior Plaster: Fill hairline cracks with Portland cement patching material; report larger cracks for correction. Test and ensure plaster is sufficiently dry to receive the paint

D. Gypsum Wallboard: Touch-up minor defects with spackle and sand smooth and flush. Report other defects as specified. Verify that skim coat specified in Section 09250 is properly applied. If not, apply one heavy coat of skim coat material specified in Section 09250, over entire surface by brush or roller.

E. Shop Coated Metal: Degrease and clean of foreign matter. Clean and spot prime field connections, welds, soldered joints, burned, or abraded portions with same material used in shop coats. After complete hardening, sand entire surfaces for coat to follow. F. Uncoated Ferrous Metal: Degrease and clean of dirt, rust, mill scale, and all other foreign matter using power tool rotary brushes to achieve a clean surface consistent with SSPC-SP3. Remove pits and welding slag, and clean surfaces to bright metal before

priming. Apply metal primer not more than three hours after preparation. G. Galvanized Metal: Eliminate contaminants and stabilize zinc film by solvent wiping or sweep blasting, as appropriate, followed by not less than one coat of wash primer of type specified in Paint Schedule hereafter, to provide suitable surface for finish painting. Allow to dry. Prepare a representative surface, not smaller than 24" square, or 36" by length of

section, as applicable, and obtain approval prior to proceeding. 1. Solvent wiping: Remove oil and grease with rags or brushes saturated in trisodium phosphate or similar alkaline detergent. For heavier soil, use MEK, or equivalent

proprietary cleaner. Do not use vinegar or acetic acid. 2. Sweep blasting: Use aluminum/magnesiumsilicate, limestone or other non-metallic

blast media to expose pure zinc. 3. Wash primer: Spray apply one coat of specified wash primer after other preparation is complete, to thickness of 0.5 mils. Allow to dry 60 minutes, and apply top coating in not more than 4 hours, If this time is exceeded for any reason, reapply wash primer prior to applying finish paint.

H.Enameled Woodwork: Remove handling marks and effects of exposure to moisture with a thorough sanding overall surfaces of the exposed portions, using at least 150 grit of finer sandpaper and thoroguhly clean all surfaces before applying sealer. After priming, putty nail holes, cracks, or other defects with putty matching color of finish paint. Cover knots and sappy areas with shallac or approved knot sealer. Sand each base coat smooth when dry.

I. Transparent Finished Woodwork: Remove handling marks and effects of exposure to moisture with a thorough sanding parallel to the grain of the wood, over all surfaces of the exposed portions, including interiors of cases and drawers, using at least 150 grit or finer sandpaper and thoroughly clean all surfaces before applying sealer. Repair all defects with filler tinted to match stain or wood color, as required, after first coat of sanding sealer and remove all smears. J. Fixtures, Equipment, and Flardware Items: Coordinate with the work of other sections, and coordinate removal of fixtures, equipment, and hardware as required to

perform painting. Items to be removed include, without limitation: signs and graphics; switch and receptacle plates; escutcheons and plates; all surface-mounted equipment; free-standing equipment blocking access; grilles and louvers at ducts opening into finished spaces; and other items as required and directed. Surfaces Not Mentioned: Prepare surfaces according to recommendations of the paint manufacturer and as approved.

K. Surfaces Not Mentioned: Prepare surfaces according to recommendations of the paint manufacturer and as approved. L. Moisture Content: Measure moisture at surfaces using an electronic moisture

Do not apply finishes unless moisture is below the following maximums: 1. Exterior Plaster and Concrete: 15 percent

2. Exterior Wood: 19 percent 3. Interior Gypsum Wallboard: 12 percent Interior Wood:4. 15 percent measured in accordance with ASTM D2016

3.03 COATS: The number of paint coats specified to be applied are minimum. Apply additional coats if required to obtain complete hiding and approved results. Ensure acceptable paint finishes of uniform color, free from cloudy or mottled areas and evident thinness on arises. "Spot" or undercoat surfaces as necessary to produce such results. Tint each coat a slightly different shade of finish color to permit identification. Conform to the approved Samples. Obtain approval of each coat before applying next coat; otherwise, apply an additional coat over entire surface

involved at no additional contract cost. 3.04 COLORS: The numbers given in the following schedule indicate the types of paints required for each surface, identified by their number in white. The actual paint to be applied on each surface shall be the same material in the color or colors as selected, and as approved on submitted samples. Allow for the use of several colors in each room or space, and for doors, frames, dadoes, trim and other items to be finished in different colors.

3.05 DEGREE OF GLOSS: Degrees of gloss shown on drawings and herein specified are approximate only. The exact degree of gloss required for each surface will be determined. Materials shall meet the following requirements for degree of gloss, when tested according to ASTM D523, using Gardner Laboratory 60 degree gloss meter after 14 days.

NOMENCLATURE	PERCENTAGE OF GLOSS
FLAT	LESS THAN 10
SUEDE OR EGGSHELL	25 - 55
SATIN OR SEMI-GLOSS	55 - 70
GLOSS OR HIGH GLOSS	MORE THAN 70

3.06 MISCELLANEOUS PAINTING: A. Fire Extinguisher and Fire Hose Cabinets and Fire Alarm Bells: Apply 2 coats of paint finish, inside and out, matching finish and color of adjoining areas, unless otherwise noted or directed.

B. Weatherstripping and Sound Seals. Paint exposed metal surfaces to match the door frame, whether or not unfinished, furnished with factory prime coat, or factory treated for paint adhesion. C. Doors: Seal top and bottom edges after cleaning with coat of primer. Where the faces of the doors differ in color or finish, finish the edges to match the face visible

when the door is open. Coat cutouts for hinges, edges of lockset holes and strikes

same as for first coat. D. Access doors and panels: Generally, paint same color as surrounding walls and

E. Louvers and glazed frames in wood and metal doors: Unless otherwise directed. paint 3 coats, colors to match doors.

G. Door Trim and Prime Coated Hinges: Paint trim to match door and paint hinges to match frame only where hinges are currently painted. Do not paint unfinished hinges. H. Speaker Grilles: Paint to match surrounding surfaces unless specified otherwise. I. Miscellaneous. For any items not specifically indicated or specified that require a paint finish, apply 3 coats of paint as directed.

3.07 CLEANING AND TOUCH-UP WORK. Make a detailed inspection of paint finishes after all painting is completed, remove spatterings of paint from the adjoining surfaces, and make good all damage that may be caused by cleaning operations. Carefully touch-up all abraded, stained, or otherwise disfigured painting, as approved, and leave entire painting in first-class condition.

<u>TABLE 1</u> EXTERIOR PA	INTING SCHEDU	PRIME WHERE NEE	FOR ALL EXISTING PAINTED SUR DED & APPLY (2) COATS OF PAINT ISTING UNPAINTED SURACES: PF	T PER TABLE BELOW. TYPCIAL
SURFACE, COATS	DUNN-EDWARDS	BENJAMIN MOORE	VISTA PAINT	SHERWIN WILLIAMS
PLASTER & CONCRETE (100% ACRYLIC EGGSHELL/SATIN) FIRST COAT SECOND COAT THIRD COAT	ESPR00 - EFF-STOP PREMIUM EVSH10 - EVERSHIELD10 EVSH10 - EVERSHIELD10	N023 FRESH START PRIMER 631 AURA SATIN 631 AURA SATIN	4600 UNIPRIME 2000 DURATONE 2000 DURATONE	LOXON LX02W0050 SUPERPAINT SATIN A89 SUPERPAINT SATIN A89
CONC. UNIT MASONRY (100% ACRYLIC EGGSHELL/SATIN) FIRST COAT SECOND COAT THIRD COAT	SBSL00-SMOOTHBLOC-FIL SELECT EVSH10 - EVERSHIELD10 EVSH10 - EVERSHIELD10	571 LATEX BLOCK FILL 631 AURA SATIN 631 AURA SATIN	040 BLOCK KOTE 2000 DURATONE 2000 DURATONE	HVY DUTY FILLER B42W46 SUPERPAINT SATIN A89 SUPERPAINT SATIN A89
FERROUS METAL ALKYD URETHNE SEMIGLOS ENAMEL FIRST COAT SECOND COAT THIRD COAT	BRPR00-BLOC-RUST PREMIUM ASHL50 - ARISTOSHIELD50 ASHL50 - ARISTOSHIELD50	OR EQUAL FROM OTHER MFRS	9600 PROTEC METAL PRIME 9800 PROTEC SEMIGLOSS 9800 PROTEC SEMIGLOSS	PROCRYL PRIMER B66 SERII PI WB ALKYD URETHANE B5 PI WB ALKYD URETHANE B5
GALVANIZED METAL, ALKYD URETHNE SEMIGLOS ENAMEL PRETREAT FIRST COAT SECOND COAT THIRD COAT	SC-ME01 - KRUD KUTTER METAL CLEAN AND ETCH UGPR00 - ULTRAGRIP PREMIUM ASHL50 - ARISTOSHIELD50 ASHL50 - ARISTOSHIELD50	OR EQUAL FROM OTHER MFRS	JASCO PREP N'PRIME 9600 PROTEC METAL PRIME 9800 PROTEC SEMIGLOSS 9800 PROTEC SEMIGLOSS	DTM WASH PRIMER PROCRYL PRIMER B66 SERII PI WB ALKYD URETHANE B5 PI WB ALKYD URETHANE B5
WOOD - PAINTED, 100% ACRYLIC SEMI-GLOSS ENAMEL FIRST COAT SECOND COAT THIRD COAT	EZPROO - E-Z PRIME PREMIUM ASHL50 - ARISTOSHIELD50 ASHL50 - ARISTOSHIELD50	N023 FRESH START PRIMER W096 MOORGLO W096 MOORGLO	4200 TERMINATOR 8400 CAREFREE 8400 CAREFREE	PREPRITE PROBLOCK B51 SOLO A76 SERIES SOLO A76 SERIES
WOOD, SEMI-TRANSPARENT STAIN FIRST COAT SECOND COAT (IF REQ'D)	CABOT STAIN SEMI-SOLID	C329 SEMI-SOLID STAIN C329 SEMI-SOLID STAIN	OLYMPIC ST STAIN OLYMPIC ST STAIN	WOODSCAPES A15T5 WOODSCAPES A15T5
	INTERIO	TABLE 2 R ENAMEL MATI	-RIAI S	
SURFACE, COATS	DUNN-EDWARDS	BENJAMIN MOORE	VISTA PAINT	SHERWIN WILLIAMS
100% ACRYLIC FINISH, GLOSS	SWLL50 SPARTAWALL60	309 IMPERVEX	8500 CAREFREE	SOLO A77 GLOSS SERIES
100% ACRYLIC FINISH, SEMI- GLOSS WALLS AND CEILINGS ONLY NON-BLICKING, FOR DOORS AND WINDOWS	W6160E VERBAGLO SWLL50 SPARTAWALL60	276 MOORCRAFT 333 REGAL AQUAGLO	7000 ACRIGLO 8400 CAREFREE	SOLO A76 SEMI-GLOSS SERIES
100% ACRYLIC FINISH, EGGSHELL	W6Z50E VERSASATIN	277 SUPER SPEC PEARL	1700 COVERALL	SOLO EGGSHELL A75 SERIE
	INTERIO	TABLE 3 R PAINTING SCH	EDULE	
SURFACE, COATS	DUNN-EDWARDS	BENJAMIN MOORE	VISTA PAINT	SHERWIN WILLIAMS
WOOD, SEMI-TRANSPARENT STAIN FIRST COAT SECOND COAT	SWLL50 SPARTAWALL60 SWLL50 SPARTAWALL60	215 REGAL WALL SATIN 215 REGAL WALL SATIN	8100 CAREFREE 8100 CAREFREE	PROMAR 200HP EGGSHELL B20-1900 PROMAR 200HP EGGSHELL B20-1900
CONCRETE UNIT MASONRY, ACRYLIC FLAT FINISH FIRST COAT SECOND COAT	SB5L00 - SMOOTH BLOCK- FIL SELECT ENAMEL FINISH	205 BLOCK FILLER 215 REGAL WALL SATIN	040 BLOCK KOTE 8100 CAREFREE	BLOCK FILLER B42W46 PROMAR 200HP EGGSHELL B20-1900 PROMAR 200HP EGGSHELL

ENAMEL FINISH 215 REGAL WALL SATIN WOOD, ENAMEL FINI FIRST COAT SECOND COAT THIRD COAT WOOD, SATIN CLEA VARNISH 3 COATS FERROUS METAL, I

SECTION 08 11 13 - HOLLOW METAL DOORS AND FRAMES

PART 1 - GENERAL

1.1 RELATED DOCUMENTS A. Drawings and general provisions of the Contract, including General and

Supplementary Conditions and Division 01 Specification Sections, apply to this Section. 1.2 SUMMARY

A. Section Includes:

Frames.

1. Standard and custom hollow metal doors and frames.

2. Steel sidelight, borrowed lite and transom frames. 3. Louvers installed in hollow metal doors.

4. Light frames and glazing installed in hollow metal doors.

B. Related Sections: 1. Division 04 Section "Unit Masonry" for embedding anchors for hollow metal work into masonry construction.

2. Division 08 Section "Glazing" for glass view panels in hollow metal doors. 3. Division 08 Section "Door Hardware".

4. Division 08 Section "Access Control Hardware". 5. Division 09 Sections "Exterior Painting" and "Interior Painting" for field painting hollow metal doors and frames.

C. Codes and References: Comply with the version year adopted by the Authority Having Jurisdiction 1. ANSI/SDI A250.8 - Recommended Specifications for Standard Steel Doors and

2. ANSI/SDI A250.4 - Test Procedure and Acceptance Criteria for Physical Endurance for Steel Doors, Frames, Frames Anchors and Hardware Reinforcing. 3. ANSI/SDI A250.6 - Recommended Practice for Hardware Reinforcing on

Standard Steel Doors and Frames. 4. ANSI/SDI A250.10 - Test Procedure and Acceptance Criteria for Prime Painted Steel Surfaces for Steel Doors and Frames.

5. ANSI/SDI A250.11 - Recommended Erection Instructions for Steel Frames. 6. ASTM A1008 - Standard Specification for Steel Sheet, Cold-Rolled, Carbon, Structural, High-Strength Low-Alloy and High-Strength Low-Alloy with Improved Formability.

7. ASTM A653 - Standard Specification for Steel Sheet, Zinc-Coated (Galvanized) or Zinc-Iron Alloy-Coated (Galvannealed) by the Hot-Dip Process. 8. ASTM A924 - Standard Specification for General Requirements for Steel

9. ASTM C 1363 - Standard Test Method for Thermal Performance of Building Assemblies by Means of a Hot Box Apparatus. 10. ANSI/BHMA A156.115 - Hardware Preparation in Steel Doors and Frames.

11. ANSI/SDI 122 - Installation and Troubleshooting Guide for Standard Steel Doors 12. ANSI/NFPA 80 - Standard for Fire Doors and Fire Windows; National Fire

Protection Association 13. ANSI/NFPA 105: Standard for the Installation of Smoke Door Assemblies. 14. NFPA 252 - Standard Methods of Fire Tests of Door Assemblies; National Fire

Protection Association. 15. UL 10C - Positive Pressure Fire Tests of Door Assemblies. 16. UL 1784 - Standard for Air Leakage Tests of Door Assemblies.

Sheet, Metallic-Coated by the Hot-Dip Process.

.3 SUBMITTALS A. Product Data: For each type of product indicated. Include construction details, material descriptions, core descriptions, hardware reinforcements, profiles, anchors, fire-resistance rating, and finishes.

B. Door hardware supplier is to furnish templates, template reference number and/or physical hardware to the steel door and frame supplier in order to prepare the doors and frames to receive the finish hardware items.

C. Shop Drawings: Include the following: 1. Elevations of each door design.

2. Details of doors, including vertical and horizontal edge details and metal thicknesses.

3. Frame details for each frame type, including dimensioned profiles and metal thicknesses.

4. Locations of reinforcement and preparations for hardware. 5. Details of anchorages, joints, field splices, and connections.

6. Details of accessories. 7. Details of moldings, removable stops, and glazing. 8. Details of conduit and preparations for power, signal, and control systems.

D. Samples for Verification: 1. Samples are only required by request of the architect and for manufacturers that are not current members of the Steel Door Institute.

Source Limitations: Obtain hollow metal doors and frames through one source from a single manufacturer wherever possible. B. Quality Standard: In addition to requirements specified, comply with ANSI/SDI A250.8, latest edition, "Recommended Specifications for Standard Steel Doors

and Frames". C. Fire-Rated Door Assemblies: Assemblies complying with NFPA 80 that are listed and labeled by a qualified testing agency, for fire-protection ratings indicated, based on testing at positive pressure according to NFPA 252 (neutral pressure at 40" above sill) or UL 10C.

1. Oversize Fire-Rated Door Assemblies Construction: For units exceeding sizes of tested assemblies, attach construction label certifying doors are built to standard construction requirements for tested and labeled fire rated door assemblies except for size. 2. Temperature-Rise Limit: Where indicated and at vertical exit enclosures

(stairwell openings) and exit passageways, provide doors that have a maximum transmitted temperature end point of not more than 450 deg F (250 deg C) above ambient after 30 minutes of standard fire-test exposure. 3. Smoke Control Door Assemblies: Comply with NFPA 105.

a. Smoke "S" Label: Doors to bear "S" label, and include smoke and draft control gasketing applied to frame and on meeting stiles of pair doors. D. Fire-Rated, Borrowed-Light Frame Assemblies: Assemblies complying with

NFPA 80 that are listed and labeled, by a testing and inspecting agency acceptable to authorities having jurisdiction, for fire-protection ratings indicated. based on testing according to NFPA 257. Provide labeled glazing material. E. Energy Efficient Exterior Openings: Comply with minimum thermal ratings, based

on ASTM C1363. Openings to be fabricated and tested as fully operable, thermal insulating door and frame assemblies. 1. Thermal Performance (Exterior Openings): Independent testing laboratory certification for exterior door assemblies being tested in accordance with

ASTM C1363 and meet or exceed the following requirements: a. Door Assembly Operable U-Factor and R-Value Ratings: U-Factor 0.29, R-Value 3.4, including insulated door, thermal-break frame and threshold. 2. Air Infiltration (Exterior Openings): Independent testing laboratory certification

for exterior door assemblies being tested in accordance with ASTM E283 to meet or exceed the following requirements: a. Rate of leakage of the door assembly shall not exceed 0.25 cfm per square foot of static differential air pressure of 1.567 psf (equivalent to 25 mph

wind velocity). F. Pre-Submittal Conference: Conduct conference in compliance with requirements in Division 01 Section "Project Meetings" with attendance by representatives of Supplier, Installer, and Contractor to review proper methods and procedures for installing hollow metal doors and frames and to verify installation of electrical knockout boxes and conduit at frames with electrified or access control hardware.

1.5 DELIVERY, STORAGE, AND HANDLING A. Deliver hollow metal work palletized, wrapped, or crated to provide protection during transit and Project site storage. Do not use non-vented plastic.

B. Deliver welded frames with two removable spreader bars across bottom of frames, tack welded to jambs and mullions. C. Store hollow metal work under cover at Project site. Place in stacks of five units maximum in a vertical position with heads up, spaced by blocking, on minimum 4inch high wood blocking. Do not store in a manner that traps excess humidity.

1. Provide minimum 1/4-inch space between each stacked door to permit air

A. Coordinate installation of anchorages for hollow metal frames. Furnish setting

circulation. Door and frames to be stacked in a vertical upright position. A. Field Measurements: Verify actual dimensions of openings by field measurements before fabrication.

drawings, templates, and directions for installing anchorages, including sleeves, concrete inserts, anchor bolts, and items with integral anchors. Deliver such items to Project site in time for installation. 1.8 WARRANTY

1.7 COORDINATION

replacement of defective doors.

A. Special Warranty: Manufacturer's standard form in which manufacturer agrees to repair or replace doors that fail in materials or workmanship within specified B. Warranty includes installation and finishing that may be required due to repair or

PART 2 - PRODUCTS

2.1 MANUFACTURERS A. Manufacturers: Subject to compliance with requirements, provide products by one

of the following:

2. Curries Company.

1. CECO Door Products.

3. Security Metal Products.

2.2 MATERIALS A. Cold-Rolled Steel Sheet: ASTM A 1008/A 1008M, Commercial Steel (CS), Type B; suitable for exposed applications.

B. Metallic-Coated Steel Sheet: ASTM A 653/A 653M, Commercial Steel (CS), Type B; with minimum G60 (Z180) or A60 (ZF180) metallic coating.

C. Frame Anchors: ASTM A 653/A 653M, Commercial Steel (CS), Commercial Steel (CS), Type B; with minimum G60 (Z180) or A60 (ZF180) metallic coating. 2.3 STANDARD HOLLOW METAL DOORS

A. General: Provide 1-3/4 inch doors of design indicated, not less than thickness indicated; fabricated with smooth surfaces, without visible joints or seams on exposed faces unless otherwise indicated. Comply with ANSI/SDI A250.8. B. Exterior Doors: Face sheets fabricated of commercial quality hot-dipped zinc coated steel that complies with ASTM A 653/A 653M, Coating Designation A60.

Provide doors complying with requirements indicated below by referencing

ANSI/SDI A250.8 for level and model and ANSI/SDI A250.4 for physical

performance level: 1. Design: Flush panel.

2. Core Construction: Manufacturer's standard polystyrene. Where indicated, provide doors fabricated as thermal-rated assemblies with a minimum R-value

3. Top and Bottom Edges: Reinforce tops and bottoms of doors with a continuous steel channel not less than 16 gauge, extending the full width of the door and welded to the face sheet. Doors with an inverted top channel to include a steel closure channel, screw attached, with the web of the channel flush with the face sheets of the door. Plastic or composite channel fillers are not acceptable. 4. Hinge Reinforcement: Minimum 7 gauge (3/16") plate 1-1/4" x 9" or minimum 14

gauge continuous channel with pierced holes, drilled and tapped. 5. Hardware Reinforcements: Fabricate according to ANSI/SDI A250.6 with

reinforcing plates from same material as door face sheets. C. Interior Doors: Face sheets fabricated of commercial quality cold rolled steel that complies with ASTM A 1008/A 1008M. Provide doors complying with requirements indicated below by referencing ANSI/SDI A250.8 for level and model and ANSI/SDI A250.4 for physical performance level:

1. Design: Flush panel. 2. Core Construction: Manufacturer's standard kraft-paper honeycomb, or onepiece polystyrene core, securely bonded to both faces.

a. Fire Door Core: As required to provide fire-protection and temperature-rise ratings indicated. 3. Top and Bottom Edges: Reinforce tops and bottoms of doors with a continuous

steel channel not less than 16 gauge, extending the full width of the door and welded to the face sheet. 4. Hinge Reinforcement: Minimum 7 gauge (3/16") plate 1-1/4" x 9" or minimum 14

gauge continuous channel with pierced holes, drilled and tapped. 5. Hardware Reinforcements: Fabricate according to ANSI/SDI A250.6 with reinforcing plates from same material as door face sheets.

D. Manufacturers Basis of Design: 2.4 ENERGY-EFFICIENT HOLLOW METAL DOORS

A. General: Provide 1-3/4 inch doors of design specified, not less than thickness indicated; fabricated with smooth surfaces, without visible joints or seams on exposed faces unless otherwise indicated. Comply with ANSI/SDI A250.8 and ANSI/NAAMM HMMA 867.

B. Energy Efficient Exterior Doors: Face sheets fabricated of commercial quality hotdipped zinc coated steel that complies with ASTM A924 A60. Provide doors complying with requirements indicated below by referencing ANSI/SDI A250.8 for level and model, ANSI/SDI A250.4 for physical performance level, and HMMA 867 for door construction. 1. Design: Flush panel.

core with no stiffener face welds, in compliance with HMMA 867 "Laminated a. Provide 22 gauge steel stiffeners at 6 inches on-center internally welded at 5" on- center to integral core assembly, foamed in place polyurethane core chemically bonded to all interior surfaces. No stiffener face welding is

2. Core Construction: Foamed in place polyurethane and steel stiffened laminated

b. Thermal properties to rate at a fully operable minimum U-Factor 0.29 and R-Value 3.4, including insulated door, thermal-break frame and threshold. 1 Kerf Type Frames: Thermal properties to rate at a fully operable minimum U-Factor 0.36 and R-Value 2.7, including insulated door, kerf type frame,

and threshold. 3. Level/Model: Level 2 and Physical Performance Level A (Heavy Duty), Minimum 18 gauge (0.042 inch - 1.1-mm) thick steel, Model 2.

4. Vertical Edges: Vertical edges to be mechanically interlocked with hairline seam. Beveled Lock Edge, 1/8 inch in 2 inches (3 mm in 50 mm). 5. Top and Bottom Edges: Reinforce tops and bottoms of doors with a continuous steel channel not less than 16 gauge, extending the full width of the door and welded to the face sheet. Doors with an inverted top channel to include a steel closure channel, screw attached, with the web of the channel flush with the

face sheets of the door. Plastic or composite channel fillers are not acceptable. 6. Hinge Reinforcement: Minimum 7 gauge (3/16") plate 1-1/4" x 9". 7. Hardware Reinforcements: Fabricate according to ANSI/SDI A250.6 with reinforcing plates from same material as door face sheets.

1. CECO Door Products Trio-E/Trio Series. 2. Curries Company 777 Trio-E/Trio Series. 2.5 STANDARD HOLLOW METAL FRAMES

C. Manufacturers Basis of Design:

B. Exterior Frames: Fabricated of hot-dipped zinc coated steel that complies with ASTM A 653/A 653M, Coating Designation A60. 1. Fabricate frames with mitered or coped corners.

A. General: Comply with ANSI/SDI A250.8 and with details indicated for type and

2. Fabricate frames, with the exception of knock down types, with "closed and tight" miter seams continuously welded on face, finished smooth with no visible seam unless otherwise indicated.

3. Frames for Level 3 Steel Doors (up to 48 inches in width): Minimum 14 gauge (0.067-inch -1.7-mm) thick steel sheet. 4. Frames for Level 3 Steel Doors (48 inches and up in width): Minimum 12 gauge (0.081-inch -2.7-mm) thick steel sheet.

5. Frames for Level 2 Steel Doors: Minimum 16 gauge (0.053-inch -1.3-mm) thick 6. Manufacturers Basis of Design: a. CECO Door Products SQ/SU/SR Series.

b. Curries Company M/G Series.

8. Manufacturers Basis of Design:

anchors not less than 0.177 inch thick.

C. Interior Frames: Fabricated from cold-rolled steel sheet that complies with ASTM A 1008/A 1008M. 1. Fabricate frames with mitered or coped corners. 2. Fabricate frames, with the exception of slip-on drywall types, with "closed and

visible seam unless otherwise indicated. 3. Frames for Steel Doors: Minimum 16 gauge (0.053-inch -1.3-mm) thick steel

tight" miter seams continuously welded on face, finished smooth with no

inch -1.3-mm) thick steel sheet.] 5. Frames for openings 48 inches and wider in width: Minimum 14 gauge (0.067inch -1.7-mm) thick steel sheet.] 6. Frames for Wood Doors: Minimum 16 gauge (0.053-inch-1.3-mm-) thick steel

a. CECO Door Products BQ/BU/DQ/DU/BR/DR Series (Drywall Profile).

4. Frames for openings up to 48 inches in width: Minimum 16 gauge (0.053-

7. Frames for Borrowed Lights: Minimum 16 gauge (0.053-inch-1.3-mm-) thick steel sheet

c. Curries Company C/CM/CG Series (Drywall Profile). d. Curries Company M/G Series (Masonry Profile). D. Fire rated frames: Fabricate frames in accordance with NFPA 80, listed and labeled by a qualified testing agency, for fire-protection ratings indicated.

E. Hardware Reinforcement: Fabricate according to ANSI/SDI A250.6 Table 4 with

formed from A60 metallic coated material, not less than 0.042 inch thick, with

corrugated or perforated straps not less than 2 inches wide by 10 inches long; or wire

reinforcement plates from same material as frames. 2.6 FRAME ANCHORS A. Jamb Anchors: Masonry Type: Adjustable strap-and-stirrup or T-shaped anchors to suit frame size.

b. CECO Door Products SQ/SU/SR Series (Masonry Profile).

1. Stud Wall Type: Designed to engage stud and not less than 0.042 inch thick. 2. Compression Type for Drywall Slip-on (Knock-Down) Frames: Adjustable compression anchors.

3. Windstorm Opening Anchors: Types as tested and required for indicated wall types to meet specified wind load design criteria.

4. FEMA 361 Storm Shelter Anchors: Masonry T-shaped, wire masonry type, or existing opening type anchors.

B. Floor Anchors: Floor anchors to be provided at each jamb, formed from A60 metallic coated material, not less than 0.042 inches thick.

C. Mortar Guards: Formed from same material as frames, not less than 0.016 inches 2.7 HOLLOW METAL PANELS A. Provide hollow metal panels of same materials, construction, and finish as

specified for adjoining hollow metal work. A. Metal Louvers: Door manufacturer's standard metal louvers unless otherwise

indicated. 1. Blade Type: Vision proof inverted V or inverted Y. 2. Metal and Finish: Galvanized steel, 0.040 inch thick, factory primed for paint finish with baked enamel or powder coated finish. Match pre-finished door

paint color where applicable. B. Louvers for Fire Rated Doors: Metal louvers with fusible link and closing device, listed and labeled for use in doors with fire protection rating of 1-1/2 hours and

1. Manufacturers: Subject to compliance with requirements, provide door

manufacturers standard louver to meet rating indicated. 2. Metal and Finish: Galvanized steel, 0.040 inch thick, factory primed for paint finish with baked enamel or powder coated finish. Match pre-finished door

paint color where applicable. 2.9 LIGHT OPENINGS AND GLAZING

A. Stops and Moldings: Provide stops and moldings around glazed lites where indicated. Form corners of stops and moldings with butted or mitered hairline joints at fabricator's shop. Fixed and removable stops to allow multiple glazed lites each to be removed independently. Coordinate frame rabbet widths between fixed and removable stops with the type of glazing and installation indicated. B. Moldings for Glazed Lites in Doors and Loose Stops for Glazed Lites in Frames: Minimum 20 gauge thick, fabricated from same material as door face sheet in which they are installed.

C. Fixed Frame Moldings: Formed integral with hollow metal frames, a minimum of 5/8 inch (16 mm) high unless otherwise indicated. Provide fixed frame moldings and stops on outside of exterior and on secure side of interior doors and frames D. Preformed Metal Frames for Light Openings: Manufacturer's standard frame

coated finish; and approved for use in doors of fire protection rating indicated. Match pre-finished door paint color where applicable. E. Glazing: Comply with requirements in Division 08 Section "Glazing" and with the

formed of 0.048-inch-thick, cold rolled steel sheet; with baked enamel or powder

1. Factory Glazing: Factory install glazing in doors as indicated. Doors with factory installed glass to include all of the required glazing material.

hollow metal door manufacturer's written instructions.

A. Mullions and Transom Bars: Join to adjacent members by welding or rigid mechanical anchors B. Grout Guards: Formed from same material as frames, not less than 0.016 inches

2.11 FABRICATION A. Fabricate hollow metal work to be rigid and free of defects, warp, or buckle. Accurately form metal to required sizes and profiles, with minimum radius for thickness of metal. Where practical, fit and assemble units in manufacturer's plant. When shipping limitations so dictate, frames for large openings are to be

fabricated in sections for splicing or splining in the field by others. B. Tolerances: Fabricate hollow metal work to tolerances indicated in ANSI/SDI A250.8.

Factory install glazing where indicated.

C. Hollow Metal Doors:

1. Exterior Doors: Provide optional weep-hole openings in bottom of exterior doors to permit moisture to escape where specified. 2. Glazed Lites: Factory cut openings in doors with applied trim or kits to fit.

3. Astragals: Provide overlapping astragals as noted in door hardware sets in Division 08 Section "Door Hardware" on one leaf of pairs of doors where required by NFPA 80 for fire-performance rating or where indicated. Extend minimum 3/4 inch beyond edge of door on which astragal is mounted. 4. Continuous Hinge Reinforcement: Provide welded continuous 12 gauge strap

D. Hollow Metal Frames: 1. Shipping Limitations: Where frames are fabricated in sections due to shipping or handling limitations, provide alignment plates or angles at each joint,

for continuous hinges specified in hardware sets in Division 08 Section "Door

fabricated of same thickness metal as frames. 2. Welded Frames: Weld flush face joints continuously; grind, fill, dress, and make smooth, flush, and invisible. a. Welded frames are to be provided with two steel spreaders temporarily attached to the bottom of both jambs to serve as a brace during shipping

and handling. Spreader bars are for bracing only and are not to be used to size the frame opening. 3. Sidelight and Transom Bar Frames: Provide closed tubular members with no

visible face seams or joints, fabricated from same material as door frame.

Fasten members at crossings and to jambs by butt welding. 4. High Frequency Hinge Reinforcement: Provide high frequency hinge reinforcements at door openings 48-inches and wider with mortise butt type hinges at top hinge locations.

5. Continuous Hinge Reinforcement: Provide welded continuous 12 gauge straps for continuous hinges specified in hardware sets in Division 08 Section "Door 6. Provide countersunk, flat- or oval-head exposed screws and bolts for exposed

fasteners unless otherwise indicated for removable stops, provide security screws at exterior locations. 7. Mortar Guards: Provide guard boxes at back of hardware mortises in frames at all hinges and strike preps regardless of grouting requirements.

8. Floor Anchors: Weld anchors to bottom of jambs and mullions with at least four spot welds per anchor. 9. Jamb Anchors: Provide number and spacing of anchors as follows: a. Masonry Type: Locate anchors not more than 18 inches from top and bottom

of frame. Space anchors not more than 32 inches o.c. and as follows: 1. Two anchors per jamb up to 60 inches high. 2. Three anchors per jamb from 60 to 90 inches high. 3. Four anchors per jamb from 90 to 120 inches high.

4. Four anchors per jamb plus 1 additional anchor per jamb for each 24 inches or fraction thereof above 120 inches high. b. Stud Wall Type: Locate anchors not more than 18 inches from top and bottom of frame. Space anchors not more than 32 inches o.c. and as follows:

3. Five anchors per jamb from 90 to 96 inches high. 4. Five anchors per jamb plus 1 additional anchor per jamb for each 24 inches or fraction thereof above 96 inches high. 5. Two anchors per head for frames above 42 inches wide and mounted in

10. Door Silencers: Except on weatherstripped or gasketed doors, drill stops to receive door silencers. Silencers to be supplied by frame manufacturer regardless if specified in Division 08 Section "Door Hardware". E. Hardware Preparation: Factory prepare hollow metal work to receive template mortised hardware; include cutouts, reinforcement, mortising, drilling, and tapping

according to the Door Hardware Schedule and templates furnished as specified in Division 08 Section "Door Hardware." 1. Locate hardware as indicated, or if not indicated, according to

1. Three anchors per jamb up to 60 inches high.

metal stud partitions.

2. Four anchors per jamb from 60 to 90 inches high.

ANSI/SDI A250.8. 2. Reinforce doors and frames to receive non-template, mortised and surface mounted door hardware. 3. Comply with applicable requirements in ANSI/SDI A250.6 and


4. Coordinate locations of conduit and wiring boxes for electrical connections with Division 26 Sections.

ANSI/DHI A115 Series specifications for preparation of hollow metal work for

HARTMANNARCHITECTURESTUDIO.COM 430 S. CARRILLO RD. OJAI, CALIFORNIA 93023 (805) 530-5559

CONSULTANTS:

AGENCY APPROVAL

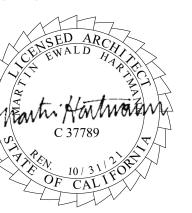

WIDE EXTERIOR PAINTING

OWNER:

OJAI UNIFIED SCHOOL DISTRICT 414 EAST OJAI AVENUE OJAI, CA 93023 (805) 640-4300 **CONTACT: ADAM DUTTER** EMAIL: adutter@ojaiusd.org

703 EL PASEO ROAD OJAI, CA 93023

OJAI USD PROJECT NO.: 2021-1600

ISSUE:		
MARK	DATE	DESCRIPTION
PROJECT INFORMATION:		

THE ORIGINAL SIZE OF THIS SHEET IS 36"x24". IF THE CURRENT SIZE IS OTHER THAN 36"x24". THEN ADJUST THE SCALE OF THE DRAWINGS ACCORDINGLY. SHEET TITLE:

PROJECT NUMBER:

PROJECT PHASE:

DRAWN BY:

REVIEWED BY:

SHEET NUMBER:

MATILIJA MS CAMPUS -

PROJECT ADDRESS: MATILIJA MIDDLE SCHOOL

2021.010 PBS

GENERAL NOTES & SPECIFICATIONS

4. Polyken 610" by Polyken Technologies. A. Prime Finishes: Doors and frames to be cleaned, and chemically treated to insure

maximum finish paint adhesion. Surfaces of the door and frame exposed to view to receive a factory applied coat of rust inhibiting shop primer. 1. Shop Primer: Manufacturer's standard, fast-curing, lead and chromate free primer complying with ANSI/SDI A250.10 acceptance criteria; recommended by primer manufacturer for substrate; and compatible with substrate and field-applied

A. Examine substrates, areas, and conditions, with Installer present, for compliance with requirements for installation tolerances and other conditions affecting performance of

B. General Contractor to verify the accuracy of dimensions given to the steel door and frame manufacturer for existing openings or existing frames (strike height, hinge

A. Remove welded in shipping spreaders installed at factory. Restore exposed finish by

grinding, filling, and dressing, as required to make repaired area smooth, flush, and B. Prior to installation, adjust and securely brace welded hollow metal frames for

squareness, alignment, twist, and plumbness.

C. Tolerances shall comply with SDI-117 "Manufacturing Tolerances Standard Steel Doors

D. Drill and tap doors and frames to receive non-template, mortised, and surface-mounted 3.3 INSTALLATION

A. General: Install hollow metal work plumb, rigid, properly aligned, and securely fastened in place; comply with Drawings and manufacturer's written instructions.

B. Hollow Metal Frames: Install hollow metal frames of size and profile indicated. Comply with ANSI/SDI A250.11 and NFPA 80 at fire rated openings. 1. Set frames accurately in position, plumbed, aligned, and braced securely until permanent anchors are set. After wall construction is complete and frames properly

undamaged. Shim as necessary to comply with installation tolerances. 2. Floor Anchors: Provide floor anchors for each jamb and mullion that extends to floor, and secure with post-installed expansion anchors.

3. Masonry Walls: Coordinate installation of frames to allow for solidly filling space between frames and masonry with mortar. 4. Grout Requirements: Do not grout head of frames unless reinforcing has been

set and secured, remove temporary braces, leaving surfaces smooth and

installed in head of frame. Do not grout vertical or horizontal closed mullion C. Hollow Metal Doors: Fit hollow metal doors accurately in frames, within clearances

specified below. Shim as necessary. 1. Non-Fire-Rated Standard Steel Doors:

a. Jambs and Head: 1/8 inch plus or minus 1/16 inch.

b. Between Edges of Pairs of Doors: 1/8 inch plus or minus 1/16 inch. c. Between Bottom of Door and Top of Threshold: Maximum 3/8 inch.

d. Between Bottom of Door and Top of Finish Floor (No Threshold): Maximum 3/4 2. Fire-Rated Doors: Install doors with clearances according to NFPA 80.

D. Field Glazing: Comply with installation requirements in Division 08 Section "Glazing" and with hollow metal manufacturer's written instructions.

A. Final Adjustments: Check and readjust operating hardware items immediately before

final inspection. Leave work in complete and proper operating condition. Remove and replace defective work, including hollow metal work that is warped, bowed, or otherwise unacceptable. B. Remove grout and other bonding material from hollow metal work immediately after

C. Prime-Coat and Painted Finish Touchup: Immediately after erection, sand smooth rusted or damaged areas of prime coat, or painted finishes, and apply touchup of

compatible air drying, rust-inhibitive primer, zinc rich primer (exterior and galvanized openings) or finish paint.

END OF SECTION 08 11 13

SECTION 06 16 43 - GYPSUM SHEATHING PART 1 - GENERAL

A. Gypsum sheathing board on exterior face of exterior stud

1.02 RELATED SECTIONS A. See Division 01

B. See section 01 81 22 Acoustical Performance Requirements

C. See section 09 21 16 Gypsum Board Assemblies 1.03 ADMINISTRATIVE REQUIREMENTS

A. Schedule installation to keep gypsum sheathing exposure to ultraviolet (UV) rays within manufacturer's recommended limits.

B. Preinstallation Meeting: Conduct a preinstallation meeting one week prior to the start of the work of this section; require attendance by all affected installers.

1.04 SUBMITTALS A. Product Data: Provide Manufacturer product data for sheathing and fasteners.

1. Submit a list of proposed products and accessories to be used on this project. B B. Test Reports: For all stud framing products that do not comply with ASTM C645 or C 754, provide independent laboratory reports showing maximum stud heights at required spacings and deflections.

C. Warranty: Submit manufacturer warranty and ensure that forms have been completed in College District's name and registered with manufacturer.

D. Sustainable Design Submittals: Provide the following information;

 Low Emitting Materials 2. Local/Regional Materials

3. Recycled Materials 1.05 QUALITY ASSURANCE

A. Manufacturer Qualifications: Company specializing in manufacturing products

specified in this section, with not less than three years of documented experience. B. Installer Qualifications: Company specializing in performing the work of this section with minimum 5 years of experience.

1.06 DELIVERY, STORAGE, AND HANDLING A. Delivery: Comply with Gypsum Association (GA) publication GA-801 "Handling Gypsum Board" and applicable requirements of ASTM C 1264 for sampling, inspection, rejection,

certification, packaging, marking, shipping, handling, and storage of gypsum panel products. 1.07 WARRANTY

2.02 MATERIALS

A. Manufacturer's Warranty: Provide specific protection against problems resulting from defective materials for 5 years after Substantial completion.

PART 2 - PRODUCTS 2.01 MANUFACTURERS

A. Basis of Design: G-P Gypsum Products Dens-Glass Gold (Type X) sheathing board complying with ASTM C 1177, www.gpgypsum.com.

B. National Gypsum Goldbond E2 XP, www.nationalgypsum.com C. USG Securock Glass-Mat Sheathing, www.usg.com

D. Temple Inland GreenGlass, www.templeinland.com. E. CertainTeed GlasRoc Sheathing, www.certainteed.com. F. Substitutions: See Section 01 60 00 - Product Requirements.

A. Gypsum sheathing: One of the following 1/2-inch thick, or equal complying with ASTM C

1. Dens-Glass Gold (Standard and Type X) sheathing board by G-P Gypsum Products complying with ASTM C 1177 (basis of design).

2. National Gypsum "Goldbond E2 XP."

3. USG "Securock Glass-Mat Sheathing." 4. Temple Inland "GreenGlass."

B. Screws: Steel drill screws with organic-polymer or other corrosion-protective coating having a salt-spray resistance of more than 800 hours according to ASTM B 117. 1. For steel framing less than 0.0329-inch thick, attach sheathing in compliance with

2. For steel framing from 0.033 to 0.112-inch thick, attach sheathing in compliance with ASTM C 954.

2.03 ACCESSORIES

A. Gypsum sheathing tape: Use only tapes approved by the sheathing manufacturers. 1. 3M" contractor sheathing tape NO.8086-inch by 3M

2. Perm-A-Barrier" wall seam tape by WR Grace &CO. 3. 108JTN" by Royston Laboratories.

5. Substitutions: See Section 01 60 00 - Product Requirements.

B. Joint compound: As recommended by panel manufacturer. C. Nails, wood framing: 11-gauge galvanized roofing nails with 7/16" head, 1-1/2" min. length for 1/2" panel and 1-3/4" length for 5/8" panel.

D. Screws, metal framing per manufacturers recommendations: 1. Bugle or wafer head, self-tapping, rust-resistant, fine thread for heavy-steel

2. Bugle or wafer head, rust-resistant sharp point, fine thread for light-gauge metal framing or furring. E. Screws, wood framing:

1. Rust-resistant, bugle or wafer head, coarse thread, 1-1/4" length sharp point for

2. Attachment to Wood Members: ASTM C 514.

PART 3 - EXECUTION 3.01 EXAMINATION

A. Examine framing to support sheathing board and verify that the surface of any framing or furring member does not vary more than 1/8-inch from the plane of faces of adjacent members.

B. Verify that studs, blocking and supporting materials are in place and ready for sheathing attachment prior to starting work. C. Coordinate the exterior placement of electrical, mechanical and plumbing wall devices, accessories and access panels, wall signage and other type wall construction with other trades before proceeding with work and during

installation. D. Correct detrimental conditions before proceeding with installation. 3.02 INSTALLATION

1. Sheathing must be installed in accordance with the instructions in Gypsum Association document GA-253 and ASTM C1280. Sheathing can be attached

orientation for specific fire assemblies and shear wall applications within this document, other reference documents or as required by designing authority. The framing width shall not be less than 1-1/2" (38 mm) wide for wood framing and 1-1/4" (32 mm) for steel framing. Framing members shall not vary more than 1/8" (3 mm) from the plane of the faces of adjacent framing.

parallel or perpendicular to wood or metal framing. Use appropriate board

2. Fasteners should be driven flush with the panel surface (not countersunk) and into the framing system. Locate fasteners at least 3/8" (9 mm) from the ends and edges of the sheathing. Nails or screws, as listed in the fastener chart, may be used to attach Sheathing to framing. When a pneumatic fastening system into metal is used to attach Sheathing, consult with manufacturer for application specifications and shear resistance data. Sheathing is not to be used as a base for nailing or other fastening.

3. Install Sheathing with joints staggered. Sheathing shall be properly flashed at openings and preferably located so that no joint will align with an edge of the opening. Ends and edges of the sheathing should fit tightly. Sheathing panels shall not be less than 7" (178 mm) from the finish grade in fully weather- and water-protected siding systems, and not less than 12" (305 mm) from the ground for properly drained and ventilated crawl spaces.

4. Provide sheathing board where indicated on drawings. a. Install sheathing board with correct face out.

b. Use maximum lengths possible to minimize number of joints. c. Attach sheathing board to wood and metal framing per manufacturers installation guide.

d. Ceilings and Soffits 1. Soffits must be dried in and protected from the elements during and after installation. Install per manufacturers installation

recommendations. 2. Apply fiberglass mesh joint tape over joints and embed in setting-type joint compound specified.

3. Skim coat surface with setting-type joint compound for smooth 4. Prime and paint with exterior grade, high quality paint.

A. Protect sheathing panels in place during the construction period against exposure UV rays, to weather, and to other sources of moisture in excess of manufacturer's recommended limits by covering exposed sheathing surfaces with products acceptable to manufacturer for accomplishing these goals.

END OF SECTION

SECTION 09 22 00 - PORTLAND CEMENT PLASTER

PART 1 - GENERAL 1.1 RELATED DOCUMENTS

A. Drawings and general provisions of the Contract, including General and Supplementary Conditions and Division 1 Specification Sections, apply to this

1.2 SUMMARY A. This Section includes the following:

1. Plaster work on concrete or masonry. 2. Integral colored finish coat and field painted finish.

B. Related Sections include the following: 1. Division 7 Section "Flexible Sheet Flashing" for flashing windows, door, and

other openings. 2. Division 7 Section "Joint Sealants" for acoustical sealants and sealants

installed with exterior portland cement plaster (stucco). 3. Division 9 Section "Painting" for field painting of plaster.

1.3 SUBMITTALS A. Product Data: For each type of product indicated.

B. Shop Drawings: 1. Showing details of construction for framing, reinforcement, and trims; including locations where each type material, mix, coating thickness, material sizes and thicknesses, and fastenings will be used.

2. Show locations and installation of control and expansion joints including plans, elevations, sections, details of components, and attachments to other work.

3. Include details of penetration and termination, flashing details, joint locations and configurations, fastening and anchorage details including mechanical fasteners, and connections to other work. 4. Show locations and extent of weather-barrier (building paper and flashing

sheet). Include details for substrate joints and cracks, counterflashing strip, penetrations, inside and outside corners, terminations, and tie-ins with

adjoining construction. a. Include details of interfaces with other materials that form part of weather

b. Include details of mockups.

C. Coordination Drawings: 1. Comprehensive, completely integrated set of plans, sections, elevations, and details, drawn to scale, of separate trades work, indicating interface support/connections, and relationships between materials, and products, on which the following items are shown and coordinated with each other, based on input from fabricators and installers of the items involved: a. Framing, including backing, blocking, strapping, and similar accessory/sub-

framing materials. b. Sheathing, including building paper. c. Portland cement plaster, including trim and self-adhering flashing sheet.

d. Other materials and products that occur in, on, adjacent to, or contiguous with above work.

2. At a minimum, indicate the following a. Locations/spacing of plaster trim moldings.

Mechanical Code & California Amendments)

b. Locations/dimensions of self-adhering flashing sheet (underlying trim moldings).

c. Locations/spacings of connections/fastenings of: Plaster trim moldings

d. Sequence of installation of: Plaster trim moldings. D. Samples for Initial Selection: For each type of factory-prepared finish coat

indicated with texture and color. E. Samples for Verification: For each type of factory-prepared finish coat indicated; 12 by 12 inches, and prepared on rigid backing with color selected. 1.4 OUALITY ASSURANCE

A. Reference Standards: 1. 2019 Building Standards Administrative Code, Part 1, CBSC. 2. 2019 California Building Code (CBC), Part 2, CBSC (2015 IBC & California

3. 2019 California Electrical Code (CEC), Part 3, CBSC (2014 National Electrical Code & California Amendments). 4. 2019 California Mechanical Code (CMC), Part 4, CBSC (2015 Uniform

6. 2019 California Plumbing Code (CPC), Part 5, CBSC (2015 Uniform Plumbing

Code & California Amendments).

7. 2019 California Energy Code, Part 6, CBSC.

8. 2019 California Historical Building Code, Part 8, CBSC. 9. 2019 California Fire Code, Part 9, CBSC (2015 International Fire Code &

California Amendments). 10. 2019 California referenced Standards, Part 12 CBSC. 11. Title 8 C.C.R. Chapter 4, Sub-Ch. 6 – Elevator Safety Orders. 12. Title 19 C.C.R., Public Safety, SFM Regulations.

13. Americans with Disabilities Act (ADA), Title II or Title III. B. Comply with requirements of 2019 CBC Chapter 25. C. Fire-Test-Response Characteristics: For portland cement plaster assemblies with fire-resistance ratings, provide materials and construction identical to those tested in assembly indicated according to ASTM E 119 by an independent testing

and inspecting agency acceptable to DSA. D. Mockups: Before plastering, install mockups of at least 100 sq. ft. in surface area to demonstrate aesthetic effects and set quality standards for materials and

execution. 1. Comprehensive, completely integrated mockups of separate trades work, indicating interface connections, transitions, relationships between materials and finishes, and quality of workmanship. Coordinated mockups shall include,

but is not limited to, the following: a. Work of this Section. b. Framing, including backing, blocking, strapping, and similar accessory/subframing materials.

c. Sheathing, including building paper. d. Sealants.

e. Penetrations of portland cement plaster assemblies. f. Other materials and finishes that are within indicated area of coordinated mockups, including barrier/backing/support for above work. 2. Install mockups for each type of finish indicated.

3. Approved mockups may become part of the completed Work if undisturbed at time of Substantial Completion. 4. Use of self-furring lath is subject to satisfactory jobsite demonstration for each project of lath installation, with approval by Inspector of Record.

requirements in Division 1 Section "Project Management and Coordination." 1.5 DELIVERY, STORAGE, AND HANDLING A. Store materials inside under cover and keep them dry and protected against damage from weather, direct sunlight, surface contamination, corrosion, construction traffic, and other causes.

E. Preinstallation Conference: Conduct conference at Project site to comply with

1.6 PROJECT CONDITIONS Comply with ASTM C 926 requirements.

B. Exterior Plasterwork: 1. Apply and cure plaster to prevent plaster drying out during curing period. Use procedures required by climatic conditions, including moist curing, providing coverings, and providing barriers to deflect sunlight and wind. 2. Apply plaster when ambient temperature is greater than 40 deg F.

plaster coat has occurred. C. Factory-Prepared Finishes: Comply with manufacturer's written recommendations for environmental conditions for applying finishes. 1.7 WARRANTY

3. Protect plaster coats from freezing for not less than 48 hours after set of

A. Manufacturer's Warranty: Manufacturer's standard form in which manufacturer agrees to repair or replace components of cement plaster system that fail in materials within specified warranty period. Failure includes, but is not limited to. blistering, peeling, flaking, delaminating, rusting, checking, crazing, fading beyond manufacturer's published limits, or chipping as a result of manufacturing defects.

1. Warranty Period: 3 years. B. Special Waterproof Warranty: Submit cement plaster system manufacturer's warranty certifying that work of this Section has been properly applied in strict accordance with system manufacturer's recommended procedures, instructions, and systems current applicable specifications; has been properly integrated into building construction in accordance with sound design and building construction practices; and will remain resistant to water penetration for specified warranty

1. Warranty Period: 3 years. C. Weather Resistive Barriers: 10 years. D. Installer's Warranty: 2 years.

PART 2 - PRODUCTS

Finish-Coat Plaster: Subject to compliance with requirements, provide products by one of the following manufacturers.

1. ColorTek by Omega. (Basis of Design)

2. LaHabra Stucco. Merlex. 4. Sto.

Or equal. B. Zinc-Coated (Galvanized) Steel Accessories: Subject to compliance with requirements, provide either the named product or an equal product by one of the

other manufacturers specified. 1. Superior Metal Trim. (Basis of Design)

2. Fry Reglet Corp. 3. Alabama Metal Industries Corporation (AMICO).

4. California Expanded Metal Products Company (CEMCO). 5. Dietrich Industries, Inc.

6. Or equal. C. Aluminum Trim and Reveals: Subject to compliance with requirements, provide either the named product or an equal product by one of the other manufacturers

specified. a. Fry Reglet Corp. (Basis of Design) b. Gordon, Inc.

c. Pittcon Industries. d. Or equal. D. Expanded Lath: Nominal 3.4 lb/yd2 weight, galvanized steel complying with ASTM

E. Water Resistive Barrier a. Over Open Framing and non-Wood-based Sheathing: One layer of D kraft building paper complying with UBC Standard 14-1.

b. Over Wood-based Sheathing: Two layers of D kraft building paper complying with UBC Standard 14-1. 2.2 ACCESSORIES

A. General: Comply with ASTM C 1063 and coordinate depth of trim and accessories with thicknesses and number of plaster coats required. B. Zinc-Coated (Galvanized) Steel Accessories: Fabricated from hot-dip galvanized

steel sheet, ASTM A 653 G90 zinc coating. 1. Foundation Weep Screed. 2. Cornerite: Fabricated.

3. External-Corner Reinforcement. 4. Cornerbeads. a. Small nose cornerbead with expanded flanges; use unless otherwise

b. Small nose cornerbead with perforated flanges; use on curved corners. c. Small nose cornerbead with expanded flanges reinforced by perforated stiffening rib; use on columns and for finishing masonry corners.

d. Bull nose cornerbead, radius 3/4 inch minimum, with expanded flanges; use

at exterior columns. 5. Casing Beads: Square-edged style; with expanded flanges. 6. Control Joints: One-piece-type, folded pair of unperforated screeds in Mshaped configuration; with perforated flanges and removable protective tape

on plaster face of control joint. 7. Expansion Joints: Folded pair of unperforated screeds in M-shaped configuration; with expanded flanges. a. Internal Corners: Double-V, narrow reveal type ("No. 30").

8. Two-Piece Expansion Joints: Formed to produce slip-joint and square-edged

reveal that is adjustable from 1/4-to-5/8-inch wide; with perforated flanges. 9. Stucco Reglet: A. Product: "ST" Stucco Reglet by Fry Reglet. B. Thickness: 24 gage.

A. Product: "SM" Surface Mount Reglet by Fry Reglet.

10. Surface Mounted Reglet:

B. Thickness: 24 gage. 11. Flashing System: A. Product: Springlok Flashing System by Fry Reglet. B. Thickness: 24 gage.

12. Continuous Soffit Vents: Perforated screeds, with expanded flanges.

A. Product: Model SRS Superior Reveal Screed by Superior Metal Trim. B. Vent Width: As indicated on Drawings. 13. Termination Screed: J Mold.

a. Product: SJB Superior "J" Bead by Superior Metal Trim.

14. Window /Door Drip: Door Drip Screed. a. Product: SWD Superior Window Drip by Superior Metal Trim. 15. Drip Screed: Stucco Drip Soffit.

a. Product: SSC Superior Soffit Corner by Superior Metal Trim. A. Aluminum Trim and Reveals: 1. Aluminum shall be extruded alloy 6063 T5, with clear anodized finish.

a. Size: As indicated on Drawings. 2.3 MISCELLANEOUS MATERIALS

A. Water for Mixing: Potable and free of substances capable of affecting plaster set or of damaging plaster, lath, or accessories. B. Bonding Compound: ASTM C 932.

C. Fasteners for Attaching Metal Lath to Substrates: Complying with ASTM C 1063 and CBC Section 2507. 1. Nails, screws, and staples as specified in CBC. 2. Per CBC 2510.7.1 - Bonding agents shall conform with the provisions of United

States Government Military Specifications MIL-B-19235. 3. Masonry Applications: Galvanized steel fasteners of furring type and length suitable for at least 1/2 inch penetration of the brick or block substrate. 4. Wood Stud Applications: Galvanized steel furring nails and or screws, of type

and length suitable for at least a 5/8 inch penetration of the wood stud system. D. Sheathing: Comply with requirements of Division 6 Section "Rough Carpentry". E. Isolation Strip at Exterior Walls: Comply with requirements of Division 7 Section "Flexible Sheet Flashing" for flashing windows, door, and other openings.

F. Thermal Insulation: Comply with requirements of Division 7 Section "Building G. Acoustical Sealant for Exposed and Concealed Joints: Comply with requirements of Division 7 Section "Joint Sealants". 2.4 PLASTER MATERIALS

A. Scratch and Brown Coat: 1. Portland Cement: ASTM C 150, Type I or II.

coloring agents, and proprietary ingredients.

harmful effects caused by plastering.

B. Reinforcement for External Corners:

2. Sand Aggregate: ASTM C 897. 3. Lime: ASTM C 206, Type S; or ASTM C 207, Type S. B. Ready-Mixed Finish-Coat Plaster: Mill-mixed portland cement, aggregates,

 Finish Texture: a. Exterior: Sand 30/30 finish 2. Colorant: Match color of field finish coating specified in Division 9 Section

A. General: Comply with ASTM C 926 for applications indicated. B. Factory-Prepared Finish-Coat Mixes: For ready-mixed finish-coat plasters, comply with manufacturer's written instructions.

2.5 PLASTER MIXES

PART 3 - EXECUTION 3.1 EXAMINATION A. Examine areas and substrates, with Installer present, and including welded hollow-metal frames, cast-in anchors, and structural framing, for compliance with requirements and other conditions affecting performance.

1. Proceed with installation only after unsatisfactory conditions have been corrected 3.2 PREPARATION A. Protect adjacent work from soiling, spattering, moisture deterioration, and other

B. Prepare solid-plaster bases that are smooth or that do not have the suction capability required to bond with plaster according to ASTM C 926. A. Fire-Resistance-Rated Assemblies: Install components according to requirements for design designations from listing organization and publication indicated on

B. Thermal Insulation: As specified in Division 7 Section "Building Insulation".

C. Sound Attenuation Blankets: Where required, install blankets before installing lath unless blankets are readily installed after lath has been installed on one side. D. Acoustical Sealant: Where required, seal joints between edges of plasterwork and abutting construction with acoustical sealant.

3.4 INSTALLING METAL LATH AND WEATHER-RESISTANT BARRIER INSTALLATION

A. General: Comply with requirements of Title 24. 1. Use of self-furring lath is subject to satisfactory jobsite demonstration for each project of lath installation, with approval by Inspector of Record. B. Expanded-Metal Lath: Install according to ASTM C 1063. 1. Lath shall be attached to framing members at spacing of not more than 6

inches o.c., 2 inches maximum from longitudinal edges, in accordance with C. Weather-Resistant Barrier: Install 2 layers over sheathing. 3.5 INSTALLING ACCESSORIES A. Install according to ASTM C 1063 and at locations indicated on Drawings.

1. Install lath-type external-corner reinforcement at exterior locations. C. Weep screed: Install at foundation plate line on all exterior stud walls per CBC. 1. Minimum 4 inches above earth. 2. Minimum 2 inches above paved areas.

visual effect as follows. E. As required to delineate plasterwork into areas (panels) of the following maximum

D. Control Joints: Install control joints in specific locations approved by Architect for

a. Vertical Surfaces: 144 sq. ft. b. Horizontal and other Nonvertical Surfaces: 100 sq. ft. F. At distances between control joints of not greater than 18 feet o.c. G. As required to delineate plasterwork into areas (panels) with length-to-width

ratios of not greater than 2-1/2:1. H. Where control joints occur in surface of construction directly behind plaster. I. Where plasterwork areas change dimensions, to delineate rectangular-shaped areas (panels) and to relieve the stress that occurs at the corner formed by the

dimension change. 3.6 PLASTER APPLICATION A. General: Comply with ASTM C 926. 1. Do not deviate more than plus or minus 1/4 inch in 10 feet from a true plane in finished plaster surfaces, as measured by a 10-foot straightedge placed on

2. Grout hollow-metal frames, bases, and similar work occurring in plastered areas, with base-coat plaster material, before lathing where necessary. Except where full grouting is indicated or required for fire-resistance rating, grout at least 6 inches at each jamb anchor.

accessories that act as a plaster ground, unless otherwise indicated. Where casing bead does not terminate plaster at metal frame, cut base coat free from metal frame before plaster sets and groove finish coat at junctures with metal. 4. Provide plaster surfaces that are ready to receive field-applied finishes

indicated. B. Three-Coat System: Total minimum thickness of 7/8 inch for lathing base. C. Curing Time: Comply with CBC, or longer as needed to insure compliance with manufacturer's recommendations for quality stucco installation.

3. Finish plaster flush with metal frames and other built-in metal items or

2. Minimum period moist curing: a. First Coat: 48 hours. b. Second Coat: 48 hours 3. Minimum interval between coats:

Portland cement plaster:

a. First Coat: 48 hours.

b. Second Coat: 7 days. D. Bonding Compound: Apply on concrete plaster bases. E. Plaster Finish Coats: Apply to provide finish to match texture, finish, and color of Architect approved sample.

3.7 ASSEMBLY A. Exterior Side from framing out: Sheathing. 2. Weather-Resistive Barrier.

4. 3-coat portland cement plaster.

B. Exterior Side from Masonry/Concrete:

3. Metal Lath.

END OF SECTION 09 22 00

1. 2-coat portland cement plaster. 3.8 CUTTING AND PATCHING A. Cut, patch, replace, and repair plaster as necessary to accommodate other work and to restore cracks, dents, and imperfections. Repair or replace work to eliminate blisters, buckles, crazing and check cracking, dry outs, efflorescence, sweat outs, and similar defects and where bond to substrate has failed.

3.9 CLEANING AND PROTECTION A. Remove temporary protection and enclosure of other work. Promptly remove plaster from doorframes, windows, and other surfaces not indicated to be plastered. Repair floors, walls, and other surfaces stained, marred, or otherwise damaged during plastering.

SECTION 06 10 00 - ROUGH CARPENTRY

PART 1 – GENERAL 1.1 RELATED DOCUMENTS

1.4 REFERENCES

A. Drawings and general provisions of the Contract, including General and Supplementary Conditions and Division 1 Specification Sections, apply to this 1.2 SECTION INCLUDES

A. Provide all labor, material, equipment and installation to complete framing and sheathing of interior walls and partitions as shown and specified. 1.3 RELATED SECTIONS 06 16 00 – Sheathing

A. The latest editions of specifications and standards referenced herein and published by the following organizations apply to the Work of this Section only to the extent specified by the reference. American Plywood Association - Visual Inspection ASTM American Society for Testing and Materials.

> American Wood Preservers Association DFPA Douglas Plywood Association ICC International Code Council PS Public Standards of the U.S. Department of Commerce, Bureau of Standards

CBC STDS 2019 California Building Code Standards WCLIB West Coast Lumber Inspection Bureau WWPA Western Wood Products Association

A. General: Submit the following according to Conditions of Contract and Division 1 Specifications Sections. 1. Product data and current ICC Evaluation Service Reports for attachment

accessories. a. Framing Devices and framing connectors b. Gun nails .6 QUALITY ASSURANCE

of governing authorities having jurisdiction. 1. Chapter 23A of the 2019 California Building Code (CBC). 2. ANSI/AF&PA NDS-2012 National Design Specification for Wood Construction. 3. Standard Grading Rules No. 17 of the WCLIB or the Standard Grading Rules of the WWPA. Lumber to have visible grade stamp of an agency certified by the

A. Codes and Standards: Perform Work in compliance with applicable requirements

1.7 COORDINATION A. Coordinate Work of this Section with Work of other Sections to be attached to, or built into, wood framing.

PART 2 - PRODUCTS

2.11 UMBFR A. Moisture content: The maximum moisture content of framing lumber shall not exceed 19% just prior to enclosing or covering framing with plywood, gypsum wallboard and/or plaster. To ensure compliance, lumber up to 2 inch thick should be seasoned to a moisture content of 19% or less and be stamped "S-Dry". Lumber

over 2 inch thick may be shipped unseasoned and stamped "S-Green". B. Structural lumber shall be S4S stress-marked Douglas Fir-Larch, manufactured and graded in accordance with WCLIB or WWPA, with minimum grades as follows unless noted otherwise: Joists & Rafters

3. Wall Studs 4. Blocking, stripping & misc. No. 2 C. Grade stamp: Provide lumber with each piece factory-marked with grade stamp of

PART 3 – EXECUTION

(nominal) thickness.

2. 4x & 6x Beams/Headers No. 1 or better

and mill. 2.2ACCESSORY MATERIALS A. All Nails shall be common wire nails with dimensions complying with CBC Table 2304.9.1, manufacture shall conform to Fed. Spec, FF-N-1-1 and shall be hotdipped galvanized for exterior locations, high humidity locations and for treated wood; plain finish for other interior locations; size and type to suit application. 1. Box nails and/or "Sinker" nails are not acceptable for Work shown and/or

inspection agency evidencing compliance with grading rule requirements and

identifying grading agency, grade species, moisture content at time of surfacing,

detailed on the Structural Drawings. B. Bolts, Nuts and Washers conforming to ASTM A-307 shall be hot-dipped galvanized for exterior locations, high humidity locations and treated wood; plain finish for other interior locations. C. Anchor Bolts: ASTM A 307, non-headed type.

D. Lag Screws, Lag Bolts, Pins and Wood Screws; Sized to suit application; hot-

dipped galvanized for exterior locations, high humidity locations and treated

wood; plain finish for other interior locations. Comply with NDS Section 11.1.3. E. Framing connectors: current ICC Evaluation Services Report, sized and profiled to suit application; hot-dipped galvanized finish, manufactured by Simpson Strong-Tie Company, KC Metals, or approved equal. F. Gun Nails: Use Common Nails or current ICC Evaluation Services Report special

gun nails of the same wire diameter and length as common nails specified on the Drawings. Box nails and/or "Sinker" nails are not acceptable for Work shown on the Structural Drawings. G. Drypack: Cement/sand drypack composed of one part cement to 3 parts sand. Dry mix first then add with only enough water to hold the mix together. Drypack

required under sills as noted on the Drawings. 2.3 WOOD TREATMENT A. Wood Preservative (Pressure Treatment): Chromated zinc chloride or Wolman salts

for pressure treated members. B. Pressure treatment of Douglas Fir-Larch plates, nailers, ledgers and other exposed wood structures, shall be in accordance with the AWPA's standards for the purchase and preservation of treated timber, with a retention of a least 0.35 lb. Wolman salts, 0.75 lb chromated zinc chloride per cubic feet of lumber, or 0.30 lb. per cubic foot of Pentachlorophenol type "C" light solvent. In exposed

conditions, the incising of the lumber shall be waived. 1. See Architectural Drawings for treatment of trellis members. C. Wood Preservative (Surface Application): Clear, manufactured by Woodlife, "Res"

3.1 WOOD TREATMENT A. Shop pressure treat and deliver to the site ready for installation all wood materials requiring pressure impregnated preservatives. B. Treat site-sawn ends and holes in pressure treated lumber.

1. Apply preservative treatment in accordance with manufacturer's instruction. 2. Allow site applied preservative to cure prior to erecting members. 3.2 FRAMING A. Layout, cutting and installation of framing shall be under the continuous supervision of a full-time carpenter foreman experienced in all phases of framing

construction and exposed architectural framing required for the Work of this Section and on the Contract Drawings. B. Structural members shall not be cut for pipes, conduits, ducts, etc., unless specifically noted or detailed on the Structural Drawings. C. Erect wood framing members true to lines and levels. Do not deviate from true

alignment more than 1/4 inch. Install simple span members with crown up.

D. Space framing members at 16 inches on center unless otherwise noted on the

E. Construct members of continuous pieces of longest possible lengths except as noted on the Drawings. F. Holes in wood for bolts shall be drilled 1/32" to 1/16" larger than the diameter of

G. Number of fasteners shall be as indicated on the Drawings or as noted in the ICC Evaluation Report where number of fasteners are not shown on the Drawings. H. Sheet metal framing connectors shown on the Drawings shall be Simpson connectors as manufactured by the Simpson Strong-Tie Company, Inc.,

Superspeed Connectors as manufactured by the KC Metals company or equal.

I. Bolts shall have standard cut washers under heads and/or nuts where in contact with wood. Bolt threads shall not bear on wood. J. Lag bolts, lag screws and wood screws shall be screwed (not driven) into wood members. In placing lag screws or wood screws in wood, a hole of the same diameter and depth of "the solid shank" shall be bored after which the hole with a diameter equal to the diameter of the screw at the root of the thread shall be continued to a depth equal to the threaded screw length portion. Provide cut

washers under the heads of lag bolts/lag screws where in contact with wood. K. Bolts, lag screws and wood screws shall be re-tightened prior to the application of drywall, plywood, plaster, etc. L. Drive nails perpendicular to grain of wood in lieu of toenailing, where feasible. M. For conditions not covered on the Drawings, provide penetration into the piece

receiving the point of not less than 1/2 the length of the common nail or spike,

provided, however, that 16d nails may be used to connect two pieces of two inch

430 S. CARRILLO RD. OJAI, CALIFORNIA 93023

CONSULTANTS:

AGENCY APPROVAL

SEALS:



OWNER: OJAI UNIFIED SCHOOL DISTRICT 414 EAST OJAI AVENUE OJAI, CA 93023 (805) 640-4300

EMAIL: adutter@ojaiusd.org PROJECT ADDRESS: MATILIJA MIDDLE SCHOOL

OJAI, CA 93023

OJAI USD PROJECT NO.: 2021-1600

MARK	DATE	DESCRIPTION
PROJECT PROJECT PROJECT		N: 2021.01 Ci
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GENERAL NOTES & SPECIFICATIONS

SHEET NUMBER:

HARTMANNARCHITECTURESTUDIO.COM

(805) 530-5559



MATILIJA MS CAMPUS -WIDE EXTERIOR PAINTING

CONTACT: ADAM DUTTER

703 EL PASEO ROAD

ISSUE:

DRAWN BY: REVIEWED BY: THE ORIGINAL SIZE OF THIS SHEET IS 36"x24". IF THE CURRENT SIZE IS OTHER THAN 36"x24". THEN ADJUST THE SCALE OF THE DRAWINGS ACCORDINGLY

SHEET TITLE:

PBS

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N. Provide fire blocking in furred spaces, stud spaces and other concealed cavities as
                                                                                             C. Control Expansion, and Soft Joints in Masonry, and Between Masonry and
   indicated and as follows:
                                                                                             D. Lap Joints in Exterior Sheet Metal Work: Type SJ-4.
   1. Fire block furred spaces of walls at each floor level, at ceiling, and at not more than
      96 inches o.c. with 2-inch nominal thickness solid wood blocking or noncombustible
                                                                                            E. Joints Between Exterior Metal Frames and Adjacent Work (except masonry): Type
      materials accurately fitted to close furred spaces.
 3.4 CLEAN-UP
 A. Clean up leftover materials of this Section and legally dispose off site. Dispose of
   pressure- treated wood in an authorized disposal area. Burning of materials on the Site
   is prohibited. Do not bury material and/or wood of any type on the job site.
 END OF SECTION 06 10 00
 SECTION 07 92 00 JOINT SEALANTS
 PART 1 - GENERAL
  1.1 SECTION INCLUDES
A. Sealants and joint backing.
 1.2 RELATED SECTIONS
 1.3 DEFINITIONS
 A. Based on ASTM C 920 Substrates:
  1. M type substrates: Concrete, concrete masonry units, brick, mortar, natural stone.
      The term "masonry" means brick, stone, and concrete masonry work.
   2. G type substrates: Glass and transparent plastic glazing sheets.
   3. A type substrates: Metals, porcelain, glazed tile, and smooth plastics.
   4. 0 type substrates: Wood, unglazed tile; substrates not included under other
      categories
 1.4 SUBMITTALS
 A. See Section 01 33 00 - Submittal Procedures.
 B. Product Data: Provide data indicating sealant chemical characteristics, performance
   criteria, substrate preparation, limitations, and color availability.
 C. Samples: Submit two samples, 6 inch long illustrating sealant colors for selection.
 D. Color selection: Color selection shall be made from manufacturers standard color
   selection. Selection shall be made by Architect.
 E. Manufacturer's Installation Instructions: Indicate special procedures.
 F. Sustainable Design Submittals: Provide the following information

    Low Emitting Materials

 1.5 QUALITY ASSURANCE
 A. Maintain one copy of each referenced document covering installation requirements on
 B. Manufacturer Qualifications: Company specializing in manufacturing the Products
   specified in this section with minimum three years documented experience.
 C. Applicator Qualifications: Company specializing in performing the work of this section
    with minimum three years of experience.
 1.6 FIELD CONDITIONS
 A. Maintain temperature and humidity recommended by the sealant manufacturer during
   and after installation.
 A. See Section 01 77 00 - Closeout Procedures, for additional warranty requirements.
 B. Correct defective work within a five year period after Date of Substantial Completion.
 C. Warranty: Include coverage for installed sealants and accessories which fail to achieve
   airtight seal, exhibit loss of adhesion or cohesion, or do not cure.
PART 2 - PRODUCTS
  2.1 SEALANTS
 A. Sealants and Primers - General: Provide only products having lower volatile organic
   compound (VOC) content than required by South Coast Air Quality Management District
 B. Type SJ-1 - General Purpose Exterior Sealant: Silicone, nonstaining, S, NS, 50, NT.
   1. Applications: Use for:
      a. Control, expansion, and soft joints in masonry.
      b. Joints between concrete and other materials.
      c. Joints between metal frames and other materials.
      d. Other exterior joints for which no other sealant is indicated.
 C. Type SJ-2 - Exterior Expansion Joint Sealer: Multi-component self-leveling
    polyurethane sealant, ASTM C 920, Type M, Grade P, Class 25, Use T.
    1. Size as indicated on drawings, if not detailed, then per manufacturer's
      recommendation to provide weathertight seal when installed.
   2. Provide product recommended by manufacturer for traffic-bearing use.
   3. Applications: Use for:
      a. Exterior horizontal joints in concrete flatwork and extruded curbs.
 D. Type SJ-3 - Silicone Sealant: ASTM C 920, Type S, Grade NS, Class 100/50, Uses NT, A,
   G; single component, solvent curing, non-sagging, non-staining, non-bleeding.
   1. Color: Match adjacent finished surfaces.
    2. Movement Capability: Plus 100 percent, minus 50 percent.
   3. Service Temperature Range: -65 to 180 degrees F.
   4. Shore A Hardness Range: 15 to 35
   5. Applications: Use for:
      a. Glazing at aluminum frames.
 E. Type SJ-4 - Exterior Metal Lap Joint Sealant: One-part non-sag silyl terminated
   polyether sealant: ASTM C-920, Type S. Grade NS, Class 25, Use NT, T, M, G, A, O.
    1. Applications: Use for:
      a. Concealed sealant bead in sheet metal work.
 F. Type SJ-5 - General Purpose Interior Sealant: Acrylic emulsion latex; ASTM C834, Type
   OP, Grade NF single component, paintable.
    1. Color: To be selected by Architect from manufacturer's standard range.
   2. Applications: Use for:
      A. Interior wall and ceiling control joints.
      B. Joints between door and window frames and wall surfaces.
     C. Interior joint sealant between window frames and wall or curb below
      D. Other interior joints for which no other type of sealant is indicated.
 G. Type SJ-6 - BathtublTile Sealant: White silicone; ASTM C920, Uses I, M and A; single
   component, mildew resistant.
   1. Applications: Use for:
      A. Joints between plumbing fixtures and floor and wall surfaces.
      B. Joints between countertops with faucets and wall surfaces and backsplash.
 H. Type SJ-7 - Acoustical Sealant: Non-skinning, sound dampering; single component,
   solvent release curing, non-skinning.
     A. Applications: Use for concealed locations only:
        a. Sealant bead between top stud runner and structure and between bottom
            stud track and floor.
 A. Primer: Non-staining type, recommended by sealant manufacturer to suit application.
 B. Joint Cleaner: Non-corrosive and non-staining type, recommended by sealant
   manufacturer; compatible with joint forming materials.
 C. Joint Backing: Round foam rod compatible with sealant; ASTM 01667, closed cell PVC;
   oversized 30 to 50 percent larger than joint width; Backer Rod manufactured by Backer
   Rod Manufacturing, Inc., Denver, CO.
 D. Bond Breaker: Pressure sensitive tape recommended by sealant manufacturer to suit
   application.
 PART 3 - EXECUTION
 3.1 EXAMINATION
 A. Verify that substrate surfaces are ready to receive work.
 B. Verify that joint backing and release tapes are compatible with sealant.
 3.2 PREPARATION
 A. Remove loose materials and foreign matter that could impair adhesion of sealant.
 B. Clean and prime joints in accordance with manufacturer's instructions.
 C. Perform preparation in accordance with manufacturer's instructions and ASTM C1193.
 D. Protect elements surrounding the work of this section from damage or disfigurement.
 3.3INSTALLATION
 A. Perform work in accordance with sealant manufacturer's requirements for preparation
   of surfaces and material installation instructions.
 B. Perform installation in accordance with ASTM C1193.
C. Perform acoustical sealant application work in accordance with ASTM C919.
D. Install bond breaker where joint backing is not used.
 E. Install sealant free of air pockets, foreign embedded matter, ridges, and sags.
F. Apply sealant within recommended application temperature ranges. Consult
   manufacturer when sealant cannot be applied within these temperature ranges.
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G. Tool joints concave.

A. Clean adjacent soiled surfaces.

A. Control and Expansion Joints in Paving: Type SJ-2.

A. Protect sealants until cured.

3.4 CLEANING

3.5 PROTECTION

3.6 SCHEDULE

H. Precompressed Foam Sealant: Do not stretch; avoid joints except at corners, ends, and

I. Compression Gaskets: Avoid joints except at ends, corners, and intersections; seal all joints with adhesive; install with face 1/8 to 1/4 inch below adjoining surface.

B. Joints Between Concrete Panels and Between Panels and Adjacent Work: Type SJ-1.

intersections; install with face 1/8 to 1/4 inch below adjoining surface.

Adjacent Work: Type SJ-1.

and Walls: Type SJ-6.

END OF SECTION

Construction: Type SJ- 7.

F. Joints Between Interior Metal Frames and Adjacent Work (except masonry): Type G. Under Exterior Door Thresholds: Type SJ-4. H. Interior Joints for Which No Other Sealant is Indicated: Type SJ-5; None; N/A. I. Control and Expansion Joints in Interior Concrete Slabs and Floors: Type SJ-2. J. Joints Between Plumbing Fixtures and Walls and Floors, and Between Countertops K. In Sound Rated Walls, Between Metal Stud Track/Runner and Adjacent

AGENCY APPROVAL: HARTMANNARCHITECTURESTUDIO.COM (805) 530-5559 CONSULTANTS: OWNER: OJAI UNIFIED SCHOOL DISTRICT 414 EAST OJAI AVENUE OJAI. CA 93023 (805) 640-4300 CONTACT: ADAM DUTTER EMAIL: adutter@ojaiusd.org PROJECT ADDRESS: MATILIJA MIDDLE SCHOOL 703 EL PASEO ROAD OJAI, CA 93023 OJAI USD PROJECT NO.: 2021-1600 ISSUE: MARK PROJECT INFORMATION: PROJECT NUMBER: PROJECT PHASE: DRAWN BY: REVIEWED BY: THE ORIGINAL SIZE OF THIS SHEET IS 36"x24". IF THE CURRENT SIZE IS OTHER THAN 36"x24", THEN ADJUST THE SCALE OF THE DRAWINGS ACCORDING! Y. SHEET TITLE: **GENERAL NOTES & SPECIFICATIONS** SHEET NUMBER:



430 S. CARRILLO RD. OJAI, CALIFORNIA 93023

MATILIJA MS CAMPUS -WIDE EXTERIOR PAINTING

DESCRIPTION

2021.010

PBS

CAMPUS BUILDING INFO						
BUILDING NAME	DSA APP. NOS. / A#'s	USE	OCCUPANCY	CONSTRUCTON TYPE	BUILDING AREA	FIRE SPRINKLERS
BUILDING A	9320 / 5155 / 03-107896	CLASSROOMS	E	III-B	4880 +/-	NO
BUILDING B	03-119638	DINING HALL / KITCHEN	А	V-B	2270 +/-	YES
BUILDING C	1926 / 9388 / 51555 / 03-107301	CLASSROOMS / ADMINISTRATION	E	III-B	8610 +/-	NO
BUILDING D	9230 / 51555	CLASSROOM	E	V-B	1110 +/-	NO
BUILDING E	9231 / 03-118467	LOCKER ROOM	Е	V-B	3790 +/-	NO
BUILDING F	1926 / 51555 / 104381 / 03-107301	AUDITORIUM / CLASSROOMS	E	III-B	6230 +/-	PARTIALLY
BUILDING G	37821 / 03-107896	CLASSROOMS	E	V-B	2602 +/-	NO
BUILDING H	26247	CLASSROOMS	Е	V-B	5280 +/-	NO
BUILDING I	28247	CLASSROOMS	Е	V-B	5280 +/-	NO
BUILDING J	28346	CLASSROOMS	Е	V-B	4200 +/-	NO
BUILDING K	3294 / 5346 / 51555 / 12116 / 03-118467	GYMNASIUM	E	V-B	7030 +/-	NO
PAVILION	03-118002	ASSEMBLY	Е	V-B	690 +/-	YES


1. SITE PLAN IS SCHEMATIC TO ONLY SHOW APPROXIMATE BUILDING LOCATIONS. FOR DETAILS OF SITE PAINTING SCOPE, SEE REFERENCED PHOTOS AND KEYNOTES ON

AGENCY APPROVAL:



HARTMANNARCHITECTURESTUDIO.COM 430 S. CARRILLO RD. OJAI, CALIFORNIA 93023 (805) 530-5559

CONSULTANTS:

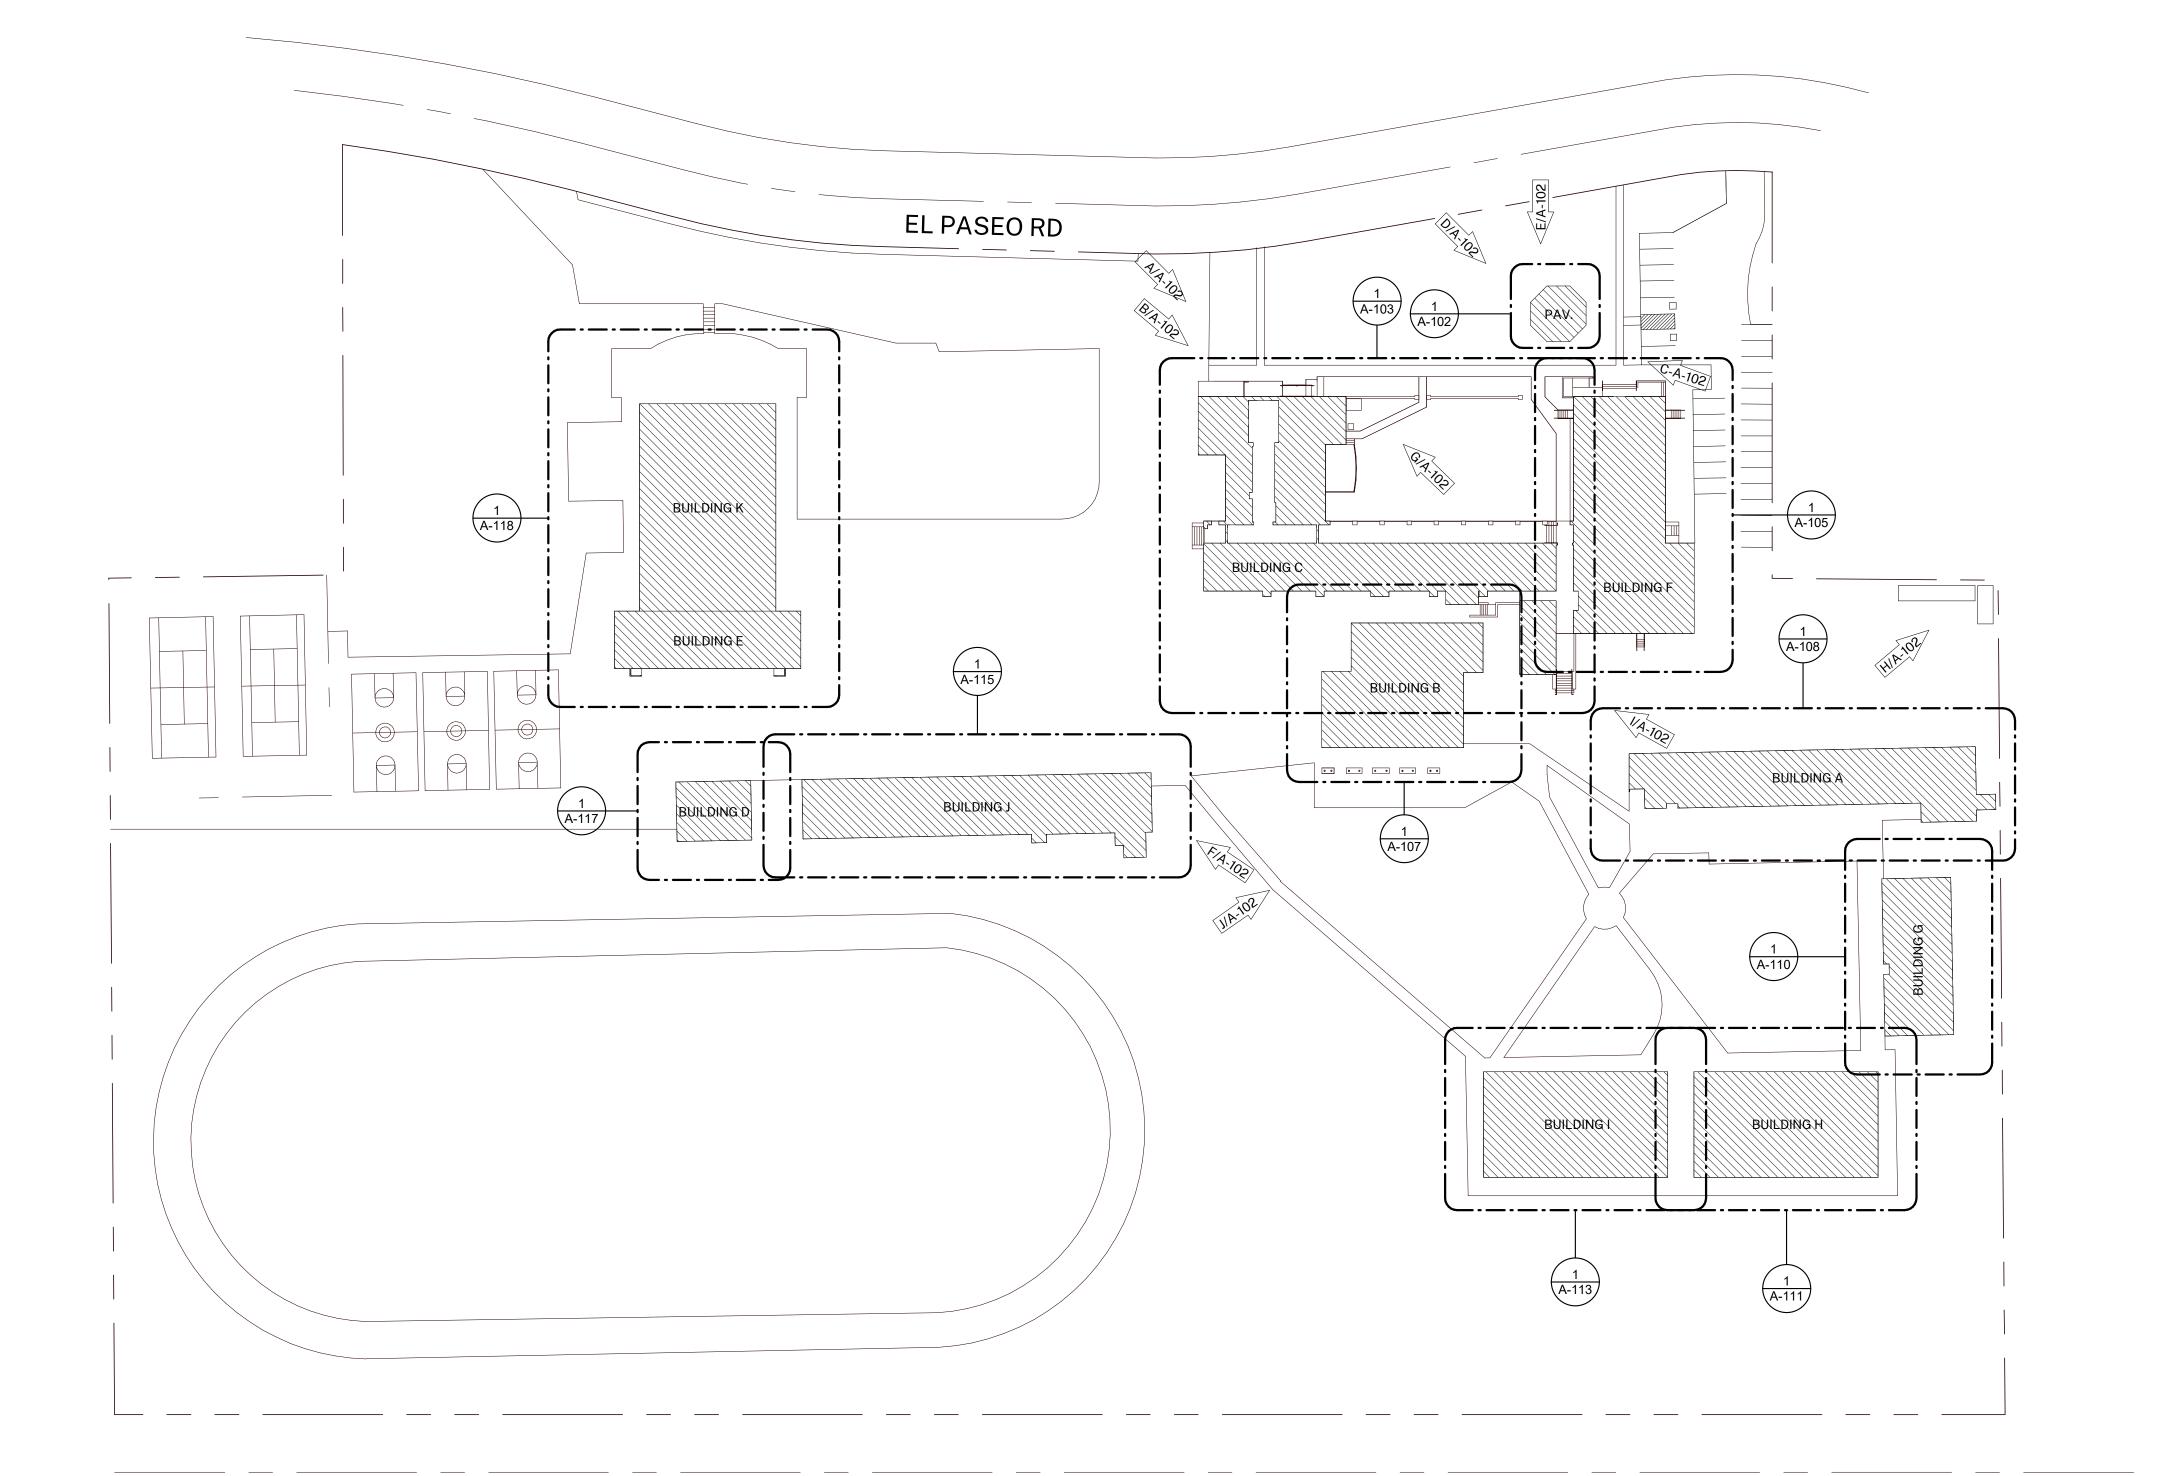

MATILIJA MS CAMPUS -WIDE EXTERIOR PAINTING

OWNER:

PROJECT:

SEALS:

OJAI UNIFIED SCHOOL DISTRICT
414 EAST OJAI AVENUE
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CONTACT: ADAM DUTTER EMAIL: adutter@ojaiusd.org

PROJECT ADDRESS: MATILIJA MIDDLE SCHOOL 703 EL PASEO ROAD OJAI, CA 93023

OJAI USD PROJECT NO.: 2021-1600

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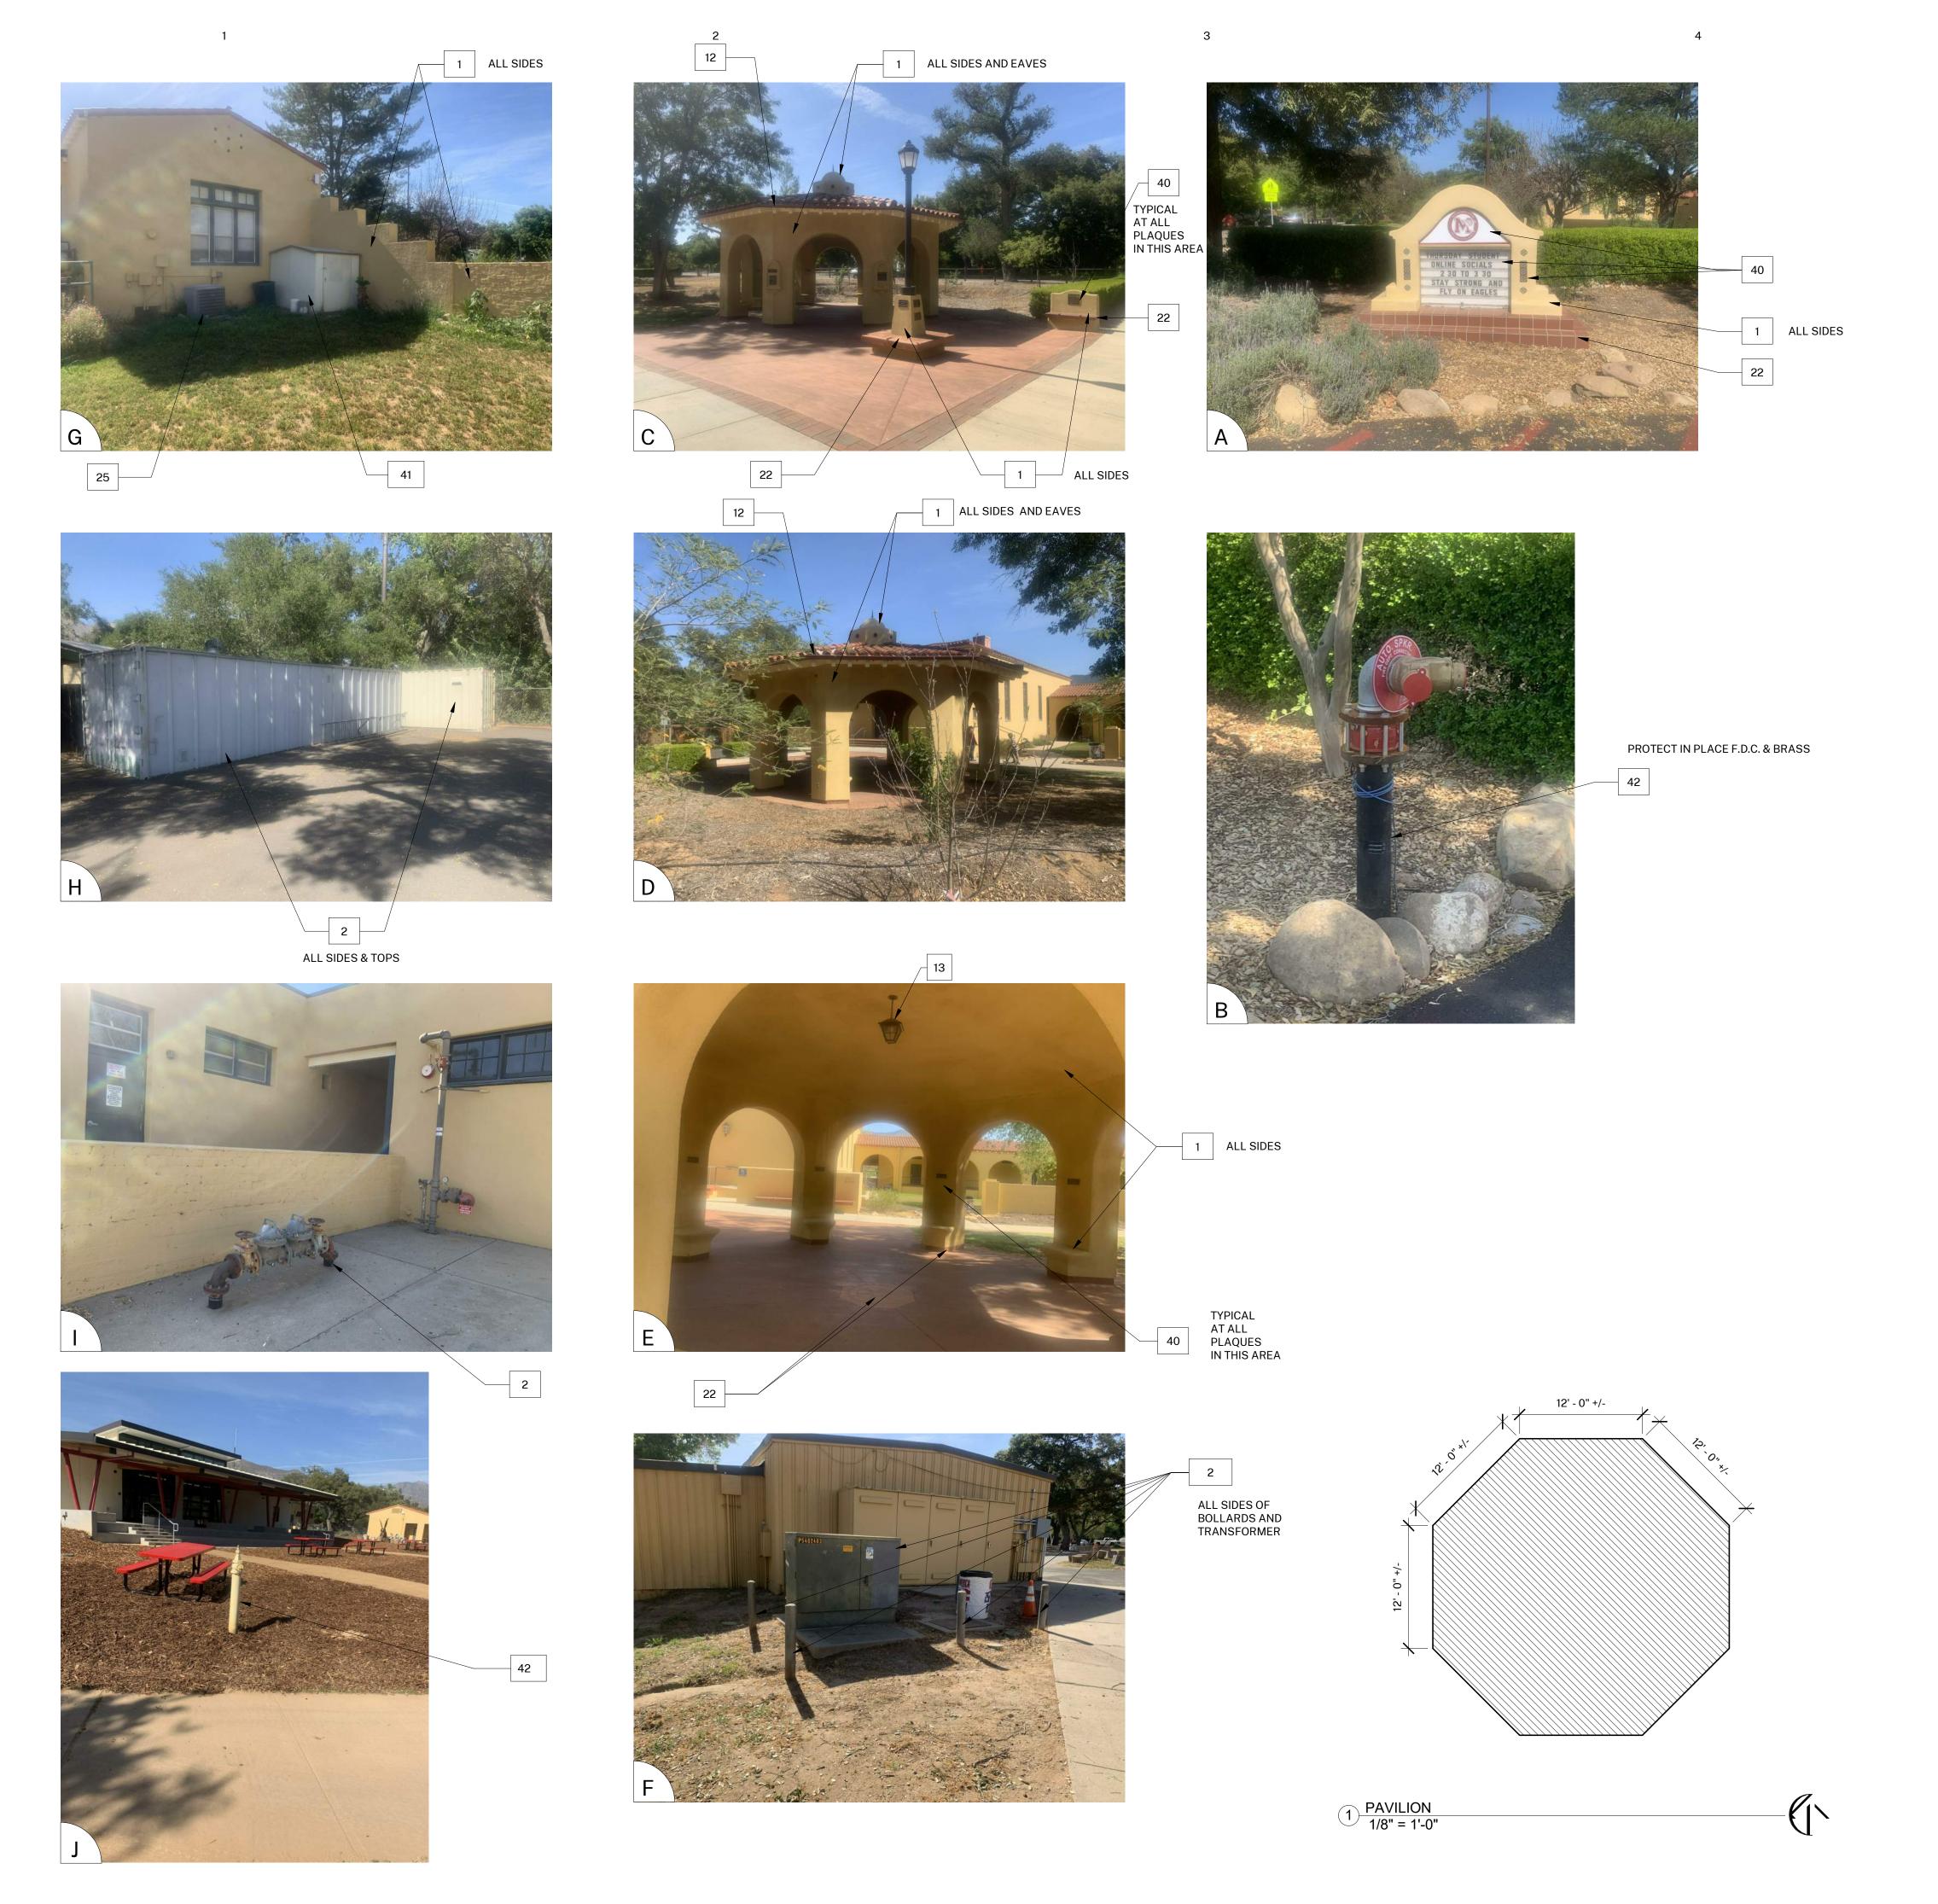
SITE PLAN

SHEET NUMBER:

DATE: 05/14/21

A-101

1" = 50'-0"



- 1. BUILDING PLANS ARE SCHEMATIC TO ONLY SHOW APPROXIMATE OVERALL BUILDING DIMENSIONS, DOOR QUANTITIES AND APPROXIMATE DOOR LOCATIONS AND ARE PROVIDED AS A CONVENIENCE FOR BIDDING. FIELD VERIFY CONDITIONS PRIOR TO BID. REFER TO SHEET KEYNOTES, PHOTOS, AND LEGENDS FOR ADDITIONAL INFORMATION.
- 2. ALL EXISTING PAINTED EXTERIOR WALLS OF BUILDING, PAINTED ROOF EAVES, OVERHANGS, CONDUITS, CABINTES, LOUVERS, VENTS, DUCTS AND ROOF EAVES AND GABLES INCLUDED IN THE SCOPE OF WORK ARE TO BE REPAINTED COLORS AS LISTED AND AS DETAILED IN THESE DRAWINGS AND SPECIFICATIONS UNLESS NOTED OTHERWISE.
- 3. ALL EXISTING UNPAINTED EXTERIOR SURFACES ARE TO REMAIN UNPAINTED UNLESS NOTED OTHERWISE. PROTECT IN PLACE ALL UNPAINTED SURFACES. 4. CAREFULLY PRUNE SHRUBS AND PLANTS AND REMOVE WEEDS AND PLANTINGS AT BASE OF WALL TO BARE EARTH TO ALLOW FOR COMPLETE WALL COVERAGE. 5. EXISTING PAINTED DOORS, DOOR FRAMES, DOOR TRIM, WINDOW FRAMES, MULLIONS, AND SEALANTS TO REMAIN UNLESS NOTED OTHERWISE. DO NOT PAINT
- ALUMINUM WINDOWS. PROTECT IN PLACE. 6. TYPICAL WORK AT EXISTING SIGNS TO REMAIN: REMOVE SIGN, PAINT BEHIND SIGN, CLEAN SIGN, REINSTALL SIGN UNLESS NOTED OTHERWISE.

HARTMANNARCHITECTURESTUDIO.COM 430 S. CARRILLO RD. OJAI, CALIFORNIA 93023 (805) 530-5559

CONSULTANTS:

AGENCY APPROVAL:

COLOR LEGEND AND NOTES

COLOR 2 - ROYAL GREY DUNN EDWARDS, MATCH EXISTING COLOR 3 - WILD CURRANT SHERWIN WILLIAMS SW7583

COLOR 4 - MATCH TERRA COTTA ROOF TILE, FIELD VERIFY

1. PHOTOS WITH KEYNOTES ARE CREATED ELECTRONICALLY AND ARE INTENDED TO BE VIEWED IN COLOR TO SEE LOCATIONS OF COLORS ON THE BUILDINGS. CONTRACTOR SHALL FIELD VERIFY ACTUAL LOCATIONS AND DIMENSIONS OF COLORS PRIOR TO BID.

DUNN EDWARDS DEW341

SHEET KEYNOTES

COLOR 1 - SWISS COFFEE

NOTE: NOT ALL KEYNOTES **USED ON EVERY SHEET**

1. PAINT COLOR 1

2. PAINT COLOR 2

3. PAINT COLOR 3 4. PAINT COLOR 4

5. REMOVE / PAINT WALL / REINSTALL: EXISTING SIGN

6. PROTECT IN PLACE: EXISTING SECURITY CAMERA TYPICAL AT ALL LOCATIONS

7. PREP / PAINT: UTILITY CONDUITS, CABINETS & HVAC TO MATCH WALL BEYOND. 8. PREP / PAINT: EXISTING SIGNAGE IN PLACE

9. PREP / PAINT: EXISTING LOUVERS AND/OR VENTS, TYPICAL

10. REMOVE / PAINT WALL / REINSTALL: LIGHT FIXTURE ESCUTCHEON PLATE OR LIGHT FIXTURE ITSELF TO WALL SURFACE BEHIND. TYPICAL AT ALL LIGHT FIXTURES U.N.O. 11. PREP / PAINT: EXISTING GUTTERS AND DOWNSPOUTS. PAINT COLOR 4

12. PROTECT IN PLACE: EXISTING GUTTERS AND LEADERHEADS 13. PROTECT IN PLACE: EXISTING LIGHT FIXTURE / SPEAKER / FIRE ALARM DEVICE 14. PREP / PAINT: EXISTING HVAC DUCTWORK WHERE ALREADY PAINTED.

15. PROTECT IN PLACE: EXISTING MURAL. PAINT WALLS AROUND MURAL TO MATCH EXISTING BUILDING COLOR SCHEME. TOUCH-UP/REPAINT MURALS WHERE PAINTED TO MATCH EXISTING.

16. PROTECT IN PLACE: EXISTING DRINKING FOUNTAIN 17. PREP / PAINT: EXISTING PAINTED DRINKING FOUNTAIN CANE DETECTION RAILS

18. PREP/STAIN/SEAL: EXISTING WOOD DISPLAY CASES, FIELD VERIFY STAIN COLOR + SEALER SHEEN 19. REMOVE / DISCARD: EXISTING SIGN

20. REMOVE / SALVAGE TO ARCHITECT: EXISTING SIGN 21. REMOVE ACCESSIBLE SIGN / PAINT WALL / REINSTALL

22. PROTECT IN PLACE: EXISTING CONCRETE, CMU OR TILE 23. PREP / PAINT: EXISTING CONCRETE / CMU WALL

24. PREP / PAINT: EXISTING METAL FENCE & GATE

25. PROTECT IN PLACE: EXISTING MECHANICAL EQUIPMENT 26. PREP / PAINT: EXISTING ROLL-UP DOOR

27. PREP / PAINT: EXISTING STORAGE CONTAINER, ALL SIDES AND TOP, PAINT COLOR 2

28. PREP / PAINT: EXISTING WOOD BENCH / SEATS AND SLEEERS. 29. PREP / PAINT: EXISTING CMU WALLS. PAINT INSIDE AND OUTSIDE OF ENCLOSURE AND DOORS.

30. PREP / PRIME / PAINT: PAVILION PLASTERED SURFACES & EAVES 31. PREP / PAINT: EXISTING DOOR OR WINDOW METAL SECURITY GRATING 32. PATCH / REPAIR / PREP / PRIME / PAINT: EXISTING PLASTER. SEE 1&3/A-201

33. PREP / PAINT: METAL PARAPET WALL CAP 34. PREP / PAINT: PLASTERED ROOF TOP EQUIPMENT SCREEN WALLS INSIDE AND OUT 35. CONTINUE WAINSCOAT AROUND ENTIRE PERIMETER OF BUILDING INCLUDING

RECESSED DOOR AND WINDOW RETURNS 36. PREP / PAINT: EXISTING RAIL 37. REMOVE / REPLACE CEILING LIGHTS, OWNER PROVIDED

38. EXISTING MURAL, PAINT OVER MURAL

39. REMOVE AND REPLACE EXISTING EQUIPMENT CLOSET DOOR, FRAME, HARDWARE AND LOUVER, PAINT COLOR 2

40. PROTECT IN PLACE: EXISTING SIGN/PLAQUE 41. REMOVE EXISTING STRUCTURE

42. PREP/PAINT SAFETY YELLOW

43. REMOVE/PAINT/REINSTALL EQUIPMENT 44. REPAIR/REPLACE/PAINT: DAMAGED WOOD EAVE


45. PREP/PAINT: EXISTING WINDOW FRAMES & MUNTINS

46. REMOVE/DISCARD AS NOTED 47. PROTECT IN PLACE AS NOTED

SYMBOL LEGEND



EXISTING DOOR: FIELD VERIFY SIZES AND CONDITIONS, PAINT DOOR WARNING STRIPING ON LANDING AT ALL OUTSWINGING EXTERIOR DOORS U.N.O.

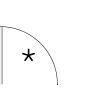

EXISTING RESTROOM DOOR: FIELD VERIFY SIZES AND CONDITIONS, PAINT DOOR WARNING STRIPING ON LANDING AT ALL OUTSWINGING EXTERIOR DOORS U.N.O. PAINT EXTERIOR DOOR FACE, FRAME EXTERIOR AND INTERIOR JAMB TO FACE OF DOOR STOP. APPLY RESTROOM IDENTIFICATION DOOR SIGNAGE ON EXTERIOR AND INTERIOR WHERE DOORS ARE PROPPED OPEN. SEE



EXISTING CLASSROOM DOOR, PAINT WARNING STRIPING ON LANDING AT ALL OUTSWINGING EXTERIOR DOORS U.N.O., REMOVE AND REPLACE TRANSOM DOOR LOUVERS AND INFILL WITH 2x LUMBER, INSULTATION, AND GYPSUM SHEATHING, PAINT ENTIRE DOOR AND FRAME COLOR 2

MATILIJA MS CAMPUS -WIDE EXTERIOR PAINTING

OWNER: OJAI UNIFIED SCHOOL DISTRICT

414 EAST OJAI AVENUE OJAI, CA 93023 (805) 640-4300 CONTACT: ADAM DUTTER EMAIL: adutter@ojaiusd.org

PROJECT ADDRESS:

MATILIJA MIDDLE SCHOOL 703 EL PASEO ROAD OJAI, CA 93023

OJAI USD PROJECT NO.: 2021-1600

MARK	DATE	DESCRIPTION
PROJECT	INFORMATION	N:
PROJECT	NUMBER:	2021.010
PROJECT	PHASE:	CD
DRAWN B	Y:	PBS

REVIEWED BY:

THE ORIGINAL SIZE OF THIS SHEET IS 36"x24". IF THE CURRENT SIZE IS OTHER THAN 36"x24", THEN ADJUST THE SCALE OF THE DRAWINGS ACCORDINGLY.

SHEET TITLE:

SITE PLAN

SHEET NUMBER:

A-102



- 1. BUILDING PLANS ARE SCHEMATIC TO ONLY SHOW APPROXIMATE OVERALL BUILDING DIMENSIONS, DOOR QUANTITIES AND APPROXIMATE DOOR LOCATIONS AND ARE PROVIDED AS A CONVENIENCE FOR BIDDING. FIELD VERIFY CONDITIONS PRIOR TO BID. REFER TO SHEET KEYNOTES, PHOTOS, AND LEGENDS FOR ADDITIONAL INFORMATION.
- 2. ALL EXISTING PAINTED EXTERIOR WALLS OF BUILDING, PAINTED ROOF EAVES, OVERHANGS, CONDUITS, CABINTES, LOUVERS, VENTS, DUCTS AND ROOF EAVES AND GABLES INCLUDED IN THE SCOPE OF WORK ARE TO BE REPAINTED COLORS AS LISTED AND AS DETAILED IN THESE DRAWINGS AND SPECIFICATIONS UNLESS NOTED OTHERWISE.
- 3. ALL EXISTING UNPAINTED EXTERIOR SURFACES ARE TO REMAIN UNPAINTED UNLESS NOTED OTHERWISE. PROTECT IN PLACE ALL UNPAINTED SURFACES. 4. CAREFULLY PRUNE SHRUBS AND PLANTS AND REMOVE WEEDS AND PLANTINGS AT BASE OF WALL TO BARE EARTH TO ALLOW FOR COMPLETE WALL COVERAGE. 5. EXISTING PAINTED DOORS, DOOR FRAMES, DOOR TRIM, WINDOW FRAMES, MULLIONS, AND SEALANTS TO REMAIN UNLESS NOTED OTHERWISE. DO NOT PAINT
- 6. TYPICAL WORK AT EXISTING SIGNS TO REMAIN: REMOVE SIGN, PAINT BEHIND SIGN,

NOTE: NOT ALL KEYNOTES **USED ON EVERY SHEET**

7. PREP / PAINT: UTILITY CONDUITS. CABINETS & HVAC TO MATCH WALL BEYOND.

12. PROTECT IN PLACE: EXISTING GUTTERS AND LEADERHEADS 13. PROTECT IN PLACE: EXISTING LIGHT FIXTURE / SPEAKER / FIRE ALARM DEVICE 14. PREP / PAINT: EXISTING HVAC DUCTWORK WHERE ALREADY PAINTED.

15. PROTECT IN PLACE: EXISTING MURAL. PAINT WALLS AROUND MURAL TO MATCH EXISTING BUILDING COLOR SCHEME. TOUCH-UP/REPAINT MURALS WHERE PAINTED TO MATCH EXISTING.

17. PREP / PAINT: EXISTING PAINTED DRINKING FOUNTAIN CANE DETECTION RAILS 18. PREP/STAIN/SEAL: EXISTING WOOD DISPLAY CASES, FIELD VERIFY STAIN COLOR +


27. PREP / PAINT: EXISTING STORAGE CONTAINER, ALL SIDES AND TOP, PAINT COLOR 2 28. PREP / PAINT: EXISTING WOOD BENCH / SEATS AND SLEEERS.

AND DOORS. 30. PREP / PRIME / PAINT: PAVILION PLASTERED SURFACES & EAVES

33. PREP / PAINT: METAL PARAPET WALL CAP 34. PREP / PAINT: PLASTERED ROOF TOP EQUIPMENT SCREEN WALLS INSIDE AND OUT 35. CONTINUE WAINSCOAT AROUND ENTIRE PERIMETER OF BUILDING INCLUDING

39. REMOVE AND REPLACE EXISTING EQUIPMENT CLOSET DOOR, FRAME, HARDWARE AND LOUVER, PAINT COLOR 2 40. PROTECT IN PLACE: EXISTING SIGN/PLAQUE


OJAI, CA 93023

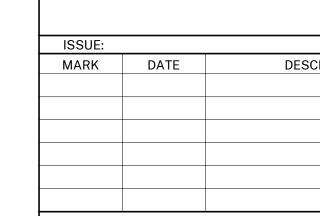

PROJECT PHASE: DRAWN BY: REVIEWED BY:

A-103

DATE: 05/14/21

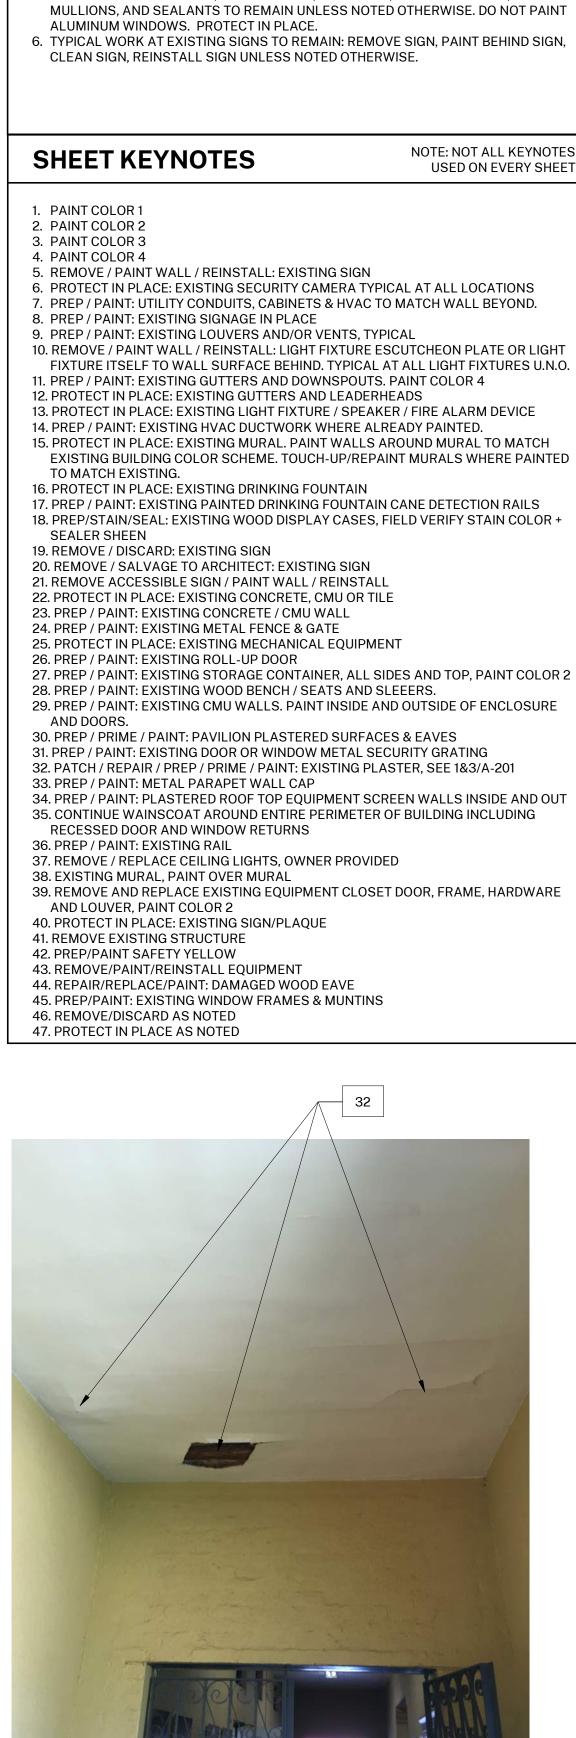

HARTMANNARCHITECTURESTUDIO.COM 430 S. CARRILLO RD. OJAI, CALIFORNIA 93023 (805) 530-5559

CONSULTANTS:

AGENCY APPROVAL:

SEALS:

MATILIJA MS CAMPUS -WIDE EXTERIOR PAINTING

OJAI UNIFIED SCHOOL DISTRICT

414 EAST OJAI AVENUE OJAI, CA 93023 (805) 640-4300 **CONTACT: ADAM DUTTER** EMAIL: adutter@ojaiusd.org

PROJECT ADDRESS: MATILIJA MIDDLE SCHOOL 703 EL PASEO ROAD

OJAI USD PROJECT NO.: 2021-1600

DESCRIPTION


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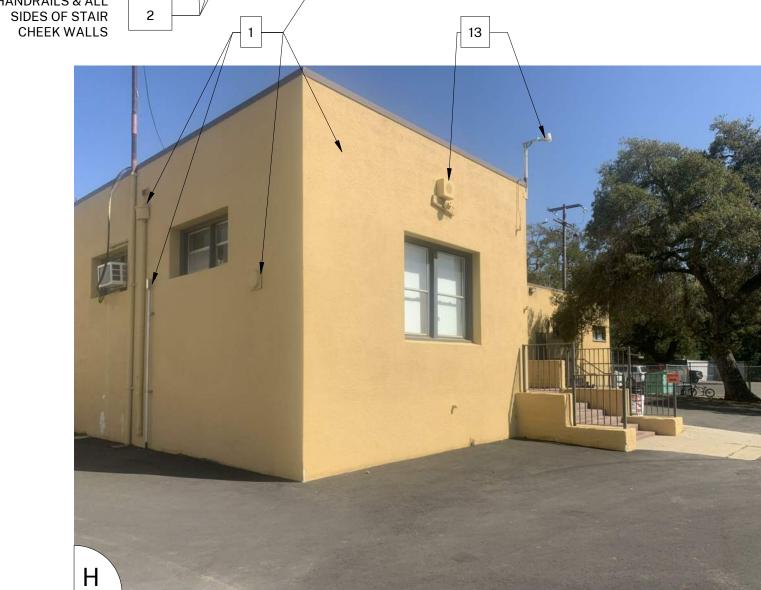
PROJECT INFORMATION: PROJECT NUMBER:

THE ORIGINAL SIZE OF THIS SHEET IS 36"x24". IF THE CURRENT SIZE IS OTHER THAN 36"x24", THEN ADJUST THE SCALE OF THE DRAWINGS ACCORDING! Y. SHEET TITLE:

BUILDING C

SHEET NUMBER:



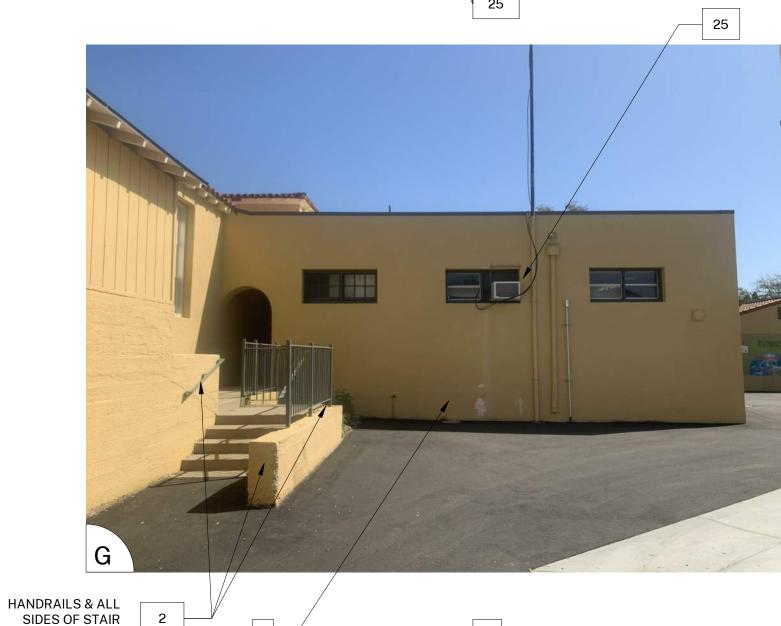

COLOR LEGEND AND NOTES

DUNN EDWARDS DEW341 COLOR 1 - SWISS COFFEE DUNN EDWARDS, MATCH EXISTING COLOR 2 - ROYAL GREY WILD CURRANT SHERWIN WILLIAMS SW7583

- MATCH TERRA COTTA ROOF TILE, FIELD VERIFY

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PAINT (2)

NOT

TYP AT

CONC

BEAMS IN

CORRIDOR

1

16

COLOR 1

REPAIR LOOSE, DAMAGED, OR BROKEN


CEILING TILE, PAINT ENTIRE CEILING

HANDRAILS

PICTURED





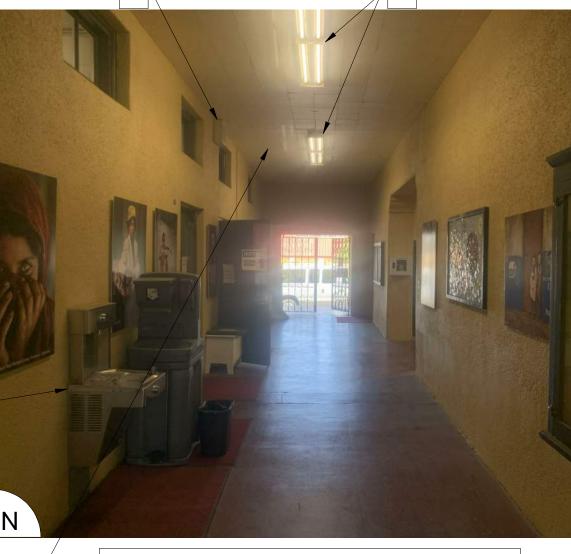

GENERAL NOTE: REMOVAL OF PHOTOGRAPHIC ARTWORK BY


GENERAL NOTES

- 1. BUILDING PLANS ARE SCHEMATIC TO ONLY SHOW APPROXIMATE OVERALL BUILDING DIMENSIONS, DOOR QUANTITIES AND APPROXIMATE DOOR LOCATIONS AND ARE PROVIDED AS A CONVENIENCE FOR BIDDING. FIELD VERIFY CONDITIONS PRIOR TO BID. REFER TO SHEET KEYNOTES, PHOTOS, AND LEGENDS FOR ADDITIONAL INFORMATION.
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- ALUMINUM WINDOWS. PROTECT IN PLACE. 6. TYPICAL WORK AT EXISTING SIGNS TO REMAIN: REMOVE SIGN, PAINT BEHIND SIGN, CLEAN SIGN, REINSTALL SIGN UNLESS NOTED OTHERWISE.

SHEET KEYNOTES

NOTE: NOT ALL KEYNOTES **USED ON EVERY SHEET**

- 1. PAINT COLOR 1 2. PAINT COLOR 2
- 3. PAINT COLOR 3 4. PAINT COLOR 4
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- 6. PROTECT IN PLACE: EXISTING SECURITY CAMERA TYPICAL AT ALL LOCATIONS 7. PREP / PAINT: UTILITY CONDUITS, CABINETS & HVAC TO MATCH WALL BEYOND.
- 8. PREP / PAINT: EXISTING SIGNAGE IN PLACE 9. PREP / PAINT: EXISTING LOUVERS AND/OR VENTS, TYPICAL
- 10. REMOVE / PAINT WALL / REINSTALL: LIGHT FIXTURE ESCUTCHEON PLATE OR LIGHT FIXTURE ITSELF TO WALL SURFACE BEHIND. TYPICAL AT ALL LIGHT FIXTURES U.N.O.
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- 14. PREP / PAINT: EXISTING HVAC DUCTWORK WHERE ALREADY PAINTED. 15. PROTECT IN PLACE: EXISTING MURAL. PAINT WALLS AROUND MURAL TO MATCH
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- 19. REMOVE / DISCARD: EXISTING SIGN 20. REMOVE / SALVAGE TO ARCHITECT: EXISTING SIGN
- 21. REMOVE ACCESSIBLE SIGN / PAINT WALL / REINSTALL 22. PROTECT IN PLACE: EXISTING CONCRETE, CMU OR TILE
- 23. PREP / PAINT: EXISTING CONCRETE / CMU WALL 24. PREP / PAINT: EXISTING METAL FENCE & GATE
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- 36. PREP / PAINT: EXISTING RAIL 37. REMOVE / REPLACE CEILING LIGHTS, OWNER PROVIDED
- 38. EXISTING MURAL, PAINT OVER MURAL
- 39. REMOVE AND REPLACE EXISTING EQUIPMENT CLOSET DOOR, FRAME, HARDWARE
- AND LOUVER, PAINT COLOR 2 40. PROTECT IN PLACE: EXISTING SIGN/PLAQUE
- 41. REMOVE EXISTING STRUCTURE
- 42. PREP/PAINT SAFETY YELLOW 43. REMOVE/PAINT/REINSTALL EQUIPMENT
- 44. REPAIR/REPLACE/PAINT: DAMAGED WOOD EAVE 45. PREP/PAINT: EXISTING WINDOW FRAMES & MUNTINS
- 46. REMOVE/DISCARD AS NOTED
- 47. PROTECT IN PLACE AS NOTED

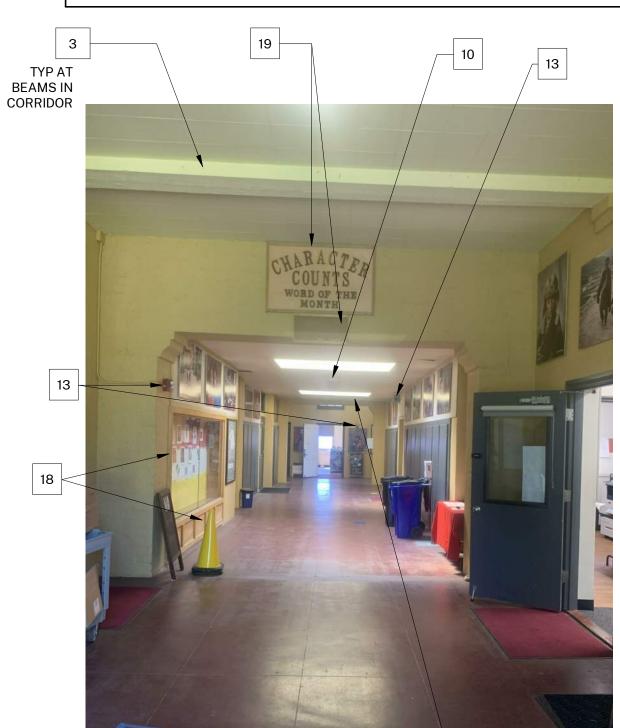




HARTMANNARCHITECTURESTUDIO.COM 430 S. CARRILLO RD. OJAI, CALIFORNIA 93023 (805) 530-5559

CONSULTANTS:

AGENCY APPROVAL:

SEALS:

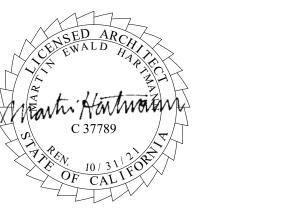

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OWNER:

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PROJECT ADDRESS:

MATILIJA MIDDLE SCHOOL 703 EL PASEO ROAD OJAI, CA 93023

OJAI USD PROJECT NO.: 2021-1600

ISSUE: MARK DATE DESCRIPTION

2021.010

PROJECT INFORMATION: PROJECT NUMBER:

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REVIEWED BY:


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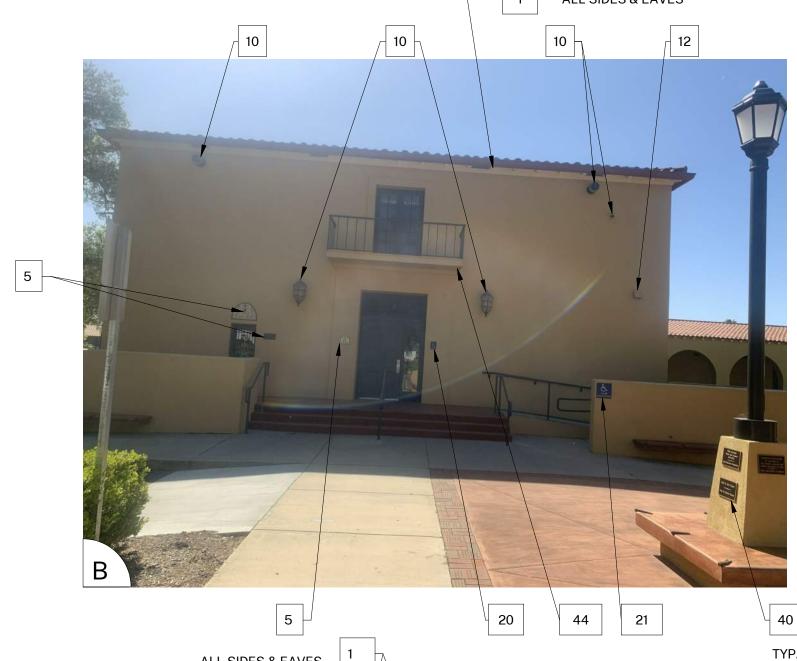
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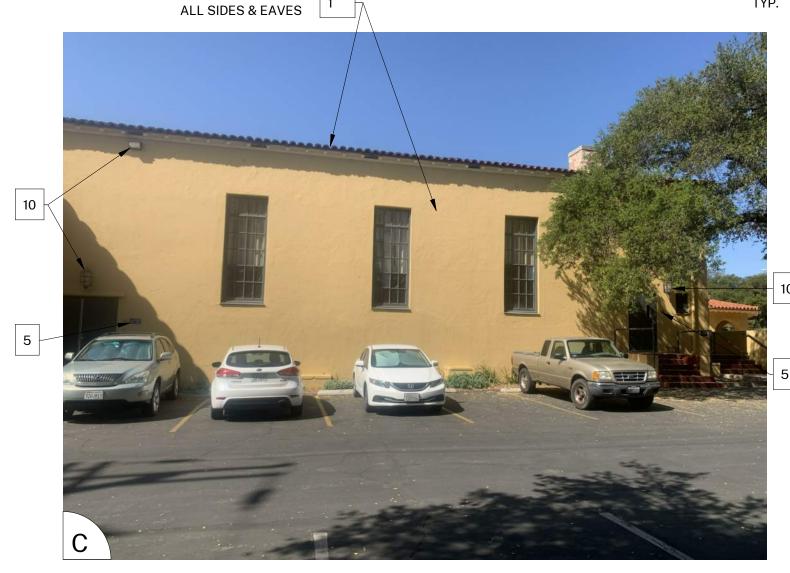
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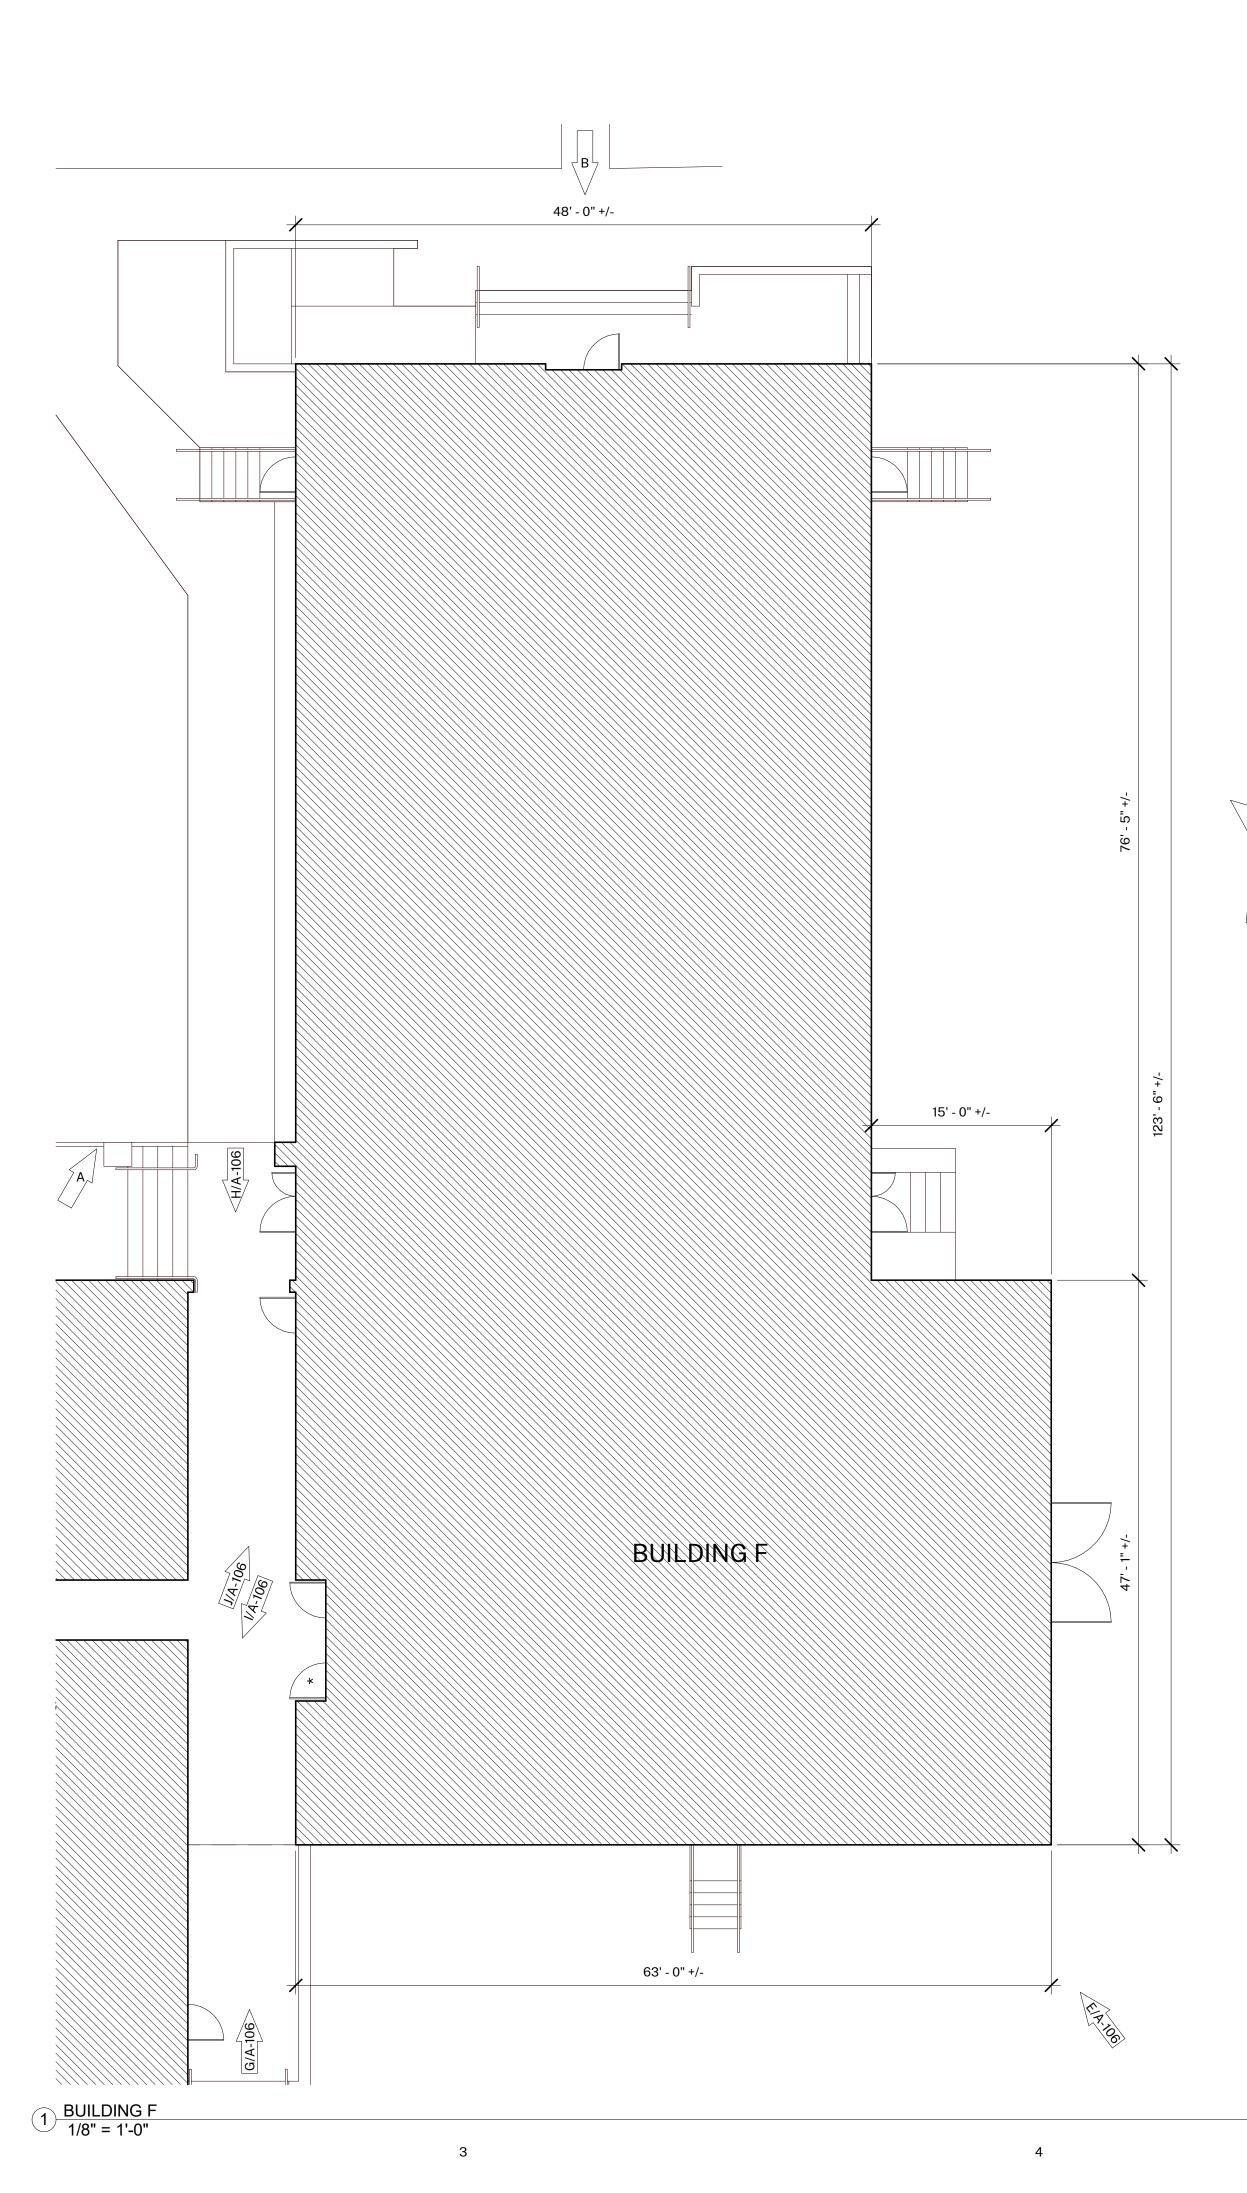
A-104

32 AT SKYLIGHT WELL







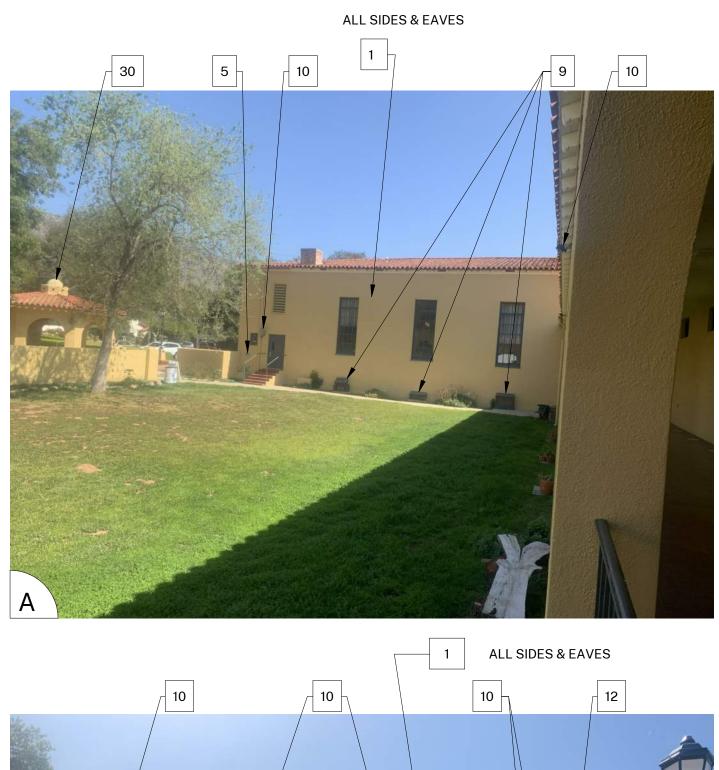

1. BUILDING PLANS ARE SCHEMATIC TO ONLY SHOW APPROXIMATE OVERALL BUILDING DIMENSIONS, DOOR QUANTITIES AND APPROXIMATE DOOR LOCATIONS AND ARE PROVIDED AS A CONVENIENCE FOR BIDDING. FIELD VERIFY CONDITIONS PRIOR TO BID. REFER TO SHEET KEYNOTES, PHOTOS, AND LEGENDS FOR ADDITIONAL INFORMATION.

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6. TYPICAL WORK AT EXISTING SIGNS TO REMAIN: REMOVE SIGN, PAINT BEHIND SIGN, CLEAN SIGN, REINSTALL SIGN UNLESS NOTED OTHERWISE.

COLOR LEGEND AND NOTES

COLOR 1 - SWISS COFFEE DUNN EDWARDS DEW341 DUNN EDWARDS, MATCH EXISTING COLOR 2 - ROYAL GREY

COLOR 3 - WILD CURRANT SHERWIN WILLIAMS SW7583 COLOR 4 - MATCH TERRA COTTA ROOF TILE, FIELD VERIFY

1. PHOTOS WITH KEYNOTES ARE CREATED ELECTRONICALLY AND ARE INTENDED TO BE VIEWED IN COLOR TO SEE LOCATIONS OF COLORS ON THE BUILDINGS. CONTRACTOR SHALL FIELD VERIFY ACTUAL LOCATIONS AND DIMENSIONS OF COLORS PRIOR TO BID.

SHEET KEYNOTES

NOTE: NOT ALL KEYNOTES **USED ON EVERY SHEET**

1. PAINT COLOR 1 2. PAINT COLOR 2

3. PAINT COLOR 3

4. PAINT COLOR 4

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14. PREP / PAINT: EXISTING HVAC DUCTWORK WHERE ALREADY PAINTED. 15. PROTECT IN PLACE: EXISTING MURAL. PAINT WALLS AROUND MURAL TO MATCH EXISTING BUILDING COLOR SCHEME. TOUCH-UP/REPAINT MURALS WHERE PAINTED TO MATCH EXISTING.

16. PROTECT IN PLACE: EXISTING DRINKING FOUNTAIN 17. PREP / PAINT: EXISTING PAINTED DRINKING FOUNTAIN CANE DETECTION RAILS 18. PREP/STAIN/SEAL: EXISTING WOOD DISPLAY CASES, FIELD VERIFY STAIN COLOR +

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36. PREP / PAINT: EXISTING RAIL 37. REMOVE / REPLACE CEILING LIGHTS, OWNER PROVIDED

38. EXISTING MURAL, PAINT OVER MURAL 39. REMOVE AND REPLACE EXISTING EQUIPMENT CLOSET DOOR, FRAME, HARDWARE AND LOUVER, PAINT COLOR 2


40. PROTECT IN PLACE: EXISTING SIGN/PLAQUE 41. REMOVE EXISTING STRUCTURE

42. PREP/PAINT SAFETY YELLOW 43. REMOVE/PAINT/REINSTALL EQUIPMENT 44. REPAIR/REPLACE/PAINT: DAMAGED WOOD EAVE

45. PREP/PAINT: EXISTING WINDOW FRAMES & MUNTINS 46. REMOVE/DISCARD AS NOTED 47. PROTECT IN PLACE AS NOTED

SYMBOL LEGEND

EXISTING DOOR: FIELD VERIFY SIZES AND CONDITIONS, PAINT DOOR WARNING STRIPING ON LANDING AT ALL OUTSWINGING EXTERIOR DOORS U.N.O.

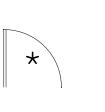

EXISTING RESTROOM DOOR: FIELD VERIFY SIZES AND CONDITIONS, PAINT DOOR WARNING STRIPING ON LANDING AT ALL OUTSWINGING EXTERIOR DOORS U.N.O. PAINT EXTERIOR DOOR FACE, FRAME EXTERIOR AND INTERIOR JAMB TO FACE OF DOOR STOP. APPLY RESTROOM IDENTIFICATION DOOR SIGNAGE ON EXTERIOR AND INTERIOR WHERE DOORS ARE PROPPED OPEN. SEE

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HARTMANNARCHITECTURESTUDIO.COM 430 S. CARRILLO RD.

> OJAI, CALIFORNIA 93023 (805) 530-5559

CONSULTANTS:

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OWNER:

OJAI UNIFIED SCHOOL DISTRICT 414 EAST OJAI AVENUE OJAI, CA 93023 (805) 640-4300 **CONTACT: ADAM DUTTER** EMAIL: adutter@ojaiusd.org

PROJECT ADDRESS: MATILIJA MIDDLE SCHOOL 703 EL PASEO ROAD

OJAI, CA 93023

OJAI USD PROJECT NO.: 2021-1600

ISSUE: MARK DATE DESCRIPTION

2021.010

PROJECT INFORMATION:

PROJECT NUMBER: PROJECT PHASE: DRAWN BY:

REVIEWED BY:

THE ORIGINAL SIZE OF THIS SHEET IS 36"x24". IF THE CURRENT SIZE IS OTHER THAN 36"x24", THEN ADJUST THE SCALE OF THE DRAWINGS ACCORDINGLY. SHEET TITLE:

BUILDING F

SHEET NUMBER:

A-105

REMOVE AND REPLACE DAMAGED

SHEET METAL ACCESS DOOR MATCH EXISTING, PAINT COLOR 1


TYP AT

BEAMS IN

CORRIDOR





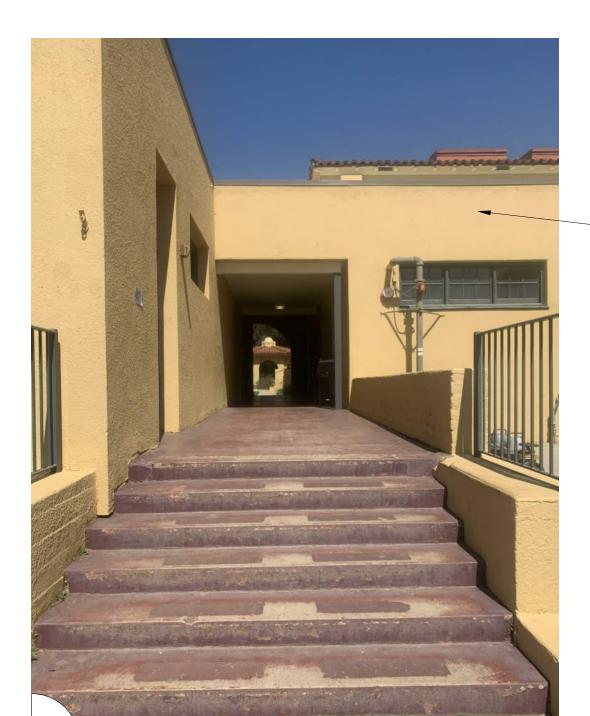

NOTE: NOT ALL KEYNOTES USED ON EVERY SHEET

1. PAINT COLOR 1

2. PAINT COLOR 2 3. PAINT COLOR 3

4. PAINT COLOR 4

SHEET KEYNOTES

5. REMOVE / PAINT WALL / REINSTALL: EXISTING SIGN 6. PROTECT IN PLACE: EXISTING SECURITY CAMERA TYPICAL AT ALL LOCATIONS

7. PREP / PAINT: UTILITY CONDUITS, CABINETS & HVAC TO MATCH WALL BEYOND. 8. PREP / PAINT: EXISTING SIGNAGE IN PLACE

9. PREP / PAINT: EXISTING LOUVERS AND/OR VENTS, TYPICAL 10. REMOVE / PAINT WALL / REINSTALL: LIGHT FIXTURE ESCUTCHEON PLATE OR LIGHT FIXTURE ITSELF TO WALL SURFACE BEHIND. TYPICAL AT ALL LIGHT FIXTURES U.N.O. 11. PREP / PAINT: EXISTING GUTTERS AND DOWNSPOUTS. PAINT COLOR 4

12. PROTECT IN PLACE: EXISTING GUTTERS AND LEADERHEADS 13. PROTECT IN PLACE: EXISTING LIGHT FIXTURE / SPEAKER / FIRE ALARM DEVICE 14. PREP / PAINT: EXISTING HVAC DUCTWORK WHERE ALREADY PAINTED.

15. PROTECT IN PLACE: EXISTING MURAL. PAINT WALLS AROUND MURAL TO MATCH EXISTING BUILDING COLOR SCHEME. TOUCH-UP/REPAINT MURALS WHERE PAINTED TO MATCH EXISTING.

16. PROTECT IN PLACE: EXISTING DRINKING FOUNTAIN 17. PREP / PAINT: EXISTING PAINTED DRINKING FOUNTAIN CANE DETECTION RAILS

18. PREP/STAIN/SEAL: EXISTING WOOD DISPLAY CASES, FIELD VERIFY STAIN COLOR + SEALER SHEEN

19. REMOVE / DISCARD: EXISTING SIGN 20. REMOVE / SALVAGE TO ARCHITECT: EXISTING SIGN

21. REMOVE ACCESSIBLE SIGN / PAINT WALL / REINSTALL 22. PROTECT IN PLACE: EXISTING CONCRETE, CMU OR TILE 23. PREP / PAINT: EXISTING CONCRETE / CMU WALL

24. PREP / PAINT: EXISTING METAL FENCE & GATE 25. PROTECT IN PLACE: EXISTING MECHANICAL EQUIPMENT 26. PREP / PAINT: EXISTING ROLL-UP DOOR

27. PREP / PAINT: EXISTING STORAGE CONTAINER, ALL SIDES AND TOP, PAINT COLOR 2 28. PREP / PAINT: EXISTING WOOD BENCH / SEATS AND SLEEERS.

29. PREP / PAINT: EXISTING CMU WALLS. PAINT INSIDE AND OUTSIDE OF ENCLOSURE AND DOORS. 30. PREP / PRIME / PAINT: PAVILION PLASTERED SURFACES & EAVES

31. PREP / PAINT: EXISTING DOOR OR WINDOW METAL SECURITY GRATING 32. PATCH / REPAIR / PREP / PRIME / PAINT: EXISTING PLASTER, SEE 1&3/A-201 33. PREP / PAINT: METAL PARAPET WALL CAP 34. PREP / PAINT: PLASTERED ROOF TOP EQUIPMENT SCREEN WALLS INSIDE AND OUT

35. CONTINUE WAINSCOAT AROUND ENTIRE PERIMETER OF BUILDING INCLUDING RECESSED DOOR AND WINDOW RETURNS 36. PREP / PAINT: EXISTING RAIL

37. REMOVE / REPLACE CEILING LIGHTS, OWNER PROVIDED 38. EXISTING MURAL, PAINT OVER MURAL 39. REMOVE AND REPLACE EXISTING EQUIPMENT CLOSET DOOR, FRAME, HARDWARE

AND LOUVER, PAINT COLOR 2 40. PROTECT IN PLACE: EXISTING SIGN/PLAQUE

41. REMOVE EXISTING STRUCTURE 42. PREP/PAINT SAFETY YELLOW

43. REMOVE/PAINT/REINSTALL EQUIPMENT 44. REPAIR/REPLACE/PAINT: DAMAGED WOOD EAVE

45. PREP/PAINT: EXISTING WINDOW FRAMES & MUNTINS 46. REMOVE/DISCARD AS NOTED

47. PROTECT IN PLACE AS NOTED

GENERAL NOTES

1. BUILDING PLANS ARE SCHEMATIC TO ONLY SHOW APPROXIMATE OVERALL BUILDING DIMENSIONS, DOOR QUANTITIES AND APPROXIMATE DOOR LOCATIONS AND ARE PROVIDED AS A CONVENIENCE FOR BIDDING. FIELD VERIFY CONDITIONS PRIOR TO BID. REFER TO SHEET KEYNOTES, PHOTOS, AND LEGENDS FOR ADDITIONAL INFORMATION.

2. ALL EXISTING PAINTED EXTERIOR WALLS OF BUILDING, PAINTED ROOF EAVES, OVERHANGS, CONDUITS, CABINTES, LOUVERS, VENTS, DUCTS AND ROOF EAVES AND GABLES INCLUDED IN THE SCOPE OF WORK ARE TO BE REPAINTED COLORS AS LISTED AND AS DETAILED IN THESE DRAWINGS AND SPECIFICATIONS UNLESS

NOTED OTHERWISE. 3. ALL EXISTING UNPAINTED EXTERIOR SURFACES ARE TO REMAIN UNPAINTED UNLESS NOTED OTHERWISE. PROTECT IN PLACE ALL UNPAINTED SURFACES.

5. EXISTING PAINTED DOORS, DOOR FRAMES, DOOR TRIM, WINDOW FRAMES, MULLIONS, AND SEALANTS TO REMAIN UNLESS NOTED OTHERWISE. DO NOT PAINT ALUMINUM WINDOWS. PROTECT IN PLACE.

6. TYPICAL WORK AT EXISTING SIGNS TO REMAIN: REMOVE SIGN, PAINT BEHIND SIGN, CLEAN SIGN, REINSTALL SIGN UNLESS NOTED OTHERWISE.

COLOR LEGEND AND NOTES

DUNN EDWARDS DEW341 COLOR 1 - SWISS COFFEE COLOR 2 - ROYAL GREY DUNN EDWARDS, MATCH EXISTING COLOR 3 - WILD CURRANT SHERWIN WILLIAMS SW7583

COLOR 4 - MATCH TERRA COTTA ROOF TILE, FIELD VERIFY

1. PHOTOS WITH KEYNOTES ARE CREATED ELECTRONICALLY AND ARE INTENDED TO BE VIEWED IN COLOR TO SEE LOCATIONS OF COLORS ON THE BUILDINGS. CONTRACTOR SHALL FIELD VERIFY ACTUAL LOCATIONS AND DIMENSIONS OF COLORS PRIOR TO BID.



HARTMANNARCHITECTURESTUDIO.COM 430 S. CARRILLO RD. OJAI, CALIFORNIA 93023

CONSULTANTS:

AGENCY APPROVAL:



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OJAI, CA 93023

MARK DESCRIPTION

2021.010

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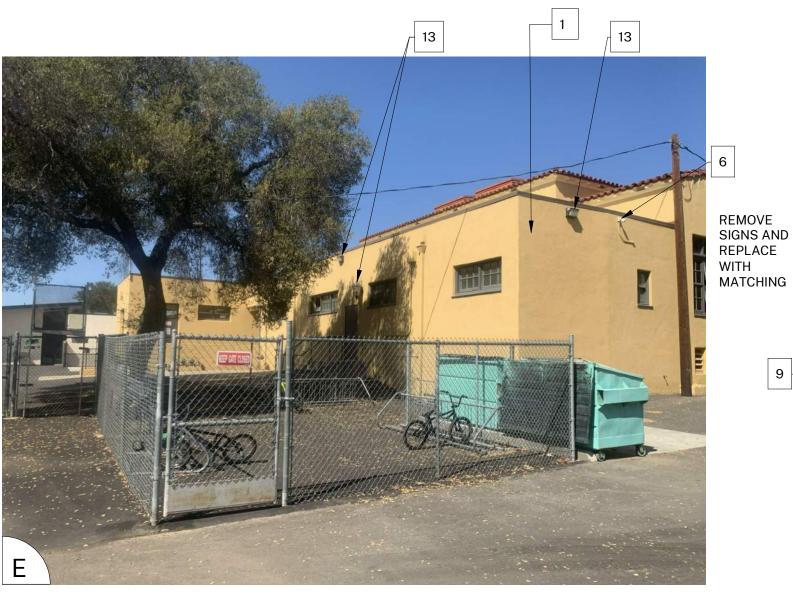
PROJECT PHASE: DRAWN BY: REVIEWED BY:

SHEET TITLE:

BUILDING F

SHEET NUMBER:

A-106



46 BRACKETS 1 ALL SIDES & EAVES

4. CAREFULLY PRUNE SHRUBS AND PLANTS AND REMOVE WEEDS AND PLANTINGS AT BASE OF WALL TO BARE EARTH TO ALLOW FOR COMPLETE WALL COVERAGE.

(805) 530-5559




MATILIJA MS CAMPUS -WIDE EXTERIOR PAINTING

OWNER: OJAI UNIFIED SCHOOL DISTRICT 414 EAST OJAI AVENUE OJAI, CA 93023

PROJECT ADDRESS:

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- 2. ALL EXISTING PAINTED EXTERIOR WALLS OF BUILDING, PAINTED ROOF EAVES, OVERHANGS, CONDUITS, CABINTES, LOUVERS, VENTS, DUCTS AND ROOF EAVES AND GABLES INCLUDED IN THE SCOPE OF WORK ARE TO BE REPAINTED COLORS AS LISTED AND AS DETAILED IN THESE DRAWINGS AND SPECIFICATIONS UNLESS NOTED OTHERWISE.
- ALL EXISTING UNPAINTED EXTERIOR SURFACES ARE TO REMAIN UNPAINTED UNLESS NOTED OTHERWISE. PROTECT IN PLACE ALL UNPAINTED SURFACES.
 CAREFULLY PRUNE SHRUBS AND PLANTS AND REMOVE WEEDS AND PLANTINGS AT BASE OF WALL TO BARE EARTH TO ALLOW FOR COMPLETE WALL COVERAGE.
 EXISTING PAINTED DOORS, DOOR FRAMES, DOOR TRIM, WINDOW FRAMES, MULLIONS, AND SEALANTS TO REMAIN UNLESS NOTED OTHERWISE. DO NOT PAINT
- ALUMINUM WINDOWS. PROTECT IN PLACE.

 6. TYPICAL WORK AT EXISTING SIGNS TO REMAIN: REMOVE SIGN, PAINT BEHIND SIGN, CLEAN SIGN, REINSTALL SIGN UNLESS NOTED OTHERWISE.

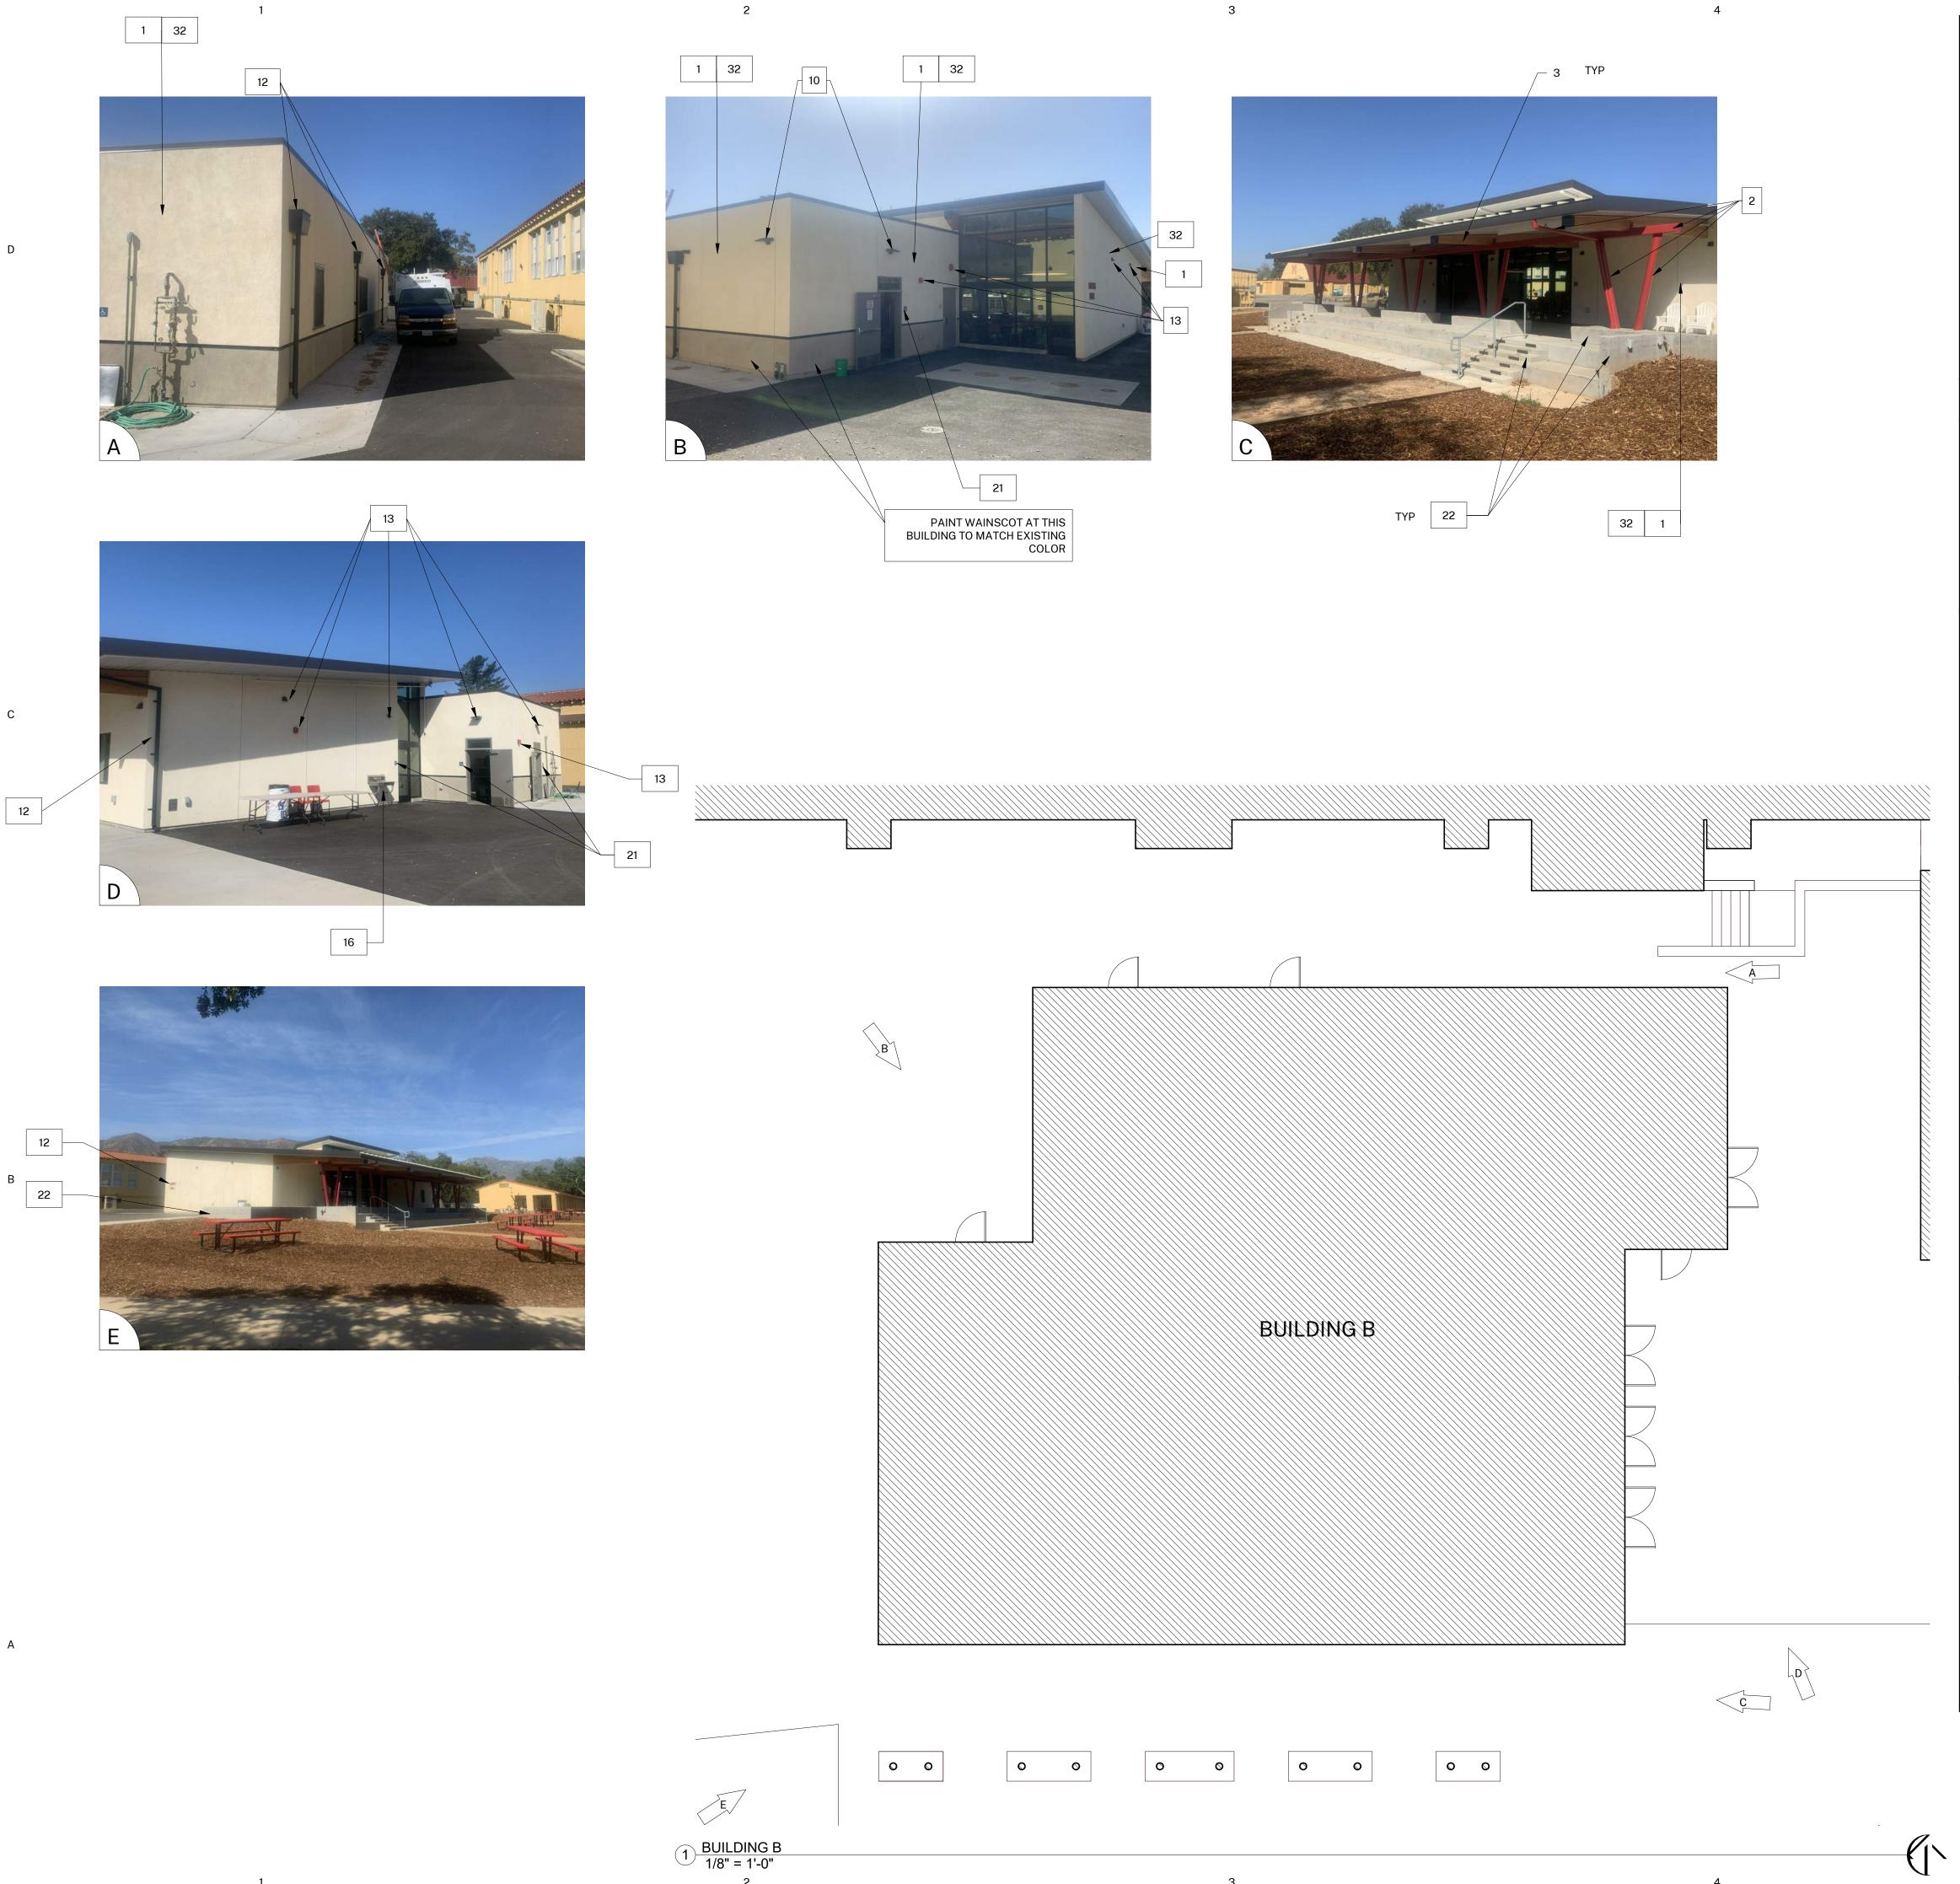COLOR LEGEND AND NOTES

COLOR 1 - SWISS COFFEE DUNN EDWARDS DEW341

COLOR 2 - ROYAL GREY DUNN EDWARDS, MATCH EXISTING

COLOR 3 - WILD CURRANT SHERWIN WILLIAMS SW7583

COLOR 4 - MATCH TERRA COTTA ROOF TILE, FIELD VERIFY

 PHOTOS WITH KEYNOTES ARE CREATED ELECTRONICALLY AND ARE INTENDED TO BE VIEWED IN COLOR TO SEE LOCATIONS OF COLORS ON THE BUILDINGS. CONTRACTOR SHALL FIELD VERIFY ACTUAL LOCATIONS AND DIMENSIONS OF COLORS PRIOR TO BID.

SHEET KEYNOTES

NOTE: NOT ALL KEYNOTES USED ON EVERY SHEET

1. PAINT COLOR 1

2. PAINT COLOR 2

3. PAINT COLOR 34. PAINT COLOR 4

5. REMOVE / PAINT WALL / REINSTALL: EXISTING SIGN

6. PROTECT IN PLACE: EXISTING SECURITY CAMERA TYPICAL AT ALL LOCATIONS

7. PREP / PAINT: UTILITY CONDUITS, CABINETS & HVAC TO MATCH WALL BEYOND.

PREP / PAINT: EXISTING SIGNAGE IN PLACE
 PREP / PAINT: EXISTING LOUVERS AND/OR VENT

9. PREP / PAINT: EXISTING LOUVERS AND/OR VENTS, TYPICAL
10. REMOVE / PAINT WALL / REINSTALL: LIGHT FIXTURE ESCUTCHEON PLATE OR LIGHT FIXTURE ITSELF TO WALL SURFACE BEHIND. TYPICAL AT ALL LIGHT FIXTURES U.N.O.

11. PREP / PAINT: EXISTING GUTTERS AND DOWNSPOUTS. PAINT COLOR 4
12. PROTECT IN PLACE: EXISTING GUTTERS AND LEADERHEADS
13. PROTECT IN PLACE: EXISTING LIGHT FIXTURE / SPEAKER / FIRE ALARM DEVICE

14. PREP / PAINT: EXISTING HVAC DUCTWORK WHERE ALREADY PAINTED.
15. PROTECT IN PLACE: EXISTING MURAL. PAINT WALLS AROUND MURAL TO MATCH EXISTING BUILDING COLOR SCHEME. TOUCH-UP/REPAINT MURALS WHERE PAINTED TO MATCH EXISTING.

16. PROTECT IN PLACE: EXISTING DRINKING FOUNTAIN
17. PREP / PAINT: EXISTING PAINTED DRINKING FOUNTAIN CANE DETECTION RAILS

18. PREP/STAIN/SEAL: EXISTING WOOD DISPLAY CASES, FIELD VERIFY STAIN COLOR + SEALER SHEEN
19. REMOVE / DISCARD: EXISTING SIGN

20. REMOVE / SALVAGE TO ARCHITECT: EXISTING SIGN 21. REMOVE ACCESSIBLE SIGN / PAINT WALL / REINSTALL

22. PROTECT IN PLACE: EXISTING CONCRETE, CMU OR TILE 23. PREP / PAINT: EXISTING CONCRETE / CMU WALL

24. PREP / PAINT: EXISTING METAL FENCE & GATE

25. PROTECT IN PLACE: EXISTING MECHANICAL EQUIPMENT 26. PREP / PAINT: EXISTING ROLL-UP DOOR

27. PREP / PAINT: EXISTING STORAGE CONTAINER, ALL SIDES AND TOP, PAINT COLOR 2 28. PREP / PAINT: EXISTING WOOD BENCH / SEATS AND SLEEERS.

29. PREP / PAINT: EXISTING CMU WALLS. PAINT INSIDE AND OUTSIDE OF ENCLOSURE AND DOORS.

30. PREP / PRIME / PAINT: PAVILION PLASTERED SURFACES & EAVES
31. DRED / DAINT: EXISTING DOOD OF WINDOW METAL SECURITY CRATING

31. PREP / PAINT: EXISTING DOOR OR WINDOW METAL SECURITY GRATING

32. PATCH / REPAIR / PREP / PRIME / PAINT: EXISTING PLASTER, SEE 1&3/A-201
33. PREP / PAINT: METAL PARAPET WALL CAP
34. PREP / PAINT: PLASTERED ROOF TOP EQUIPMENT SCREEN WALLS INSIDE AND OUT

34. PREP / PAINT: PLASTERED ROOF TOP EQUIPMENT SCREEN WALLS INSIDE AND OU 35. CONTINUE WAINSCOAT AROUND ENTIRE PERIMETER OF BUILDING INCLUDING RECESSED DOOR AND WINDOW RETURNS

36. PREP / PAINT: EXISTING RAIL
37. REMOVE / REPLACE CEILING LIGHTS, OWNER PROVIDED

39. REMOVE AND REPLACE EXISTING EQUIPMENT CLOSET DOOR, FRAME, HARDWARE AND LOUVER, PAINT COLOR 2

40. PROTECT IN PLACE: EXISTING SIGN/PLAQUE
41. REMOVE EXISTING STRUCTURE

38. EXISTING MURAL, PAINT OVER MURAL

42. PREP/PAINT SAFETY YELLOW
43. REMOVE/PAINT/REINSTALL EQUIPMENT

44. REPAIR/REPLACE/PAINT: DAMAGED WOOD EAVE


45. PREP/PAINT: EXISTING WINDOW FRAMES & MUNTINS

46. REMOVE/DISCARD AS NOTED 47. PROTECT IN PLACE AS NOTED


SYMBOL LEGEND



EXISTING DOOR: FIELD VERIFY SIZES AND CONDITIONS, PAINT DOOR WARNING STRIPING ON LANDING AT ALL OUTSWINGING EXTERIOR DOORS U.N.O.

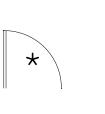

EXISTING RESTROOM DOOR: FIELD VERIFY SIZES AND CONDITIONS, PAINT DOOR WARNING STRIPING ON LANDING AT ALL OUTSWINGING EXTERIOR DOORS U.N.O. PAINT EXTERIOR DOOR FACE, FRAME EXTERIOR AND INTERIOR JAMB TO FACE OF DOOR STOP. APPLY RESTROOM IDENTIFICATION DOOR SIGNAGE ON EXTERIOR AND INTERIOR WHERE DOORS ARE PROPPED OPEN. SEE 1/A-201.

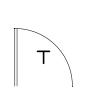

EXISTING CLASSROOM DOOR, PAINT WARNING STRIPING ON LANDING AT ALL OUTSWINGING EXTERIOR DOORS U.N.O., REMOVE AND REPLACE TRANSOM DOOR LOUVERS AND INFILL WITH 2x LUMBER, INSULTATION, AND GYPSUM SHEATHING, PAINT ENTIRE DOOR AND FRAME COLOR 2



HARTMANNARCHITECTURESTUDIO.COM 430 S. CARRILLO RD. OJAI, CALIFORNIA 93023 (805) 530-5559

CONSULTANTS:

AGENCY APPROVAL:

SEALS:



MATILIJA MS CAMPUS -WIDE EXTERIOR PAINTING

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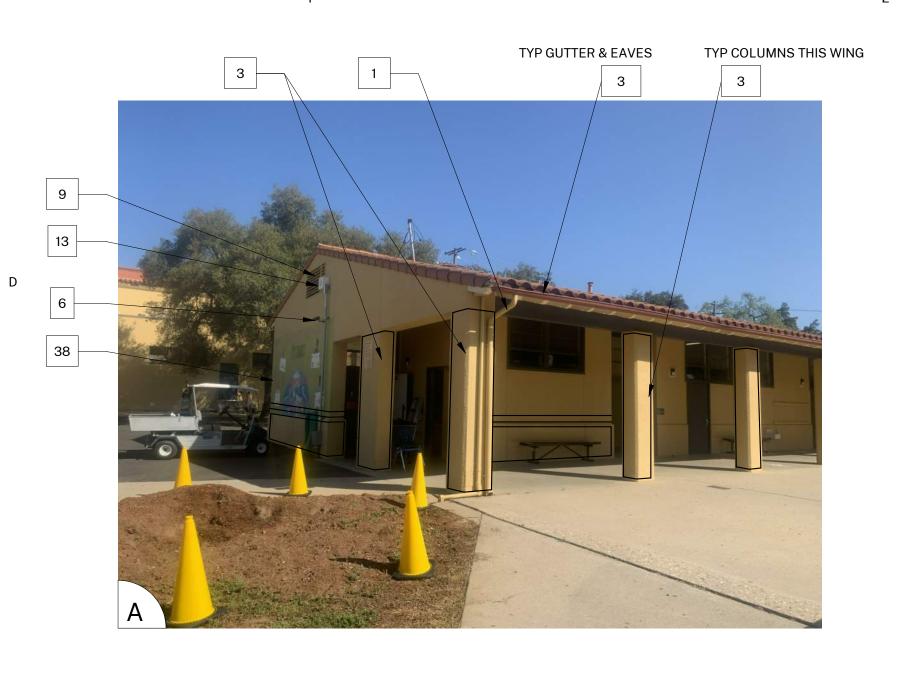
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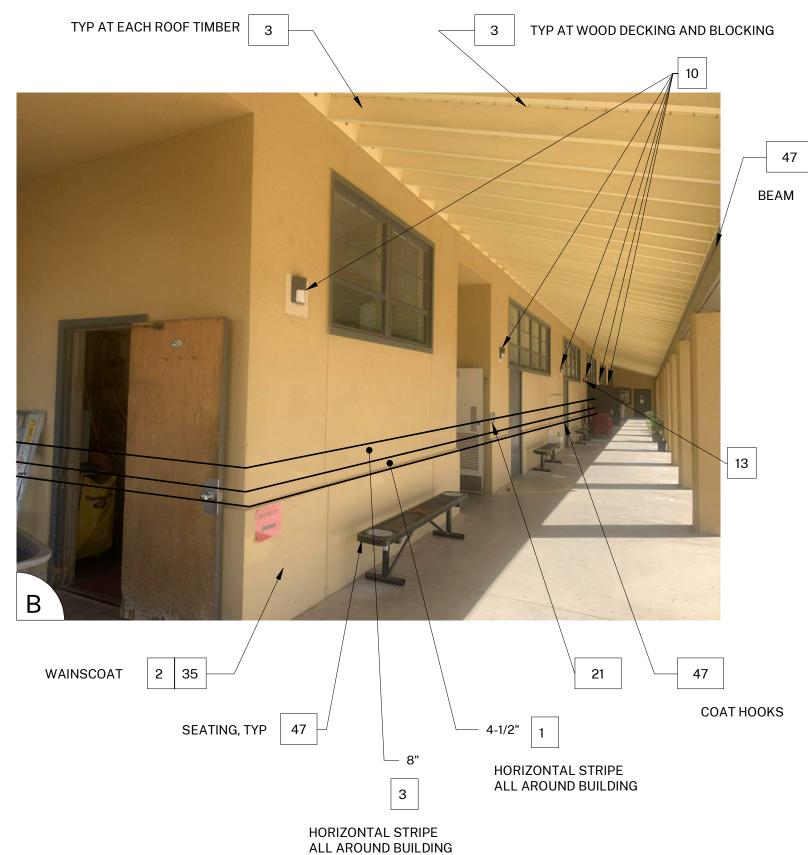
SHEET TITLE:

BUILDING B

SHEET NUMBER:

A-107





NOTE: NOT ALL KEYNOTES **SHEET KEYNOTES** USED ON EVERY SHEET

PAINT COLOR 1

2. PAINT COLOR 2

3. PAINT COLOR 3 4. PAINT COLOR 4

5. REMOVE / PAINT WALL / REINSTALL: EXISTING SIGN

6. PROTECT IN PLACE: EXISTING SECURITY CAMERA TYPICAL AT ALL LOCATIONS 7. PREP / PAINT: UTILITY CONDUITS, CABINETS & HVAC TO MATCH WALL BEYOND. 8. PREP / PAINT: EXISTING SIGNAGE IN PLACE

9. PREP / PAINT: EXISTING LOUVERS AND/OR VENTS, TYPICAL 10. REMOVE / PAINT WALL / REINSTALL: LIGHT FIXTURE ESCUTCHEON PLATE OR LIGHT FIXTURE ITSELF TO WALL SURFACE BEHIND. TYPICAL AT ALL LIGHT FIXTURES U.N.O. 11. PREP / PAINT: EXISTING GUTTERS AND DOWNSPOUTS. PAINT COLOR 4

12. PROTECT IN PLACE: EXISTING GUTTERS AND LEADERHEADS 13. PROTECT IN PLACE: EXISTING LIGHT FIXTURE / SPEAKER / FIRE ALARM DEVICE 14. PREP / PAINT: EXISTING HVAC DUCTWORK WHERE ALREADY PAINTED.

15. PROTECT IN PLACE: EXISTING MURAL. PAINT WALLS AROUND MURAL TO MATCH EXISTING BUILDING COLOR SCHEME. TOUCH-UP/REPAINT MURALS WHERE PAINTED TO MATCH EXISTING.

16. PROTECT IN PLACE: EXISTING DRINKING FOUNTAIN 17. PREP / PAINT: EXISTING PAINTED DRINKING FOUNTAIN CANE DETECTION RAILS

18. PREP/STAIN/SEAL: EXISTING WOOD DISPLAY CASES, FIELD VERIFY STAIN COLOR + SEALER SHEEN

19. REMOVE / DISCARD: EXISTING SIGN 20. REMOVE / SALVAGE TO ARCHITECT: EXISTING SIGN 21. REMOVE ACCESSIBLE SIGN / PAINT WALL / REINSTALL 22. PROTECT IN PLACE: EXISTING CONCRETE, CMU OR TILE

24. PREP / PAINT: EXISTING METAL FENCE & GATE 25. PROTECT IN PLACE: EXISTING MECHANICAL EQUIPMENT 26. PREP / PAINT: EXISTING ROLL-UP DOOR

23. PREP / PAINT: EXISTING CONCRETE / CMU WALL

27. PREP / PAINT: EXISTING STORAGE CONTAINER, ALL SIDES AND TOP, PAINT COLOR 2 28. PREP / PAINT: EXISTING WOOD BENCH / SEATS AND SLEEERS.

29. PREP / PAINT: EXISTING CMU WALLS. PAINT INSIDE AND OUTSIDE OF ENCLOSURE AND DOORS. 30. PREP / PRIME / PAINT: PAVILION PLASTERED SURFACES & EAVES

31. PREP / PAINT: EXISTING DOOR OR WINDOW METAL SECURITY GRATING

32. PATCH / REPAIR / PREP / PRIME / PAINT: EXISTING PLASTER, SEE 1&3/A-201 33. PREP / PAINT: METAL PARAPET WALL CAP 34. PREP / PAINT: PLASTERED ROOF TOP EQUIPMENT SCREEN WALLS INSIDE AND OUT

35. CONTINUE WAINSCOAT AROUND ENTIRE PERIMETER OF BUILDING INCLUDING RECESSED DOOR AND WINDOW RETURNS 36. PREP / PAINT: EXISTING RAIL

37. REMOVE / REPLACE CEILING LIGHTS, OWNER PROVIDED 38. EXISTING MURAL, PAINT OVER MURAL

39. REMOVE AND REPLACE EXISTING EQUIPMENT CLOSET DOOR, FRAME, HARDWARE AND LOUVER, PAINT COLOR 2 40. PROTECT IN PLACE: EXISTING SIGN/PLAQUE

41. REMOVE EXISTING STRUCTURE 42. PREP/PAINT SAFETY YELLOW 43. REMOVE/PAINT/REINSTALL EQUIPMENT

44. REPAIR/REPLACE/PAINT: DAMAGED WOOD EAVE 45. PREP/PAINT: EXISTING WINDOW FRAMES & MUNTINS 46. REMOVE/DISCARD AS NOTED

47. PROTECT IN PLACE AS NOTED

GENERAL NOTES

1. BUILDING PLANS ARE SCHEMATIC TO ONLY SHOW APPROXIMATE OVERALL BUILDING DIMENSIONS, DOOR QUANTITIES AND APPROXIMATE DOOR LOCATIONS AND ARE PROVIDED AS A CONVENIENCE FOR BIDDING. FIELD VERIFY CONDITIONS PRIOR TO BID. REFER TO SHEET KEYNOTES, PHOTOS, AND LEGENDS FOR

ADDITIONAL INFORMATION. 2. ALL EXISTING PAINTED EXTERIOR WALLS OF BUILDING, PAINTED ROOF EAVES, OVERHANGS, CONDUITS, CABINTES, LOUVERS, VENTS, DUCTS AND ROOF EAVES AND GABLES INCLUDED IN THE SCOPE OF WORK ARE TO BE REPAINTED COLORS AS

LISTED AND AS DETAILED IN THESE DRAWINGS AND SPECIFICATIONS UNLESS NOTED OTHERWISE. 3. ALL EXISTING UNPAINTED EXTERIOR SURFACES ARE TO REMAIN UNPAINTED UNLESS NOTED OTHERWISE. PROTECT IN PLACE ALL UNPAINTED SURFACES.

BASE OF WALL TO BARE EARTH TO ALLOW FOR COMPLETE WALL COVERAGE. 5. EXISTING PAINTED DOORS, DOOR FRAMES, DOOR TRIM, WINDOW FRAMES, MULLIONS, AND SEALANTS TO REMAIN UNLESS NOTED OTHERWISE. DO NOT PAINT ALUMINUM WINDOWS. PROTECT IN PLACE.

6. TYPICAL WORK AT EXISTING SIGNS TO REMAIN: REMOVE SIGN, PAINT BEHIND SIGN, CLEAN SIGN, REINSTALL SIGN UNLESS NOTED OTHERWISE.

4. CAREFULLY PRUNE SHRUBS AND PLANTS AND REMOVE WEEDS AND PLANTINGS AT

COLOR LEGEND AND NOTES

COLOR 1 - SWISS COFFEE DUNN EDWARDS DEW341 DUNN EDWARDS, MATCH EXISTING COLOR 2 - ROYAL GREY SHERWIN WILLIAMS SW7583 COLOR 3 - WILD CURRANT

COLOR 4 - MATCH TERRA COTTA ROOF TILE, FIELD VERIFY

1. PHOTOS WITH KEYNOTES ARE CREATED ELECTRONICALLY AND ARE INTENDED TO BE VIEWED IN COLOR TO SEE LOCATIONS OF COLORS ON THE BUILDINGS. CONTRACTOR SHALL FIELD VERIFY ACTUAL LOCATIONS AND DIMENSIONS OF COLORS PRIOR TO BID.

SYMBOL LEGEND



EXISTING DOOR: FIELD VERIFY SIZES AND CONDITIONS, PAINT DOOR WARNING STRIPING ON LANDING AT ALL OUTSWINGING EXTERIOR DOORS U.N.O.

EXISTING RESTROOM DOOR: FIELD VERIFY SIZES AND CONDITIONS, PAINT DOOR WARNING STRIPING ON LANDING AT ALL OUTSWINGING EXTERIOR DOORS U.N.O. PAINT EXTERIOR DOOR FACE, FRAME EXTERIOR AND INTERIOR JAMB TO FACE OF DOOR STOP. APPLY RESTROOM IDENTIFICATION DOOR SIGNAGE ON EXTERIOR AND INTERIOR WHERE DOORS ARE PROPPED OPEN. SEE 1/A-201.



EXISTING CLASSROOM DOOR, PAINT WARNING STRIPING ON LANDING AT ALL OUTSWINGING EXTERIOR DOORS U.N.O., REMOVE AND REPLACE TRANSOM DOOR LOUVERS AND INFILL WITH 2x LUMBER, INSULTATION, AND GYPSUM SHEATHING, PAINT ENTIRE DOOR AND FRAME COLOR 2

HARTMANNARCHITECTURESTUDIO.COM 430 S. CARRILLO RD. OJAI, CALIFORNIA 93023 (805) 530-5559

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AGENCY APPROVAL:

SEALS:



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OWNER:

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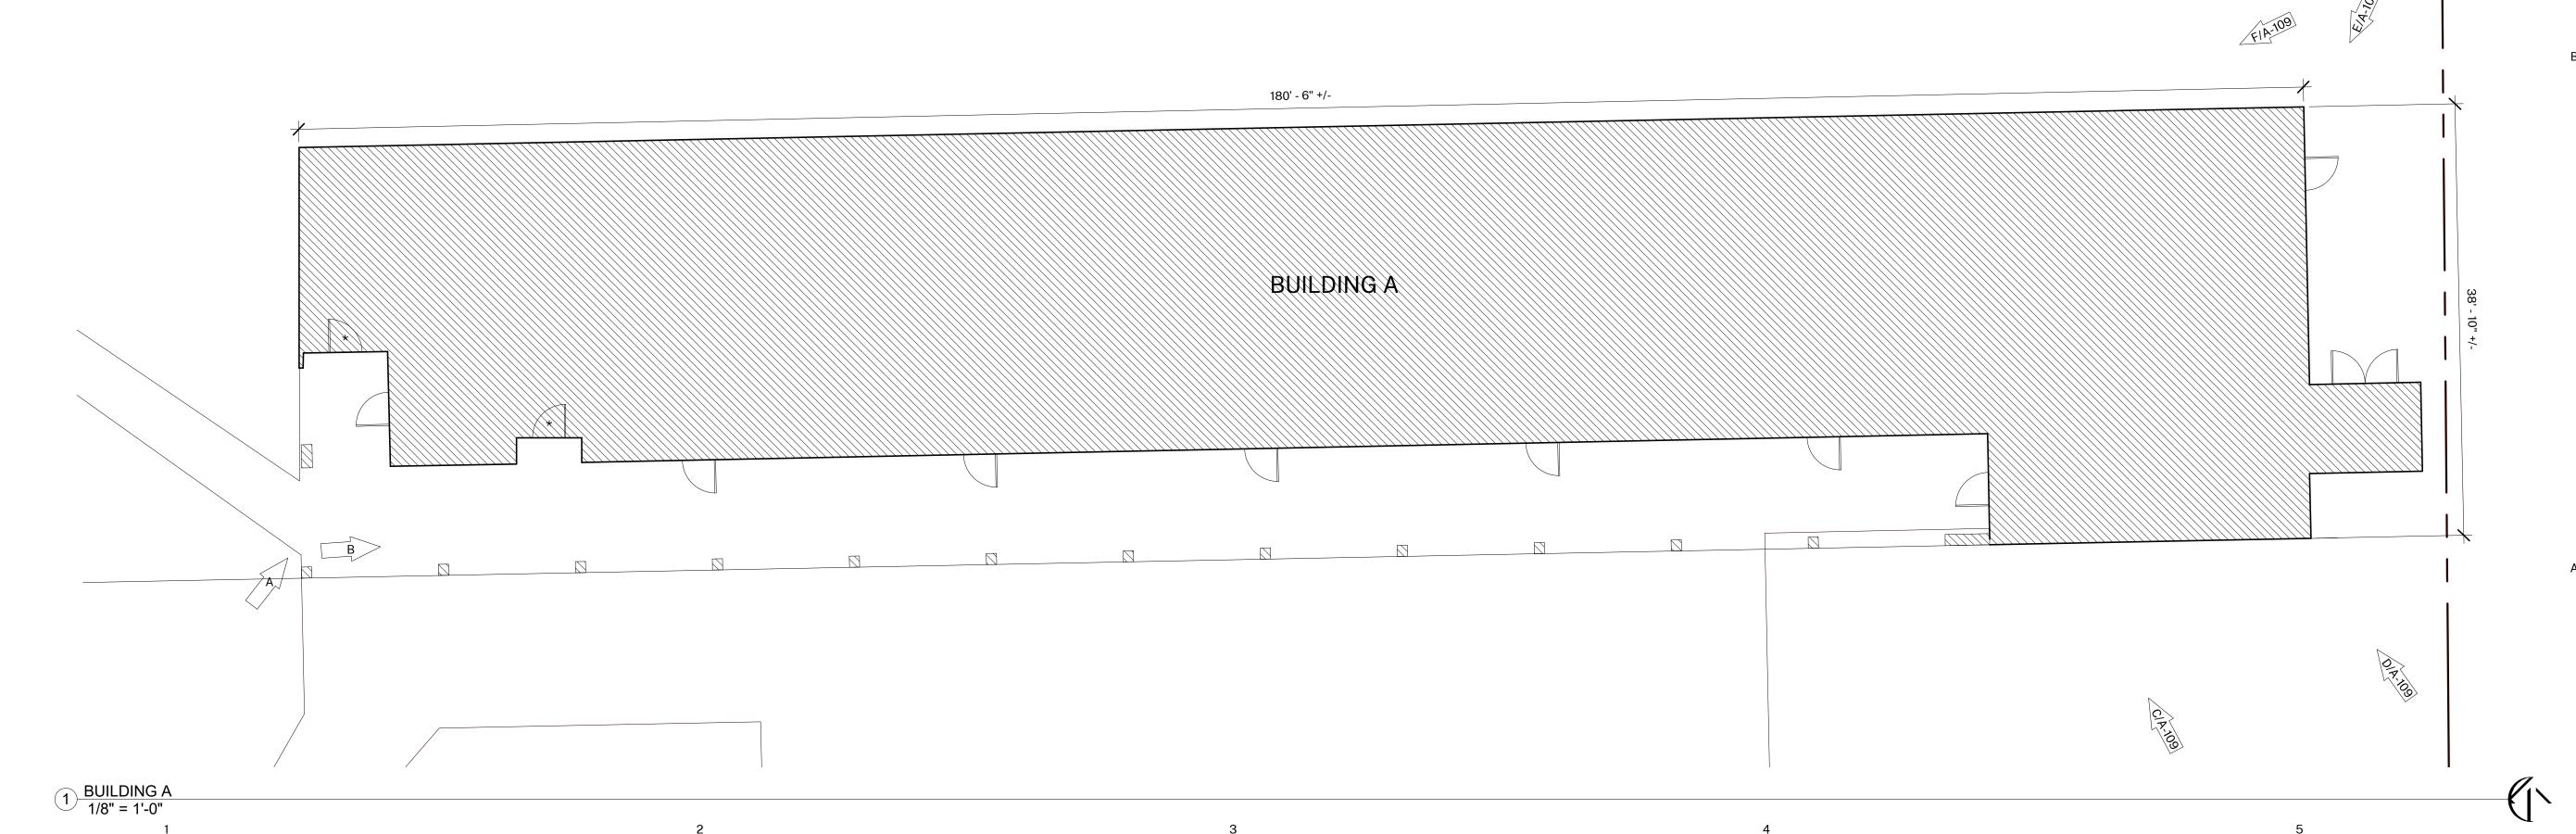
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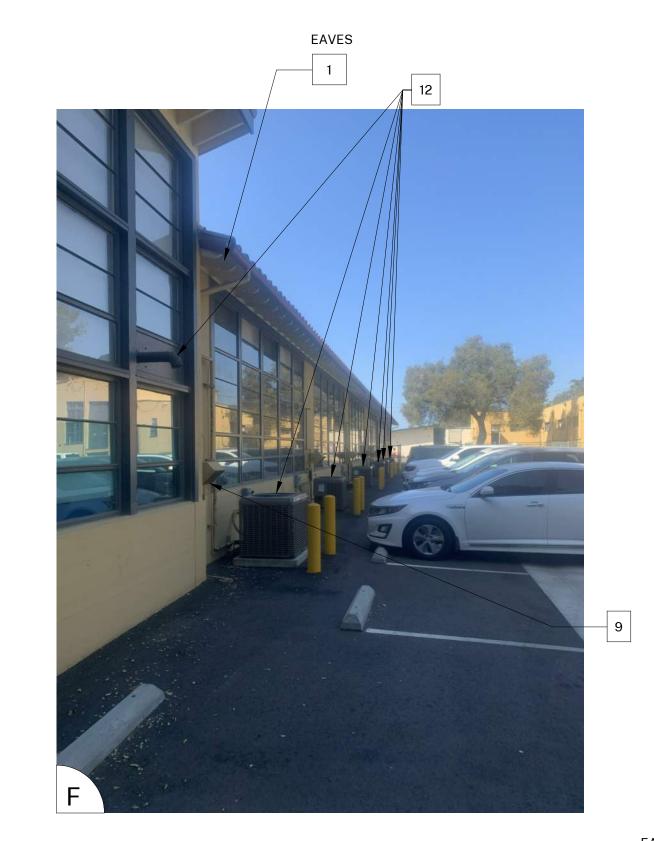
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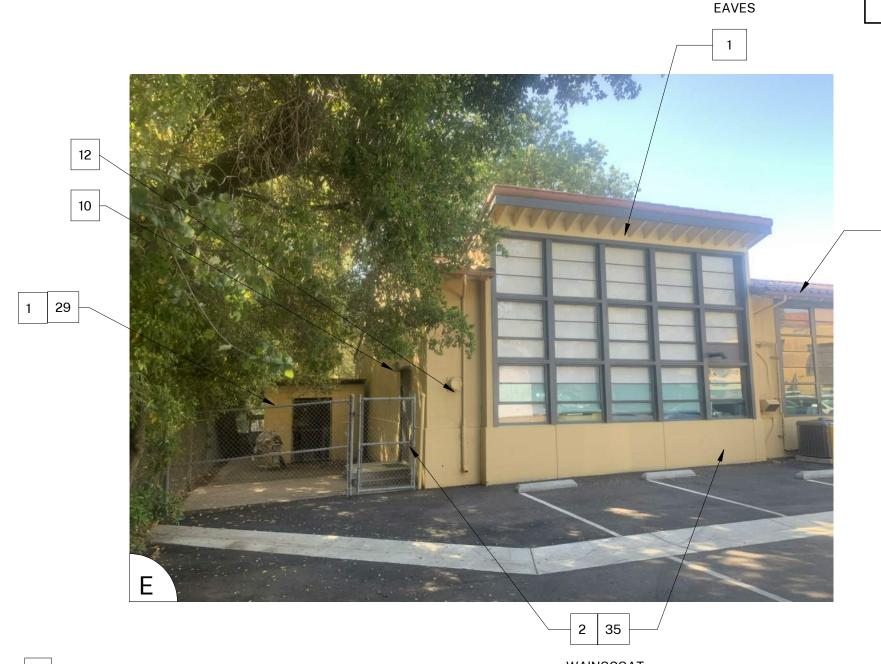
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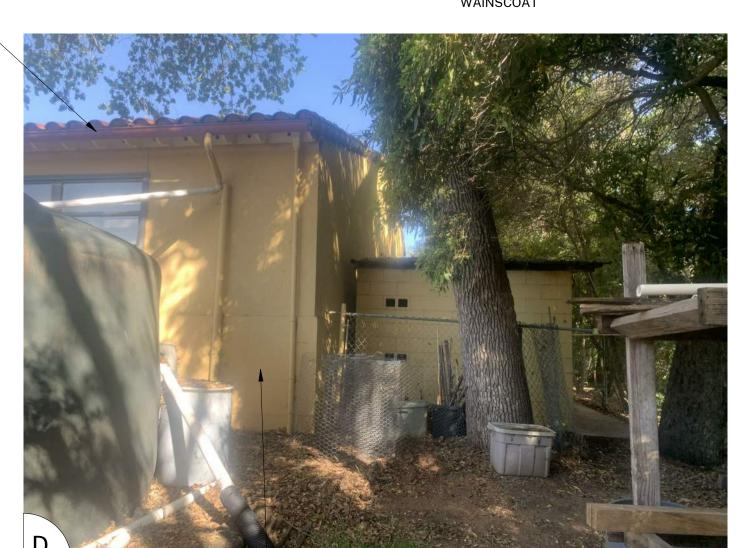
A-108

BUILDING A









2 35 WAINSCOAT

NOTE: NOT ALL KEYNOTES **SHEET KEYNOTES** USED ON EVERY SHEET

 PAINT COLOR 1 2. PAINT COLOR 2

3. PAINT COLOR 3

4. PAINT COLOR 4

5. REMOVE / PAINT WALL / REINSTALL: EXISTING SIGN 6. PROTECT IN PLACE: EXISTING SECURITY CAMERA TYPICAL AT ALL LOCATIONS

7. PREP / PAINT: UTILITY CONDUITS, CABINETS & HVAC TO MATCH WALL BEYOND. 8. PREP / PAINT: EXISTING SIGNAGE IN PLACE

9. PREP / PAINT: EXISTING LOUVERS AND/OR VENTS, TYPICAL 10. REMOVE / PAINT WALL / REINSTALL: LIGHT FIXTURE ESCUTCHEON PLATE OR LIGHT FIXTURE ITSELF TO WALL SURFACE BEHIND. TYPICAL AT ALL LIGHT FIXTURES U.N.O. 11. PREP / PAINT: EXISTING GUTTERS AND DOWNSPOUTS. PAINT COLOR 4

12. PROTECT IN PLACE: EXISTING GUTTERS AND LEADERHEADS 13. PROTECT IN PLACE: EXISTING LIGHT FIXTURE / SPEAKER / FIRE ALARM DEVICE

14. PREP / PAINT: EXISTING HVAC DUCTWORK WHERE ALREADY PAINTED. 15. PROTECT IN PLACE: EXISTING MURAL. PAINT WALLS AROUND MURAL TO MATCH EXISTING BUILDING COLOR SCHEME. TOUCH-UP/REPAINT MURALS WHERE PAINTED

TO MATCH EXISTING. 16. PROTECT IN PLACE: EXISTING DRINKING FOUNTAIN 17. PREP / PAINT: EXISTING PAINTED DRINKING FOUNTAIN CANE DETECTION RAILS

18. PREP/STAIN/SEAL: EXISTING WOOD DISPLAY CASES, FIELD VERIFY STAIN COLOR + SEALER SHEEN 19. REMOVE / DISCARD: EXISTING SIGN 20. REMOVE / SALVAGE TO ARCHITECT: EXISTING SIGN

21. REMOVE ACCESSIBLE SIGN / PAINT WALL / REINSTALL 22. PROTECT IN PLACE: EXISTING CONCRETE, CMU OR TILE 23. PREP / PAINT: EXISTING CONCRETE / CMU WALL

24. PREP / PAINT: EXISTING METAL FENCE & GATE 25. PROTECT IN PLACE: EXISTING MECHANICAL EQUIPMENT 26. PREP / PAINT: EXISTING ROLL-UP DOOR

27. PREP / PAINT: EXISTING STORAGE CONTAINER, ALL SIDES AND TOP, PAINT COLOR 2 28. PREP / PAINT: EXISTING WOOD BENCH / SEATS AND SLEEERS.

29. PREP / PAINT: EXISTING CMU WALLS. PAINT INSIDE AND OUTSIDE OF ENCLOSURE AND DOORS. 30. PREP / PRIME / PAINT: PAVILION PLASTERED SURFACES & EAVES

31. PREP / PAINT: EXISTING DOOR OR WINDOW METAL SECURITY GRATING

32. PATCH / REPAIR / PREP / PRIME / PAINT: EXISTING PLASTER, SEE 1&3/A-201 33. PREP / PAINT: METAL PARAPET WALL CAP 34. PREP / PAINT: PLASTERED ROOF TOP EQUIPMENT SCREEN WALLS INSIDE AND OUT

35. CONTINUE WAINSCOAT AROUND ENTIRE PERIMETER OF BUILDING INCLUDING RECESSED DOOR AND WINDOW RETURNS 36. PREP / PAINT: EXISTING RAIL

37. REMOVE / REPLACE CEILING LIGHTS, OWNER PROVIDED 38. EXISTING MURAL, PAINT OVER MURAL 39. REMOVE AND REPLACE EXISTING EQUIPMENT CLOSET DOOR, FRAME, HARDWARE

AND LOUVER, PAINT COLOR 2 40. PROTECT IN PLACE: EXISTING SIGN/PLAQUE 41. REMOVE EXISTING STRUCTURE

42. PREP/PAINT SAFETY YELLOW 43. REMOVE/PAINT/REINSTALL EQUIPMENT 44. REPAIR/REPLACE/PAINT: DAMAGED WOOD EAVE

45. PREP/PAINT: EXISTING WINDOW FRAMES & MUNTINS

46. REMOVE/DISCARD AS NOTED 47. PROTECT IN PLACE AS NOTED

GENERAL NOTES

1. BUILDING PLANS ARE SCHEMATIC TO ONLY SHOW APPROXIMATE OVERALL BUILDING DIMENSIONS, DOOR QUANTITIES AND APPROXIMATE DOOR LOCATIONS AND ARE PROVIDED AS A CONVENIENCE FOR BIDDING. FIELD VERIFY CONDITIONS PRIOR TO BID. REFER TO SHEET KEYNOTES, PHOTOS, AND LEGENDS FOR ADDITIONAL INFORMATION.

2. ALL EXISTING PAINTED EXTERIOR WALLS OF BUILDING, PAINTED ROOF EAVES, OVERHANGS, CONDUITS, CABINTES, LOUVERS, VENTS, DUCTS AND ROOF EAVES AND GABLES INCLUDED IN THE SCOPE OF WORK ARE TO BE REPAINTED COLORS AS LISTED AND AS DETAILED IN THESE DRAWINGS AND SPECIFICATIONS UNLESS

NOTED OTHERWISE. 3. ALL EXISTING UNPAINTED EXTERIOR SURFACES ARE TO REMAIN UNPAINTED UNLESS NOTED OTHERWISE. PROTECT IN PLACE ALL UNPAINTED SURFACES. 4. CAREFULLY PRUNE SHRUBS AND PLANTS AND REMOVE WEEDS AND PLANTINGS AT

BASE OF WALL TO BARE EARTH TO ALLOW FOR COMPLETE WALL COVERAGE. 5. EXISTING PAINTED DOORS, DOOR FRAMES, DOOR TRIM, WINDOW FRAMES, MULLIONS, AND SEALANTS TO REMAIN UNLESS NOTED OTHERWISE. DO NOT PAINT ALUMINUM WINDOWS. PROTECT IN PLACE.

6. TYPICAL WORK AT EXISTING SIGNS TO REMAIN: REMOVE SIGN, PAINT BEHIND SIGN, CLEAN SIGN, REINSTALL SIGN UNLESS NOTED OTHERWISE.

COLOR LEGEND AND NOTES

COLOR 1 - SWISS COFFEE DUNN EDWARDS DEW341 COLOR 2 - ROYAL GREY DUNN EDWARDS, MATCH EXISTING COLOR 3 - WILD CURRANT SHERWIN WILLIAMS SW7583

COLOR 4 - MATCH TERRA COTTA ROOF TILE, FIELD VERIFY

1. PHOTOS WITH KEYNOTES ARE CREATED ELECTRONICALLY AND ARE INTENDED TO BE VIEWED IN COLOR TO SEE LOCATIONS OF COLORS ON THE BUILDINGS. CONTRACTOR SHALL FIELD VERIFY ACTUAL LOCATIONS AND DIMENSIONS OF COLORS PRIOR TO BID.

SYMBOL LEGEND



EXISTING DOOR: FIELD VERIFY SIZES AND CONDITIONS, PAINT DOOR WARNING STRIPING ON LANDING AT ALL OUTSWINGING EXTERIOR DOORS U.N.O.



EXISTING RESTROOM DOOR: FIELD VERIFY SIZES AND CONDITIONS, PAINT DOOR WARNING STRIPING ON LANDING AT ALL OUTSWINGING EXTERIOR DOORS U.N.O. PAINT EXTERIOR DOOR FACE, FRAME EXTERIOR AND INTERIOR JAMB TO FACE OF DOOR STOP. APPLY RESTROOM IDENTIFICATION DOOR SIGNAGE ON EXTERIOR AND INTERIOR WHERE DOORS ARE PROPPED OPEN. SEE 1/A-201.



EXISTING CLASSROOM DOOR, PAINT WARNING STRIPING ON LANDING AT ALL OUTSWINGING EXTERIOR DOORS U.N.O., REMOVE AND REPLACE TRANSOM DOOR LOUVERS AND INFILL WITH 2x LUMBER, INSULTATION, AND GYPSUM SHEATHING, PAINT ENTIRE DOOR AND FRAME COLOR 2



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CONSULTANTS:

AGENCY APPROVAL:



MATILIJA MS CAMPUS -WIDE EXTERIOR PAINTING

OWNER:

ISSUE:

OJAI UNIFIED SCHOOL DISTRICT 414 EAST OJAI AVENUE OJAI, CA 93023 (805) 640-4300 CONTACT: ADAM DUTTER EMAIL: adutter@ojaiusd.org

PROJECT ADDRESS:

MATILIJA MIDDLE SCHOOL 703 EL PASEO ROAD OJAI, CA 93023

OJAI USD PROJECT NO.: 2021-1600

MARK DESCRIPTION PROJECT INFORMATION: PROJECT NUMBER: 2021.010 PROJECT PHASE:

DRAWN BY: REVIEWED BY:

THE ORIGINAL SIZE OF THIS SHEET IS 36"x24". IF THE CURRENT SIZE IS OTHER THAN 36"x24", THEN ADJUST THE SCALE OF THE DRAWINGS ACCORDINGLY. SHEET TITLE:

BUILDING A

A-109

SHEET NUMBER:

TYP COLUMNS THIS WING 3



BUILDING G [/] 1/8" = 1'-0"

GENERAL NOTES

1. BUILDING PLANS ARE SCHEMATIC TO ONLY SHOW APPROXIMATE OVERALL BUILDING DIMENSIONS, DOOR QUANTITIES AND APPROXIMATE DOOR LOCATIONS AND ARE PROVIDED AS A CONVENIENCE FOR BIDDING. FIELD VERIFY CONDITIONS PRIOR TO BID. REFER TO SHEET KEYNOTES, PHOTOS, AND LEGENDS FOR ADDITIONAL INFORMATION.

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COLOR LEGEND AND NOTES

COLOR 1 - SWISS COFFEE **DUNN EDWARDS DEW341** COLOR 2 - ROYAL GREY DUNN EDWARDS, MATCH EXISTING

COLOR 3 - WILD CURRANT SHERWIN WILLIAMS SW7583

COLOR 4 - MATCH TERRA COTTA ROOF TILE, FIELD VERIFY

1. PHOTOS WITH KEYNOTES ARE CREATED ELECTRONICALLY AND ARE INTENDED TO BE VIEWED IN COLOR TO SEE LOCATIONS OF COLORS ON THE BUILDINGS. CONTRACTOR SHALL FIELD VERIFY ACTUAL LOCATIONS AND DIMENSIONS OF COLORS PRIOR TO BID.

SHEET KEYNOTES

NOTE: NOT ALL KEYNOTES

USED ON EVERY SHEET

1. PAINT COLOR 1 2. PAINT COLOR 2

3. PAINT COLOR 3

4. PAINT COLOR 4

5. REMOVE / PAINT WALL / REINSTALL: EXISTING SIGN

6. PROTECT IN PLACE: EXISTING SECURITY CAMERA TYPICAL AT ALL LOCATIONS

7. PREP / PAINT: UTILITY CONDUITS, CABINETS & HVAC TO MATCH WALL BEYOND. 8. PREP / PAINT: EXISTING SIGNAGE IN PLACE

9. PREP / PAINT: EXISTING LOUVERS AND/OR VENTS, TYPICAL

10. REMOVE / PAINT WALL / REINSTALL: LIGHT FIXTURE ESCUTCHEON PLATE OR LIGHT FIXTURE ITSELF TO WALL SURFACE BEHIND. TYPICAL AT ALL LIGHT FIXTURES U.N.O.

11. PREP / PAINT: EXISTING GUTTERS AND DOWNSPOUTS. PAINT COLOR 4 12. PROTECT IN PLACE: EXISTING GUTTERS AND LEADERHEADS

13. PROTECT IN PLACE: EXISTING LIGHT FIXTURE / SPEAKER / FIRE ALARM DEVICE 14. PREP / PAINT: EXISTING HVAC DUCTWORK WHERE ALREADY PAINTED. 15. PROTECT IN PLACE: EXISTING MURAL. PAINT WALLS AROUND MURAL TO MATCH

EXISTING BUILDING COLOR SCHEME. TOUCH-UP/REPAINT MURALS WHERE PAINTED

TO MATCH EXISTING. 16. PROTECT IN PLACE: EXISTING DRINKING FOUNTAIN

17. PREP / PAINT: EXISTING PAINTED DRINKING FOUNTAIN CANE DETECTION RAILS 18. PREP/STAIN/SEAL: EXISTING WOOD DISPLAY CASES, FIELD VERIFY STAIN COLOR +

SEALER SHEEN

19. REMOVE / DISCARD: EXISTING SIGN 20. REMOVE / SALVAGE TO ARCHITECT: EXISTING SIGN

21. REMOVE ACCESSIBLE SIGN / PAINT WALL / REINSTALL

22. PROTECT IN PLACE: EXISTING CONCRETE, CMU OR TILE 23. PREP / PAINT: EXISTING CONCRETE / CMU WALL

24. PREP / PAINT: EXISTING METAL FENCE & GATE

25. PROTECT IN PLACE: EXISTING MECHANICAL EQUIPMENT

26. PREP / PAINT: EXISTING ROLL-UP DOOR 27. PREP / PAINT: EXISTING STORAGE CONTAINER, ALL SIDES AND TOP, PAINT COLOR 2

28. PREP / PAINT: EXISTING WOOD BENCH / SEATS AND SLEEERS. 29. PREP / PAINT: EXISTING CMU WALLS. PAINT INSIDE AND OUTSIDE OF ENCLOSURE

AND DOORS. 30. PREP / PRIME / PAINT: PAVILION PLASTERED SURFACES & EAVES

31. PREP / PAINT: EXISTING DOOR OR WINDOW METAL SECURITY GRATING

32. PATCH / REPAIR / PREP / PRIME / PAINT: EXISTING PLASTER, SEE 1&3/A-201

33. PREP / PAINT: METAL PARAPET WALL CAP 34. PREP / PAINT: PLASTERED ROOF TOP EOUIPMENT SCREEN WALLS INSIDE AND OUT

35. CONTINUE WAINSCOAT AROUND ENTIRE PERIMETER OF BUILDING INCLUDING RECESSED DOOR AND WINDOW RETURNS 36. PREP / PAINT: EXISTING RAIL

37. REMOVE / REPLACE CEILING LIGHTS, OWNER PROVIDED 38. EXISTING MURAL, PAINT OVER MURAL

39. REMOVE AND REPLACE EXISTING EQUIPMENT CLOSET DOOR, FRAME, HARDWARE

AND LOUVER, PAINT COLOR 2 40. PROTECT IN PLACE: EXISTING SIGN/PLAQUE


41. REMOVE EXISTING STRUCTURE 42. PREP/PAINT SAFETY YELLOW

43. REMOVE/PAINT/REINSTALL EQUIPMENT


44. REPAIR/REPLACE/PAINT: DAMAGED WOOD EAVE 45. PREP/PAINT: EXISTING WINDOW FRAMES & MUNTINS

46. REMOVE/DISCARD AS NOTED 47. PROTECT IN PLACE AS NOTED


SYMBOL LEGEND

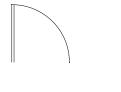

EXISTING DOOR: FIELD VERIFY SIZES AND CONDITIONS, PAINT DOOR WARNING STRIPING ON LANDING AT ALL OUTSWINGING EXTERIOR DOORS U.N.O.

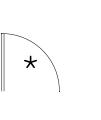

EXISTING RESTROOM DOOR: FIELD VERIFY SIZES AND CONDITIONS, PAINT DOOR WARNING STRIPING ON LANDING AT ALL OUTSWINGING EXTERIOR DOORS U.N.O. PAINT EXTERIOR DOOR FACE, FRAME EXTERIOR AND INTERIOR JAMB TO FACE OF DOOR STOP. APPLY RESTROOM IDENTIFICATION DOOR SIGNAGE ON EXTERIOR AND INTERIOR WHERE DOORS ARE PROPPED OPEN. SEE

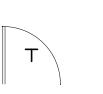

EXISTING CLASSROOM DOOR, PAINT WARNING STRIPING ON LANDING AT ALL OUTSWINGING EXTERIOR DOORS U.N.O., REMOVE AND REPLACE TRANSOM DOOR LOUVERS AND INFILL WITH 2x LUMBER, INSULTATION, AND GYPSUM SHEATHING, PAINT ENTIRE DOOR AND FRAME COLOR 2

HARTMANNARCHITECTURESTUDIO.COM 430 S. CARRILLO RD. OJAI, CALIFORNIA 93023 (805) 530-5559

CONSULTANTS:

AGENCY APPROVAL:

SEALS:



MATILIJA MS CAMPUS -WIDE EXTERIOR PAINTING

OWNER:

OJAI UNIFIED SCHOOL DISTRICT 414 EAST OJAI AVENUE OJAI, CA 93023 (805) 640-4300 **CONTACT: ADAM DUTTER** EMAIL: adutter@ojaiusd.org

PROJECT ADDRESS:

MATILIJA MIDDLE SCHOOL 703 EL PASEO ROAD OJAI, CA 93023

OJAI USD PROJECT NO.: 2021-1600

ISSUE: MARK DATE DESCRIPTION

PROJECT INFORMATION:

PROJECT NUMBER: PROJECT PHASE:

DRAWN BY: REVIEWED BY:

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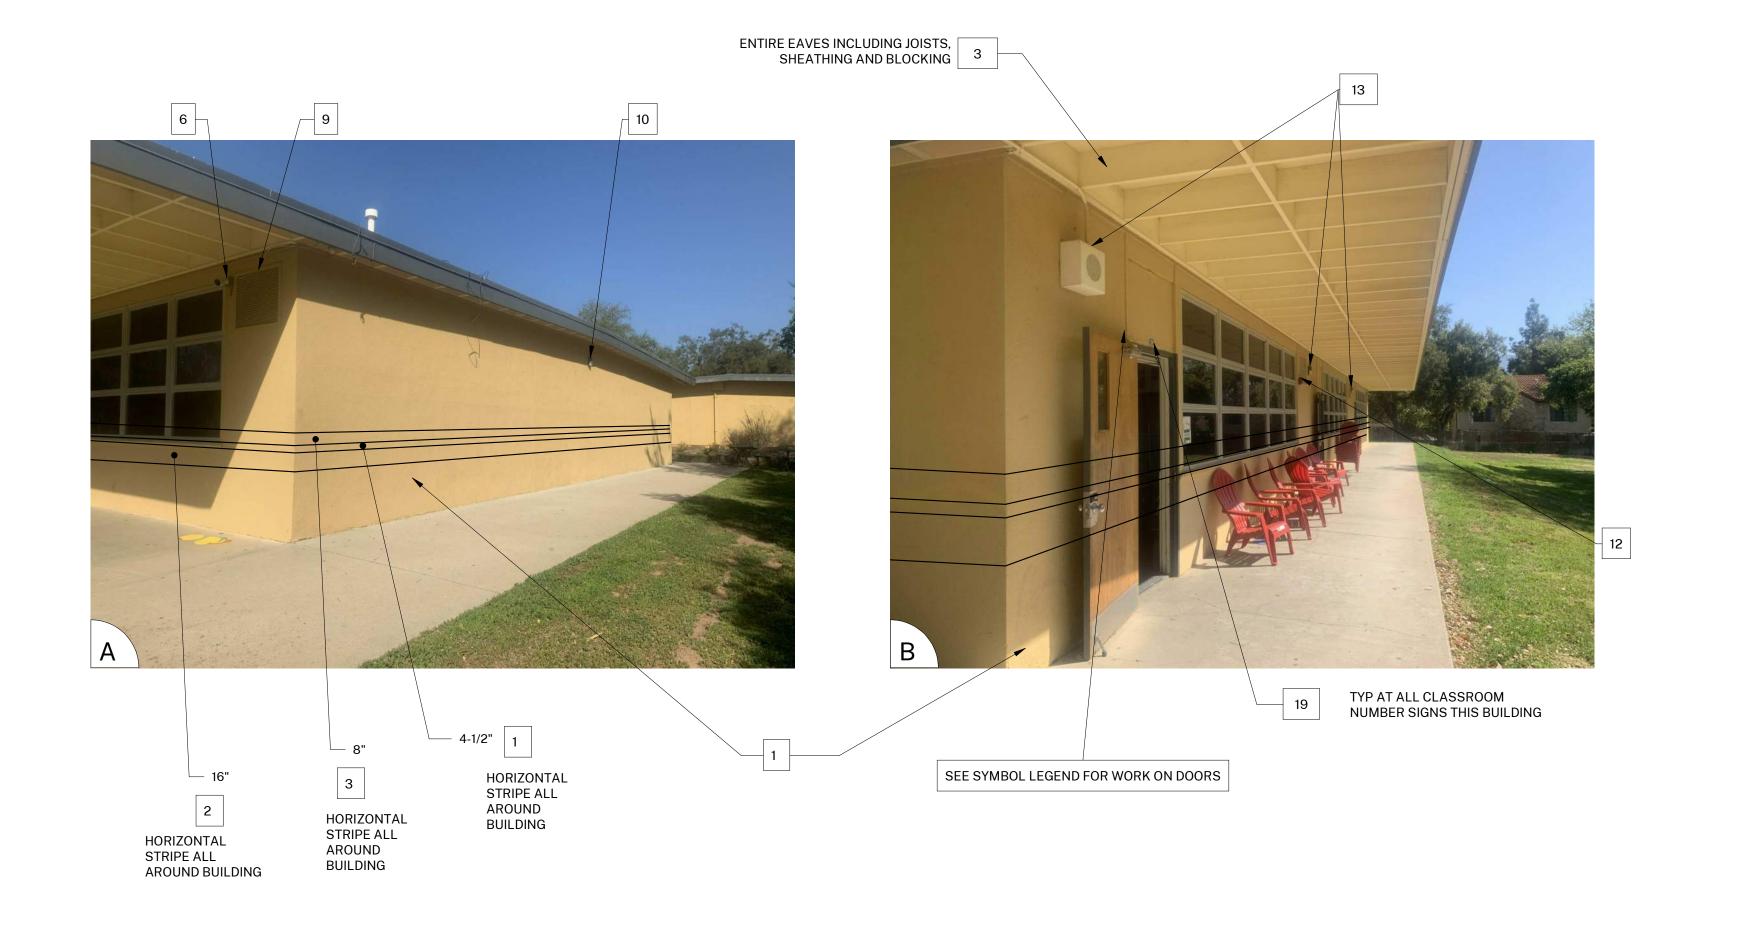
SHEET TITLE:

BUILDING G

2021.010

SHEET NUMBER:

A-110





1. BUILDING PLANS ARE SCHEMATIC TO ONLY SHOW APPROXIMATE OVERALL BUILDING DIMENSIONS, DOOR QUANTITIES AND APPROXIMATE DOOR LOCATIONS AND ARE PROVIDED AS A CONVENIENCE FOR BIDDING. FIELD VERIFY CONDITIONS PRIOR TO BID. REFER TO SHEET KEYNOTES, PHOTOS, AND LEGENDS FOR ADDITIONAL INFORMATION.

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ALUMINUM WINDOWS. PROTECT IN PLACE.

6. TYPICAL WORK AT EXISTING SIGNS TO REMAIN: REMOVE SIGN, PAINT BEHIND SIGN, CLEAN SIGN, REINSTALL SIGN UNLESS NOTED OTHERWISE.

HARIMANN ARCHITECTURE STUDIO

> HARTMANNARCHITECTURESTUDIO.COM 430 S. CARRILLO RD. OJAI, CALIFORNIA 93023 (805) 530-5559

CONSULTANTS:

AGENCY APPROVAL:

COLOR LEGEND AND NOTES

COLOR 1 - SWISS COFFEE DUNN EDWARDS DEW341

COLOR 2 - ROYAL GREY DUNN EDWARDS, MATCH EXISTING

COLOR 3 - WILD CURRANT SHERWIN WILLIAMS SW7583

COLOR 4 - MATCH TERRA COTTA ROOF TILE, FIELD VERIFY

 PHOTOS WITH KEYNOTES ARE CREATED ELECTRONICALLY AND ARE INTENDED TO BE VIEWED IN COLOR TO SEE LOCATIONS OF COLORS ON THE BUILDINGS. CONTRACTOR SHALL FIELD VERIFY ACTUAL LOCATIONS AND DIMENSIONS OF COLORS PRIOR TO BID.

SHEET KEYNOTES

NOTE: NOT ALL KEYNOTES USED ON EVERY SHEET

1. PAINT COLOR 1

2. PAINT COLOR 2

3. PAINT COLOR 3

4. PAINT COLOR 45. REMOVE / PAINT WALL / REINSTALL: EXISTING SIGN

6. PROTECT IN PLACE: EXISTING SECURITY CAMERA TYPICAL AT ALL LOCATIONS
7. PREP / PAINT: UTILITY CONDUITS, CABINETS & HVAC TO MATCH WALL BEYOND.

8. PREP / PAINT: EXISTING SIGNAGE IN PLACE

9. PREP / PAINT: EXISTING LOUVERS AND/OR VENTS, TYPICAL
10. REMOVE / PAINT WALL / REINSTALL: LIGHT FIXTURE ESCUTCHEON P

10. REMOVE / PAINT WALL / REINSTALL: LIGHT FIXTURE ESCUTCHEON PLATE OR LIGHT FIXTURE ITSELF TO WALL SURFACE BEHIND. TYPICAL AT ALL LIGHT FIXTURES U.N.O. 11. PREP / PAINT: EXISTING GUTTERS AND DOWNSPOUTS. PAINT COLOR 4

12. PROTECT IN PLACE: EXISTING GUTTERS AND LEADERHEADS
13. PROTECT IN PLACE: EXISTING LIGHT FIXTURE / SPEAKER / FIRE ALARM DEVICE
14. PREP / PAINT: EXISTING HVAC DUCTWORK WHERE ALREADY PAINTED.
15. PROTECT IN PLACE: EXISTING MURAL. PAINT WALLS AROUND MURAL TO MATCH

EXISTING BUILDING COLOR SCHEME. TOUCH-UP/REPAINT MURALS WHERE PAINTED TO MATCH EXISTING.

16. PROTECT IN PLACE: EXISTING DRINKING FOUNTAIN
17. PREP / PAINT: EXISTING PAINTED DRINKING FOUNTAIN CANE DETECTION RAILS
18. PREP/STAIN/SEAL: EXISTING WOOD DISPLAY CASES, FIELD VERIFY STAIN COLOR + SEALER SHEEN

19. REMOVE / DISCARD: EXISTING SIGN 20. REMOVE / SALVAGE TO ARCHITECT: EXISTING SIGN

21. REMOVE ACCESSIBLE SIGN / PAINT WALL / REINSTALL 22. PROTECT IN PLACE: EXISTING CONCRETE, CMU OR TILE

23. PREP / PAINT: EXISTING CONCRETE / CMU WALL 24. PREP / PAINT: EXISTING METAL FENCE & GATE

25. PROTECT IN PLACE: EXISTING METAL FENCE & GATE

26. PREP / PAINT: EXISTING ROLL-UP DOOR
27. PREP / PAINT: EXISTING STORAGE CONTAINER, ALL SIDES AND TOP, PAINT COLOR 2

28. PREP / PAINT: EXISTING WOOD BENCH / SEATS AND SLEEERS.
29. PREP / PAINT: EXISTING CMU WALLS. PAINT INSIDE AND OUTSIDE OF ENCLOSURE

AND DOORS.

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31. PREP / PAINT: EXISTING DOOR OR WINDOW METAL SECURITY GRATING

32. PATCH / REPAIR / PREP / PRIME / PAINT: EXISTING PLASTER, SEE 1&3/A-201
33. PREP / PAINT: METAL PARAPET WALL CAP
34. PREP / PAINT: PLASTERED ROOF TOP EQUIPMENT SCREEN WALLS INSIDE AND OUT
35. CONTINUE WAINSCOAT AROUND ENTIRE PERIMETER OF BUILDING INCLUDING

RECESSED DOOR AND WINDOW RETURNS 36. PREP / PAINT: EXISTING RAIL 37. REMOVE / REPLACE CEILING LIGHTS, OWNER PROVIDED

37. REMOVE / REPLACE CEILING LIGHTS, OWNER PROVIDED

38. EXISTING MURAL, PAINT OVER MURAL


39. REMOVE AND REPLACE EXISTING EQUIPMENT CLOSET DOOR, FRAME, HARDWARE

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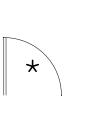
42. PREP/PAINT SAFETY YELLOW
43. REMOVE/PAINT/REINSTALL EQUIPMENT
44. REPAIR/REPLACE/PAINT: DAMAGED WOOD EAVE
45. PREP/PAINT: EXISTING WINDOW FRAMES & MUNTINS

46. REMOVE/DISCARD AS NOTED 47. PROTECT IN PLACE AS NOTED

SYMBOL LEGEND

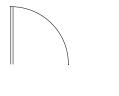

EXISTING DOOR: FIELD VERIFY SIZES AND CONDITIONS, PAINT DOOR WARNING STRIPING ON LANDING AT ALL OUTSWINGING EXTERIOR DOORS U.N.O.



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T

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OJAI UNIFIED SCHOOL DISTRICT 414 EAST OJAI AVENUE OJAI, CA 93023 (805) 640-4300 CONTACT: ADAM DUTTER EMAIL: adutter@ojaiusd.org

MATILIJA MS CAMPUS -

WIDE EXTERIOR PAINTING

PROJECT ADDRESS:
MATILIJA MIDDLE SCHOOL
703 EL PASEO ROAD
OJAI, CA 93023

OWNER:

OJAI USD PROJECT NO.: 2021-1600

MARK	DATE	DESCRIPTION
PROJECT	INFORMATION	N:
PROJECT	NUMBER:	2021.010
DROIFCT	DH V CE.	CD

DRAWN BY:
REVIEWED BY:

THE ORIGINAL SIZE OF THIS SHEET IS 36"x24". IF THE CURRENT SIZE IS OTHER THAN 36"x24", THEN ADJUST THE SCALE OF THE DRAWINGS ACCORDINGLY.

SHEET TITLE:

BUILDING H

SHEET NUMBER:

A-111

DATE: 05/14/21

1 BUILDING H 1/8" = 1'-0"

ENTIRE EAVES INCLUDING JOISTS, SHEATHING AND BLOCKING SEE SYMBOL LEGEND FOR WORK ON DOORS HORIZONTAL 16" 2 HORIZONTAL STRIPE STRIPE ALL ALL AROUND BUILDING AROUND BUILDING HORIZONTAL STRIPE ALL AROUND BUILDING

TYP AT ALL CLASSROOM

SIGNS THIS

NUMBER

BUILDING

GENERAL NOTES

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3. ALL EXISTING UNPAINTED EXTERIOR SURFACES ARE TO REMAIN UNPAINTED UNLESS NOTED OTHERWISE. PROTECT IN PLACE ALL UNPAINTED SURFACES. 4. CAREFULLY PRUNE SHRUBS AND PLANTS AND REMOVE WEEDS AND PLANTINGS AT BASE OF WALL TO BARE EARTH TO ALLOW FOR COMPLETE WALL COVERAGE. 5. EXISTING PAINTED DOORS, DOOR FRAMES, DOOR TRIM, WINDOW FRAMES, MULLIONS, AND SEALANTS TO REMAIN UNLESS NOTED OTHERWISE. DO NOT PAINT ALUMINUM WINDOWS. PROTECT IN PLACE.

6. TYPICAL WORK AT EXISTING SIGNS TO REMAIN: REMOVE SIGN, PAINT BEHIND SIGN, CLEAN SIGN, REINSTALL SIGN UNLESS NOTED OTHERWISE.

COLOR LEGEND AND NOTES

DUNN EDWARDS DEW341 COLOR 1 - SWISS COFFEE COLOR 2 - ROYAL GREY DUNN EDWARDS, MATCH EXISTING COLOR 3 - WILD CURRANT SHERWIN WILLIAMS SW7583

COLOR 4 - MATCH TERRA COTTA ROOF TILE, FIELD VERIFY

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SHEET KEYNOTES

NOTE: NOT ALL KEYNOTES

USED ON EVERY SHEET

3. PAINT COLOR 3

1. PAINT COLOR 1 2. PAINT COLOR 2

4. PAINT COLOR 4

5. REMOVE / PAINT WALL / REINSTALL: EXISTING SIGN

6. PROTECT IN PLACE: EXISTING SECURITY CAMERA TYPICAL AT ALL LOCATIONS

7. PREP / PAINT: UTILITY CONDUITS, CABINETS & HVAC TO MATCH WALL BEYOND. 8. PREP / PAINT: EXISTING SIGNAGE IN PLACE

9. PREP / PAINT: EXISTING LOUVERS AND/OR VENTS, TYPICAL

10. REMOVE / PAINT WALL / REINSTALL: LIGHT FIXTURE ESCUTCHEON PLATE OR LIGHT FIXTURE ITSELF TO WALL SURFACE BEHIND. TYPICAL AT ALL LIGHT FIXTURES U.N.O. 11. PREP / PAINT: EXISTING GUTTERS AND DOWNSPOUTS. PAINT COLOR 4

12. PROTECT IN PLACE: EXISTING GUTTERS AND LEADERHEADS 13. PROTECT IN PLACE: EXISTING LIGHT FIXTURE / SPEAKER / FIRE ALARM DEVICE 14. PREP / PAINT: EXISTING HVAC DUCTWORK WHERE ALREADY PAINTED.

15. PROTECT IN PLACE: EXISTING MURAL. PAINT WALLS AROUND MURAL TO MATCH EXISTING BUILDING COLOR SCHEME. TOUCH-UP/REPAINT MURALS WHERE PAINTED TO MATCH EXISTING.

18. PREP/STAIN/SEAL: EXISTING WOOD DISPLAY CASES, FIELD VERIFY STAIN COLOR +

16. PROTECT IN PLACE: EXISTING DRINKING FOUNTAIN 17. PREP / PAINT: EXISTING PAINTED DRINKING FOUNTAIN CANE DETECTION RAILS

SEALER SHEEN 19. REMOVE / DISCARD: EXISTING SIGN

20. REMOVE / SALVAGE TO ARCHITECT: EXISTING SIGN

21. REMOVE ACCESSIBLE SIGN / PAINT WALL / REINSTALL 22. PROTECT IN PLACE: EXISTING CONCRETE, CMU OR TILE 23. PREP / PAINT: EXISTING CONCRETE / CMU WALL

24. PREP / PAINT: EXISTING METAL FENCE & GATE

25. PROTECT IN PLACE: EXISTING MECHANICAL EQUIPMENT

26. PREP / PAINT: EXISTING ROLL-UP DOOR

27. PREP / PAINT: EXISTING STORAGE CONTAINER, ALL SIDES AND TOP, PAINT COLOR 2

31. PREP / PAINT: EXISTING DOOR OR WINDOW METAL SECURITY GRATING

28. PREP / PAINT: EXISTING WOOD BENCH / SEATS AND SLEEERS. 29. PREP / PAINT: EXISTING CMU WALLS. PAINT INSIDE AND OUTSIDE OF ENCLOSURE

AND DOORS. 30. PREP / PRIME / PAINT: PAVILION PLASTERED SURFACES & EAVES

32. PATCH / REPAIR / PREP / PRIME / PAINT: EXISTING PLASTER, SEE 1&3/A-201 33. PREP / PAINT: METAL PARAPET WALL CAP 34. PREP / PAINT: PLASTERED ROOF TOP EQUIPMENT SCREEN WALLS INSIDE AND OUT 35. CONTINUE WAINSCOAT AROUND ENTIRE PERIMETER OF BUILDING INCLUDING

RECESSED DOOR AND WINDOW RETURNS 36. PREP / PAINT: EXISTING RAIL

37. REMOVE / REPLACE CEILING LIGHTS, OWNER PROVIDED 38. EXISTING MURAL, PAINT OVER MURAL 39. REMOVE AND REPLACE EXISTING EQUIPMENT CLOSET DOOR, FRAME, HARDWARE

AND LOUVER, PAINT COLOR 2 40. PROTECT IN PLACE: EXISTING SIGN/PLAQUE 41. REMOVE EXISTING STRUCTURE

42. PREP/PAINT SAFETY YELLOW 43. REMOVE/PAINT/REINSTALL EQUIPMENT 44. REPAIR/REPLACE/PAINT: DAMAGED WOOD EAVE 45. PREP/PAINT: EXISTING WINDOW FRAMES & MUNTINS


46. REMOVE/DISCARD AS NOTED 47. PROTECT IN PLACE AS NOTED

ENTIRE EAVES INCLUDING JOISTS, SHEATHING AND BLOCKING

HARTMANNARCHITECTURESTUDIO.COM 430 S. CARRILLO RD. OJAI, CALIFORNIA 93023 (805) 530-5559 CONSULTANTS:

AGENCY APPROVAL:

SEALS:

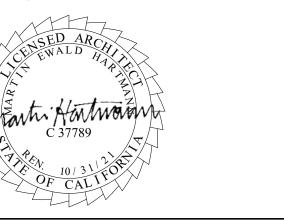

MATILIJA MS CAMPUS -WIDE EXTERIOR PAINTING

OWNER:

OJAI UNIFIED SCHOOL DISTRICT 414 EAST OJAI AVENUE OJAI, CA 93023 (805) 640-4300 CONTACT: ADAM DUTTER EMAIL: adutter@ojaiusd.org

PROJECT ADDRESS:

MATILIJA MIDDLE SCHOOL 703 EL PASEO ROAD OJAI, CA 93023

OJAI USD PROJECT NO.: 2021-1600

ISSUE: MARK DATE DESCRIPTION

2021.010

PBS

PROJECT INFORMATION:

PROJECT NUMBER: PROJECT PHASE: DRAWN BY:


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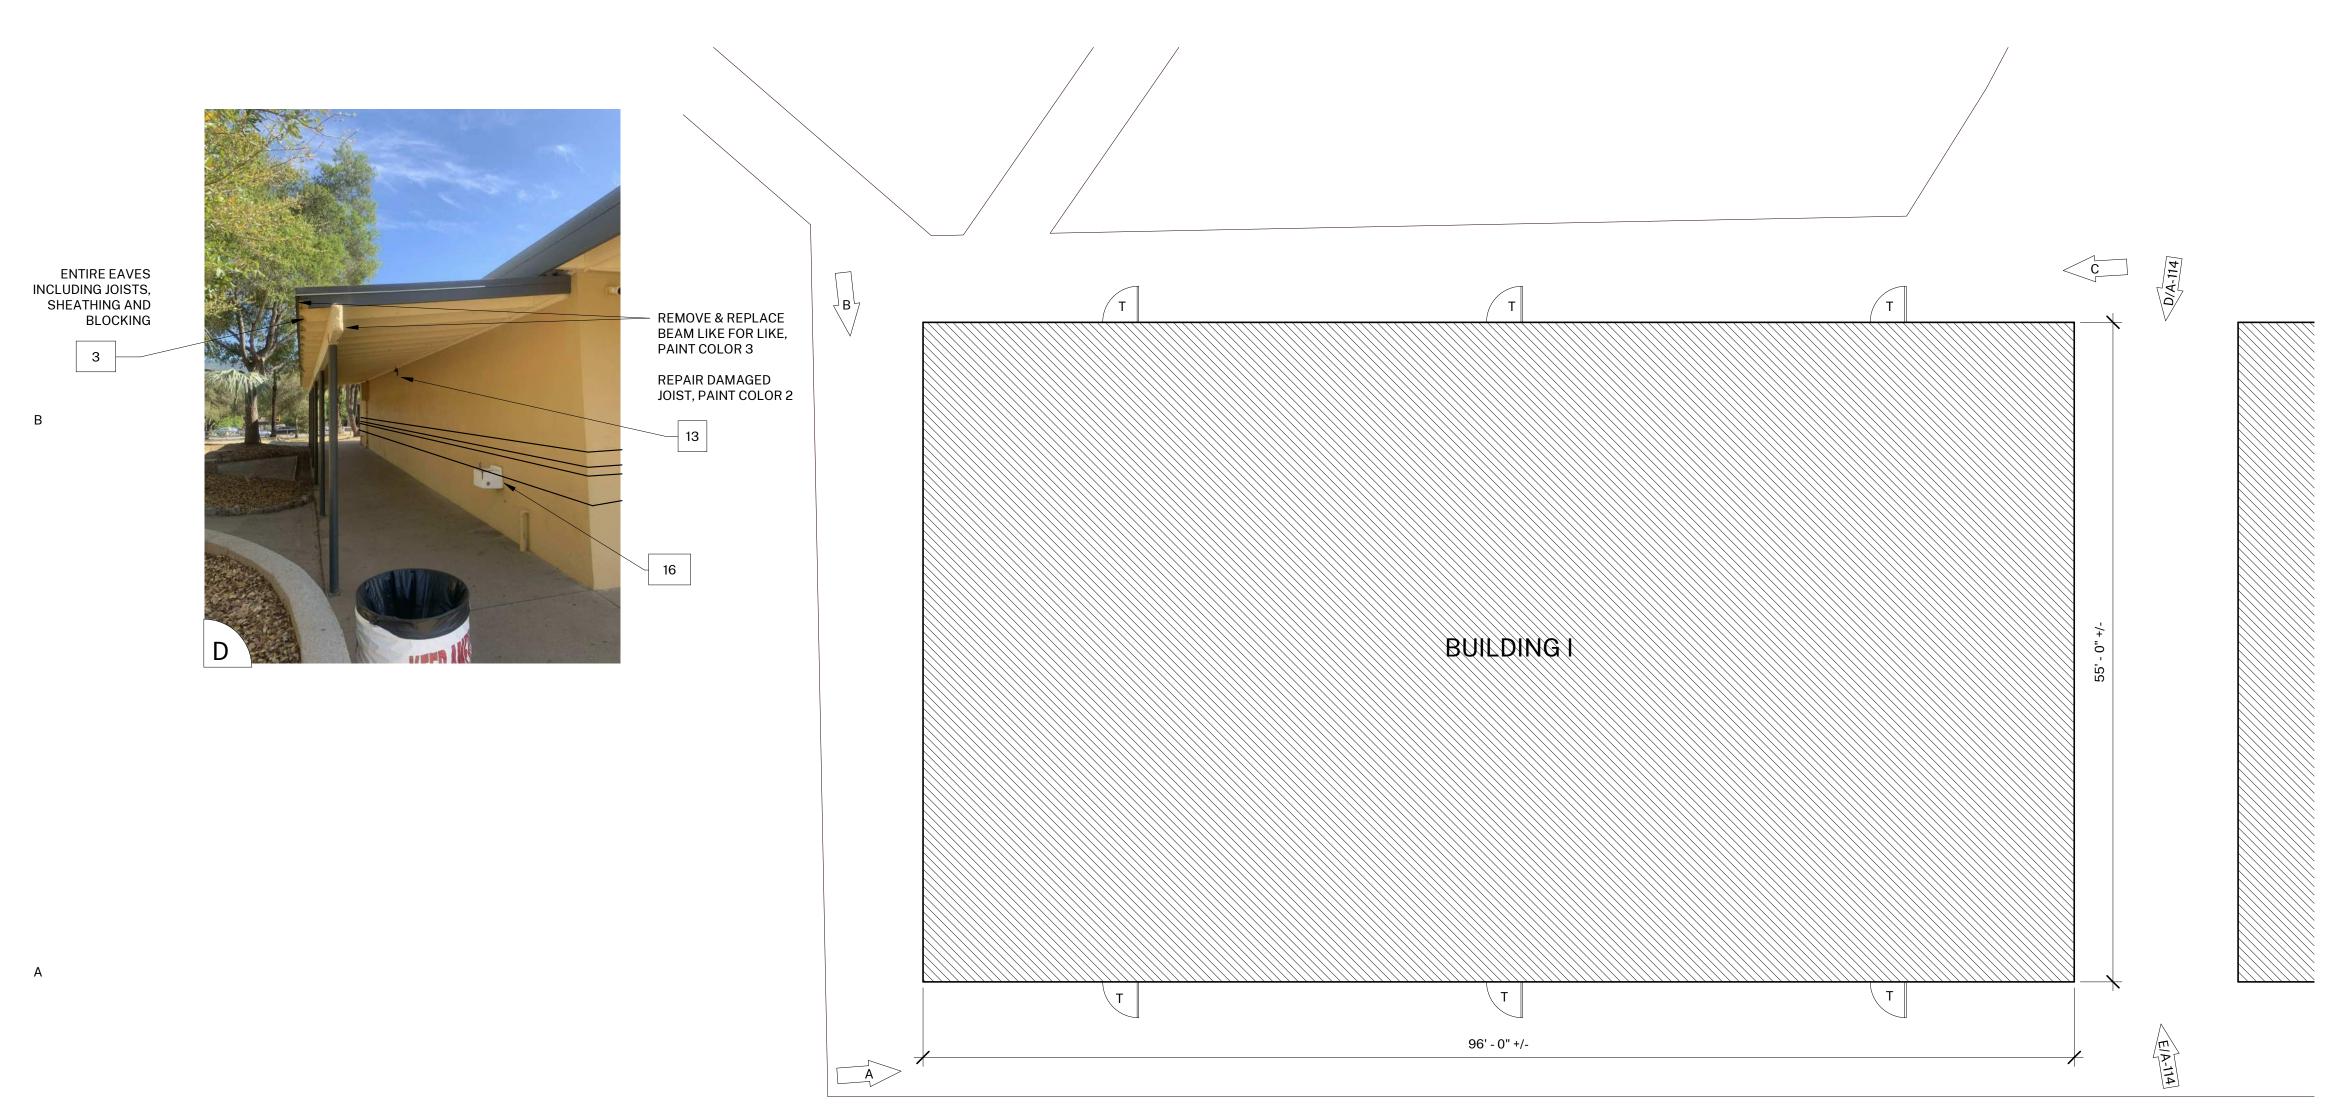
THE ORIGINAL SIZE OF THIS SHEET IS 36"x24". IF THE CURRENT SIZE IS OTHER THAN 36"x24", THEN ADJUST THE SCALE OF THE DRAWINGS ACCORDING! V

SHEET TITLE:

BUILDING H

SHEET NUMBER:



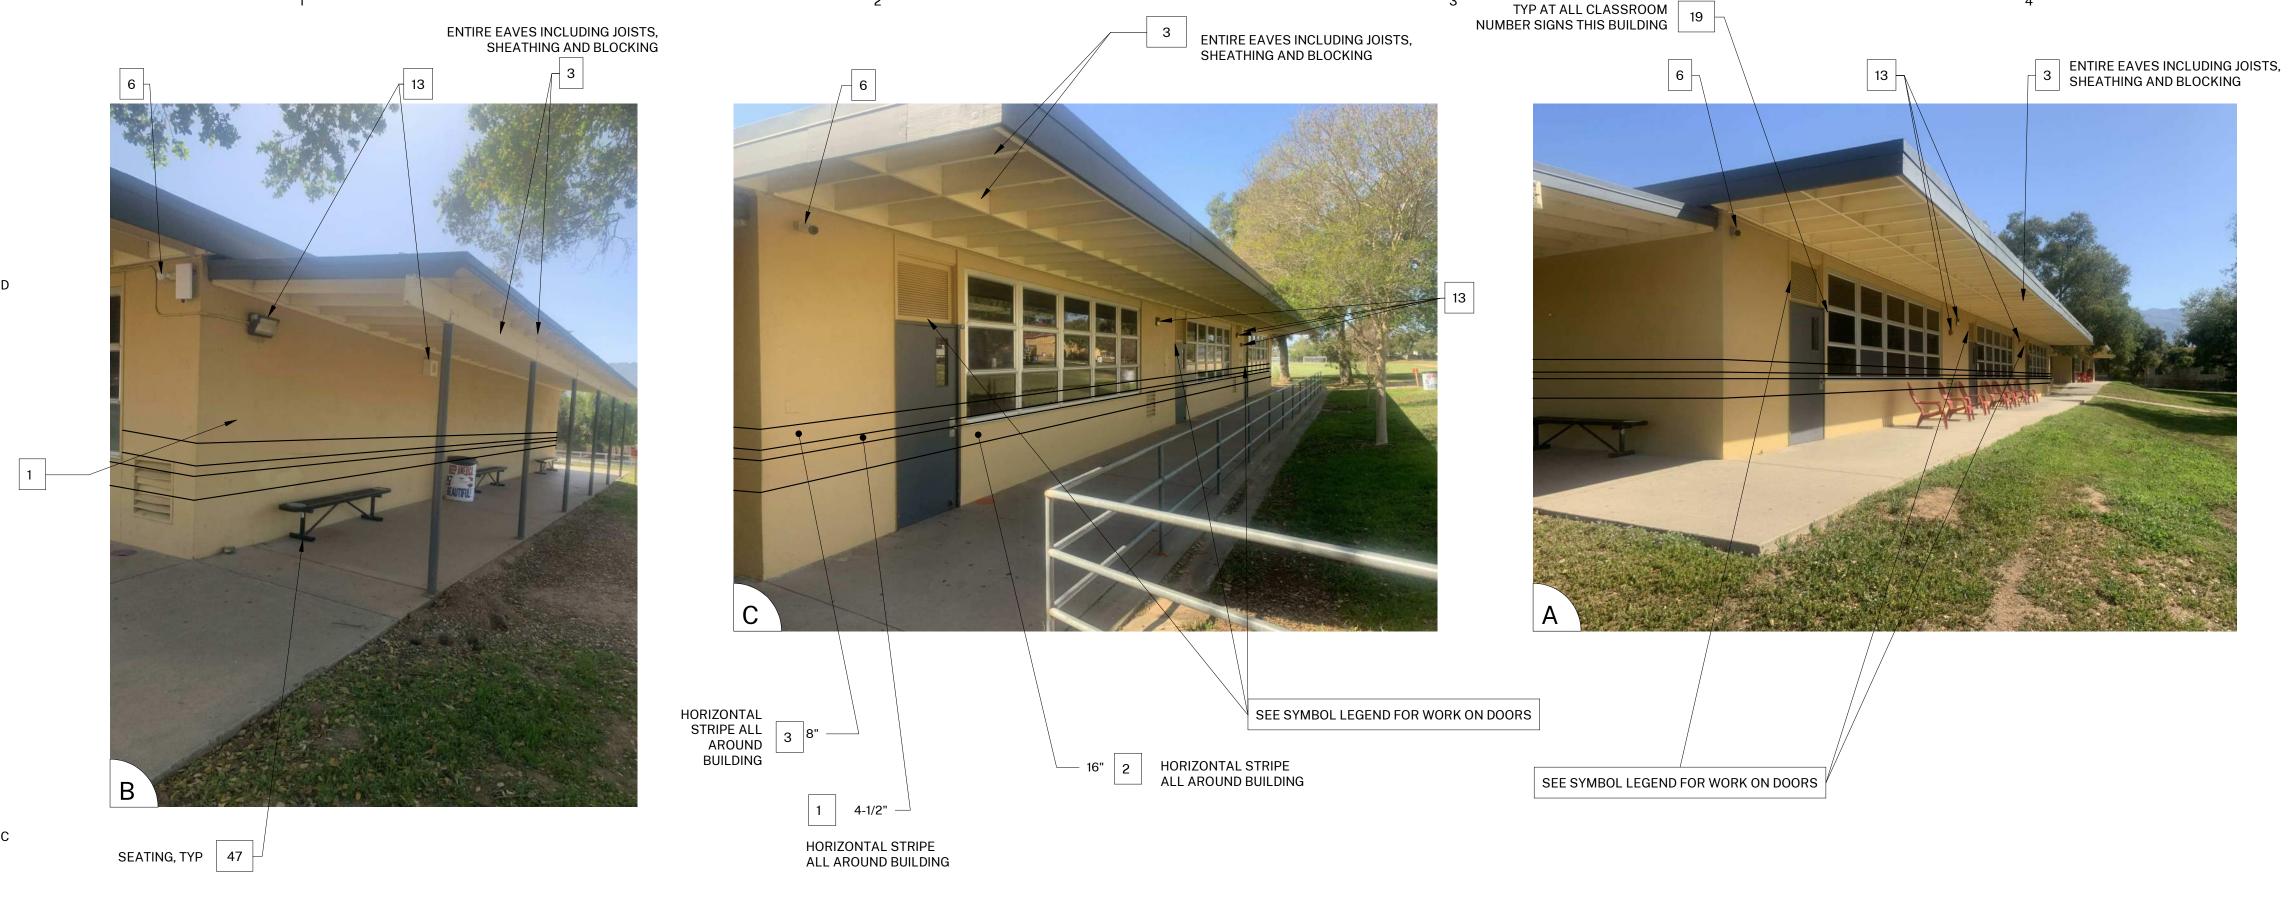

- 1. BUILDING PLANS ARE SCHEMATIC TO ONLY SHOW APPROXIMATE OVERALL BUILDING DIMENSIONS, DOOR QUANTITIES AND APPROXIMATE DOOR LOCATIONS AND ARE PROVIDED AS A CONVENIENCE FOR BIDDING. FIELD VERIFY CONDITIONS PRIOR TO BID. REFER TO SHEET KEYNOTES, PHOTOS, AND LEGENDS FOR ADDITIONAL INFORMATION.
- 2. ALL EXISTING PAINTED EXTERIOR WALLS OF BUILDING, PAINTED ROOF EAVES, OVERHANGS, CONDUITS, CABINTES, LOUVERS, VENTS, DUCTS AND ROOF EAVES AND GABLES INCLUDED IN THE SCOPE OF WORK ARE TO BE REPAINTED COLORS AS LISTED AND AS DETAILED IN THESE DRAWINGS AND SPECIFICATIONS UNLESS NOTED OTHERWISE.
- 3. ALL EXISTING UNPAINTED EXTERIOR SURFACES ARE TO REMAIN UNPAINTED UNLESS NOTED OTHERWISE. PROTECT IN PLACE ALL UNPAINTED SURFACES. 4. CAREFULLY PRUNE SHRUBS AND PLANTS AND REMOVE WEEDS AND PLANTINGS AT BASE OF WALL TO BARE EARTH TO ALLOW FOR COMPLETE WALL COVERAGE. 5. EXISTING PAINTED DOORS, DOOR FRAMES, DOOR TRIM, WINDOW FRAMES, MULLIONS. AND SEALANTS TO REMAIN UNLESS NOTED OTHERWISE, DO NOT PAINT
- ALUMINUM WINDOWS. PROTECT IN PLACE. 6. TYPICAL WORK AT EXISTING SIGNS TO REMAIN: REMOVE SIGN, PAINT BEHIND SIGN, CLEAN SIGN, REINSTALL SIGN UNLESS NOTED OTHERWISE.

COLOR LEGEND AND NOTES

COLOR 1 - SWISS COFFEE **DUNN EDWARDS DEW341** COLOR 2 - ROYAL GREY DUNN EDWARDS, MATCH EXISTING SHERWIN WILLIAMS SW7583

COLOR 3 - WILD CURRANT COLOR 4 - MATCH TERRA COTTA ROOF TILE, FIELD VERIFY

1. PHOTOS WITH KEYNOTES ARE CREATED ELECTRONICALLY AND ARE INTENDED TO BE VIEWED IN COLOR TO SEE LOCATIONS OF COLORS ON THE BUILDINGS. CONTRACTOR SHALL FIELD VERIFY ACTUAL LOCATIONS AND DIMENSIONS OF COLORS PRIOR TO BID.

SHEET KEYNOTES

NOTE: NOT ALL KEYNOTES

USED ON EVERY SHEET

1. PAINT COLOR 1

2. PAINT COLOR 2

3. PAINT COLOR 3 4. PAINT COLOR 4

5. REMOVE / PAINT WALL / REINSTALL: EXISTING SIGN

6. PROTECT IN PLACE: EXISTING SECURITY CAMERA TYPICAL AT ALL LOCATIONS 7. PREP / PAINT: UTILITY CONDUITS, CABINETS & HVAC TO MATCH WALL BEYOND.

8. PREP / PAINT: EXISTING SIGNAGE IN PLACE

9. PREP / PAINT: EXISTING LOUVERS AND/OR VENTS, TYPICAL 10. REMOVE / PAINT WALL / REINSTALL: LIGHT FIXTURE ESCUTCHEON PLATE OR LIGHT FIXTURE ITSELF TO WALL SURFACE BEHIND. TYPICAL AT ALL LIGHT FIXTURES U.N.O.

11. PREP / PAINT: EXISTING GUTTERS AND DOWNSPOUTS. PAINT COLOR 4 12. PROTECT IN PLACE: EXISTING GUTTERS AND LEADERHEADS 13. PROTECT IN PLACE: EXISTING LIGHT FIXTURE / SPEAKER / FIRE ALARM DEVICE

14. PREP / PAINT: EXISTING HVAC DUCTWORK WHERE ALREADY PAINTED. 15. PROTECT IN PLACE: EXISTING MURAL. PAINT WALLS AROUND MURAL TO MATCH EXISTING BUILDING COLOR SCHEME. TOUCH-UP/REPAINT MURALS WHERE PAINTED

TO MATCH EXISTING. 16. PROTECT IN PLACE: EXISTING DRINKING FOUNTAIN

17. PREP / PAINT: EXISTING PAINTED DRINKING FOUNTAIN CANE DETECTION RAILS 18. PREP/STAIN/SEAL: EXISTING WOOD DISPLAY CASES, FIELD VERIFY STAIN COLOR + SEALER SHEEN

19. REMOVE / DISCARD: EXISTING SIGN 20. REMOVE / SALVAGE TO ARCHITECT: EXISTING SIGN

21. REMOVE ACCESSIBLE SIGN / PAINT WALL / REINSTALL 22. PROTECT IN PLACE: EXISTING CONCRETE, CMU OR TILE

23. PREP / PAINT: EXISTING CONCRETE / CMU WALL 24. PREP / PAINT: EXISTING METAL FENCE & GATE

25. PROTECT IN PLACE: EXISTING MECHANICAL EQUIPMENT

26. PREP / PAINT: EXISTING ROLL-UP DOOR

27. PREP / PAINT: EXISTING STORAGE CONTAINER, ALL SIDES AND TOP, PAINT COLOR 2 28. PREP / PAINT: EXISTING WOOD BENCH / SEATS AND SLEEERS.

29. PREP / PAINT: EXISTING CMU WALLS. PAINT INSIDE AND OUTSIDE OF ENCLOSURE AND DOORS. 30. PREP / PRIME / PAINT: PAVILION PLASTERED SURFACES & EAVES

31. PREP / PAINT: EXISTING DOOR OR WINDOW METAL SECURITY GRATING 32. PATCH / REPAIR / PREP / PRIME / PAINT: EXISTING PLASTER, SEE 1&3/A-201 33. PREP / PAINT: METAL PARAPET WALL CAP

34. PREP / PAINT: PLASTERED ROOF TOP EOUIPMENT SCREEN WALLS INSIDE AND OUT 35. CONTINUE WAINSCOAT AROUND ENTIRE PERIMETER OF BUILDING INCLUDING RECESSED DOOR AND WINDOW RETURNS

36. PREP / PAINT: EXISTING RAIL 37. REMOVE / REPLACE CEILING LIGHTS, OWNER PROVIDED

38. EXISTING MURAL, PAINT OVER MURAL 39. REMOVE AND REPLACE EXISTING EQUIPMENT CLOSET DOOR, FRAME, HARDWARE

AND LOUVER, PAINT COLOR 2 40. PROTECT IN PLACE: EXISTING SIGN/PLAQUE 41. REMOVE EXISTING STRUCTURE

42. PREP/PAINT SAFETY YELLOW 43. REMOVE/PAINT/REINSTALL EQUIPMENT

44. REPAIR/REPLACE/PAINT: DAMAGED WOOD EAVE 45. PREP/PAINT: EXISTING WINDOW FRAMES & MUNTINS

46. REMOVE/DISCARD AS NOTED 47. PROTECT IN PLACE AS NOTED

SYMBOL LEGEND

EXISTING DOOR: FIELD VERIFY SIZES AND CONDITIONS, PAINT DOOR WARNING STRIPING ON LANDING AT ALL OUTSWINGING EXTERIOR DOORS U.N.O.

EXISTING RESTROOM DOOR: FIELD VERIFY SIZES AND CONDITIONS, PAINT DOOR WARNING STRIPING ON LANDING AT ALL OUTSWINGING EXTERIOR DOORS U.N.O. PAINT EXTERIOR DOOR FACE, FRAME EXTERIOR AND INTERIOR JAMB TO FACE OF DOOR STOP. APPLY RESTROOM IDENTIFICATION DOOR SIGNAGE ON EXTERIOR AND INTERIOR WHERE DOORS ARE PROPPED OPEN. SEE 1/A-201.

EXISTING CLASSROOM DOOR, PAINT WARNING STRIPING ON LANDING AT ALL OUTSWINGING EXTERIOR DOORS U.N.O., REMOVE AND REPLACE TRANSOM DOOR LOUVERS AND INFILL WITH 2x LUMBER, INSULTATION, AND GYPSUM SHEATHING, PAINT ENTIRE DOOR AND FRAME COLOR 2

HARTMANNARCHITECTURESTUDIO.COM 430 S. CARRILLO RD. OJAI, CALIFORNIA 93023 (805) 530-5559

CONSULTANTS:

AGENCY APPROVAL:

SEALS:



MATILIJA MS CAMPUS -WIDE EXTERIOR PAINTING

OWNER:

OJAI UNIFIED SCHOOL DISTRICT 414 EAST OJAI AVENUE OJAI, CA 93023 (805) 640-4300 **CONTACT: ADAM DUTTER** EMAIL: adutter@ojaiusd.org

PROJECT ADDRESS: MATILIJA MIDDLE SCHOOL 703 EL PASEO ROAD

OJAI, CA 93023

OJAI USD PROJECT NO.: 2021-1600

ISSUE:		
MARK	DATE	DESCRIPTION

PROJECT INFORMATION: PROJECT NUMBER: PROJECT PHASE: DRAWN BY:

REVIEWED BY:

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BUILDING I

2021.010

SHEET NUMBER:

A-113


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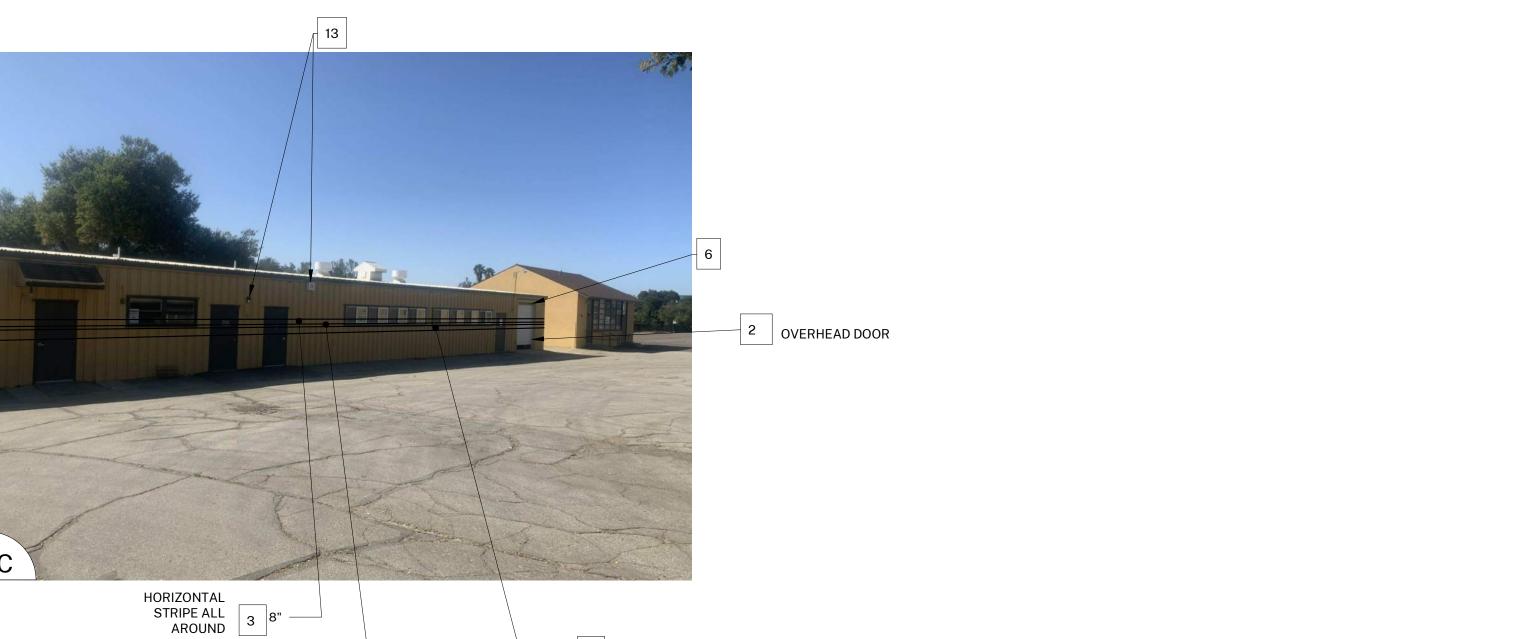
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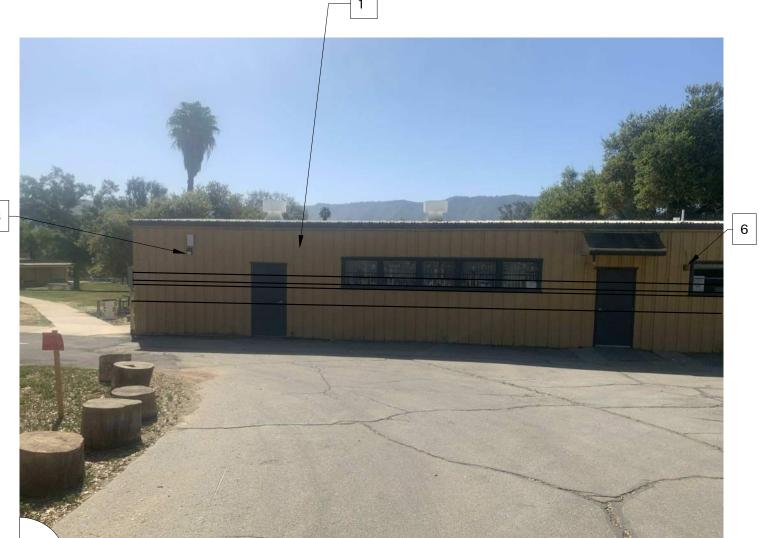


BUILDING

1 BUILDING J 1/8" = 1'-0"





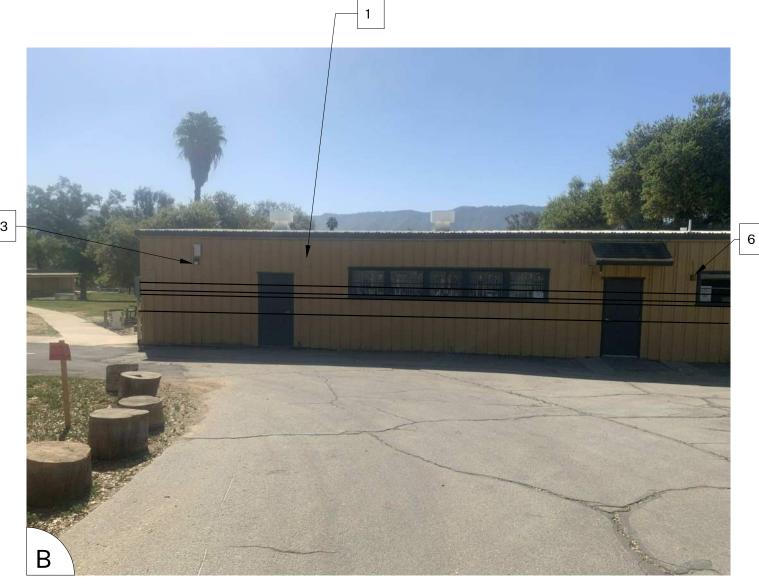

NOTE: NOT ALL KEYNOTES USED ON EVERY SHEET

 PAINT COLOR 1 2. PAINT COLOR 2

3. PAINT COLOR 3 4. PAINT COLOR 4

SHEET KEYNOTES

5. REMOVE / PAINT WALL / REINSTALL: EXISTING SIGN

6. PROTECT IN PLACE: EXISTING SECURITY CAMERA TYPICAL AT ALL LOCATIONS 7. PREP / PAINT: UTILITY CONDUITS, CABINETS & HVAC TO MATCH WALL BEYOND. 8. PREP / PAINT: EXISTING SIGNAGE IN PLACE

9. PREP / PAINT: EXISTING LOUVERS AND/OR VENTS, TYPICAL

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12. PROTECT IN PLACE: EXISTING GUTTERS AND LEADERHEADS 13. PROTECT IN PLACE: EXISTING LIGHT FIXTURE / SPEAKER / FIRE ALARM DEVICE

14. PREP / PAINT: EXISTING HVAC DUCTWORK WHERE ALREADY PAINTED. 15. PROTECT IN PLACE: EXISTING MURAL, PAINT WALLS AROUND MURAL TO MATCH EXISTING BUILDING COLOR SCHEME. TOUCH-UP/REPAINT MURALS WHERE PAINTED

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17. PREP / PAINT: EXISTING PAINTED DRINKING FOUNTAIN CANE DETECTION RAILS 18. PREP/STAIN/SEAL: EXISTING WOOD DISPLAY CASES, FIELD VERIFY STAIN COLOR +

SEALER SHEEN 19. REMOVE / DISCARD: EXISTING SIGN 20. REMOVE / SALVAGE TO ARCHITECT: EXISTING SIGN 21. REMOVE ACCESSIBLE SIGN / PAINT WALL / REINSTALL

22. PROTECT IN PLACE: EXISTING CONCRETE, CMU OR TILE 23. PREP / PAINT: EXISTING CONCRETE / CMU WALL 24. PREP / PAINT: EXISTING METAL FENCE & GATE

25. PROTECT IN PLACE: EXISTING MECHANICAL EQUIPMENT 26. PREP / PAINT: EXISTING ROLL-UP DOOR

27. PREP / PAINT: EXISTING STORAGE CONTAINER, ALL SIDES AND TOP, PAINT COLOR 2 28. PREP / PAINT: EXISTING WOOD BENCH / SEATS AND SLEEERS.

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32. PATCH / REPAIR / PREP / PRIME / PAINT: EXISTING PLASTER, SEE 1&3/A-201 33. PREP / PAINT: METAL PARAPET WALL CAP 34. PREP / PAINT: PLASTERED ROOF TOP EQUIPMENT SCREEN WALLS INSIDE AND OUT 35. CONTINUE WAINSCOAT AROUND ENTIRE PERIMETER OF BUILDING INCLUDING

RECESSED DOOR AND WINDOW RETURNS 36. PREP / PAINT: EXISTING RAIL

37. REMOVE / REPLACE CEILING LIGHTS, OWNER PROVIDED 38. EXISTING MURAL, PAINT OVER MURAL 39. REMOVE AND REPLACE EXISTING EQUIPMENT CLOSET DOOR, FRAME, HARDWARE

AND LOUVER, PAINT COLOR 2

40. PROTECT IN PLACE: EXISTING SIGN/PLAQUE 41. REMOVE EXISTING STRUCTURE 42. PREP/PAINT SAFETY YELLOW

43. REMOVE/PAINT/REINSTALL EQUIPMENT 44. REPAIR/REPLACE/PAINT: DAMAGED WOOD EAVE

45. PREP/PAINT: EXISTING WINDOW FRAMES & MUNTINS 46. REMOVE/DISCARD AS NOTED

47. PROTECT IN PLACE AS NOTED

GENERAL NOTES

1. BUILDING PLANS ARE SCHEMATIC TO ONLY SHOW APPROXIMATE OVERALL BUILDING DIMENSIONS, DOOR QUANTITIES AND APPROXIMATE DOOR LOCATIONS AND ARE PROVIDED AS A CONVENIENCE FOR BIDDING. FIELD VERIFY CONDITIONS PRIOR TO BID. REFER TO SHEET KEYNOTES, PHOTOS, AND LEGENDS FOR ADDITIONAL INFORMATION.

2. ALL EXISTING PAINTED EXTERIOR WALLS OF BUILDING, PAINTED ROOF EAVES, OVERHANGS, CONDUITS, CABINTES, LOUVERS, VENTS, DUCTS AND ROOF EAVES AND GABLES INCLUDED IN THE SCOPE OF WORK ARE TO BE REPAINTED COLORS AS LISTED AND AS DETAILED IN THESE DRAWINGS AND SPECIFICATIONS UNLESS

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6. TYPICAL WORK AT EXISTING SIGNS TO REMAIN: REMOVE SIGN, PAINT BEHIND SIGN, CLEAN SIGN, REINSTALL SIGN UNLESS NOTED OTHERWISE.

COLOR LEGEND AND NOTES

COLOR 1 - SWISS COFFEE DUNN EDWARDS DEW341 COLOR 2 - ROYAL GREY DUNN EDWARDS, MATCH EXISTING

COLOR 4 - MATCH TERRA COTTA ROOF TILE, FIELD VERIFY

1. PHOTOS WITH KEYNOTES ARE CREATED ELECTRONICALLY AND ARE INTENDED TO BE VIEWED IN COLOR TO SEE LOCATIONS OF COLORS ON THE BUILDINGS. CONTRACTOR SHALL FIELD VERIFY ACTUAL LOCATIONS AND DIMENSIONS OF COLORS PRIOR TO BID.

SYMBOL LEGEND

COLOR 3 - WILD CURRANT



EXISTING DOOR: FIELD VERIFY SIZES AND CONDITIONS, PAINT DOOR WARNING STRIPING ON LANDING AT ALL OUTSWINGING EXTERIOR DOORS U.N.O.

SHERWIN WILLIAMS SW7583

EXISTING RESTROOM DOOR: FIELD VERIFY SIZES AND CONDITIONS, PAINT DOOR WARNING STRIPING ON LANDING AT ALL OUTSWINGING EXTERIOR DOORS U.N.O. PAINT EXTERIOR DOOR FACE, FRAME EXTERIOR AND INTERIOR JAMB TO FACE OF DOOR STOP. APPLY RESTROOM IDENTIFICATION DOOR SIGNAGE ON EXTERIOR AND INTERIOR WHERE DOORS ARE PROPPED OPEN. SEE 1/A-201.



EXISTING CLASSROOM DOOR, PAINT WARNING STRIPING ON LANDING AT ALL OUTSWINGING EXTERIOR DOORS U.N.O., REMOVE AND REPLACE TRANSOM DOOR LOUVERS AND INFILL WITH 2x LUMBER, INSULTATION, AND GYPSUM SHEATHING, PAINT ENTIRE DOOR AND FRAME COLOR 2



HARTMANNARCHITECTURESTUDIO.COM 430 S. CARRILLO RD. OJAI, CALIFORNIA 93023 (805) 530-5559

CONSULTANTS:

AGENCY APPROVAL:



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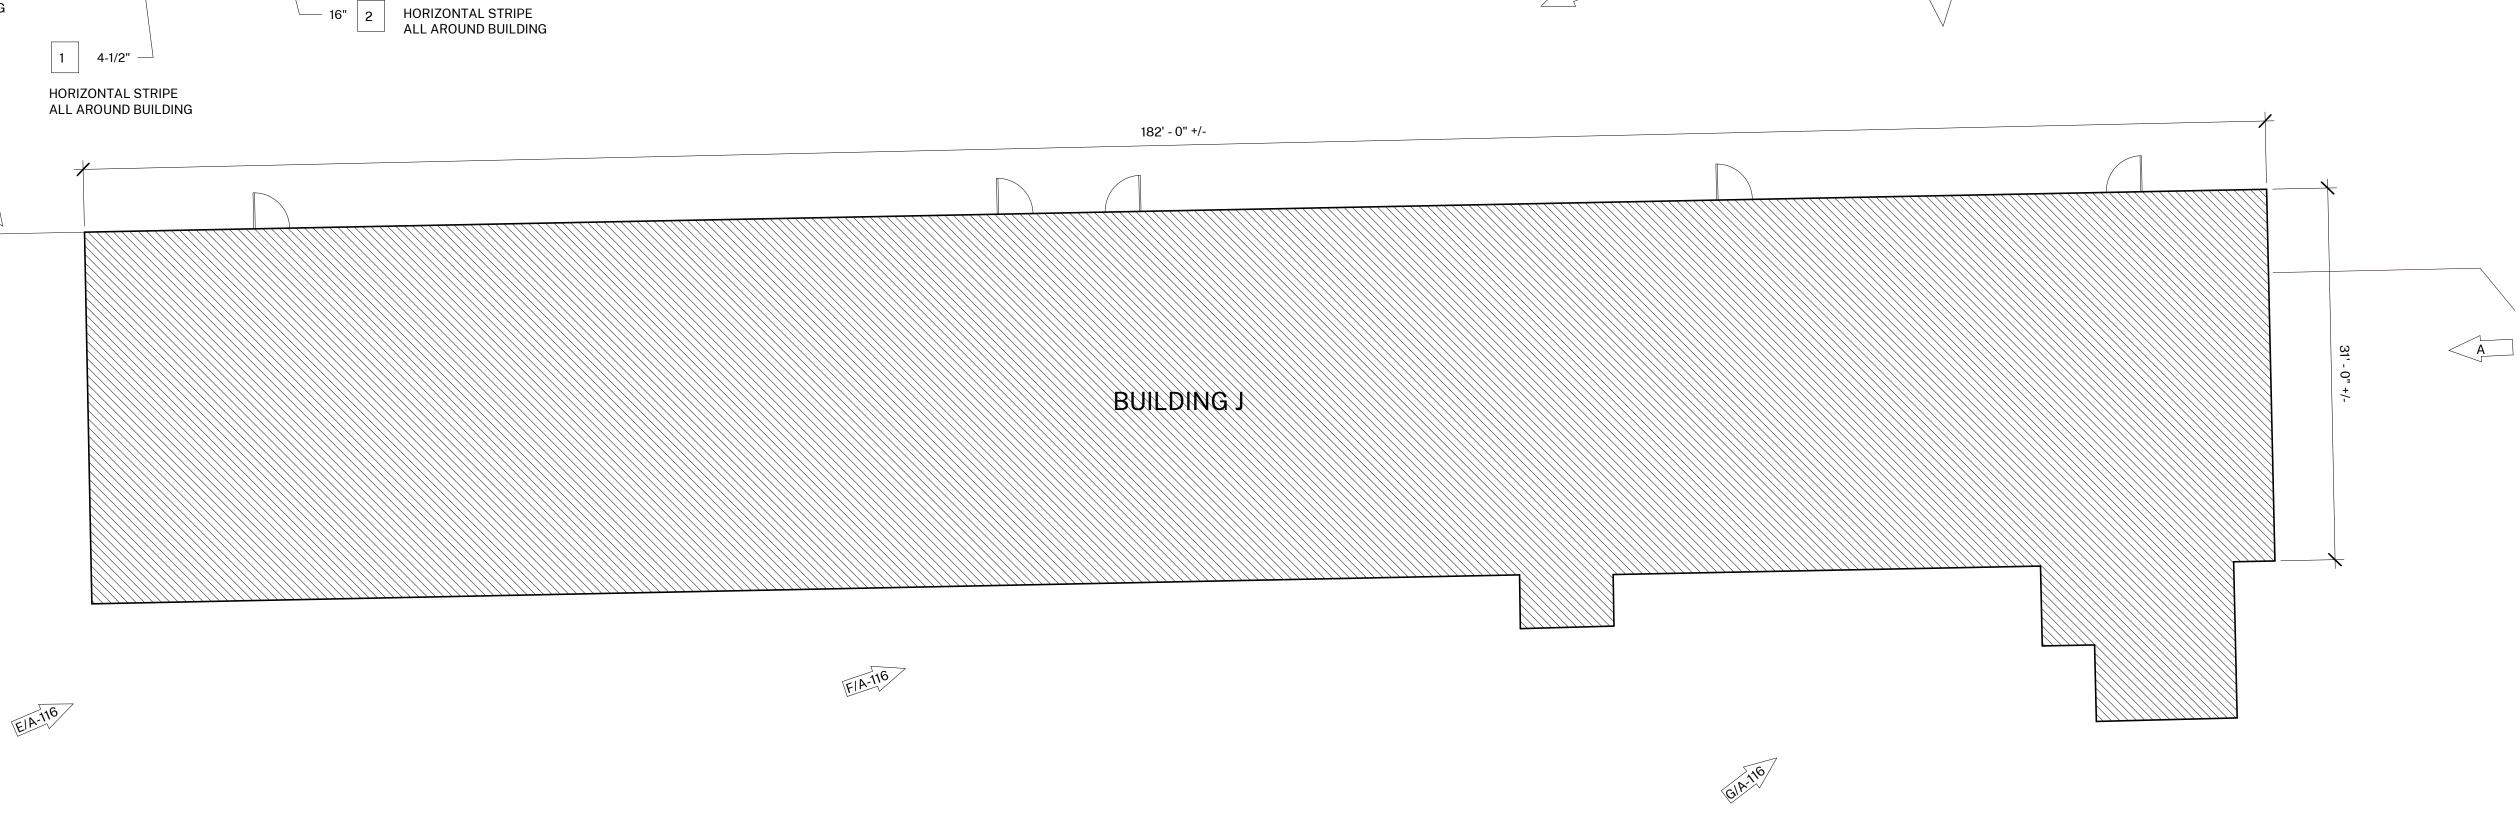
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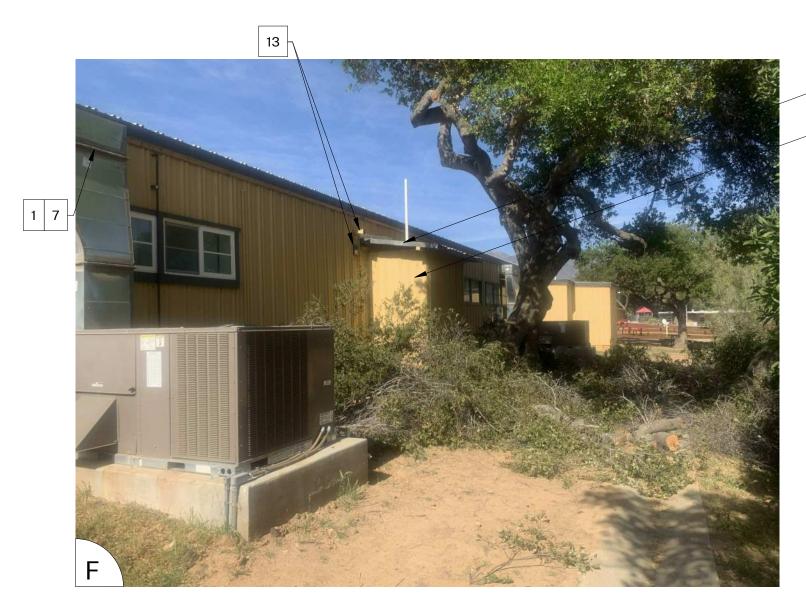
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BUILDING J

SHEET NUMBER:

A-115





NOTE: DISTRICT TO REPLACE THIS ROOF STRUCTURE WITH NEW





GENERAL NOTES

1. BUILDING PLANS ARE SCHEMATIC TO ONLY SHOW APPROXIMATE OVERALL BUILDING DIMENSIONS, DOOR QUANTITIES AND APPROXIMATE DOOR LOCATIONS AND ARE PROVIDED AS A CONVENIENCE FOR BIDDING. FIELD VERIFY CONDITIONS PRIOR TO BID. REFER TO SHEET KEYNOTES, PHOTOS, AND LEGENDS FOR ADDITIONAL INFORMATION.

2. ALL EXISTING PAINTED EXTERIOR WALLS OF BUILDING, PAINTED ROOF EAVES, OVERHANGS, CONDUITS, CABINTES, LOUVERS, VENTS, DUCTS AND ROOF EAVES AND GABLES INCLUDED IN THE SCOPE OF WORK ARE TO BE REPAINTED COLORS AS LISTED AND AS DETAILED IN THESE DRAWINGS AND SPECIFICATIONS UNLESS NOTED OTHERWISE.

3. ALL EXISTING UNPAINTED EXTERIOR SURFACES ARE TO REMAIN UNPAINTED UNLESS NOTED OTHERWISE. PROTECT IN PLACE ALL UNPAINTED SURFACES. 4. CAREFULLY PRUNE SHRUBS AND PLANTS AND REMOVE WEEDS AND PLANTINGS AT BASE OF WALL TO BARE EARTH TO ALLOW FOR COMPLETE WALL COVERAGE. 5. EXISTING PAINTED DOORS, DOOR FRAMES, DOOR TRIM, WINDOW FRAMES, MULLIONS, AND SEALANTS TO REMAIN UNLESS NOTED OTHERWISE. DO NOT PAINT ALUMINUM WINDOWS. PROTECT IN PLACE.

6. TYPICAL WORK AT EXISTING SIGNS TO REMAIN: REMOVE SIGN, PAINT BEHIND SIGN, CLEAN SIGN, REINSTALL SIGN UNLESS NOTED OTHERWISE.

AGENCY APPROVAL:

COLOR LEGEND AND NOTES

COLOR 1 - SWISS COFFEE **DUNN EDWARDS DEW341** DUNN EDWARDS, MATCH EXISTING COLOR 2 - ROYAL GREY COLOR 3 - WILD CURRANT SHERWIN WILLIAMS SW7583

COLOR 4 - MATCH TERRA COTTA ROOF TILE, FIELD VERIFY

1. PHOTOS WITH KEYNOTES ARE CREATED ELECTRONICALLY AND ARE INTENDED TO BE VIEWED IN COLOR TO SEE LOCATIONS OF COLORS ON THE BUILDINGS. CONTRACTOR SHALL FIELD VERIFY ACTUAL LOCATIONS AND DIMENSIONS OF COLORS PRIOR TO BID.

SHEET KEYNOTES

NOTE: NOT ALL KEYNOTES **USED ON EVERY SHEET**

1. PAINT COLOR 1 2. PAINT COLOR 2

3. PAINT COLOR 3 4. PAINT COLOR 4

5. REMOVE / PAINT WALL / REINSTALL: EXISTING SIGN

6. PROTECT IN PLACE: EXISTING SECURITY CAMERA TYPICAL AT ALL LOCATIONS 7. PREP / PAINT: UTILITY CONDUITS, CABINETS & HVAC TO MATCH WALL BEYOND.

8. PREP / PAINT: EXISTING SIGNAGE IN PLACE

9. PREP / PAINT: EXISTING LOUVERS AND/OR VENTS, TYPICAL

10. REMOVE / PAINT WALL / REINSTALL: LIGHT FIXTURE ESCUTCHEON PLATE OR LIGHT FIXTURE ITSELF TO WALL SURFACE BEHIND. TYPICAL AT ALL LIGHT FIXTURES U.N.O. 11. PREP / PAINT: EXISTING GUTTERS AND DOWNSPOUTS. PAINT COLOR 4

12. PROTECT IN PLACE: EXISTING GUTTERS AND LEADERHEADS 13. PROTECT IN PLACE: EXISTING LIGHT FIXTURE / SPEAKER / FIRE ALARM DEVICE 14. PREP / PAINT: EXISTING HVAC DUCTWORK WHERE ALREADY PAINTED. 15. PROTECT IN PLACE: EXISTING MURAL. PAINT WALLS AROUND MURAL TO MATCH

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17. PREP / PAINT: EXISTING PAINTED DRINKING FOUNTAIN CANE DETECTION RAILS 18. PREP/STAIN/SEAL: EXISTING WOOD DISPLAY CASES, FIELD VERIFY STAIN COLOR + SEALER SHEEN 19. REMOVE / DISCARD: EXISTING SIGN

20. REMOVE / SALVAGE TO ARCHITECT: EXISTING SIGN 21. REMOVE ACCESSIBLE SIGN / PAINT WALL / REINSTALL 22. PROTECT IN PLACE: EXISTING CONCRETE, CMU OR TILE

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37. REMOVE / REPLACE CEILING LIGHTS, OWNER PROVIDED


38. EXISTING MURAL, PAINT OVER MURAL 39. REMOVE AND REPLACE EXISTING EQUIPMENT CLOSET DOOR, FRAME, HARDWARE AND LOUVER, PAINT COLOR 2

40. PROTECT IN PLACE: EXISTING SIGN/PLAQUE 41. REMOVE EXISTING STRUCTURE 42. PREP/PAINT SAFETY YELLOW


43. REMOVE/PAINT/REINSTALL EQUIPMENT 44. REPAIR/REPLACE/PAINT: DAMAGED WOOD EAVE 45. PREP/PAINT: EXISTING WINDOW FRAMES & MUNTINS

46. REMOVE/DISCARD AS NOTED 47. PROTECT IN PLACE AS NOTED


SYMBOL LEGEND

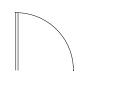

EXISTING DOOR: FIELD VERIFY SIZES AND CONDITIONS, PAINT DOOR WARNING STRIPING ON LANDING AT ALL OUTSWINGING EXTERIOR DOORS U.N.O.

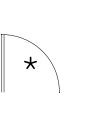

EXISTING RESTROOM DOOR: FIELD VERIFY SIZES AND CONDITIONS, PAINT DOOR WARNING STRIPING ON LANDING AT ALL OUTSWINGING EXTERIOR DOORS U.N.O. PAINT EXTERIOR DOOR FACE, FRAME EXTERIOR AND INTERIOR JAMB TO FACE OF DOOR STOP. APPLY RESTROOM IDENTIFICATION DOOR SIGNAGE ON EXTERIOR AND INTERIOR WHERE DOORS ARE PROPPED OPEN. SEE

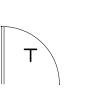


EXISTING CLASSROOM DOOR, PAINT WARNING STRIPING ON LANDING AT ALL OUTSWINGING EXTERIOR DOORS U.N.O., REMOVE AND REPLACE TRANSOM DOOR LOUVERS AND INFILL WITH 2x LUMBER, INSULTATION, AND GYPSUM SHEATHING, PAINT ENTIRE DOOR AND FRAME COLOR 2

HARTMANNARCHITECTURESTUDIO.COM 430 S. CARRILLO RD. OJAI, CALIFORNIA 93023 (805) 530-5559

CONSULTANTS:

SEALS:

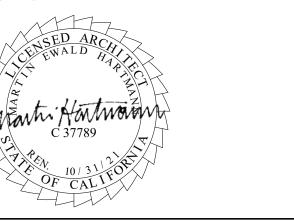

MATILIJA MS CAMPUS -WIDE EXTERIOR PAINTING

OWNER:

ISSUE:

OJAI UNIFIED SCHOOL DISTRICT 414 EAST OJAI AVENUE OJAI, CA 93023 (805) 640-4300 CONTACT: ADAM DUTTER EMAIL: adutter@ojaiusd.org

PROJECT ADDRESS:

MATILIJA MIDDLE SCHOOL 703 EL PASEO ROAD OJAI, CA 93023

OJAI USD PROJECT NO.: 2021-1600

MARK DATE DESCRIPTION PROJECT INFORMATION: PROJECT NUMBER: 2021.010 PROJECT PHASE:

DRAWN BY: REVIEWED BY:

THE ORIGINAL SIZE OF THIS SHEET IS 36"x24". IF THE CURRENT SIZE IS OTHER THAN 36"x24", THEN ADJUST THE SCALE OF THE DRAWINGS ACCORDINGLY. SHEET TITLE:

BUILDING J

SHEET NUMBER:

A-116



1. BUILDING PLANS ARE SCHEMATIC TO ONLY SHOW APPROXIMATE OVERALL BUILDING DIMENSIONS, DOOR QUANTITIES AND APPROXIMATE DOOR LOCATIONS AND ARE PROVIDED AS A CONVENIENCE FOR BIDDING. FIELD VERIFY CONDITIONS PRIOR TO BID. REFER TO SHEET KEYNOTES, PHOTOS, AND LEGENDS FOR ADDITIONAL INFORMATION.

2. ALL EXISTING PAINTED EXTERIOR WALLS OF BUILDING, PAINTED ROOF EAVES, OVERHANGS, CONDUITS, CABINTES, LOUVERS, VENTS, DUCTS AND ROOF EAVES AND GABLES INCLUDED IN THE SCOPE OF WORK ARE TO BE REPAINTED COLORS AS LISTED AND AS DETAILED IN THESE DRAWINGS AND SPECIFICATIONS UNLESS NOTED OTHERWISE.

3. ALL EXISTING UNPAINTED EXTERIOR SURFACES ARE TO REMAIN UNPAINTED UNLESS NOTED OTHERWISE. PROTECT IN PLACE ALL UNPAINTED SURFACES. 4. CAREFULLY PRUNE SHRUBS AND PLANTS AND REMOVE WEEDS AND PLANTINGS AT BASE OF WALL TO BARE EARTH TO ALLOW FOR COMPLETE WALL COVERAGE. 5. EXISTING PAINTED DOORS, DOOR FRAMES, DOOR TRIM, WINDOW FRAMES, MULLIONS, AND SEALANTS TO REMAIN UNLESS NOTED OTHERWISE. DO NOT PAINT ALUMINUM WINDOWS. PROTECT IN PLACE.

6. TYPICAL WORK AT EXISTING SIGNS TO REMAIN: REMOVE SIGN, PAINT BEHIND SIGN, CLEAN SIGN, REINSTALL SIGN UNLESS NOTED OTHERWISE.

HARTMANNARCHITECTURESTUDIO.COM 430 S. CARRILLO RD. OJAI, CALIFORNIA 93023 (805) 530-5559

AGENCY APPROVAL:

CONSULTANTS:

COLOR LEGEND AND NOTES

COLOR 1 - SWISS COFFEE **DUNN EDWARDS DEW341** DUNN EDWARDS, MATCH EXISTING COLOR 2 - ROYAL GREY

COLOR 3 - WILD CURRANT SHERWIN WILLIAMS SW7583

COLOR 4 - MATCH TERRA COTTA ROOF TILE, FIELD VERIFY

1. PHOTOS WITH KEYNOTES ARE CREATED ELECTRONICALLY AND ARE INTENDED TO BE VIEWED IN COLOR TO SEE LOCATIONS OF COLORS ON THE BUILDINGS. CONTRACTOR SHALL FIELD VERIFY ACTUAL LOCATIONS AND DIMENSIONS OF COLORS PRIOR TO BID.

SHEET KEYNOTES

NOTE: NOT ALL KEYNOTES **USED ON EVERY SHEET**

1. PAINT COLOR 1

2. PAINT COLOR 2

3. PAINT COLOR 3 4. PAINT COLOR 4

SEALER SHEEN

5. REMOVE / PAINT WALL / REINSTALL: EXISTING SIGN

6. PROTECT IN PLACE: EXISTING SECURITY CAMERA TYPICAL AT ALL LOCATIONS 7. PREP / PAINT: UTILITY CONDUITS, CABINETS & HVAC TO MATCH WALL BEYOND.

8. PREP / PAINT: EXISTING SIGNAGE IN PLACE

9. PREP / PAINT: EXISTING LOUVERS AND/OR VENTS, TYPICAL

10. REMOVE / PAINT WALL / REINSTALL: LIGHT FIXTURE ESCUTCHEON PLATE OR LIGHT FIXTURE ITSELF TO WALL SURFACE BEHIND. TYPICAL AT ALL LIGHT FIXTURES U.N.O. 11. PREP / PAINT: EXISTING GUTTERS AND DOWNSPOUTS. PAINT COLOR 4

12. PROTECT IN PLACE: EXISTING GUTTERS AND LEADERHEADS 13. PROTECT IN PLACE: EXISTING LIGHT FIXTURE / SPEAKER / FIRE ALARM DEVICE 14. PREP / PAINT: EXISTING HVAC DUCTWORK WHERE ALREADY PAINTED.

15. PROTECT IN PLACE: EXISTING MURAL. PAINT WALLS AROUND MURAL TO MATCH EXISTING BUILDING COLOR SCHEME. TOUCH-UP/REPAINT MURALS WHERE PAINTED TO MATCH EXISTING.

16. PROTECT IN PLACE: EXISTING DRINKING FOUNTAIN 17. PREP / PAINT: EXISTING PAINTED DRINKING FOUNTAIN CANE DETECTION RAILS 18. PREP/STAIN/SEAL: EXISTING WOOD DISPLAY CASES, FIELD VERIFY STAIN COLOR +

19. REMOVE / DISCARD: EXISTING SIGN 20. REMOVE / SALVAGE TO ARCHITECT: EXISTING SIGN 21. REMOVE ACCESSIBLE SIGN / PAINT WALL / REINSTALL

22. PROTECT IN PLACE: EXISTING CONCRETE, CMU OR TILE 23. PREP / PAINT: EXISTING CONCRETE / CMU WALL 24. PREP / PAINT: EXISTING METAL FENCE & GATE

25. PROTECT IN PLACE: EXISTING MECHANICAL EQUIPMENT 26. PREP / PAINT: EXISTING ROLL-UP DOOR

27. PREP / PAINT: EXISTING STORAGE CONTAINER, ALL SIDES AND TOP, PAINT COLOR 2 28. PREP / PAINT: EXISTING WOOD BENCH / SEATS AND SLEEERS.

29. PREP / PAINT: EXISTING CMU WALLS. PAINT INSIDE AND OUTSIDE OF ENCLOSURE AND DOORS. 30. PREP / PRIME / PAINT: PAVILION PLASTERED SURFACES & EAVES

31. PREP / PAINT: EXISTING DOOR OR WINDOW METAL SECURITY GRATING 32. PATCH / REPAIR / PREP / PRIME / PAINT: EXISTING PLASTER. SEE 1&3/A-201 33. PREP / PAINT: METAL PARAPET WALL CAP

34. PREP / PAINT: PLASTERED ROOF TOP EOUIPMENT SCREEN WALLS INSIDE AND OUT 35. CONTINUE WAINSCOAT AROUND ENTIRE PERIMETER OF BUILDING INCLUDING RECESSED DOOR AND WINDOW RETURNS

36. PREP / PAINT: EXISTING RAIL 37. REMOVE / REPLACE CEILING LIGHTS, OWNER PROVIDED

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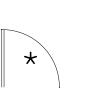
42. PREP/PAINT SAFETY YELLOW 43. REMOVE/PAINT/REINSTALL EQUIPMENT 44. REPAIR/REPLACE/PAINT: DAMAGED WOOD EAVE

45. PREP/PAINT: EXISTING WINDOW FRAMES & MUNTINS 46. REMOVE/DISCARD AS NOTED


SYMBOL LEGEND

47. PROTECT IN PLACE AS NOTED

EXISTING DOOR: FIELD VERIFY SIZES AND CONDITIONS, PAINT DOOR WARNING STRIPING ON LANDING AT ALL OUTSWINGING EXTERIOR DOORS U.N.O.




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EXISTING CLASSROOM DOOR, PAINT WARNING STRIPING ON LANDING AT ALL OUTSWINGING EXTERIOR DOORS U.N.O., REMOVE AND REPLACE TRANSOM DOOR LOUVERS AND INFILL WITH 2x LUMBER, INSULTATION, AND GYPSUM SHEATHING, PAINT ENTIRE DOOR AND FRAME COLOR 2

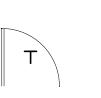SEALS:



MATILIJA MS CAMPUS -WIDE EXTERIOR PAINTING

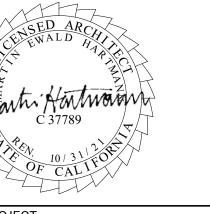OWNER:

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BUILDING D

2021.010

PBS


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A-117

DATE: 05/14/21


1 BUILDING D

′ 1/8" = 1'-0"



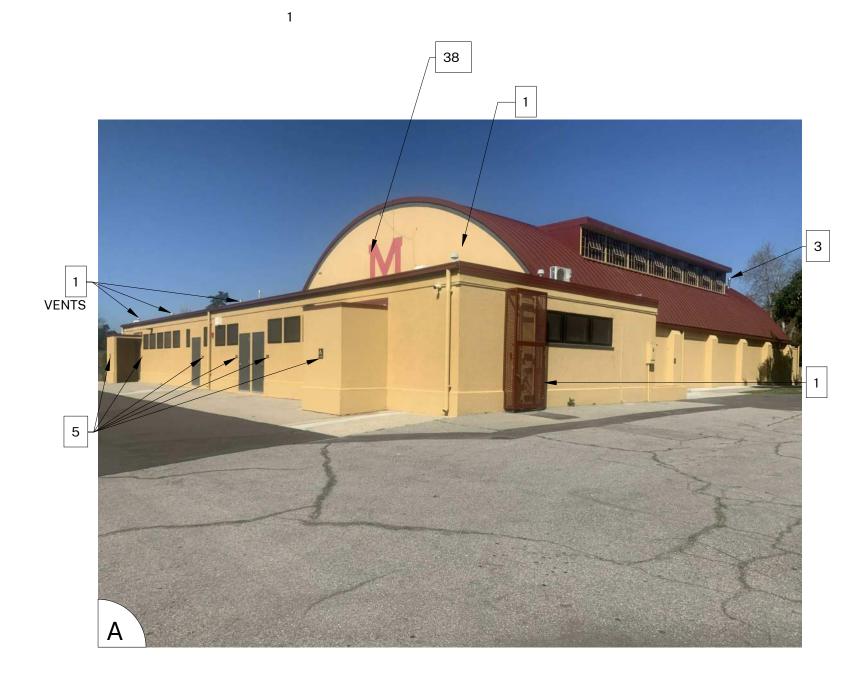



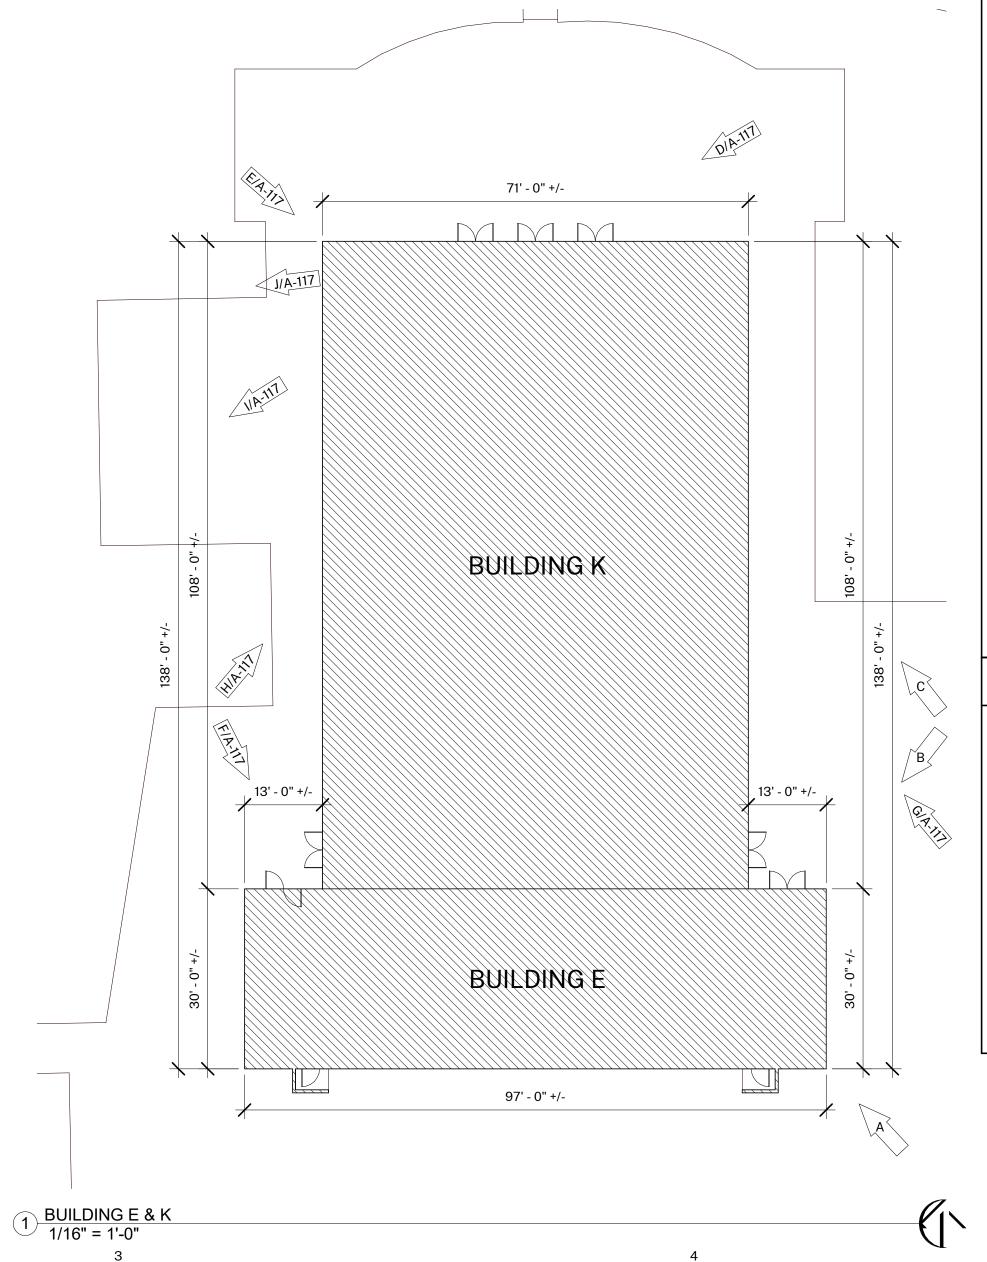

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- 6. TYPICAL WORK AT EXISTING SIGNS TO REMAIN: REMOVE SIGN, PAINT BEHIND SIGN, CLEAN SIGN, REINSTALL SIGN UNLESS NOTED OTHERWISE.

COLOR LEGEND AND NOTES

ALUMINUM WINDOWS. PROTECT IN PLACE.

COLOR 1 - SWISS COFFEE DUNN EDWARDS DEW341 DUNN EDWARDS, MATCH EXISTING COLOR 2 - ROYAL GREY

COLOR 3 - WILD CURRANT SHERWIN WILLIAMS SW7583

COLOR 4 - MATCH TERRA COTTA ROOF TILE, FIELD VERIFY

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SHEET KEYNOTES

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1. PAINT COLOR 1

2. PAINT COLOR 2

3. PAINT COLOR 3 4. PAINT COLOR 4

5. REMOVE / PAINT WALL / REINSTALL: EXISTING SIGN

6. PROTECT IN PLACE: EXISTING SECURITY CAMERA TYPICAL AT ALL LOCATIONS 7. PREP / PAINT: UTILITY CONDUITS, CABINETS & HVAC TO MATCH WALL BEYOND.

8. PREP / PAINT: EXISTING SIGNAGE IN PLACE

9. PREP / PAINT: EXISTING LOUVERS AND/OR VENTS, TYPICAL

10. REMOVE / PAINT WALL / REINSTALL: LIGHT FIXTURE ESCUTCHEON PLATE OR LIGHT FIXTURE ITSELF TO WALL SURFACE BEHIND. TYPICAL AT ALL LIGHT FIXTURES U.N.O. 11. PREP / PAINT: EXISTING GUTTERS AND DOWNSPOUTS. PAINT COLOR 4

12. PROTECT IN PLACE: EXISTING GUTTERS AND LEADERHEADS 13. PROTECT IN PLACE: EXISTING LIGHT FIXTURE / SPEAKER / FIRE ALARM DEVICE 14. PREP / PAINT: EXISTING HVAC DUCTWORK WHERE ALREADY PAINTED. 15. PROTECT IN PLACE: EXISTING MURAL. PAINT WALLS AROUND MURAL TO MATCH

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16. PROTECT IN PLACE: EXISTING DRINKING FOUNTAIN 17. PREP / PAINT: EXISTING PAINTED DRINKING FOUNTAIN CANE DETECTION RAILS 18. PREP/STAIN/SEAL: EXISTING WOOD DISPLAY CASES, FIELD VERIFY STAIN COLOR +

SEALER SHEEN 19. REMOVE / DISCARD: EXISTING SIGN

20. REMOVE / SALVAGE TO ARCHITECT: EXISTING SIGN

21. REMOVE ACCESSIBLE SIGN / PAINT WALL / REINSTALL 22. PROTECT IN PLACE: EXISTING CONCRETE, CMU OR TILE

23. PREP / PAINT: EXISTING CONCRETE / CMU WALL

24. PREP / PAINT: EXISTING METAL FENCE & GATE 25. PROTECT IN PLACE: EXISTING MECHANICAL EQUIPMENT

26. PREP / PAINT: EXISTING ROLL-UP DOOR

27. PREP / PAINT: EXISTING STORAGE CONTAINER, ALL SIDES AND TOP, PAINT COLOR 2 28. PREP / PAINT: EXISTING WOOD BENCH / SEATS AND SLEEERS.

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30. PREP / PRIME / PAINT: PAVILION PLASTERED SURFACES & EAVES

31. PREP / PAINT: EXISTING DOOR OR WINDOW METAL SECURITY GRATING

32. PATCH / REPAIR / PREP / PRIME / PAINT: EXISTING PLASTER, SEE 1&3/A-201

33. PREP / PAINT: METAL PARAPET WALL CAP 34. PREP / PAINT: PLASTERED ROOF TOP EOUIPMENT SCREEN WALLS INSIDE AND OUT 35. CONTINUE WAINSCOAT AROUND ENTIRE PERIMETER OF BUILDING INCLUDING

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AND LOUVER, PAINT COLOR 2 40. PROTECT IN PLACE: EXISTING SIGN/PLAQUE

41. REMOVE EXISTING STRUCTURE


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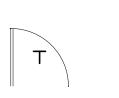
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47. PROTECT IN PLACE AS NOTED



EXISTING DOOR: FIELD VERIFY SIZES AND CONDITIONS, PAINT DOOR WARNING STRIPING ON LANDING AT ALL OUTSWINGING EXTERIOR DOORS U.N.O.

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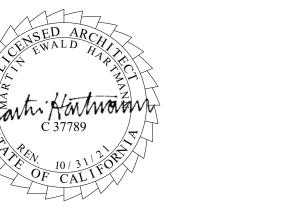


EXISTING CLASSROOM DOOR, PAINT WARNING STRIPING ON LANDING AT ALL OUTSWINGING EXTERIOR DOORS U.N.O., REMOVE AND REPLACE TRANSOM DOOR LOUVERS AND INFILL WITH 2x LUMBER, INSULTATION, AND GYPSUM SHEATHING, PAINT ENTIRE DOOR AND FRAME COLOR 2

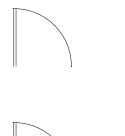HARTMANNARCHITECTURESTUDIO.COM 430 S. CARRILLO RD. OJAI, CALIFORNIA 93023 (805) 530-5559

CONSULTANTS:

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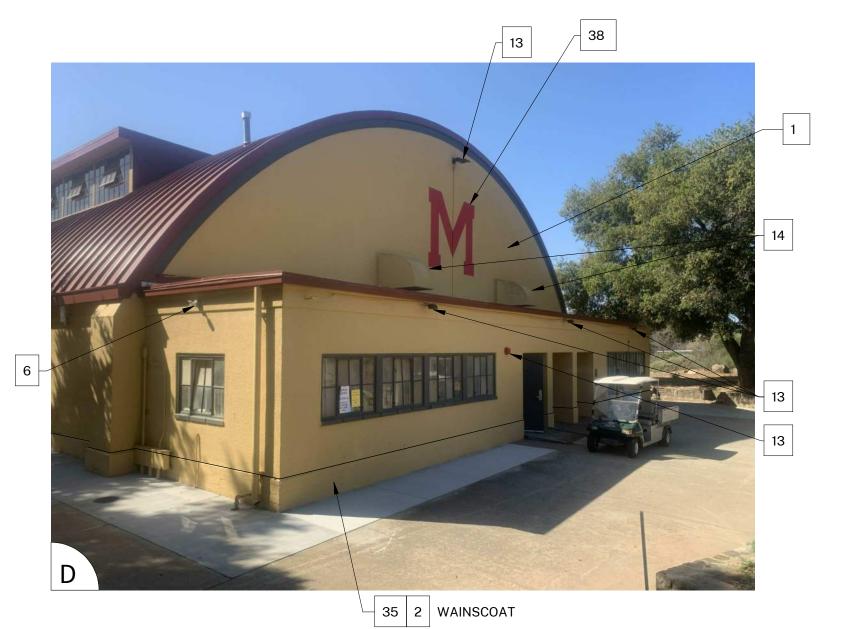
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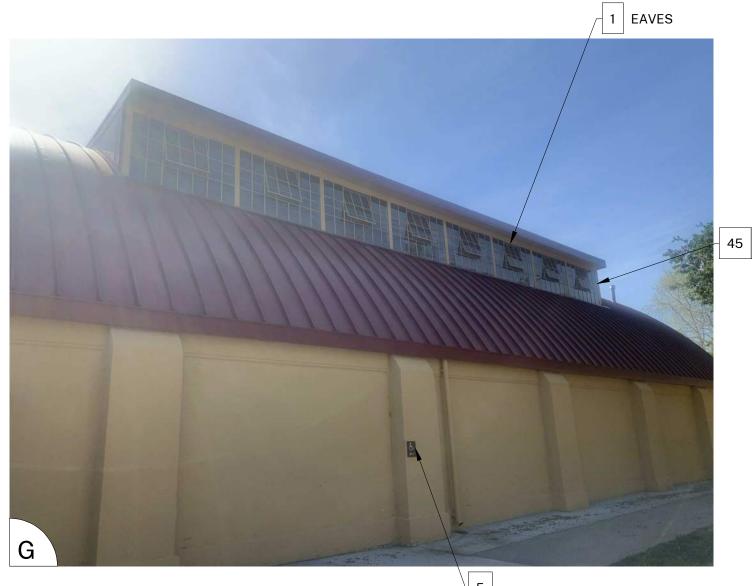
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2021.010


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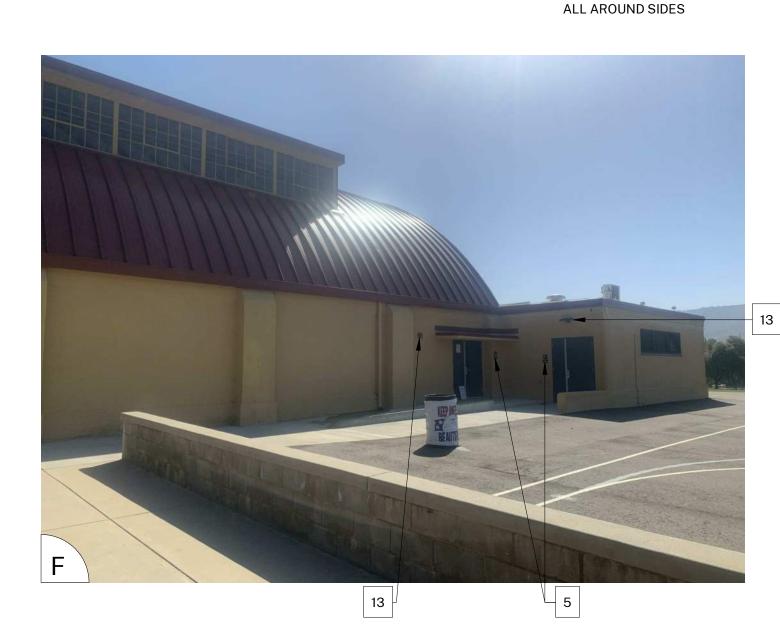
A-118









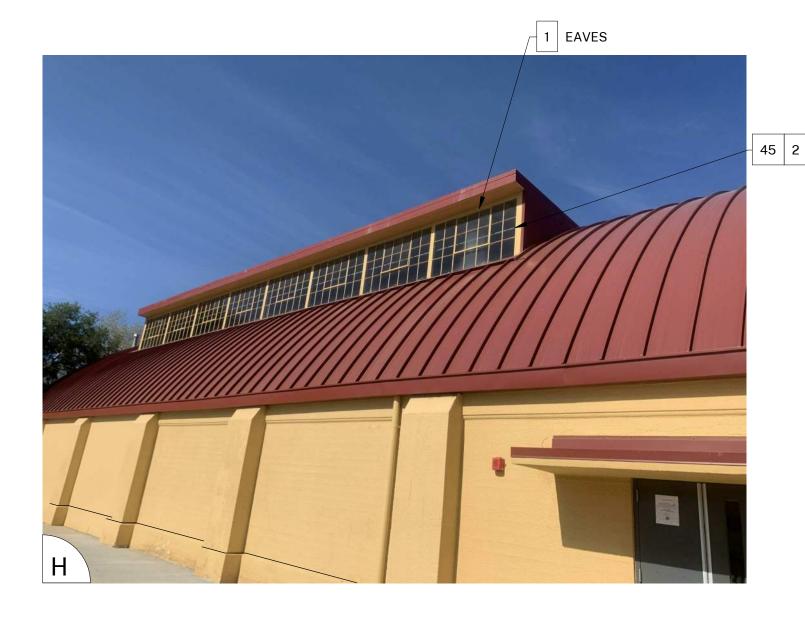





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COLOR LEGEND AND NOTES

DUNN EDWARDS DEW341 COLOR 1 - SWISS COFFEE COLOR 2 - ROYAL GREY DUNN EDWARDS, MATCH EXISTING COLOR 3 - WILD CURRANT SHERWIN WILLIAMS SW7583

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SHEET KEYNOTES

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5. REMOVE / PAINT WALL / REINSTALL: EXISTING SIGN

6. PROTECT IN PLACE: EXISTING SECURITY CAMERA TYPICAL AT ALL LOCATIONS

7. PREP / PAINT: UTILITY CONDUITS, CABINETS & HVAC TO MATCH WALL BEYOND. 8. PREP / PAINT: EXISTING SIGNAGE IN PLACE

9. PREP / PAINT: EXISTING LOUVERS AND/OR VENTS, TYPICAL

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42. PREP/PAINT SAFETY YELLOW

43. REMOVE/PAINT/REINSTALL EQUIPMENT 44. REPAIR/REPLACE/PAINT: DAMAGED WOOD EAVE

45. PREP/PAINT: EXISTING WINDOW FRAMES & MUNTINS

46. REMOVE/DISCARD AS NOTED 47. PROTECT IN PLACE AS NOTED

HARTMANNARCHITECTURESTUDIO.COM 430 S. CARRILLO RD. OJAI, CALIFORNIA 93023 (805) 530-5559

CONSULTANTS:

AGENCY APPROVAL:

SEALS:



MATILIJA MS CAMPUS -WIDE EXTERIOR PAINTING

OWNER:

OJAI UNIFIED SCHOOL DISTRICT 414 EAST OJAI AVENUE OJAI, CA 93023 (805) 640-4300 CONTACT: ADAM DUTTER EMAIL: adutter@ojaiusd.org

PROJECT ADDRESS:

ISSUE: MARK

MATILIJA MIDDLE SCHOOL 703 EL PASEO ROAD OJAI, CA 93023

OJAI USD PROJECT NO.: 2021-1600

PROJECT INFORMATION: PROJECT NUMBER: 2021.010

DESCRIPTION

DRAWN BY: **REVIEWED BY:**

PROJECT PHASE:


THE ORIGINAL SIZE OF THIS SHEET IS 36"x24". IF THE CURRENT SIZE IS OTHER THAN 36"x24", THEN ADJUST THE SCALE OF THE DRAWINGS ACCORDINGLY. SHEET TITLE:

BUILDING E & K

SHEET NUMBER: A-119

(E) SUBSTRATE WEATHER RESISTIVE BARRIER, 2 LAYERS OF GARDE 'D' PAPER EXPANDED MTL. LATH, V-GROOVE SHELF-FURRING, 2.5 LBS/SQ YD MIN, HAND WITH 6d STAINLESS NAILS 7/8" THREE-COAT PORTLAND CEMENT PLASTER-MATCH (E) FINISH-PAINT APPLY CASING BEADS WHERE PLASTER TERMINATES AT UNDERSIDE OF ROOF AND PENETRATIONS CORNER AID SHALL BE USED AT THE VERTICAL EDGE OF INTERSECTING WALL SURFACES SELF-FURRING WOVEN-WIRE MAY BE SUBSTITUTED FOR MTL. LATH SCRATCH COAT SHALL BE MOIST CURED FOR SECTION VIEW 48 HOURS MIN.

1 EXTERIOR CEMENT PLASTER
3" = 1'-0"

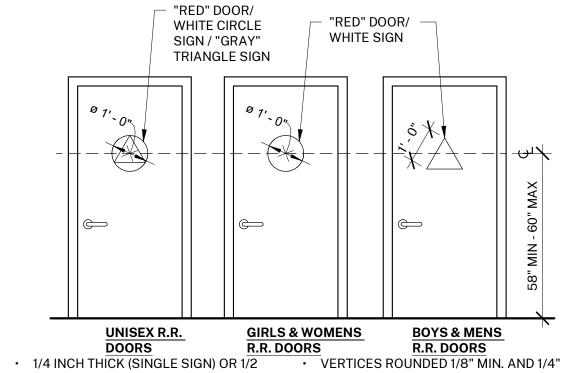

INCH THICK OVERALL (UNISEX SIGN).


 NON-STATIC, FIRE-RETARDANT, AND SELF-EXTINGUISHING. SYMBOLS SHALL CONTRAST WITH

BACKGROUND. ROUNDED EDGES 1/16" MIN OR 1/8" CHAMFERED.

3. SAMPLE

 COLOR OF PLASTIC: AS SELECTED FROM MANUFACTURER'S STANDARD COLORS. FINISH OF PLASTIC: MATTE. SUBMIT FOR APPROVAL: 1. SHOP DRAWINGS 2. MANUFACTURER'S PRODUCT INFO

2 TOILET FACILITY GEOMETRIC SYMBOLS
3/8" = 1'-0"

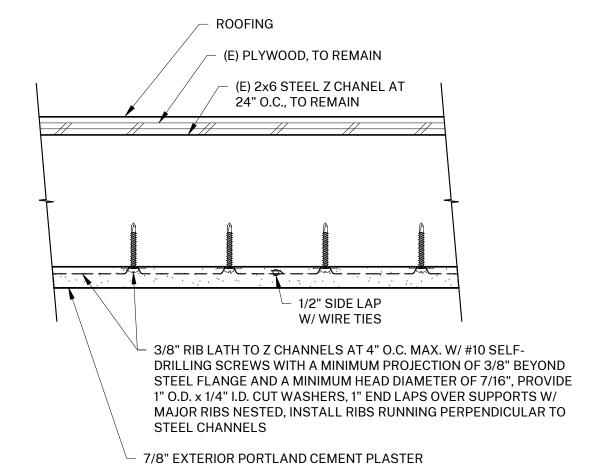

HORIZONTAL EXTERIOR PLASTER AT 3 CANOPY 3" = 1'-0"

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DETAILS

2021.010

PBS MH

SHEET NUMBER:

A-201