

DESIGN PROFESSIONAL IN GENERAL RESPONSIBLE CHARGE STATEMENT

THE PATH OF TRAVEL (POT) IDENTIFIED IN THESE CONSTRUCTION DOCUMENTS MEETS THE REQUIREMENTS OF THE CURRENT APPLICABLE CALIFORNIA BUILDING CODE (CBC) ACCESSIBILITY PROVISIONS FOR PATH OF TRAVEL REQUIREMENTS FOR ALTERATIONS, ADDITIONS, AND STRUCTURAL REPAIRS. AS PART OF THE DESIGN OF THIS PROJECT, THE POT WAS EXAMINED AND ANY ELEMENTS, COMPONENTS OR PORTIONS OF THE POT THAT WERE DETERMINED TO BE NONCOMPLIANT WITH THE CBC HAVE BEEN IDENTIFIED AND THE CORRECTIVE WORK NECESSARY TO BRIND THEM INTO COMPLIANCE HAS BEEN INCLUDED WITHIN THE SCOPE OF THIS PROJECT'S WORK THROUGH DETAILS, DRAWINGS AND SPECIFICATIONS INCORPORATED INTO THESE CONSTRUCTION DOCUMENTS. ANY NONCOMPLIANT ELEMENTS, COMPONENTS OR PORTIONS OF THE POT THAT WILL NOT BE CORRECTED BY THIS PROJECT BASED ON VALUATION THRESHOLD LIMITATIONS OR A FINDING OF UNREASONABLE HARDSHIP ARE INDICATED IN THESE CONSTRUCTION DOCUMENTS.

DURING CONSTRUCTION, IF POT ITEMS WITHIN THE SCOPE OF THE PROJECT REPRESENTED AS CBC COMPLIANT ARE FOUND TO BE NONCONFORMING BEYOND REASONABLE CONSTRUCTION TOLERANCES, THE ITEMS SHALL BE BROUGHT INTO COMPLIANCE WITH THE CBC AS PART OF THIS PROJECT BY MEANS OF A CONSTRUCTION CHANGE DOCUMENT.

HARTMANNARCHITECTURESTUDIO.COM 430 S. CARRILLO RD. OJAI, CALIFORNIA 93023 (805) 530-5559

CONSULTANTS:

AGENCY APPROVAL:

SYMBOL LEGEND

PATH OF TRAVEL (P.O.T.) AS INDICATED, IS A COMMON BARRIER FREE ACCESS ROUTE WITHOUT ANY ABRUPT

ACCESSIBLE PATH OF TRAVEL

VERTICAL CHANGES EXCEEDING ¹/₂ INCH BEVELED AT 1:2 MAXIMUM SLOPE, EXCEPT THAT LEVEL CHANGES DO NOT EXCEED 1/4 INCH VERTICAL AND IS AT LEAST 48" WIDE. THE PATH SURFACE IS SLIP RESISTANT, STABLE, FIRM, AND SMOOTH. PASSING SPACES (11B-403.5.3) AT LEAST 60 INCHES BY 60 INCHES ARE LOCATED NOT MORE THAN 200 FEET APART. PARTS OF P.O.T. WITH CONTINUOUS GRADIENTS HAVE 60 INCH LEVEL AREAS (11B-403.7) NOT MORE THAN 400 FEET APART. THE CROSS-SLOPE DOES NOT EXCEED 2 PERCENT AND SLOPE IN THE DIRECTION OF TRAVEL IS LESS THAN 5 PERCENT UNLESS OTHERWISE INDICATED. P.O.T. SHALL BE MAINTAINED FREE OF OVERHANGING OBSTRUCTIONS TO 80 INCHES MINIMUM (11B-307.4) AND PROTRUDING OBJECTS GREATER THAN 4 INCHES PROJECTION FROM WALL AND ABOVE 27 INCHES AND LESS THAN 80 INCHES (11B-307.2). ARCHITECT SHALL VERIFY PATH OF TRAVEL CONFORMS WITH THE ABOVE. IF GATES OCCUR ALONG THE PATH OF TRAVEL, THEY MUST COMPLY WITH THE ACCESSIBLE REQUIREMENTS PER CBC 2019.



(E) FIRE HYDRANT



MATILIJA MIDDLE SCHOOL LIBRARY RENOVATION

OJAI UNIFIED SCHOOL DISTRICT 414 E. OJAI AVE. OJAI, CA 93023

ATTN: ADAM DUTTER, BOND MANAGER

adutter@ojaiusd.org

PROJECT ADDRESS: MATILIJA MIDDLE SCHOOL 703 EL PASEO RD. OJAI, CA 93023

(805) 640-4300

DESCRIPTION

2020.032

PROJECT INFORMATION: PROJECT NUMBER: PROJECT PHASE:

DRAWN BY:

REVIEWED BY:

SITE PLAN

DATE: 11/10/2021

SITE PLAN


		CAMPUS BU	ILDING INFO				
BUILDING NAME	DSA APP. NOS. / A#'s	USE	OCCUPANCY	CONSTRUCTION TYPE	FIRE SPRINKLERS	┪ '	
BUILDING A	9320 / 5155 / 03-107896	CLASSROOMS	E	III-B	NO		PROJECT INFORMA
BUILDING B	03-119638	DINING HALL / KITCHEN	А	V-B	YES		PROJECT NUMBER: PROJECT PHASE:
BUILDING C	1926 / 9388 / 51555 / 03-107301	CLASSROOMS / ADMINISTRATION	Е	III-B	NO		DRAWN BY: REVIEWED BY:
BUILDING D	9230 / 51555	CLASSROOM	Е	V-B	NO		THE ORIGINAL SIZE OF THIS 36"x24", THEN ADJUST THE S
BUILDING E	9231 / 03-118467	LOCKER ROOM	Е	V-B	NO		SHEET TITLE:
BUILDING F	1926 / 51555 / 104381 / 03-107301	AUDITORIUM / CLASSROOMS	Е	III-B	PARTIALLY		S
BUILDING G	37821 / 03-107896	CLASSROOMS	E	V-B	NO		
BUILDING H	26247	CLASSROOMS	E	V-B	NO		
BUILDING I	28247	CLASSROOMS	E	V-B	NO		
BUILDING J	28346	CLASSROOMS	Е	V-B	NO		
BUILDING K	3294 / 5346 / 51555 / 12116 / 03-118467	GYMNASIUM	Е	V-B	NO		SHEET NUMBER:
						[I

NOTE: A#03-119638 - NEW DINING HALL AND KITCHEN) IS CURRENTLY UNDER CONSTRUCTION. MOST RECENT PROJECT AT THIS CAMPUS (A#03-118467) WAS CLOSED ON 7/29/20.

ASSEMBLY

PAVILION

03-118002

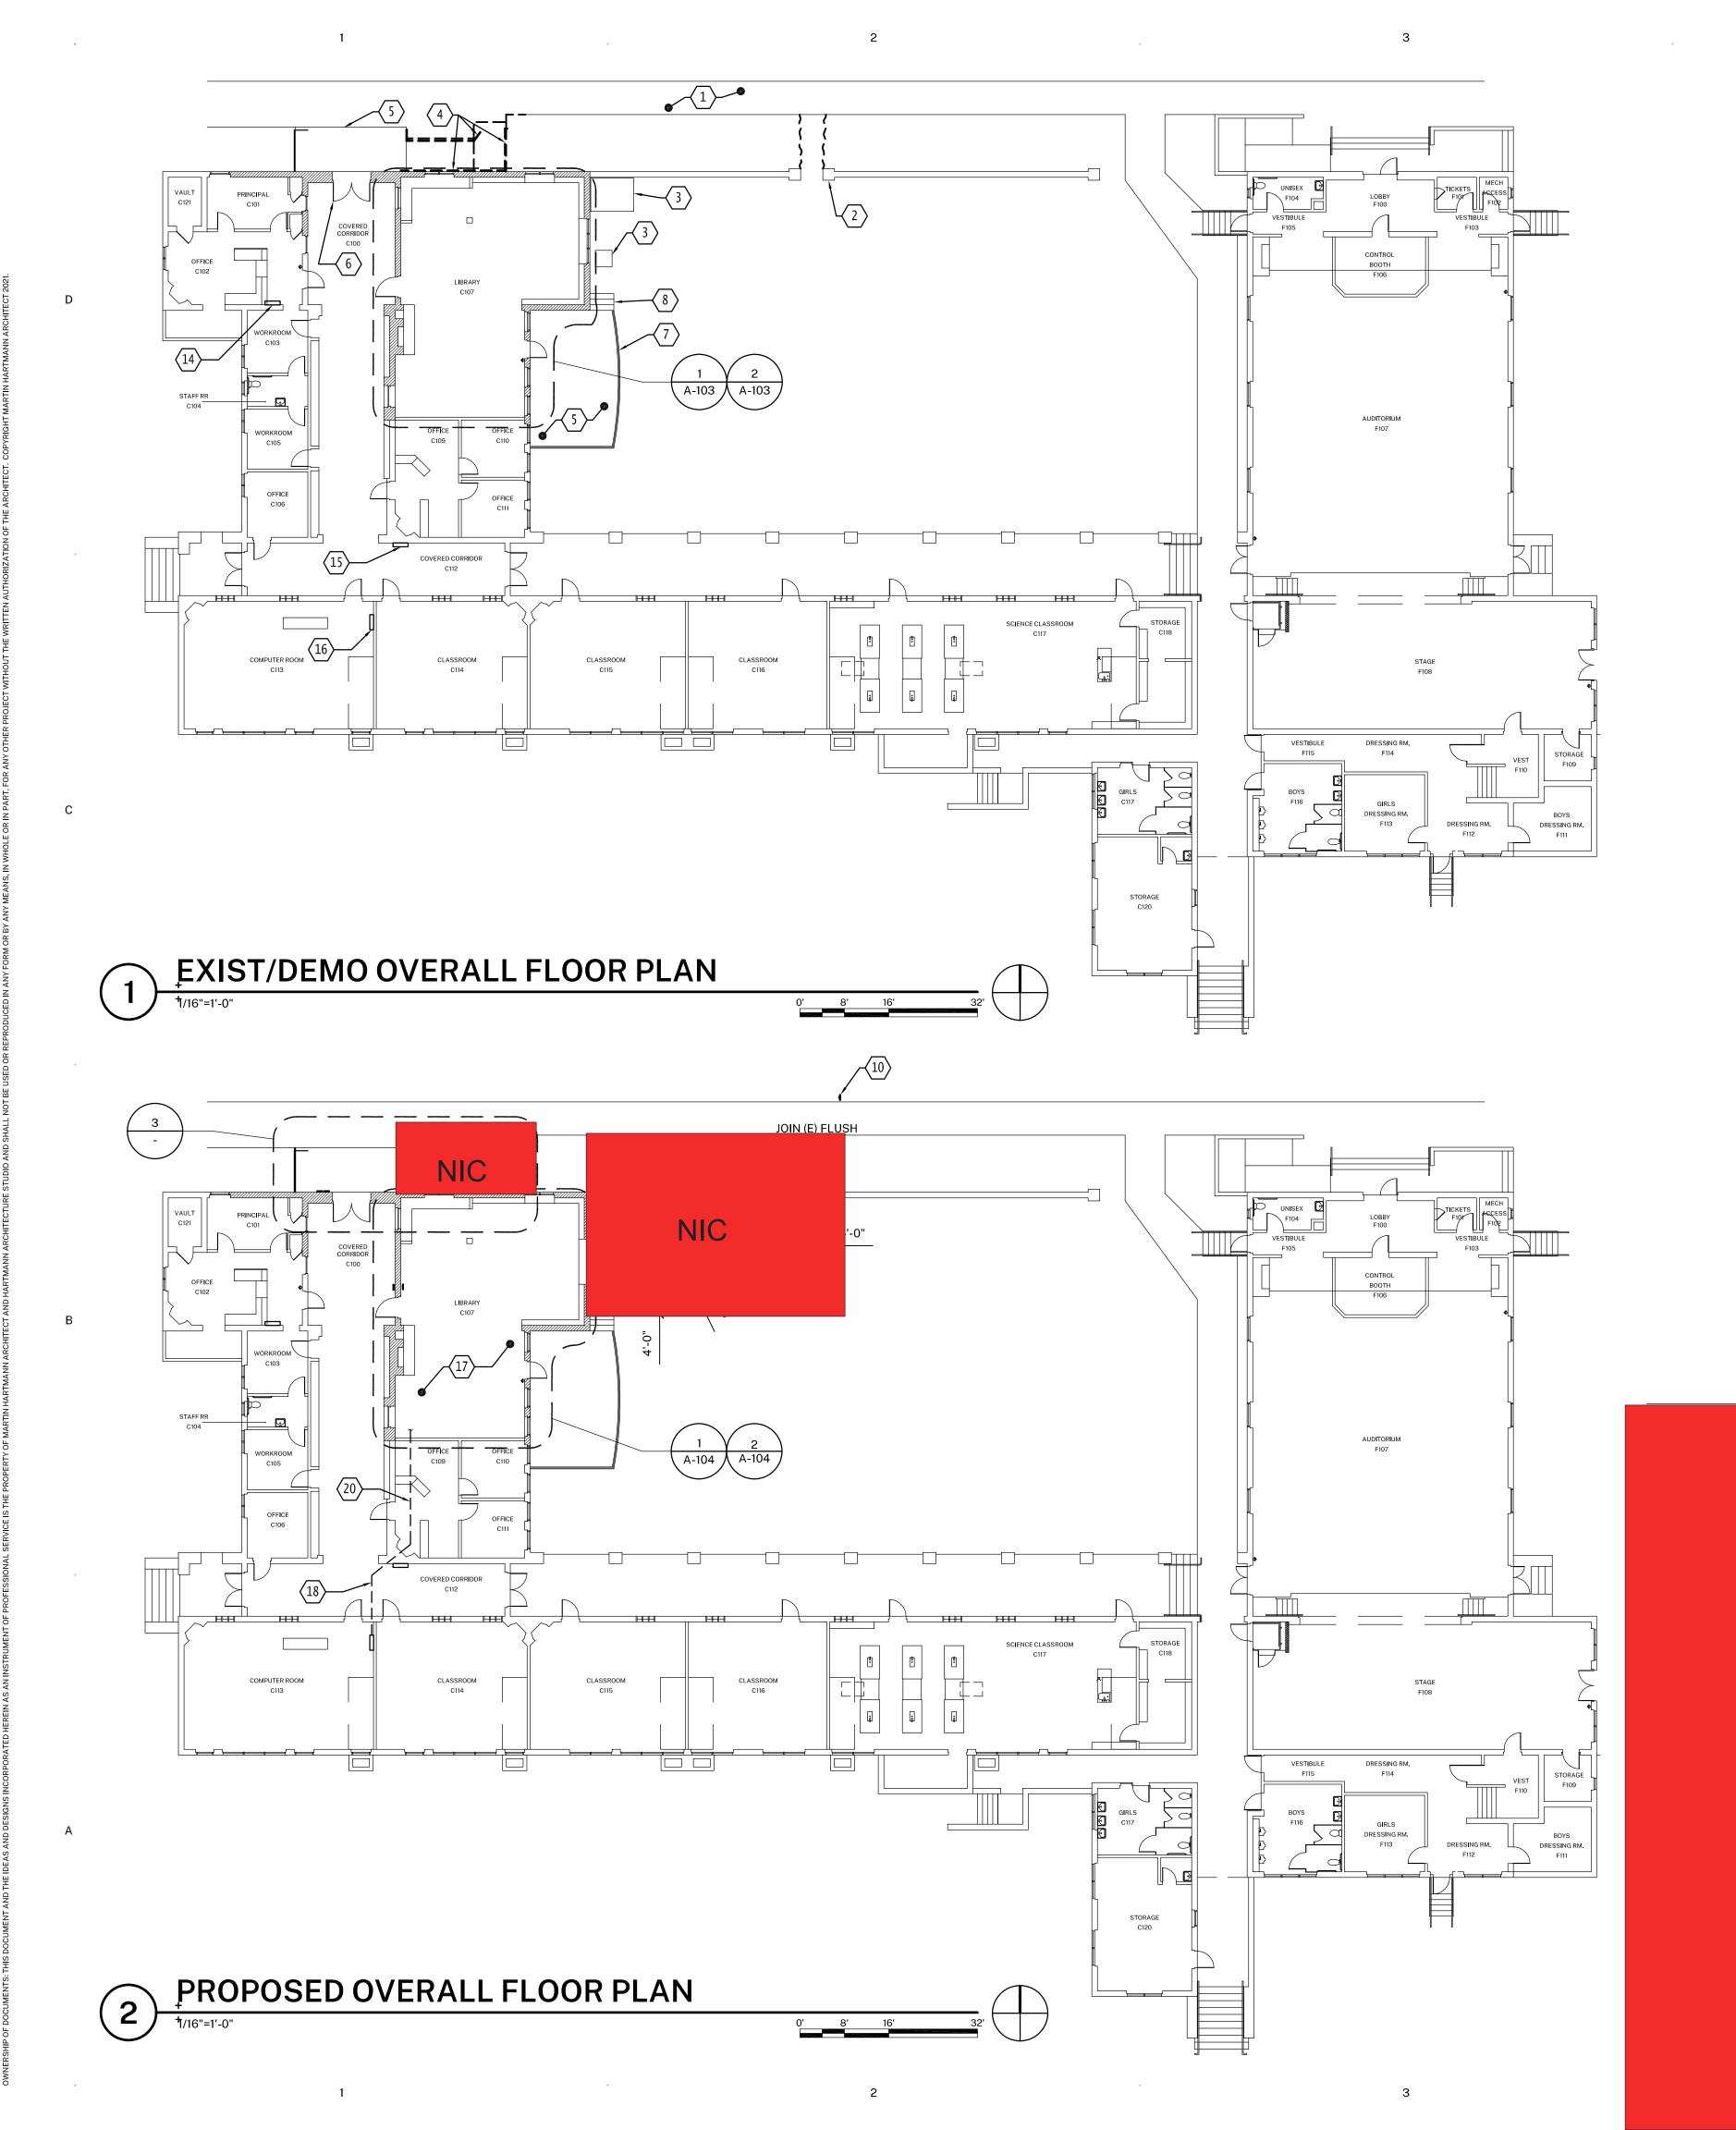

SHEET KEYNOTES

NOT ALL NOTES USED ON THIS SHEET

1. (E) CONCRETE WALK, TO REMAIN

2. (E) CONCRETE WALL, TO REMAIN

3. (E) EQUIPMENT, TO REMAIN 4. (E) CONCRETE RAMP AND METAL HANDRAILS, REMOVE

5. (E) CONCRETE LANDING, TO REMAIN

6. (E) METAL GATE, TO REMAIN 7. (E) METAL RAILS, TO REMAIN

8. (E) STAIRS, TO REMAIN

9. CRUSHED STONE PAVING 10. ACCESSIBLE DIRECTIONAL SIGNAGE, SEE 6/A-302

11. CONCRETE JOINT PER 10/A-302 12. CONCRETE RAMP AND CURB

13. METAL HANDRAIL, PAINT TO MATCH EXISTING BUILDING METAL RAILINGS

14. (E) FIRE ALARM CONTROL PANEL, PROTECT PANEL AND CONNECTED COMPONENTS IN PLACE.

15. (E) ORIGINAL ELECTRICAL SUBPANEL, TO REMAIN

16. (E) BUILDING ELECTRICAL PANEL, TO REMAIN 17. FIELD VERIFY EXISTING POWER AND WIRING CONDITIONS IN LIBRARY. REUSE EXISTING BRANCH CIRCUITS WHERE FEASIBLE.

18. ALLOW FOR REMOVAL AND REPLACEMENT OF (E) 12"x12" GLUE-ON TILE CEILING FINISH TO ACCOMMODATE NEW ELECTRICAL WIRING FROM (E) PANEL TO AREA OF

19. REMOVE AND REINSTALL (E) SUSPENDED ACOUSTIC CEILING TILES TO

ACCOMMODATE NEW ELECTRICAL WIRING.

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CONSULTANTS:

AGENCY APPROVAL:

Not In Contract

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(805) 640-4300 ATTN: ADAM DUTTER, BOND MANAGER adutter@ojaiusd.org

PROJECT ADDRESS:

OJAI, CA 93023

MATILIJA MIDDLE SCHOOL 703 EL PASEO RD. OJAI, CA 93023

MARK DATE DESCRIPTION

PROJECT INFORMATION:

PROJECT NUMBER: PROJECT PHASE:

DRAWN BY: **REVIEWED BY:**

EXIST/DEMO & PROPOSED

OVERALL FLOOR PLANS & PROPOSED ENTRY PLAN

A-102

DATE: 11/10/2021

DEMOLITION NOTES

1. IN ACCORDANCE WITH PERTINENT ITEMS OF THESE NOTE AND THOSE ITEMS SO INDICATED ON THE DRAWINGS "CAREFULLY" DEMOLISH AND REMOVE FROM THE JOB SITE THOSE ITEMS SCHEDULED TO BE SO DEMOLISHED ANREMOVED. 2. ALL EXISTING CONDITIONS REPRESENTED MUST BE VERIED IN THE FIELD. 3. USE ADEQUATE NUMBERS OF SKILLED WORKMEN WHO ARE MOROUGHLY

TRAINED AND EXPERIENCED IN THE NECESSARY CRAFTS ANDWHO ARE COMPLETELY FAMILIAR WITH THE SPECIFIED REQUIREMENTS AND THE METHODS NEEDED FOR PROPER PERFORMANCE OF THE WORK. 4. SURFACE CONDITIONS: EXAMINE THE AREAS AND CONDI**TIONS** UNDER WHICH

WORK WILL BE PERFORMED. CORRECT CONDITIONS DETRIMEMAL TO TIMELY AND PROPER COMPLETION OF THE WORK. DO NOT PROCEED UNTUNSATISFACTORY CONDITIONS ARE CORRECTED. 5. DEMOLITION: BY CAREFUL STUDY OF THE DRAWINGS, DEERMINE THE LOCATION

AND EXTENT OF SELECTIVE DEMOLITION TO BE PERFORMED. 6. VISIT THE SITE AND VERIFY THE EXTENT AND LOCATIONOF SELECTIVE

DEMOLITION REQUIRED. 7. CAREFULLY IDENTIFY LIMITS OF SELECTIVE DEMOLITION

8. MARK INTERFACE SURFACES AS REQUIRED TO ENABLE WORMAN ALSO TO IDENTIFY ITEMS TO BE REMOVED AND ITEMS TO BE LEFT/IPLACE INTACT. 9. PREPARE AND FOLLOW AN ORGANIZED PLAN FOR DEMOLION AND REMOVAL

10. COMPLETELY REMOVE ITEMS SCHEDULED TO BE SO DEMOSHED AND REMOVED, LEAVING SURFACES CLEAN, SOLID, AND READY OF RECEIVE NEW MATERIALS SPECIFIED ELSEWHERE.

11. SALVAGE: AFTER CAREFUL REVIEW OF THE DRAWINGS SOWING PROPOSED NEW CONSTRUCTION, IDENTIFY THOSE ITEMS THAT ARE GOD CANDIDATES FOR RE-USE AND CAREFULLY REMOVE AND STOCKPILE THEM ON SITEN A PROTECTED

12. DEMOLISHED MATERIALS SHALL BE CONSIDERED TO BE ROPERTY OF THE CONTRACTOR AND SHALL BE COMPLETELY REMOVED FROM THEOB SITE. 13. REPLACEMENTS: IN THE EVENT OF DEMOLITION OF ITESINOT SO SCHEDULED TO BE DEMOLISHED, PROMPTLY REPLACE SUCH ITEMS TO THAPPROVAL OF THE DESIGNER AND AT NO ADDITIONAL COST TO THE OWNER.

14. IT SHALL BE THE RESPONSIBILITY OF THE OWNER TOETERMINE THE PRESENCE OR NON-PRESENCE OF HAZARDOUS AND/OR TOXIC CONSTRUCTON MATERIALS IN THE EXISTING BUILDING. IF HAZARDOUS AND/OR TOXIC MATERIALS ARE ENCOUNTERED, THEN THE OWNER SHALL IMMEDIATELY NOTIF THE CONTRACTOR AND THE ARCHITECT AND TAKE APPROPRIATE REMEDIAL ACION PURSUANT TO ALL STATE AND FEDERAL LAWS PERTAINING TO SAID MATERIALS

15. DURING DEMOLITION AND CONSTRUCTION, THE CONTRACTR SHALL PROVIDE ADEQUATE CONTROL MEASURES TO PREVENT THE MIGRATION DEMOLITION AND CONSTRUCTION-RELATED DEBRIS AND OTHER POTENTIAL COMAMINANTS SUCH AS MOISTURE, DUST, VAPORS, UNNECESSARY NOISE, ETC INTOCCUPIED AREAS OF THE SITE AND ADJOINING PUBLIC AREAS.

16. DURING DEMOLITION AND CONSTRUCTION, THE CONTRACTR SHALL BE RESPONSIBLE FOR PROTECTING ALL EXISTING TREES, LANSCAPING AND PAVING SURFACES DURING CONSTRUCTION.

17. TERMINATE ALL ELECTRICAL CONDUITS CONTAINED IN WILLS TO BE DEMOLISHED PER CEC 2019. CONDUITS FEEDING DEMOLISHEAREAS, BUT CONTAINED WITHIN CONSTRUCTION TO REMAIN MAY BE ABANDONED IN PLACE. 18. REMOVE ABANDONED WASTE LINES.

19. RE-USE EXISTING PLUMBING LINES IN PLACE WHERE PRCTICAL. 20. THE DISPOSAL OF ALL DEMOLISHED MATERIALS SHALL E IN ACCORDANCE WITH ALL APPLICABLE LAWS AND ORDINANCES.

21. UNLESS CALLED OUT TO BE SALVAGED FOR RE-USE, ALITEMS NOT NOTED AS "EXISTING TO REMAIN" ARE TO BE REMOVED AND DISCARDD. 22. CONSTRUCTION WASTE REDUCTION, DISPOSAL AND RECYCING R334.1 CGBC


23. DECONSTRUCTION, DEMOLITION, AND CONSTRUCTION DERIS DIVERSION: 23.1. CONTRACTOR TO DEVISE AND IMPLEMENT A DECONSTR**O**TION, DEMOLITION, AND CONSTRUCTION DEBRIS PROGRAM. THE ROGRAM SHALL BE PRESENTED AND APPROVED BY THE OWNER'S REPRESENTAVE PRIOR TO COMMENCEMENT OF WORK. WASTE PREVENTION AND RECYCLIG ACTIVITIES TO BE DISCUSSED AT THE BEGINNING OF EACH SAFETY MEEING. SUBCONTRACTORS TO COMPLY WITH THE CONTRACTOR'S PRORAM. 23.2. DECONSTRUCTION: EXISTING MATERIALS NOTED TO EXESCARDED AND IDENTIFIED AS RE-USABLE SUCH AS WALL TILE, PLUMBING HARDWARE, LIGHT FIXTURES, TOILET PARTITIONS, ET. TO BE CAREFULY REMOVED, MINIMALLY PROCESSED, SORTED AND SECURELY STORED FORONATION TO HABITAT FOR HUMANITY'S RESTORE ((805) 981-2268) OR SIMILAR SALVAGE COMPANY. CONTRACTOR TO PROVIDE WRITTEN DOCUMENTAON THAT RE-USABLE ITEMS HAVE BEEN ACCEPTED OR REJECTED BY SALAGE COMPANY. 23.3. DEMOLITION: EXISTING MATERIALS NOTED TO BE **DIA**RDED AND IDENTIFIED AS NOT RE-USABLE BUT RECYCLABLE SUCH ASSYPSUM BOARD, METALS, GLASS, CONCRETE, ETC. TO BE REMOVED AND HALED TO DEL NORTE REGIONAL RECYCLING & TRANSFER FACILITY ((805) 278-8200) OR SIMILAR FACILITY FOR RECYCLING. CONTRACTOR TO PROVIDE WRITEN DOCUMENTATION THAT RECYCLABLE ITEMS HAVE BEEN ACCEPED BY DISPOSAL FACILITY.


23.4. CONSTRUCTION: RECYCLABLE CONSTRUCTION WASTE MERIALS SUCH AS METAL, CARDBOARD, WOOD, PLASTIC, GLASS, ETCTO BE SORTED AND RECYCLED.

24. CONTRACTOR SHALL SCHEDULE A PRE-DEMOLITION INSPECTION PRIOR TO THE START OF THE WORK

25. CONTRACTOR TO FIELD VERIFY BUILDING AND SITE UTITY LOCATIONS AND UTILITY SHUT-OFFS PRIOR TO DEMOLITION. 26. PATCH/REPAIR/FINISH ALL AREAS OF WOOD FLOORING ELOW WALLS AND

BOOKCASES THAT ARE SCHEDULED TO BE REMOVED. 27. REMOVE ALL REMAINING EXISTING ACOUSTICAL WALL PAILS WHERE OCCURS

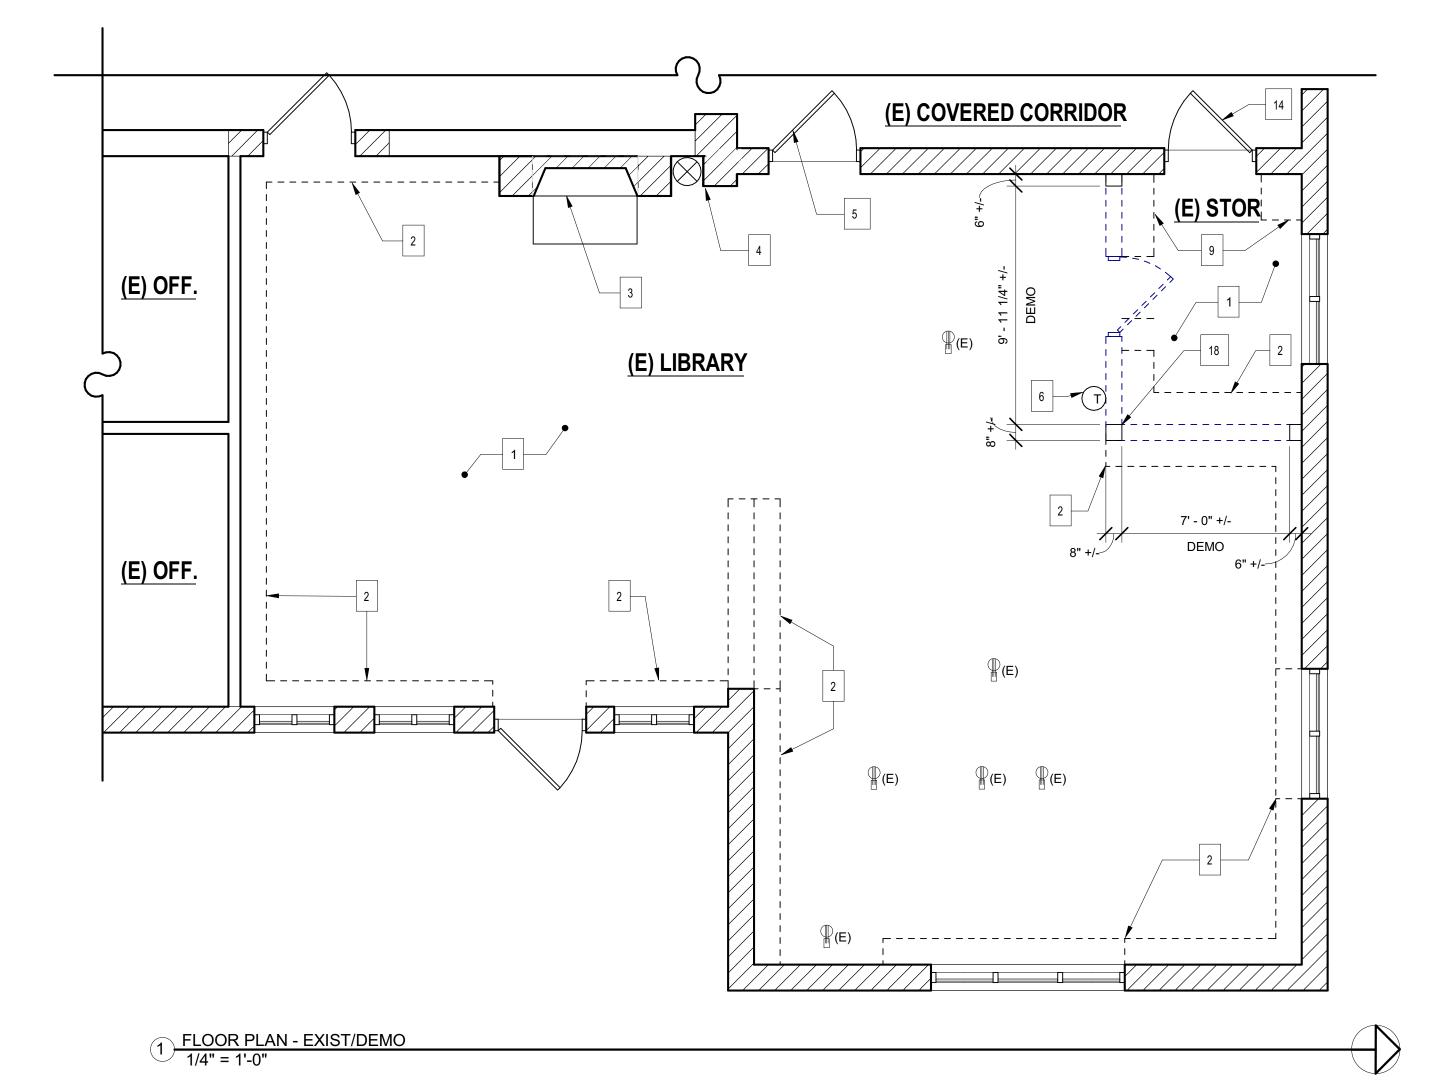

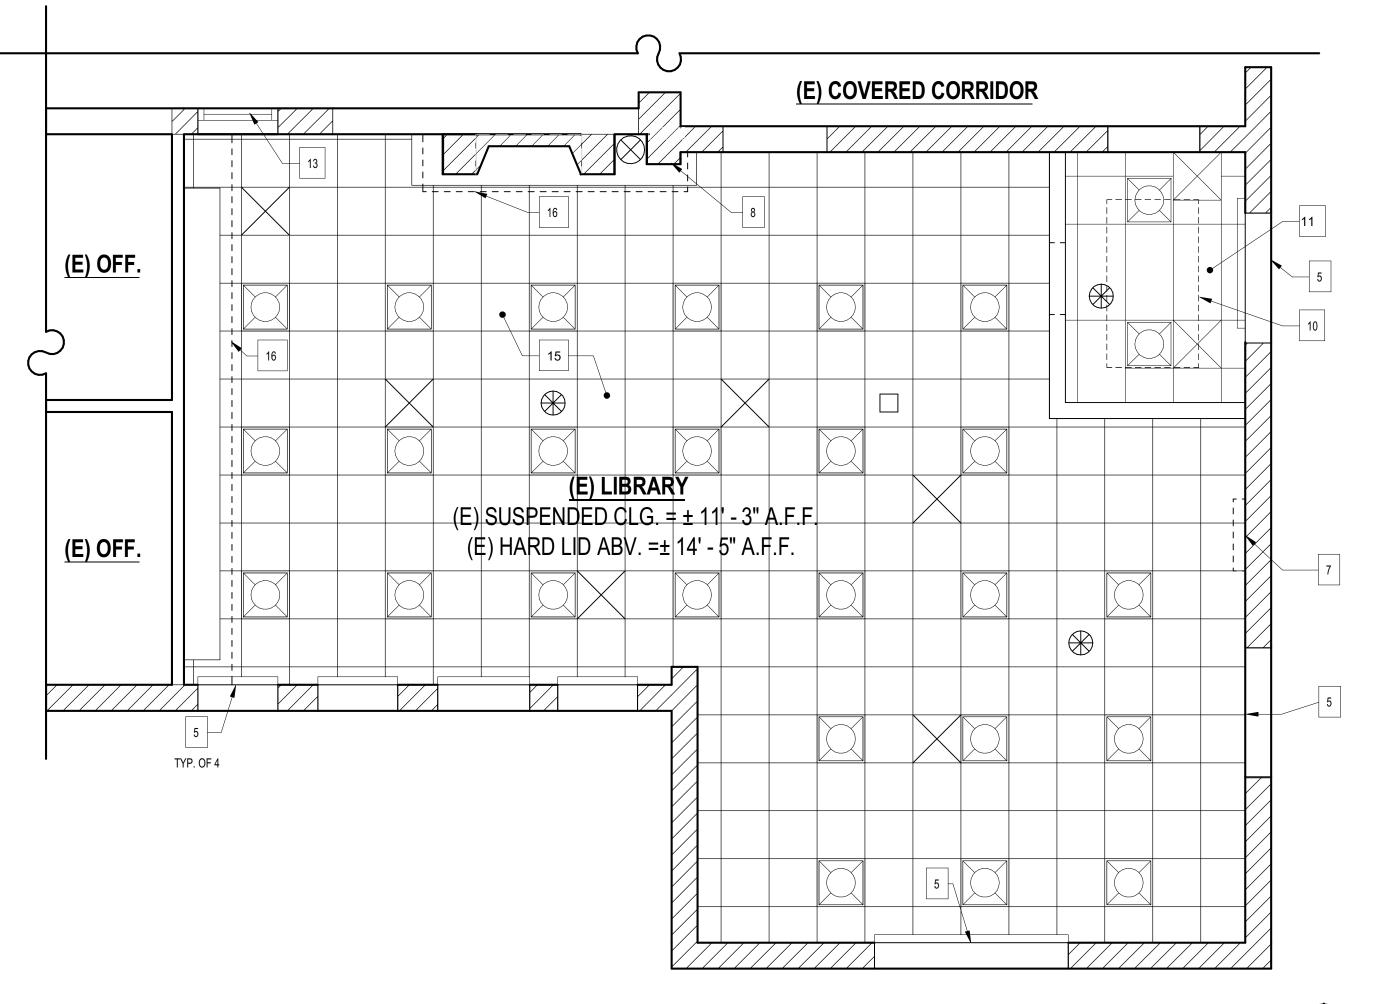

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CONSULTANTS:

AGENCY APPROVAL:

- - - - - (E) WOOD-FRAMED WALL, REMOVE U.N.O.

(E) WOOD-FRAMED WALL W/ GYPSUM PLASTER, TO REMAIN

(E) CONCRETE WALL, TO REMAIN

SYMBOL LEGEND

(E) DOOR, TO REMAIN

(E) LIGHT FIXTURE, TO REMAIN

(E) FIRE ALARM DEVICE, TO REMAIN, PROTECT IN PLACE



(E) MECHANICAL REGISTER, TO REMAIN

(E) FLOOR-MOUNTED POWER & DATA RECEPTACLE GANGED BXES, TO REMAIN, REPLACE RECEPTACLES IN EXISTING LOCATION, BFURBISH AND PROVIDE BRASS COVER PLATES, REPAIR FLOORING AREQ'D.

SHEET KEYNOTES

- 1. (E) CARPET, REMOVE FLOORING, PAD, ADHESIVE, STAPS & RUBBER BASE THROUGHOUT TO EXPOSE (E) WOOD FLOORS AND LEAVE A SONOTH, UNIFORM SURFACE
- (E) BOOKCASE, REMOVE, PATCH & PAINT EXPOSED WALS.
- (E) ABANDONED FIREPLACE & HEARTH, TO REMAIN
- 4. (E) AIR DUCT & RETURN AIR REGISTER, TO REMAIN 5. (E) ROLLER SHADE, TO REMAIN
- 6. (E) THERMOSTAT, REMOVE & RELOCATE
- 7. (E) WALL CLOCK & BELL, REMOVE & DISCARD
- 8. (E) SPEAKER, REMOVE AND REINSTALL
- 9. (E) CABINET, REMOVE 10. (E) HAVAC UNIT & DUCT WORK ABV., TO REMAIN
- 11. (E) SUSPENDED ACOUSTICAL TILE CEILING, TO REMAJ REMOVE& REPLACE TILES REPLACE TILES ONLY.
- 12. (E) WINDOW, TO REMAIN, FIX IN POSITION
- 13. (E) TRANSOM WINDOW, TO REMAIN, APPLY OPAQUE FINE TO BACK OF WINDOW
- 14. (E) ROLLER SHADE, REMOVE AND RETURN TO DISTRICT
- 15. (E) SUSPENDED ACOUSTICAL TILE CEILING, TO REM**AI** U.N.O. PROTECT IN PLACE 16. (E) SUSPENDED ACOUSTICAL TILE CEILING, REMOVEMODIFY, AND REINSTALL TO ACCOMMODATE WORK
- 17. (E) PLUG MOLD, WIRING & RECEPTACLES, REMOVE ANDEUSE BRANCH CIRCUITS WHERE POSSIBLE
- 18. (E) POWER & REFRIGERANT LINES FOR HVAC UNIT IN ABOVE, TO REMAIN, PROTECT IN PLACE.



MATILIJA MIDDLE SCHOOL LIBRARY RENOVATION

OWNER:

ISSUE:

OJAI UNIFIED SCHOOL DISTRICT414 E. OJAI AVENUE OJAI, CA 93023 (805)640-4300

CONTACT: ADAM DUTTER, BOND MANAGER EMAIL: adutter@ojaiusd.org

PROJECT ADDRESS:

MATILIJA MIDDLE SCHOOL 703 EL PASEO ROAD OJAI, CA 93023

MARK	DATE	DESCRIPTION

2020.032

PBS/MH

PROJECT INFORMATION: PROJECT NUMBER:

PROJECT PHASE: DRAWN BY:

REVIEWED BY: THE ORIGINAL SIZE OF THIS SHEET IS 36"x24". IF THE CURRENT SIZE IS OTHER THAN 36"x24", THEN ADJUST THE SCALE OF THE DRAWINGS ACCORDINGLY.


SHEET TITLE:

EXISTING/DEMO PLANS

SHEET NUMBER:

A-103

DATE: 11/10/2021 6:59:15 PM

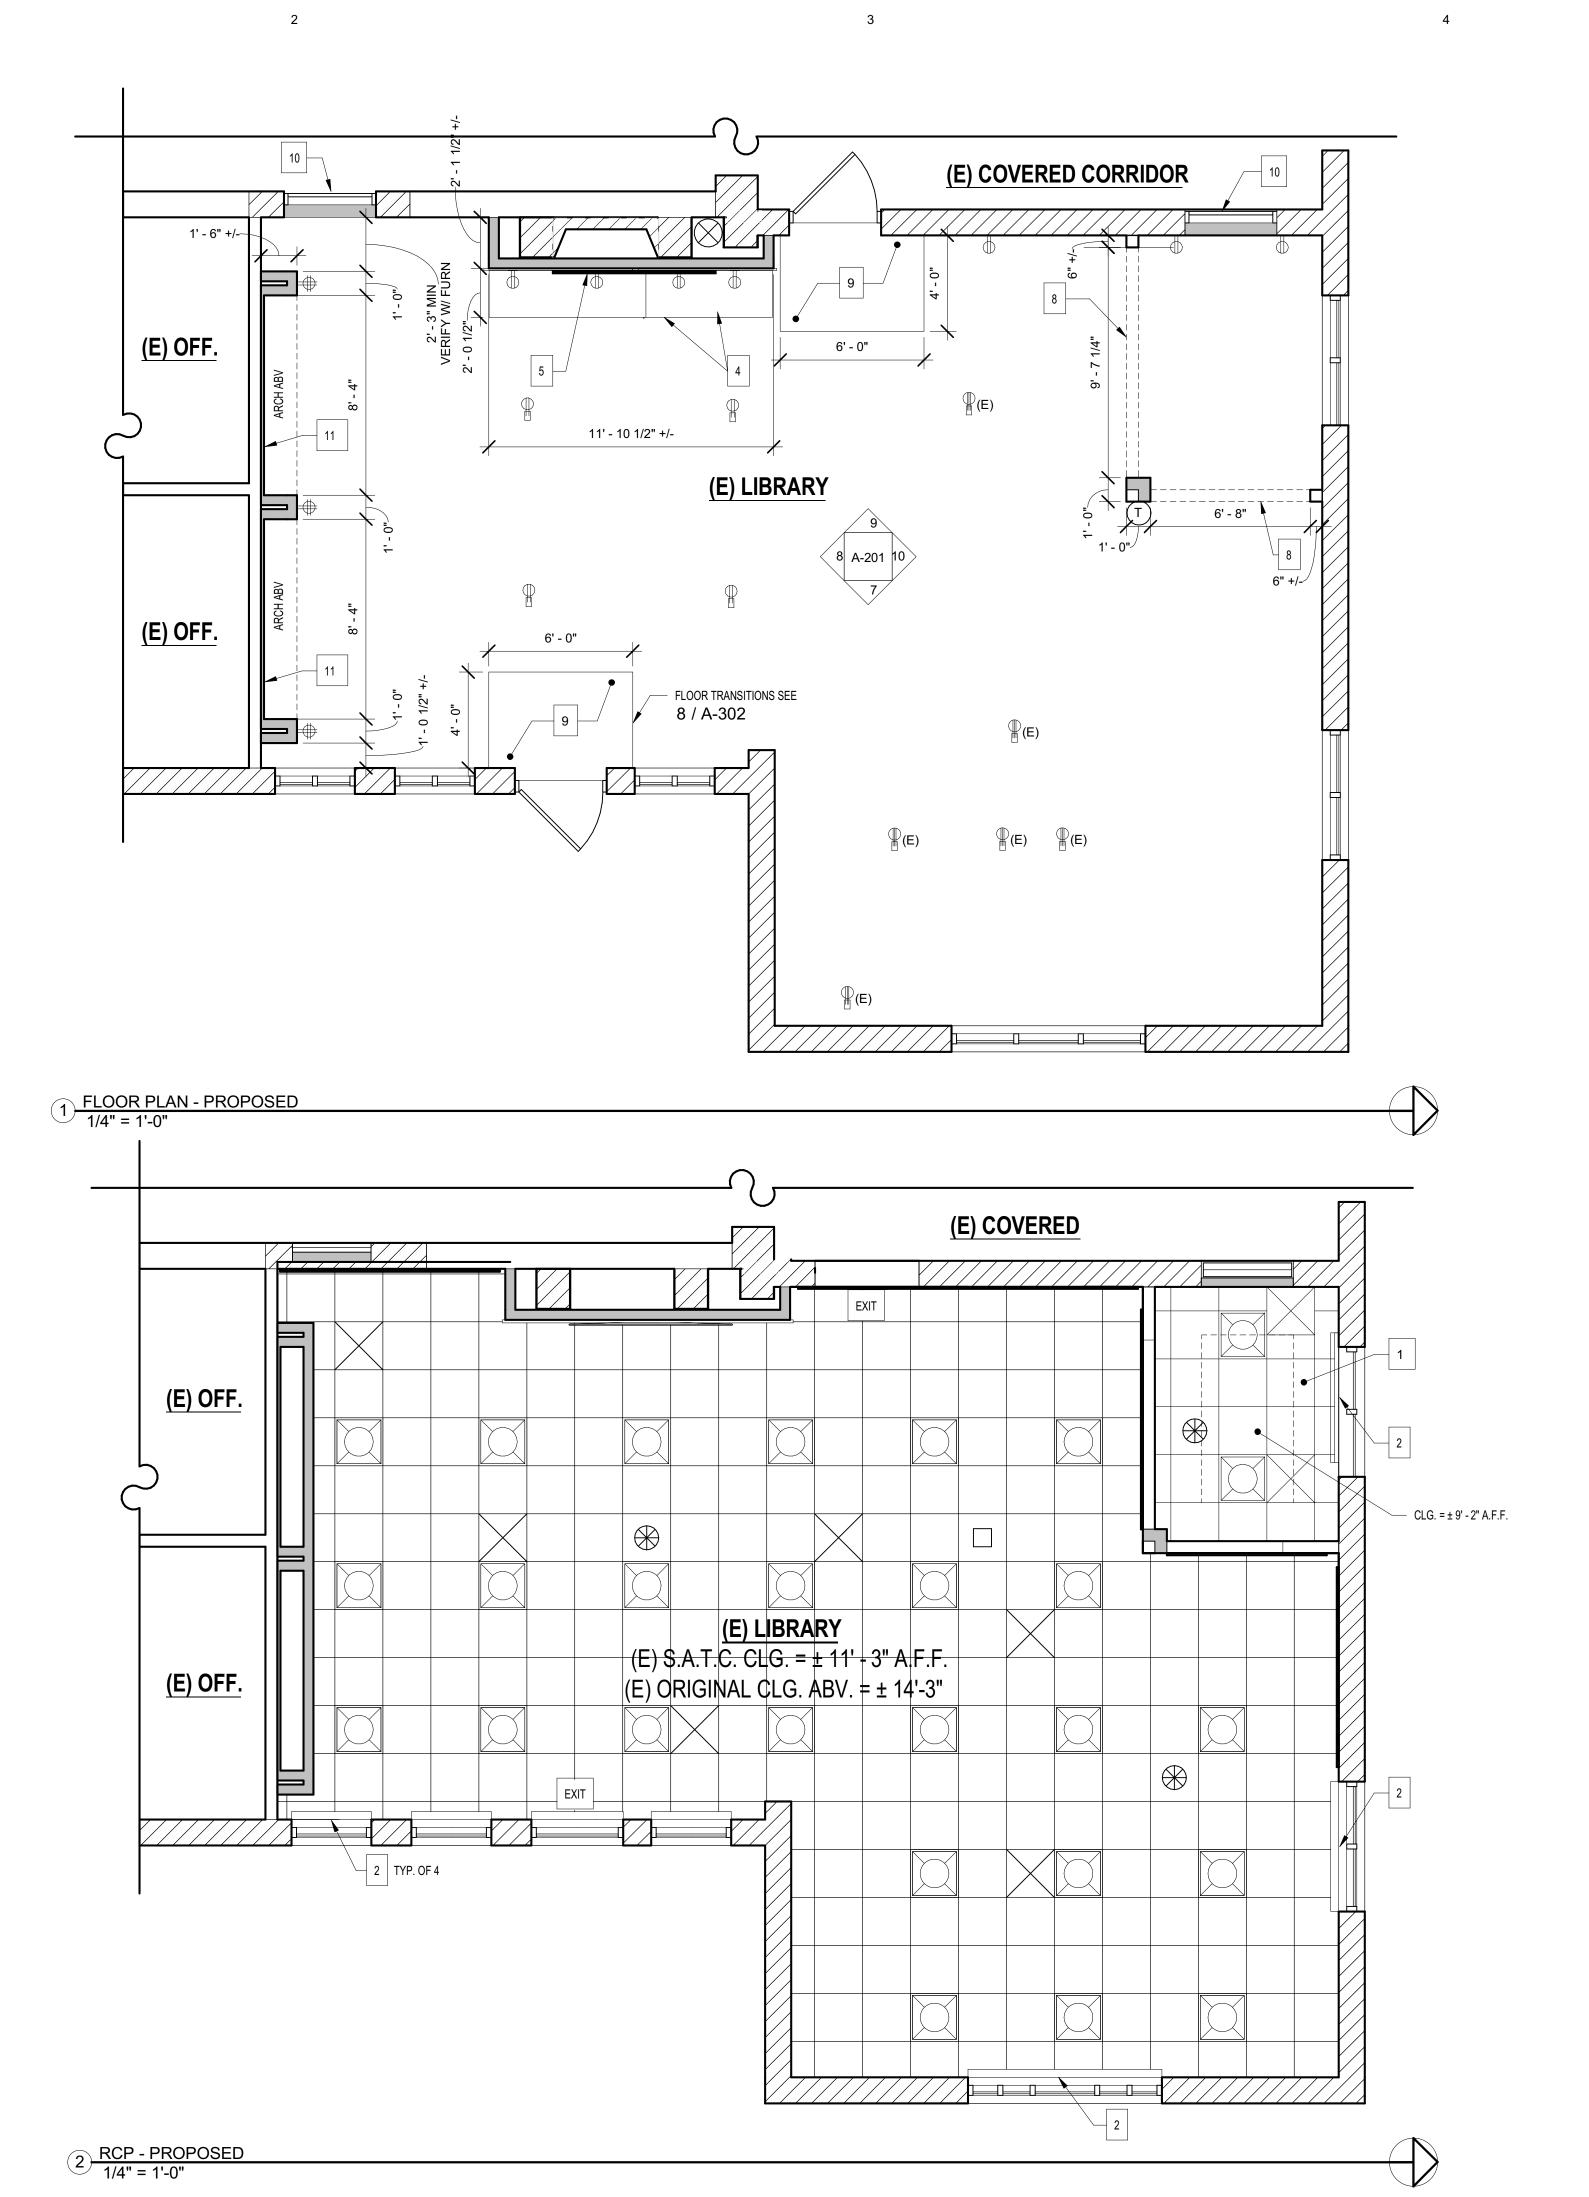

GENERAL NOTES

- 1. ROLLER WINDOW FASCIA NOTES:
- A. CONTINUOUS REMOVABLE EXTRUDED ALUMINUM FASCIA THAT ATTACHED TO SHADE MOUNTING BRACKETS WITHOUT THE USE OF ADHESSES, MAGNETIC STRIPS, OR EXPOSED FASTENERS.
- B. FASCIA SHALL BE ABLE TO BE INSTALLED ACROSS TWOOR MORE SHADE BANDS IN ONE PIECE.
- C. FASCIA SHALL FULLY CONCEAL BRACKETS, SHADE ROLL® AND FABRIC ON THE TUBE.
- D. PROVIDE BRACKET / FASCIA END CAPS WHERE MOUNTING ONDITIONS EXPOSE OUTSIDE OF ROLLER SHADE BRACKETS. NOTCHING OF FASCIA FOR MANUAL CHAIN SHALL NOT BEACCEPTABLE.
- INSPECT SUBFLOOR CRAWLSPACE PRIOR TO COMMENCINGWORK. REPAIR/REPLACE DAMAGED AND ROTED FLOOR FRAMING, IANY EXISTS. INSULATE UNDERSIDE OF FLOOR WITH UNFACED FIBERGLASSINSULATION, R-19
- VALUE REPAIR/REPLACE ALL UNDERFLOOR VENT SCREENINGN PROJECT AREA. DO NOT USE POWDER DRIVEN FASTENERS IN (E) CONCRE. PREDRILL HOLES AND USE TAPCON SCREWS OR EQUAL.
- 4. (E) GLUE-ON 12"x12" ACOUSTIC TILE ON ORIGINAL CEING IS ASSUMED TO HAVE ASBESTOS CONTAINING MATERIALS. COMPLY WITH ALL REGILATIONS NECESSARY FOR ABATEMENT WHERE TILES ARE REMOVED TOCCOMMODATE THE WORK.
- 5. FIELD VERIFY ALL POWER RECEPTACLE LOCATIONS WITHDISTRICT PRIOR TO

SYMBOL LEGEND

2x6 WOOD-FRAMED FULL HEIGHT NONBEARING WALL W/ 5/8" TYPE X GYPSUM BOARD OVER 3/8" PLYWOOD, FINISH TO MATCH (E) YPSUM PLASTER, PROVIDE CONTROL JOINTS AT MATERIAL TRANSITONS, ATTACH TO ORIGINAL CEILING JOISTS ABV, SEE GEN. FRIMING NOTES & DTLS 17 - 20/ A-302 & 4/A-301

(E) WALL, TO REMAIN

(E) CONCRETE WALL, TO REMAIN

(E) DOOR, TO REMAIN, REMOVE + REPLACE (E) DOOR HARDARE WITH PANIC HARDWARE, SEE DETAILS 2 AND 3 / A-302

FLOOR-MOUNTED POWER RECEPTACLES, FIELD VERIFY LOCATIONS W/ OWNER AND (E) POWER PANEL

(E) FLOOR-MOUNTED POWER & DATE RECEPTACLES, TO REMM, SEE

- QUAD PLEX WALL MOUNTED POWER RECEPTACLE, FIELD VERY LOCATIONS W/ OWNER AND (E) POWER PANEL
- DUPLEX WALL MOUNTED POWER RECEPTACLE, FIELD VERIFYOCATIONS W/ OWNER AND (E) POWER PANEL

EXIT SIGN, SELF-ILLUMINATED

SHEET KEYNOTES

- 1. (E) SUSPENDED ACOUSTIC TILE CEILING, TO REMAIR, EPLACE (E) CEILING TILES ONLY, ARMSTRONG MODEL #1135 IMPRESSION 24"x48", TOUCH UP PAINT ON GRID
- 2. ANODIZED ALUMINUM VALENCE OVER (E) ROLLER SHADE
- BOOKCASE
- 4. BASE CABINET W/ COUNTERTOP
- 5. FLAT PANEL TELEVISION AND MOUNTING BRACKET, OFCI
- 6. NOT IN USE
- 7. TALL CABINET
- 8. LINE OF HEADER ABV. SEE GEN. FRAMING NOTES & DTS 17 20 / A-302
- CARPET
- 10. (E) DOOR, COAT GLASS WITH OPAQUE FILM, FIX INLACE, WEATHERSTRIP 11. APPLY 1/4" GYPSUM BOARD VENEER OVER (E)WOOD SIDUWALL AS SACRIFICIAL LAYER FOR GLUED-ON ACOUSTIC PANELS.



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CONSULTANTS:

AGENCY APPROVAL:

SEALS:



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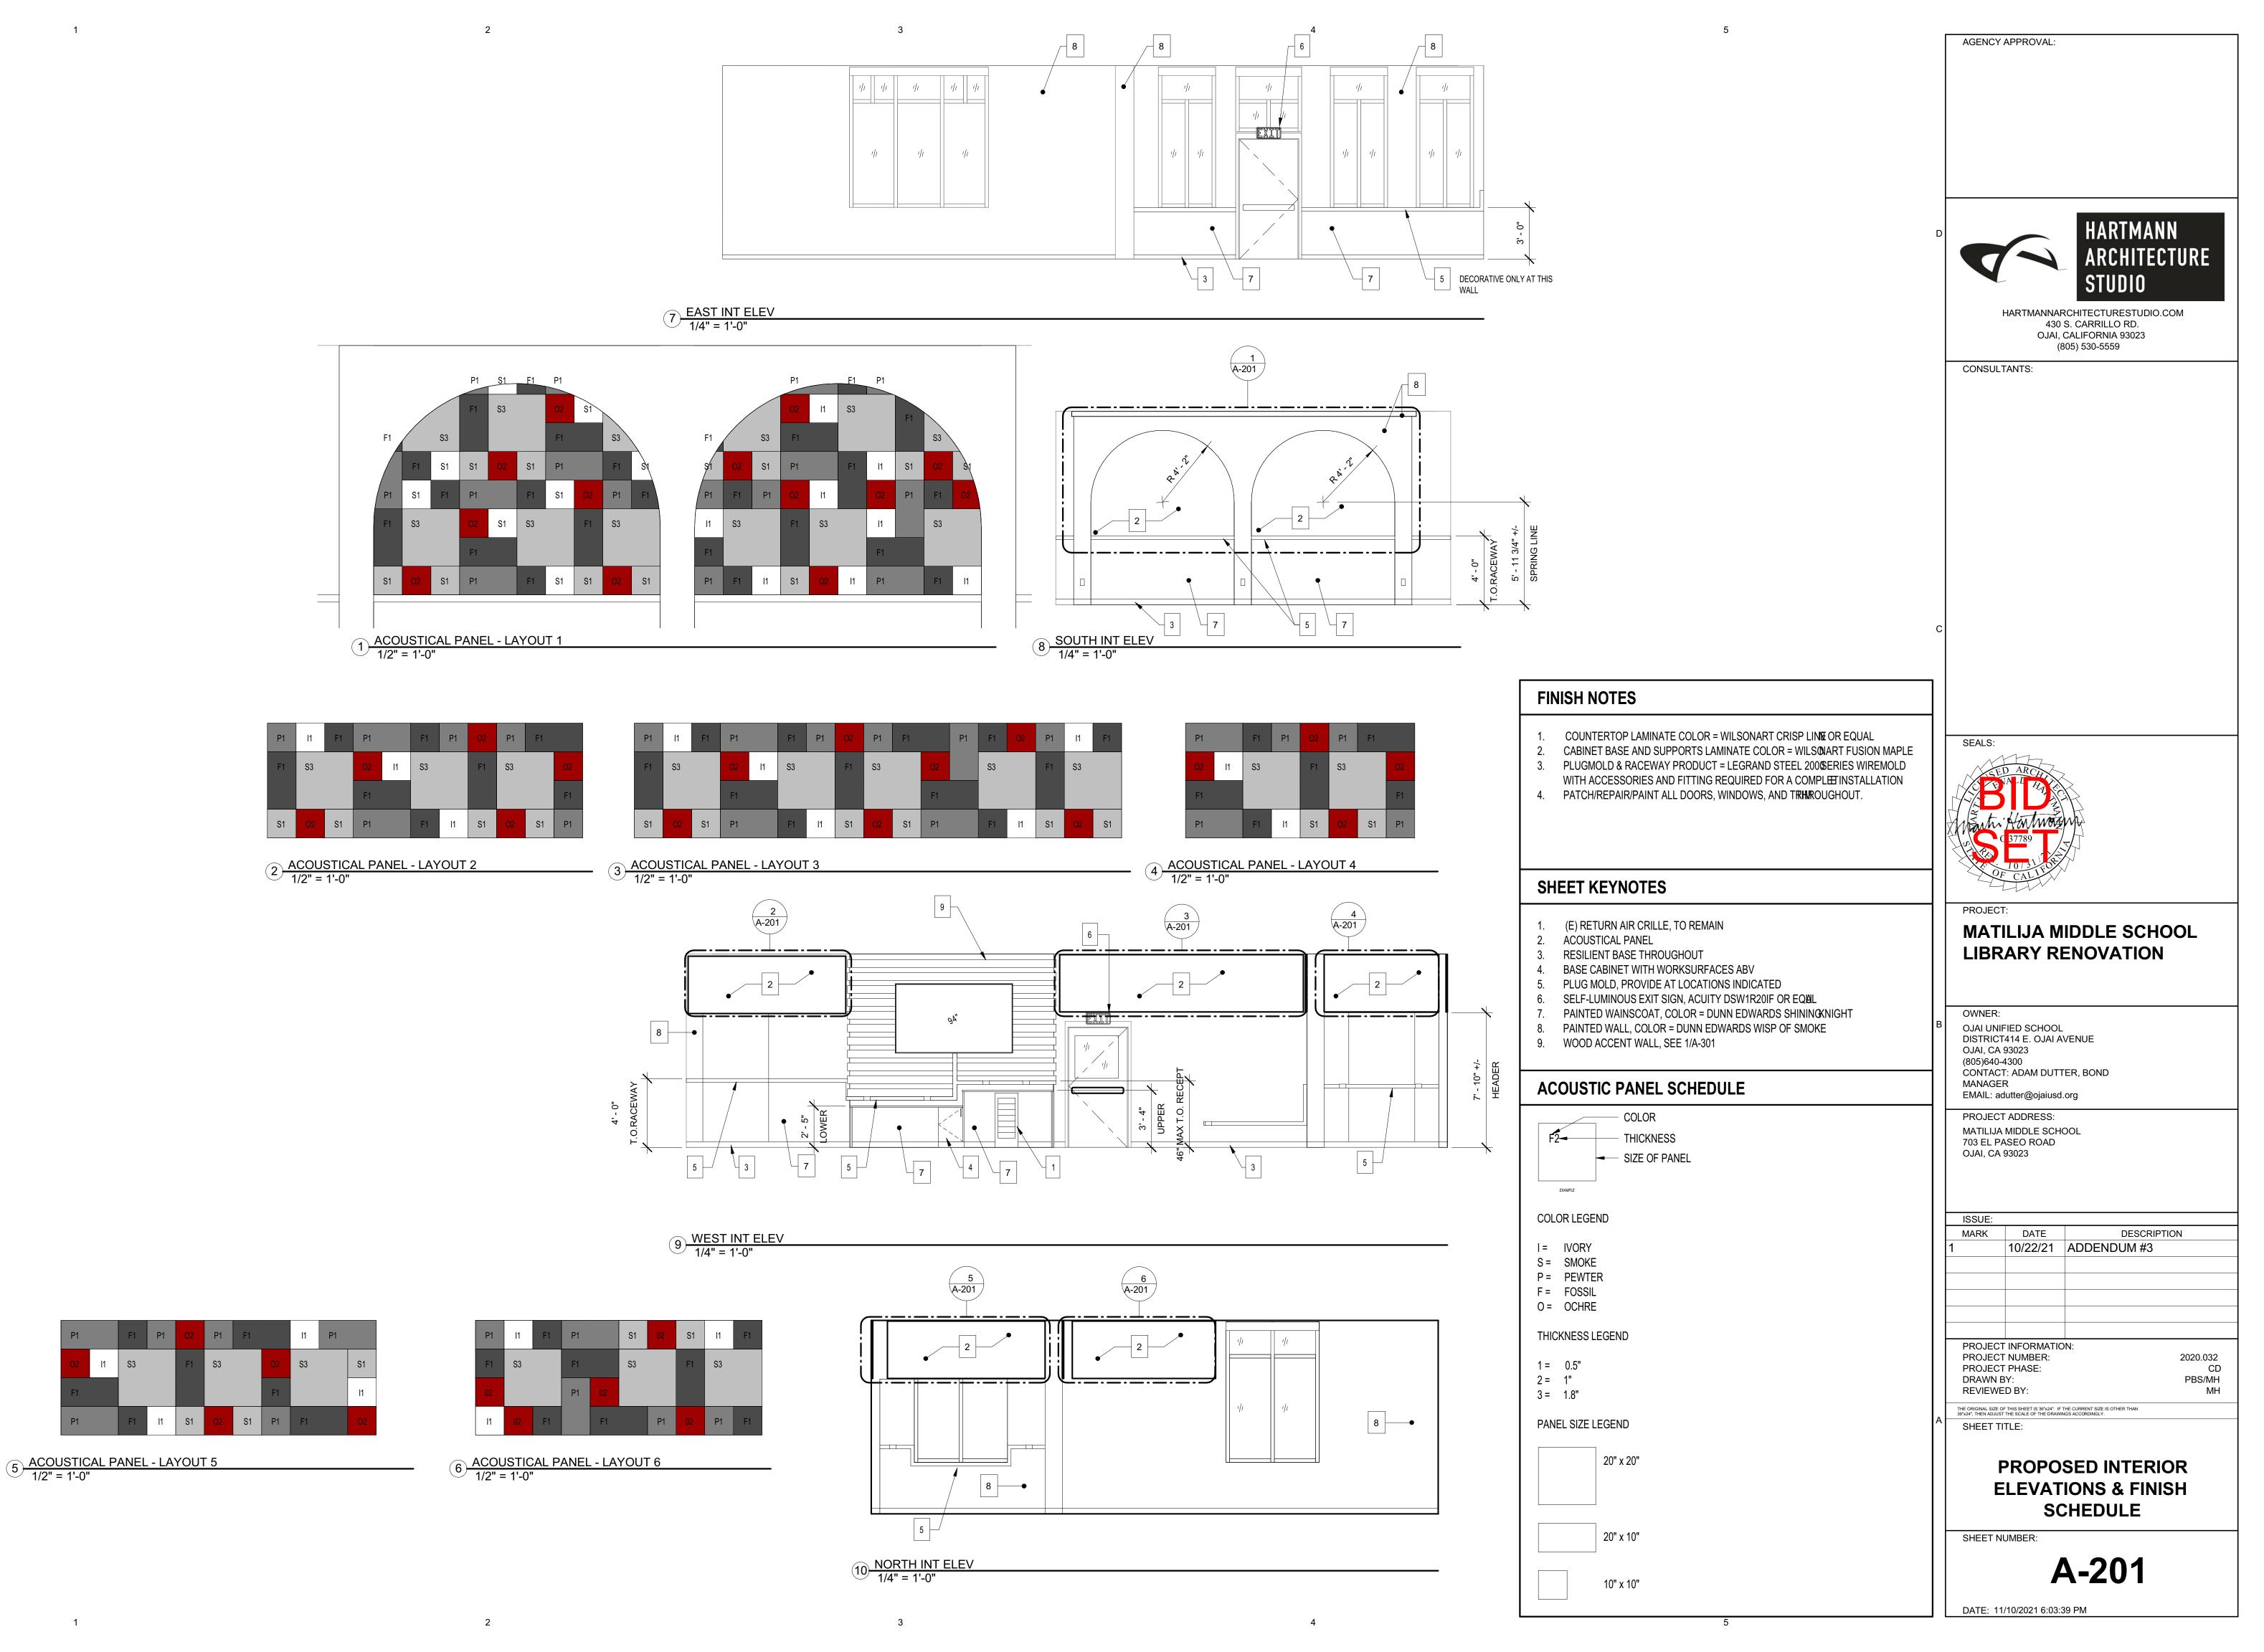
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PROPOSED PLANS

SHEET NUMBER:

A-104

DATE: 11/10/2021 6:59:15 PM



С

ROOF OR FLOOR JOIST

2-16d EA. SIDE

SIMPSON HTC
CLIP @ 24" O.C.,
TYP. U.O.N.

2x STUDS @ 16"
O.C., TYP. U.O.N.


FLOOR PLY

16d @ 16" O.C.


FLOOR PLY

(N) WALL PARTITION FRAMING
3/4" = 1'-0"


PROVIDE BRIDING AT 6'-0" O.C. MAX.

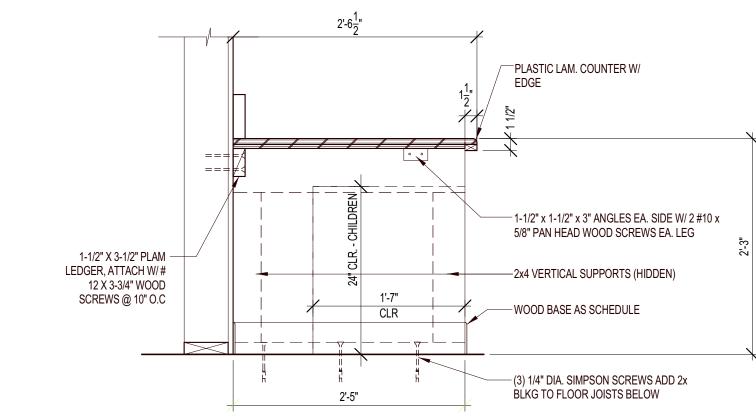

(A) SECTION AT WORK TOP END SUPPORT

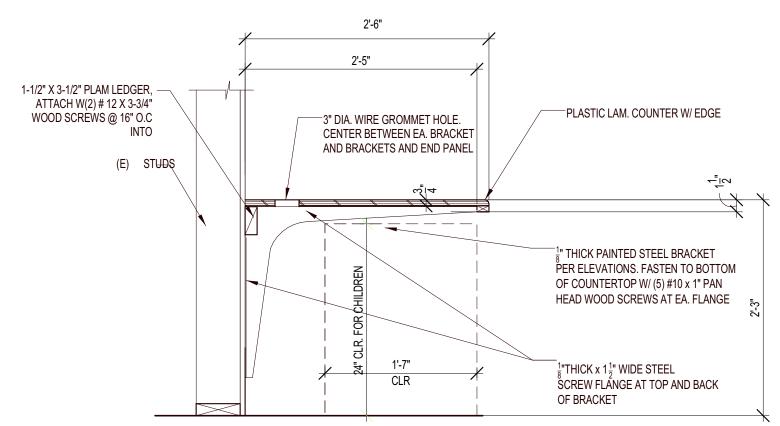



B SECTION AT WORK TOP METAL BRACKET

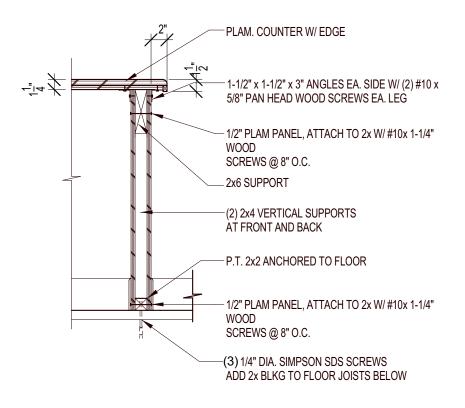

(C) SECTION AT END SUPPORT


3 TYPICAL WORK TOP DETAILS
1" = 1'-0"

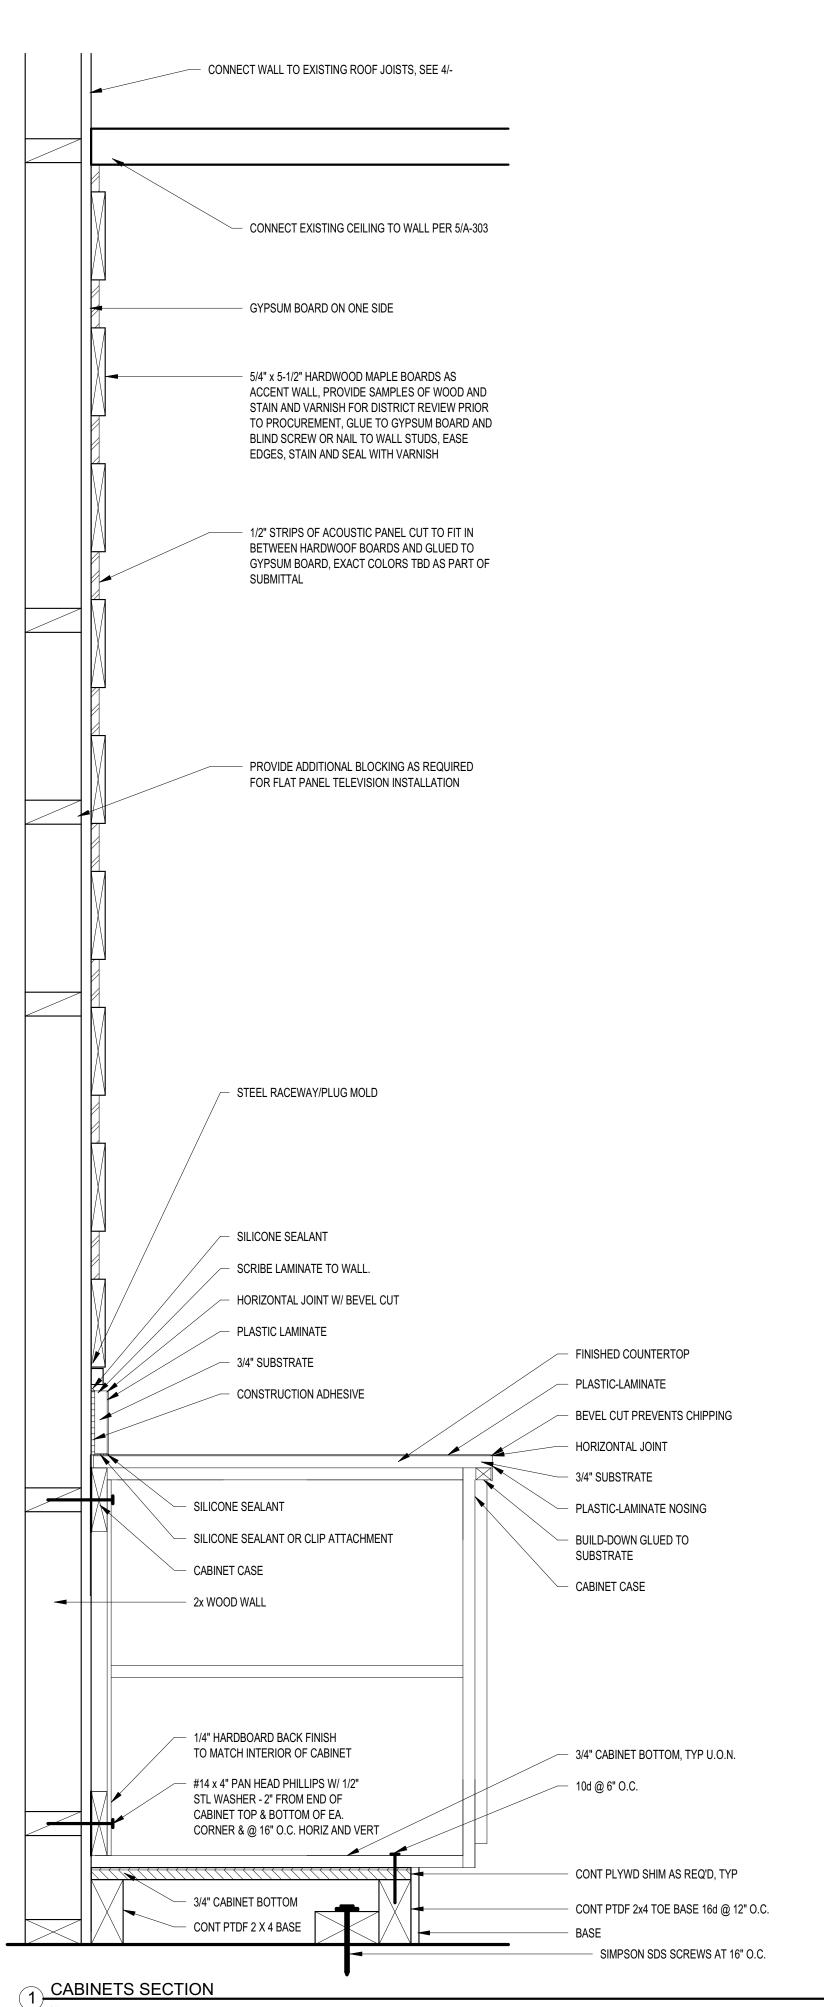

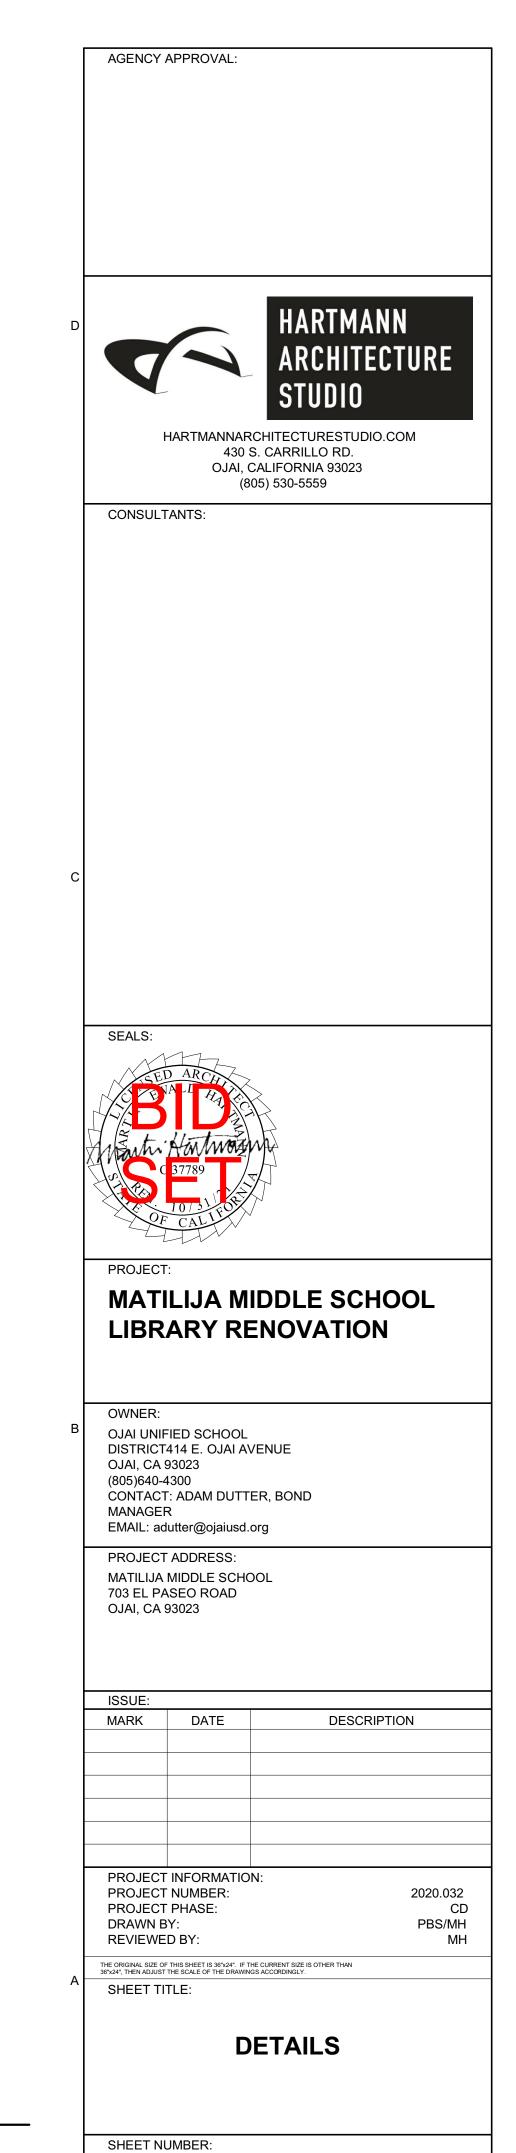


A-301


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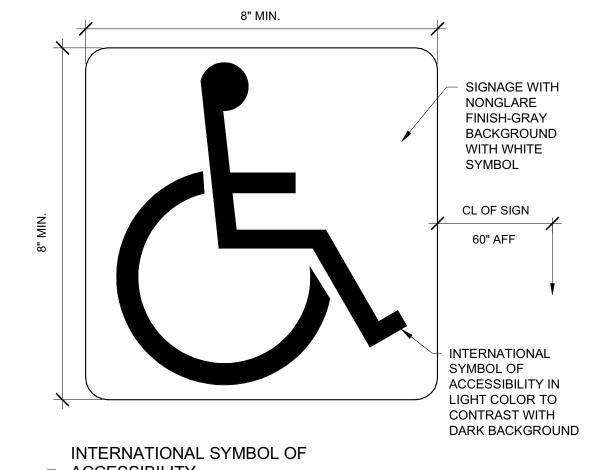


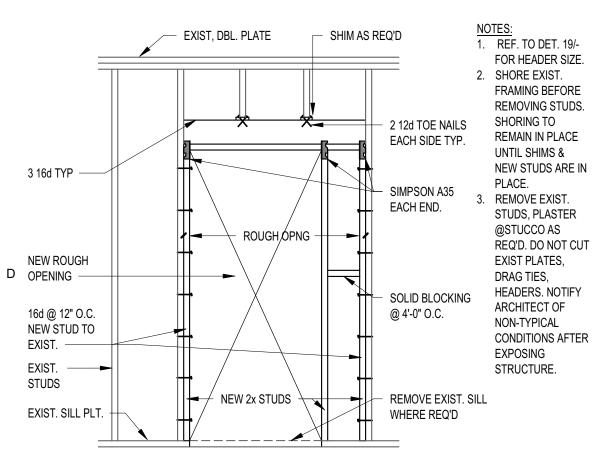(N) OPENING IN (E) STUD WALL 12" = 1'-0"

Not In Contract



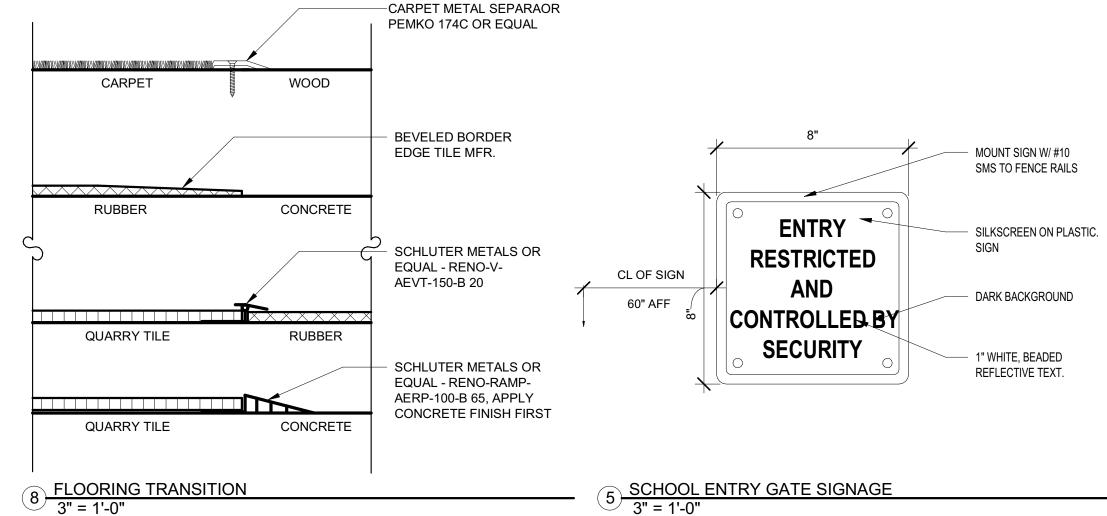

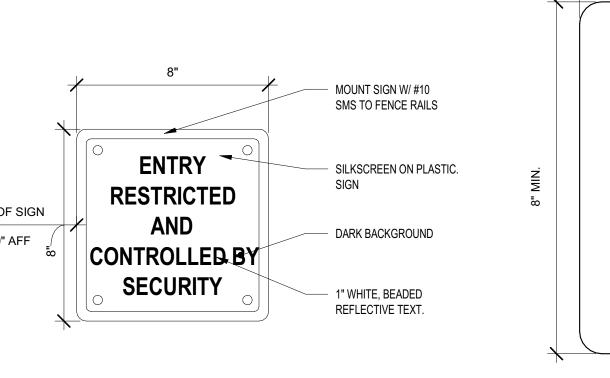

HARTMANNARCHITECTURESTUDIO.COM 430 S. CARRILLO RD.

OJAI, CALIFORNIA 93023


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CONSULTANTS:

AGENCY APPROVAL:

- ADD SHEATING TO MATCH EXIST. (WHERE OCCURS) | HEADER | EXIST. 2x STUDS @ 16" O.C. 🗕 NEW 2x W/16d @ 8" O.C. (2) 8d TOE NAILS ea. SIDE TYP. NEW 2x W/16d @ 8" O.C. EXISTING OPENING NEW 2x P.T.D.F. SILL PL. TO BE FILLED IN. -ON DRY PACK AS REQ'D NEW 2x @ 16" O.C. TOP OF EXISTING AT BEARING WALL: FOUNDATION -1/4"Ø, x 3-1/2" HILTI 'KH-EZ EXIST. SILL PLATE -[ICC ESR-3027] @ 24" o.c., EMBED 1-5/8" (MIN. 3 REQ'D.) AT NON -BEARING WALL: EF. TO STRUCTURAL EXISTING FOUNDATION **ENEAL NOTES**


18 FILL EXISTING OPENING IN STUD WALL 12" = 1'-0"

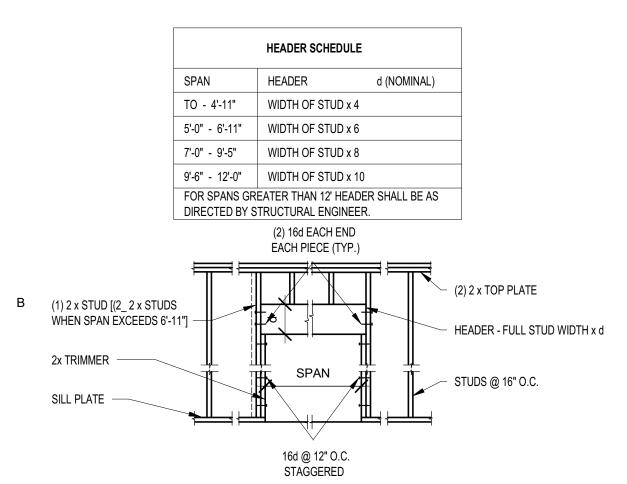

TYPICAL MINIMUM HEADERS FOR 19 INTERIOR NON-BEARING WALLS
6" = 1'-0"


NAILING SCHEDULE		(1)	NAIL DIMENSIONS		
<u> </u>		<u>NAI</u>	<u>L</u>	DIAMETER	LENGTH
CONNECTION	NAILING	(2)			
JOIST TO SILL OR GIRDER. TOE NAIL	(3) - 8d	20d		0.192"	4"
BLOCKING TO JOIST, EACH END	(2) - 16d				
SOLE PLATE TO JOIST OR BLOCKING, FACE NAIL	16d AT 16" O.C.	16d		0.162"	3-1/2"
TOP PLATE TO STUD, END NAIL	(2) - 16d				
STUD TO SOLE PLATE, TOE NAIL	(4) - 8d	10d		0.148"	3"
DOUBLE STUDS, FACE NAIL	16d AT 24" O.C.			••	·
DOUBLE TOP PLATES, FACE NAIL	16d AT 16" O.C.			0.131"	2-1/2"
TOP PLATES, LAPS & INTERSECTIONS. FACE NAIL	(4) - 16d (OR AS SPECIFIED)			0.101	2 1/2
CONTINUOUS HEADER, TWO PIECES	16d @ 16" (ALONG EA. EDGE)				
CEILING JOISTS TO PLATE, TOE NAIL	(3) - 8d				
CONT. HEADER TO STUD, TOE NAIL	(4) - 8d				
CEILING JOISTS, LAPS OVER PARTITIONS, FACE	(3) - 16d				
NAIL					
CEILING JOISTS TO PARALLEL RAFTERS, FACE	(3) - 16d				
NAIL					
RAFTER TO PLATE	(3) - 8d				
1" BRACE TO EA. STUD & PLATE, FACE NAIL	(2) - 8d (OR AS SPECIFIED)				
BUILT-UP CORNER STUDS	16d at 24" O.C.				
BUILT-UP GIRDERS & BEAMS	20d @ 32" O.C. (tTOP & BOTT. AND STAGGE	:RED)			
DIVAMOOD ELOOD A DOOF OUEATURIO	(2) - 20d @ ENDS				
PLYWOOD FLOOR & ROOF SHEATHING	JÓIST TO SILLL OR GIRDER, TOE NAIL				
NOTES:					
 MINIMUM NAILING ONLY. SEE DI 	ETAILS FOR LOCATIONSWHERE				
OTHER NAILING IS SPECIFIED.					
2. COMMON NAILS CONFORMING	O ASTM F1667 TO BE USED				
THROUGHOUT U.N.O.					
3. NAILS SPACED AT 6" O.C. AT ED	CES 12" O C AT INTERMEDIATE				
	•	,			
SUPPORTS (10" O.C. AT INTERM	EDIATE SUPPORTS FOR FLUIRS).			
NAILING SCHEDU	E				

Not In Contract

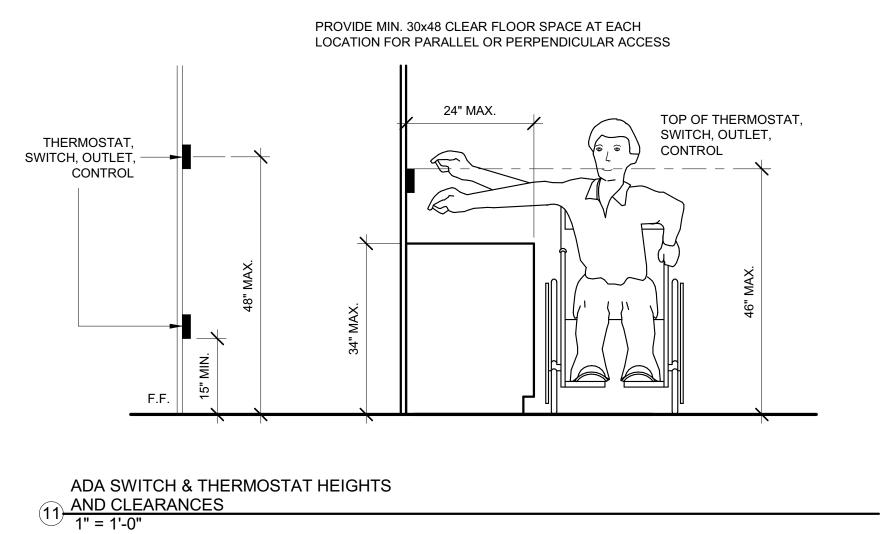

-ALLOWABLE REACH AREA COUNTER KNEE CLEARANCE

7 KNEE CLEARANCE 1/2" = 1'-0"

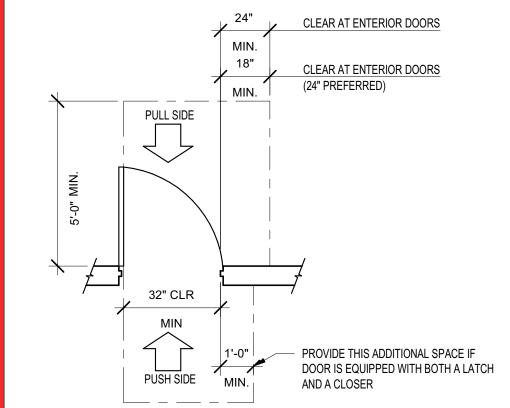

MANEUVERING CLEARANCE AT DOOR-FRONT APPROACH

EGRESS DOORS SHALL BE READILY CENTER OPENABLE FROM THE EGRESS SIDE DOOR OPENING WITHOUT THE USE OF A KEY OR HARDWARE WITHIN SPECIAL KNOWLEDGE OR EFFORT. MOUNTING HAND-ACTIVATED ACCESSIBLE DOOR OPENING HARDWARE ON ACCESSIBLE DOORS SHALL HAVE A SHAPE THAT IS EASY TO GRASP WITH ONE HAND AND DOES NOT REQUIRE TIGHT GRASPING, TIGHT PINCHING OR TWISTING OF THE WRIST TO OPERATE, I.E. LEVER TYPE. HAND-ACTIVATED ACCESSIBLE DOORS SHALL BE OPERABLE WITH A SINGLE EFFORT BY LEVER-TYPE HARDWARE, PANIC BARS, PUSH-PULL ACTIVATING BARS OR OTHER HARDWARE. SMOOTH, UNINTERRUPTED SURFACE MAXIMUM EFFORT TO OPERATE OR IF NARROW FRAME DOOR, THEN DOORS SHALL NOT EXCEED 5 LBF FOR PROVIDE A SMOOTH PANEL

EXTERIOR AND INTERIOR DOORS. ON THE PUSH SIDE, NOT REQUIRED FOR AUTOMATIC OR SLIDING DOORS ACCESSIBLE DOOR OPERATIONAL 3 <u>REQUIREMENTS</u> 1/2" = 1'-0"

Not In Contract

SEALS:

MATILIJA MIDDLE SCHOOL LIBRARY RENOVATION

OWNER: OJAI UNIFIED SCHOOL DISTRICT414 E. OJAI AVENUE OJAI, CA 93023 (805)640-4300 CONTACT: ADAM DUTTER, BOND MANAGER

EMAIL: adutter@ojaiusd.org

PROJECT ADDRESS: MATILIJA MIDDLE SCHOOL 703 EL PASEO ROAD OJAI, CA 93023

ISSUE: DESCRIPTION PROJECT INFORMATION: PROJECT NUMBER: 2020.032 PROJECT PHASE: PBS/MH DRAWN BY: REVIEWED BY:


THE ORIGINAL SIZE OF THIS SHEET IS 36"x24". IF THE CURRENT SIZE IS OTHER THAN 36"x24", THEN ADJUST THE SCALE OF THE DRAWINGS ACCORDINGLY. SHEET TITLE:


DETAILS

SHEET NUMBER:

A-302

DATE: 11/10/2021 6:03:40 PM

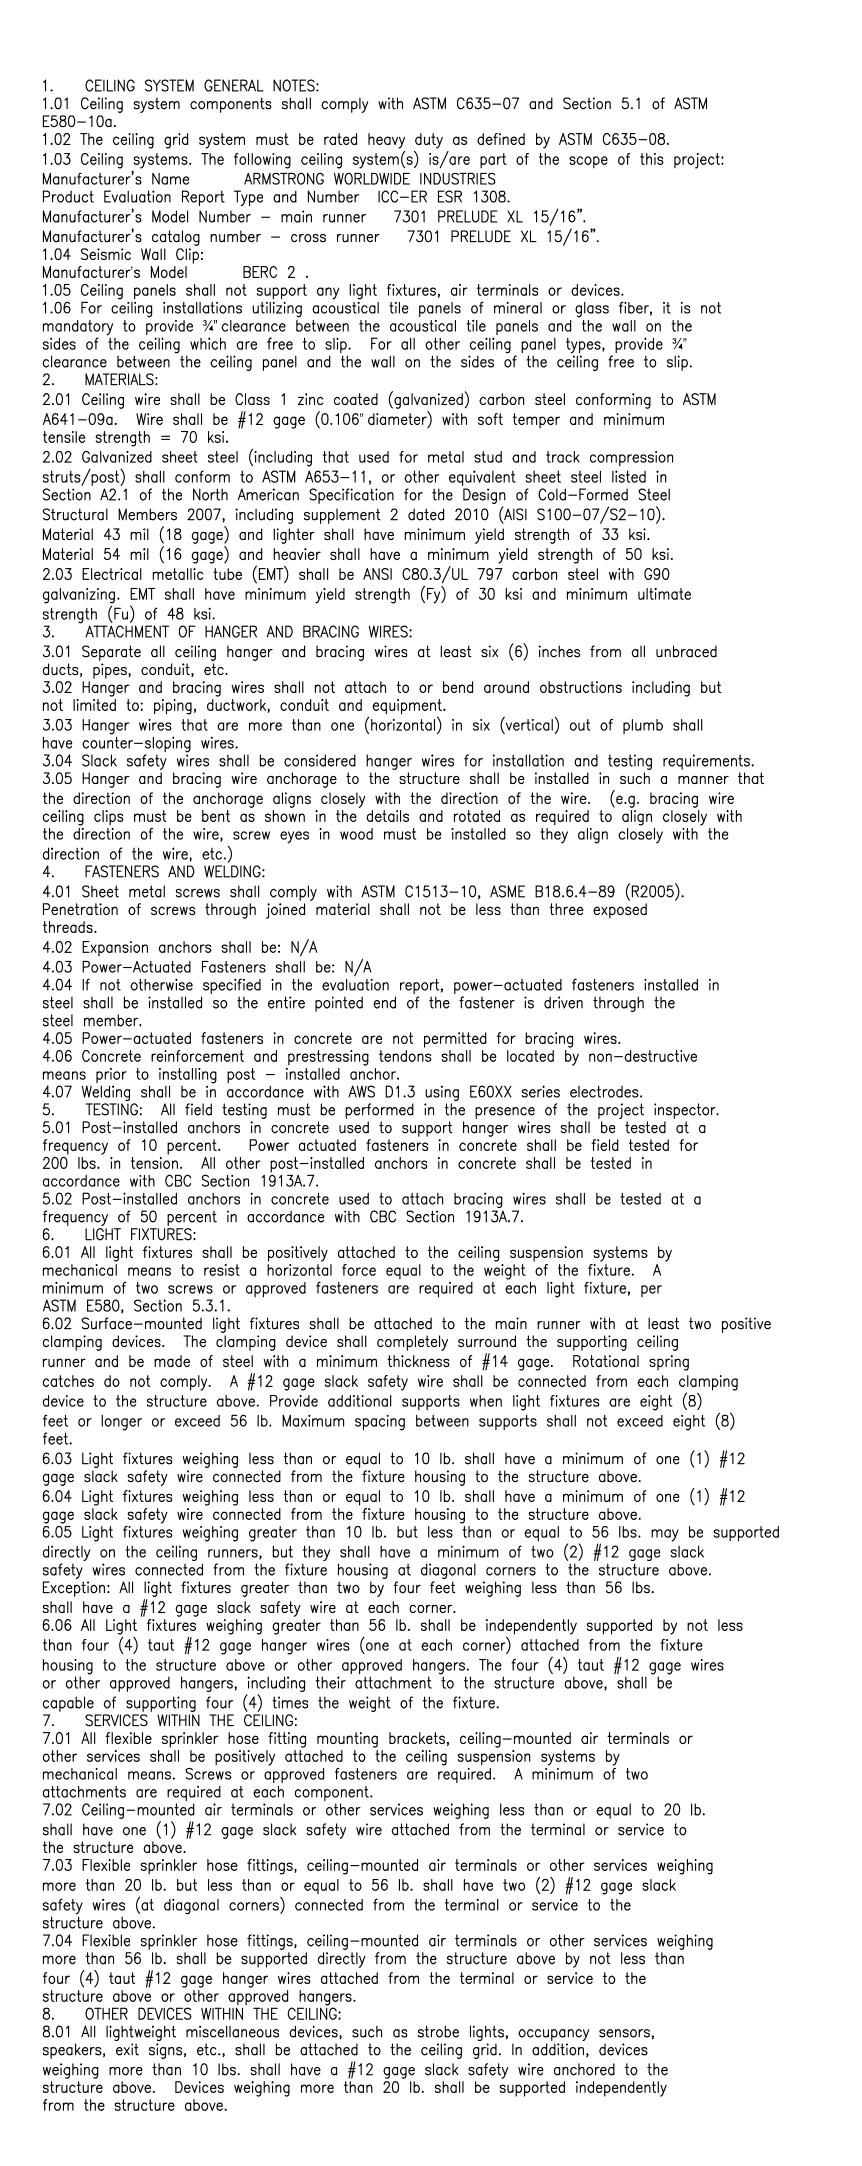

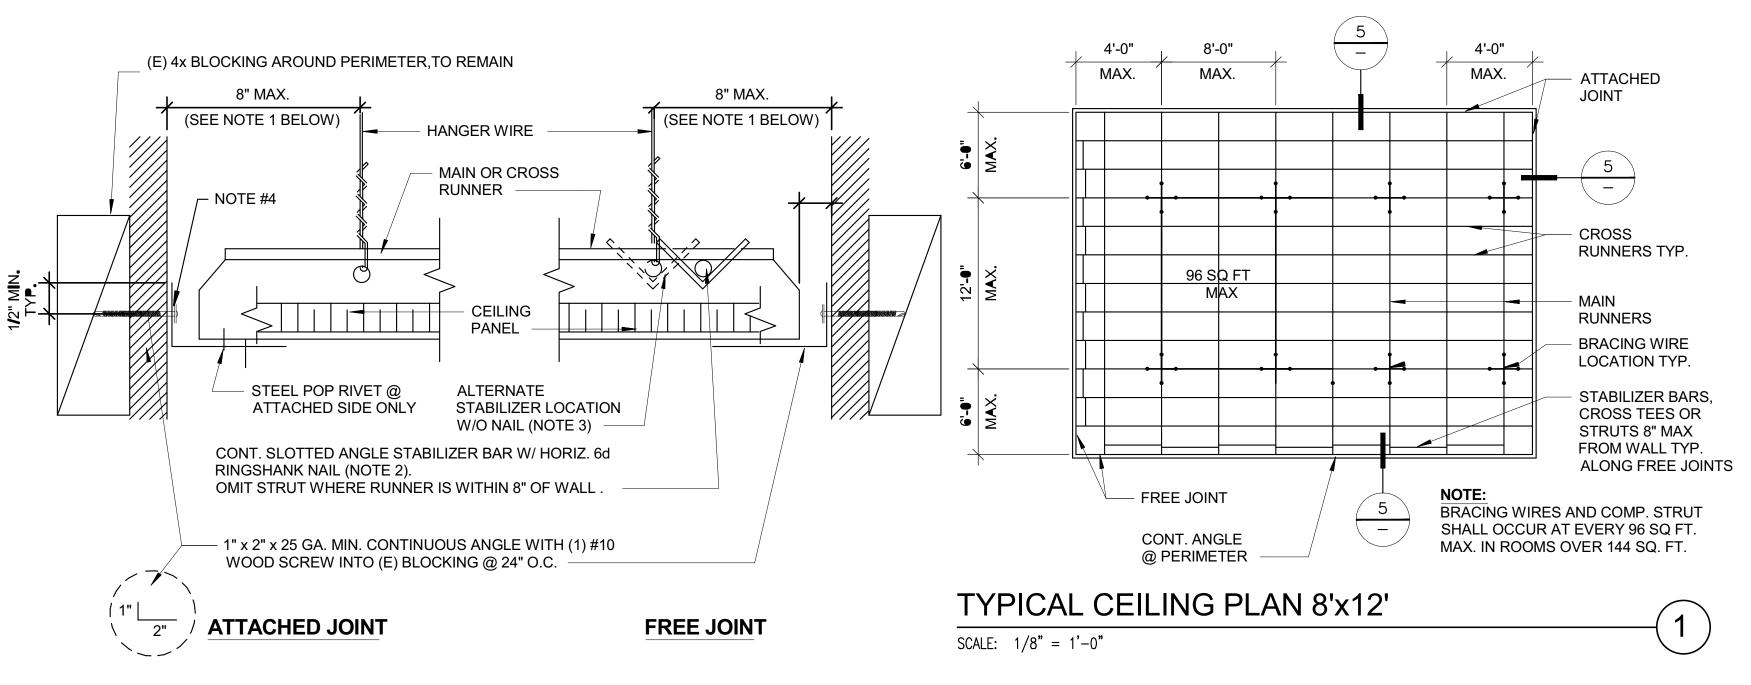

PROVIDE #12 GAGE HANGER WIRES AT THE ENDS OF ALL MAIN AND CROSS RUNNERS WITHIN EIGHT (8) INCHES OF THE SUPPORT OR WITHIN ONE-FOURTH (1/4) OF THE LENGTH OF THE END TEE, WHICHEVER IS LESS, FOR THE PERIMETER OF THE CEILING AREA. PERIMETER WIRES ARE NOT REQUIRED WHEN THE LENGTH OF THE END TEE IS EIGHT (8) INCHES OR LESS. NAILS AT ENDS OF HORIZONTAL CHANNEL STABILIZERS ARE TO BE PLACED WITH (STABILIZER BAR) NAIL HEAD TOWARD CENTER LINE OF SPAN OF STRUT. STABILIZER BAR MAY BE SLOTTED APPROVED STABILIZER APPROVED ANGLES OR CHANNELS WITH (SEE NOTE 3) "DIAMOND POINTS" OF SPRING STEEL WHICH SNAP TIGHT TO PREVENT MOVEMENT OF STRUT

CEILING PERIMETER

(1) #10 SMS TO 20 GA. MIN. WALL STUD @

SCALE: 6" = 1'-0"

RIGID VERT. STRUT SEE DET. 10/-SEE "CHANNEL STRUT" FOR LOCATION OF BRACING WIRES AND STRUT MAIN RUNNER 1. STRUTS SHALL NOT REPLACE HANGER WIRES. 2. THE MINIMUM ACCEPTABLE ANGLE IS DETERMINED SUCH THAT THE WIRES DO NOT CROSS RUNNER

INTERFER WITH THE RUNNERS, LIGHTFIXTURES,

ETC. AND REMAIN STRAIGHT AND UNOBSTRUCTED.

12 GA VERTICAL HANGERS AT4'-0"

WITH MINIMUM 3-TIGHT TURNS IN

3" AT BOTH ENDS, SEE 3/-

O.C. EACH WAY AT MAIN RUNNER

SUSPENSION & BRACING ASSEMBLY SCALE: 3/8" = 1'-0"

SEE 12/-AND 11/-FOR CONNECTION STRUCTURE 1/2" TYP 10° TO 45° 1 1/2" MAX 1/2" TY₽ #12 GAGE WIRE 3 TURNS @ HANGER WIRE TYPICAL @ EACH — 4 TURNS @ BRACE WIRES TYP. @ #12 GAGE WIRE EACH END

HANGER WIRE

BRACING WIRE

12 GA. BRACING WIRE W/ MIN.4-

OF WIRE CONNECTEDTO MAIN

EACH STRUT (U.N.O.) SEE 3/-

TIGHT TURNS IN 1 1/2" BOTH ENDS

RUNNERS 90° APART, 4-TOTAL AT

2

TYPICAL WIRE TURNS

SCALE: 1-1/2" = 1'-0"

AGENCY APPROVAL: HARTMANN HARTMANNARCHITECTURESTUDIO.COM 430 S. CARRILLO RD. OJAI, CALIFORNIA 93023 (805) 530-5559 CONSULTANTS: MATILIJA MIDDLE SCHOOL LIBRARY RENOVATION OJAI UNIFIED SCHOOL DISTRICT414 E. OJAI AVENUE OJAI, CA 93023 (805)640-4300 CONTACT: ADAM DUTTER, BOND MANAGER EMAIL: adutter@ojaiusd.org PROJECT ADDRESS: MATILIJA MIDDLE SCHOOL 703 EL PASEO ROAD OJAI, CA 93023 ISSUE: MARK DATE DESCRIPTION PROJECT INFORMATION: PROJECT NUMBER: 2020.032 PROJECT PHASE: DRAWN BY: Author REVIEWED BY: Checker THE ORIGINAL SIZE OF THIS SHEET IS 36"x24". IF THE CURRENT SIZE IS OTHER THAN 36"x24". THEN ADJUST THE SCALE OF THE DRAWINGS ACCORDING! Y. SHEET TITLE: **CEILING DETAILS**

A - 303

SHEET NUMBER:

DATE: 11/10/2021 6:03:40 PM

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