WIND LOAD INFO: Vasd = 124 mph Vuit = 160 mph (3 sec. GUST) RISK CATEGORY I Exposure D

DUNE WALKOVER CONSTRUCTION

LOADS:

THE DUNE WALKOVER HAS BEEN DESIGNED FOR A VERTICAL LIVE LOAD OF 100 PSF, DEAD LOADS ASSOCIATED WITH THE STRUCTURE ITSELF, AND WIND LOADS PER CODE. THE STRUCTURE HAS NOT BEEN DESIGNED FOR SCOUR, OR HYDRODYNAMIC LOADS (INCLUDING BUT NOT LIMITED TO WAVE LOADS, CURRENT LOADS, ETC.),

ENGINEER MAKES NO WARRANTY OR CERTIFICATION REGARDING EXISTING STRUCTURES ONSITE.

ATLANTIC OCEAN FRONTAGE 800 OCEAN DRIVE (JB-2) TOWN OF JUNO BEACH PALM BEACH COUNTY, FLORIDA

CLIENT:

TOWN OF JUNO BEACH

OCTOBER 2020

PROJECT

This item has been electronically signed and sealed by Mark A. Powell, P.E. on November 6, 2020 using a Digital Signature. Printed copies of this document are not considered signed and sealed and the signature must be verified on any electronic copies.

FOR BID PURPOSES ONLY. NOT FOR CONSTRUCTION.

INDEX TO DRAWINGS

SHEET NUMBER

TITLE

- **VICINITY MAP & TITLE SHEET**
- **DEMOLITION PLAN**
- SITE PLAN
- PILE LAYOUT
- FRAMING PLAN
- SOUTH ELEVATION
- **DETAILS**

* No No ORIDA CHILINIAN STONAL ENGINEERS

PRELIMINARY

VICINITY MAP & TITLE SHEET

ISIMINGER & STUBBS Engineering, inc.


COASTAL • ENVIRONMENTAL • MARINE

REGISTRY NUMBER: 8114 P.O. BOX 14702 - NORTH PALM BEACH, FL. 33408 - 561-881-0003

DUNE WALKOVER CONSTRUCTION ATLANTIC OCEAN FRONTAGE 800 OCEAN DRIVE (JB-2) TOWN OF JUNO BEACH, PALM BEACH COUNTY, FL

CLIENT: TOWN OF JUNO BEACH


DATE	10)/20	DRAWN	PJK	CHKD	KI	KDB		KDB		KDB		KDB		PRVD	MAF	5
DWG N	Э.	2016	1A1				SH	EE.	1								
COMPUTER FILE NO.				20161A			OF		7	1							

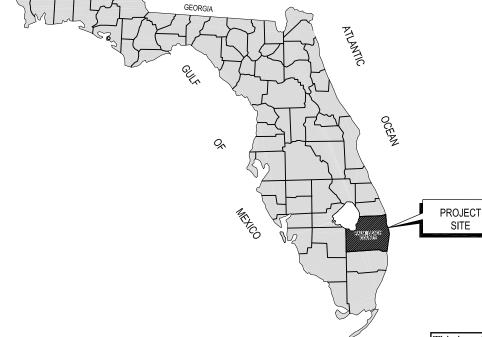


APPLICABLE PROVISION(S):

THE DUNE WALKOVER HAS BEEN DESIGNED IN ACCORDANCE WITH THE APPLICABLE SECTIONS OF THE 2017 FLORIDA BUILDING CODE.

THESE PLANS MUST BE USED IN CONJUNCTION WITH THE ATTACHED TECHNICAL SPECIFICATIONS.

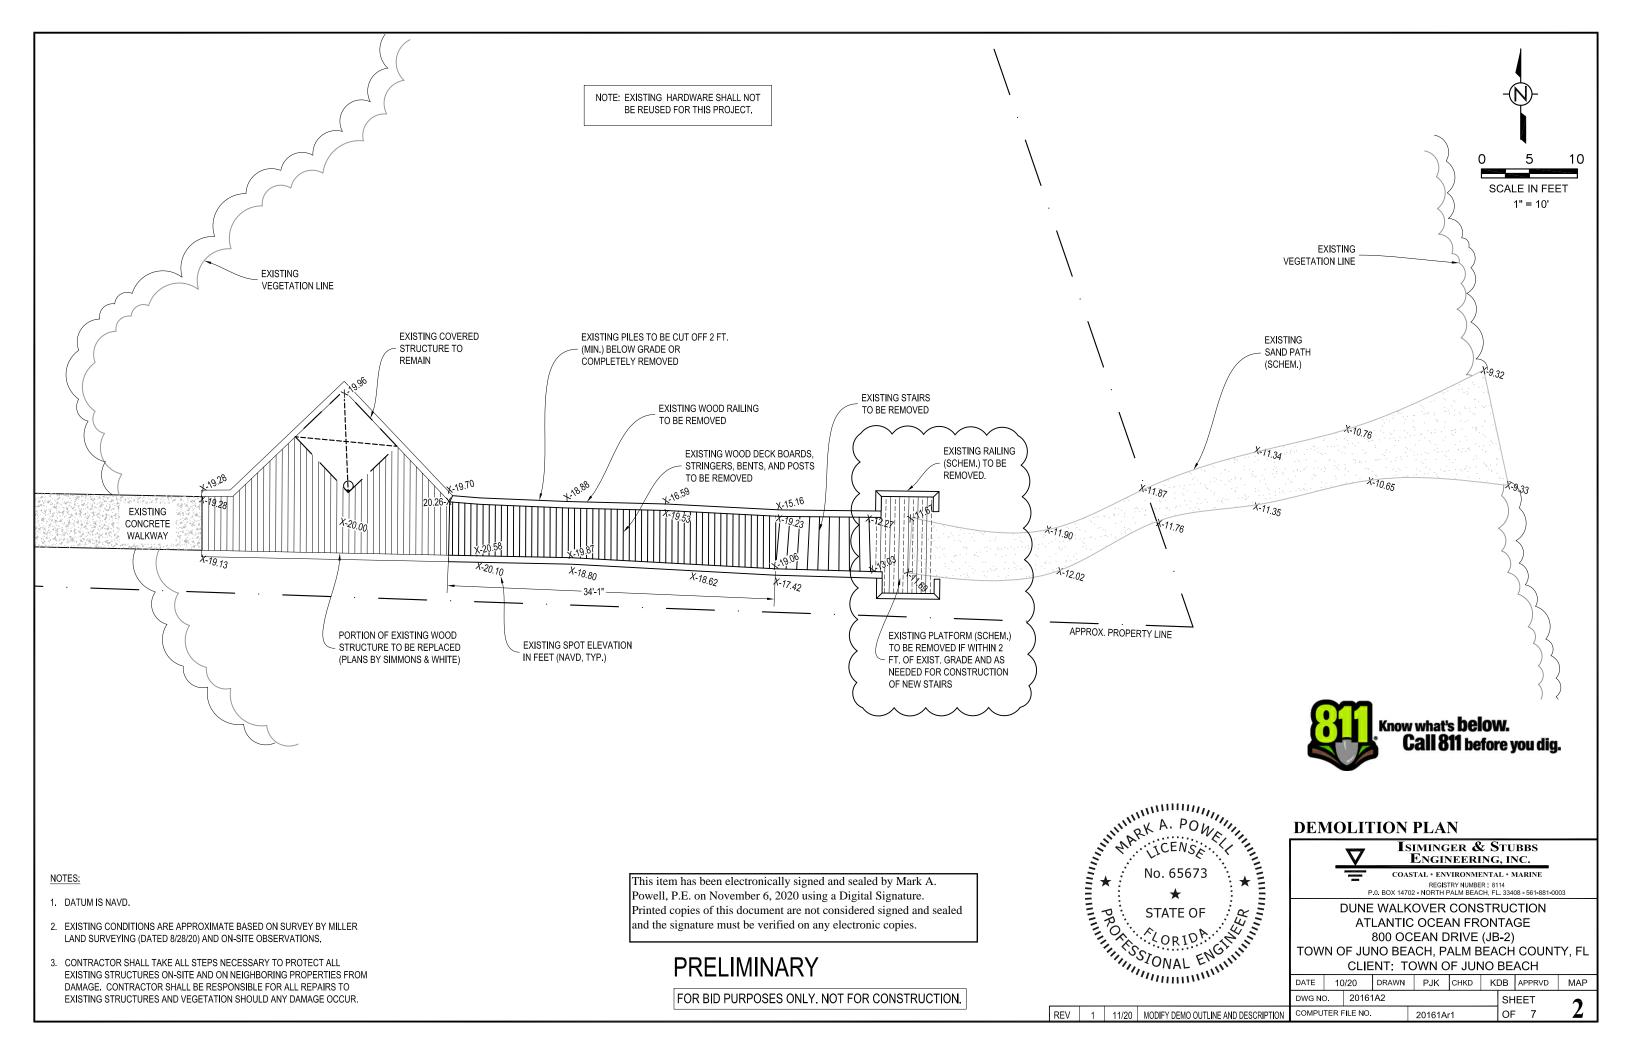

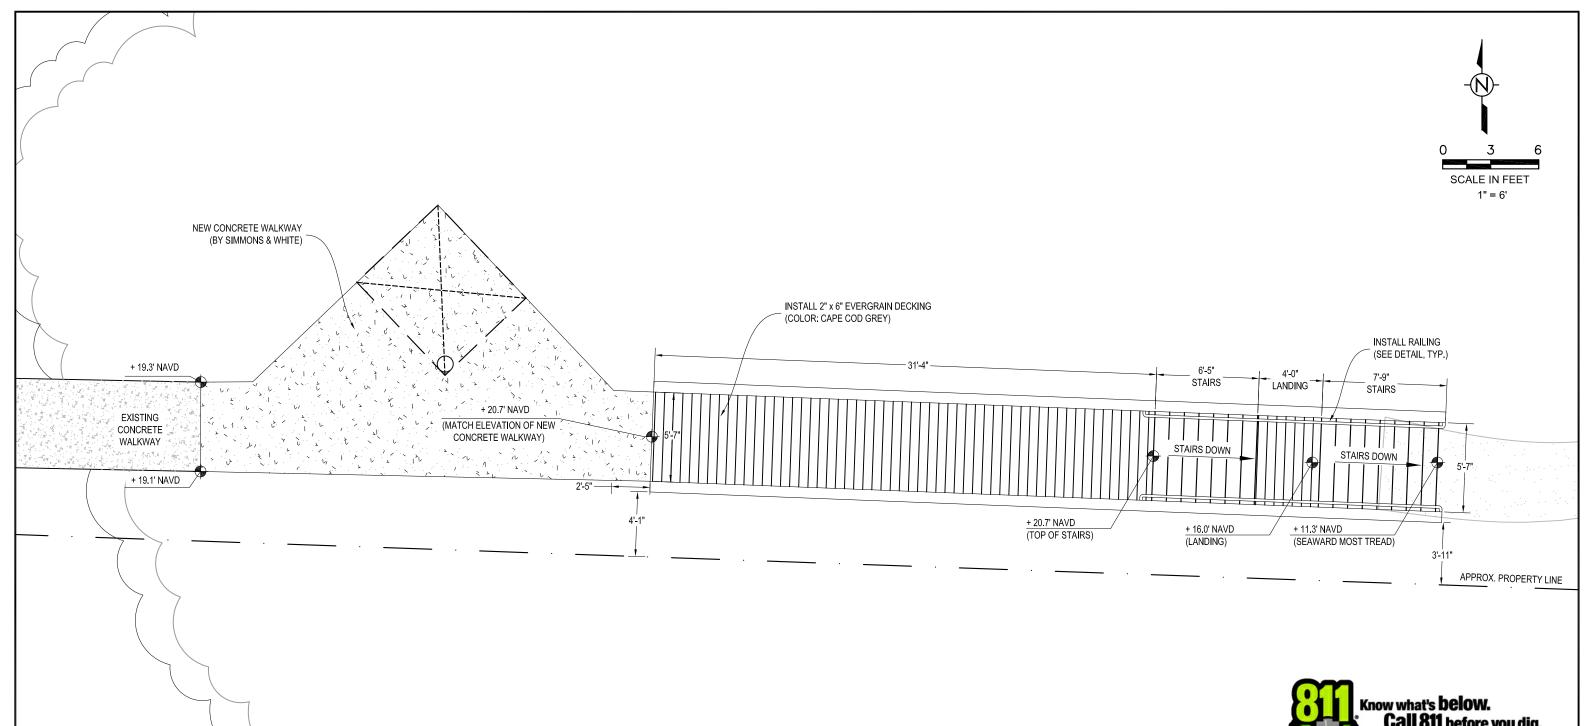

Know what's **below. Call 811** before you dig.


NOTES:

- 1. DATUM IS NAVD.
- 2. EXISTING CONDITIONS ARE APPROXIMATE BASED ON SURVEY BY MILLER LAND SURVEYING (DATED 8/28/20) AND ON-SITE OBSERVATIONS.
- 3. CONTRACTOR SHALL TAKE ALL STEPS NECESSARY TO PROTECT ALL EXISTING STRUCTURES ON-SITE AND ON NEIGHBORING PROPERTIES FROM DAMAGE. CONTRACTOR SHALL BE RESPONSIBLE FOR ALL REPAIRS TO EXISTING STRUCTURES AND VEGETATION SHOULD ANY DAMAGE OCCUR.
- 4. SOME TRIM ELEMENTS NOT SHOWN. CONTRACTOR TO CONFIRM DETAILING OF TRIM ELEMENTS PRIOR TO COMMENCEMENT OF CONSTRUCTION.

This item has been electronically signed and sealed by Mark A. Powell, P.E. on November 6, 2020 using a Digital Signature. Printed copies of this document are not considered signed and sealed and the signature must be verified on any electronic copies.

PRELIMINARY

FOR BID PURPOSES ONLY. NOT FOR CONSTRUCTION.

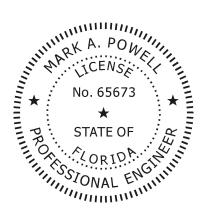

SITE PLAN

Isiminger & Stubbs Engineering, inc.


COASTAL • ENVIRONMENTAL • MARINE

REGISTRY NUMBER: 8114 P.O. BOX 14702 - NORTH PALM BEACH, FL. 33408 - 561-881-0003

DUNE WALKOVER CONSTRUCTION ATLANTIC OCEAN FRONTAGE 800 OCEAN DRIVE (JB-2) TOWN OF JUNO BEACH, PALM BEACH COUNTY, FL

CLIENT: TOWN OF JUNO BEACH

DATE	10/20	DRAWN	PJK	CHKD	ΚI	אכ	APPRVD	IVIAH
DWG NO.	2016	A3				SH	IEET	
COMPUTER	R FILE NO.		20161A			OF	7	<u> </u>

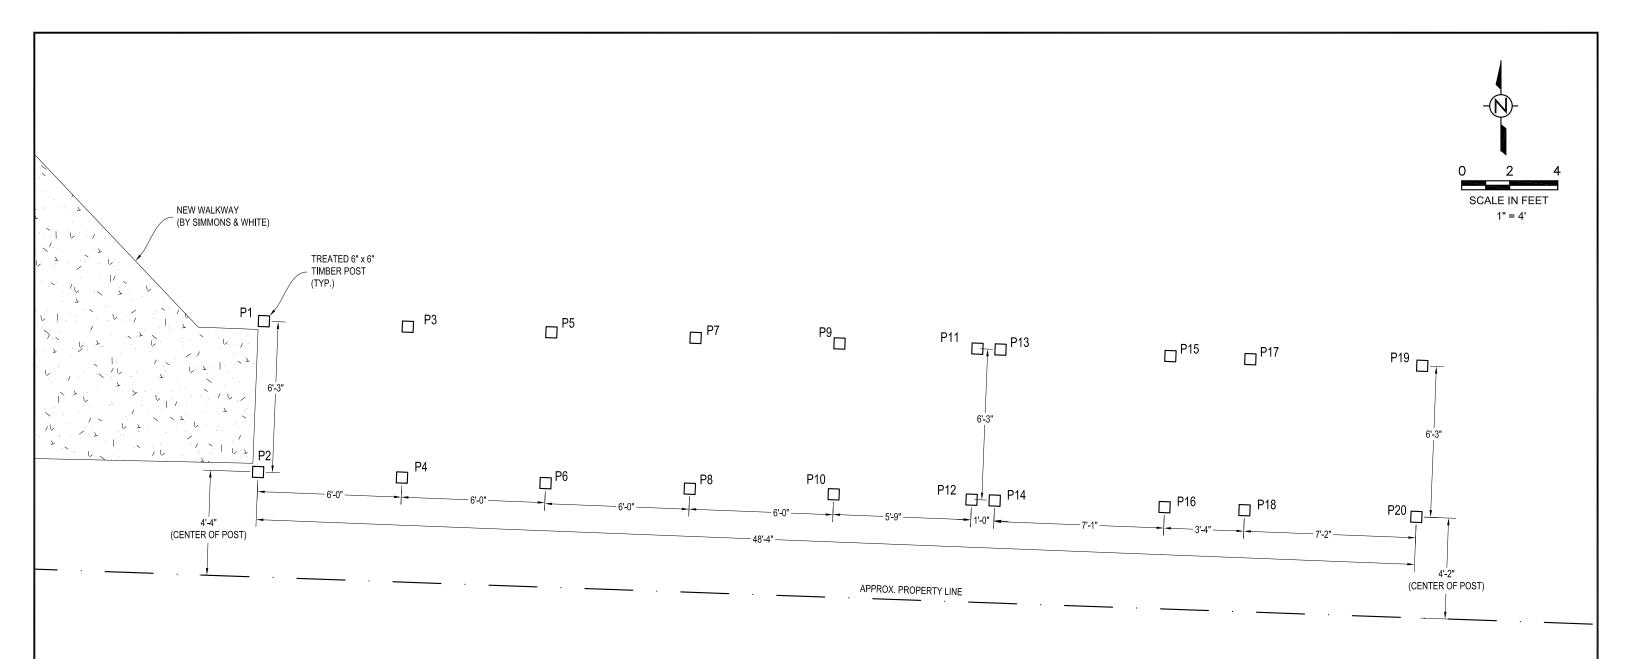



NOTES:

- DATUM IS NAVD.
- 2. EXISTING CONDITIONS ARE APPROXIMATE BASED ON SURVEY BY MILLER LAND SURVEYING (DATED 8/28/20) AND ON-SITE OBSERVATIONS.
- 3. CONTRACTOR SHALL TAKE ALL STEPS NECESSARY TO PROTECT ALL EXISTING STRUCTURES ON-SITE AND ON NEIGHBORING PROPERTIES FROM DAMAGE, CONTRACTOR SHALL BE RESPONSIBLE FOR ALL REPAIRS TO EXISTING STRUCTURES AND VEGETATION SHOULD ANY DAMAGE OCCUR.
- 4. SOME TRIM ELEMENTS NOT SHOWN. CONTRACTOR TO CONFIRM DETAILING OF TRIM ELEMENTS PRIOR TO COMMENCEMENT OF CONSTRUCTION.

This item has been electronically signed and sealed by Mark A. Powell, P.E. on November 6, 2020 using a Digital Signature. Printed copies of this document are not considered signed and sealed and the signature must be verified on any electronic copies.

PRELIMINARY

FOR BID PURPOSES ONLY. NOT FOR CONSTRUCTION.



PILE LAYOUT




ISIMINGER & STUBBS Engineering, inc.

COASTAL * ENVIRONMENTAL * MARINE
REGISTRY NUMBER: 8114
P.O. BOX 14702 - NORTH PALM BEACH, FL. 33408 - 561-881-0003

DUNE WALKOVER CONSTRUCTION ATLANTIC OCEAN FRONTAGE

800 OCEAN DRIVE (JB-2) TOWN OF JUNO BEACH, PALM BEACH COUNTY, FL CLIENT: TOWN OF JUNO BEACH

ATE	10	/20	DRAWN	PJK	CHKD	KI	KDB		PRVD	MAP	
WG N	Ο.	20161	A4				SH	EE	1		
OMPU	IPUTER FILE NO.			20161A			OF		7	4	

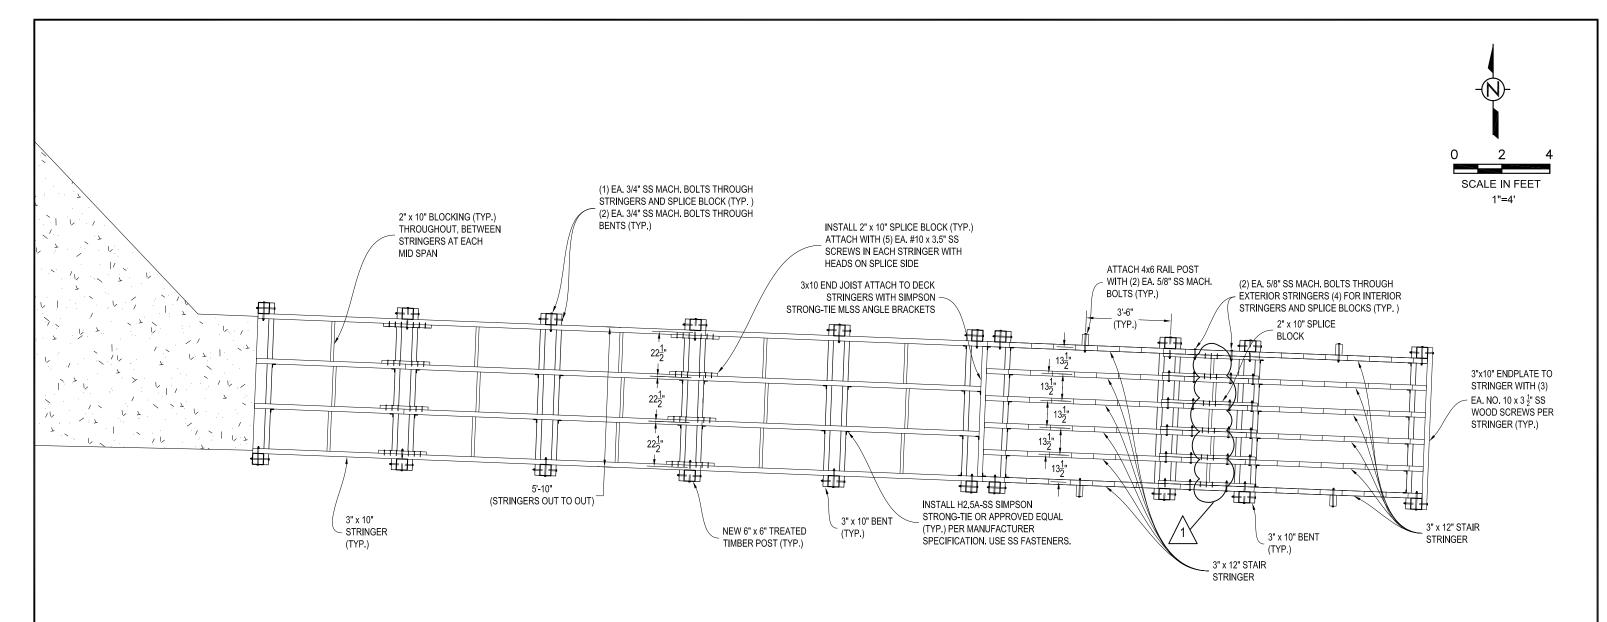

PRODUCT NOTES:

WOOD

ALL STRUCTURAL MEMBERS SHALL BE PRESSURE TREATED ("GROUND CONTACT", AWPA CATEGORY UC4B MINIMUM EQUIVALENT) NO. 1 SOUTHERN YELLOW PINE OR BETTER.

HARDWARE:


ALL BOLTS, WASHERS, NUTS, SCREWS, NAILS, AND OTHER HARDWARE ITEMS SHALL BE 316 STAINLESS. THREADED ROD MAY BE USED IN PLACE OF HEX HEAD BOLTS FOR BOLTS LONGER THAN 7".

DECKING

DECKING SHALL CONSIST OF 2" x 6" EVERGRAIN® DECKING (COLOR: CAPE COD GREY). END-TO-END JOINTS ARE NOT ALLOWED. DECKING SHALL BE INSTALLED WITH (2) EA. #10 X 3 $\frac{1}{2}$ " DECK SCREWS PER STRINGER CROSSING, GAP BOARDS 1/8" SIDE TO SIDE AND BETWEEN THE BOARDS AND OTHER SURFACES. PRE-DRILLING/COUNTERSINKING IS REQUIRED SUCH THAT THE TOP OF SCREWS ARE FLUSH WITH OR NO LOWER THAN $\frac{1}{32}$ " BELOW THE TOP OF DECKING. ALL OTHER MANUFACTURER INSTALLATION REQUIREMENTS (INCLUDING BOARD EDGE SPACING) SHALL BE FOLLOWED.

NOTES:

- 1. DATUM IS NAVD.
- EXISTING CONDITIONS ARE APPROXIMATE BASED ON SURVEY BY MILLER LAND SURVEYING (DATED 8/28/20) AND ON-SITE OBSERVATIONS.
- 3. SOME TRIM ELEMENTS NOT SHOWN. CONTRACTOR TO CONFIRM DETAILING OF TRIM ELEMENTS PRIOR TO COMMENCEMENT OF CONSTRUCTION.

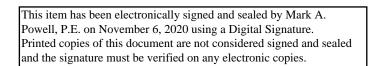

PRELIMINARY

FOR BID PURPOSES ONLY. NOT FOR CONSTRUCTION.





REV 1 11/20

FRAMING PLAN

∇

Isiminger & Stubbs Engineering, inc.

COASTAL • ENVIRONMENTAL • MARINE


REGISTRY NUMBER: 8114 P.O. BOX 14702 - NORTH PALM BEACH, FL. 33408 - 561-881-0003

DUNE WALKOVER CONSTRUCTION
ATLANTIC OCEAN FRONTAGE
800 OCEAN DRIVE (JB-2)
TOWN OF JUNO BEACH, PALM BEACH COUNTY, FL

CLIENT: TOWN OF JUNO BEACH

DWG NO. 20161A5 SHEET ADD RI OCKING TO LANDING COMPUTER FILE NO. 20161A OF 7	· annin	DATE 10/20)/20	DRAWN	PJK	CHKD	K	DB	APPRVD	MAP	
ADD BLOCKING TO LANDING COMPUTER FILE NO. 20161A OF 7		DWG NO. 20161A5								IEET		7
ABB BEGGINITO TO EXTENSIVE	ADD BLOCKING TO LANDING	COMPU	COMPUTER FILE NO.			20161A			OF	7	<u> </u>	╛



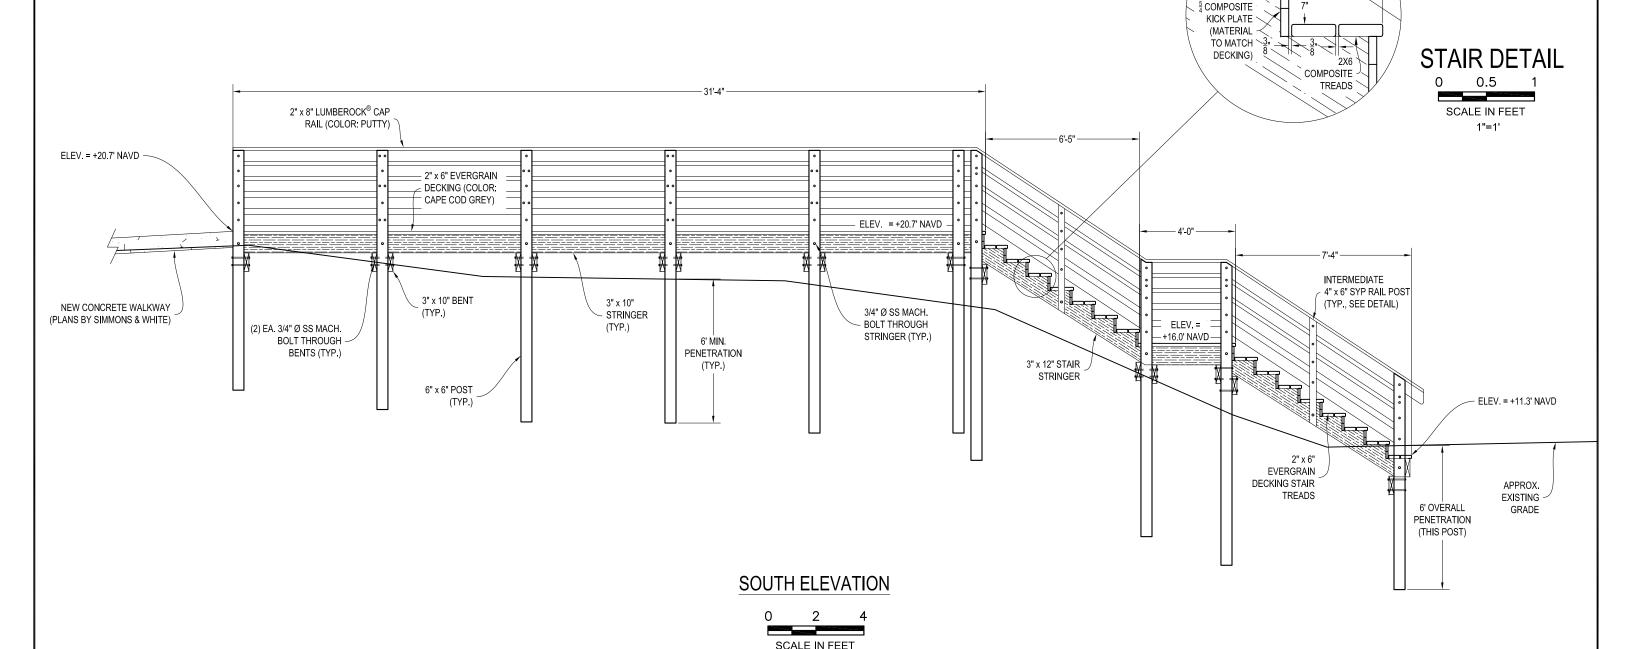

NOTES:


- 1. DATUM IS NAVD.
- 2. EXISTING CONDITIONS ARE APPROXIMATE BASED ON SURVEY BY MILLER LAND SURVEYING (DATED 8/28/20) AND ON-SITE OBSERVATIONS.
- 3. ALL STRUCTURAL MEMBERS SHALL BE PRESSURE TREATED ("GROUND CONTACT", AWPA CATEGORY UC4B MINIMUM EQUIVALENT) NO. 1 SOUTHERN YELLOW PINE OR BETTER.
- 4. ALL BOLTS, WASHERS, NUTS, SCREWS, NAILS, AND OTHER HARDWARE ITEMS SHALL BE 316 STAINLESS STEEL UNLESS SPECIFIED OTHERWISE. ALL BOLTS SHALL HAVE POLISHED FINISH. THREADED ROAD MAY BE SUBSTITUTED FOR BOLTS LONGER THAN 7".
- 5. SOME TRIM ELEMENTS NOT SHOWN. CONTRACTOR TO CONFIRM DETAILING OF TRIM ELEMENTS PRIOR TO COMMENCEMENT OF CONSTRUCTION.

This item has been electronically signed and sealed by Mark A. Powell, P.E. on November 6, 2020 using a Digital Signature. Printed copies of this document are not considered signed and sealed and the signature must be verified on any electronic copies.

PRELIMINARY

FOR BID PURPOSES ONLY. NOT FOR CONSTRUCTION.

1"=4'

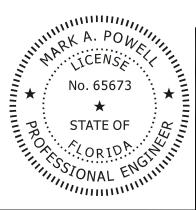

SOUTH ELEVATION


ISIMINGER & STUBBS Engineering, inc. COASTAL • ENVIRONMENTAL • MARINE

REGISTRY NUMBER: 8114 P.O. BOX 14702 - NORTH PALM BEACH, FL. 33408 - 561-881-0003

DUNE WALKOVER CONSTRUCTION ATLANTIC OCEAN FRONTAGE 800 OCEAN DRIVE (JB-2) TOWN OF JUNO BEACH, PALM BEACH COUNTY, FL


CLIENT: TOWN OF JUNO BEACH DATE 10/20 DRAWN P.IK CHKD KDR APPRVD MAD

DATE	10	1/20	DRAWIN	FJK	CHKD	ΓL	סכ	AFFRVD	IVIAL
DWG N	Ο.	20161	A6				SH	IEET	-
COMPU	TER F	ILE NO.		20161A			OF	7	<u>0</u>

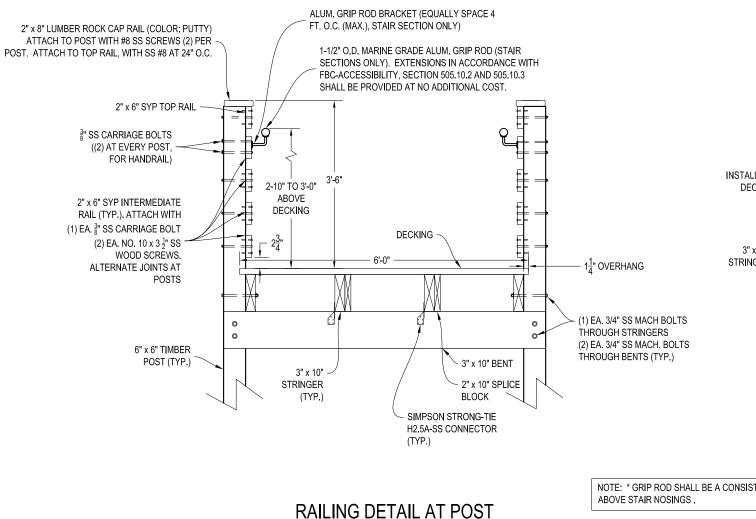

SCALE IN FEET


1"=2'-0"

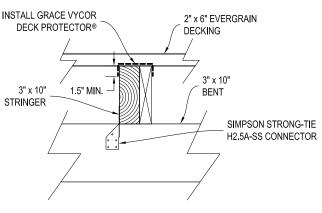

DECK PROTECTOR® 3" x 10" STRINGER SIMPSON STRONG-TIE H2.5A-SS CONNECTOR OR APPROVED EQUAL PER MANUFACTURER SPECIFICATIONS. 3" x 10" BENT

INSTALL GRACE VYCOR

GRACE VYCOR DETAIL

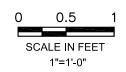

NOTE: * GRIP ROD SHALL BE A CONSISTENT HEIGHT

STRINGER/BENT DETAIL

NOT TO SCALE

Know what's **below. Call 811** before you dig.


NOTES:

- DATUM IS NAVD.
- 2. ALL STRUCTURAL MEMBERS SHALL BE PRESSURE TREATED ("GROUND CONTACT", AWPA CATEGORY UC4B MINIMUM EQUIVALENT) NO. 1 SOUTHERN YELLOW PINE OR BETTER.
- 3. ALL BOLTS, WASHERS, NUTS, SCREWS, NAILS, AND OTHER HARDWARE ITEMS SHALL BE 316 STAINLESS STEEL UNLESS SPECIFIED OTHERWISE. ALL BOLTS SHALL HAVE POLISHED FINISH. THREADED ROAD MAY BE SUBSTITUTED FOR BOLTS LONGER THAN 7". ALUMINUM HANDRAILS SHALL BE ALLOY 6061. CONTRACTOR TO PROVIDE CONNECTION DETAILS TO ENGINEER PRIOR TO ORDERING AND INSTALLING.
- SOME TRIM ELEMENTS NOT SHOWN. CONTRACTOR TO CONFIRM DETAILING OF TRIM ELEMENTS PRIOR TO COMMENCEMENT OF CONSTRUCTION.

This item has been electronically signed and sealed by Mark A. Powell, P.E. on November 6, 2020 using a Digital Signature. Printed copies of this document are not considered signed and sealed and the signature must be verified on any electronic copies.

PRELIMINARY

FOR BID PURPOSES ONLY. NOT FOR CONSTRUCTION.

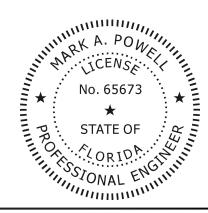

DETAILS



Isiminger & Stubbs Engineering, inc.

COASTAL • ENVIRONMENTAL • MARINE

REGISTRY NUMBER: 8114 P.O. BOX 14702 - NORTH PALM BEACH, FL. 33408 - 561-881-0003

DUNE WALKOVER CONSTRUCTION

ATLANTIC OCEAN FRONTAGE 800 OCEAN DRIVE (JB-2) TOWN OF JUNO BEACH, PALM BEACH COUNTY, FL CLIENT: TOWN OF JUNO BEACH

DATE	10	/20	DRAWN	PJK	CHKD	KI	DB	B APPRVD		MAP
DWG NO. 20161A7							SH	EE	Т]
COMPUTER FILE NO.				20161A			OF		7	/