
# Renovations St. James Middle School



350 HILTON ROAD / SUITE 101 MYRTLE BEACH, SC 29572



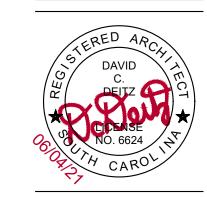

9775 St. James Road Myrtle Beach, SC

TAX MAP No: 190-0003-053

Architect: D3G Architects LLC

## Drawing List:

COVER

MASTER EXISTING FLOOR PLAN


**ENLARGED AREAS** 

WALL SECTIONS

DOOR TYPES, DOOR DETAILS

RCP DETAILS

June 4, 2021

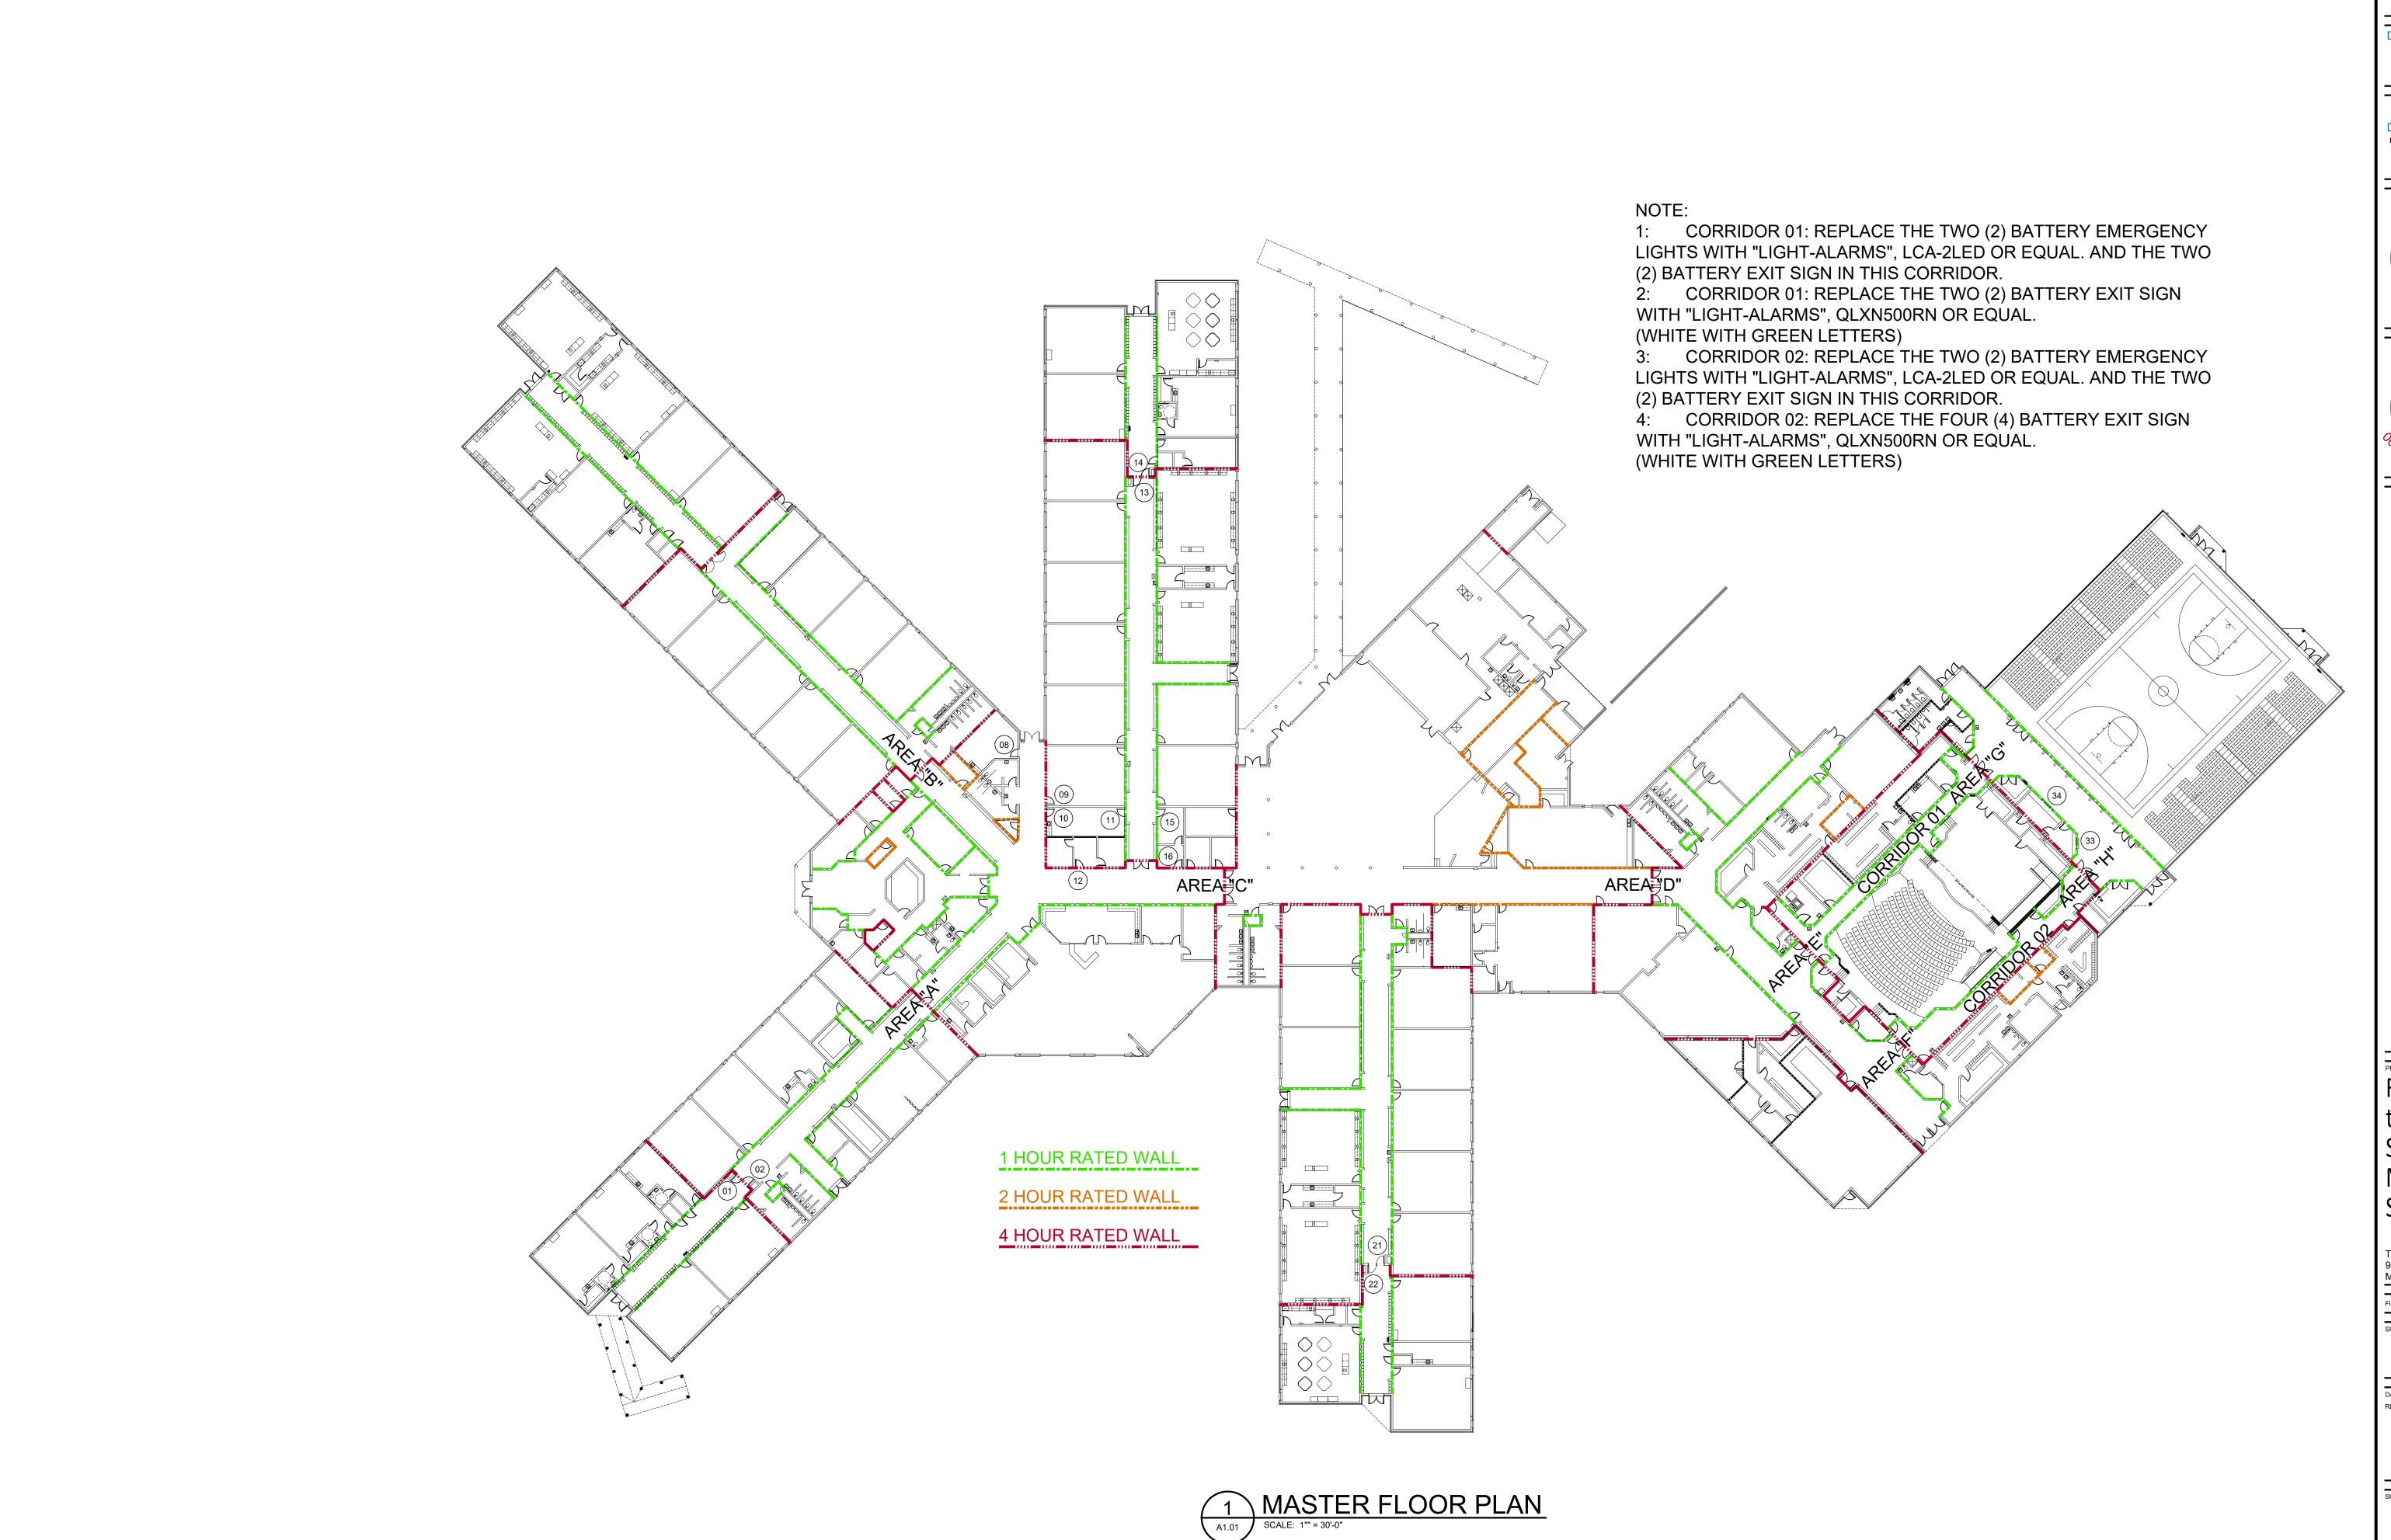




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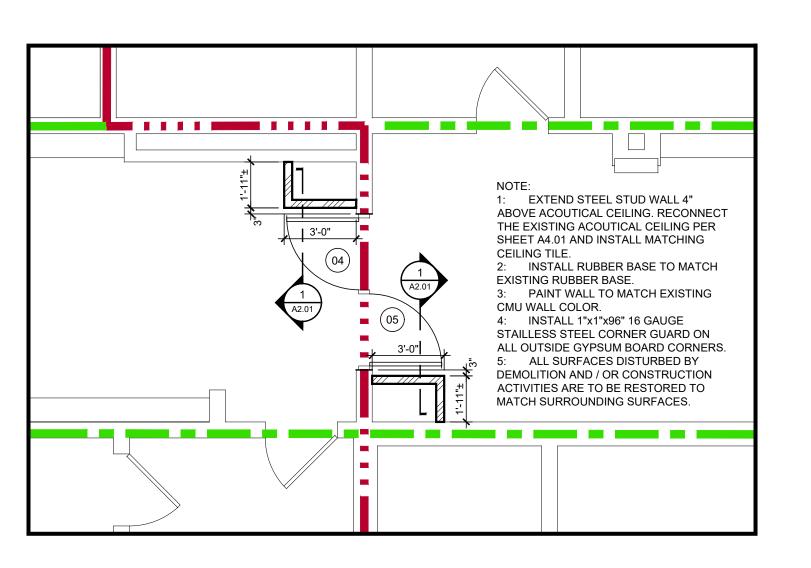





Renovations

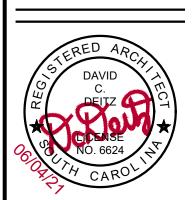St. James Middle School

TMS: 190-0003-053 9775 St, James Road Myrtle Beach, SC





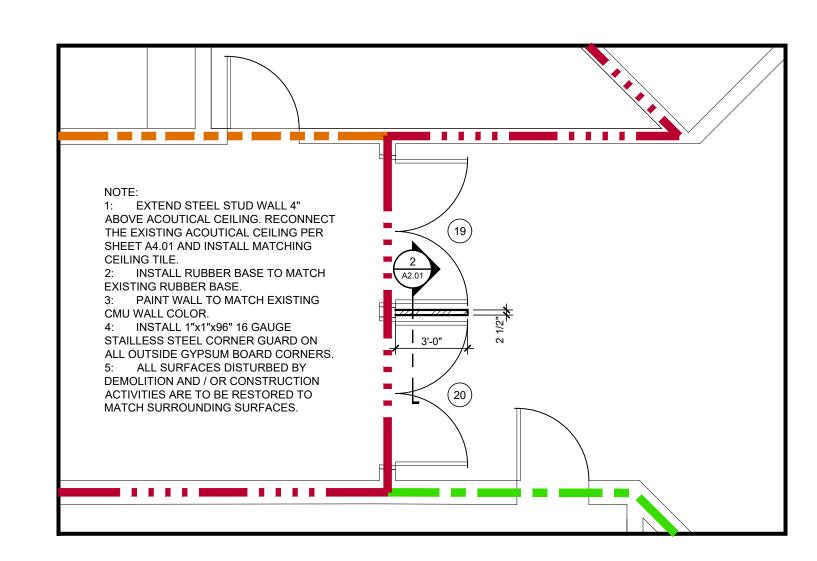



**GENERAL NOTES:** 

EXISTING JOB CONDITIONS.

1: DO NOT SCALE DRAWINGS. ALL WRITTEN DIMENSIONS GOVERN.

REPORT ANY DISCREPANCIES TO ARCHITECT IMMEDIATELY PRIOR

TO ROUGH-IN, ERECTION, FABRICATION OR INSTALLATION. VERIFY ALL DIMENSIONS SHOWN FOR ANY APPLIANCES, EQUIPMENT, ETC.

2: ALL DIMENSIONS ARE TO FACE OF STEEL OR WOOD STUDS

3: CONTRACTOR IS TO VISIT SITE AND FAMILIARIZE HIMSELF WITH

4: CONTRACTOR IS TO FIELD-DETERMINE DIMENSIONS PRIOR TO

5: CONTRACTOR IS TO NOTIFY ARCHITECT OF ANY DISCREPANCIES

EXTENDED TO BE TYPICAL AND SHALL BE CONSTRUED TO APPLY TO


6: ALL DETAILS AND WALL SECTIONS ON THE DRAWINGS ARE

ANY SIMILAR SITUATION ELSEWHERE ON THE PROJECT EXCEPT

UNLESS OTHERWISE NOTED. (SEE WALL LEGEND).

COMMENCEMENT OF CONSTRUCTION ACTIVITIES.

DISCOVERED PRIOR TO PROCEEDING WITH WORK.

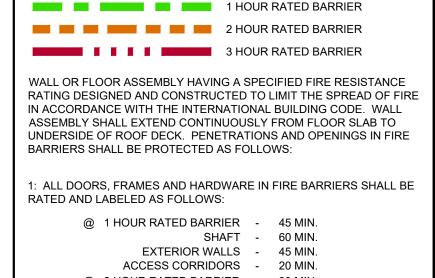

@ 2 HOUR RATED BARRIER - 90 MIN.
EXTERIOR WALLS - 90 MIN.
@ 3 HOUR RATED BARRIER - 180 MIN.
EXTERIOR WALLS - 90 MIN.

EXTERIOR WALLS - 90 MIN.

2: ALL PENETRATIONS AND MISCELLANEOUS OPENINGS SHALL BE

APPROVED MATERIALS. SEE SHEET "A3.01"

RATED BARRIER LEGEND:

SEALED WITH "NFPA" APPROVED MATERIALS. SEE SHEET "A3.01"

3: SEAL FIRE RATED BARRIERS TO FIRE RATED CEILING WITH "NFPA"

## PLAN LEGEND: O4 DOOR TYPE 04, SEE DOOR NUMBER 04 SEE SHEET A3.01.

WHERE A SEPARATE DETAIL IS SHOWN.

WALL LEGEND:

EXISTING CMU WALL:
8" OR 12" CMU WALL


A2.01 SEE WALL SECTION "1" ON SHEET "A2.01"

INTERIOR WALL:


4" OR 2 1/2" STEEL STUDS 18 GAUGE @ 12" O.C.

WATERPROOF MEMBRANE BETWEEN STEEL STUD


TRACK & CONCRETE W/ 2 LAYERS OF 5/8" GYPSUM
BOARD ON CORRIDOR SIDE. EXTEND TO 4" ABOVE
ACOUSTICAL CEILING. BRACING AS REQUIRED.

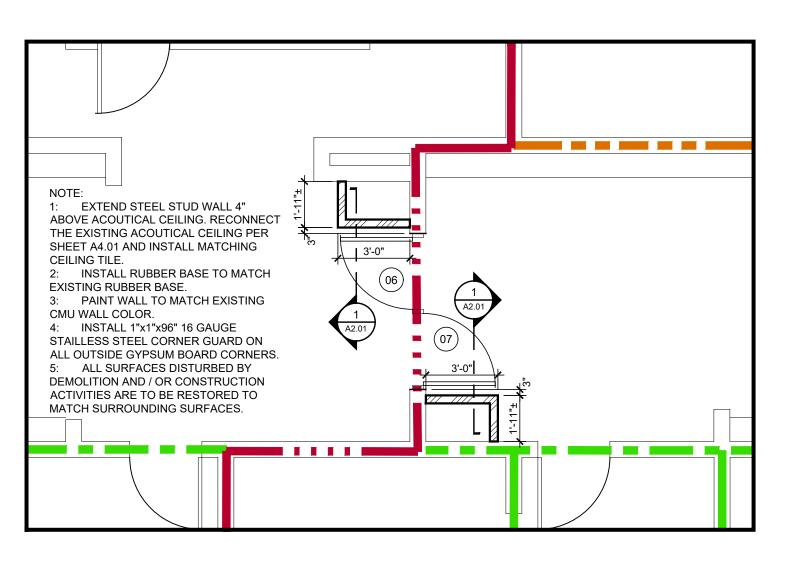




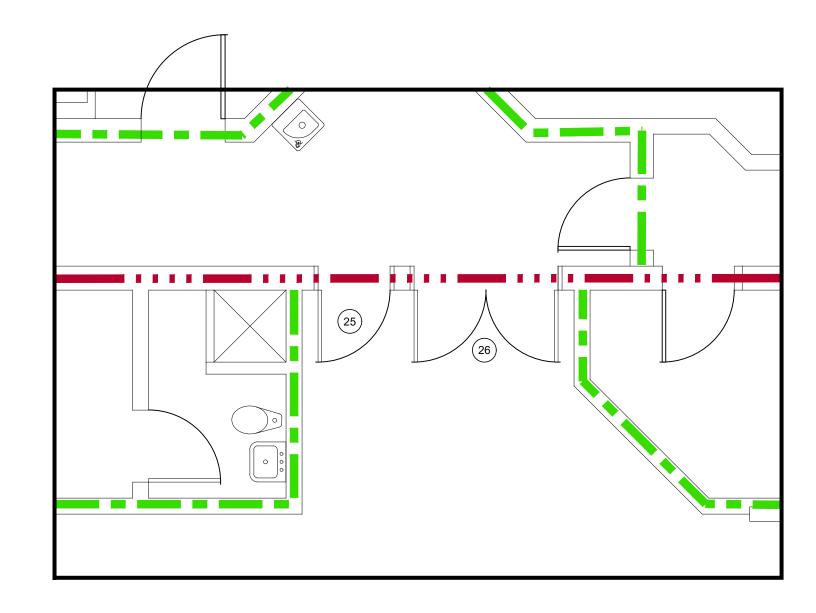




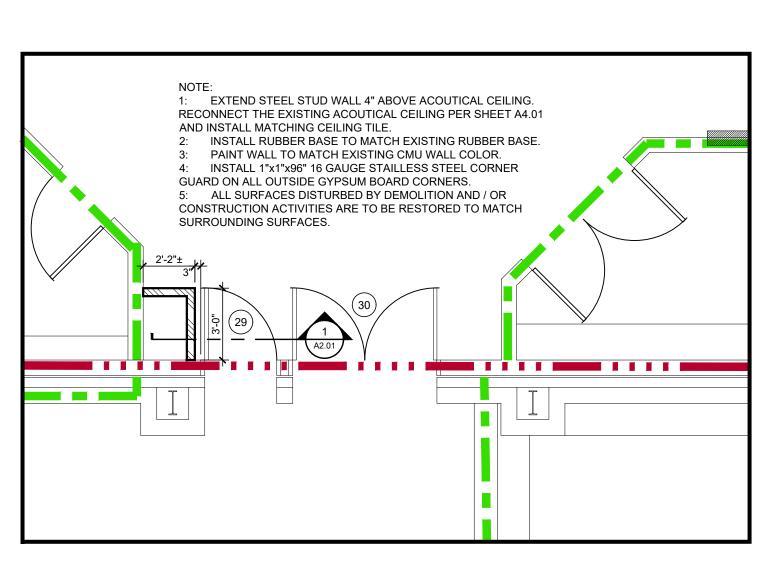



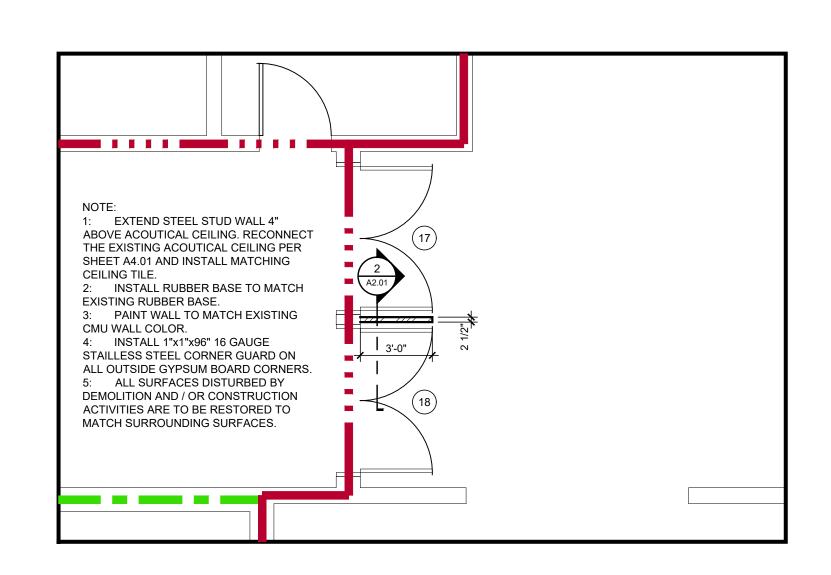




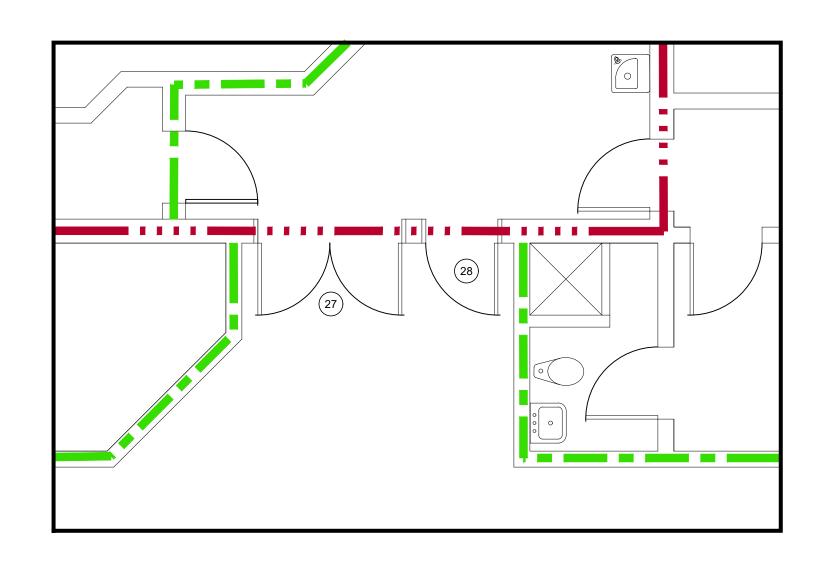

AREA "F"

6 ENLARGED FLOOR AREA

SCALE: 1/4" = 1'-0"

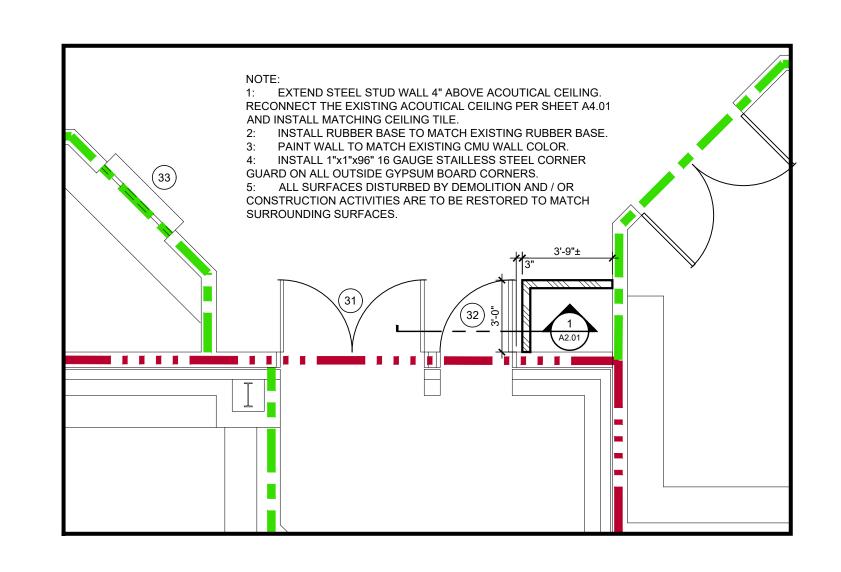





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ARCHITECT:

MYRTLE BEACH, SC 29572

Renovations to St. James

TMS: 190-0003-053 9775 St, James Road

Middle

School


Myrtle Beach, SC

FILE NUMBER:

SHEET TITLE: ENLARGED FLOOR PLAN

DATE: June 4, 20
REVISION DATE:

SHEET NUMBER:

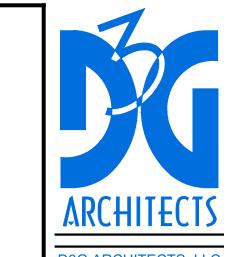



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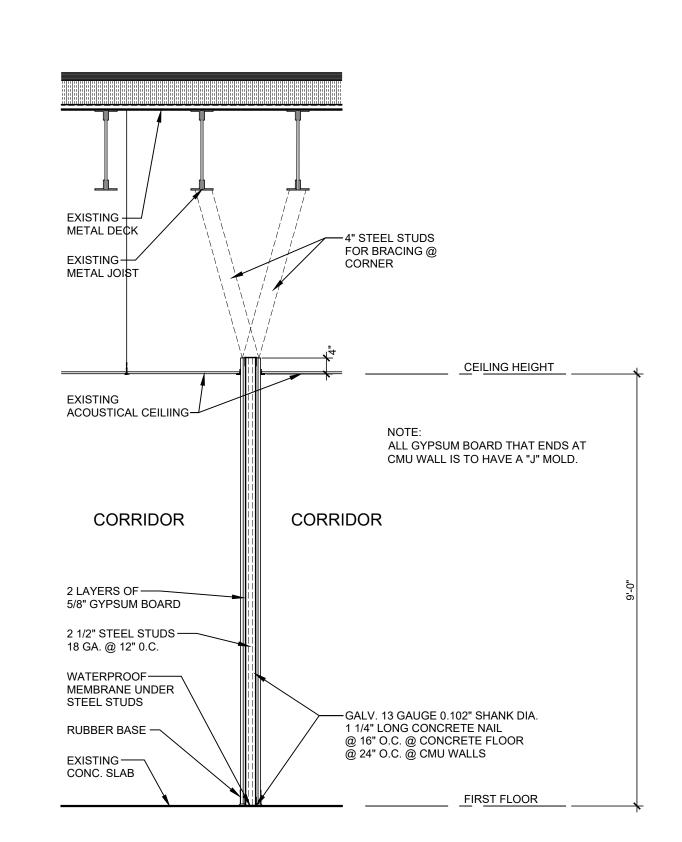
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TYPICAL

WALL SECTION

SCALE: 1/2" = 1'-0"

Renovations
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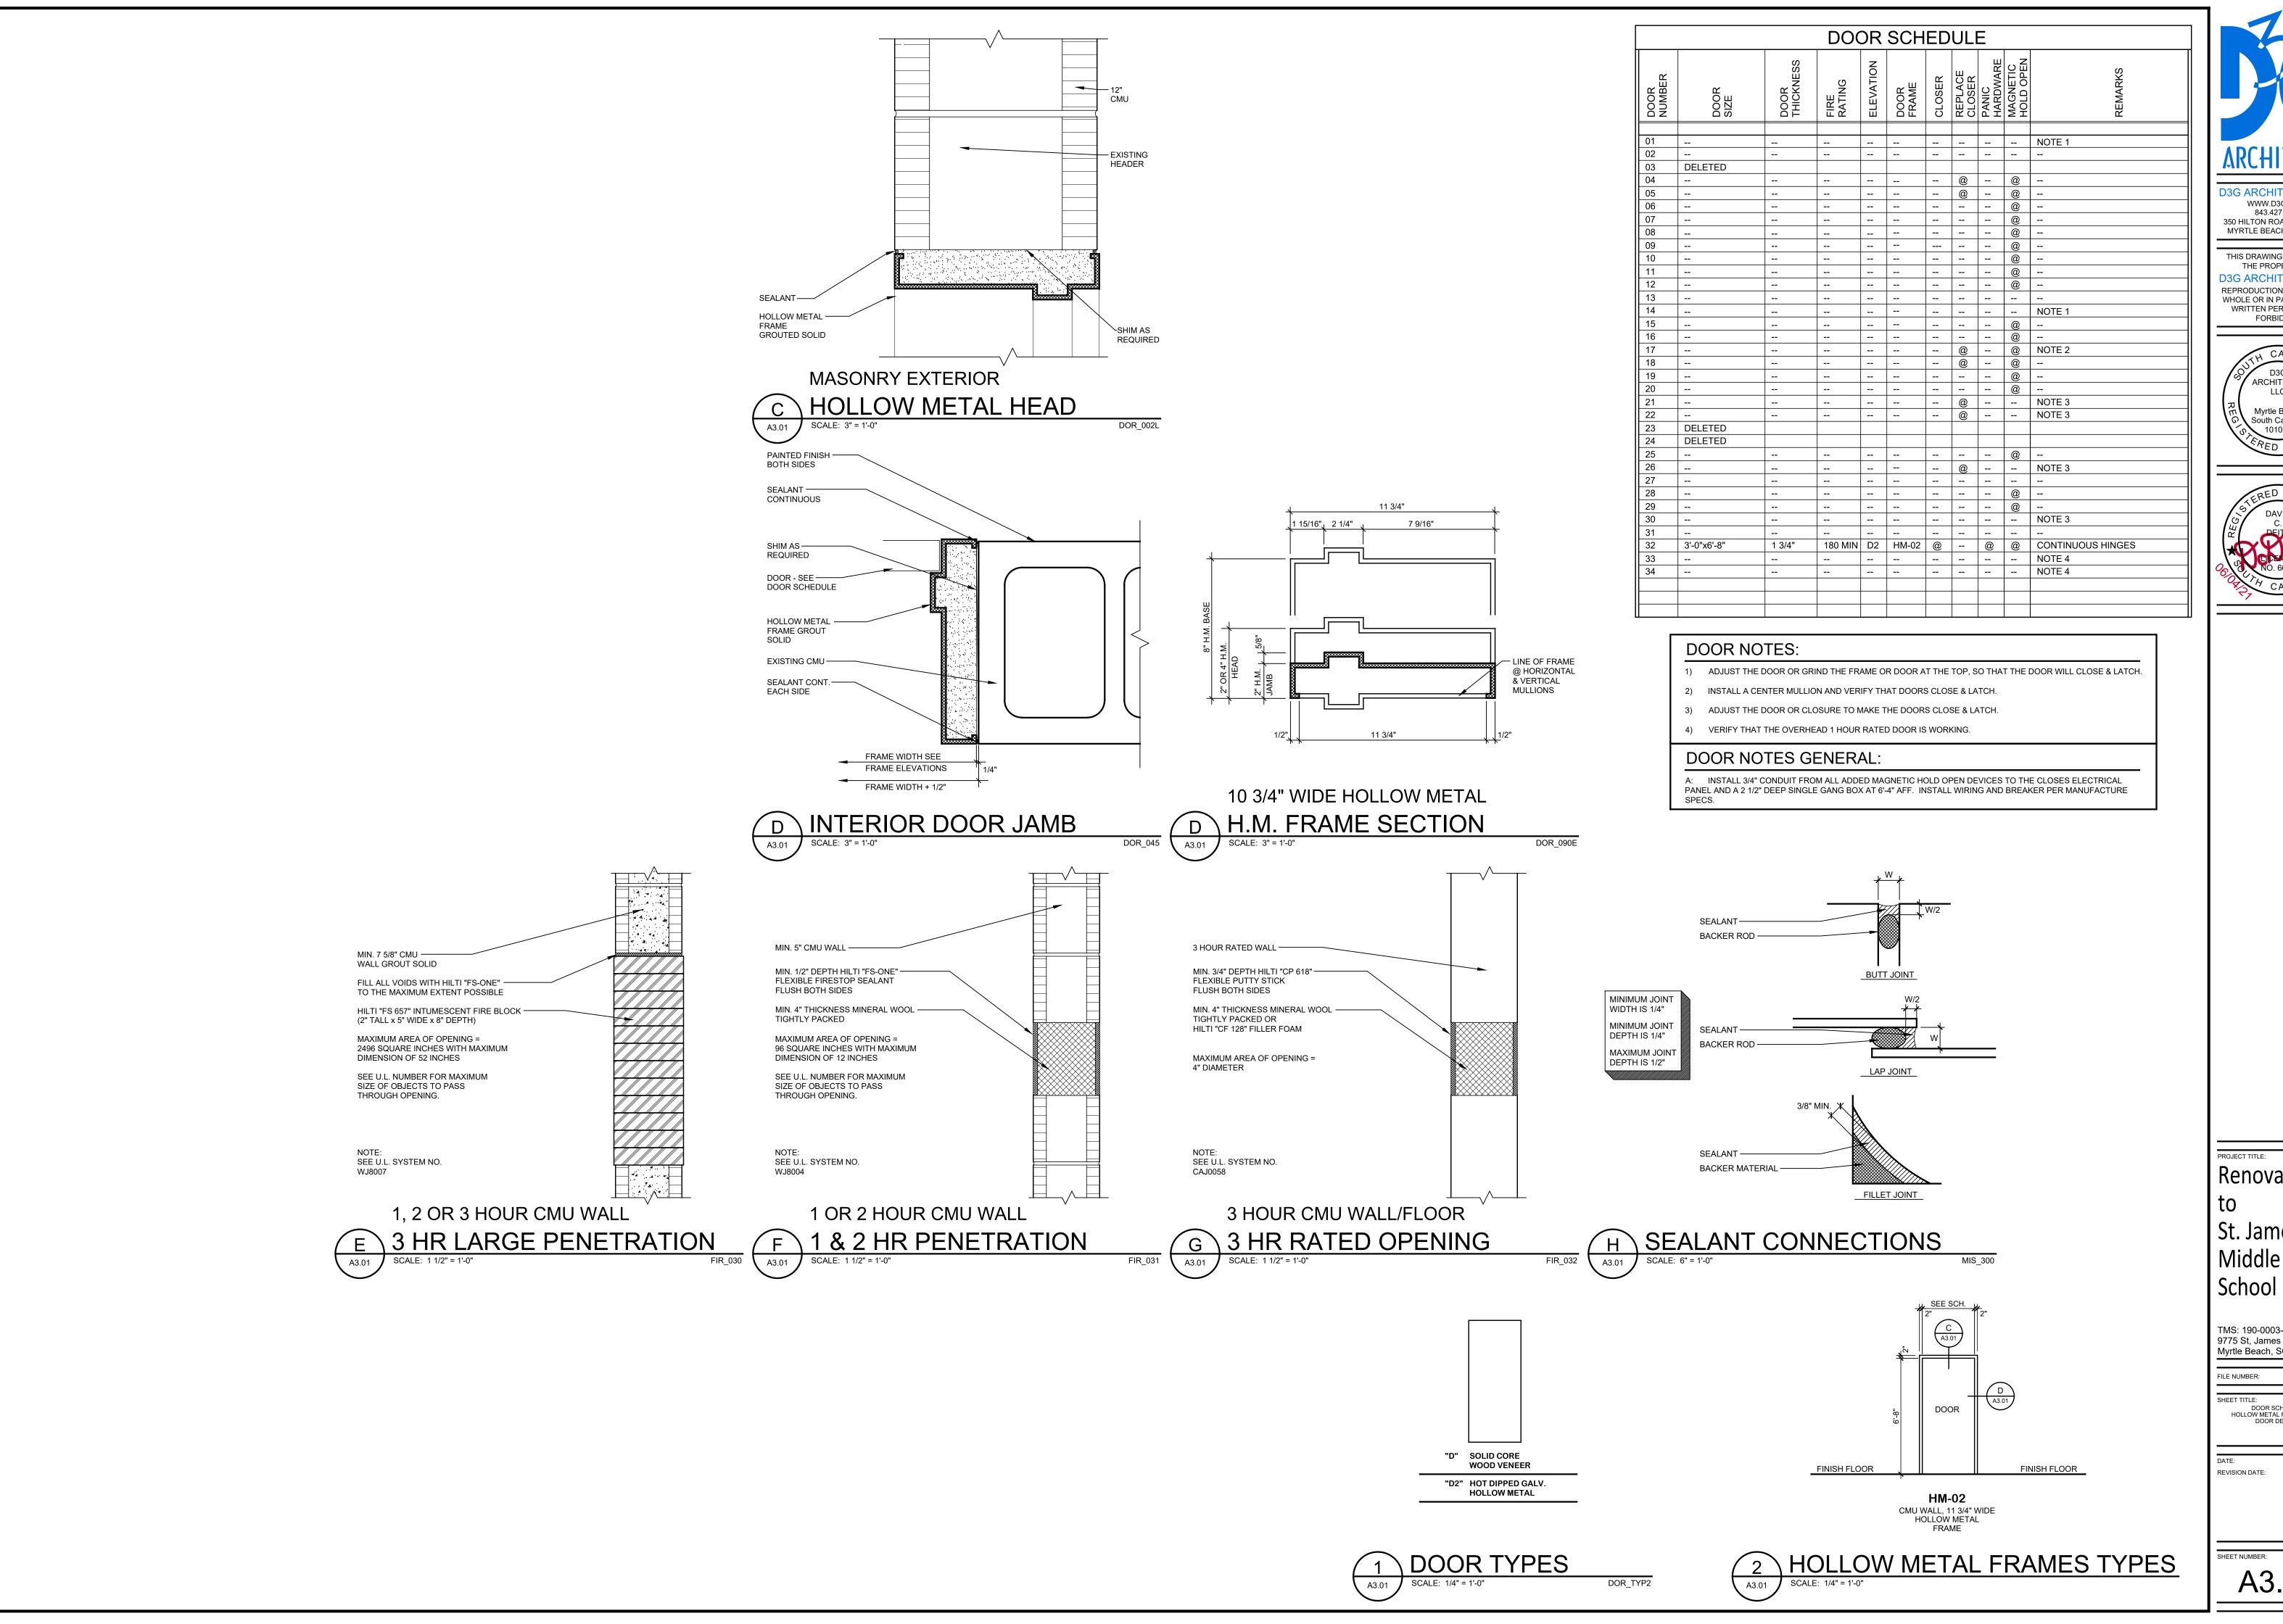
FILE NUMBER: 2123

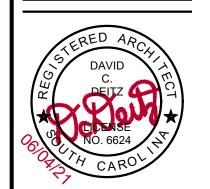SHEET TITLE:
WALL SECTIONS

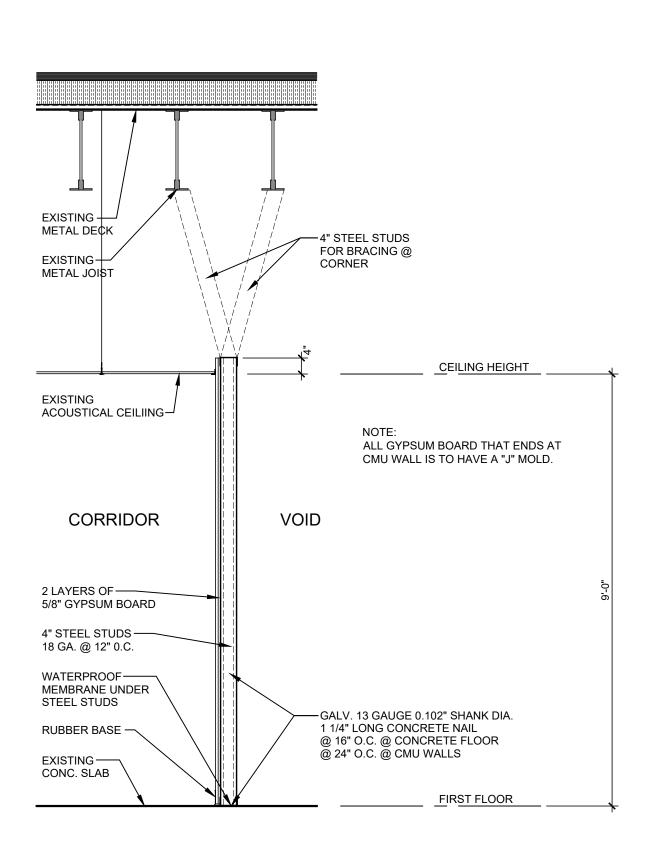DATE: June 4, 2021
REVISION DATE:

SHEET NUMBER:

A2.01




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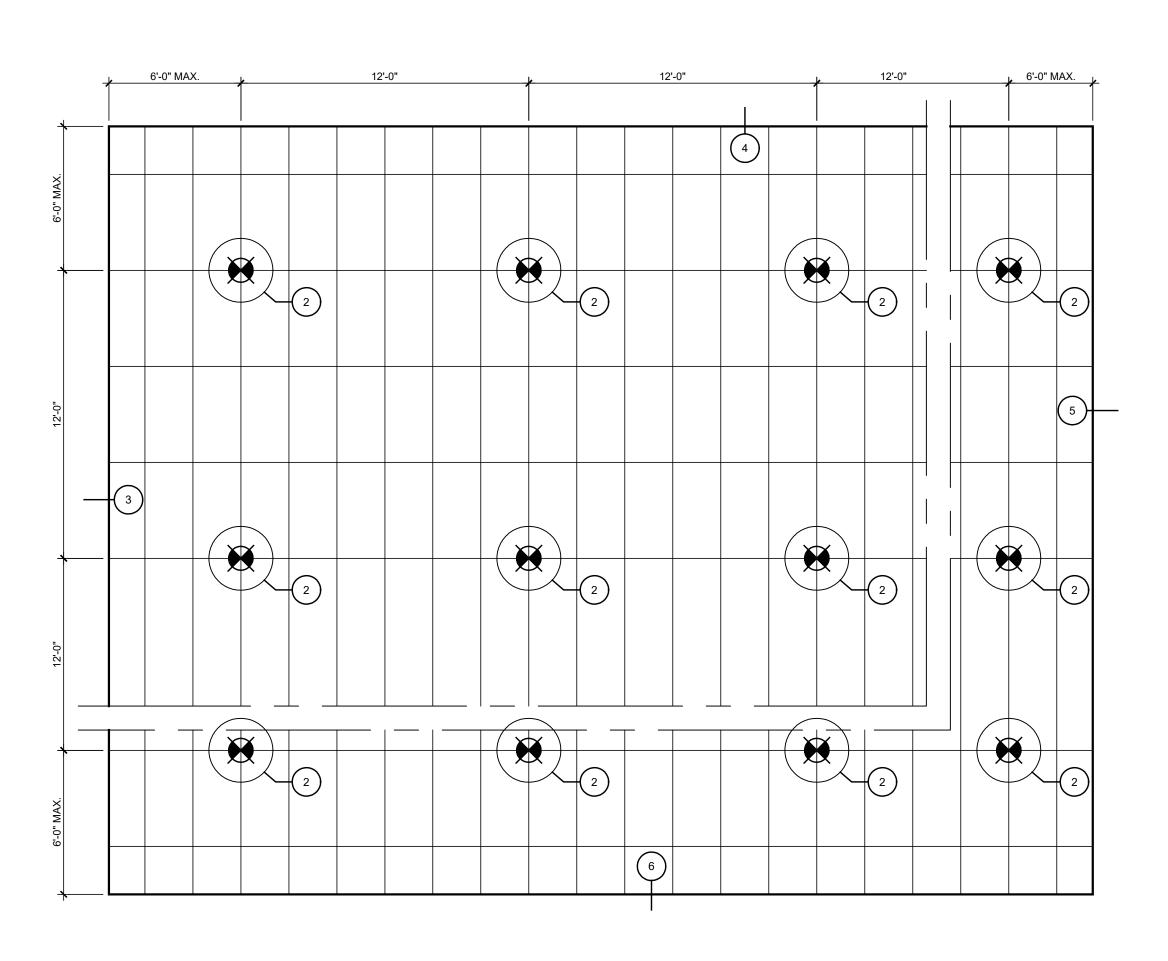
Renovations St. James


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Myrtle Beach, SC FILE NUMBER:

HOLLOW METAL FRAME TYPES DOOR DETAILS REVISION DATE:

DOOR SCHEDULE

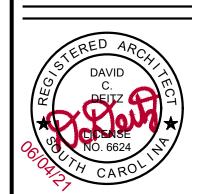

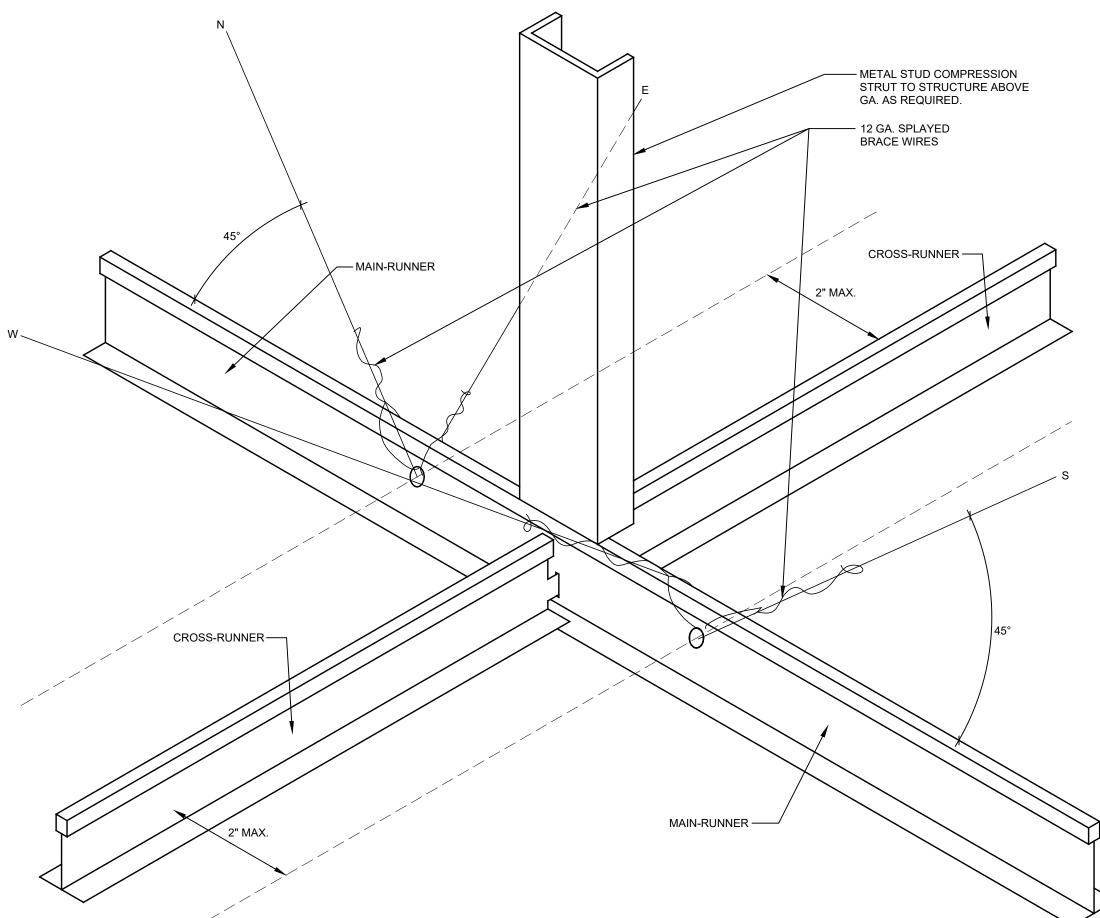

### ACOUSTICAL CEILING TYPICAL BRACING DETAIL FOR A SPACE OVER 1,000 SF


A4.02


HORIZONTAL SEISMIC RESTRAINT CEILING GRID (SEISMIC) XXX\_000 A4.02 SCALE: 6" = 1'-0"


8" MAX. 8" MAX. — SEISMIC CLIPS PER MANUFACTURE --- MAIN-RUNNER ---- MAIN-RUNNER ─ ATTACHMENT SCREW — 2 WALL ATTACHMENT SCREW — WALL ANGLE —EDGE OF WALL ----- EDGE OF WALL NOTE: ATTACHED AT TWO (2) ADJACENT WALLS

MAIN-RUNNER @ WALL (ATTACHED)


3 CEILING GRID (SEISMIC)

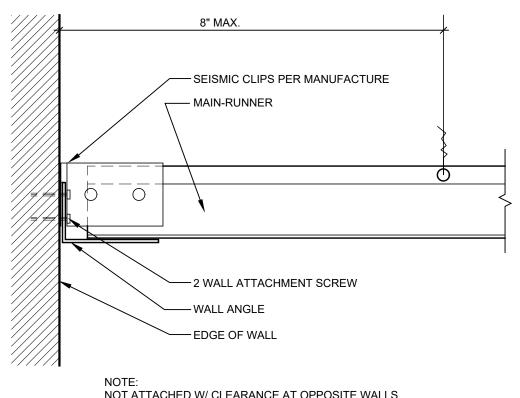

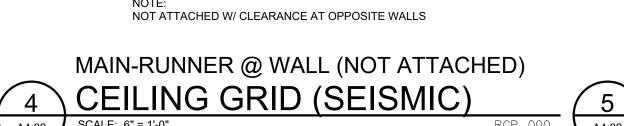

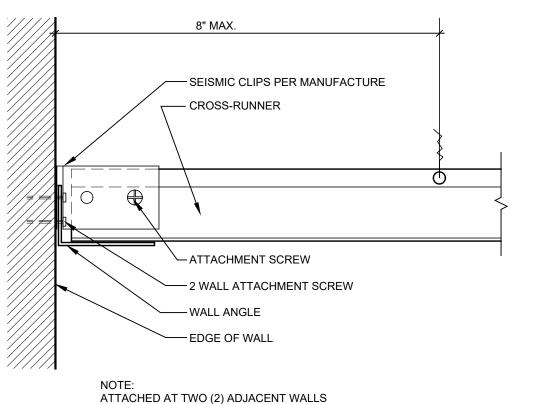



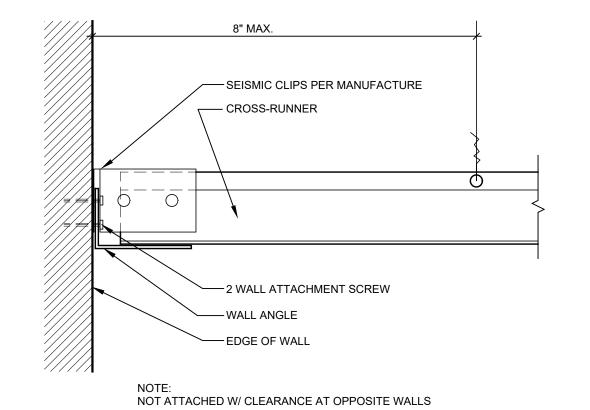

CROSS-RUNNER @ WALL (NOT ATTACHED) 6 CEILING GRID (SEISMIC)




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#### ACOUSTICAL CEILING 2018 SEISMIC INSTALLATION

1.0 INSTALLATION
A: GENERAL: INSTALL ACOUSTICAL PANEL CEILINGS TO COMPLY WITH ASTM C 636 AND SEISMIC DESIGN CATEGORY D, E & F REQUIREMENTS, PER MANUFACTURER'S WRITTEN INSTRUCTIONS AND CISCA'S "CEILING SYSTEMS HANDBOOK FOR ZONES 3-4", AND IBC 2018 SEISMIC INSTALLATION REQUIREMENTS.

RCP\_000

2.0 QUALITY ASSURANCE
A: SOURCE LIMITATIONS: OBTAIN EACH TYPE OF ACOUSTICAL CEILING PANEL AND SUPPORTING SUSPENSION SYSTEM THROUGH ONE SOURCE FROM A SINGLE

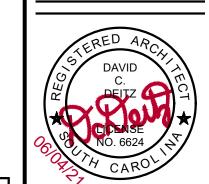B: SURFACE-BURNING CHARACTERISTICS: PROVIDE ACOUSTICAL PANELS WITH THE FOLLOWING SURFACE CHARACTERISTICS COMPLYING WITH ASTM E 1264 FOR CLASS A MATERIALS AS DETERMINED BY TESTING IDENTICAL PRODUCTS PER ASTM E 84: C: SMOKE-DEVELOPED INDEX: 450 OR LESS.

D: SEISMIC STANDARD: SEISMIC DESIGN CATEGORY D. PROVIDE ACOUSTICAL PANEL CEILINGS DESIGNED AND INSTALLED TO WITHSTAND THE EFFECTS OF EARTHQUAKE MOTIONS ACCORDING TO THE FOLLOWING:

E: PREINSTALLATION CONFERENCE: CONDUCT CONFERENCE AT PROJECT SITE TO COMPLY WITH REQUIREMENTS IN DIVISION 1 SECTION "PROJECT MANAGEMENT AND

3.0 METAL SUSPENSION SYSTEMS, GENERAL
A: COMPLY WITH CISCA 3-4 AND IBC 2006 SEISMIC INSTALLATION REQUIREMENTS.

B: METAL SUSPENSION SYSTEM STANDARD: PROVIDE MANUFACTURER'S STANDARD DIRECT-HUNG METAL SUSPENSION SYSTEMS OF TYPES, STRUCTURAL CLASSIFICATIONS. AND FINISHES INDICATED THAT COMPLY WITH APPLICABLE REQUIREMENTS IN ASTM C 635. C: FINISHES AND COLORS, GENERAL: COMPLY WITH NAAMM'S "METAL FINISHES MANUAL FOR ARCHITECTURAL AND METAL PRODUCTS" FOR RECOMMENDATIONS FOR APPLYING AND DESIGNATING FINISHES. PROVIDE MANUFACTURER'S STANDARD FACTORY-APPLIED FINISH FOR TYPE OF SYSTEM INDICATED.

D: HIGH-HUMIDITY FINISH: COMPLY WITH ASTM C 635 REQUIREMENTS FOR "COATING CLASSIFICATION FOR SEVERE ENVIRONMENT PERFORMANCE" WHERE HIGH-HUMIDITY

FINISHES ARE INDICATED. E: ATTACHMENT DEVICES: SIZE FOR FIVE TIMES THE DESIGN LOAD INDICATED IN ASTM

C 635, TABLE 1, "DIRECT HUNG," UNLESS OTHERWISE INDICATED. COMPLY WITH SEISMIC DESIGN REQUIREMENTS.

F: WIRE HANGERS, BRACES, AND TIES: PROVIDE WIRES COMPLYING WITH THE FOLLOWING REQUIREMENTS: G: ZINC-COATED, CARBON-STEEL WIRE: ASTM A 641/A 641M, CLASS 1 ZINC COATING,

SOFT TEMPER. H: STAINLESS-STEEL WIRE: ASTM A 580/A 580M, TYPE 304, NONMAGNETIC. NICKEL-COPPER-ALLOY WIRE: ASTM B 164, NICKEL-COPPER-ALLOY UNS NO. N04400.

SIZE: SELECT WIRE DIAMETER SO ITS STRESS AT 3 TIMES HANGER DESIGN LOAD (ASTM C 635, TABLE 1, "DIRECT HUNG") WILL BE LESS THAN YIELD STRESS OF FIRE, BUT PROVIDE NOT LESS THAN 0.106-INCH- (2.69-MM.) DIAMETER WIRE. K: HANGER RODS: MILD STEEL, ZINC COATED OR PROTECTED WITH RUST-INHIBITIVE

L: ANGLE HANGERS: ANGLES WITH LEGS NOT LESS THAN 7/8 INCH (22 MM) WIDE; FORMED WITH 0.04-INCH- (1-MM-) THICK, GALVANIZED STEEL SHEET COMPLYING WITH ASTM A 653/A 653M, G90 (Z275) COATING DESIGNATION; WITH BOLTED CONNECTIONS AND 5/16-INCH- (8-MM-) DIAMETER BOLTS.

M: SEISMIC STABILIZER BARS: MANUFACTURER'S STANDARD PERIMETER STABILIZERS DESIGNED TO ACCOMMODATE SEISMIC FORCES. M: SEISMIC STRUTS: MANUFACTURER'S STANDARD COMPRESSION STRUTS DESIGNED TO ACCOMMODATE SEISMIC FORCES.

O: SEISMIC CLIPS: MANUFACTURER'S STANDARD SEISMIC CLIPS DESIGNED AND SPACED TO SECURE ACOUSTICAL PANELS IN-PLACE.

P: HOLD-DOWN CLIPS: WHERE INDICATED, PROVIDE MANUFACTURER'S STANDARD HOLD-DOWN CLIPS SPACED 24" (610 MM) O.C. ON ALL CROSS TEES. Q: IMPACT CLIPS: WHERE INDICATED, PROVIDE MANUFACTURER'S STANDARD IMPACT-CLIP SYSTEM DESIGNED TO ABSORB IMPACT FORCES AGAINST ACOUSTICAL PANELS.

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