# ARLINGTON COUNTY, VIRGINIA OFFICE OF THE PURCHASING AGENT 2100 CLARENDON BOULEVARD, SUITE 500 ARLINGTON, VIRGINIA 22201

#### **CONTRACT AWARD COVERPAGE**

TO: ARDENT COMPANY, LLC DATE ISSUED: JULY 1, 2021

1307 DOLLEY MADISON BOULEVARD, SUITE 200 CONTRACT NO: 21-DES-ITB-591

MC LEAN, VIRGINIA 22101 CONTRACT TITLE: CC20 – 18<sup>TH</sup> STREET SOUTH

IMPROVEMENT PROJECT

#### THIS IS A NOTICE OF AWARD OF CONTRACT AND NOT AN ORDER. NO WORK IS AUTHORIZED UNTIL THE VENDOR RECEIVES A VALID COUNTY PURCHASE ORDER ENCUMBERING CONTRACT FUNDS.

The contract documents consist of the terms and conditions of AGREEMENT No. 21-DES-ITB-591 including any attachments or amendments thereto.

**EFFECTIVE DATE**: JULY 1, 2021

EXPIRES: MAY 31, 2023 RENEWALS: NONE

**COMMODITY CODE(S)**: 91117, 91313, 91319

LIVING WAGE: N

**ATTACHMENTS**:

AGREEMENT No. 21-DES-ITB-591

#### **EMPLOYEES NOT TO BENEFIT:**

NO COUNTY EMPLOYEE SHALL RECEIVE ANY SHARE OR BENEFIT OF THIS CONTRACT NOT AVAILABLE TO THE GENERAL PUBLIC.

<u>VENDOR CONTACT:</u> ARASH HOOSHANGI <u>VENDOR TEL. NO.:</u> (703) 288-3250x210

EMAIL ADDRESS: ARASH@ARDENTCOMPANY.COM

COUNTY CONTACT: ARIEL YANG, DES-TRANSPORTATION PLAN COUNTY TEL. NO.: (703) 228-4019

**COUNTY CONTACT EMAIL: AYANG@ARLINGTONVA.US** 

#### PURCHASING DIVISION AUTHORIZATION

Sy Gezachew Title: Procurement Officer Date: June 28, 2021

# ARLINGTON COUNTY, VIRGINIA OFFICE OF THE PURCHASING AGENT SUITE 500, 2100 CLARENDON BOULEVARD ARLINGTON, VA 22201

#### **AGREEMENT NO. 21-DES-ITB-591**

THIS AGREEMENT is made, on **July 1, 2021**, between **Ardent Company**, **LLC**, 1307 Dolley Madison Boulevard, Suite 200, Mc Lean, Virginia 22101 ("Contractor") a Virginia Limited Liability Company authorized to do business in the Commonwealth of Virginia, and the **County Board of Arlington County**, **Virginia**. The County and the Contractor, for the consideration hereinafter specified, agree as follows:

#### 1. CONTRACT DOCUMENTS

The Contract Documents consist of:

- Agreement No. 21-DES-ITB-591, and all modifications properly incorporated into the Agreement
- Exhibit A Arlington County Invitation to Bid No. 2-DES-ITB-591, including DES General Conditions, Special Conditions, and Supplementary Specifications incorporated herein by reference
- Exhibit B Specifications, Drawings and Construction Notes
- Exhibit C Price Bid of Contractor

Where the terms and provisions of this Agreement vary from the terms and provisions of the other Contract Documents, the terms and provisions of this Agreement will prevail over the other Contract Documents, and the remaining Contract Documents will be complementary to each other. If there are any conflicts, the most stringent terms or provisions will prevail.

The Contract Documents set forth the entire agreement between the County and the Contractor. The County and the Contractor agree that no representative or agent of either party has made any representation or promise with respect to the parties' agreement that is not contained in the Contract Documents. The Contract Documents may be referred to below as the "Contract" or the "Agreement".

#### 2. SCOPE OF WORK

The Contractor will furnish all labor, materials, and equipment for the construction of street improvement located on 18<sup>th</sup> Street in Crystal City (the "Project") and all other work shown, described, and required by the Contract Documents (hereinafter "the Work").

The Work shall be performed according to the standards established by the Contract Documents read together as a single specification. It shall be the Contractor's responsibility, at solely the Contractor's cost, to provide sufficient services to fulfill the purposes of the Work. Nothing in the Contract Documents shall be construed to limit the Contractor's responsibility to manage the details and execution of its Work.

#### 3. PROJECT OFFICER

The performance of the Contractor is subject to the review and approval of the County Project Officer identified in Section 53, Notices, unless the Contractor is otherwise notified in writing.

#### 4. TIME FOR COMPLETION

Work under this Agreement shall achieve Substantial Completion no later than five-hundred fifty (550) consecutive calendar days after the commencement date given in a Notice to Proceed provided by the County to the Contractor, subject to any modifications made as provided for in the Contract Documents. This five-hundred fifty (550) day period shall be the Period of Performance for Substantial Completion. No Work shall be deemed Substantially Complete until it meets the requirements of Substantial Completion set forth in the General Conditions. Final Completion of the Work shall be completed no later than sixty (60) calendar days after the date of acceptance of Substantial Completion by the County Project Officer. Work will not reach Final Completion until it meets the requirements set forth in the General Conditions.

Unless otherwise provided, no claims for early completion are allowed.

#### 5. CONTRACT AMOUNT

The County will pay the Contractor in accordance with the terms of the Progress Payments and Retainage and Payment Terms sections below and at the prices shown in Exhibit C, but not more than \$2,227,700.00 for the Contractor's completion of the Work as required by the Contract Documents provided the Work is performed to the satisfaction of and is accepted by the Project Officer. The Contractor will complete the Work for the total amount specified in this section ("Contract Amount") unless such amount is modified as provided in this Agreement. The Contract Amount includes all of the Contractor's costs and fees (profit) and is inclusive of all anticipated or known site conditions, anticipated or known materials, labor, and equipment costs, or any other costs which should reasonably have been expected by the Contract Documents.

#### 6. **PROGRESS PAYMENTS AND RETAINAGE**

The County will make monthly progress payments to the Contractor upon written application by the Contractor, on the basis of a written estimate of the work performed during the preceding calendar month as approved by the Project Officer. However, 5% of each progress payment will be retained by the County until Final Completion and acceptance of all Work covered by the Agreement.

All material and work covered by partial payments will become the property solely of the County at the time the partial payment is made. However, the Contractor will have the sole responsibility, care and custody for all materials and work upon which payments have been made until Substantial Completion.

When calculating payment for materials on-site, the County shall not pay for materials which are not scheduled for incorporation into the Work within sixty (60) days from the date of application for payment.

#### 7. PAYMENT TERMS

The Contractor must submit invoices to the County's Project Officer, who will either approve the invoice or require corrections. The County will pay the Contractor 45 days after approval of an invoice for completed work which is reasonable and allocable to the Contract. The number of the County Purchase Order pursuant to work has been performed must appear on all invoices.

#### 8. PAYMENT OF SUBCONTRACTORS

The Contractor is obligated to take one of the two following actions within seven days after receipt of payment by the County for work performed by any subcontractor under this Contract:

a. Pay the subcontractor for the proportionate share of the total payment received from the County attributable to the work performed by the subcontractor under this Contract; or

b. Notify the County and the subcontractor, in writing, of the Contractor's intention to withhold all or a part of the subcontractor's payment with the reason for nonpayment.

The Contractor is obligated to pay interest to the subcontractor on all amounts owed by the Contractor to the subcontractor that remain unpaid after seven days following receipt by the Contractor of payment from the County for work performed by the subcontractor under this Contract, except for amounts withheld as allowed in subsection b., above. Unless otherwise provided under the terms of this Contract, interest will accrue at the rate of 1% per month.

The Contractor must include in each of its subcontracts, if any are permitted, a provision requiring each subcontractor to include or otherwise be subject to the same payment and interest requirements with respect to each lower-tier subcontractor.

The Contractor's obligation to pay an interest charge to a subcontractor pursuant to this section may not be construed to be an obligation of the County. A Contract modification may not be made for the purpose of providing reimbursement for such interest charge. A cost reimbursement claim may not include any amount for reimbursement for such interest charge.

#### 9. RELEASE AND REQUEST FOR FINAL PAYMENT

In order to receive final payment upon Final Completion of the Project and before Final Acceptance, the Contractor must submit to the Project Officer a signed original notarized copy of the Arlington County Release and Request for Final Payment form per the General Conditions.

#### 10. LIQUIDATED DAMAGES

Time is of the essence under this Contract. The Work must be completed within the Time for Completion. The County and the Contractor agree that damages for failure to achieve Substantial Completion of the Work by the date specified under Time for Completion are not susceptible to exact determination but that \$1,758.00 per calendar day is in proportion to the actual loss that the County would suffer from such delay. Therefore, the Contractor will pay the County as liquidated damages \$1,758.00 per day for each and every day beyond the time for Substantial Completion that the County determines Substantial Completion has not achieved. The County and the Contractor also agree that damages for failure to achieve Final Completion of the Work by the date specified under Time for Completion are not susceptible to exact determination but that \$1,758.00 per calendar day is in proportion to the actual loss the County would suffer from such delay. Therefore, the Contractor will pay the County as liquidated damages \$1,758.00 per day for each and every day beyond the time for Final Completion until Final Completion is achieved.

#### 11. NON-APPROPRIATION

All payments by the County to the Contractor pursuant to this Contract are subject to the availability of an annual appropriation for this purpose by the County Board of Arlington County, Virginia ("Board"). In the event that the Board does not appropriate funds for the goods or services provided under this Contract, the County will terminate the Contract, without termination charge or other liability to the County, on the last day of the fiscal year or when the previous appropriation has been spent, whichever occurs first.

#### 12. ESTIMATED QUANTITIES/NON-EXCLUSIVITY OF CONTRACTOR

This Contract does not obligate the County to purchase a specific quantity of items or services during Contract Term. Any quantities that are included in the Contract Documents are the present expectations of the County for the period of the Contract; and the County is under no obligation to buy that or any amount as a result of having provided this estimate or of having had any normal or otherwise measurable requirement in the past. The County may require more goods and/or services than the estimated annual quantities, and any such additional quantities will not give rise to any claim for compensation other than at the unit prices and/or rates in the Contract.

The County does not guarantee that the Contractor will be the exclusive provider of the goods or services covered by this Contract. The items or services covered by this Contract may be or become available under other County contract(s), and the County may determine that it is in its best interest to procure the items or services through those contract(s).

#### 13. COUNTY PURCHASE ORDER REQUIREMENT

County purchases are authorized only if the County issues a Purchase Order in advance of the transaction, indicating that the ordering County agency has sufficient funds available to pay for the purchase. If the Contractor provides goods or services without a signed County Purchase Order, it does so at its own risk and expense. The County will not be liable for payment for any purchases made by its employees that are not authorized by the County Purchasing Agent.

#### **14.** LIEN

It is expressly agreed that after any payment has been made by the County either to the Contractor for work done, or labor or material supplied under the Contract, the County will have a lien upon all material delivered to the site either by the Contractor, or for the Contractor, which is to be used in the performance of the Contract.

#### 15. VALUE ENGINEERING PROPOSAL (VE)

Unless otherwise provided, the Contractor may submit to the County a written VE for modifying the plans, specifications, or other requirements of the Agreement covering the work (Contract) for the purpose of reducing the total cost of the Contract without reducing the design capacity or quality of the finished product. If the VEP is accepted by the County, the net savings will be equally divided by the County and the Contractor.

Each VEP shall result in a net savings over the Contract cost without impairing essential functions and characteristics of the item(s) or of any other part of the project, including, but not limited to, service life, reliability, economy of operation, ease of maintenance, aesthetics, and safety. At least the following information shall be submitted with each VE:

- (a) a statement that the proposal is submitted as a VE;
- (b) a statement concerning the basis for the VE, benefits to the County, and an itemization of the Contract items and requirements affected by the VE;
- (c) a detailed estimate of the cost under the existing Contract and under the VE;
- (d) proposed specifications and recommendations as to the manner in which the VE changes are to be accomplished; and

(e) a statement as to the time by which a Contract Amendment adopting the VE must be issued so as to obtain the maximum cost-effectiveness.

The County will process the VE in the same manner as prescribed for any other proposal that would necessitate issuance of an Amendment. The County may accept a VE in whole or part by issuing an Amendment that will identify the VE on which it is based. The County will not be liable to the Contractor for failure to accept or act on any VE submitted pursuant to these requirements or for delays in the work attributable to any VE. Until a VE is put into effect by an Amendment, the Contractor shall remain obligated to the terms and conditions of the existing Agreement. If an executed Amendment has not been issued by the date on which the Contractor's proposal specifies that a decision should be made or such other date as the Contractor may subsequently have specified in writing, the VE shall be deemed rejected.

The Amendment effecting the necessary modification of the Contract will establish the net savings agreed on, provide for adjustment of the contract prices, and indicate the net savings. The Contractor shall absorb all costs incurred in preparing a VE. Reasonably incurred costs for reviewing and administering a VE will be borne by the County. The County may establish any reasonable conditions it deems appropriate for consideration, approval, and implementation of the VE. The Contractor's 50 percent share of the net savings shall constitute full compensation to it, including by way of illustration and not limitation compensation for time, for effecting all changes pursuant to the Amendment.

Unless specifically provided for in the Amendment authorizing the VE, acceptance of the VE and performance of the work thereunder will not change the Contract Term limit.

The County may adopt a VE for general use in contracts administered by the County if it determines that the VE is suitable for application to other contracts. A VE identical with or similar to a previously submitted VE will be eligible for consideration and compensation under these provisions if it has not been previously adopted for general application to other contracts administered by the County. When a VE is adopted for general use, compensation pursuant to these requirements will be applied only to those awarded contracts for which the VE was submitted prior to the date of adoption of the VE.

If a VEP is based on or is similar to a change in the plans, specifications, or special provisions adopted by the County prior to submission of the VE, as determined by the County, the County will not accept the VE.

The County will be the sole judge of the acceptability of a VE. The requirements herein apply to each VE initiated, developed, and identified as such by the Contractor at the time of its submission to the County. However, nothing herein shall be construed as requiring the County to consider or approve a VE, and the decision to enter into an Amendment to the contract to accommodate a VE shall be in the County's sole discretion.

Subject to the provisions contained herein, the County, or any other public agency with the County's permission, shall have the right to use all or part of an accepted VE without obligation or compensation of any kind to the Contractor.

If a VE is accepted by the County, any provisions herein that pertain to the adjustment of contract unit prices attributable to alterations of contract quantities will not apply to the items adjusted or deleted as a result of putting the VE into effect by an Amendment.

#### 16. EMPLOYMENT DISCRIMINATION BY CONTRACTOR PROHIBITED

During the performance of its work pursuant to this Contract:

- A. The Contractor will not discriminate against any employee or applicant for employment because of race, religion, color, sex, national origin, age or disability or on any other basis prohibited by state law. The Contractor agrees to post in conspicuous places, available to employees and applicants for employment, notices setting forth the provisions of this nondiscrimination clause.
- B. Notices, advertisements and solicitations placed in accordance with federal law, rule or regulation will be deemed sufficient for meeting the requirements of this section.
- C. The Contractor will state in all solicitations or advertisements for employees that it places or causes to be placed that such Contractor is an Equal Opportunity Employer.
- D. The Contractor will comply with the provisions of the Americans with Disabilities Act of 1990 ("ADA"), which prohibits discrimination against individuals with disabilities in employment and mandates that disabled individuals be provided access to publicly and privately provided services and activities.
- E. The Contractor must include the provisions of the foregoing paragraphs in every subcontract or purchase order of more than \$10,000.00 relating to this Contract so that the provisions will be binding upon each subcontractor or vendor.

#### 17. <u>EMPLOYMENT OF UNAUTHORIZED ALIENS PROHIBITED</u>

In accordance with §2.2-4311.1 of the Code of Virginia, as amended, the Contractor must not during the performance of this Contract knowingly employ an unauthorized alien, as that term is defined in the federal Immigration Reform and Control Act of 1986.

#### 18. DRUG-FREE WORKPLACE TO BE MAINTAINED BY CONTRACTOR

During the performance of this Contract, the Contractor must: (i) provide a drug-free workplace for its employees; (ii) post in conspicuous places, available to employees and applicants for employment, a statement notifying employees that the unlawful manufacture, sale, distribution, dispensation, possession, or use of a controlled substance or marijuana is prohibited in the Contractor's workplace and specifying the actions that will be taken against employees for violating such prohibition; (iii) state in all solicitations or advertisements for employees placed by or on behalf of the Contractor that the Contractor maintains a drug-free workplace; and (iv) include the provisions of the foregoing clauses in every subcontract or purchase order of more than \$10,000.00 relating to this Contract so that the provisions will be binding upon each subcontractor or vendor.

For the purposes of this section, "workplace" means the site(s) for the performance of the work required by this Contract.

#### 19. \*SEXUAL HARASSMENT POLICY

If the Contractor employs more than five employees, the Contractor shall (i) provide annual training on the Contractor's sexual harassment policy to all supervisors and employees providing services in the Commonwealth, except such supervisors or employees that are required to complete sexual harassment training provided by the Department of Human Resource Management, and (ii) post the Contractor's

sexual harassment policy in (a) a conspicuous public place in each building located in the Commonwealth that the Contractor owns or leases for business purposes and (b) the Contractor's employee handbook.

#### 20. PROJECT STAFF

The County has the right to reasonably reject staff or subcontractors whom the Contractor assigns to the Project. The Contractor must then provide replacement staff or subcontractors satisfactory to the County in a timely manner and at no additional cost to the County. The day-to-day supervision and control of the Contractor's employees and its subcontractors is the sole responsibility of the Contractor.

#### 21. FAILURE TO DELIVER

If the Contractor fails to deliver goods or services in accordance with the Contract terms and conditions, the County, after notice to the Contractor, may procure the goods or services from other sources and hold the Contractor responsible for any resulting additional purchase and administrative costs. The County shall be entitled to offset such costs against any sums owed by the County to the Contractor. However, if public necessity requires the use of nonconforming materials or supplies, they may be accepted at a reduction in price to be determined solely by the County.

#### 22. <u>UNSATISFACTORY WORK</u>

If any of the work done, or material, goods, or equipment provided by the Contractor, is unsatisfactory to the County the Contractor must, upon notice from the County, immediately remove at the Contractor's expense such unsatisfactory work, material, goods, or equipment and replace the same with work, material, goods, or equipment satisfactory to the County. If the Contractor fails to do so after fifteen (15) days the County shall have the right to remove or replace the rejected work, material, goods, or equipment at the expense of the Contractor and offset the expense and administrative costs against any sums owed to the Contractor. This provision applies during the Contract term and during any warranty or guarantee period. At the Project Officer's discretion, rather than correction or replacement of the work, an appropriate adjustment to the Contract Amount may be made.

#### 23. <u>TERMINATION</u>

The County may terminate this Contract at any time as follows: (1) for cause, if, as determined by the County, the Contractor is in breach or default or has failed to perform the Work satisfactorily; or (2) for the convenience of the County.

Upon receipt of a notice of termination, the Contractor must not place any further orders or subcontracts for materials, services or facilities; must terminate all vendors and subcontracts, except as are necessary for the completion of any portion of the Work that the County did not terminate; and must immediately deliver all documents related to the terminated Work to the County.

Any purchases that the Contractor makes after the notice of termination will be the sole responsibility of the Contractor, unless the County has approved the purchases in writing as necessary for completion of any portion of the Work that the County did not terminate.

If any court of competent jurisdiction finds a termination for cause by the County to be improper, then the termination will be deemed a termination for convenience.

#### A. TERMINATION FOR CAUSE, INCLUDING BREACH AND DEFAULT; CURE

1. <u>Termination for Unsatisfactory Performance</u>. If the County determines that the Contractor has failed to perform satisfactorily, then the County will give the Contractor

written notice of such failure(s) and the opportunity to cure them within 15 days or any other period specified by the County ("Cure Period"). If the Contractor fails to cure within the Cure Period, the County may terminate the Contract for failure to provide satisfactory performance by providing written notice with a termination date. Upon such termination, the Contractor may apply for compensation for Contract services that the County previously accepted ("Termination Costs"), unless payment is otherwise barred by the Contract. The Contractor must submit any request for Termination Costs, with all supporting documentation, to the County Project Officer within 30 days after the expiration of the Cure Period. The County may accept or reject the request for Termination Costs, in whole or in part, and may notify the Contractor of its decision within a reasonable time.

In the event of termination by the County for failure to perform satisfactorily, the Contractor must continue to provide its services as previously scheduled through the termination date, and the County must continue to pay all fees and charges incurred through the termination date.

2. <u>Termination for Breach or Default</u>. If the County terminates the Contract for default or breach of any Contract provision or condition, then the termination will be immediate after notice of termination to the Contractor (unless the County provides for an opportunity to cure), and the Contractor will not be permitted to seek Termination Costs.

Upon any termination pursuant to this section, the Contractor will be liable to the County for costs that the County must expend to complete the Work, including costs resulting from any related delays and from unsatisfactory or non-compliant work performed by the Contractor or its subcontractors. The County will deduct such costs from any amount due to the Contractor; or if the County does not owe the Contractor, the Contractor must promptly pay the costs within 15 days of a demand by the County. This section does not limit the County's recovery of any other damages to which it is entitled by law.

Except as otherwise directed by the County, the Contractor must stop work on the date of receipt the notice of the termination.

#### B. TERMINATION FOR THE CONVENIENCE OF THE COUNTY

The County may terminate this Contract in whole or in part whenever the Purchasing Agent determines that termination is in the County's best interest. The County will give the Contractor at least 15 days' notice in writing. The notice must specify the extent to which the Contract is terminated and the effective termination date. The Contractor will be entitled to Termination Costs, as defined above, plus any other reasonable amounts that the parties might negotiate; but no amount will be allowed for anticipatory profits.

Except as otherwise directed by the County, the Contractor must stop work on the date of receipt of the notice of the termination.

#### 24. INDEMNIFICATION

The Contractor covenants for itself, its employees and its subcontractors to save, defend, hold harmless and indemnify the County and all of its elected and appointed officials, officers, current and former employees, agents, departments, agencies, boards and commissions (collectively the "County ITB No. 21-DES-ITB-591

Page 8

Indemnitees") from and against any and all claims made by third parties for any and all losses, damages, injuries, fines, penalties, costs (including court costs and attorneys' fees), charges, liability, demands or exposure resulting from, arising out of or in any way connected with the Contractor's acts or omissions, including the acts or omissions of its employees, vendors, delivery drivers and/or subcontractors, in performance or nonperformance of the Contract. This duty to save, defend, hold harmless and indemnify will survive the termination of this Contract. If the Contractor fails or refuses to fulfill its obligations contained in this section, the Contractor must reimburse the County for any and all resulting payments and expenses, including reasonable attorneys' fees. The Contractor must pay such expenses upon demand by the County, and failure to do so may result in the County withholding such amounts from any payments to the Contractor under this Contract.

#### 25. <u>INTELLECTUAL PROPERTY INDEMNIFICATION</u>

The Contractor warrants and guarantees that in providing services under this Contract neither the Contractor nor any subcontractor is infringing on the intellectual property rights (including, but not limited to, copyright, patent, mask and trademark) of third parties.

If the Contractor or any of its employees or subcontractors uses any design, device, work or material that is covered by patent or copyright, it is understood that the Contract Amount includes all royalties, licensing fees, and any other costs arising from such use in connection with the Work under this Contract.

The Contractor covenants for itself, its employees and its subcontractors to save, defend, hold harmless, and indemnify the County Indemnitees, as defined above, from and against any and all claims, losses, damages, injuries, fines, penalties, costs (including court costs and attorneys' fees), charges, liability or exposure for infringement of or on account of any trademark, copyright, patented or unpatented invention, process or article manufactured or used in the performance of this Contract. This duty to save, defend, hold harmless and indemnify will survive the termination of this Contract. If the Contractor fails or refuses to fulfill its obligations contained in this section, the Contractor must reimburse the County for any and all resulting payments and expenses, including reasonable attorneys' fees. The Contractor must pay such expenses upon demand by the County, and failure to do so may result in the County withholding such amounts from any payments to the Contractor under this Contract.

#### 26. <u>COPYRIGHT</u>

By this Contract, the Contractor irrevocably transfers, assigns, sets over and conveys to the County all rights, title and interest, including the sole exclusive and complete copyright interest, in any and all copyrightable works created pursuant to this Contract. The Contractor will execute any documents that the County requests to formalize such transfer or assignment.

The rights granted to the County by this section are irrevocable and may not be rescinded or modified, including in connection with or as a result of the termination of or a dispute concerning this Contract.

The Contractor may not use subcontractors or third parties to develop or provide input into any copyrightable materials produced pursuant to this Contract without the County's advance written approval and unless the Contractor includes this Copyright provision in any contract or agreement with such subcontractors or third parties related to this Contract.

#### 27. OWNERSHIP AND RETURN OF RECORDS

This Contract does not confer on the Contractor any ownership rights or rights to use or disclose the County's data or inputs.

All drawings, specifications, blueprints, data, information, findings, memoranda, correspondence, documents or records of any type, whether written, oral or electronic, and all documents generated by the Contractor or its subcontractors as a result of this Contract (collectively "Records") are the exclusive property of the County and must be provided or returned to the County upon completion, termination, or cancellation of this Contract. The Contractor will not use or willingly cause or allow such materials to be used for any purpose other than performance of this Contract without the written consent of the County.

The Records are confidential, and the Contractor will neither release the Records nor share their contents. The Contractor will refer all inquiries regarding the status of any Record to the Project Officer or to his or her designee. At the County's request, the Contractor will deliver all Records, including hard copies of electronic records, to the Project Officer and will destroy all electronic Records.

The Contractor agrees to include the provisions of this section as part of any contract or agreement related to this Contract into which it enters with subcontractors or other third parties.

The provisions of this section will survive any termination or cancellation of this Contract.

#### 28. <u>CONFIDENTIAL INFORMATION</u>

The Contractor and its employees, agents and subcontractors will hold as confidential all County information obtained under this Contract. Confidential information includes, but is not limited to, nonpublic personal information; personal health information (PHI); social security numbers; addresses; dates of birth; other contact information or medical information about a person; and information pertaining to products, operations, systems, customers, prospective customers, techniques, intentions, processes, plans and expertise. The Contractor must take reasonable measures to ensure that all of its employees, agents and subcontractors are informed of and abide by this requirement.

#### 29. ETHICS IN PUBLIC CONTRACTING

This Contract incorporates by reference Article 9 of the Arlington County Purchasing Resolution, as well as all state and federal laws related to ethics, conflicts of interest or bribery, including the State and Local Government Conflict of Interests Act (Code of Virginia § 2.2-3100 et seq.), the Virginia Governmental Frauds Act (Code of Virginia § 18.2-498.1 et seq.) and Articles 2 and 3 of Chapter 10 of Title 18.2 of the Code of Virginia, as amended (§ 18.2-438 et seq.). The Contractor certifies that its bid was made without collusion or fraud; that it has not offered or received any kickbacks or inducements from any other offeror, supplier, manufacturer or subcontractor; and that it has not conferred on any public employee having official responsibility for this procurement any payment, loan, subscription, advance, deposit of money, services or anything of more than nominal value, present or promised, unless consideration of substantially equal or greater value was exchanged.

#### 30. COUNTY EMPLOYEES

No Arlington County employee may share in any part of this Contract or receive any benefit from the Contract that is not available to the general public.

#### 31. FORCE MAJEURE

Neither party will be held responsible for failure to perform the duties and responsibilities imposed by this Contract if such failure is due to a fire, riot, rebellion, natural disaster, war, act of terrorism or act of God that is beyond the control of the party and that makes performance impossible or illegal, unless otherwise specified in the Contract.

#### 32. AUTHORITY TO TRANSACT BUSINESS

The Contractor must, pursuant to Code of Virginia § 2.2-4311.2, be and remain authorized to transact business in the Commonwealth of Virginia during the entire term of this Contract. Otherwise, the Contract is voidable at the sole option of and with no expense to the County.

#### 33. RELATION TO THE COUNTY

The Contractor is an independent contractor, and neither the Contractor nor its employees or subcontractors will be considered employees, servants or agents of the County. The County will not be responsible for any negligence or other wrongdoing by the Contractor or its employees, servants or agents. The County will not withhold payments to the Contractor for any federal or state unemployment taxes, federal or state income taxes or Social Security tax or for any other benefits. The County will not provide to the Contractor any insurance coverage or other benefits, including workers' compensation.

#### 34. ANTITRUST

The Contractor conveys, sells, assigns and transfers to the County all rights, title and interest in and to all causes of action under state or federal antitrust laws that the Contractor may have relating to this Contract.

#### 35. REPORT STANDARDS

The Contractor must submit all written reports required by this Contract for advance review in a format approved by the Project Officer. Reports must be accurate and grammatically correct and should not contain spelling errors. The Contractor will bear the cost of correcting grammatical or spelling errors and inaccurate report data and of other revisions that are required to bring the report(s) into compliance with this section.

Whenever possible, proposals must comply with the following guidelines:

- printed double-sided on at least 30% recycled-content and/or tree-free paper
- recyclable and/or easily removable covers or binders made from recycled materials (proposals with glued bindings that meet all other requirements are acceptable)
- avoid use of plastic covers or dividers
- avoid unnecessary attachments or documents or superfluous use of paper (e.g. separate title sheets or chapter dividers)

#### 36. AUDIT

The Contractor must retain all books, records and other documents related to this Contract for at least five years, or such period of time required by the County's funding partner(s), if any, whichever is greater, after the final payment and must allow the County or its authorized agents to examine the documents during this period and during the Contract Term. The Contractor must provide any requested documents to the County for examination within 15 days of the request, at the Contractor's expense. Should the County's examination reveal any overcharging by the Contractor, the Contractor must, within 30 days of County's request, reimburse the County for the overcharges and for the reasonable costs of the County's examination, including, but not limited to, the services of external audit firm and attorney's fees; or the County may deduct the overcharges and examination costs from any amount that the County owes to the Contractor. If the Contractor wishes to destroy or dispose of any records related to this Contract (including confidential records to which the County does not have ready access) within five years after the final payment, or such period of time required by the County's funding partner(s), if any, whichever is greater,

the Contractor must give the County at least 30 days' notice and must not dispose of the documents if the County objects.

The Purchasing Agent may require the Contractor to demonstrate that it has the necessary facilities, ability, and financial resources to comply with the Contract and furnish the service, material or goods specified herein in a satisfactory manner at any time during the term of this Contract.

#### 37. **ASSIGNMENT**

The Contractor may not assign, transfer, convey or otherwise dispose of any award or any of its rights, obligations or interests under this Contract without the prior written consent of the County.

#### 38. **AMENDMENTS**

This Contract may not be modified except by written amendment executed by persons duly authorized to bind the Contractor and the County.

#### 39. ARLINGTON COUNTY PURCHASING RESOLUTION AND COUNTY POLICIES

Nothing in this Contract waives any provision of the Arlington County Purchasing Resolution, which is incorporated herein by reference, or any applicable County policy.

#### 40. DISPUTE RESOLUTION

All disputes arising under this Agreement or concerning its interpretation, whether involving law or fact and including but not limited to claims for additional work, compensation or time, and all claims for alleged breach of contract must be submitted in writing to the Project Officer as soon as the basis for the claim arises. In accordance with the Arlington County Purchasing Resolution, claims denied by the Project Officer may be submitted to the County Manager in writing no later than 60 days after the final payment. The time limit for a final written decision by the County Manager is 30 days. Procedures concerning contractual claims, disputes, administrative appeals and protests are contained in the Arlington County Purchasing Resolution. The Contractor must continue to work as scheduled pending a decision of the Project Officer, County Manager, County Board or a court of law.

#### 41. <u>APPLICABLE LAW, FORUM, VENUE, AND JURISDICTION</u>

This Contract is governed in all respects by the laws of the Commonwealth of Virginia; and the jurisdiction, forum and venue for any litigation concerning the Contract or the Work is in the Circuit Court for Arlington County, Virginia, and in no other court.

#### 42. <u>ARBITRATION</u>

No claim arising under or related to this Contract may be subject to arbitration.

#### 43. **NONEXCLUSIVITY OF REMEDIES**

All remedies available to the County under this Contract are cumulative, and no remedy will be exclusive of any other at law or in equity.

#### 44. NO WAIVER

The failure to exercise a right provided for in this Contract will not be a subsequent waiver of the same right or of any other right.

#### 45. SEVERABILITY

The sections, paragraphs, clauses, sentences, and phrases of this Contract are severable; and if any section, paragraph, clause, sentence or phrase of this Contract is declared invalid by a court of competent jurisdiction, the rest of the Contract will remain in effect.

#### 46. <u>ATTORNEY'S FEES</u>

In the event that the County prevails in any legal action or proceeding brought by the County to enforce any provision of this Contract, the Contractor will pay the County's reasonable attorney's fees and expenses.

#### 47. SURVIVAL OF TERMS

In addition to any statement that a specific term or paragraph survives the expiration or termination of this Contract, the following sections also survive: INDEMNIFICATION; INTELLECTUAL PROPERTY INDEMNIFICATION; RELATION TO COUNTY; OWNERSHIP AND RETURN OF RECORDS; AUDIT; COPYRIGHT; DISPUTE RESOLUTION; APPLICABLE LAW AND JURISDICTION; ATTORNEY'S FEES, AND CONFIDENTIAL INFORMATION.

#### 48. HEADINGS

The section headings in this Contract are inserted only for convenience and do not affect the substance of the Contract or limit the sections' scope.

#### 49. AMBIGUITIES

The parties and their counsel have participated fully in the drafting of this Agreement; and any rule that ambiguities are to be resolved against the drafting party does not apply. The language in this Agreement is to be interpreted as to its plain meaning and not strictly for or against any party.

#### 50. NOTICES

Unless otherwise provided in writing, all legal notices and other formal communications required by this Contract are deemed to have been given when either (a) delivered in person; (b) delivered by an agent, such as a delivery service; or (c) deposited in the United States mail, postage prepaid, certified or registered and addressed as follows:

Page 13

#### TO THE CONTRACTOR:

Arash Hooshangi Ardent Company, LLC PO Box 879 McLean, Virginia 22101

Email: arash@ardentcompany.com

Tel: 703.288.3250 Ext 210

#### TO THE COUNTY:

Ariel Yang, Project Officer Arlington County, Virginia 2100 Clarendon Boulevard, Suite 500 Arlington, Virginia 22201

Email: ayang@arlingonva.us

Tel: (703) 228-4019

ITB No. 21-DES-ITB-591

#### <u>AND</u>

Sharon T. Lewis, LL.M, MPS, VCO, CPPB Purchasing Agent Arlington County, Virginia 2100 Clarendon Boulevard, Suite 500 Arlington, Virginia 22201

Email: slewis1@arlingtonva.us

#### TO COUNTY MANAGER'S OFFICE (FOR PROJECT CLAIMS):

Mark Schwartz, County Manager Arlington County, Virginia 2100 Clarendon Boulevard, Suite 318 Arlington, Virginia 22201

#### 51. NON-DISCRIMINATION NOTICE

Arlington County does not discriminate against faith-based organizations.

#### 52. <u>INSURANCE, PAYMENT AND PERFORMANCE BONDS</u>

The Contractor shall maintain the required insurance coverage and payment and performance bonds as set forth in the Invitation to Bid through completion of the Contract, including all warranty and guarantee periods.

#### 53. MATERIAL CHANGES

The Contractor shall notify Purchasing Agent within seven days of any material changes in its operation that relate to any matter attested regarding certifications on its bid form.

#### 54. COUNTERPARTS

This Agreement may be executed in one or more counterparts and all of such counterparts shall together constitute one and the same instrument. Original signatures transmitted and received via facsimile or other electronic transmission (e.g., PDF or similar format) are true and valid signatures for all purposes hereunder and shall be effective as delivery of a manually executed original counterpart.

WITNESS these signatures:

THE COUNTY BOARD OF ARLINGTON COUNTY, VIRGINIA	ARDENT COMPANY, LLC
AUTHORIZED SIGNATURE: Sy Gradiew 27FC198F4A6D475	AUTHORIZED SIGNATURE:  Docusigned by:  Arash Hoshani  12F57179898046E
NAME: SY GEZACHEW	NAME:
TITLE: PROCUREMENT OFFICER	TITLE:Managing Director
DATE:6/28/2021	DATE:
ITR No. 21-DES-ITR-591	Page 1/1

	PREPARED BY:
_2705082286A WAS ISSUED ON THE FEE AND ALL RENEWAL FEES REQUIRED UN MATERIALS, AND ALL THINGS NECESSARY	TRACTOR NAME)_Ardent Company, LLC
21-DES-ITB-591	CHECKED BY:

MASTER ITEM #	DESCRIPTION	QTY	UNIT	UNIT PRICE	TOTAL
C1	GENERAL EARTH WORK	-	-		
MASTER ITEM #	DESCRIPTION	QTY	UNIT	UNIT PRICE	TOTAL
	Aggregate, VDOT #21-A (Compacted in				
02200-C1-00130	Place per VDOT standards & Specs)	1480	CY	\$45.00	\$66,600.00
01000-C1-SP121	WMATA Grate Cover (per plan detals)	3	EA	\$1,500.00	\$4,500.00
				SUBTOTAL	\$71,100.00

#### C2 **CONCRETE WORK**

MASTER ITEM #	DESCRIPTION	QTY	UNIT	UNIT PRICE	TOTAL
	Concrete Curb, Standard Header Curb C-3				
	(Arlington County Detail R-2.0), includes				
02750-C2-00020	curb for aprons, ramps, etc.	990	LF	\$30.00	\$29,700.00
	Concrete Curb & Gutter, Standard C-2 and C-				
	2R (Arlington County Detail R-2.0), includes				
02750-C2-00060	curb & gutter for aprons, ramps, etc.	1650	LF	\$30.00	\$49,500.00
	Concrete Sidewalk, 4" Thickness (Arlington				
02611-C2-00110	County Detail R-2.0)	940	SY	\$60.00	\$56,400.00
	CG-12 Detectable Warning Surface -				
02611-C2-00190	Truncated Domes	12	SY	\$200.00	\$2,400.00
	Concrete Driveway Entrance, 6" Thick				
	Residential (Arlington County Details R-2.4A,				
02611-C2-00170	R-2.4B, R-2.4C, R-2.4D)	66	SY	\$80.00	\$5,280.00
	Concrete Driveway Entrance, 9" Thick				
	Commercial (Arlington County Details R-				
02611-C2-00180	2.4A, R-2.4B, R-2.4C, R-2.4D)	200	SY	\$100.00	\$20,000.00
	Median Strip (per Arlington County Detail R-				
02611-C2-SP010	1.4)	255	SY	\$60.00	\$15,300.00
				SUBTOTAL	\$178,580.00

#### C3 ASPHALT WORK

MASTER ITEM #	DESCRIPTION	QTY	UNIT	UNITPRICE	TOTAL
	Asphalt Concrete, Planing or Milling (1/2" to				
02600-C3-00010	3" Depth)	1650	SY	\$5.00	\$8,250.00
	Asphalt Concrete, Base Course (VDOT BM-				
02600-C3-00030	25.0A)	3176	TON	\$90.00	\$285,840.00
	Asphalt Concrete, Surface Course (VDOT SM-				
02600-C3-00060	9.5A)	1059	TON	\$90.00	\$95,310.00

MASTER ITEM #	DESCRIPTION	QTY	UNIT	UNITPRICE	TOTAL
	Asphalt Concrete, Planing or Milling (1/2" to				_
02600-C3-00010	3" Depth)	1650	SY	\$5.00	\$8,250.00
	Asphalt Concrete, Base Course (VDOT BM-				
02600-C3-00030	25.0A)	3176	TON	\$90.00	\$285,840.00
	Asphalt Concrete, Surface Course (VDOT SM-				
02600-C3-00060	9.5A)	1059	TON	\$90.00	\$95,310.00
Ardent C					
BIDDER	Signature				Page 1 of 6

IS CURRENTLY REGISTE _2705082286A W	TIFIES THAT (CONTRACTOR NAME)_Ardent Company, LLC_ RED WITH THE VIRGINIA STATE BOARD OF CONTRACTORS VAS ISSUED ON THE29DAY OFFeb, 2020	S AS REQUI	ERSIGNED	HE CODE OF VIRGINIA. CE FURTHER CERTIFIES THA	T THE REGISTRATION
MATERIALS, AND ALL TI	FEES REQUIRED UNDER LAW HAVE BEEN PAID. THE CONT HINGS NECESSARY TO PERFORM THE WORK AS SET FORTH FO PERFORM RELATED WORK FOR THE FOLLOWING ITEMS LATION).	IN ACCOR	DANCE WI	TH THE PLANS AND SPECI	FICATIONS. THE
21-DES-ITB-591		CHEC	KED BY	<b>/</b> :	
MASTER ITEM #	DESCRIPTION	QTY	UNIT	UNIT PRICE	TOTAL
				SUBTOTAL	\$389,400.00
C4	STORM SEWER UTILITY WORK				
MASTER ITEM #	DESCRIPTION	QTY	UNIT	UNITPRICE	TOTAL
02500-C4-00620	15" Pipe, RCP Class III, In Place Up to 6' Deep	80	LF	\$70.00	\$5,600.00
02505-C4-00630	15" Pipe, RCP Class III, In Place 6' to 8' Deep	72	LF	\$70.00	\$5,040.00
02500 C4 00020	15" Pipe, RCP Class IV, In Place Up to 6' Deep	127		\$70.00	\$8,890.00
02500-C4-00820 02505-C4-01440	Underdrain, Standard VDOT UD-4	501		\$10.00	
02303-C4-01440	Storm Manhole MH-1 (Arlington County	301		710.00	\$5,010.00
02505-C4-00010	Detail D-3.0), In Place, DEPTH 8'	3	EA	\$1,500.00	\$4,500.00
	CB-2 (Arlington County Standards), In Place			72,000.00	<del>+ 1,000.00</del>
02505-C4-00080	Up to 6' Deep	7	EA	\$3,000.00	\$21,000.00
	Curb Drop Inlet, Standard VDOT DI-2B (12"			. ,	· ,
	to 24" Pipe), In Place Up to 9' Deep, Inlet				
02505-C4-00180	Throat Length 4' to 20'	2	EA	\$3,500.00	\$7,000.00
	Storm Manhole, Catch Basin, Drop Inlet,				
02505-C4-00600	Yard Inlet, or Grate Inlet, Remove	4	EA	\$500.00	\$2,000.00
	Storm Manhole MH-1 (Arlington County				
	Detail D-3.0), In Place, PER ADDITIONAL VF				
02500-C4-00011	OVER 8'	10	VF	\$1.00	\$10.00
	CB-2 (Arlington County Standards), Each VF				
02505-C4-00090	Over 6' Deep	25	VF	\$1.00	\$25.00
	45" D: DOD G! N/   D!	224	l. <u>-</u>	470.00	64647000
02500-C4-SP010	15" Pipe, RCP Class IV, In Place > 6' Deep	231	LF	\$70.00	\$16,170.00
02500-C4-SP020	18" Pipe, RCP Class IV, In Place > 6' Deep	104		\$80.00	\$8,320.00
02500-C4-SP020	15" RCP Pipe Removal (not included in new	104	LF	\$60.00	\$6,520.00
02500-C4-SP030	installation)	289	LF	\$5.00	\$1,445.00
02300-04-31 030	27" RCP Pipe Removal (not included in new	203		75.00	71,113.00
02500-C4-SP040	installation)	13	LF	\$5.00	\$65.00
				SUBTOTAL	\$85,075.00
				-	. ,
C5	GUARDRAIL	1		T	<u> </u>
MASTER ITEM #	DESCRIPTION	QTY	UNIT	UNITPRICE	TOTAL
				SUBTOTAL	\$0.00
C6	WATERMAIN WORK				
Ardent (	Company				

Ardent Company
BIDDER\_\_\_\_\_ Signature\_\_\_\_ Page 2 of 6

		PREPA	RED BY:	:	
IS CURRENTLY REGISTE	RTIFIES THAT (CONTRACTOR NAME)_Ardent Company, LLC_ ERED WITH THE VIRGINIA STATE BOARD OF CONTRACTOR: VAS ISSUED ON THE29DAY OFFeb, 202	s as requi			
FFF AND ALL RENEWAL	FEES REQUIRED UNDER LAW HAVE BEEN PAID. THE CONT	RACTOR AC	GREES TO E	URNISH ALL NECESSARY	ABOR, FOUTPMENT.
	HINGS NECESSARY TO PERFORM THE WORK AS SET FORTH				
	TO PERFORM RELATED WORK FOR THE FOLLOWING ITEMS	AT THE FO	LLOWING S	STIPULATED PRICES: (ALL	PRICES INCLUDE
PROVISION AND INSTA	LLATION).				
21-DES-ITB-591		CHEC	KED BY:	·	
MASTER ITEM #	DESCRIPTION	QTY	UNIT	UNIT PRICE	TOTAL
MASTER ITEM #	DESCRIPTION	QTY	UNIT	UNITPRICE	TOTAL
				SUBTOTAL	\$0.00
<b>C7</b>	SANITARY SEWER WORK				
MASTER ITEM #	DESCRIPTION	QTY	UNIT	UNITPRICE	TOTAL
		Ì		SUBTOTAL	\$0.00
		•		•	
MASTER ITEM #	TRAFFIC SIGNAL WORK DESCRIPTION	QTY	UNIT	UNITPRICE	TOTAL
13160-C8-03000	Traffic Signal Cost		LS	\$600,000.00	
15160-C8-05000	Trame signal cost	1 -	<u>  [5</u>	SUBTOTAL	\$600,000.00
				SOBIOTAL	3000,000.00
С9	STREET LIGHTING WORK				
MASTER ITEM #	DESCRIPTION	QTY	UNIT	UNITPRICE	TOTAL
	Furnish and Install 2 Inch Sch 40 PVC				
14030-C9-00040	Conduit in Trench (Detail 14030-01)	309	LF	\$10.00	\$3,090.00
	Furnish and Install Junction Box and Lid				
14040-C9-00170	SMALL (Detail 14040-01)	3	EA	\$600.00	\$1,800.00
14040-C9-00220	Enter Existing Junction Box	2	EA	\$250.00	\$500.00
14050-C9-00260	Furnish & Install # 6 TNNH Copper Cable	309	LF	\$1.00	\$309.00
	Install Streetlight Pole Foundation (Detail				
14060-C9-00290	14060-01)	3	EA	\$500.00	\$1,500.00
	Removal of Existing Foundation - up to 4'				
14060-C9-00350	Deep	1	EA	\$500.00	\$500.00
	Decorative Post-Top Aluminum Streetlight				
	Pole with Single Post-Top Luminaire per				
14160-C9-00910	Arlington Lighting Standard 14112-01	3	EA	\$5,500.00	\$16,500.00
14100-05-00510		<u>                                      </u>		SUBTOTAL	\$24,199.00
		1	1	1000.0	<del></del>
C10	PAVEMENT MARKING AND SIGNAGE WORK				
MASTER ITEM #	DESCRIPTION	QTY	UNIT	UNITPRICE	TOTAL
02900-C10-00030	Twelve (12) Inch Transverse Markings		LF	\$4.00	
02900-C10-00040	Eighteen (18) Inch Transverse Markings	170	LF	\$5.75	\$977.50
	Twenty Four (24) Inch Transverse Markings,				
	Note: Used For Continental (Ladder)				
02900-C10-00050	Crosswalk	940	1	\$6.25	
02900-C10-00070	Four (4) Inch Longitudinal Solid Line	6390	LF	\$0.60	\$3,834.00

Ardent Company
BIDDER\_\_\_\_\_ Signature\_\_\_\_ Page 3 of 6

	PREPARED BY:
THE UNDERSIGNED CERTIFIES THAT (CONTRACTOR NAME)_	_Ardent Company, LLC
IS CURRENTLY REGISTERED WITH THE VIRGINIA STATE BOA	ARD OF CONTRACTORS AS REQUIRED BY THE CODE OF VIRGINIA. CERTIFICATE NUMBER
_2705082286A WAS ISSUED ON THE29DAY O	FFeb, 2020 THE UNDERSIGNED FURTHER CERTIFIES THAT THE REGISTRATION
fee and all renewal fees required under law have i	BEEN PAID. THE CONTRACTOR AGREES TO FURNISH ALL NECESSARY LABOR, EQUIPMENT,
MATERIALS, AND ALL THINGS NECESSARY TO PERFORM THE	E WORK AS SET FORTH IN ACCORDANCE WITH THE PLANS AND SPECIFICATIONS. THE
CONTRACTOR AGREES TO PERFORM RELATED WORK FOR TI	HE FOLLOWING ITEMS AT THE FOLLOWING STIPULATED PRICES: (ALL PRICES INCLUDE
PROVISION AND INSTALLATION).	
21-DES-ITB-591	CHECKED BY:

MASTER ITEM #	DESCRIPTION	QTY	UNIT	UNIT PRICE	TOTAL
	Four (4) Inch Longitudinal Skip Line (Ten (10)				
	Foot Line/Thirty (30) Foot Spacing), Note:				
	Forty (40) LF Consists of Ten (10) LF of				
02900-C10-00080	Marking and Thirty (30) LF of Space	1750	LF	\$0.60	\$1,050.00
02900-C10-00120	Six (6) Inch Longitudinal Solid Line	540	LF	\$3.00	\$1,620.00
Six (6) Inch Longit	Six (6) Inch Longitudinal Skip Line (Two (2)				
	Foot Line/ Four (4) Foot Spacing), Note:				
	Twelve (12) LF Consists of Two (2) LF of				
02900-C10-00160	Marking and Four (4) LF of Space	550	LF	\$1.00	\$550.00
	Eight (8) Foot Letters, Note: 'Turn Only' (for				
02900-C10-00230	example)	4	EA	\$100.00	\$400.00
02900-C10-00240	Single Arrows	2	EA	\$90.00	\$180.00
	Standard Bicycle Symbols (MUTCD, Chapter				
	9C, Figure 9C-3), "Bike Symbol", "Helmeted				
02900-C10-00290	Bicyclist Symbol"	6	EA	\$190.00	\$1,140.00
	Colorized Bike Lane Coatings (per				
02900-C10-00350	Supplemental Specification 02901)	617	SF	\$12.50	\$7,712.50
	Traffic Control Sign (Typical Stop, Yield, No				
	Parking, Speed Limit, or Similar), Install per				
02900-C10-00410	Detail SG-1.0	4	EA	\$300.00	\$1,200.00
	Traffic Control Sign (Typical Stop, Yield, No				
	Parking, Speed Limit, or Similar), Relocate				
02900-C10-00430	with New Post	9	EA	\$250.00	\$2,250.00
	Traffic Control Sign (Typical Stop, Yield, No				
	Parking, Speed Limit, or Similar), Mount Sign				
02900-C10-00440	to Light or Utility Pole	1	EA	\$200.00	\$200.00
02900-C10-00441	Remove Existing signs	10	EA	\$150.00	\$1,500.00
				SUBTOTAL	\$28,749.00

#### LANDSCAPE AND HARDSCAPE

C11 **RESTORATION WORK** 

MASTER ITEM #	DESCRIPTION	QTY	UNIT	UNITPRICE	TOTAL
	Topsoil for Street Trees, Backfill Soil Mixture				
	of 3/4 Existing Soil and 1/4 Organic Material				
02800-C11-00020	(per Arlington County DPR Specification)	260	СҮ	\$30.00	\$7,800.00
02801-C11-00060	Sod, Tall Fescue/Bluegrass Mixture	1559	SY	\$3.00	\$4,677.00

MASTER ITEM #	DESCRIPTION	QTY	UNIT	UNITPRICE	TOTAL
	Topsoil for Street Trees, Backfill Soil Mixture				
	of 3/4 Existing Soil and 1/4 Organic Material				
02800-C11-00020	(per Arlington County DPR Specification)	260	CY	\$30.00	\$7,800.00
02801-C11-00060	Sod, Tall Fescue/Bluegrass Mixture	1559	SY	\$3.00	\$4,677.00
		•		•	•
Al 4 C	Name				
BIDDER	Company Signature				Page 4 of 6

IS CURRENTLY REGISTER _2705082286A WA FEE AND ALL RENEWAL F MATERIALS, AND ALL TH	TIFIES THAT (CONTRACTOR NAME)_Ardent Company, LLC_ED WITH THE VIRGINIA STATE BOARD OF CONTRACTORS AS ISSUED ON THE29DAY OFFeb, 2020 EES REQUIRED UNDER LAW HAVE BEEN PAID. THE CONTINGS NECESSARY TO PERFORM THE WORK AS SET FORTH DO PERFORM RELATED WORK FOR THE FOLLOWING ITEMS ATION)	S AS REQU THE UNI RACTOR A IN ACCOR	DERSIGNED AGREES TO RDANCE WI	HE CODE OF VIRGINIA. CEI D FURTHER CERTIFIES THA FURNISH ALL NECESSARY L ITH THE PLANS AND SPECIF	T THE REGISTRATION ABOR, EQUIPMENT, FICATIONS. THE
21-DES-ITB-591	ATON).	CHE	CKED BY	<b>/</b> :	
MASTER ITEM #	DESCRIPTION	QTY	UNIT	UNIT PRICE	TOTAL
IVIASTER TIEIVI#	Tree/Stump Removal - Class A. Remove and	Q I I	ONT	OWITERIOL	IOIAL
	Dispose, Up to 6" DBH to 12" DBH (Diameter				
02800-C11-00500	at Breast Height)	2	1 EA	\$500.00	\$2,000.00
02800-C11-00602	Trees, Deciduous - 1.5 to 2.0" caliper		EA	\$300.00	
	Brick Pavers, Including Concrete Base			,	. ,
02800-C11-00100	(Arlington County Detail R-2.1)	8	3 SY	\$200.00	\$1,600.00
		İ		SUBTOTAL	\$18,777.00
C12	BUS STOP SHELTER AND FURNISHINGS				
MASTER ITEM #	DESCRIPTION	QTY	UNIT	UNITPRICE	TOTAL
				SUBTOTAL	\$0.00
C13	EROSION AND SEDIMENT CONTROL WORK	T	T		
MASTER ITEM #	DESCRIPTION	QTY	UNIT	UNITPRICE	TOTAL
				SUBTOTAL	\$0.00
C15	UNLISTED WORK				
MASTER ITEM #	DESCRIPTION	QTY	UNIT	UNITPRICE	TOTAL
				SUBTOTAL	\$0.00
C16	MOT AND RE-MOBILIZATION WORK				
MASTER ITEM #	DESCRIPTION	QTY	UNIT	UNITPRICE	TOTAL
				SUBTOTAL	\$0.00
C17	STORMWATER WORK				
MASTER ITEM #	DESCRIPTION	QTY	UNIT	UNITPRICE	TOTAL
				SUBTOTAL	\$0.00
C18	NON COUNTY UTILITIES				
MASTER ITEM #	DESCRIPTION	QTY	UNIT	UNITPRICE	TOTAL
				SUBTOTAL	\$0.00
	CONTRACT TOTAL (	EXCLU	DING PE	RCENTAGE ITEMS)	\$1,395,880.00
PCT	PERCENTAGE LINE ITEMS				
MASTER ITEM #	DESCRIPTION	QTY	UNIT	UNITPRICE	TOTAL
01500-C13-10000	Temporary Erosion and Sediment Controls		L LS	20000.00	\$20,000.00

Ardent Company
BIDDER\_\_\_\_\_ Signature\_\_\_\_ Page 5 of 6

	PREPARED BY:
THE UNDERSIGNED CERTIFIES THAT (CONTRACTOR NAME)_Ardent Con	mpany, LLC
IS CURRENTLY REGISTERED WITH THE VIRGINIA STATE BOARD OF CO	ONTRACTORS AS REQUIRED BY THE CODE OF VIRGINIA. CERTIFICATE NUMBER
_2705082286A WAS ISSUED ON THE29DAY OFFeb	, 2020 THE UNDERSIGNED FURTHER CERTIFIES THAT THE REGISTRATION
FEE AND ALL RENEWAL FEES REQUIRED UNDER LAW HAVE BEEN PAID.	. THE CONTRACTOR AGREES TO FURNISH ALL NECESSARY LABOR, EQUIPMENT,
MATERIALS, AND ALL THINGS NECESSARY TO PERFORM THE WORK AS	S SET FORTH IN ACCORDANCE WITH THE PLANS AND SPECIFICATIONS. THE
CONTRACTOR AGREES TO PERFORM RELATED WORK FOR THE FOLLOW	WING ITEMS AT THE FOLLOWING STIPULATED PRICES: (ALL PRICES INCLUDE
PROVISION AND INSTALLATION).	
21-DES-ITB-591	CHECKED BY:

MASTER ITEM #	DESCRIPTION	QTY	UNIT	UNIT PRICE	TOTAL
01000-C16-00010	Maintenance of Traffic (MOT)	1	LS	699000.00	\$699,000.00
01000-C16-00030	Mobilization and De-Mobilization	1	LS	110000.00	\$110,000.00
01500-SA-00200	SWPPP Administration	1	LS	2820.00	\$2,820.00
	PE	RCENTA	GE LINE	ITEMS SUBTOTAL	\$831,820.00

PROJECT TOTAL: \$2,227,700.00

Ardent Company

Signature\_\_\_\_\_

Page 6 of 6



ENGINEER
DEPARTMENT OF
ENVIRONMENTAL SERVICES

CONSTRUCTION DRAWINGS FOR:

FACILITIES & ENGINEERING DIVISION ENGINEERING BUREAU 2100 CLARENDON BOULEVARD, SUITE 813, ARLINGTON, VA 22201 PHONE: 703.228.3629 FAX: 703.228.3606 WWW.ARLINGTONVA.US

18TH STREET SOUTH - ROADWAY IMPROVEMENTS PROJECT

OWNER
DEPARTMENT OF
ENVIRONMENTAL SERVICES

DIVISION OF TRANSPORTATION & DEVELOPMENT TRANSPORTATION PLANNING 2100 CLARENDON BOULEVARD, SUITE 900, ARLINGTON, VA 22201 PHONE: 703.228.3344 FAX: 703.228.7974 WWW.ARLINGTONVA.US

C044.7

C044.8

C044.9

C044.10

C044.11

C045.1

C045.2

C045.3

C045.4

**CROSS-SECTIONS** 

CROSS-SECTIONS

CROSS-SECTIONS

CROSS-SECTIONS

**CROSS-SECTIONS** 

GEOMETRIC PLAN


GEOMETRIC PLAN

GEOMETRIC PLAN

UTILITY GEOMETRIC PLAN

CONTRACTOR TO BE DETERMINED

# LOCATION MAP

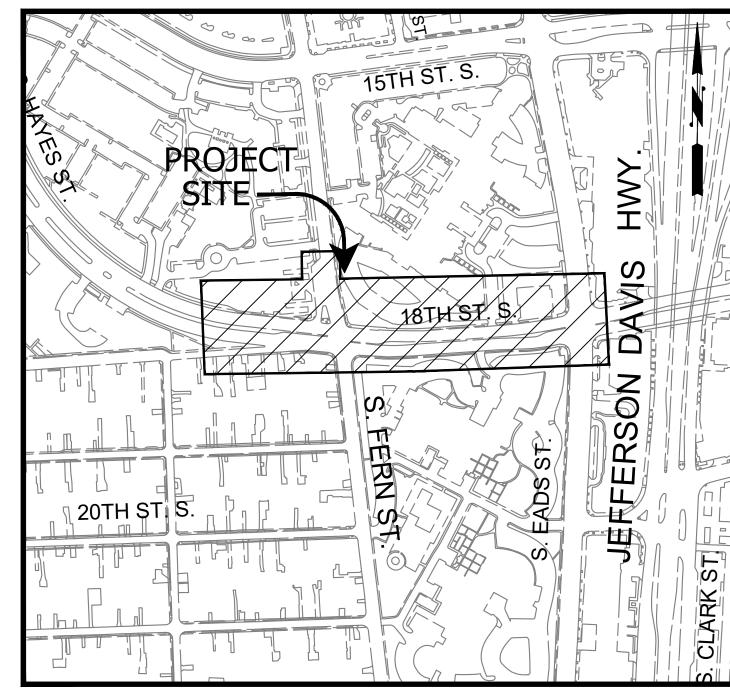

GRAPHIC SCALE

# QUALITY CONTROL ENGINEER 6.2 Kamal N. Taktak CONSTRUCTION MANAGEMENT SUPER 06.2 WATER, SEWER, STREETS BUREAU CH

**APPROVALS** 

TRANSPORTATION DIRECTOR

Aciel Yang

PROJECT MANAGER

6/17/202

ARLINGTON

DEPARTMENT OF ENVIRONMENTAL SERVICES

REVISIONS

KEN1210112 DA

# **GENERAL NOTES:**

FROM S. FERN STREET TO S. EADS STREET

#### **GENERAL CONSTRUCTION NOTES**

PROJECT CODE: CC20

- 1. ALL CONSTRUCTION WORK FOR THIS PROJECT SHALL CONFORM TO THE ARLINGTON COUNTY DEPARTMENT OF ENVIRONMENTAL SERVICES, CONSTRUCTION STANDARDS AND SPECIFICATIONS, AND WHERE APPLICABLE THE VIRGINIA DEPARTMENT OF TRANSPORTATION (VDOT) ROAD AND BRIDGE SPECIFICATIONS, AND ROAD AND BRIDGE STANDARDS. THE LATEST EDITIONS OF EACH RELEVANT MANUAL SHALL BE USED.
- 2. ALL CONSTRUCTION AND WORK ACTIVITIES SHALL COMPLY WITH THE VIRGINIA WORK AREA PROTECTION MANUAL AND ALL OTHER RELEVANT WORK SAFETY REQUIREMENTS, LATEST EDITIONS.
- 3. THE CONTRACTOR SHALL IMMEDIATELY NOTIFY THE PROJECT OFFICER OF ANY DISCREPANCIES

BETWEEN ACTUAL FIELD CONDITIONS AND THE APPROVED PLANS.

- 4. THE CONTRACTOR SHALL CONTACT "MISS UTILITY" AT 811 FOR MARKING THE LOCATIONS OF EXISTING UNDERGROUND UTILITIES (i.e. WATER, SEWER, GAS, TELEPHONE, ELECTRIC, AND CABLE TV) AT LEAST 72 HOURS PRIOR TO ANY EXCAVATION OR CONSTRUCTION. THE CONTRACTOR IS REQUIRED TO IDENTIFY AND PROTECT ALL OTHER UTILITY LINES FOUND IN THE WORK SITE AREA BELONGING TO OTHER OWNERS THAT ARE NOT MEMBERS OF "MISS UTILITY". PRIVATE WATER, SEWER AND GAS LATERALS WILL NOT BE MARKED BY MISS UTILITY OR THE COUNTY. THE CONTRACTOR SHALL LOCATE AND PROTECT THESE SERVICES DURING CONSTRUCTION.
- 5. THE CONTRACTOR SHALL BE RESPONSIBLE FOR LAYING OUT THE WORK AND SHALL RETAIN A PROFESSIONAL LAND SURVEYOR LICENSED IN THE COMMONWEALTH OF VIRGINIA TO PROVIDE ALL NECESSARY CONSTRUCTION LAYOUTS AND ESTABLISH ALL CONTROL LINES, GRADES, AND ELEVATION DURING CONSTRUCTION. THE CONTRACTOR SHALL SUBMIT A COPY OF ALL CUT SHEETS FOR REVIEW, PER THE SPECIFICATIONS. THE COST OF ALL NECESSARY SURVEYING SERVICES SHALL BE CONSIDERED INCIDENTAL TO THE WORK AND, UNLESS OTHERWISE SPECIFIED, THE COST SHALL BE INCORPORATED INTO THE COSTS FOR RELEVANT ITEMS.
- 6. THE LOCATION OF ALL EXISTING UTILITIES SHOWN ON THESE PLANS ARE FROM BEST AVAILABLE RECORDS AND SHALL BE CONSIDERED TO BE APPROXIMATE. WHEN CONSTRUCTION ACTIVITY REACHES IN PROXIMITY TO EXISTING UTILITIES, THE TRENCH(ES) SHALL BE OPENED A SUFFICIENT DISTANCE AHEAD OF THE WORK OR TEST PITS SHALL BE MADE TO VERIFY THE EXACT LOCATION AND INVERTS OF THE UTILITY TO ALLOW FOR POSSIBLE CHANGES IN THE LINE OR GRADE AS DIRECTED BY OFFICER. THE CONTRACTOR SHALL BE RESPONSIBLE FOR ANY DAMAGE TO THE EXISTING UTILITIES AND THE RELATED STRUCTURES. ALL EXISTING UTILITY SYSTEMS SHALL BE PROTECTED TO PREVENT DAMAGE DURING THE CONTRACTOR'S OPERATIONS. ANY SYSTEM DAMAGED SHALL BE PROMPTLY REPAIRED AT NO COST TO THE OWNER.
- 7. EXISTING MANHOLE FRAMES, COVERS, VALVE BOXES, AND OTHER APPURTENANCES SHALL BE ADJUSTED TO THE FINAL GRADE OR REPLACED, AS NECESSARY. UNLESS OTHERWISE SPECIFIED, THE COST FOR THIS SHALL BE CONSIDERED INCIDENTAL TO THE WORK, AND SHALL BE INCORPORATED INTO THE COSTS FOR RELEVANT ITEMS.
- TIMES AND SHALL ENSURE THE SAFETY OF ALL THOSE PASSING THROUGH OR ADJACENT TO THE SITE.

  9. ALL SIDEWALK AND CURB AND GUTTER DEMOLITION SHALL BEGIN AND END AT THE CONSTRUCTION

  10. THE SECOND FOR THE PERSON OF TH

8. THE CONTRACTOR SHALL PROVIDE ADA COMPLIANT ACCESS THROUGH OR AROUND THE SITE AT ALL

JOINT NEAREST TO THE DEPICTED DEMOLITION EXTENTS WITH A NEAT SAWCUT LINE TO FULL DEPTH OF PAVEMENT SECTION.

#### STORMWATER AND ENVIRONMENTAL PROTECTION

10. THE CONTRACTOR SHALL CONFINE <u>ALL</u> ACTIVITIES AT THE SITE ASSOCIATED WITH CONSTRUCTION ACTIVITIES, TO INCLUDE STORAGE OF EQUIPMENT AND OR MATERIALS, ACCESS TO THE WORK, FORMWORK, ETC. TO WITHIN THE DESIGNATED LIMITS OF DISTURBANCE (LOD).

#### TREE PROTECTION

11. TREES SHALL BE PROTECTED PER THE REQUIREMENTS OF ARLINGTON PARKS & RECREATION STANDARD.

#### TRAFFIC CONTROL

12. CONTRACTOR SHALL NOTIFY THE PROJECT OFFICER AT LEAST 3 WORKING DAYS PRIOR TO DISTURBING ANY EXISTING, OR INSTALLING ANY NEW, TRAFFIC SIGNS, SIGNALS, OR OTHER TRAFFIC CONTROL DEVICES.

- 13. THE CONTRACTOR SHALL PREMARK THE LAYOUT OF ANY PERMANENT TRAFFIC CONTROL STRIPING, INDICATING THE PROPOSED LOCATION AND TYPE OF MARKING TO BE INSTALLED. THE PREMARKING MAY CONSIST OF TYPE D TAPE, CHALK, OR LUMBER CRAYONS. THE CONTRACTOR SHALL ALLOW 3 WORKING DAYS FOR THE INSPECTION AND APPROVAL OF THE PREMARKINGS PRIOR TO PLACING THE PERMANENT MARKINGS.
- 14. THE CONTRACTOR SHALL SUBMIT ANY REQUESTS FOR TEMPORARY "NO PARKING" RESTRICTIONS TO THE PROJECT OFFICER AT LEAST 3 WORKING DAYS PRIOR TO THE DESIRED ONSET OF RESTRICTIONS. PRIOR TO A REQUEST FOR THE REMOVAL OF ACCESS TO ANY ADA PARKING SPACE THE CONTRACTOR MUST HAVE MADE PROVISION FOR ALTERNATIVE ADA PARKING AS INDICATED ON THE APPROVED PLAN OR AS DIRECTED BY THE PROJECT OFFICER.
- 15. WHEN THE APPROVED PLAN CALLS FOR THE REMOVAL OF ANY PARKING METER THE CONTRACTOR MUST MAKE A REQUEST TO THE PROJECT OFFICER AT LEAST ONE WEEK IN ADVANCE OF THE DESIRED REMOVAL. THE PROJECT OFFICER WILL THEN COORDINATE THE PARKING METER REMOVAL WITH TRAFFIC ENGINEERING AND OPERATIONS.
- 16. THE CONTRACTOR SHALL PRESERVE ALL BUS STOPS, INCLUDING MAINTAINING ADEQUATE ACCESSIBILITY THROUGH AND ADJACENT TO THE CONSTRUCTION FOR BUSES AND THEIR PASSENGERS. THE CONTRACTOR SHALL NOT CLOSE, RELOCATE, OR OTHERWISE MODIFY A BUS STOP WITHOUT PRIOR REQUEST OF THE PROJECT OFFICER. ANY RELOCATION OR CLOSURE OF A BUS STOP SHALL REQUIRE AT LEAST FOUR WEEKS ADVANCE NOTICE FOR COORDINATION WITH THE COUNTY'S BUS STOP COORDINATOR 703-228-3049.
- 17. WHEN CONDITIONS WARRANT DUE TO TRAFFIC VOLUMES, PATTERNS, OR SPECIAL EVENTS, THE COUNTY MAY SUSPEND OR OTHERWISE DIRECT THE CONTRACTOR'S ACTIVITIES TO PROTECT THE PUBLIC AND OR THE COUNTY'S TRANSPORTATION NETWORK.

#### WATER DISTRIBUTION, STORM AND SANITARY SEWER SYSTEMS

- 18. UNLESS OTHERWISE DIRECTED, CONTRACTORS ARE EXPRESSLY PROHIBITED FROM OPERATING ANY WATER VALVES OR APPURTENANCES. CONTRACTORS SHALL SUBMIT ALL REQUESTS FOR VALVE OPERATIONS TO THE PROJECT OFFICER AT LEAST 1 WEEK IN ADVANCE OF THE REQUIRED OPERATION.
- 19. IN THE EVENT OF A WATER OR SEWER EMERGENCY, THE CONTRACTOR SHALL IMMEDIATELY NOTIFY THE COUNTY'S WATER CONTROL CENTER AT 703-228-6555 AND THE PROJECT OFFICER.
- 20. THE CONTRACTOR SHALL COORDINATE ALL UTILITY SHUTOFFS, DISCONNECTS, AND/OR ABANDONMENT WITH UTILITY OWNER AND PROJECT OFFICER AT LEAST 1 WEEK IN ADVANCE OF THE REQUIRED INTERRUPTION.

#### FIRE DEPARTMENT NOTES:

- 21. ALL EXISTING FIRE HYDRANTS AND FIRE DEPARTMENT CONNECTIONS SHALL BE MAINTAINED UNOBSTRUCTED AND ACCESSIBLE AT ALL TIMES IN ACCORDANCE WITH SECTIONS 508.5.4 AND 508.5.5 OF THE ARLINGTON COUNTY FIRE PREVENTION CODE.
- 22. ACCESS TO BUILDINGS FOR FIREFIGHTING SHALL BE MAINTAINED AT ALL TIMES. EXISTING FIRE APPARATUS ACCESS ROADS (FIRE LANES) SHALL BE KEPT CLEAR OF OBSTRUCTIONS IN ACCORDANCE WITH SECTION 503.4 OF THE ARLINGTON COUNTY FIRE PREVENTION CODE. ACCESS TO CONSTRUCTION SITES SHALL BE PROVIDED AND MAINTAINED IN ACCORDANCE WITH SECTION 1410 OF THE ARLINGTON COUNTY FIRE PREVENTION CODE.
- 23. IN THE EVENT THAT EXISTING FIRE DEPARTMENT CONNECTIONS OR FIRE APPARATUS ACCESS ROADS (FIRE LANES) MUST BE OBSTRUCTED TO FACILITATE CONSTRUCTION ACTIVITIES, CONTACT THE ARLINGTON COUNTY FIRE DEPARTMENT FIRE PREVENTION OFFICE AT 703-228-4644 TO COORDINATE REVIEW AND APPROVAL OF TEMPORARY FIRE DEPARTMENT CONNECTIONS AND/OR FIRE APPARATUS ACCESS ROADS PRIOR TO CREATING THE OBSTRUCTION.

#### **WMATA NOTES:**

24. CONTRACTOR TO BE AWARE OF WMATA TPSS STRUCTURE LOCATED BETWEEN STATIONS 8+65 - 9+65 OF 18TH STREET S. CONSTRUCTION BASELINE. COORDINATION WITH WMATA PRIOR TO CONSTRUCTION IN THIS AREA WILL BE REQUIRED. TPSS STRUCTURE IS LOCATED APPROXIMATELY 5-6 FEET BELOW GROUND SURFACE

#### Sheet List Table STORM SEWER COMPUTATIONS **DETAILS** C002.1 SWM DRAINAGE AREA MAP TYPICAL SECTIONS **SWM COMPUTATIONS** C004.2 TYPICAL SECTIONS C091.1 LANDSCAPE PLAN C011.1 EXISTING CONDITION C091.2 LANDSCAPE PLAN C011.2 EXISTING CONDITION C092.1 LANDSCAPE NOTES AND DETAILS C011.3 EXISTING CONDITION C101.1 STRIPING AND SIGNAGE PLAN C021.1 **DEMOLITION PLAN** C101.2 STRIPING AND SIGNAGE PLAN C021.2 DEMOLITION PLAN C101.3 STRIPING AND SIGNAGE PLAN C031.1 E&S CONTROL PLAN C111.1 STREETLIGHT PLAN C031.2 **E&S CONTROL PLAN** STREETLIGHT PLAN C111.2 C032.1 E&S CONTROL NOTES MAINT. OF TRAFFIC PLAN NOTES C121.1 C032.2 **E&S CONTROL DETAILS** C121.2 MAINT. OF TRAFFIC - ZONE 1 C035.1 STORMWATER PPP C121.3 MAINT. OF TRAFFIC - ZONE 2 C035.2 STORMWATER PPP C121.4 MAINT. OF TRAFFIC - ZONE 3 C041.1 PLAN AND PROFILE C121.5 MAINT. OF TRAFFIC - ZONE 4 C041.2 PLAN AND PROFILE C121.6 MAINT. OF TRAFFIC - ZONE 5 C041.3 PLAN AND PROFILE C121.7 MAINT. OF TRAFFIC - ZONE 6 C042.1 RAMP DETAIL C121.8 MAINT. OF TRAFFIC - ZONE 7 C042.2 RAMP DETAIL MAINT. OF TRAFFIC - ZONE 8 C121.9 C042.3 RAMP DETAIL MAINT. OF TRAFFIC - ZONE 9 C121.10 C042.4 RAMP DETAIL MAINT. OF TRAFFIC - ZONE 10 C121.11 C042.5 RAMP DETAIL C121.12 MAINT. OF TRAFFIC - ZONE 11 C042.6 RAMP DETAIL C121.13 MAINT. OF TRAFFIC - ZONE 12 C042.7 RAMP DETAIL C121.14 MAINT. OF TRAFFIC - ZONE 13 C043.1 **CURB RETURN PROFILE** C121.15 MAINT. OF TRAFFIC - ZONE 14 C044.1 CROSS SECTION EXHIBIT MAINT. OF TRAFFIC - ZONE 15 C044.2 CROSS-SECTIONS MAINT. OF TRAFFIC - ZONE 16 C044.3 **CROSS-SECTIONS** MAINT. OF TRAFFIC - ZONE 17 C044.4 **CROSS-SECTIONS** MAINT. OF TRAFFIC - ZONE 18 C044.5 **CROSS-SECTIONS** MAINT. OF TRAFFIC - ZONE 19 C044.6 CROSS-SECTIONS

Traffic Sheet List Table

COMMUNICATION PLAN

**COVER SHEET** 

Sheet Title

TRAFFIC SIGNAL MODIFICATION PLAN

Sheet #

## 

SWM

STORMWATER MANAGEMENT #: SWM19-0213 LAND DISTURBANCE ACTIVITY #: LDA19235

## **AD**1

18TH STREET SOUTH - 8,300 VPD (VDOT 2019) SOUTH FERN STREET - 6,300 VPD (VDOT 2019) SOUTH EADS STREET - 10,000 VPD (VDOT 2019)

# STREET CLASSIFICATION

18TH STREET SOUTH - ARTERIAL TYPE B SOUTH FERN STREET - NEIGHBORHOOD PRINCIPAL SOUTH EADS STREET - MINOR ARTERIAL

# POSTED SPEED

30 MPH @ 18th STREET SOUTH 25 MPH @ FERN STREET SOUTH 18TH STREE

COVER SI

COMMAN IMPR

SON

DESIGNED: NS
DRAWN: NS
CHECKED: TL
MISS UTILITY TRANSMITTAL #: XXXX

FILENAME:
CC20-200-COVER.DWG
PATH: Q:\DATA\CC20\DESIGN\CAD\\_ACTIVE

PLOTTED: MARCH 1 2021

PLOTTED BY:NSHARP

SCALE: AS NOTED

\_ |

SHEET C000.1

COPYRIGHT © 2016 ARLINGTON COUNTY VIRGINIA - ALL RIGHTS RESERVED

18TH STREET SOUTH

LINETADE LECEND

CVMPOL LECEND

	LINETYF	PE LEGEND	<u>S</u>	YMBOL LEGE	<u>:ND</u>	
<u>FEATURE</u>	EXISTING	<u>PROPOSED</u>	EXISTING FEATURE	<u> </u>	PROPOSE FEATURE	
BUILDING						
CENTERLINE / BASELINE			EX CABLE PEDESTAL	C		
COMMUNICATIONS CABLE	COM	сом	EX ELECTRIC BOX	E		
CONTOURS MAJOR;MINOR?			EX FIRE HYDRANT		PROP FIRE HYDRANT	
CRITICAL ROOT ZONE	CRZ	CRZ	EX GAS VALVE		PROP GAS VALVE	©
EASEMENT			EX GROUND LIGHT	•		
ELECTRIC (UNDERGROUND)	UGE	UGE	EX GUY WIRES	<b>≻</b>		
FENCE (MATERIAL NOTED)	xxxx	xxxx	EX IRON PIPE OR PIN	•		
FIBER OPTIC	—— FO —— FO ——	—— FO ——	EX LIGHT POLE	<b>©</b>	PROP LIGHT POLE	
GAS LINE	——— GAS ————	—— GAS ——— GAS ———	EX MAILBOX			
X" GAS LINE (SIZE INCLUDED IF AVAILABLE)	——————————————————————————————————————	——————————————————————————————————————	EX MONUMENT			
GUARDRAIL	. 0 0 0 0 0.	· <del>o o o o o</del> ·	EX PARKING METER	$\odot$		
HARDSCAPE FEATURE (MATERIAL NOTED)			EX PAY STATION	PS	PROP PAY STATION	PS)
LIMITS OF DISTURBANCE	LOD	LOD	EX SANITARY MANHOLE	0	PROP SANITARY MANHOLE	©
LIMITS OF WORK	LOW	LOW	EX STORM BASIN	0	PROP STORM CATCH BASIN (TO SCALE)	0
OVERHEAD WIRES		ı    ı	EX STORM MANHOLE	0	PROP STORM MANHOLE	0
PAVEMENT MINI SKIP LINE			EX TELEPHONE PEDESTAL	T		
PAVEMENT SKIP LINE			EX TRAFFIC CONTROL BOX			
PROPERTY LINE			EX TRAFFIC SIGN	-	PROP TRAFFIC SIGN	•
RIGHT-OF-WAY LINE			EX TRASH CAN	*	PROP TRASH CAN	₩
ROOT PRUNING	—— RP ——— RP ———	—— RP ———	EX TRAVERSE	$\triangle$		
SANITARY SEWER	SAN SAN	——————————————————————————————————————	EX TREES, WOODED AREA	( II )	PROPOSED TREE REMOVAL	X
X" SANITARY SEWER (SIZE INCLUDED IF AVAILABLE)	——————————————————————————————————————	——————————————————————————————————————	EX UTILITY MANHOLE TYPE INDICATED ELECTRIC, TELE, ETC	<b>(</b>		
SILT FENCE	——————————————————————————————————————	———— SF —————	EX UTILITY POLE	ė.	PROP UTILITY POLE	•
STORM (SIZE NOTED)	STM		EX WATER MANHOLE	Θ	PROP WATER MANHOLE	<b>©</b>
STREAM			EX WATER METER		PROP WATER METER	•
STREET LIGHT CONDUIT	—— SL ———	SL	EX WATER VALVE	$\otimes$	PROP WATER VALVE	€
TELEPHONE (UNDERGROUND)	UGT	—— UGT ——	EX YARD INLET		PROP YARD INLET (TO SCALE)	
TREE LINE			EX BENCHMARK		CONSTRUCTION NOTES (LEADER TO AREA AFFECTED)	<u></u>
TREE PROTECTION FENCE	ТР	TP			CURVE NUMBER (SEE CURVE TABLE)	<b>C</b> #)
WALL					LINE NUMBER (SEE LINE TABLE)	(L#)
WATER	w	w			TEST HOLE	•
X" WATER (SIZE INCLUDED IF AVAILABLE)	X" W X" W	x" w x" w			NORTH ARROW	N

LABEL LEGEND

**EXISTING** 

EX SAN STRUC NO. EXISTING SANITARY STRUCTURE NUMBER

PROP SAN SEW STRUC NO.
PROPOSED SANITARY SEWER STRUCTURE NUMBER

XXXX

EX STRM SEW STRUC NO. EX STRM SEW STRUC NO.
EXISTING STORM SEWER STRUCTUE NUMBER

XXXX


PROP STRM SEW STRUC NO.
PROPOSED STORM SEWER STRUCTURE NUMBER

PROPOSED

 $\langle$  XXXX $\rangle$ 

#### HATCH LEGEND

PROP MILL & OVERLAY SEE TYPICAL SECTION FOR DETAILS

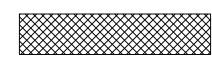


PROP FULL DEPTH ASPHALT SEE TYPICAL SECTION FOR DETAILS

PROP CONCRETE

REPLACE & MATCH EXISTING DRIVEWAY OR LEADWALK. SEE CONSTRUCTION NOTES


DEMOLITION AREA

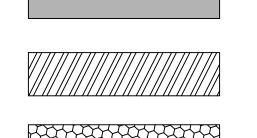

ARLINGTON VIRGINIA

DEPARTMENT OF ENVIRONMENTAL SERVICES FACILITIES & ENGINEERING DIVISION ENGINEERING BUREAU 2100 CLARENDON BOULEVARD, SUITE 813 ARLINGTON, VA 22201 PHONE: 703.228.3629 FAX: 703.228.3606

COPYRIGHT © 2016 ARLINGTON COUNTY VIRGINIA - ALL RIGHTS RESERVED

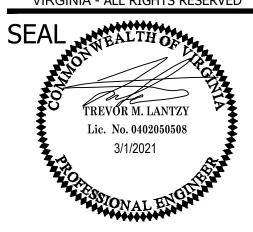

APPROVALS	DATE
Camel/	フ 6/18/2020
QUALITY CONTROL ENGINEER	6.26.20
Kamal N. Taktak	
CONSTRUCTION MANAGEMENT	SUPERVISOR
Glufa	06.29.20
WATER, SEWER, STREETS BURE	AU CHIEF
Dennis M. Leach	6/24/20
TRANSPORTATION DIRECTOR	
Aiel Yang	6/17/2020


PROJECT MANAGER

HLO	VEMENTS FADS ST
SOU	OVEM FAD

LEGEND
ROADWAY IMPROVEN
S FERN ST TO S EAD

DESIGNED:	NS
ORAWN:	NS
CHECKED:	TL
MISS UTILIT	Y TRANSMITTAL #: XXXX

FILENAME: CC20-202-LEGEND.DWG PATH: Q:\DATA\CC20\DESIGN\CAD\\_ACTIVE


STREET

18TH

PLOTTED: MARCH 1 2021 PLOTTED BY:NSHARP


SCALE:

SHEET C006.1

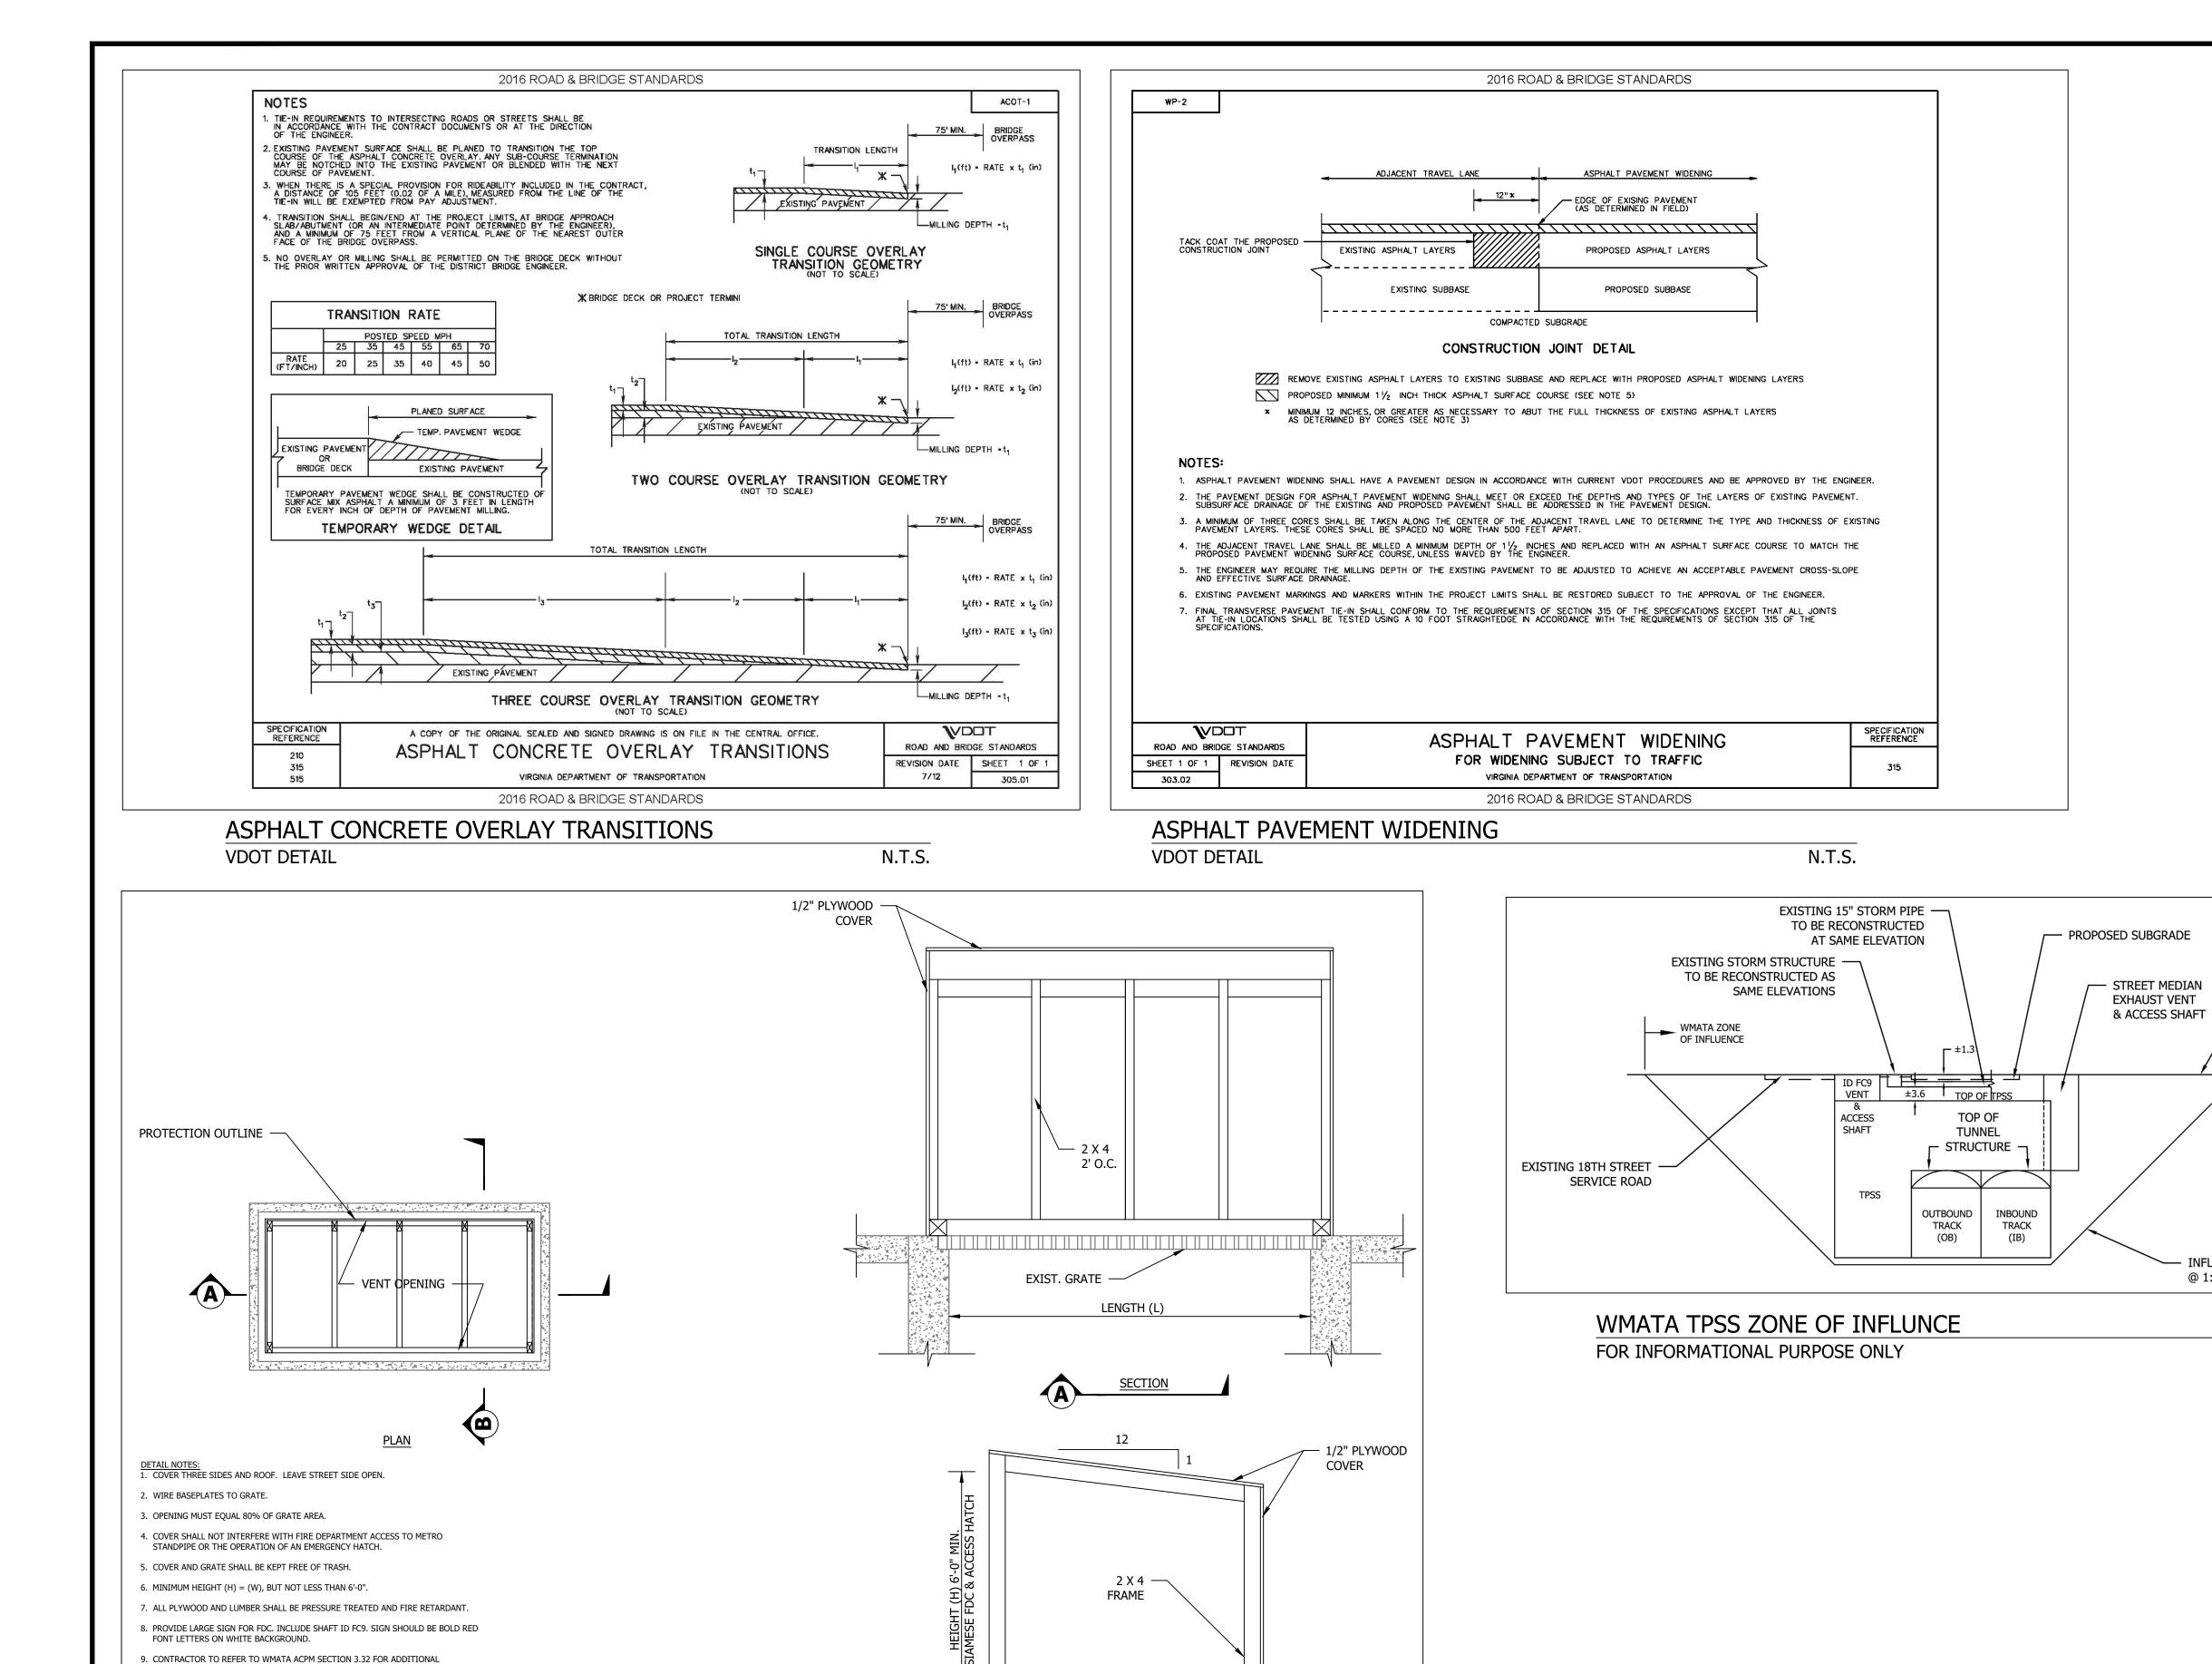

EXIST. GRATE

N.T.S.

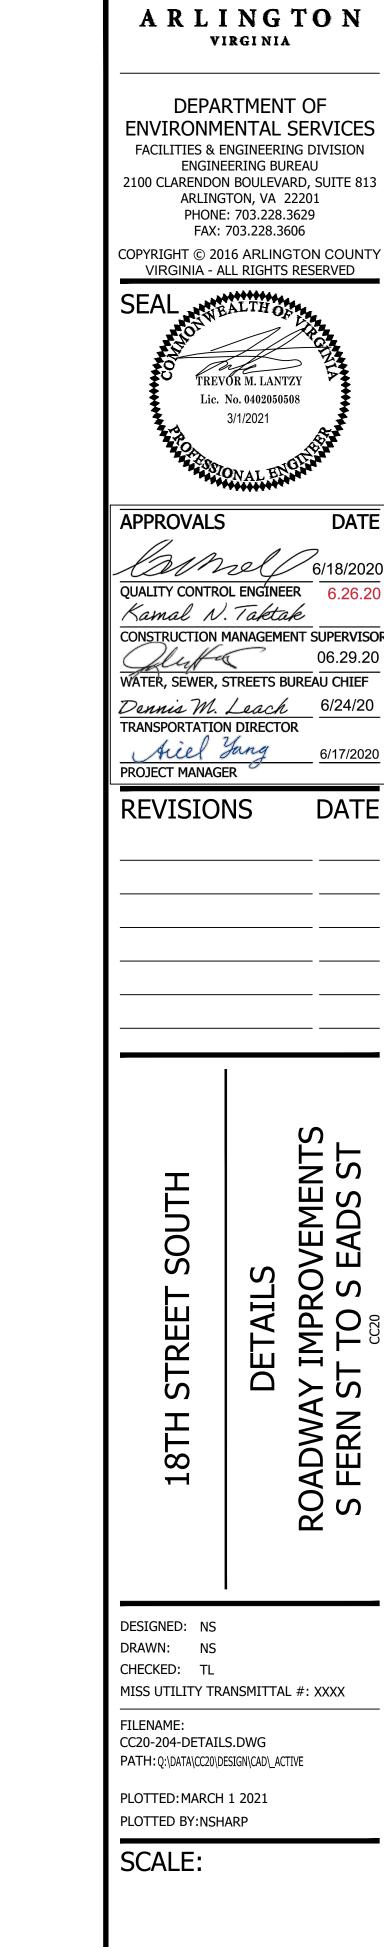

EXISTING AND

INFLUENCE LINE

N.T.S.

@ 1:1 SLOPE

PROPOSED GRADE

DATE

**AS SHOWN** 

SHEET C002.1

COPYRIGHT © 2016 ARLINGTON COUNTY VIRGINIA - ALL RIGHTS RESERVED

WMATA DETAIL

PLYWOOD OR OTHER SOLID MATERIAL AS VENTILATION NEEDS TO BE MAINTAINED.

ACCESS HATCH CAN NOT BE BLOCKED AT ANYTIME DURING CONSTRUCTION.

THE METAL GRATES IN THIS LOCATION ARE FAN FC9 WHICH PROVIDES VENTILATION TO WMATA TUNNEL IN THIS LOCATION. THIS IS A FIRE AND LIFE SAFETY SYSTEM WHICH REMOVES SMOKE OR SUPPLIES FRESH AIR RO RHE TUNNEL. THE OTHER GRATES ARE INTAKE AND EXHAUSTS FOR A TRACTION POWER SUBSTATION (TPSS) WHICH IS A HIGH VOLTAGE ROOM WHERE POWER (TRANSFORMER) IS SUPPLIED TO OPERATE THE

• THESE GRATES DURING CONSTRUCTION NEED TO BE PROTECTED FROM CONSTRUCTION, DEBRIS FROM ENTERING INTO THESE SHAFTS.

THE FAN SHAFT FC9 IS AN EMERGENCY EGRESS FROM THE TUNNEL SO THIS WILL NEED TO BE MAINTAINED, CAN NOT BE BLOCKED. THE DRY STANDPIPE AT FC9 WILL ALSO NEED TO MAINTAIN ACCESS IN CASE OF EMERGENCY AND IF THE FIRE DEPT NEEDS TO USE. THE CONSTRUCTION PROJECT NEEDS TO MAINTAIN THESE SHAFTS IN THE CURB AREA AND ENSURE WATER IS NOT DIRECTED INTO THESE SHAFTS OR THAT THESE SHAFTS BECOME LOW POINTS IN THE CURB AREA AND THUS RECEIVE WATER SURFACE RUN OFF. THIS WOULD CAUSE FLOODING ISSUES IN THE TUNNEL OR IN HIGH VOLTAGE ROOM RESULTING IN STOP OF RAIL SERVICE OR DAMAGE TO


DUST CONTROL MEASURES MUST BE PUT IN PLACE BECAUSE OF SUBSTATION EQUIPMENT BELOW. THE SHAFTS CANNOT BE COVERED BY


WMATA GRATE COVER PROTECTION


REQUIREMENTS.


WMATA ADDITIONAL NOTES:


EXPENSIVE/CRITICAL EQUIPMENT.

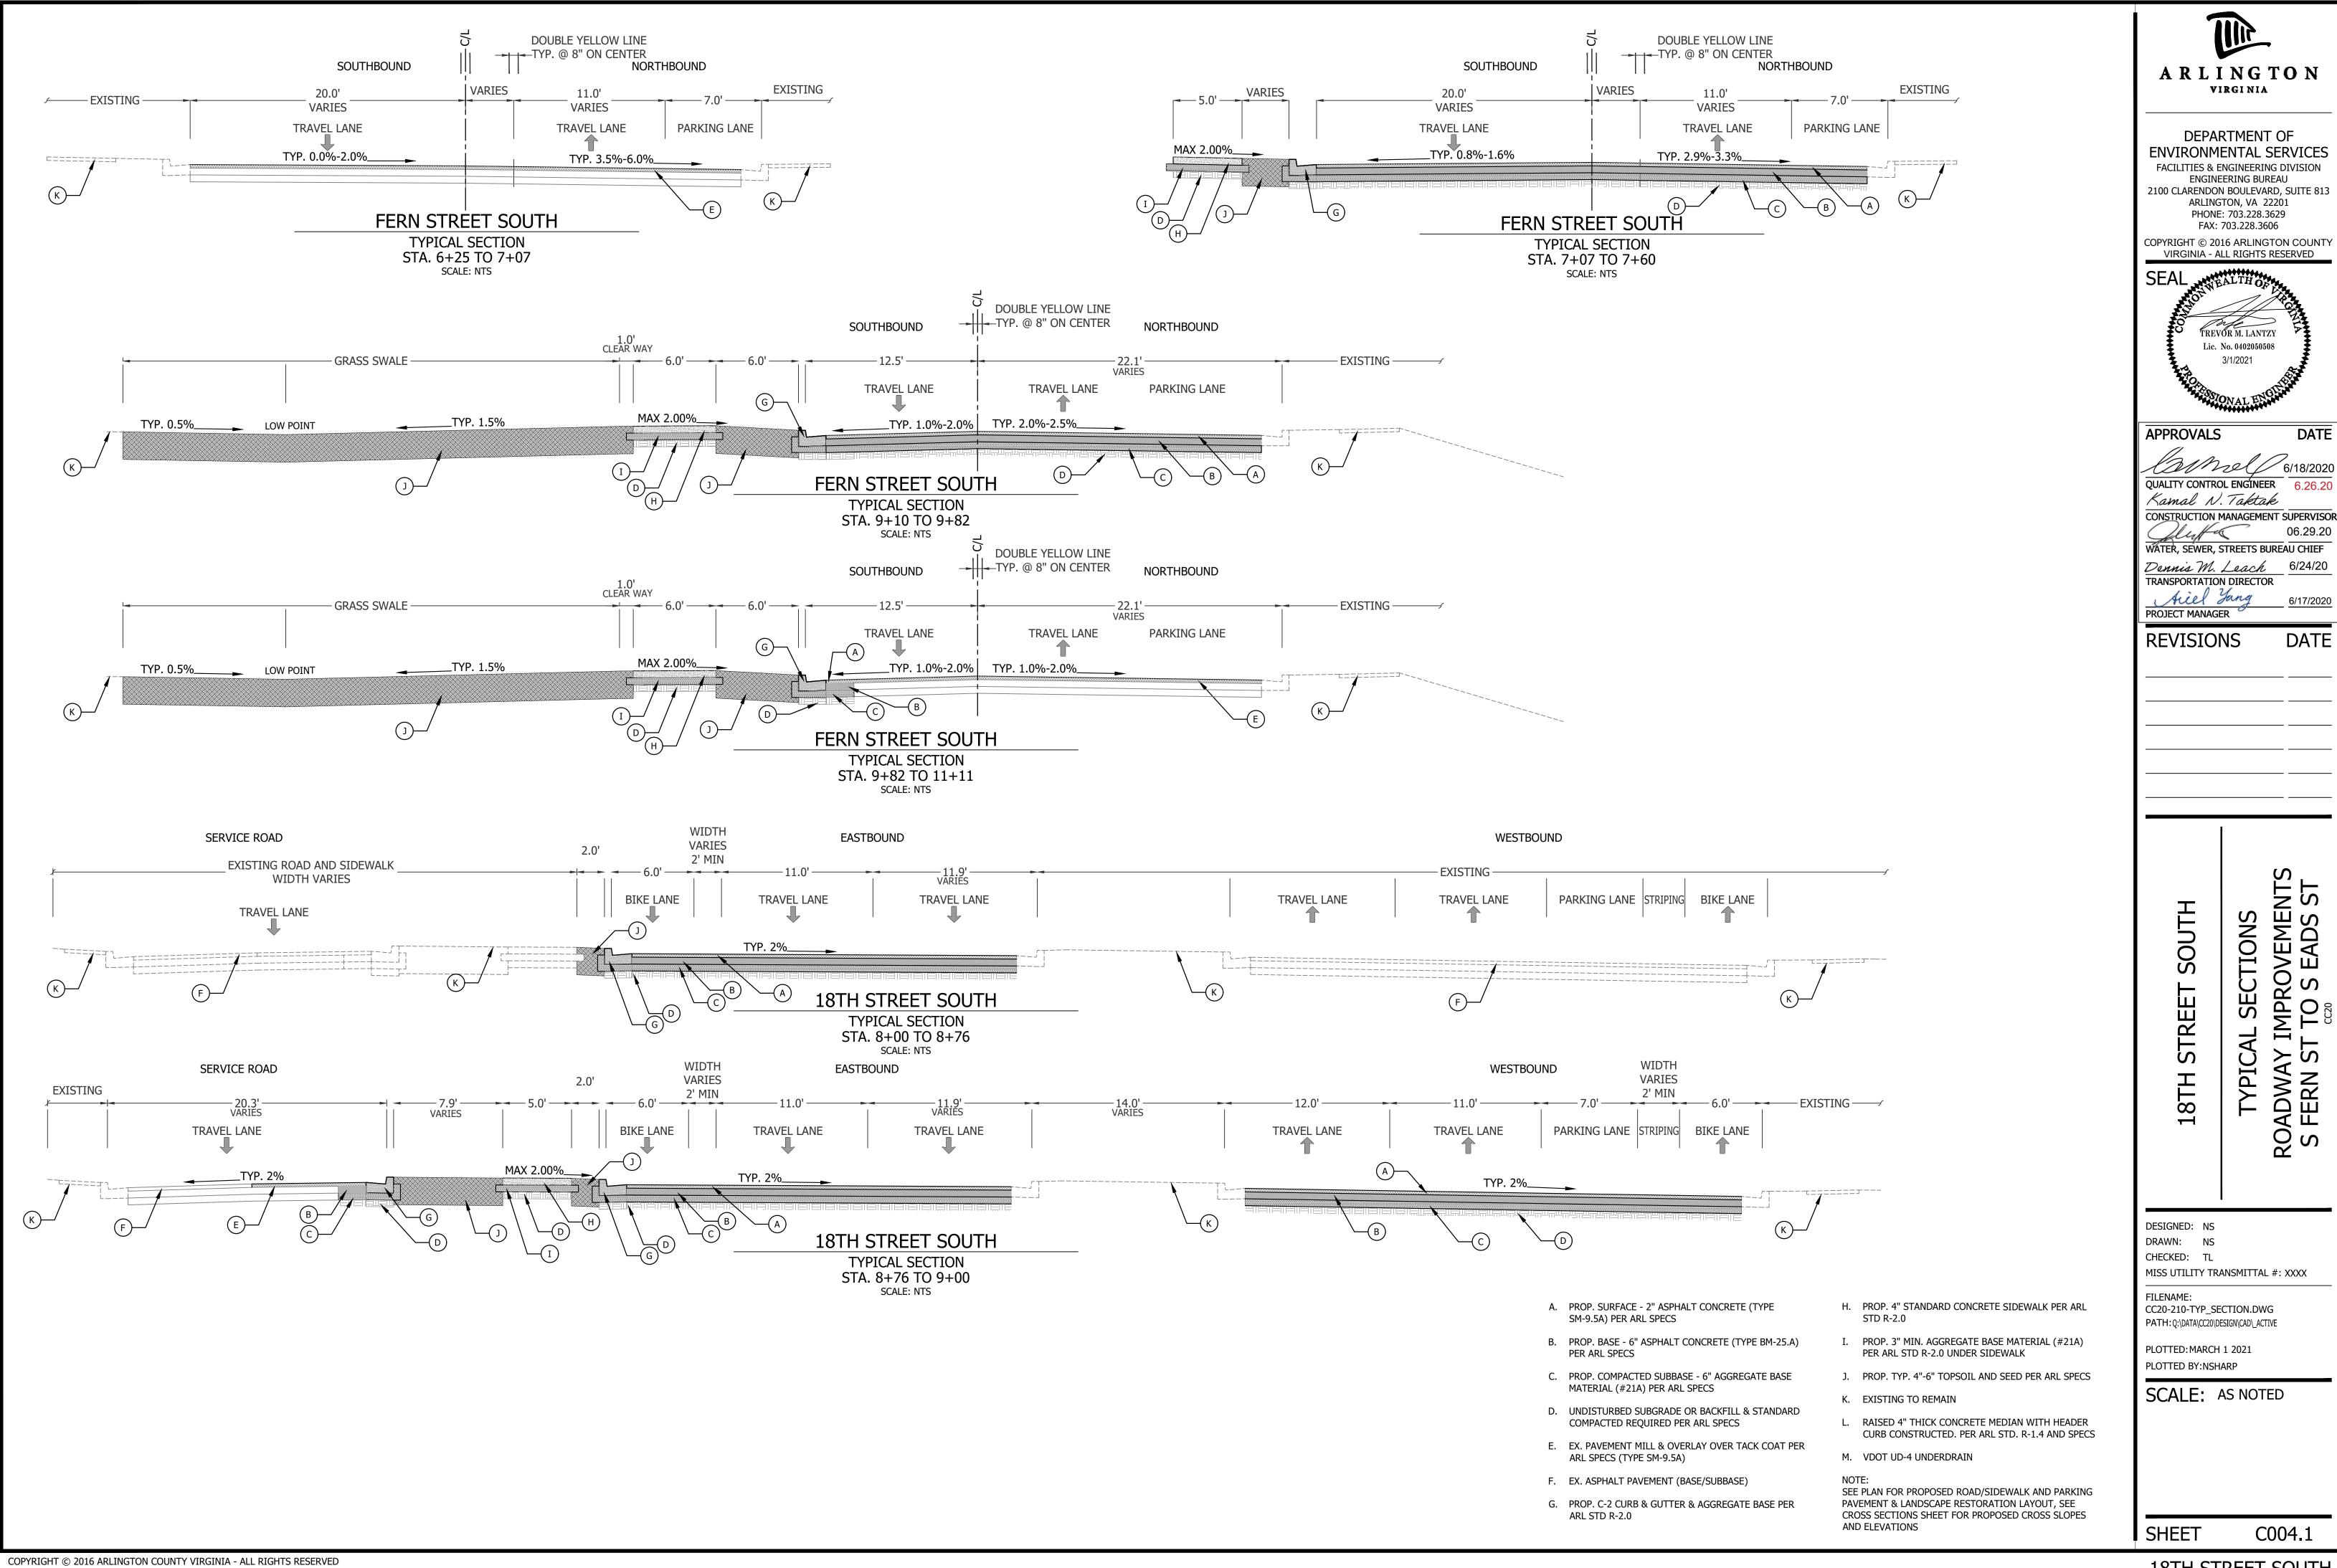


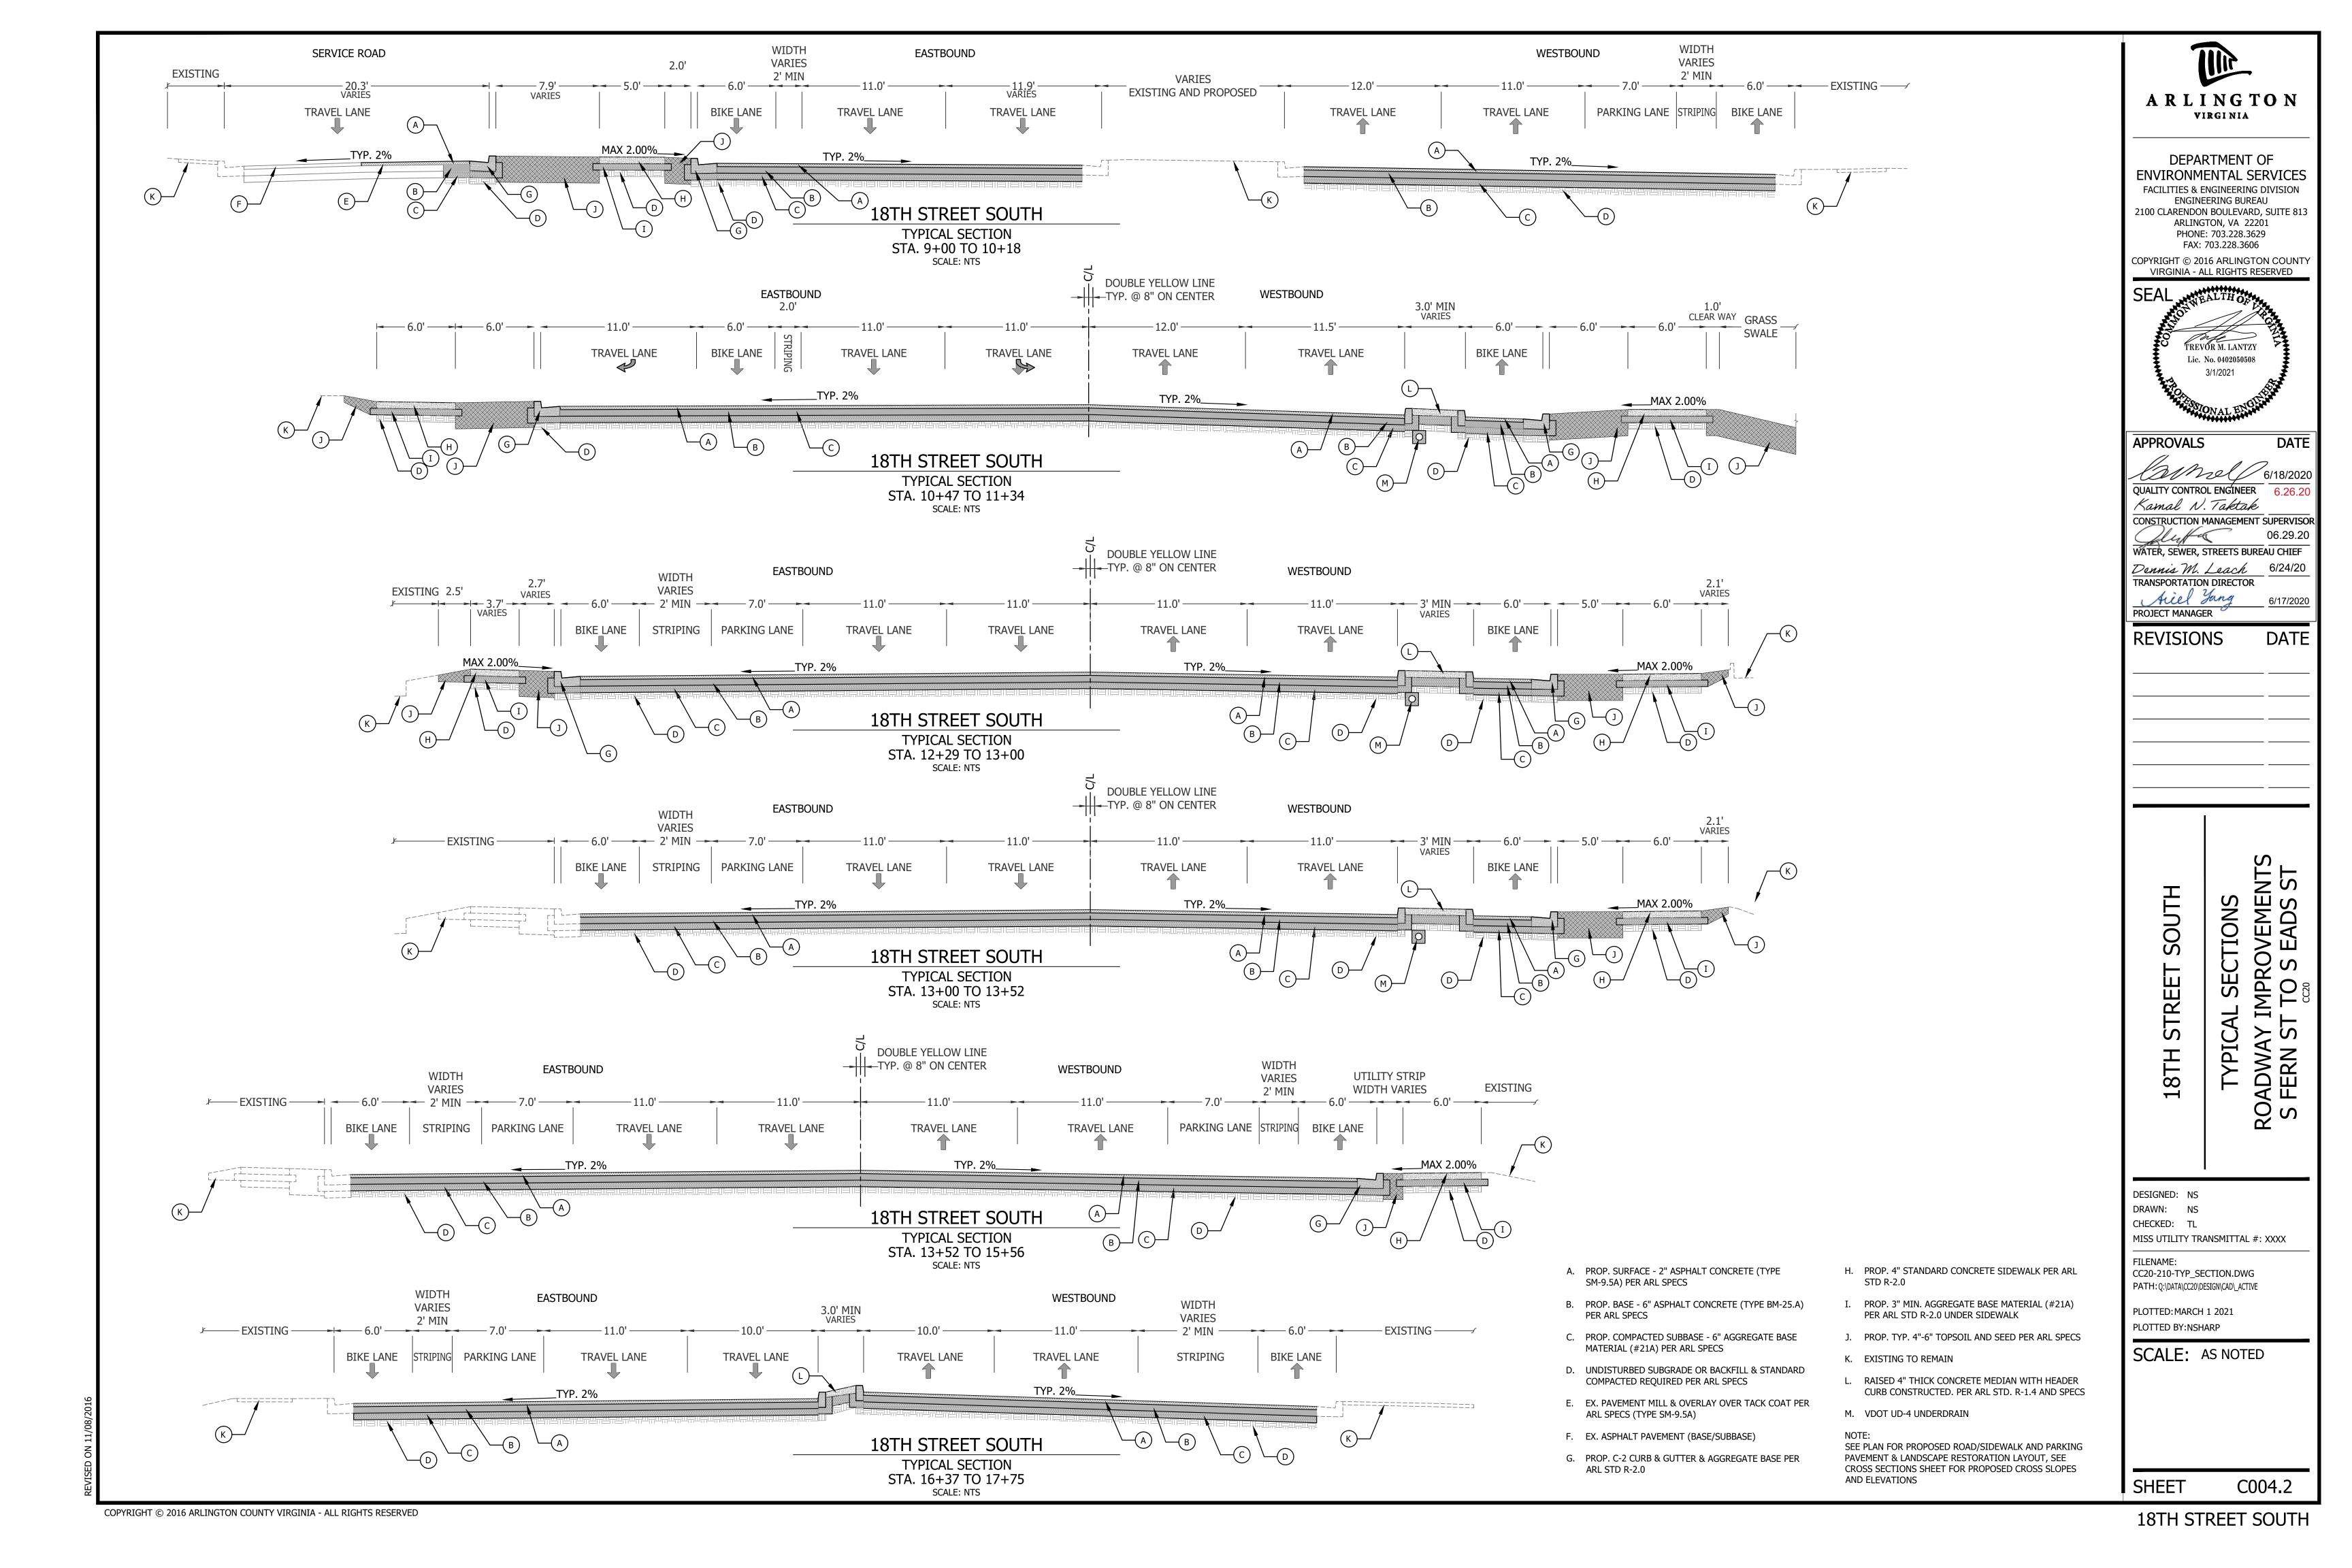


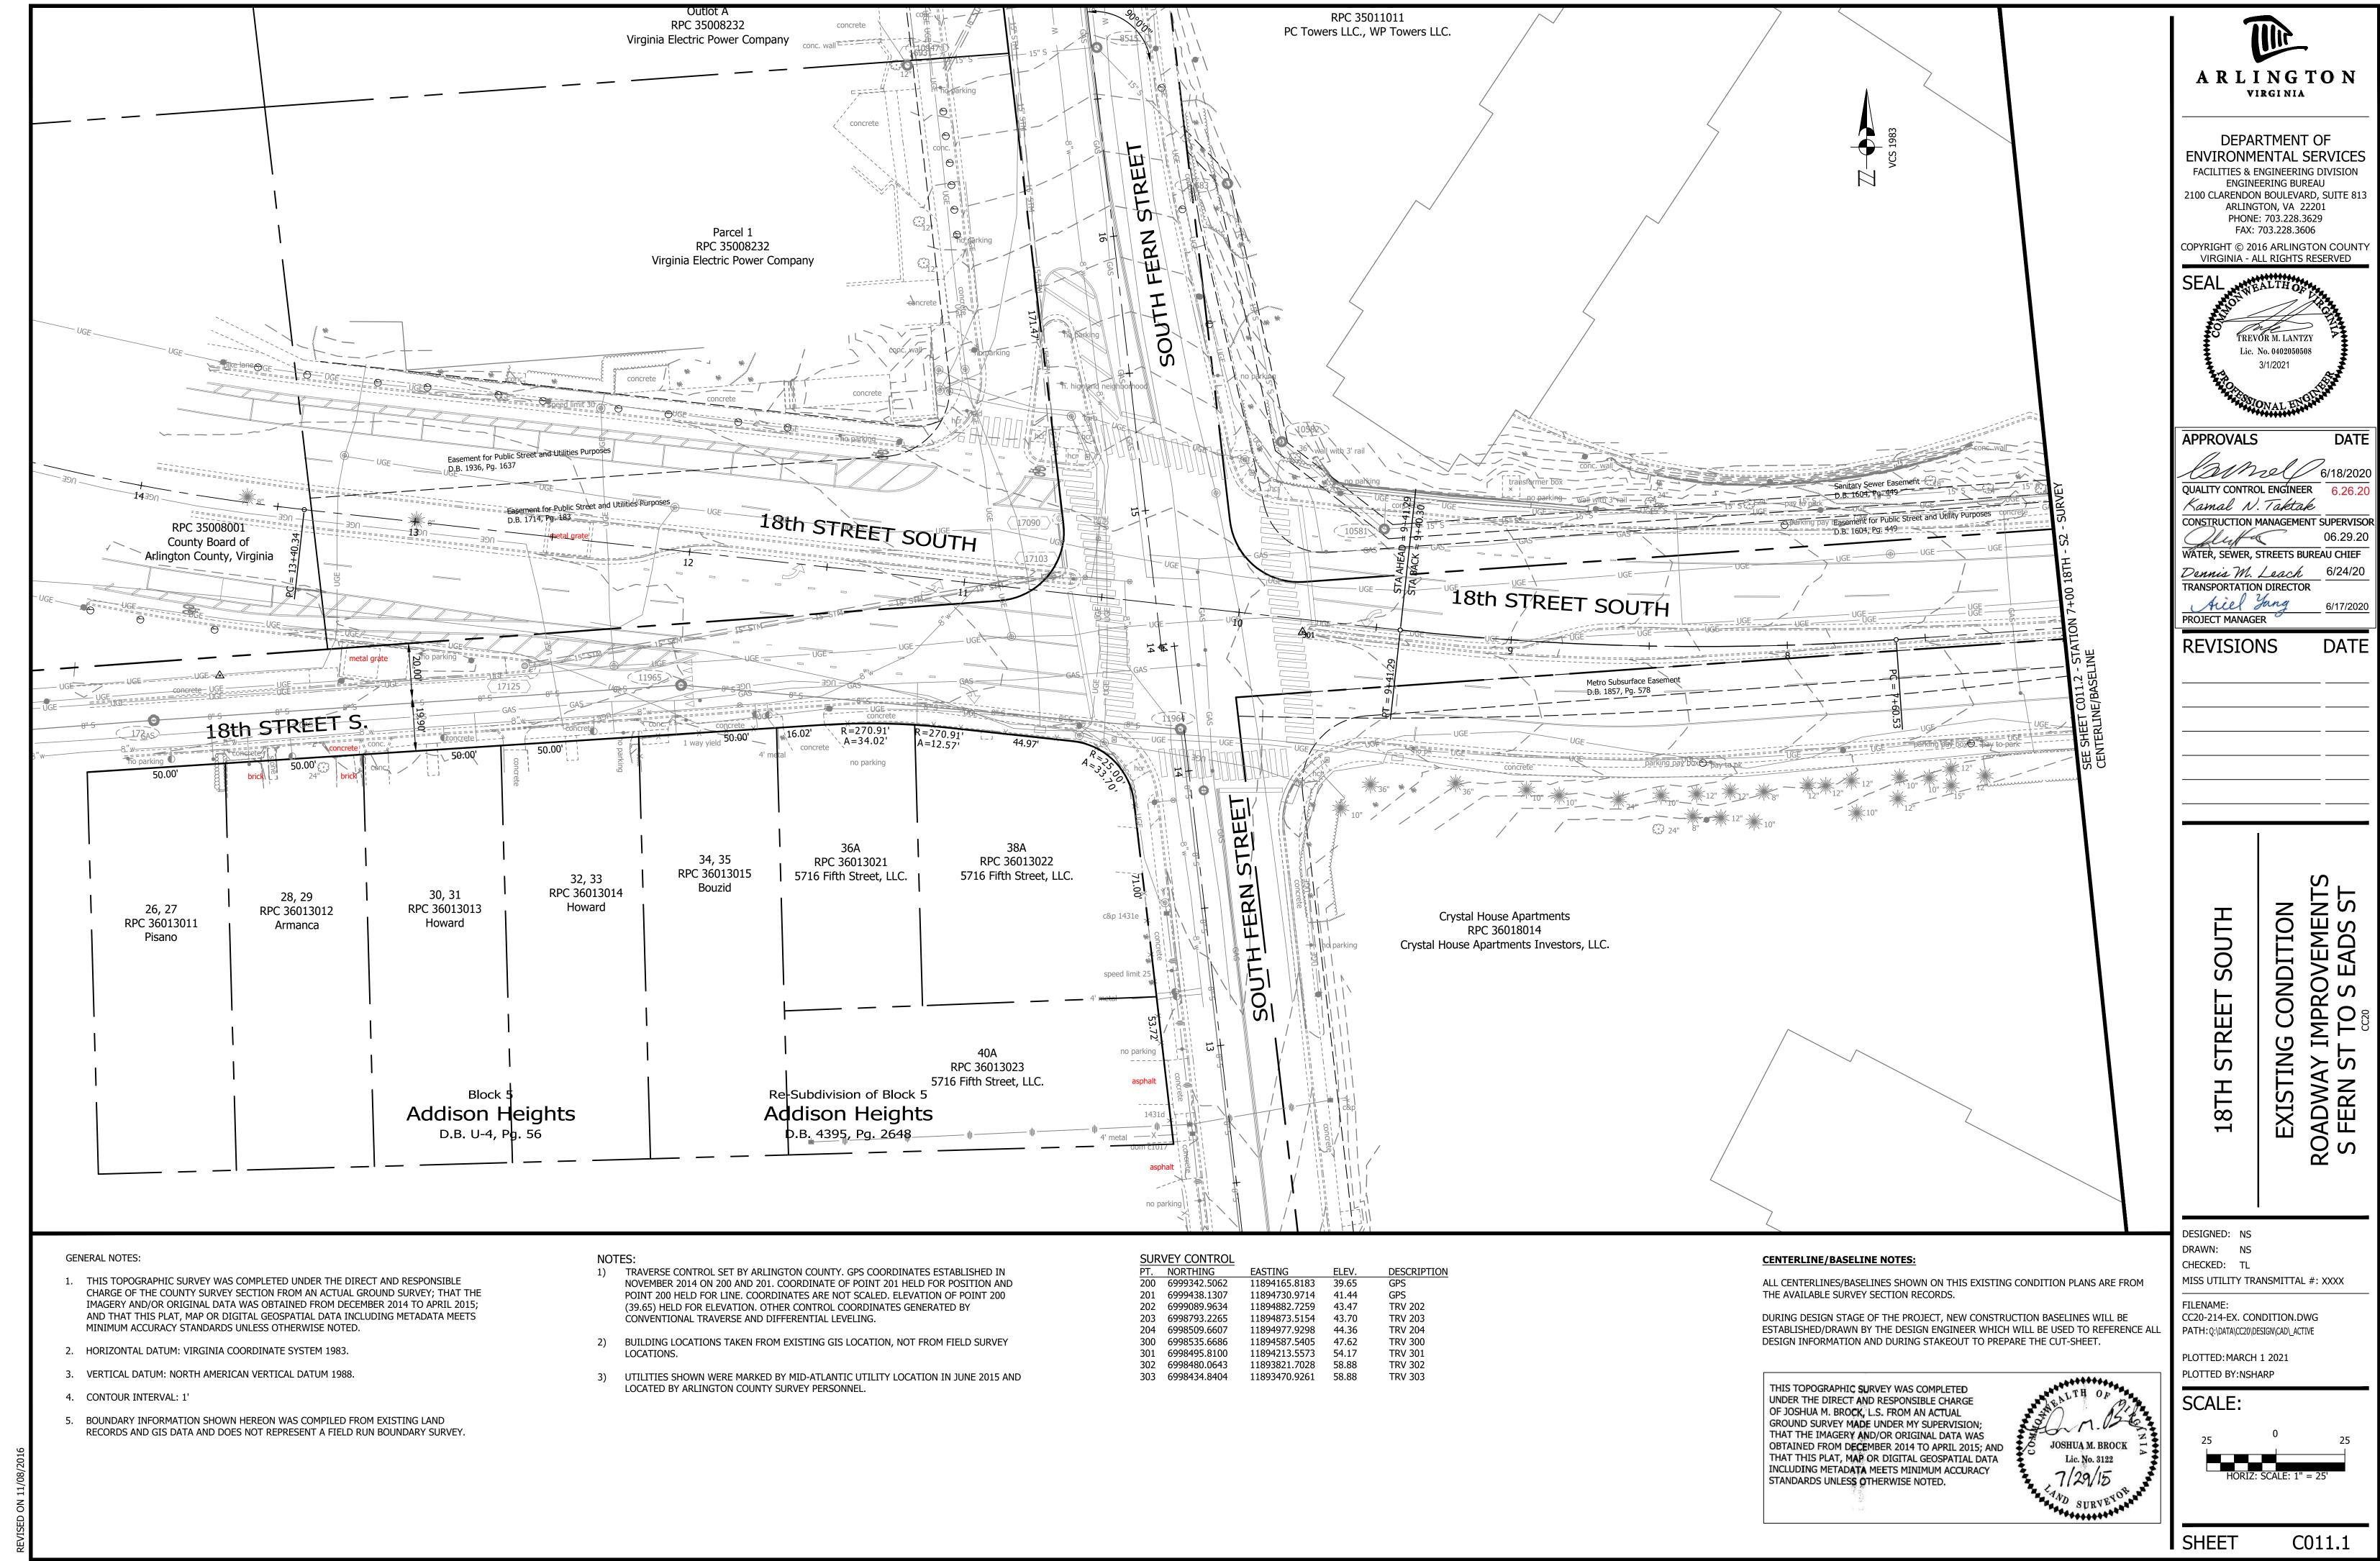


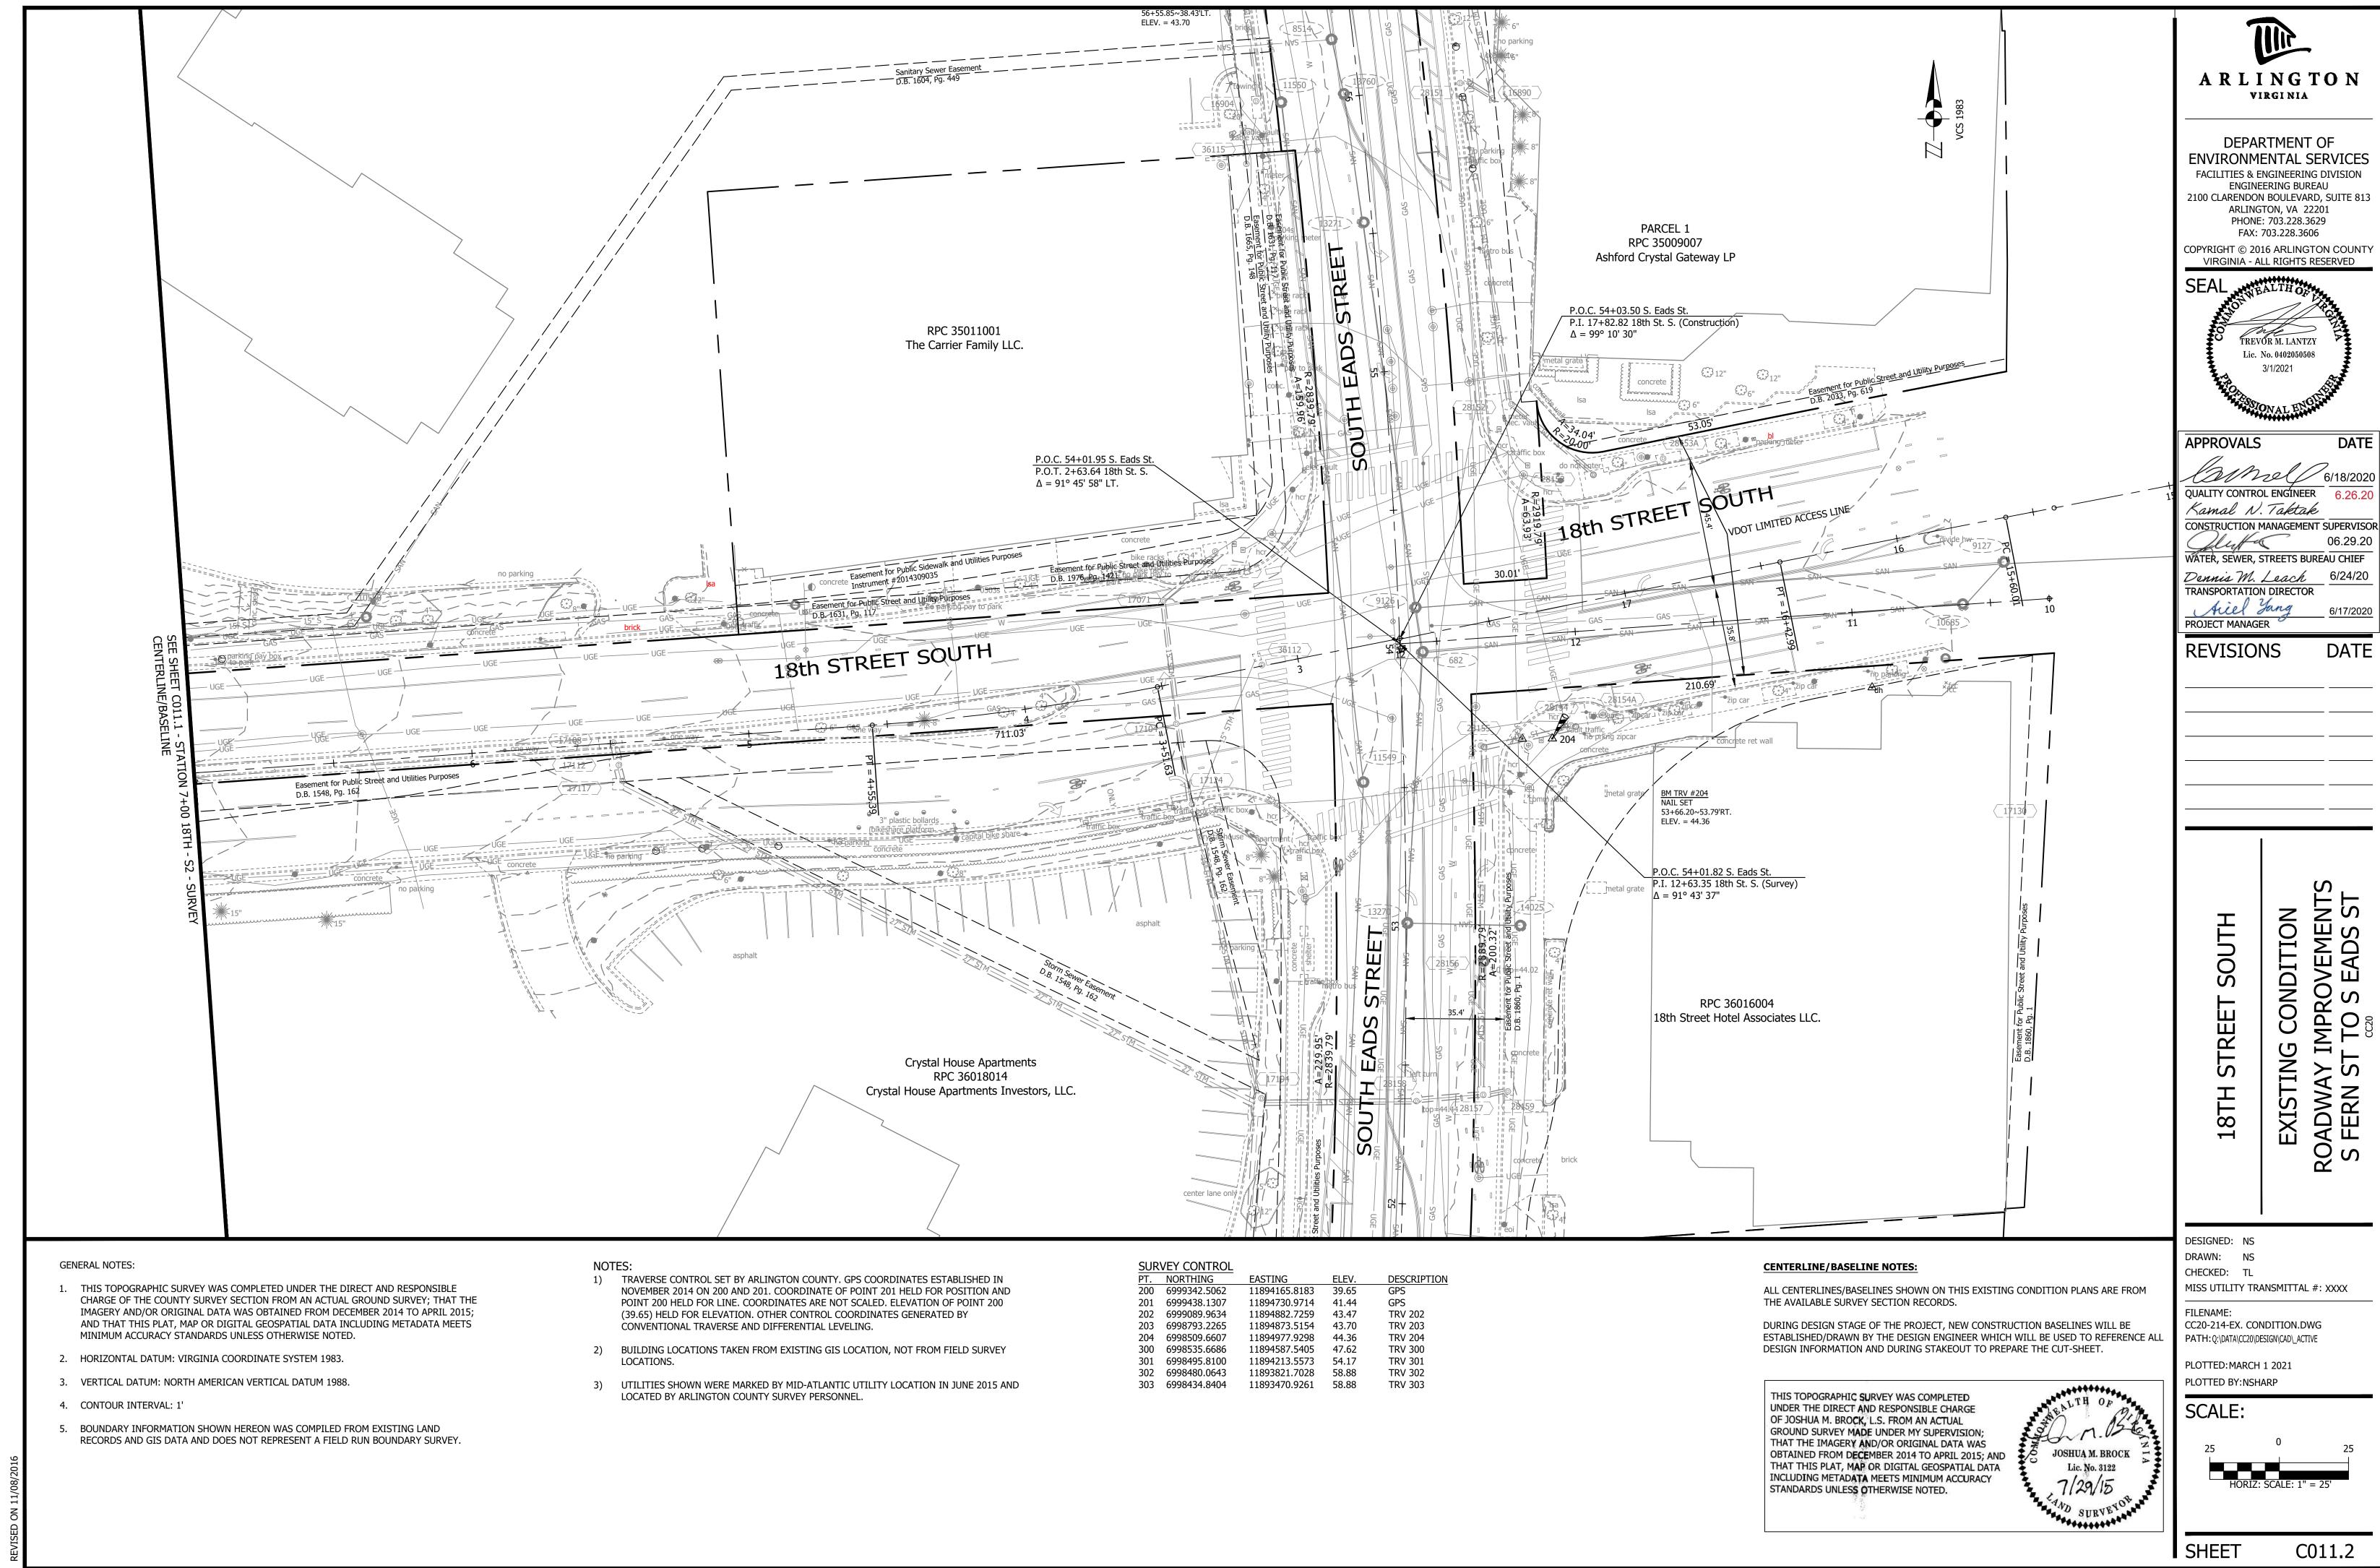


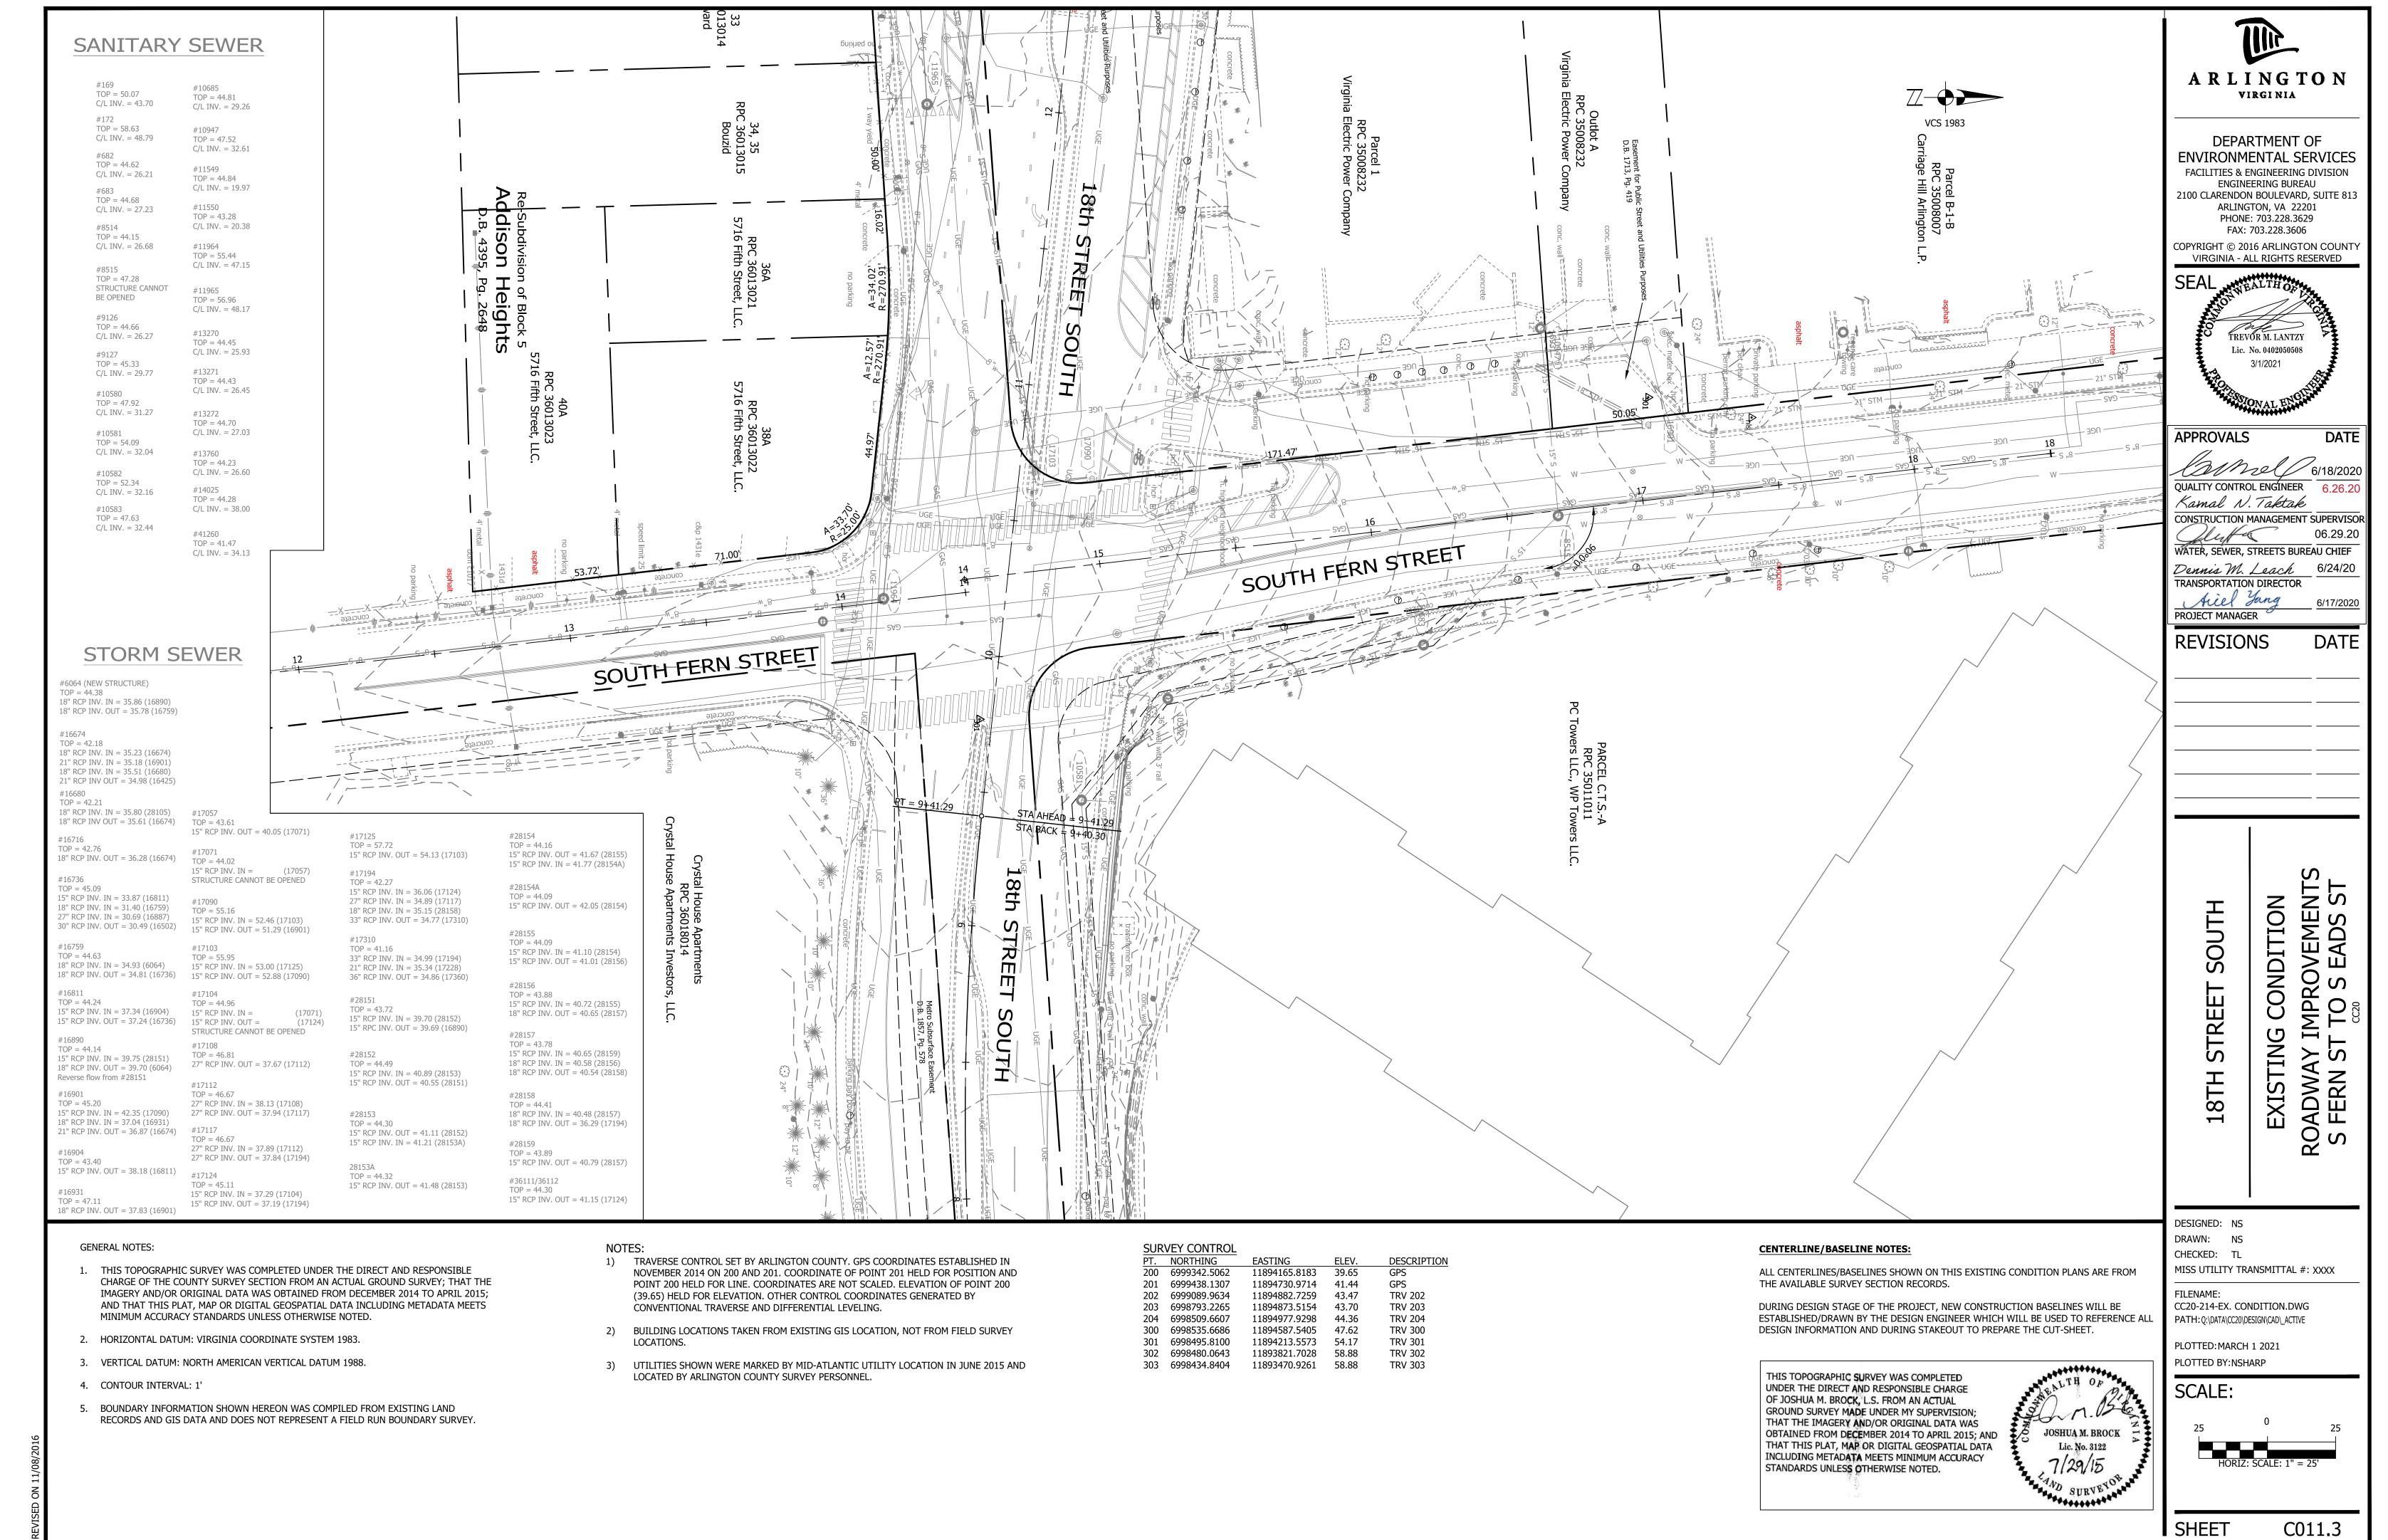

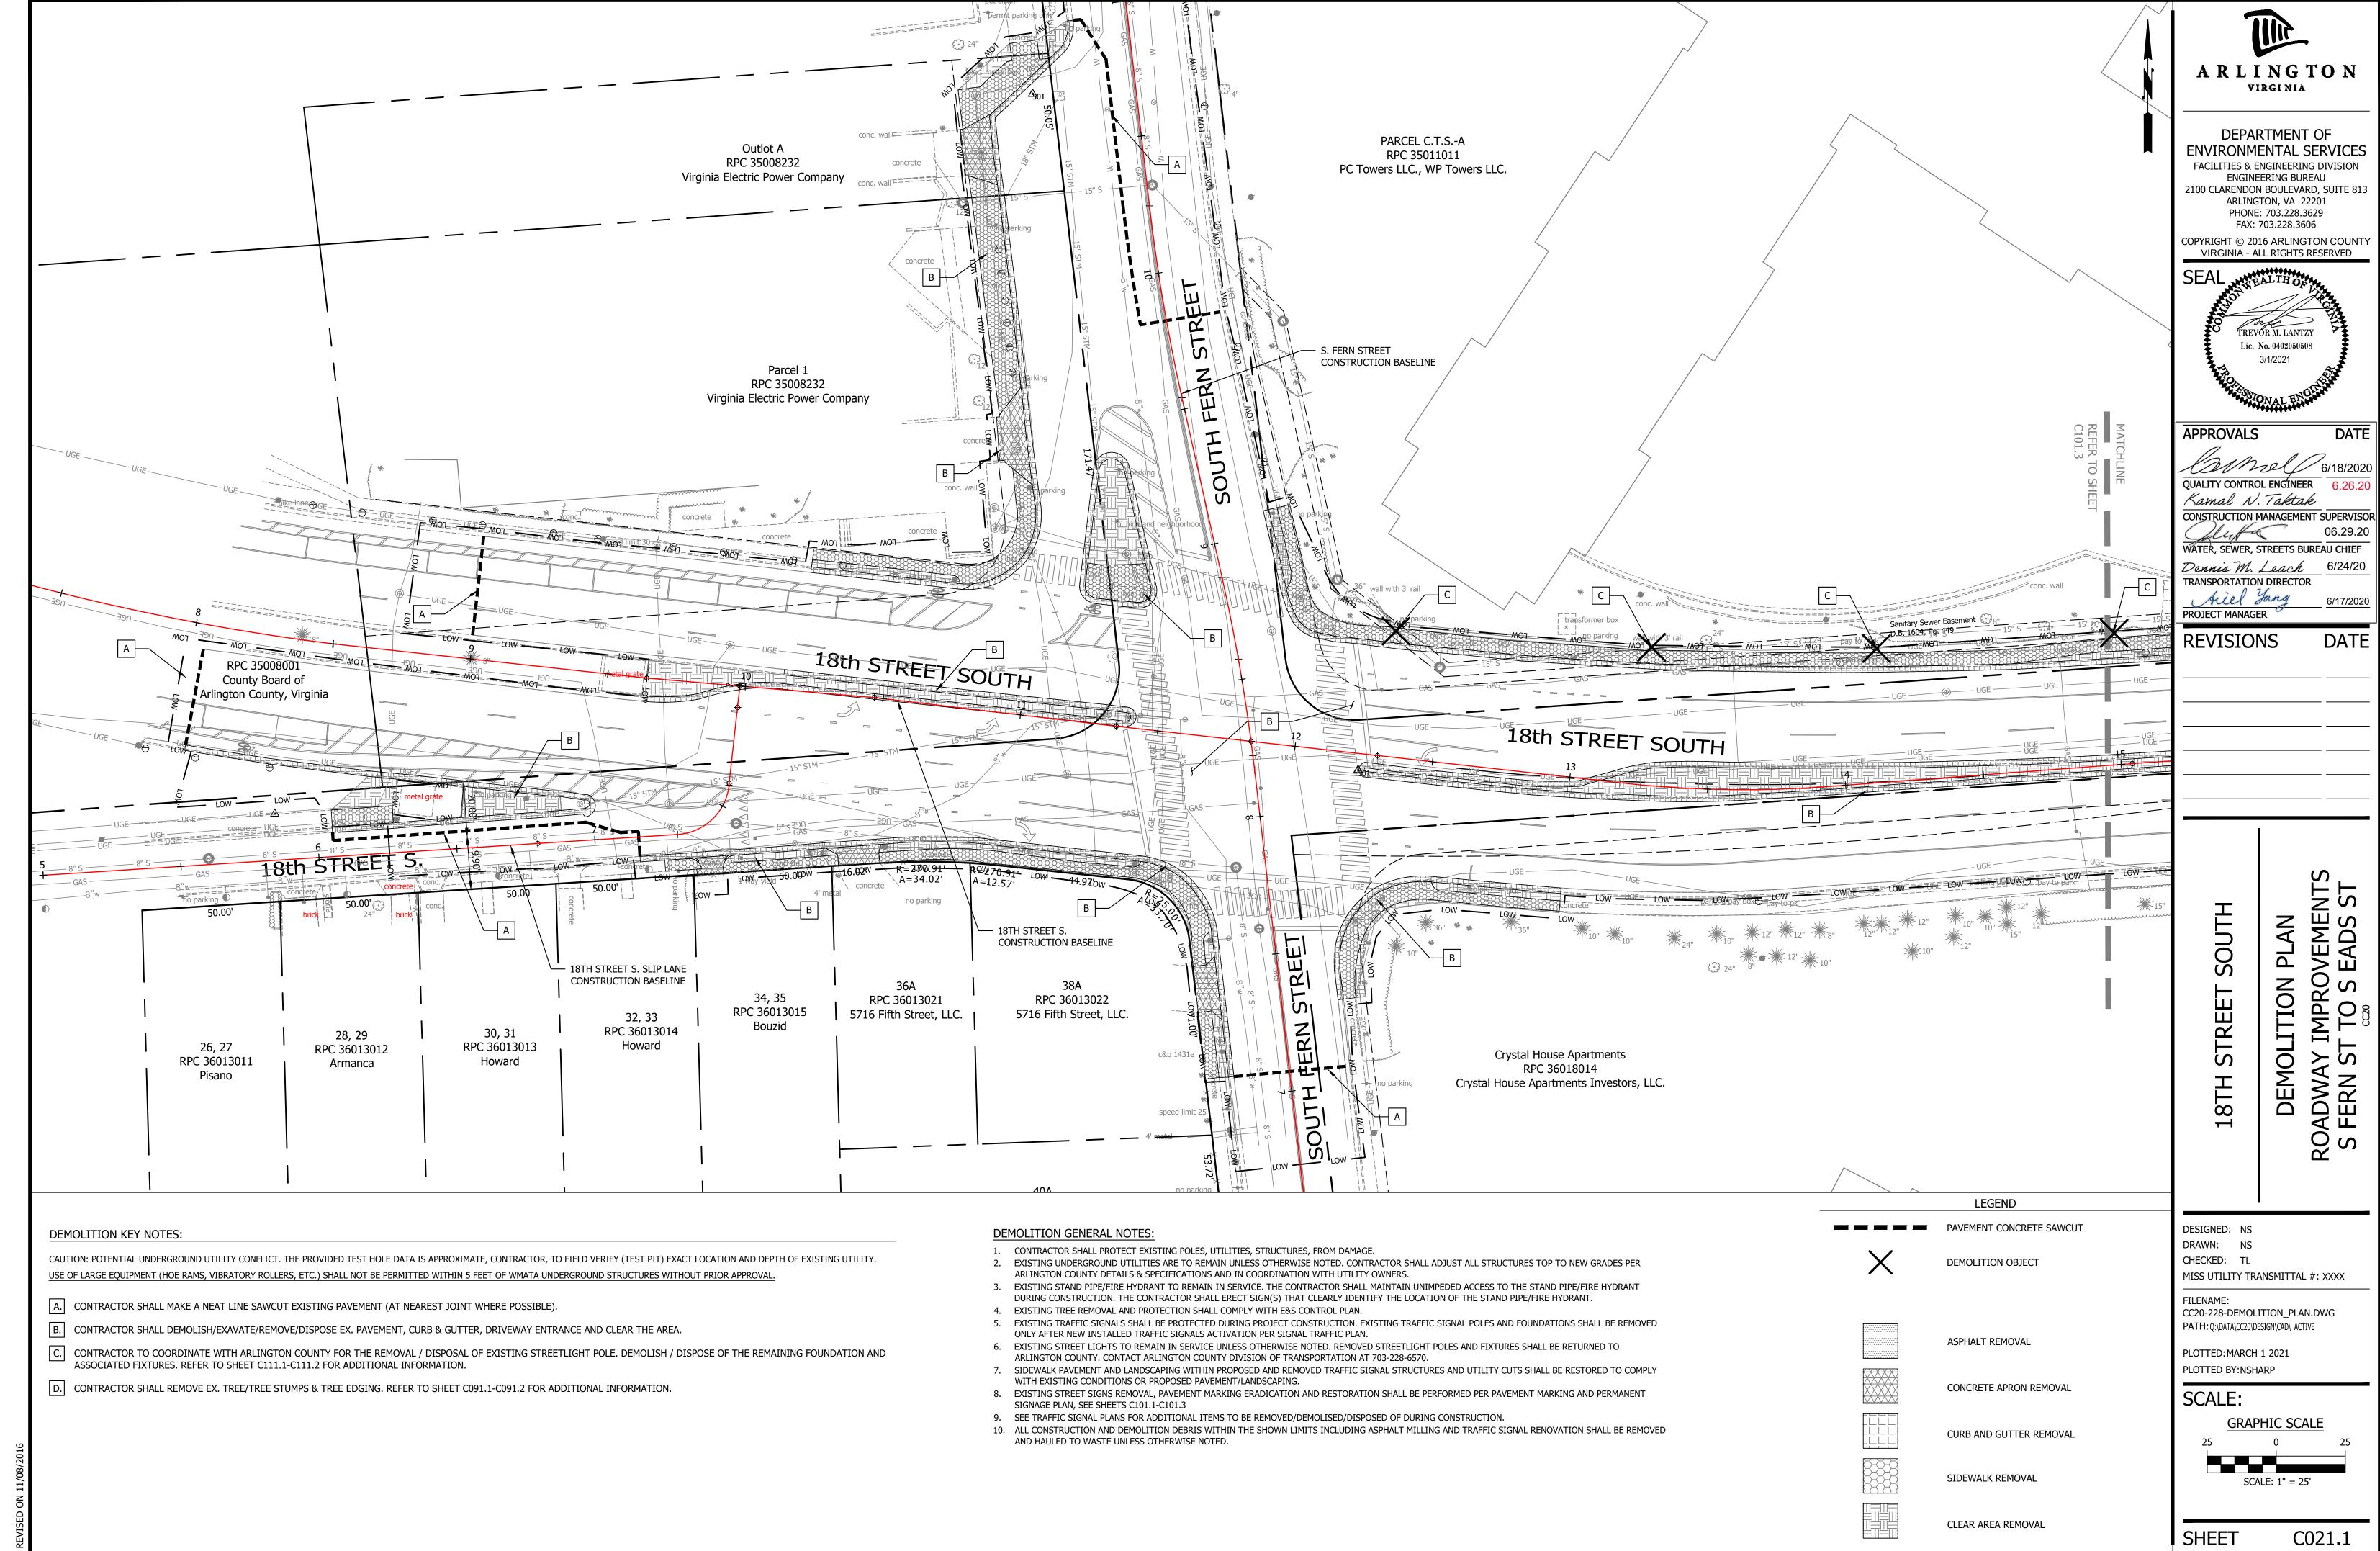

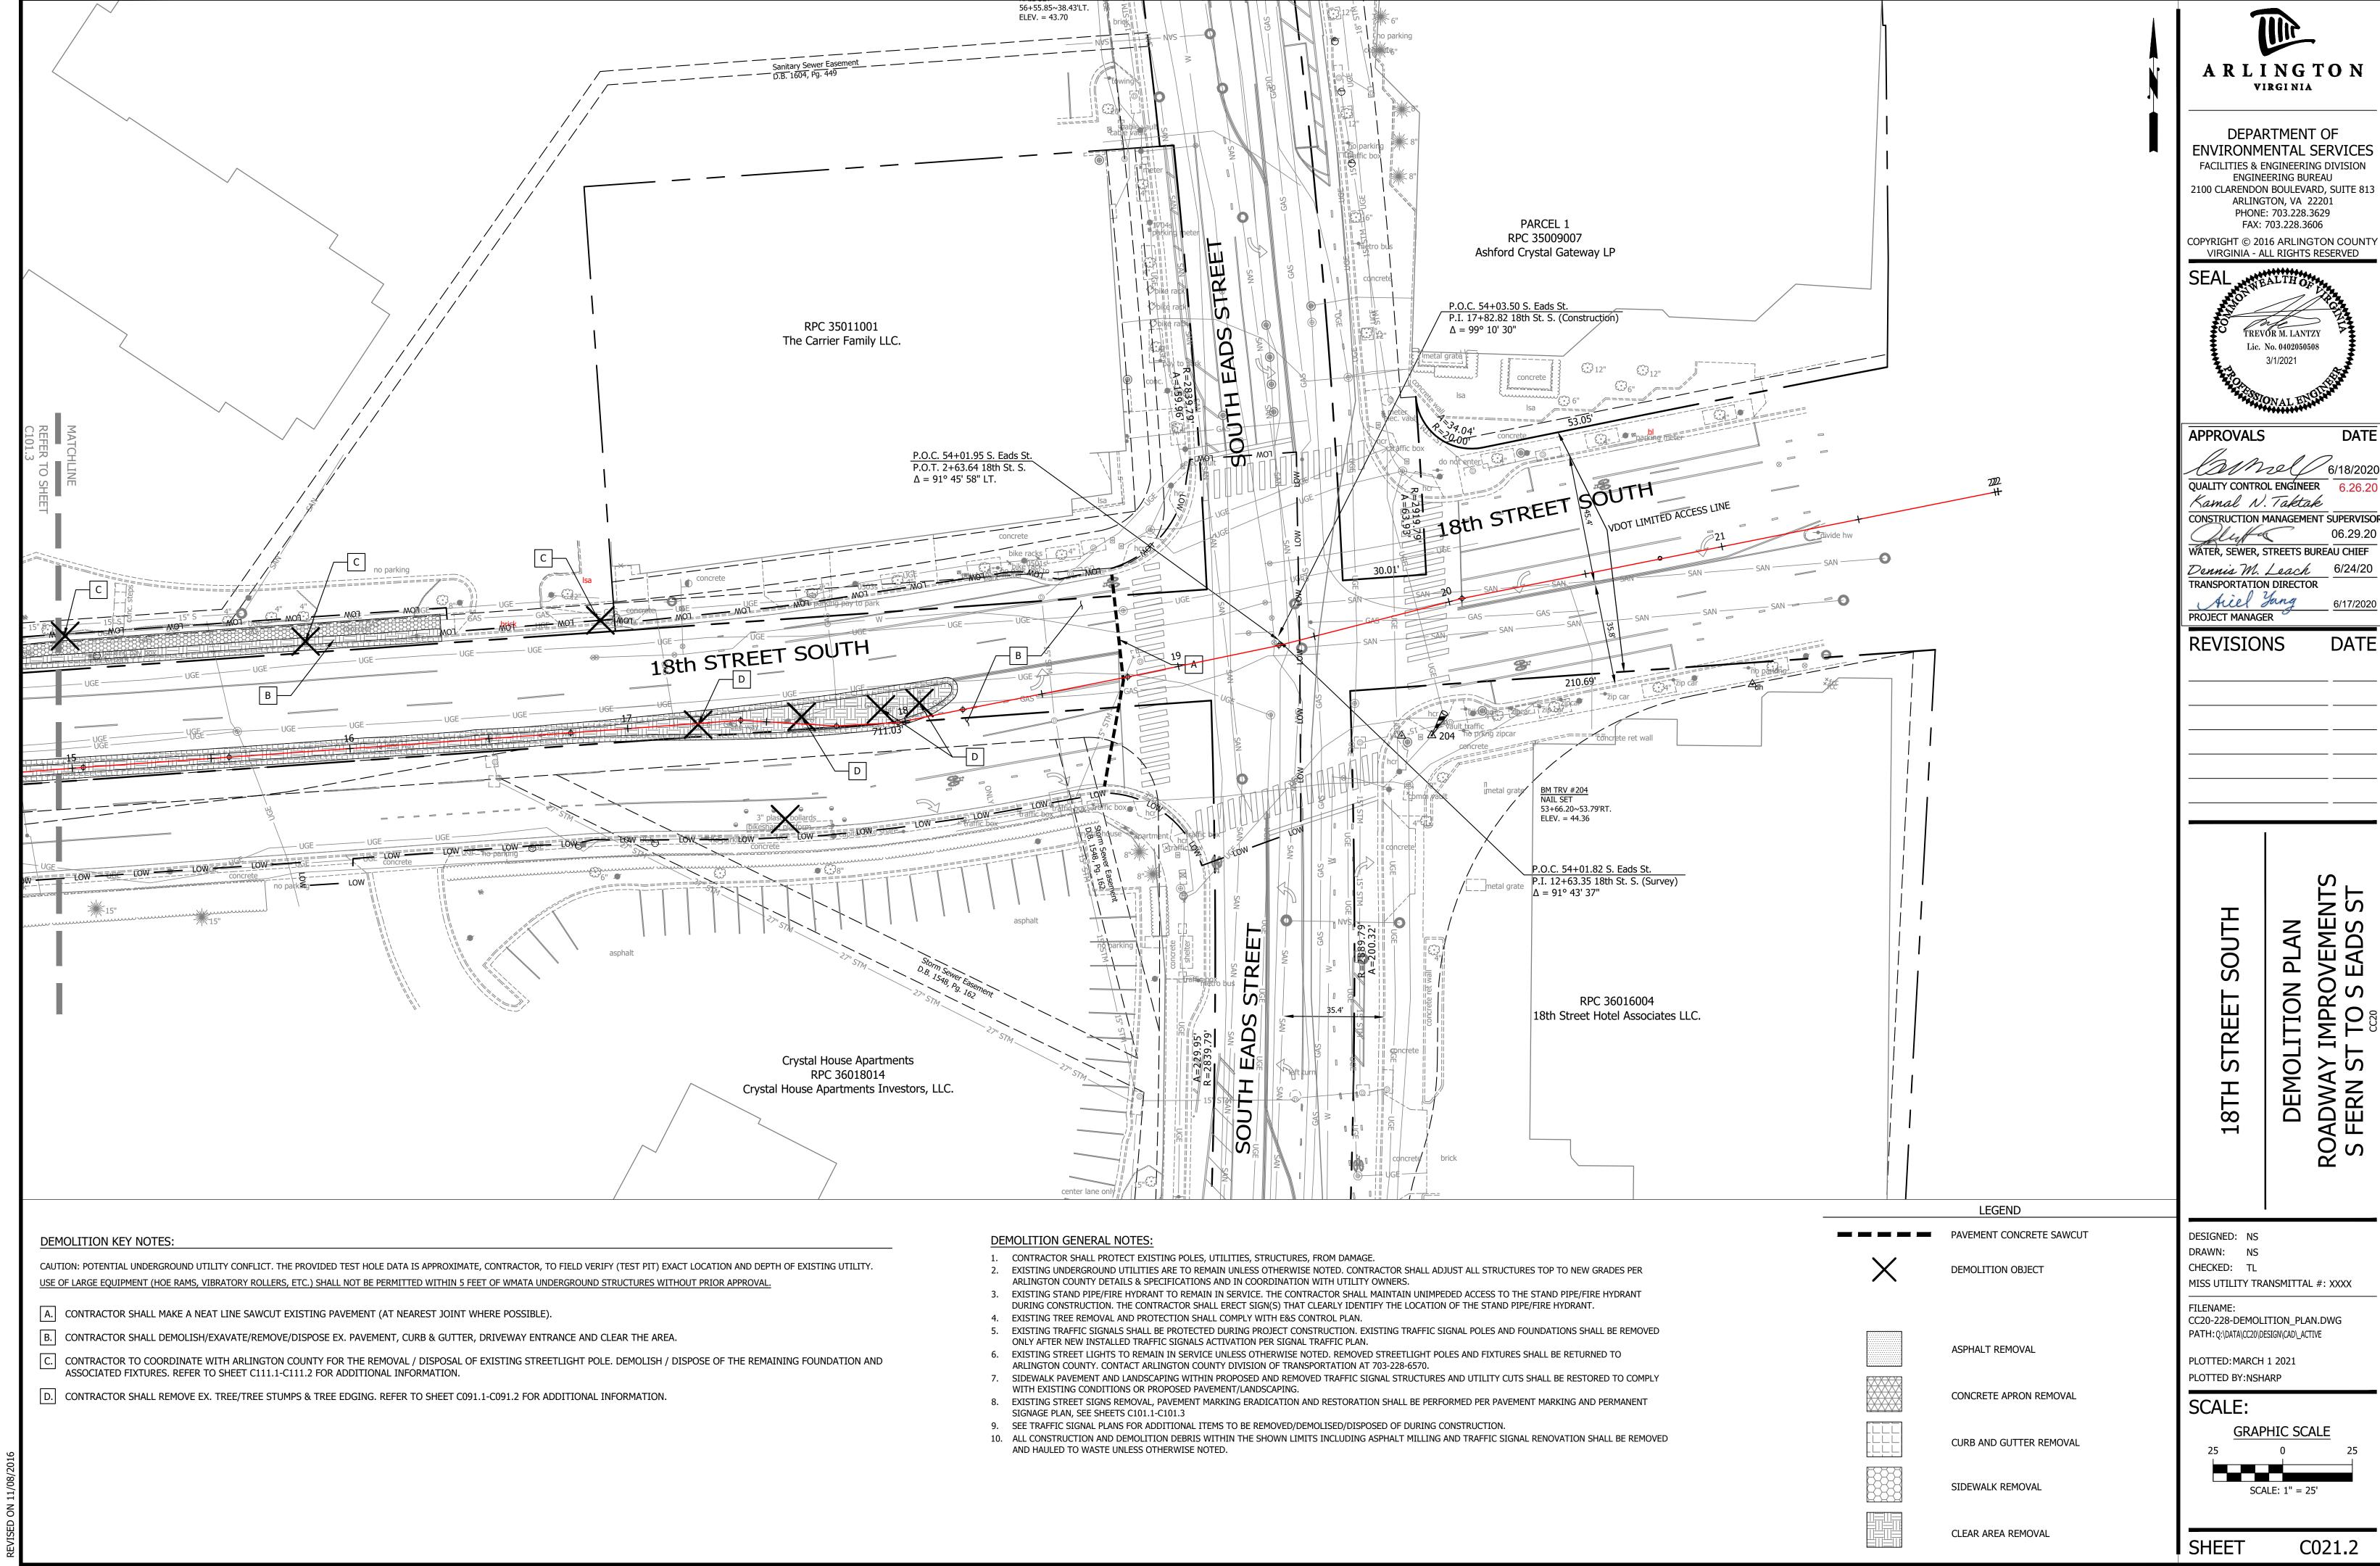

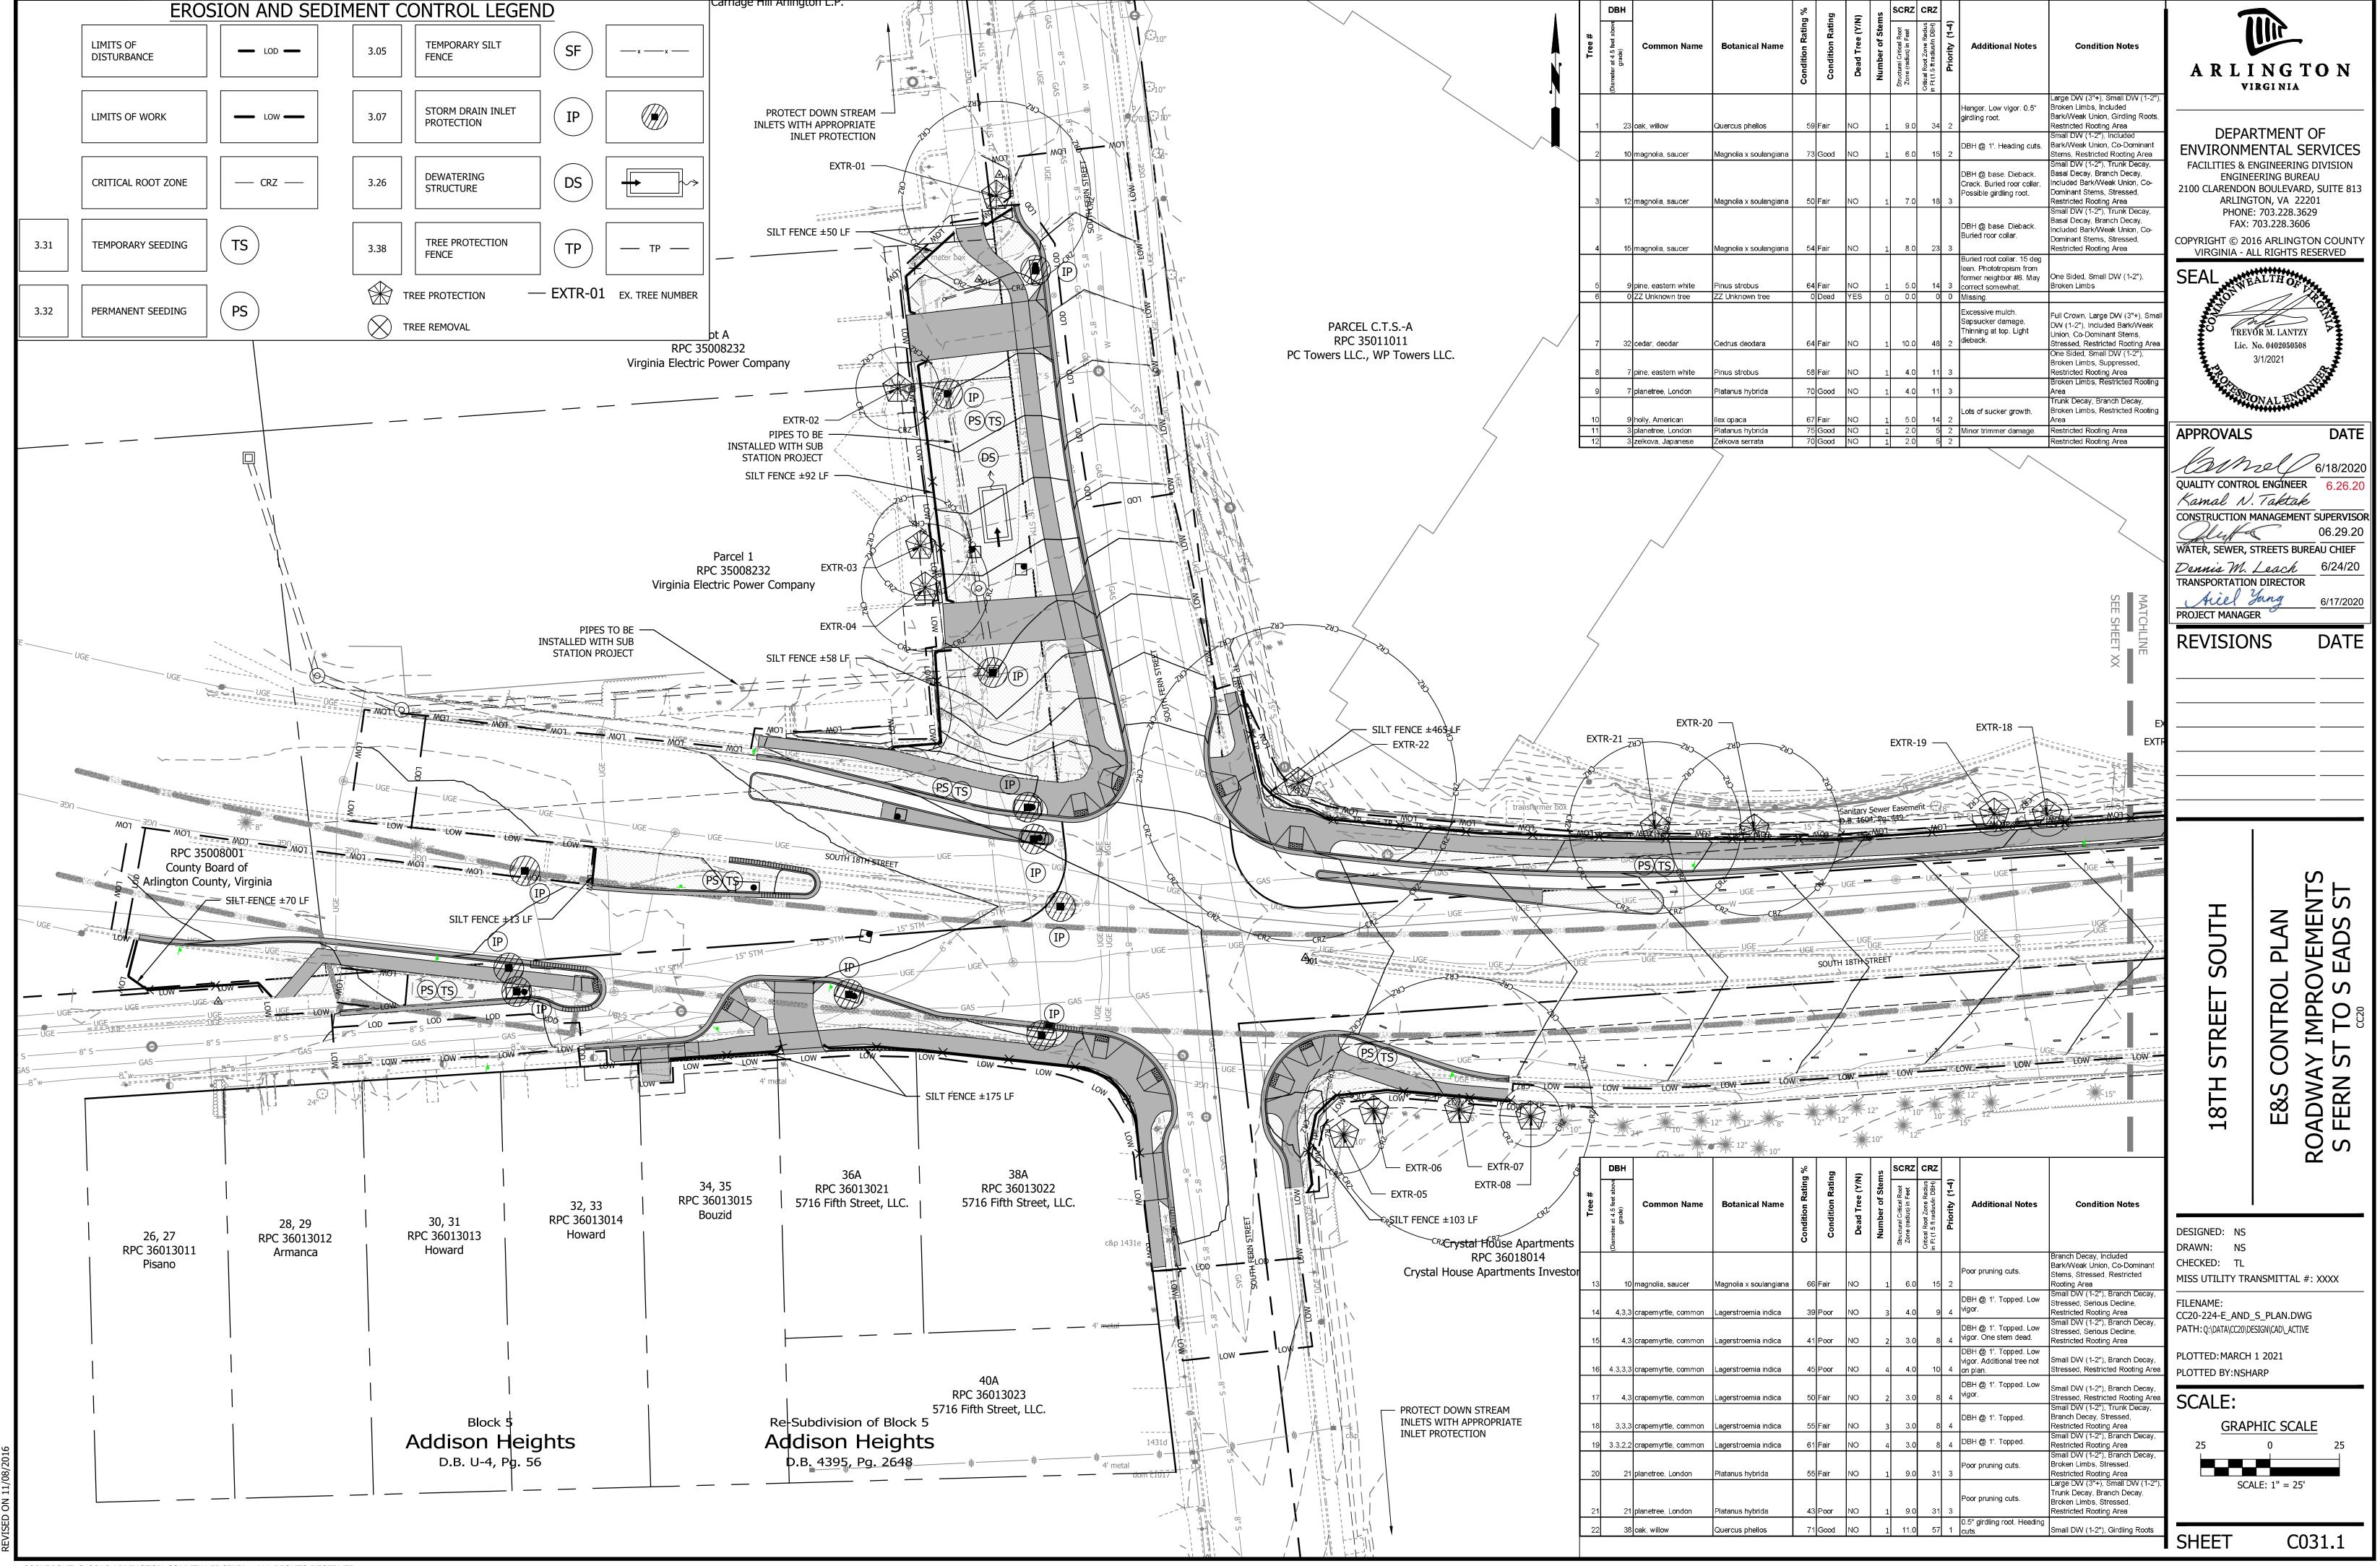

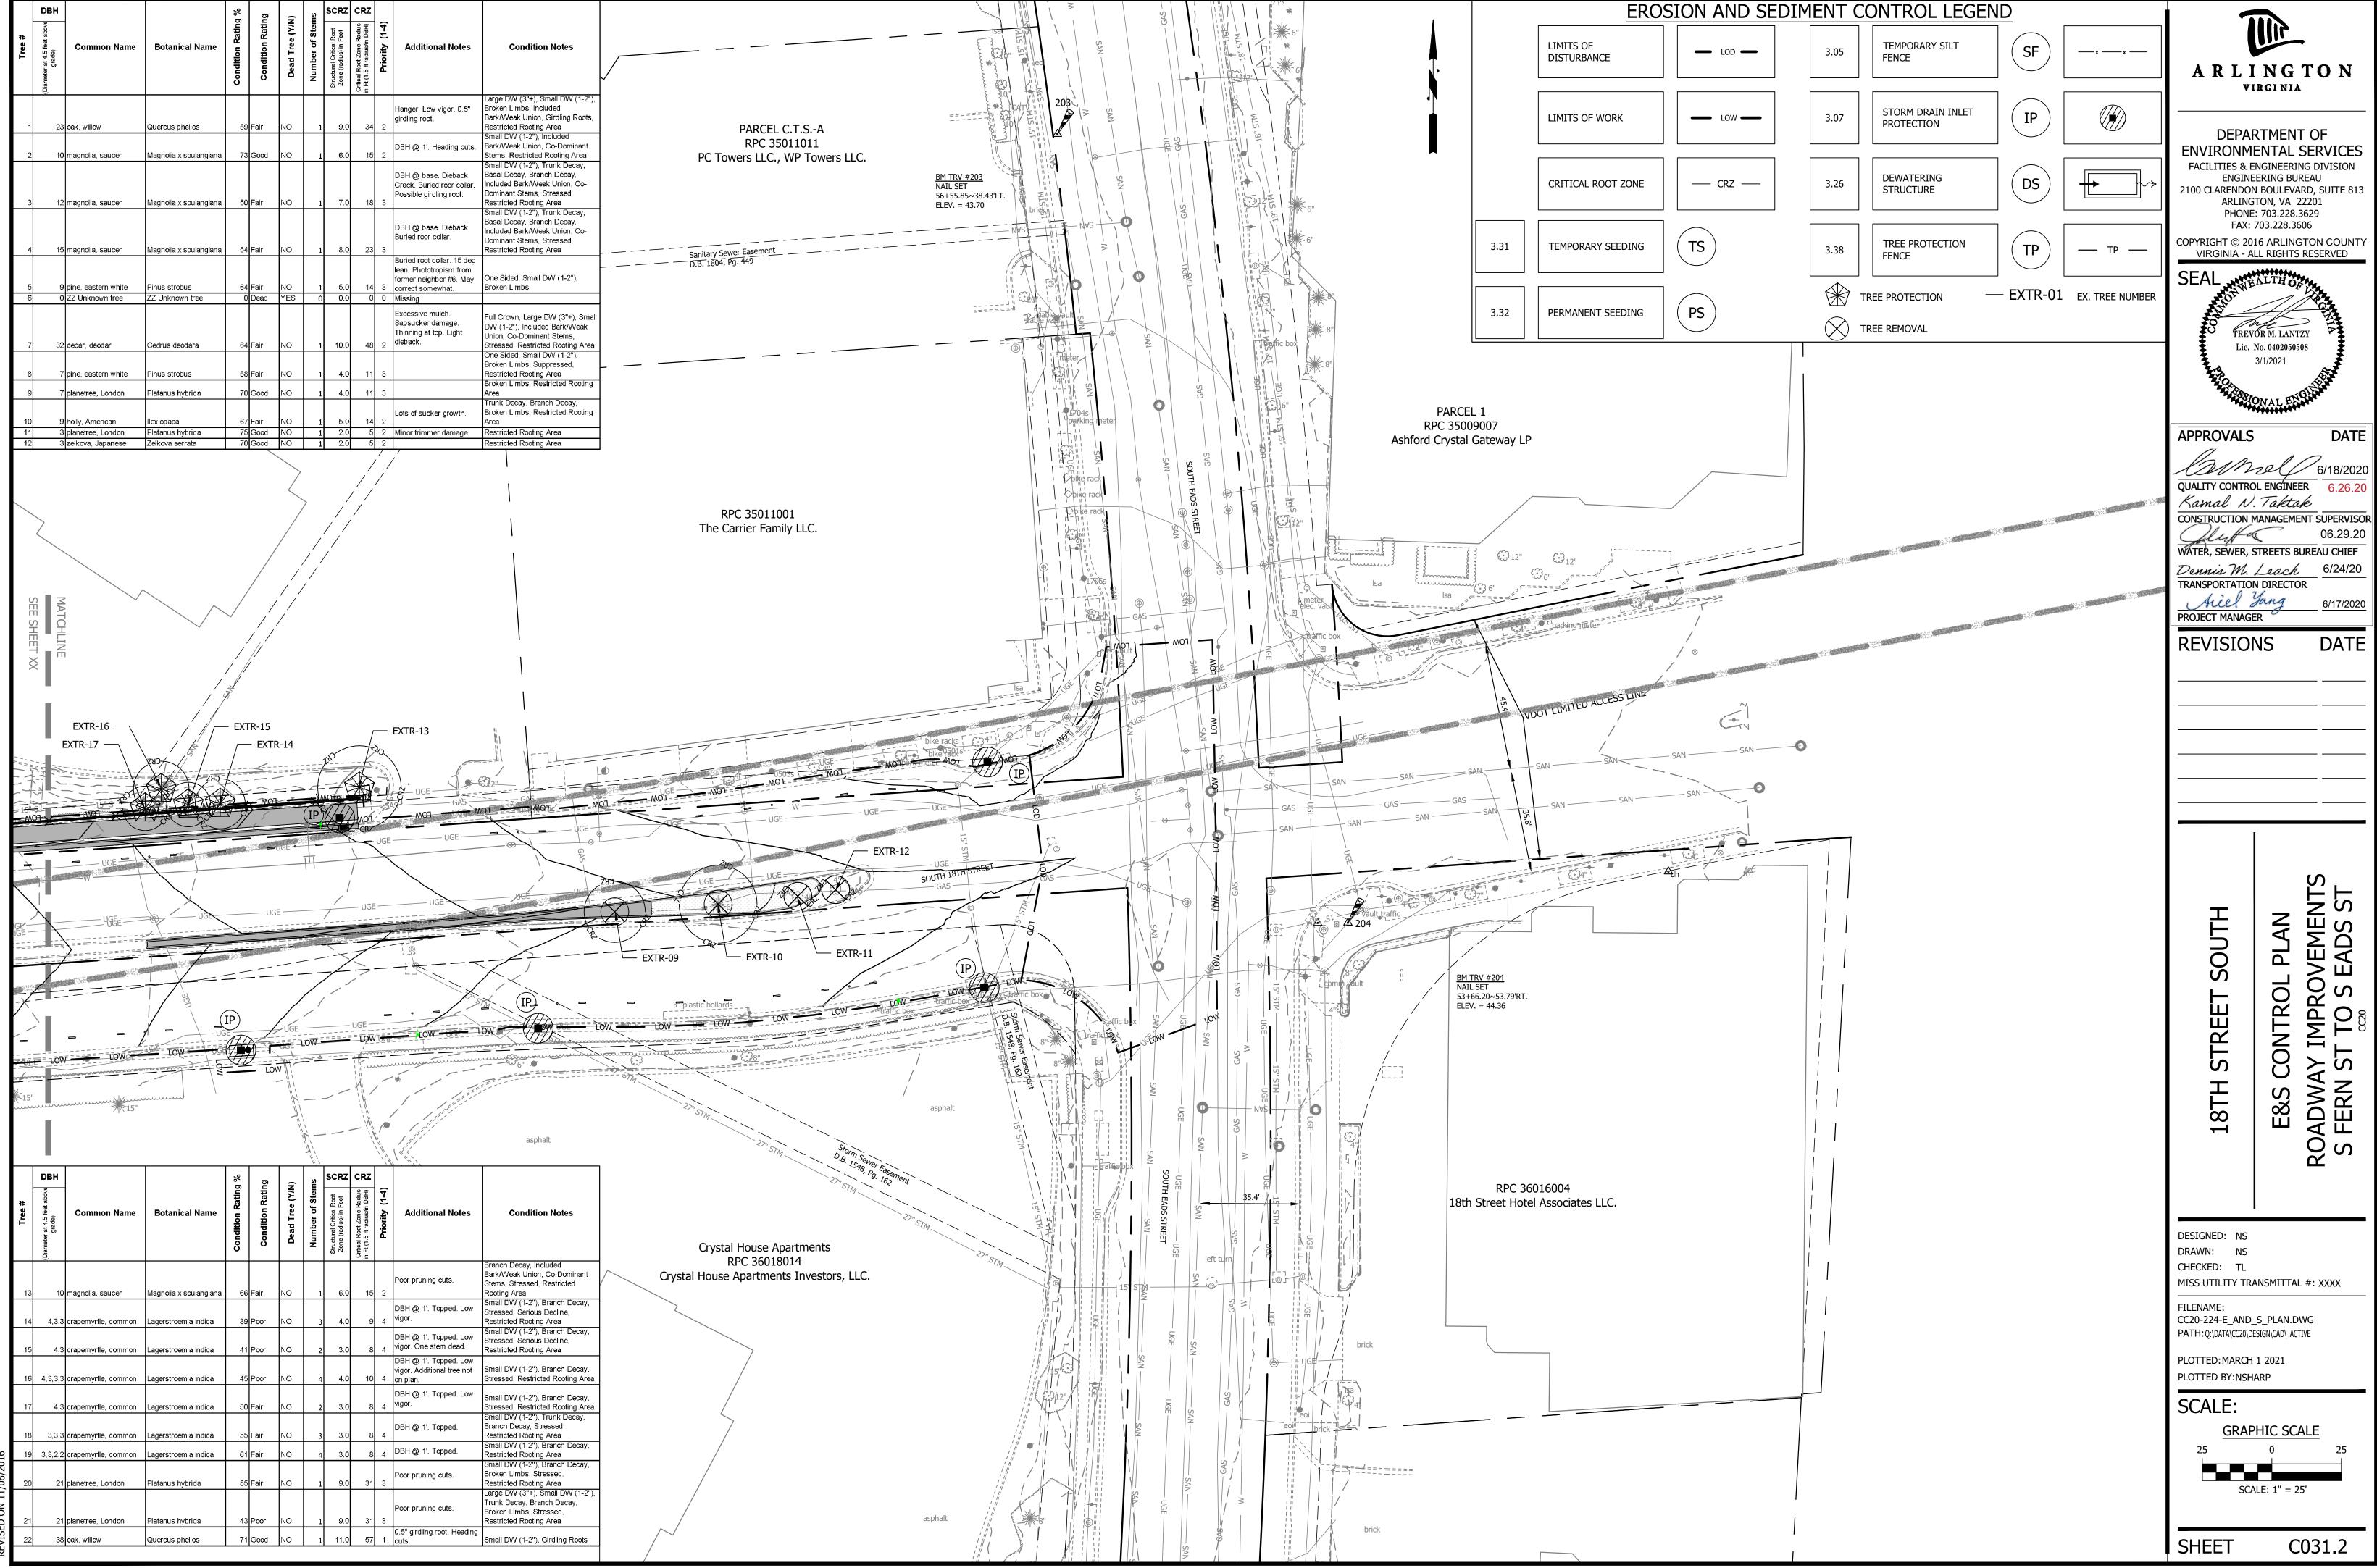

#### **EROSION AND SEDIMENT CONTROL NARRATIVE**

#### PROJECT DESCRIPTION:

18TH STREET SOUTH IMPROVEMENTS PROPOSED BETWEEN SOUTH EADS STREET AND SOUTH FERN STREET, ARLINGTON COUNTY, VA. THE PROJECT INCLUDES THE STREET REALIGNMENT OF CURBS, BIKE LANE, PARKING, MEDIANS, AND TRAVEL LANES.

#### **EXISTING SITE CONDITIONS:**

THE PROJECT SITE IS A BUSINESS AREA AND CONSISTS MOSTLY OF IMPERVIOUS AREA (ASPHALT ROADWAY AND CONCRETE SIDEWALK). SUFFICIENT STORM DRAINAGE SYSTEM IS IN PLACE AND THERE IS NO KNOWN RECORD OF FLOODING IN THE AREA.

#### **ADJACENT PROPERTIES:**

EAST - THE AREA TO THE EAST OF THE PROJECT CONSISTS OF SOUTH EADS STREET.

WEST - THE AREA TO THE WEST OF THE PROJECT CONSISTS OF THE CONTINUATION OF 18TH STREET SOUTH BEYOND FERN STREET. NORTH - MULTI-STORY RESIDENTIAL HOUSING AND AN ELECTRICAL SUB STATION.

#### SOUTH - MULTI-STORY RESIDENTIAL HOUSING AND SINGLE FAMILY HOUSING.

#### **OFF-SITE AREAS:**

THE EXTENT OF OFFSITE CONSTRUCTION IS LIMITED TO CONNECTING TO PROPOSED IMPROVEMENTS TO THE EXISTING STREETS, AND CONNECTING PROPOSED UTILITIES TO EXISTING UTILITIES.

#### **CRITICAL AREAS:**

AS THE PROJECT AREA IS WITHIN THE EXISTING ROADWAY, THERE ARE NO EXISTING EROSION PROBLEMS IDENTIFIED

#### **EROSION AND SEDIMENT CONTROL MEASURES:**

THE EROSION AND SEDIMENT CONTROL MEASURES FOR THIS PROJECT AREA INCLUDE SAFETY FENCE AND INLET PROTECTION. INLET PROTECTION IS REQUIRED OUTSIDE THE PROJECT LIMITS WHEN/WHERE WATER FROM DISTURBED AREA FLOWS.

#### **PERMANENT STABILIZATION:**

ALL AREAS DISTURBED BY CONSTRUCTION SHALL BE STABILIZED WITH GRASS, MULCH OR SOD, SEE THE PROPOSED PLANS FOR ADDITIONAL

#### STORMWATER RUNOFF CONSIDERATIONS:

NO ADDITIONAL IMPERVIOUS AREA WILL BE ADDED TO THIS PROJECT. TOTAL LIMITS OF WORK... ..... = 3.1003 ACRES (135,050 SF) TOTAL LAND DISTURBANCE..... = 2.7221 ACRES (118,576 SF) PRE-IMPROVEMENT IMPERVIOUS AREA..... = 2.5251 ACRES (109,993 SF) POST-IMPROVEMENT IMPERVIOUS AREA.... = 2.3741 ACRES (103,415 SF) INCREASED IMPERVIOUS AREA..... = -0.1510 ACRES (-6,578 SF)

#### **SOILS INFORMATION:**

THE FOLLOWING SOILS ARE FOUND ON SITE

#### SOIL#: SOIL NAME: HYDROLOGIC GROUP: ERODABILITY:

URBAN LAND-UDORTHENTS VARIES (ASSUMED AS GROUP D)

URBAN LAND-UDORTHENTS COMPLEX, 2% TO 15% SLOPES. THIS MAPPING UNIT CONSISTS OF AREAS WHERE MORE THAN 85% OF THE SURFACE IS URBAN LAND, COVERED BY BUILDINGS, ASPHALT, CONCRETE, OR OTHER IMPERVIOUS MATERIALS. THE OTHER 15% CONSISTS OF AREAS OF DEEP TO VERY DEEP, NEARLY LEVEL TO MODERATELY SLOPING, WELL AND MODERATELY WELL DRAINED SOILS. THE URBAN LAND AND UDORTHENTS ARE SO INTERMINGLED IT WAS NOT PRACTICAL TO MAP THEM SEPARATELY. THIS UNIT IS ABOUT 85% URBAN LAND, 10% UDORTHENTS, AND 5% OTHER SOILS.

THE UDORTHENTS CONSIST OF MATERIAL THAT HAS BEEN GRADED, CUT, FILLED, OR OTHERWISE DISTURBED DURING URBANIZATION. THE DISTURBED MATERIAL IS LOAMY AND GENERALLY REFLECTS THE SOILS IN THE ADJACENT AREA.

#### **WATERSHED INFORMATION:**

ROACHES RUN WATERSHED - 461.00 AC

VIRGINIA HIGHLAND WATERSHED - 309.00 AC

#### REFER TO SHEET C081.1 FOR OUTFALL INFORMATION FLOODPLAIN AND RESOURCE PROTECTION AREA (RPA):

THERE ARE NO FLOODPLAIN OR RESOURCE PROTECTION AREAS LOCATED WITHIN THIS PROJECT SITE. FLOOD ZONE X PER FIRM MAP 51013C0081C EFF.

#### **EROSION & SEDIMENT CONTROL PROJECT PHASING**

#### 1. PHASE I:

- a. PRE-CONSTRUCTION MEETING WITH THE PROJECT OFFICER, CONTRACTOR, AND COUNTY INSPECTOR.
- b. INSTALL THE TEMPORARY CONSTRUCTION ENTRANCE (IF NEEDED). MUD AND DEBRIS SHALL BE WASHED FROM ALL TRUCKS EXISTING THE SITE.
- c. INSTALL PERIMETER TREE DEMARCATION FENCING IN THE FORM OF TREE PROTECTION FENCE (TP) AS SHOWN ON E&S PLAN.
- d. PERFORM INITIAL PERIMETER CLEARING TO INSTALL REMAINDER OF PERIMETER CONTROLS SUCH AS SILT FENCE (SF) AND INLET PROTECTION (IP) FOR EXISTING STRUCTURES AS PER THE PLAN.
- e. SEED AND MULCH ALL EARTHEN CONTROLS.
- f. CONTACT ARLINGTON COUNTY PROJECT OFFICER FOR A PERIMETER INSPECTION PRIOR TO CLEARING THE REMAINDER OF THE SITE IN ORDER TO OBTAIN PHASE II GRADING PERMIT.
- g. CLEAR THE SITE TO THE LIMITS AS SHOWN ON THE CONSTRUCTION PLANS.

#### 2. PHASE II:

- a. BEGIN UTILITY CONSTRUCTION, INSTALL ALL UTILITIES UNDERGROUND UTILITIES AND BEGIN SITE GRADING.
- b. INLET PROTECTION (IP) SHALL BE PROVIDED AT STORM DRAIN INLETS AS THEY ARE CONSTRUCTED
- c. ONCE THE SITE IS BOUGHT TO NEAR FINAL GRADE, AND THE UTILITY CONSTRUCTION IS COMPLETE, COMMENCE CONSTRUCTION OF CURB & GUTTER, STREET, SIDEWALKS, AND OTHER IMPROVEMENTS
- d. THE CONTROL MEASURES MAY NOT BE REMOVED UNTIL ALL OF THE DISTURBED AREAS HAVE BEEN STABILIZED AND ONLY AS APPROVED AND DIRECTED BY THE INSPECTOR.

RUNOFF SHALL BE TREATED WITH SILT FENCE AND INLET PROTECTION PRIOR TO ENTERING MAJOR STORM SEWER SYSTEMS.

#### EROSION AND SEDIMENT CONTROL MEASURES

UNLESS OTHERWISE INDICATED, ALL VEGETATIVE AND STRUCTURAL EROSION AND SEDIMENT CONTROL PRACTICES SHALL BE CONSTRUCTED AND MAINTAINED ACCORDING TO MINIMUM STANDARDS AND SPECIFICATIONS OF THE VIRGINIA EROSION AND SEDIMENT CONTROL HANDBOOK AND THE ARLINGTON COUNTY EROSION AND SEDIMENT CONTROL ORDINANCE. THE MINIMUM STANDARDS OF THE VIRGINIA EROSION AND SEDIMENT CONTROL HANDBOOK SHALL BE ADHERED TO UNLESS OTHERWISE WAIVED OR APPROVED BY A VARIANCE.

#### 1. STRUCTURAL PRACTICES

a. TEMPORARY CONSTRUCTION ENTRANCE - VESCH 3.02

- a.a. A TEMPORARY CONSTRUCTION ENTRANCE WITH A WASH RACK SHALL BE INSTALLED AT THE EXISTING ACCESS POINT TO THE SITE. DURING MUDDY CONDITIONS, DRIVERS OF CONSTRUCTION VEHICLES WILL BE REQUIRED TO WASH THEIR WHEELS BEFORE RE-ENTERING THE LOCAL
- a.b. THE ENTRANCE SHALL BE MAINTAINED IN A CONDITION WHICH WILL PREVENT TRACKING OR FLOW OF MUD ONTO PUBLIC RIGHTS-OF-WAY. THIS MAY REQUIRE PERIODIC WASHING OF THE MATS AND/OR REPLACEMENT OF WOOD CHIPS AS NECESSARY.
- a.c. ALL MATERIALS SPILLED, DROPPED, WASHED, OR TRACKED FROM VEHICLES ONTO ROADWAYS OR INTO STORM DRAINS MUST BE REMOVED
- a.d. THE USE OF WATER TRUCKS TO REMOVE MATERIALS DROPPED, WASHED, OR TRACKED INTO ROADWAYS WILL NOT BE PERMITTED UNDER ANY CIRCUMSTANCES.

#### b. SILT FENCE - VESCH 3.05

- b.a. SILT FENCE WILL BE INSTALLED WITH THE E&S PLAN TO FILTER RUNOFF FROM DISTURBED AREAS. RUNOFF SHALL NOT BE DIRECTED PARALLEL TO THE INSTALLATION OF SILT FENCE.
- b.b. SILT FENCES SHALL BE INSPECTED IMMEDIATELY AFTER EACH RAINFALL AND AT LEAST DAILY DURING PROLONGED RAINFALL. ANY
- REQUIRED REPAIRS SHALL BE MADE IMMEDIATELY.
- b.c. CLOSE ATTENTION SHALL BE PAID TO THE REPAIR OF DAMAGED SILT FENCE RESULTING FROM UNDERCUTTING. b.d. SHOULD THE FABRIC ON A SILT FENCE DECOMPOSE OR BECOME INEFFECTIVE PRIOR TO THE END OF THE EXPECTED USABLE LIFE, THE
- FABRIC SHALL BE REPLACED IMMEDIATELY. b.e. SEDIMENT DEPOSITS SHALL BE REMOVED AFTER EACH STORM EVENT. THEY MUST BE REMOVED WHEN DEPOSITS REACH APPROXIMATELY
- b.f. ANY SEDIMENT DEPOSITS REMAINING IN PLACE AFTER THE SILT FENCE IS NO LONGER REQUIRED SHALL BE DRESSED TO CONFORM WITH
- THE EXISTING GRADE, THEN PREPARED AND SEEDED. c. STORM DRAIN INLET PROTECTION - VESCH 3.07

ONE-HALF THE HEIGHT OF THE BARRIER.

- c.a. ALL EXISTING & PROPOSED STORM SEWER INLETS IN AND AROUND THE PROJECT LIMITS SHALL BE PROTECTED DURING CONSTRUCTION. SEDIMENT-LADEN WATER SHALL BE FILTERED BEFORE ENTERING THE STORM SEWER INLETS.
- c.b. THE STRUCTURE SHALL BE INSPECTED AFTER EACH RAIN EVENT AND REPAIRS SHALL BE MADE AS NECESSARY
- c.c. STRUCTURES SHALL BE REMOVED AND THE AREA STABILIZED WHEN THE REMAINING DRAINAGE AREA HAS BEEN PROPERLY STABILIZED. d. DEWATERING STRUCTURE - VESCH 3.26
- d.a. SEDIMENT LADEN OR TURBID WATER SHALL BE FILTERED, SETTLED OR SIMILARLY TREATED PRIOR TO DISCHARGE.
- d.b. THE FILTERING DEVICES MUST BE INSPECTED FREQUENTLY AND REPAIRED OR REPLACED ONCE THE SEDIMENT BUILD-UP PREVENTS THE STRUCTURE FROM FUNCTIONING AS DESIGNED.
- d.c. THE ACCUMULATED SEDIMENT WHICH IS REMOVED FROM A DEWATERING DEVICE MUST BE SPREAD ON-SITE AND STABILIZED OR DISPOSED OF AT AN APPROVED DISPOSAL SITE AS PER THE APPROVED PLAN.
- e.a. ALL TREES ARE TO BE PROTECTED UNLESS OTHERWISE DIRECTED BY THE COUNTY INSPECTOR AND URBAN FORESTER. THE COUNTY'S URBAN FORESTER (703-228-1863) SHALL INSPECT ALL TREE PROTECTION 72 HOURS PRIOR TO THE START OF CONSTRUCTION. IN SPITE OF PRECAUTIONS, SOME DAMAGE TO PROTECTED TREES MAY OCCUR. IN SUCH CASES, THE FOLLOWING MAINTENANCE GUIDELINES SHALL BE
- e.a.a. SOIL AERATION: IF THE SOIL HAS BECOME COMPACTED OVER THE ROOT ZONE OF ANY TREE, THE GROUND SHALL BE AERATED BY PUNCHING HOLES WITH AN IRON BAR. THE BAR SHALL BE DRIVEN 1-FOOT DEEP AND THEN MOVED BACK AND FORTH UNTIL THE SOIL IS LOOSENED. THIS PROCEDURE SHALL BE REPEATED EVERY 18 INCHES UNTIL ALL OF THE COMPACTED SOIL BENEATH THE CROWN OF THE TREE HAS BEEN LOOSENED.
- e.a.b. REPAIR OF DAMAGE:

e. TREE PROTECTION - VESCH 3.38

- ANY DAMAGE TO THE CROWN, TRUNK, OR ROOT SYSTEM OF ANY TREE RETAINED ON THE SITE SHALL BE REPAIRED IMMEDIATELY. WHENEVER MAJOR ROOT OR BARK DAMAGE OCCURS, REMOVE SOME FOLIAGE TO REDUCE THE DEMAND FOR WATER AND
- NUTRIENTS. DAMAGED ROOTS SHALL IMMEDIATELY BE CUT OFF CLEANLY INSIDE THE EXPOSED OR DAMAGED AREA. CUT SURFACES SHALL BE
- PAINTED WITH APPROVED TREE PAINT, AND MOIST PEAT MOSS, BURLAP, OR TOPSOIL SHALL BE SPREAD OVER THE EXPOSED AREA. TO TREAT BARK DAMAGE, CAREFULLY CUT AWAY ALL LOOSENED BARK BACK INTO THE UNDAMAGED AREA, TAPER THE CUT AT THE TOP AND BOTTOM, AND PROVIDE DRAINAGE AT THE BASE OF THE WOUND.
- ALL TREE LIMBS DAMAGED DURING CONSTRUCTION OR REMOVED FOR ANY OTHER REASON SHALL BE CUT OFF ABOVE THE COLLAR AT THE PRECEDING BRANCH JUNCTION.
- CARE FOR SERIOUS INJURIES SHALL BE PRESCRIBED BY A FORESTER OR A TREE SPECIALIST. e.b. FERTILIZATION: BROADLEAF TREES THAT HAVE BEEN STRESSED OR DAMAGED SHALL RECEIVE A HEAVY APPLICATION OF FERTILIZER TO AID
- e.b.a. TREES SHALL BE FERTILIZED IN THE LATE FALL (AFTER OCTOBER 1) OR THE EARLY SPRING (FROM THE TIME FROST IS OUT OF THE GROUND UNTIL MAY 1). FALL APPLICATIONS ARE PREFERRED, AS THE NUTRIENTS WILL BE MADE AVAILABLE OVER A LONGER PERIOD
- FERTILIZER SHALL BE APPLIED TO THE SOIL OVER THE FEEDER ROOTS. IN NO CASE SHALL IT BE APPLIED CLOSER THAN 3 FEET TO THE TRUNK. THE ROOT SYSTEM OF CONIFERS EXTENDS SOME DISTANCE BEYOND THE DRIP LINE. INCREASE THE AREA TO BE FERTILIZED BY ONE FOURTH THE AREA OF THE CROWN.
- e.b.c. FERTILIZER SHALL BE APPLIED USING APPROVED FERTILIZATION METHODS AND EQUIPMENT.
- e.b.d. FORMULATIONS AND APPLICATION RATES SHALL CONFORM TO THE GUIDELINES GIVEN IN TABLE 3.38-A OF VESCH.

#### 2. VEGETATIVE PRACTICES

a. TEMPORARY SEEDING - VESCH 3.31

- a.a. ALL DENUDED AREAS, WHICH WILL BE LEFT DORMANT FOR EXTENDED PERIODS OF TIME SHALL BE SEEDED WITH FAST GERMINATING TEMPORARY VEGETATION IMMEDIATELY FOLLOWING GRADING. SELECTION OF THE SEED MIXTURE WILL DEPEND ON THE TIME OF YEAR IT IS APPLIED
- a.b. SEE SHEET III-288 OF THE VIRGINIA EROSION AND SEDIMENT CONTROL HANDBOOK (VESCH) FOR ALLOWABLE PLANTING MATERIAL, SEEDING RATES, AND DATES. THE PLANTING REQUIREMENTS OF THE "SOUTH" SHALL BE FOLLOWED. LIMING SHALL BE BASED ON TABLE 3.31-A OF VESCH. FERTILIZERS SHALL BE APPLIED AS 600 LB/ACRE. THE FERTILIZER SHALL BE INCORPORATED INTO THE TOP 2-4" OF SOIL. SEED SHALL BE EVENLY APPLIED AND SMALL GRAINS SHALL BE PLANTED NO MORE THAN 1.5" DEEP. SEEDING MADE IN FALL FOR WINTER COVER AND DURING HOT SUMMER MONTHS SHALL BE MULCHED.

b. PERMANENT SEEDING - VESCH 3.32

- b.a. SINCE THE SUBJECT SITE IS LOCATED WITHIN THE COASTAL PLAIN AREA OF VIRGINIA, SHEET III-304 OF THE VIRGINIA EROSION AND SEDIMENT CONTROL HANDBOOK SHALL BE FOLLOWED FOR FINAL SEEDING MATERIAL, SEEDING RATES, AND DATES OF APPLICATION. c. SODDING - VESCH 3.33
- c.a. SODDED AREAS SHALL BE BROUGHT TO FINAL GRADE IN ACCORDANCE WITH THE APPROVED PLANS. SOIL TESTS SHALL BE MADE TO DETERMINE THE EXACT REQUIREMENTS FOR LIME AND FERTILIZER. PRIOR TO LAYING SOD, SOIL SURFACE SHALL BE CLEAR OF TRASH, DEBRIS AND LARGE OBJECTS. QUALITY OF SOD SHALL BE STATE CERTIFIED TO ENSURE GENETIC PURITY AND HIGH QUALITY. SOD SHALL NOT BE LAID ON FROZEN SOIL SURFACE, OR IN EXCESSIVELY WET OR DRY WEATHER. SOD SHALL BE DELIVERED AND INSTALLED WITHIN 36 HOURS, AND SHALL BE INSTALLED PER PAGE III-339 OF VESCH.

THE EROSION AND SEDIMENT CONTROL INSPECTOR SHALL HAVE THE AUTHORITY TO ADD OR DELETE EROSION AND SEDIMENT CONTROLS AS NEEDED IN THE FIELD. IN ADDITION, NO SEDIMENT TRAPS OR BASINS MAY BE REMOVED WITHOUT PRIOR APPROVAL OF THE INSPECTOR

#### **EROSION AND SEDIMENT CONTROL MANAGEMENT MEASURES**

#### LANDSCAPE / TREE PRESERVATION NOTES

PRIOR TO ANY LAND DISTURBING ACTIVITY, THE CONTRACTOR SHALL CONTACT THE ARLINGTON COUNTY ARBORIST TO SCHEDULE AN INSPECTION.

#### **LAND CONSERVATION NOTES:**

- 1. NO DISTURBED AREA WILL REMAIN DENUDED FOR MORE THAN 7 CALENDAR DAYS UNLESS OTHERWISE AUTHORIZED BY THE DIRECTOR OR HIS AGENT. 2. ALL EROSION AND SEDIMENT CONTROL MEASURES ARE TO BE PLACED PRIOR TO OR AS THE FIRST STEP IN GRADING. FIRST AREAS TO BE CLEARED ARE TO BE THOSE REQUIRED FOR THE PERIMETER CONTROLS.
- 3. ALL STORM AND SANITARY SEWER LINES NOT IN STREETS ARE TO BE MULCHED AND SEEDED WITHIN 5 DAYS AFTER BACKFILL. NO MORE THAN 100 FEET ARE TO BE OPEN AT ANY ONE TIME.
- 4. ELECTRIC POWER, TELEPHONE AND GAS SUPPLY TRENCHES ARE TO BE COMPACTED, SEEDED AND MULCHED WITHIN 5 DAYS AFTER BACKFILLING.

5. ALL TEMPORARY EARTH BERMS, DIVERSIONS AND SEDIMENT CONTROL DAMS ARE TO BE MULCHED AND SEEDED FOR TEMPORARY VEGETATIVE COVER

IMMEDIATELY AFTER GRADING. STRAW OR HAY MULCH IS REQUIRED. THE SAME APPLIES TO ALL SOIL STOCKPILES.

6. DURING CONSTRUCTION, ALL STORM SEWER INLETS WILL BE PROTECTED BY INLET PROTECTION.

- 7. ANY DISTURBED AREA NOT COVERED BY NOTE 1 ABOVE AND NOT PAVED, SODDED OR BUILT UPON BY NOV. 1, OR DISTURBED AFTER THAT DATE, SHALL BE MULCHED IMMEDIATELY WITH HAY OR STRAW MULCH AT THE RATE OF 2 TONS/ACRE AND OVER-SEEDED BY APRIL 15.
- 8. AT THE COMPLETION OF ANY PROJECT CONSTRUCTION AND PRIOR TO BOND RELEASE, ALL TEMPORARY SEDIMENT CONTROLS SHALL BE REMOVED AND ALL DENUDED AREAS SHALL BE STABILIZED.

#### **EROSION & SEDIMENT CONTROL PROGRAM:**

- 1. THE EROSION CONTROL PLAN IS INTENDED TO ESTABLISH ENTRANCES AND PERIMETER CONTROL MEASURES WHICH INCLUDES SILT FENCE (SF), INLET PROTECTION (IP), AND OTHER CONTROLS SPECIFIED ON THE PLANS.
- 2. WHERE CONSISTENT WITH JOB SAFETY REQUIREMENTS, ALL EXCAVATED MATERIAL SHALL BE PLACED ON THE UPHILL SIDE OF TRENCHES. NO MATERIAL SHALL BE PLACED IN STREAMBEDS. ANY STOCKPILED MATERIAL WHICH WILL REMAIN IN PLACE LONGER THAN 7 DAYS SHALL BE SEEDED AND MULCHED. WHEN SPOIL IS PLACED ON THE DOWNHILL SIDE OF TRENCH, IT SHALL BE BACKSLOPED TO DRAIN TOWARD THE TRENCH. WHEN NECESSARY TO DEWATER THE TRENCH, THE PUMP DISCHARGE HOSE SHALL OUTLET IN A STABILIZED AREA OR A SEDIMENT TRAPPING DEVICE.
- 3. ALL PRACTICES AND CONTROL DEVICES DESCRIBED HEREIN SHALL CONFORM TO THE CURRENT VIRGINIA EROSION AND SEDIMENT CONTROL HANDBOOK (VESCH). IN ADDITION, THE CONTRACTOR SHALL TAKE THE FOLLOWING STEPS TO MINIMIZE THE VOLUME OF SILT:
- a. CONTRACTOR SHALL EVALUATE THE SITE TO DETERMINE EXTENSIVE CUT AND FILL AREAS, AND SHALL WORK THOSE AREAS TO MINIMIZE THE USE OF HEAVY EQUIPMENT. CONTRACTOR SHALL BRING DISTURBED AREAS TO GRADE (ROUGH OR FINISHED) AND STABILIZE THOSE AREAS WITH TEMPORARY OR PERMANENT VEGETATION. THESE DISTURBED AREAS SHALL BE STABILIZED PRIOR TO BEGINNING WORK IN ANOTHER AREA.
- b. FILL AREAS SHALL BE COMPACTED COMPLETELY PRIOR TO THE END OF EACH WORK DAY. FILL SLOPE SURFACES SHALL BE KEPT ROUGH TO REDUCE SHEET EROSION OF THE SLOPES. CONTRACTOR SHALL RE-DIRECT CONCENTRATED RUNOFF, BY EARTH BERMS OR OTHER DEVICES, AROUND ACTIVELY DISTURBED AREAS TO STABILIZED OUTLETS.
- c. CUT SLOPES SHALL BE PROTECTED FROM CONCENTRATED FLOW BY BERMS (ABOVE THE SLOPE) AND DIRECTED AROUND THE DISTURBED AREA TO STABILIZED OUTLETS.
- 4. MEASURES TO CONTROL EROSION AND SILTATION SHALL BE PROVIDED PURSUANT TO AND IN COMPLIANCE WITH CURRENT STATE AND LOCAL REGULATIONS. THE INFORMATION CONTAINED IN THE CONSTRUCTION PLANS AND/OR THE APPROVAL OF THE PLANS SHALL IN NO WAY RELIEVE THE CONTRACTOR OR HIS AGENT OF ANY LEGAL RESPONSIBILITY WHICH MAY BE REQUIRED BY THE CODE OF VIRGINIA AND CHAPTER 57 OF THE ARLINGTON COUNTY CODE.
- 5. ALL AREAS, ON OR OFF-SITE, THAT ARE DISTURBED BY THIS CONSTRUCTION AND WHICH ARE NOT PAVED OR BUILT UPON SHALL BE ADEQUATELY STABILIZED TO CONTROL EROSION AND SEDIMENTATION. ACCEPTABLE STABILIZATION SHALL CONSIST OF PERMANENT GRASS SEED MIXTURE OR SOD THAT IS INSTALLED IN ACCORDANCE WITH THE PROJECT SPECIFICATIONS. ALL SLOPES 3:1 AND GREATER SHALL BE RECEIVE SOIL STABILIZATION IN ACCORDANCE WITH THE SPECIFICATIONS.
- 6. WHERE STREAM CROSSINGS ARE REQUIRED FOR EQUIPMENT, TEMPORARY CULVERTS SHALL BE PROVIDED.
- 7. FOR FURTHER REQUIREMENTS AND DETAILS OF TREE PRESERVATION, PLANTING, EROSION AND SEDIMENT CONTROL, SEE COUNTY CONSTRUCTION STANDARDS AND SPECIFICATIONS AND/OR THE VIRGINIA EROSION AND SEDIMENT CONTROL HANDBOOK.

#### **GENERAL EROSION AND SEDIMENT CONTROL NOTES**

- 1. UNLESS OTHERWISE INDICATED, ALL VEGETATIVE AND STRUCTURAL EROSION AND SEDIMENT CONTROL PRACTICES WILL BE CONSTRUCTED AND MAINTAINED ACCORDING TO THE MINIMUM STANDARDS AND SPECIFICATIONS OF THE VIRGINIA EROSION AND SEDIMENT CONTROL HANDBOOK AND VIRGINIA REGULATIONS VR 625-02-00 EROSION AND SEDIMENT CONTROL REGULATIONS.
- 2. THE PLAN APPROVING AUTHORITY MUST BE NOTIFIED ONE WEEK PRIOR TO THE PRE-CONSTRUCTION CONFERENCE, ONE WEEK PRIOR TO THE COMMENCEMENT OF LAND DISTURBING ACTIVITY, AND ONE WEEK PRIOR TO THE FINAL INSPECTION.
- 3. ALL EROSION AND SEDIMENT CONTROL MEASURES ARE TO BE PLACED PRIOR TO OR AS THE FIRST STEP IN CLEARING.
- 4. A COPY OF THE APPROVED EROSION AND SEDIMENT CONTROL PLAN SHALL BE MAINTAINED ON THE SITE AT ALL TIMES.
- 5. PRIOR TO COMMENCING LAND DISTURBING ACTIVITIES IN THE AREAS OTHER THAN INDICATED ON THESE PLANS (INCLUDING, BUT NOT LIMITED TO, OFF-SITE BORROW OR WASTE AREAS), THE CONTRACTOR SHALL SUBMIT A SUPPLEMENTARY EROSION AND SEDIMENT CONTROL PLAN TO THE OWNER FOR REVIEW AND APPROVAL BY THE PLAN APPROVING AUTHORITY.
- 6. THE CONTRACTOR IS RESPONSIBLE FOR INSTALLATION OF ANY ADDITIONAL EROSION AND SEDIMENT CONTROL MEASURES NECESSARY TO PREVENT EROSION AND SEDIMENTATION AS DETERMINED BY THE PLAN APPROVING AUTHORITY.
- 7. ALL DISTURBED AREAS ARE TO DRAIN TO APPROVED SEDIMENT CONTROL MEASURES AT ALL TIMES DURING LAND DISTURBING ACTIVITIES AND DURING SITE DEVELOPMENT UNTIL FINAL STABILIZATION IS ACHIEVED.
- 8. DURING DEWATERING OPERATIONS, WATER WILL BE PUMPED INTO AN APPROVED FILTERING DEVICE.
- 9. THE CONTRACTOR SHALL INSPECT ALL EROSION AND SEDIMENT CONTROL MEASURES PERIODICALLY AND AFTER EACH RUNOFF-PRODUCING RAINFALL EVENT. ANY NECESSARY REPAIRS OR CLEANUP TO MAINTAIN THE EFFECTIVENESS OF THE EROSION CONTROL DEVICES SHALL BE MADE IMMEDIATELY.
- 10. ALL BIOFILTERS SHALL BE KEPT OFF-LINE UNTIL CONSTRUCTION IS COMPLETED AND ALL AREAS HAVE BEEN PROPERLY STABILIZED. THIS SHALL BE ACHIEVED BY USING INLET PROTECTION AT THE CURB CUTS AND STORMWATER CATCH BASINS LEADING DIRECTLY INTO THE BIOFILTERS.
- 11. ALL TEMPORARY EROSION AND SEDIMENT CONTROL MEASURES SHALL BE REMOVED WITHIN 30 DAYS AFTER FINAL SITE STABILIZATION OR AFTER THE TEMPORARY MEASURES ARE NO LONGER NEEDED.

#### PRE-STORM EROSION & SEDIMENTATION CHECKLIST:

PER GENERAL EROSION AND SEDIMENT CONTROL NOTE 6, THE CONTRACTOR IS RESPONSIBLE FOR THE INSTALLATION AND MAINTENANCE OF ANY ADDITIONAL EROSION AND SEDIMENT CONTROL (ESC) MEASURES NECESSARY TO PREVENT EROSION AND SEDIMENTATION AS DETERMINED BY THE COUNTY. THESE SUPPLEMENTARY PRACTICES ARE IN ADDITION TO THOSE SHOWN IN AN EROSION AND SEDIMENT CONTROL PLAN. EROSION AND SEDIMENT CONTROL PRACTICES SHALL BE MODIFIED AS NEEDED TO ENSURE ONLY CLEAR WATER IS DISCHARGED FROM THE SITE.

THE FOLLOWING ACTIONS SHALL BE TAKEN PRIOR TO STORM EVENTS WITH PREDICTED HEAVY AND/OR LARGE VOLUME RAINFALL TO PREVENT SEDIMENT DISCHARGES FROM A CONSTRUCTION SITE. A TYPICAL SUMMER THUNDERSTORM IS AN EXAMPLE OF A STORM EVENT WITH PREDICTED HEAVY AND/OR LARGE VOLUME RAINFALL.

- 1. PERIMETER CONTROLS
- a. SILT FENCE SHALL BE CHECKED FOR UNDERMINING, HOLES, OR DETERIORATION OF THE FABRIC. FENCING SHALL BE REPLACED IMMEDIATELY IF THE FABRIC IS DAMAGED OR WON. SILT FENCE MUST BE TRENCHED INTO THE GROUND PER STATE SPECIFICATIONS (VESCH STD & SPEC 3.09).
- b. WOODEN STAKES OR STEEL POSTS SHALL BE PROPERLY SECURED UPRIGHT INTO THE GROUND. DAMAGED POSTS OR STAKES MUST BE REPLACED c. SEDIMENT THAT HAS ACCUMULATED AGAINST THE SILT FENCE SHALL BE REMOVED. ACCUMULATED SEDIMENT MUST BE REMOVED WHEN THE
- LEVEL REACHES ONE-HALF THE HEIGHT OF THE FENCING. d. HAY BALES OR A STONE BERM SHALL BE PLACED ACROSS THE CONSTRUCTION ENTRANCE TO PREVENT SEDIMENT FROM LEAVING THE CONSTRUCTION SITE.

#### 2. EXPOSED SLOPES AND SOIL

a. EXPOSED SLOPES NOT AT THE FINAL STABILIZATION PHASE SHALL BE COVERED WITH TARPS, PLASTIC SHEETING, OR EROSION CONTROL MATTING. COVERING MATERIAL SHALL BE PROPERLY SECURED/ANCHORED.

b. CONTROLS SHALL BE INSTALLED TO PREVENT CONCENTRATED FLOW DOWN AN EXPOSED SLOPE. BERMS OR DIVERSION DIKES SHALL BE

- INSTALLED AT THE TOP OF CUT/EXPOSED SLOPES TO DIRECT STORM FLOW AROUND THE DISTURBED AREA. c. EXPOSED SLOPES AT THE FINAL STABILIZATION PHASE SHALL BE STABILIZED USING SLOPE STABILIZATION PRACTICES SUCH AS SOIL STABILIZATION BLANKETS OR MATTING AS SPECIFIED IN THE VIRGINIA EROSION AND SEDIMENT CONTROL HANDBOOK (VESCH STD & SPEC 3.36).
- BLANKETS OR MATS MUST BE PROPERLY SECURED AND ANCHORED TO THE SLOPE USING STAPLES, PINS, OR STAKES. d. SEEDED AREAS SHALL BE CHECKED AND RESEEDED AS NECESSARY TO COVER EXPOSED SOIL. RECENTLY SEEDED AREAS SHALL BE PROTECTED BY STRAW OR SOIL STABILIZATION BLANKETS TO PREVENT SEEDING FROM BEING WASHED AWAY

#### 3. STOCKPILES

- a. STOCKPILED SOIL AND OTHER LOOSE MATERIALS THAT CAN BE WASHED AWAY SHALL BE COVERED WITH A TARP, PLASTIC SHEETING, OR OTHER STABILIZATION MATTING. THE COVER MUST BE PROPERLY SECURED/ANCHORED DOWN TO PREVENT IT FROM BEING BLOWN OFF AND EXPOSING MATERIALS TO RAIN. CONTROLS SUCH AS HAY BALES OR BOOMS SHALL BE PLACED ALONG THE PERIMETER OF THE STOCKPILE (DOWNHILL SIDE) 4. INLET PROTECTION
- a. INLET PROTECTION CONTROLS SHALL BE INSPECTED TO ENSURE THEY ARE FUNCTIONING PROPERLY AND FLOODING WILL NOT OCCUR CLOGGED OR DAMAGED CONTROLS MUST BE REPLACED IMMEDIATELY. ENSURE CONTROLS ALLOW FOR OVERFLOW/BYPASS OF STORMWATER RUNOFF DURING SIGNIFICANT STORM EVENTS.

#### IN ADDITION TO THESE PRE-STORM ACTIONS, ALL EROSION AND SEDIMENT CONTROL (ESC) MEASURES MUST BE CHECKED DAILY AND AFTER EACH SIGNIFICANT RAINFALL.

- **POLLUTION PREVENTION PLAN NOTES (STORMWATER MANUAL SECTION 2.4)** 1. ONLY THE FOLLOWING NON-STORMWATER DISCHARGES ARE AUTHORIZED BY ARLINGTON COUNTY'S MS4 PERMIT, UNLESS THE STATE WATER CONTROL BOARD, THE VIRGINIA SOIL AND WATER CONSERVATION BOARD (BOARD), OR ARLINGTON COUNTY DETERMINES THE DISCHARGE TO BE A SIGNIFICANT SOURCE OF POLLUTANTS TO SURFACE WATERS:
- a. WATER LINE FLUSHING; LANDSCAPE IRRIGATION; DIVERTED STREAM FLOWS; RISING GROUND WATERS; UNCONTAMINATED GROUND WATER INFILTRATION (AS DEFINED AT 40 CFR 35,2005(20)); UNCONTAMINATED PUMPED GROUND WATER; DISCHARGES FROM POTABLE WATER SOURCES; FOUNDATION DRAINS; AIR CONDITIONING CONDENSATION; IRRIGATION WATER; SPRINGS; WATER FROM CRAWL SPACE PUMPS; FOOTING DRAINS; LAWN WATERING; INDIVIDUAL RESIDENTIAL CAR WASHING; FLOWS FROM RIPARIAN HABITATS AND WETLANDS; DECHLORINATED SWIMMING POOL DISCHARGES; DISCHARGES OR FLOWS FROM FIREFIGHTING; AND, OTHER ACTIVITIES GENERATING DISCHARGES IDENTIFIED BY THE DEPARTMENT OF ENVIRONMENTAL QUALITY AS NOT REQUIRING VPDES AUTHORIZATION.
- 2. APPROPRIATE CONTROLS MUST BE IMPLEMENTED TO PREVENT ANY NON-STORMWATER DISCHARGES NOT INCLUDED ON THE ABOVE LIST (E.G., CONCRETE WASH WATER, PAINT WASH WATER, VEHICLE WASH WATER, DETERGENT WASH WATER, ETC.) FROM BEING DISCHARGED INTO ARLINGTON COUNTY'S MS4 SYSTEM, WHICH INCLUDES THE CURB AND GUTTER SYSTEM, AS WELL AS CATCH BASINS AND OTHER STORM DRAIN INLETS, OR STREAM
- 3. PER CHAPTER 26 OF THE ARLINGTON COUNTY CODE, IT SHALL BE UNLAWFUL FOR ANY PERSON TO DISCHARGE DIRECTLY OR INDIRECTLY INTO THE STORM SEWER SYSTEM OR STATE WATERS, ANY SUBSTANCE LIKELY, IN THE OPINION OF THE COUNTY MANAGER, TO HAVE AN ADVERSE EFFECT ON THE STORM SEWER SYSTEM OR STATE WATERS.

- **UTILITY INSTALLATION:** UNDERGROUND UTILITY LINES SHALL BE INSTALLED IN ACCORDANCE WITH THE FOLLOWING STANDARDS IN ADDITION TO OTHER APPLICABLE CRITERIA
- 1. NO MORE THAN 100 LINEAR FEET OF TRENCH MAY BE OPENED AT ONE TIME.
- 2. EXCAVATED MATERIAL SHALL BE PLACED ON THE UPHILL SIDE OF TRENCHES. 3. EFFLUENT FROM DEWATERING OPERATIONS SHALL BE FILTERED OR PASSED THROUGH AN APPROVED SEDIMENT TRAPPING DEVICE, OR BOTH, AND
- DISCHARGED IN A MANNER THAT DOES NOT ADVERSELY AFFECT FLOWING STREAMS OR OFF-SITE PROPERTY 4. MATERIAL USED FOR BACKFILLING TRENCHES SHALL BE PROPERLY COMPACTED IN ORDER TO MINIMIZE EROSION AND PROMOTE STABILIZATION.
- 5. STABILIZATION SHALL BE ACCOMPLISHED IN ACCORDANCE WITH THESE REGULATIONS. 6. APPLICABLE SAFETY REGULATIONS SHALL BE COMPLIED WITH.
- 9. ANY DISTURBED AREA NOT COVERED BY NOTE #1 ABOVE AND PAVED, SODDED OR BUILT UPON BY NOVEMBER 1ST, OR DISTURBED AFTER THAT DATE, SHALL BE MULCHED WITH HAY OR STRAW AT THE RATE OF 2 TONS PER ACRE AND OVER-SEEDED NO LATER THAN MAY 15TH.
- 10. AT THE COMPLETION OF THE CONSTRUCTION PROJECT AND PRIOR TO BOND RELEASE, ALL TEMPORARY SEDIMENT CONTROLS SHALL BE REMOVED AND ALL DENUDED AREAS SHALL BE STABILIZED. ARLINGTON COUNTY INSPECTOR TO APPROVE REMOVAL OF ALL TEMPORARY SILTATION MEASURES.

#### **MAINTENANCE PROGRAM:**

- THE FOLLOWING IS A PROGRAM OF MAINTENANCE FOR THE MECHANICAL CONTROLS SPECIFIED IN THIS NARRATIVE AND ON THE PLAN:
- 1. THE SITE SUPERINTENDENT OR HIS/HER REPRESENTATIVE SHALL MAKE A VISUAL INSPECTION OF ALL MECHANICAL CONTROLS AND NEWLY STABILIZED AREA (I.E. SEEDED AND MULCHED AND/OR SODDED AREAS) ON A DAILY BASIS; ESPECIALLY AFTER A HEAVY RAINFALL EVENT TO ENSURE THAT ALL CONTROLS ARE MAINTAINED AND PROPERLY FUNCTIONING. ANY DAMAGED CONTROLS SHALL BE REPAIRED PRIOR TO THE END OF THE WORK DAY INCLUDING RE-SEEDING AND MULCHING OR RE-SODDING IF NECESSARY.
- 2. ALL SEDIMENT TRAPPING DEVICES SHALL BE CLEARED OUT AT 50% TRAP CAPACITY AND THE SEDIMENT SHALL BE DISPOSED OF BY SPREADING ON THE SITE OR IF NOT SUITABLE FOR FILL, HAULING AWAY AND DEPOSITING AT AN ACCEPTABLE DUMP SITE.
- 3. THE CONTRACTOR SHALL TAKE SPECIAL CARE TO PREVENT MUD AND/OR OTHER DEBRIS FROM BEING ENTERED ONTO EXISTING SWM/BMP FACILITIES OR DOWNSTREAM WATER WAYS. SHOULD OFF-SITE AREAS BECOME POLLUTED BY CONSTRUCTION ACTIVITIES, THE CONTRACTOR SHALL BE RESPONSIBLE FOR CLEANING THE AFFECTED AREAS TO THE SATISFACTION OF THE INSPECTOR.

REMAINING DENUDED AREAS SHALL BE STABILIZED. CERTAIN DEVICES MAY BE REMOVED PRIOR TO CONSTRUCTION COMPLETION BUT ONLY WITH

THE APPROVAL OF THE COUNTY INSPECTOR. 5. AFTER CONSTRUCTION OPERATIONS HAVE ENDED, ALL DISTURBED AREAS SHALL BE STABILIZED. UPON APPROVAL OF THE COUNTY INSPECTOR, MECHANICAL SEDIMENT CONTROLS SHALL BE REMOVED AND THE GROUND PERMANENTLY STABILIZED WITH VEGETATION WITHIN 30 DAYS.

4. AT THE COMPLETION OF CONSTRUCTION AND PRIOR TO BOND RELEASE, ALL TEMPORARY SEDIMENT CONTROLS SHALL BE REMOVED AND ANY




**VIRGINIA** DEPARTMENT OF

ENVIRONMENTAL SERVICES **FACILITIES & ENGINEERING DIVISION** ENGINEERING BUREAU 2100 CLARENDON BOULEVARD, SUITE 813 ARLINGTON, VA 22201

PHONE: 703.228.3629

FAX: 703.228.3606

COPYRIGHT © 2016 ARLINGTON COUNTY

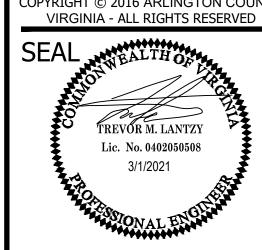

**APPROVALS** OUALITY CONTROL ENGINEER Kamal N. Taktak CONSTRUCTION MANAGEMENT SUPERVISOR WATER, SEWER, STREETS BUREAU CHIEF

PROJECT MANAGER **REVISIONS** 

Dennis M. Leach

TRANSPORTATION DIRECTOR

Sicel Yang

SOUTH OTI

ONTR TRE S S **8**T  $\triangleleft$   $\blacksquare$ O<sub>S</sub>

DESIGNED: NS DRAWN: NS CHECKED: TL MISS UTILITY TRANSMITTAL #: XXXX

CC20-220-E\_AND\_S\_NOTES\_SWPPP.DWG PATH: Q:\DATA\CC20\DESIGN\CAD\\_ACTIVE PLOTTED: MARCH 1 2021

PLOTTED BY:NSHARP


FILENAME:


SCALE:


C032.1

COPYRIGHT © 2016 ARLINGTON COUNTY VIRGINIA - ALL RIGHTS RESERVED

**18TH STREET SOUTH** 

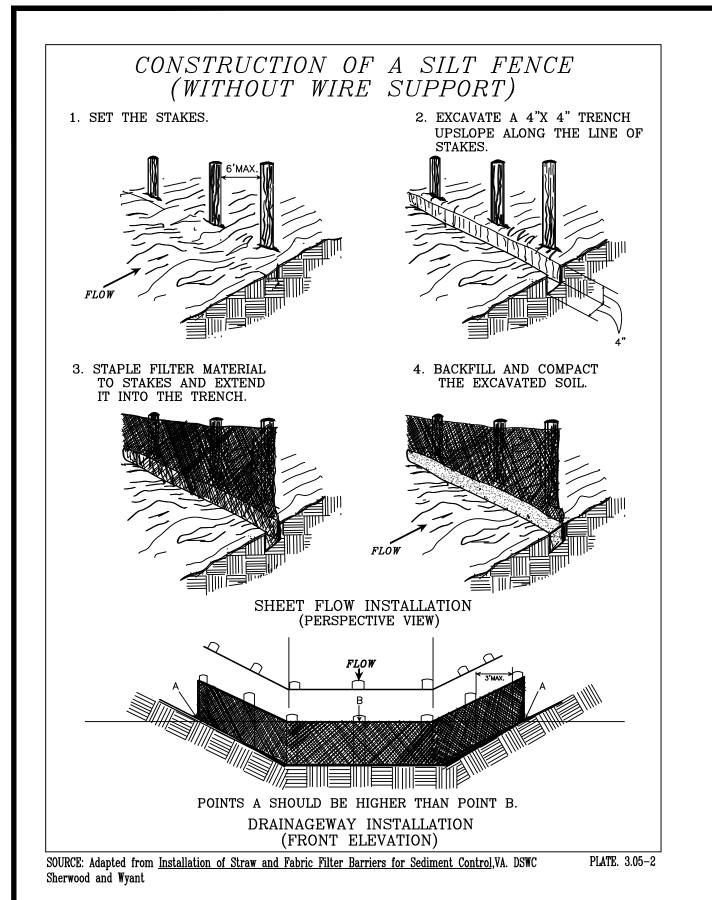

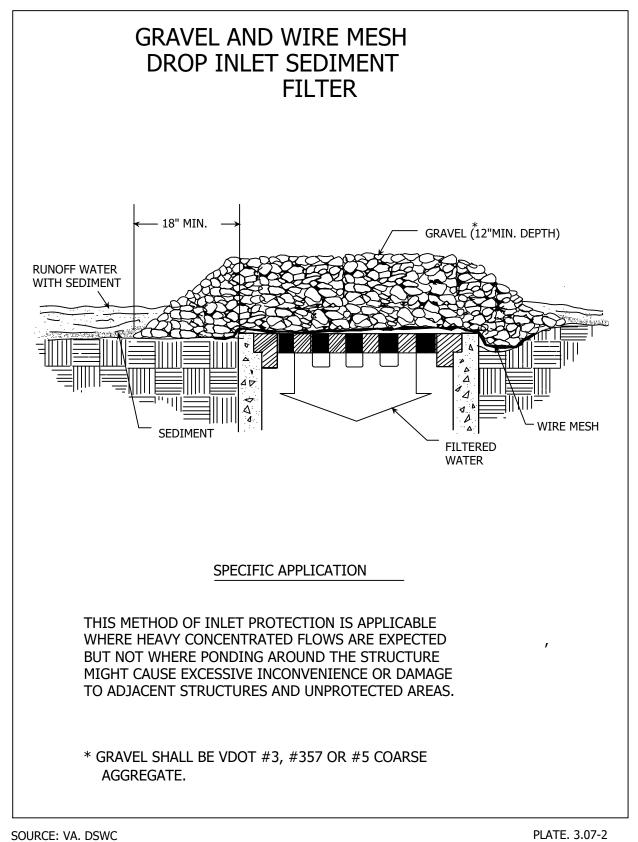

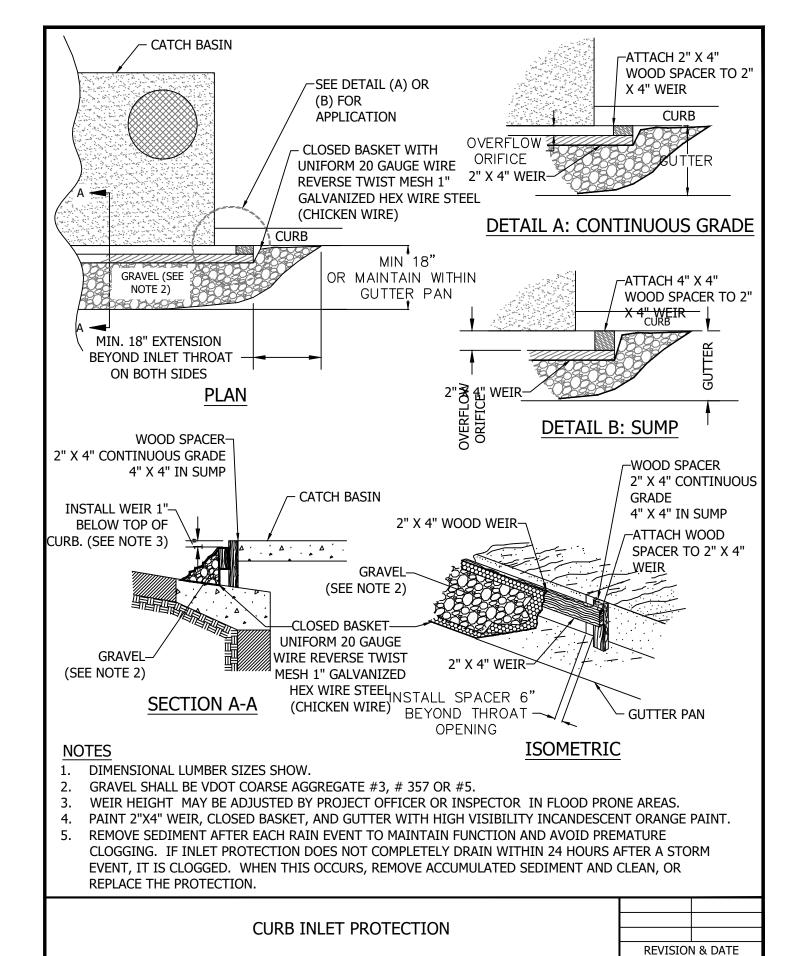


ARLINGTON COUNTY, VIRGINIA


DEPARTMENT OF ENVIRONMENTAL SERVICES


ARLINGTON


DRAWING NO.


3.07-7 (ACG)

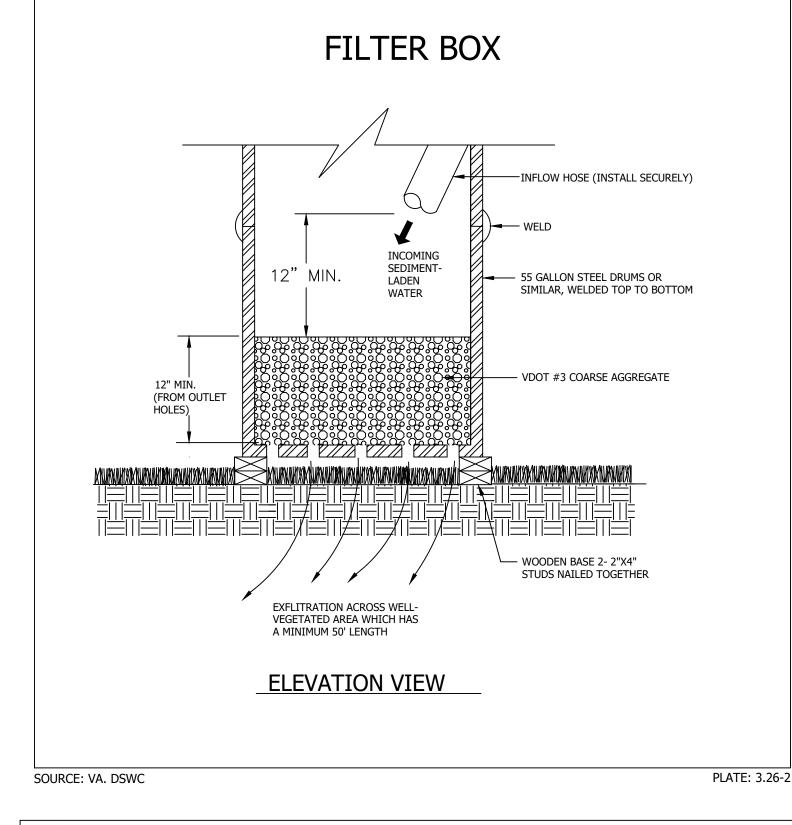


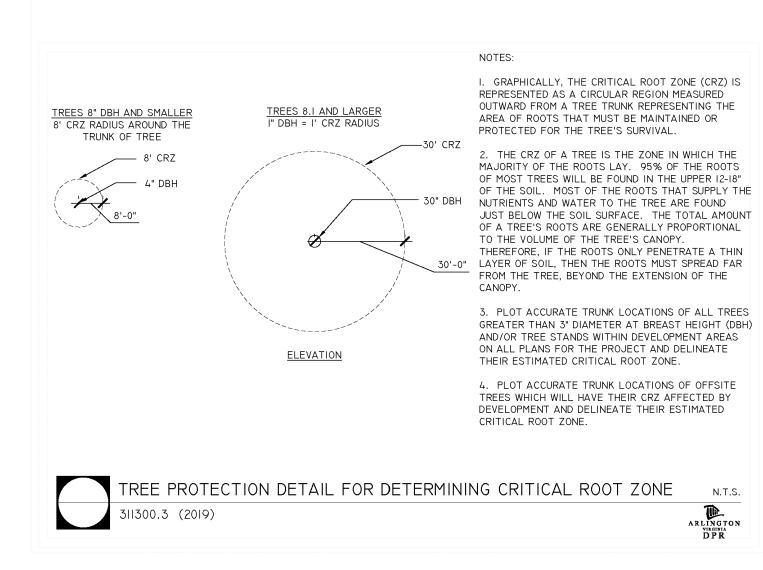


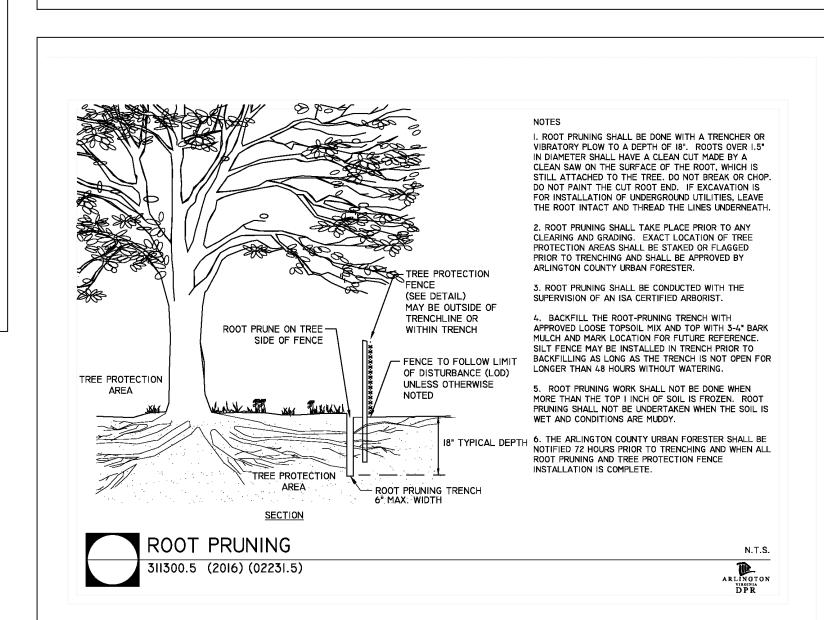


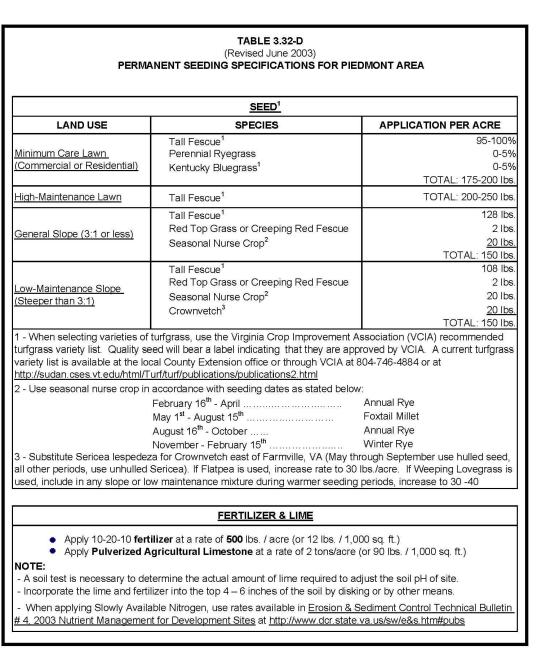


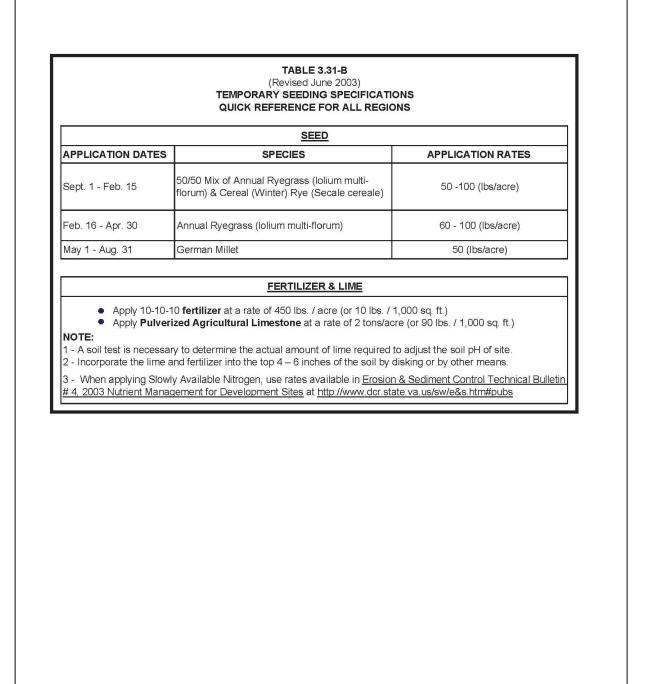

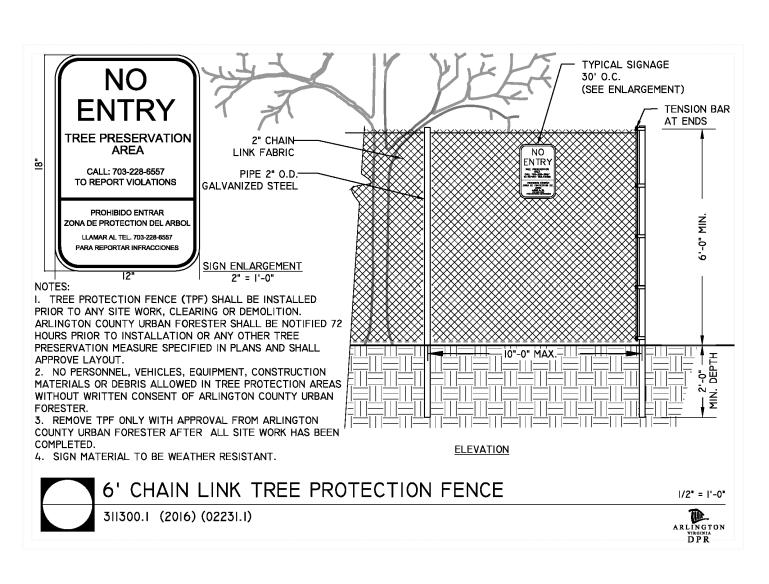

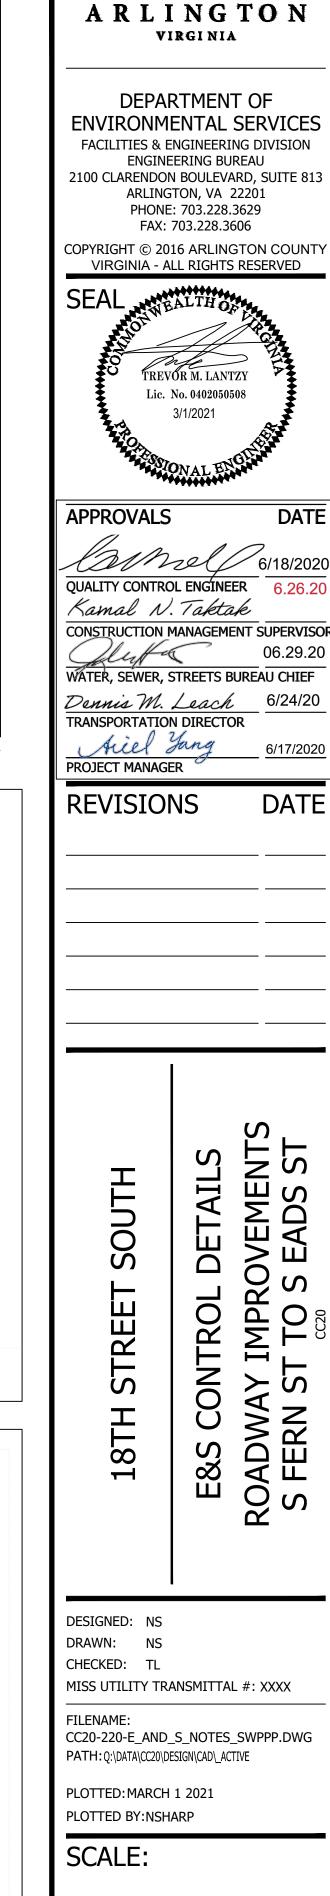

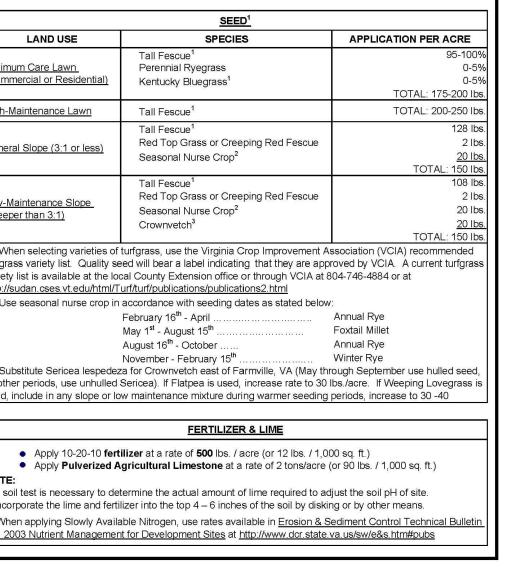

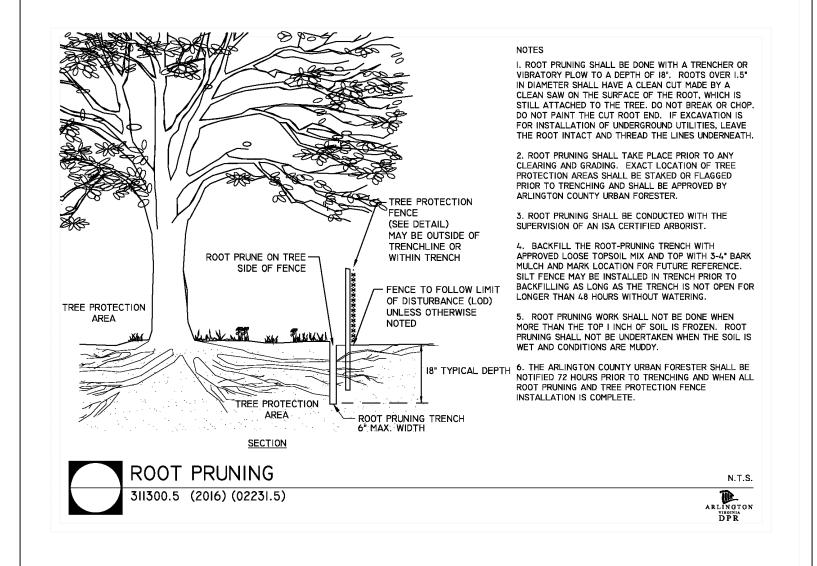

COPYRIGHT © 2016 ARLINGTON COUNTY VIRGINIA - ALL RIGHTS RESERVED

C032.2

SHEET

	date
o:	
Qianqian L ESC Progra	ı, P.E. ım Administrator
Departmen	of Environmental Sevices
	ndon Boulevard, Suite 813 Virginia 22201
Armigion,	7 i gnia 22201
Re: Erosio	n and Sediment Control Permit Application for:
CC20 - 18	Sth Street South
street addr	255
between !	S Fern St. & S Eads St.
	ection subdivision
LDA19235	
permit num	ber
Dear Mrs. 1	i.
Dear Wils.	J1.
3. 4. 5. 6. 7. I may be re	Walking the site prior to construction to identify critical areas.  Conducting a pre-construction briefing with earth moving and site contractors to present the E&S plan and highlight the presence of critical areas, the limits of clearing and the required E&S controls and tree protection measures to be installed. Call 703-228-0760 to schedule pre-construction meeting.  Regularily inspecting the site during construction to ensure that all E&S controls are functioning and are adequate to address erosion and sedimentation. Inspect the site 48 hours after a runoff-generating storm, and provide a copy of the inspection findings to the county.  Reporting to the owner the presence inadequate or non functioning E&S controls when they are observed. Ensuring that temporary soil stabilization is applied within 7 days to areas denuded that will remain undisturbed for longer than 14 days. Permanent stabilization shall be applied to areas that are to be left dorn for more than one year.  Calling (703) 228-0760 at least 80 hours before demolishing any structure.  ached at 703-228-0596 with questions about this plan or my execution of the duties of telephone number.
Sincerely,	
The same of the same of	
Jana d	
agned	
Trevor La	an and a state of the state of
name print	2050508
name print	

RESPONSIBLE LAND DISTURBER LETTER FOR PERMITTING PURPOSES ONLY. CONTRACTOR TO SIGN AND SUPPLY ONE PRIOR TO THE START OF CONSTRUCTION.

				Polluta	ante							
Pollutant-Generating Activity	Likely Present at your Project Site?	Sediment	Nutrients	Heavy Metals	pH (acids and bases)	Pesticides & Herbicides	Oil & Grease	Bacteria & Viruses	Trash, Debris, Solids	Other Toxic Chemicals	Pollution Prevention Practice	Responsible Party
Clearing, grading, excavating, and un-stabilized areas	⊠ Yes □ No	x							x		(1)	
Paving operations	⊠ Yes □ No	х					х		х		(2)	
Concrete washout and cement waste	⊠ Yes □ No			х	х				х		(3)	
Structure construction, stucco, painting, and cleaning	☐ Yes ⊠ No			х	х				х	Х	(4)	
Dewatering operations	⊠ Yes □ No	х	Х						х		(5)	
Material delivery and storage	⊠ Yes □ No	х	Х	Х	х		Х		х	Х	(6)	Construction Activity Operator (See Cover Page of this SWPPP
Material use during building process	☐ Yes ⊠ No		Х	Х	х		Х		х	Х	(7)	rage of this Swerr
Solid waste disposal	⊠ Yes □ No								х	Х	(8)	
Sanitary waste	☐ Yes ⊠ No		Х		х			Х			(9)	
Landscaping operations	⊠ Yes □ No	х	Х			х			х	Х	(10)	
Others [describe]	☐ Yes ☐ No	[X]	[X]	[X]	[X]	[X]	[X]	[X]	[X]	[X]	(11)	

# STORMWATER POLLUTION PREVENTION PLAN CC20 - 18th Street South

**Pollution Prevention Practices:** 

of stormwater from construction activities.

ammability and mixing of chemicals.

6.0 Stormwater Management Controls

that apply

Arlington County – SWPPP 9/2016

(11) Others – If applicable, describe your Pollution Prevention Practice.

Stormwater Management Control

Post-development Stormwater Management Controls

provided by a

Larger Common Plan of Development or Sale

Rooftop Disconnection

Sheet flow to Vegetated Filter (1 or 2)

Grass Channel

Rainwater Harvesting

Permeable Pavement (1 or 2)

STORMWATER POLLUTION PREVENTION PLAN (SWPPP) COVER PAGE	
For Construction Activities At:	
CC20 – 18 <sup>th</sup> Street South  Between S Fern St and S Eads St  Arlington, VA 22202	
Latitude: 38.8572 N (decimal degrees)	
Longitude: -77.0545 W (decimal degrees)	
Construction Activity Operator:	
Insert Company/Organization Name Insert Name Insert Address Insert City, State, Zip Code Insert Telephone Number Insert Email Address Insert 24-hour Emergency Contact	
SWPPP Preparation Date:	
January 21, 2019	
CERTIFICATION	
"I certify under penalty of law that I have read and understand this document and that this document and all attachments were prepared in accordance with a system designed to assure that qualified personnel properly gathered and evaluated the information submitted. Based on my inquiry of the person or persons who manage the system, or those persons directly responsible for gathering the information, the information submitted is, to the best of my knowledge and belief, true, accurate, and complete. I am aware that there are significant penalties for submitting false information, including the possibility of fine and imprisonment for knowing violations."	
Operator Name:	
Title:	
Signature:	
Date:	
Arlington County – SWPPP 9/2016	

sediment laden or turbid runoff from leaving the construction site. Dispose of clearing debris at acceptable

disposal sites. Apply permanent or temporary stabilization, sodding and/or mulching to denuded areas in

accordance with the erosion and sediment control specifications and the general VPDES permit for discharges

Paving operations – Cover storm drain inlets during paving operations and utilize pollution prevention materials such as drip pans and absorbent/oil dry for all paving machines to limit leaks and spills of paving materials and

settling basin that is designed so that no overflows can occur due to inadequate sizing or precipitation. Hardened

concrete wastes shall be removed and disposed of in a manner consistent with the handling of other

quality and OSHA regulations. Mix paint indoors, in a containment area or in a flat unpaved area. Prevent the

discharge of soaps, solvents, detergents and wash water from construction materials, including the clean-up of stucco paint, form release oils and curing compounds.

Dewatering operations – Construction site dewatering from building footings or other sources may not be

discharged without treatment. Sediment laden or turbid water shall be filtered, settled or similarly treated prior

Material delivery and storage - Designate areas of the construction site for material delivery and storage.

Material use during building process – Use materials only where and when needed to complete the construction activity. Follow manufacturer's instructions regarding uses, protective equipment, ventilation,

(8) Solid waste disposal – Designate a waste collection area on the construction site that does not receive a substantial amount of runoff from upland areas and does not drain directly to a waterway. Ensure that

(10) Landscaping operations - Maintain as much existing vegetation as practicable. Apply permanent or

Apply nutrients in accordance with manufacturer's recommendations and not during rainfall events.

whenever possible. Schedule waste collection to prevent the containers from overfilling.

sanitary facilities. Locate sanitary facilities in a convenient location away from waterways.

Place near construction entrances, away from waterways, and avoid transport near drainage paths or

containers have lids so they can be covered before periods of rain, and keep containers in a covered area

temporary stabilization, sodding and/or mulching to denuded areas in accordance with the erosion and sediment

control specifications and the general VPDES permit for discharges of stormwater from construction activities.

Installation Date

Party

Common Plan

Construction

Activity Operator

**Activity Operator** 

(See Cover Page of this SWPPP)

Sanitary waste - Prevent the discharge of sanitary waste by providing convenient and well-maintained portable

(3) Concrete washout and cement waste – Direct concrete wash water into a leak-proof container or leak-proof

(4) Structure construction, stucco, painting and cleaning – Enclose, cover or berm building material storage areas if susceptible to contaminated stormwater runoff. Conduct painting operations consistent with local air

STORMWATER POLLUTION PREVENTION PLAN

CC20 - 18th Street South

#### Construction General Permit Pollution Prevention Plan Erosion & Sediment Control Plan (or agreement in lieu of) Stormwater Management Plan 2.0 Authorized Non-Stormwater Discharges Type of Authorized Non-Stormwater Discharge External buildings wash down Uncontaminated foundation or footing drains Uncontaminated excavation dewatering Landscape irrigation Others [describe] 3.0 Pollution Prevention Awareness 4.0 Erosion & Sediment Controls Erosion & Sediment Control Installation that apply Construction Entrance (Std. & Spec. 3.02) $\boxtimes$ (Std. & Spec. 3.05) Culvert Inlet Protectio (Std. & Spec. 3.08) (Std. & Spec. 3.18) Temporary Seeding As required $\boxtimes$ NA (Std. & Spec. 3.31) by 3.31 Permanent Seeding NA (Std. & Spec. 3.32) NA (Std. & Spec. 3.33) NA (Std. & Spec. 3.35) (Std. & Spec 3.01) Storm Drain Inlet Protection (Std. & Spec 3.08) Arlington County – SWPPP 9/2016

# 1.0 SWPPP Documents Located Onsite & Available for Review Located Onsite & Available for Review? SWPPP Document Type Registration Statement Notice of Coverage Letter Likely Present at Your Project Site? Employees will be given a "walk through" of the site identifying areas of possible pollution and will be shown Erosion and Sediment Controls and Pollution Prevention Practices (identified in Sections 4.0 and 5.0 of this SWPPP) that are applicable to their assigned job duties. A refresher meeting and "walk through" will be conducted on an as needed Construction Activity Operator (See Cover Page of this SWPPP)

Stormwater Management Control

Infiltration (1 or 2)

Bioretention (1 or 2)

Others [describe]

Exempted

Protect equipment and property
Protect the environment

Stop spill from spreading (use absorbent or other material)

Most spills can be cleaned up following manufacturer specifications. Absorbent/oil dry, sealable containers, plastic

1. Check for hazards (flammable material, noxious fumes, cause of spill) - if flammable liquid, turn off engines and nearby electrical equipment. If serious hazards are present leave the area and call 911. LARGE SPILLS ARE LIKELY TO PRESENT A HAZARD.

2. Make Sure the spill area is safe to enter and that it does not pose an immediate threat to health or safety of

Call co-workers and supervisor for assistance and to make them aware of the spill and potential dangers.

8. Clean up spilled material according to manufacturer specifications, for liquid spills use absorbent materials

9. Properly dispose of cleaning materials and used absorbent material according to manufacturer specifications.

If possible, stop spill from entering drains (use absorbent or other material as necessary).

If spilled material has entered a storm sewer; contact locality's storm water department.

bags, and shovels/brooms are suggested minimum spill response items that should be available at this location.

2<sup>nd</sup> Priority:

3<sup>rd</sup> Priority:

7.0 Spill Prevention & Response

any person.
3. Stop the spill source.

Emergency Contacts:

**Normal Working Hours** 

Local Contacts

DEQ Northern Regional Office

Nights, Holidays & Weekends

Arlington County Fire & Police

Washington Gas Emergency

VA Dept. of Emergency Management 24 Hour Reporting Service

Arlington County – SWPPP 9/2016

DES Water, Sewer, Streets 24-Hour Emergency

and do not flush area with water.

# STORMWATER POLLUTION PREVENTION PLAN

STORMWATER POLLUTION PREVENTION PLAN

NA

703-583-3800

804-674-2400

703-228-6555

703-750-1400

Estimated Responsible


Party


Activity Operator


(See Cover Page

NA

of this SWPPP)

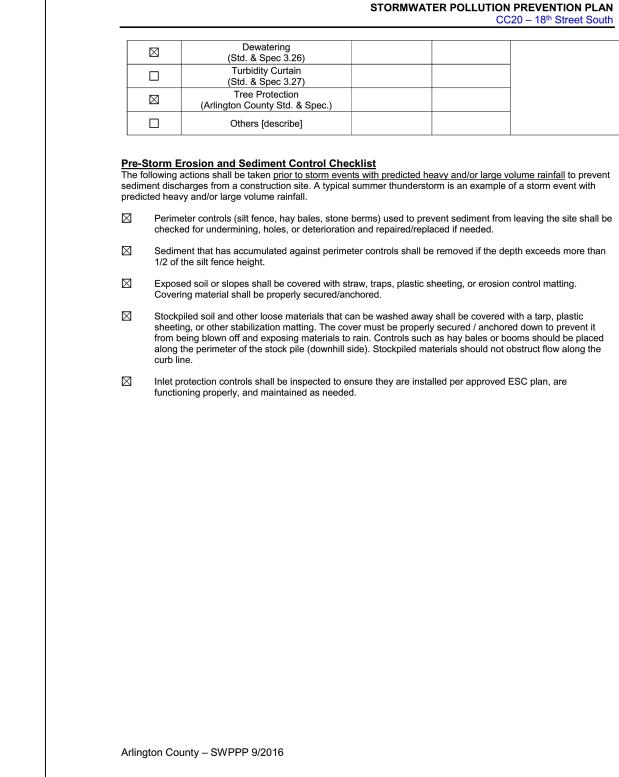

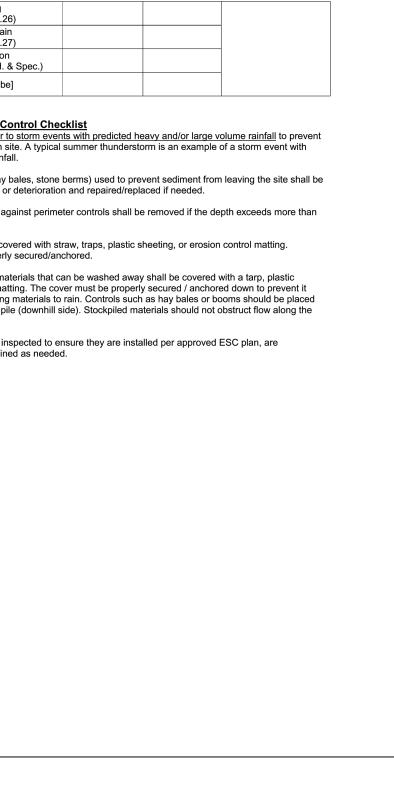

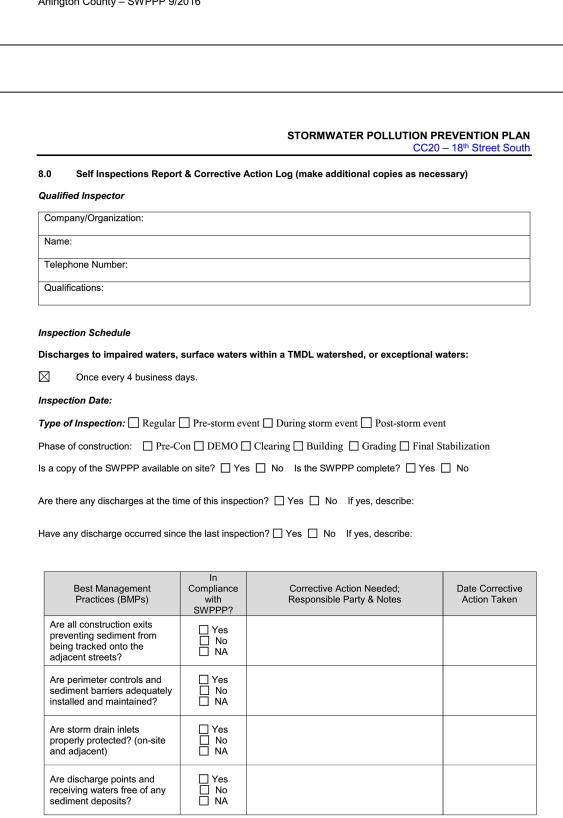

Best Management Practices (BMPs)	In Compliance with SWPPP?	Corrective Action Needed; Responsible Party & Notes	Date Corrective Action Taken
Are all construction exits preventing sediment from being tracked onto the adjacent streets?	☐ Yes ☐ No ☐ NA		
Are perimeter controls and sediment barriers adequately installed and maintained?	☐ Yes ☐ No ☐ NA		
Are storm drain inlets properly protected? (on-site and adjacent)	☐ Yes ☐ No ☐ NA		
Are discharge points and receiving waters free of any sediment deposits?	☐ Yes ☐ No ☐ NA		

Arlington County – SWPPP 9/2016

	ENVIRONMENTAL SE FACILITIES & ENGINEERING I ENGINEERING BUREA	DIVISION
	2100 CLARENDON BOULEVARD, ARLINGTON, VA 2220 PHONE: 703.228.3629 FAX: 703.228.3606	SUITE 813 1
	COPYRIGHT © 2016 ARLINGTO VIRGINIA - ALL RIGHTS RES	
	SEAL WEALTHON	
	TREVOR M. LANTZY Lic. No. 0402050508 3/1/2021	
	TONAL ENGINE	
	APPROVALS	DATE
	Camel/	6/18/2020
	QUALITY CONTROL ENGÍNEER	6.26.20
	Kamal N. Taktak	0.20.20
	Kamal N. Taktak CONSTRUCTION MANAGEMENT	
		SUPERVISOR 06.29.20
	CONSTRUCTION MANAGEMENT	SUPERVISOR 06.29.20 AU CHIEF
	CONSTRUCTION MANAGEMENT  Construction Manageme	SUPERVISOR 06.29.20 AU CHIEF
	CONSTRUCTION MANAGEMENT  Construction Management  Construction Management  Water, Sewer, Streets Bure  Dennis M. Leach  TRANSPORTATION DIRECTOR  Aiel Yang	SUPERVISOR 06.29.20 AU CHIEF 6/24/20
	CONSTRUCTION MANAGEMENT  WATER, SEWER, STREETS BURE  Dennis M. Leach  TRANSPORTATION DIRECTOR  Aiel Yang  PROJECT MANAGER	SUPERVISOR 06.29.20 AU CHIEF 6/24/20 6/17/2020
	CONSTRUCTION MANAGEMENT  WATER, SEWER, STREETS BURE  Dennis M. Leach  TRANSPORTATION DIRECTOR  Aiel Yang  PROJECT MANAGER	SUPERVISOR 06.29.20 AU CHIEF 6/24/20 6/17/2020

VIRGINIA

DEPARTMENT OF

S, S ррр IPROVI STORMWATER ΣĽ

DWAY ERN S A I O<sub>S</sub>

DESIGNED: NS DRAWN: NS CHECKED: TL MISS UTILITY TRANSMITTAL #: XXXX

FILENAME: CC20-220-E\_AND\_S\_NOTES\_SWPPP.DWG PATH: Q:\DATA\CC20\DESIGN\CAD\\_ACTIVE

PLOTTED: MARCH 1 2021

SOUTH

TRE

**18TH** 

PLOTTED BY:NSHARP

SCALE:

SHEET C035.1

COPYRIGHT © 2016 ARLINGTON COUNTY VIRGINIA - ALL RIGHTS RESERVED

18TH STREET SOUTH

#### STORMWATER POLLUTION PREVENTION PLAN CC20 – 18th Street South

Best Management Practices (BMPs)	In Compliance with SWPPP?	Corrective Action Needed; Responsible Party & Notes	Date Corrective Action Taken
Are all slopes and disturbed areas not actively being worked properly stabilized?	☐ Yes ☐ No ☐ NA		
Are washout facilities (e.g., concrete, paint, stucco) available, clearly marked and maintained?	☐ Yes ☐ No ☐ NA		
Is trash/litter from work areas collected and contained in dumpsters?	☐ Yes ☐ No ☐ NA		
Are non-stormwater discharges (e.g., wash water, dewatering) properly controlled?	☐ Yes ☐ No ☐ NA		
Are natural resources (e.g., streams, wetlands, mature trees) area protected with barriers or similar BMPs?	☐ Yes ☐ No ☐ NA		
Are vehicle and equipment fueling, cleaning and maintenance areas free of spills, leaks, or other deleterious material?	☐ Yes ☐ No ☐ NA		
Are materials that are potential stormwater contaminants stored inside or under cover?	☐ Yes ☐ No ☐ NA		
Are disturbed areas stabilized within 7 days, if areas denuded will remain undisturbed for 14 days?	☐ Yes ☐ No ☐ NA		

Non – Compliance Describe any incidents of non-compliance not described above (use another page is necessary)

#### Certification

"I certify under penalty of law that I have read and understand this document and that this document and all attachments were prepared in accordance with a system designed to assure that qualified personnel properly gathered and evaluated the information submitted. Based on my inquiry of the person or persons who manage the system, or those persons directly responsible for gathering the information, the information submitted is, to the best of my knowledge and belief, true, accurate, and complete. I am aware that there are significant penalties for submitting false information, including the possibility of fine and imprisonment for knowing violations."

Operator or Assigned Qualified Personnel Name: \_\_\_\_

Signature: \_\_\_\_\_

Arlington County – SWPPP 9/2016

#### STORMWATER POLLUTION PREVENTION PLAN CC20 – 18th Street South

#### 9.0 Grading & Stabilization Activities Log

Date Grading Activity Initiated	Description of the Grading Activity (including location)	Date Grading Activity Ceased	Date Stabilization Measures Initiated	Description of the Stabilization Measure (including location)

#### 10.0 SWPPP Modification & Update Log

Modification Date	Description of the Modification / Update (name & title that request the modification)	Modification Prepared By (name & title)

Arlington County – SWPPP 9/2016

#### INSTRUCTIONS for COMPLETING the SINGLE FAMILY RESIDENCE, COMMON PLAN of DEVELOPMENT or SALE STORMWATER POLLUTION PREVENTION PLAN (SWPPP)

General
A Stormwater Pollution Prevention Plan (SWPPP) must be developed prior to obtaining locality (e.g., City, County, Town) authorization to commence land disturbance.

SWPPP Cover Page
For a construction activity, enter the project/site name and physical address (if available), including city (or town), state and zip code. Enter the latitude and longitude in decimal degrees of the construction activity.

Enter the Construction Activity Operator's company/organization name, the Operator's name and mailing address, including city (or town), state, and zip code, telephone number, email address (if available), and a 24-hour emergency contact.

The Construction Activity Operator identified on the cover page of the SWPPP is responsible for certifying the information contained therein. Please sign the certification in INK. Please note that state statues require the SWPPP to be signed as follows:

(1) For a corporation: by a responsible corporate officer;

(2) For a partnership or sole proprietorship: by a general partner or the proprietor, respectively;

(3) For a municipality, state, federal, or other public agency: by either a principal executive officer or ranking elected official.

Section 1.0 SWPPP Documents Located Onsite & Available for Review
Utilize the provided checklist to ensure that the required SWPPP documents are located onsite and are available for review, if

Section 2.0 Authorized Non-Stormwater Discharges Identify the authorized non-stormwater discharges likely to be present at the project site. If an unlisted authorized non-stormwater discharge is likely to be present at the project site, provide it here.

Section 3.0 Pollution Prevention Awareness
Provide employees with a "walk through" of the project site and identify areas of possible pollution, erosion and sediment controls,

and pollution prevention practices which are applicable to their assigned job duties. Conduct refresher meetings and perform additional "walk throughs" on an as needed basis.

Section 4.0 Erosion & Sediment Controls Identify the erosion and sediment controls to be implemented at the project site. For each erosion and sediment control, enter the

estimated installation date and estimated removal date. If an unlisted erosion and sediment control will be implemented at the project site, provide the applicable information here.

Section 5.0 Potential Sources of Pollution & Pollution Prevention Practices
Identify the pollutant-generating activities likely to be present at the project site; implement and maintain the corresponding pollution prevention practices. If an unlisted pollutant-generating activity is likely to be present at the project site, describe it, identify the associated pollutant(s), and provide the corresponding pollution prevention practice(s) to be implemented and maintained.

Section 6.0 Stormwater Management Controls Identify the stormwater management controls to be implemented at the project site, if applicable. For each stormwater management control, enter the estimated installation date. If an unlisted stormwater management control will be implemented at the project site, provide the applicable information here.

Section 7.0 Spill Prevention & Response
Most spills can be cleaned up following manufacturer specifications. The priority should be to protect all people, equipment, property, and the environment. Enter the telephone number of your local fire and police departments.

Section 8.0 Inspections & Corrective Action Log
Enter the qualified inspector's company/organization name, the inspector's name, telephone number, and qualifications. Select the applicable inspection type, enter the construction activity inspection date, and enter the date and rainfall amount of the last measurable storm event (if applicable). Identify if the implemented best management practices are in compliance with the SWPPP. Enter corrective actions needed; the party responsible for implementing the corrective actions, and the date corrective actions were taken,

if applicable. Make additional copies of the inspection and corrective action log as necessary. Section 9.0 Grading & Stabilization Activities Log

Enter the date grading activities were initiated, a description of the grading activities including location, the date grading activities ceased, the date stabilization measures were initiated, and a description of the stabilization measures including location.

Section 10.0 SWPPP Modification & Update Log
Enter the SWPPP modification date, description of the SWPPP modification/update, and the name and title of the SWPPP modification preparer, if applicable.


Arlington County – SWPPP 9/2016



DEPARTMENT OF **ENVIRONMENTAL SERVICES** FACILITIES & ENGINEERING DIVISION ENGINEERING BUREAU 2100 CLARENDON BOULEVARD, SUITE 813 ARLINGTON, VA 22201 PHONE: 703.228.3629

COPYRIGHT © 2016 ARLINGTON COUNTY VIRGINIA - ALL RIGHTS RESERVED

FAX: 703.228.3606

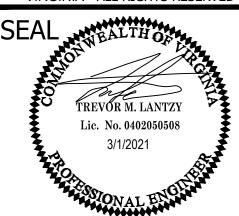

**APPROVALS** 

QUALITY CONTROL ENGINEER 6.26.20 Kamal N. Taktak CONSTRUCTION MANAGEMENT SUPERVISOR

WATER, SEWER, STREETS BUREAU CHIEF Dennis M. Leach 6/24/20

TRANSPORTATION DIRECTOR Aiel Yang PROJECT MANAGER

**REVISIONS** 

SOUTH STREET

'IMPROVEMENTS STORMWATER PPP ADWAY I FERN ST RO, S

DESIGNED: NS DRAWN: NS CHECKED: TL MISS UTILITY TRANSMITTAL #: XXXX


**18TH** 


FILENAME: CC20-220-E\_AND\_S\_NOTES\_SWPPP.DWG PATH: Q:\DATA\CC20\DESIGN\CAD\\_ACTIVE

PLOTTED: MARCH 1 2021 PLOTTED BY:NSHARP


SCALE:


SHEET C035.2

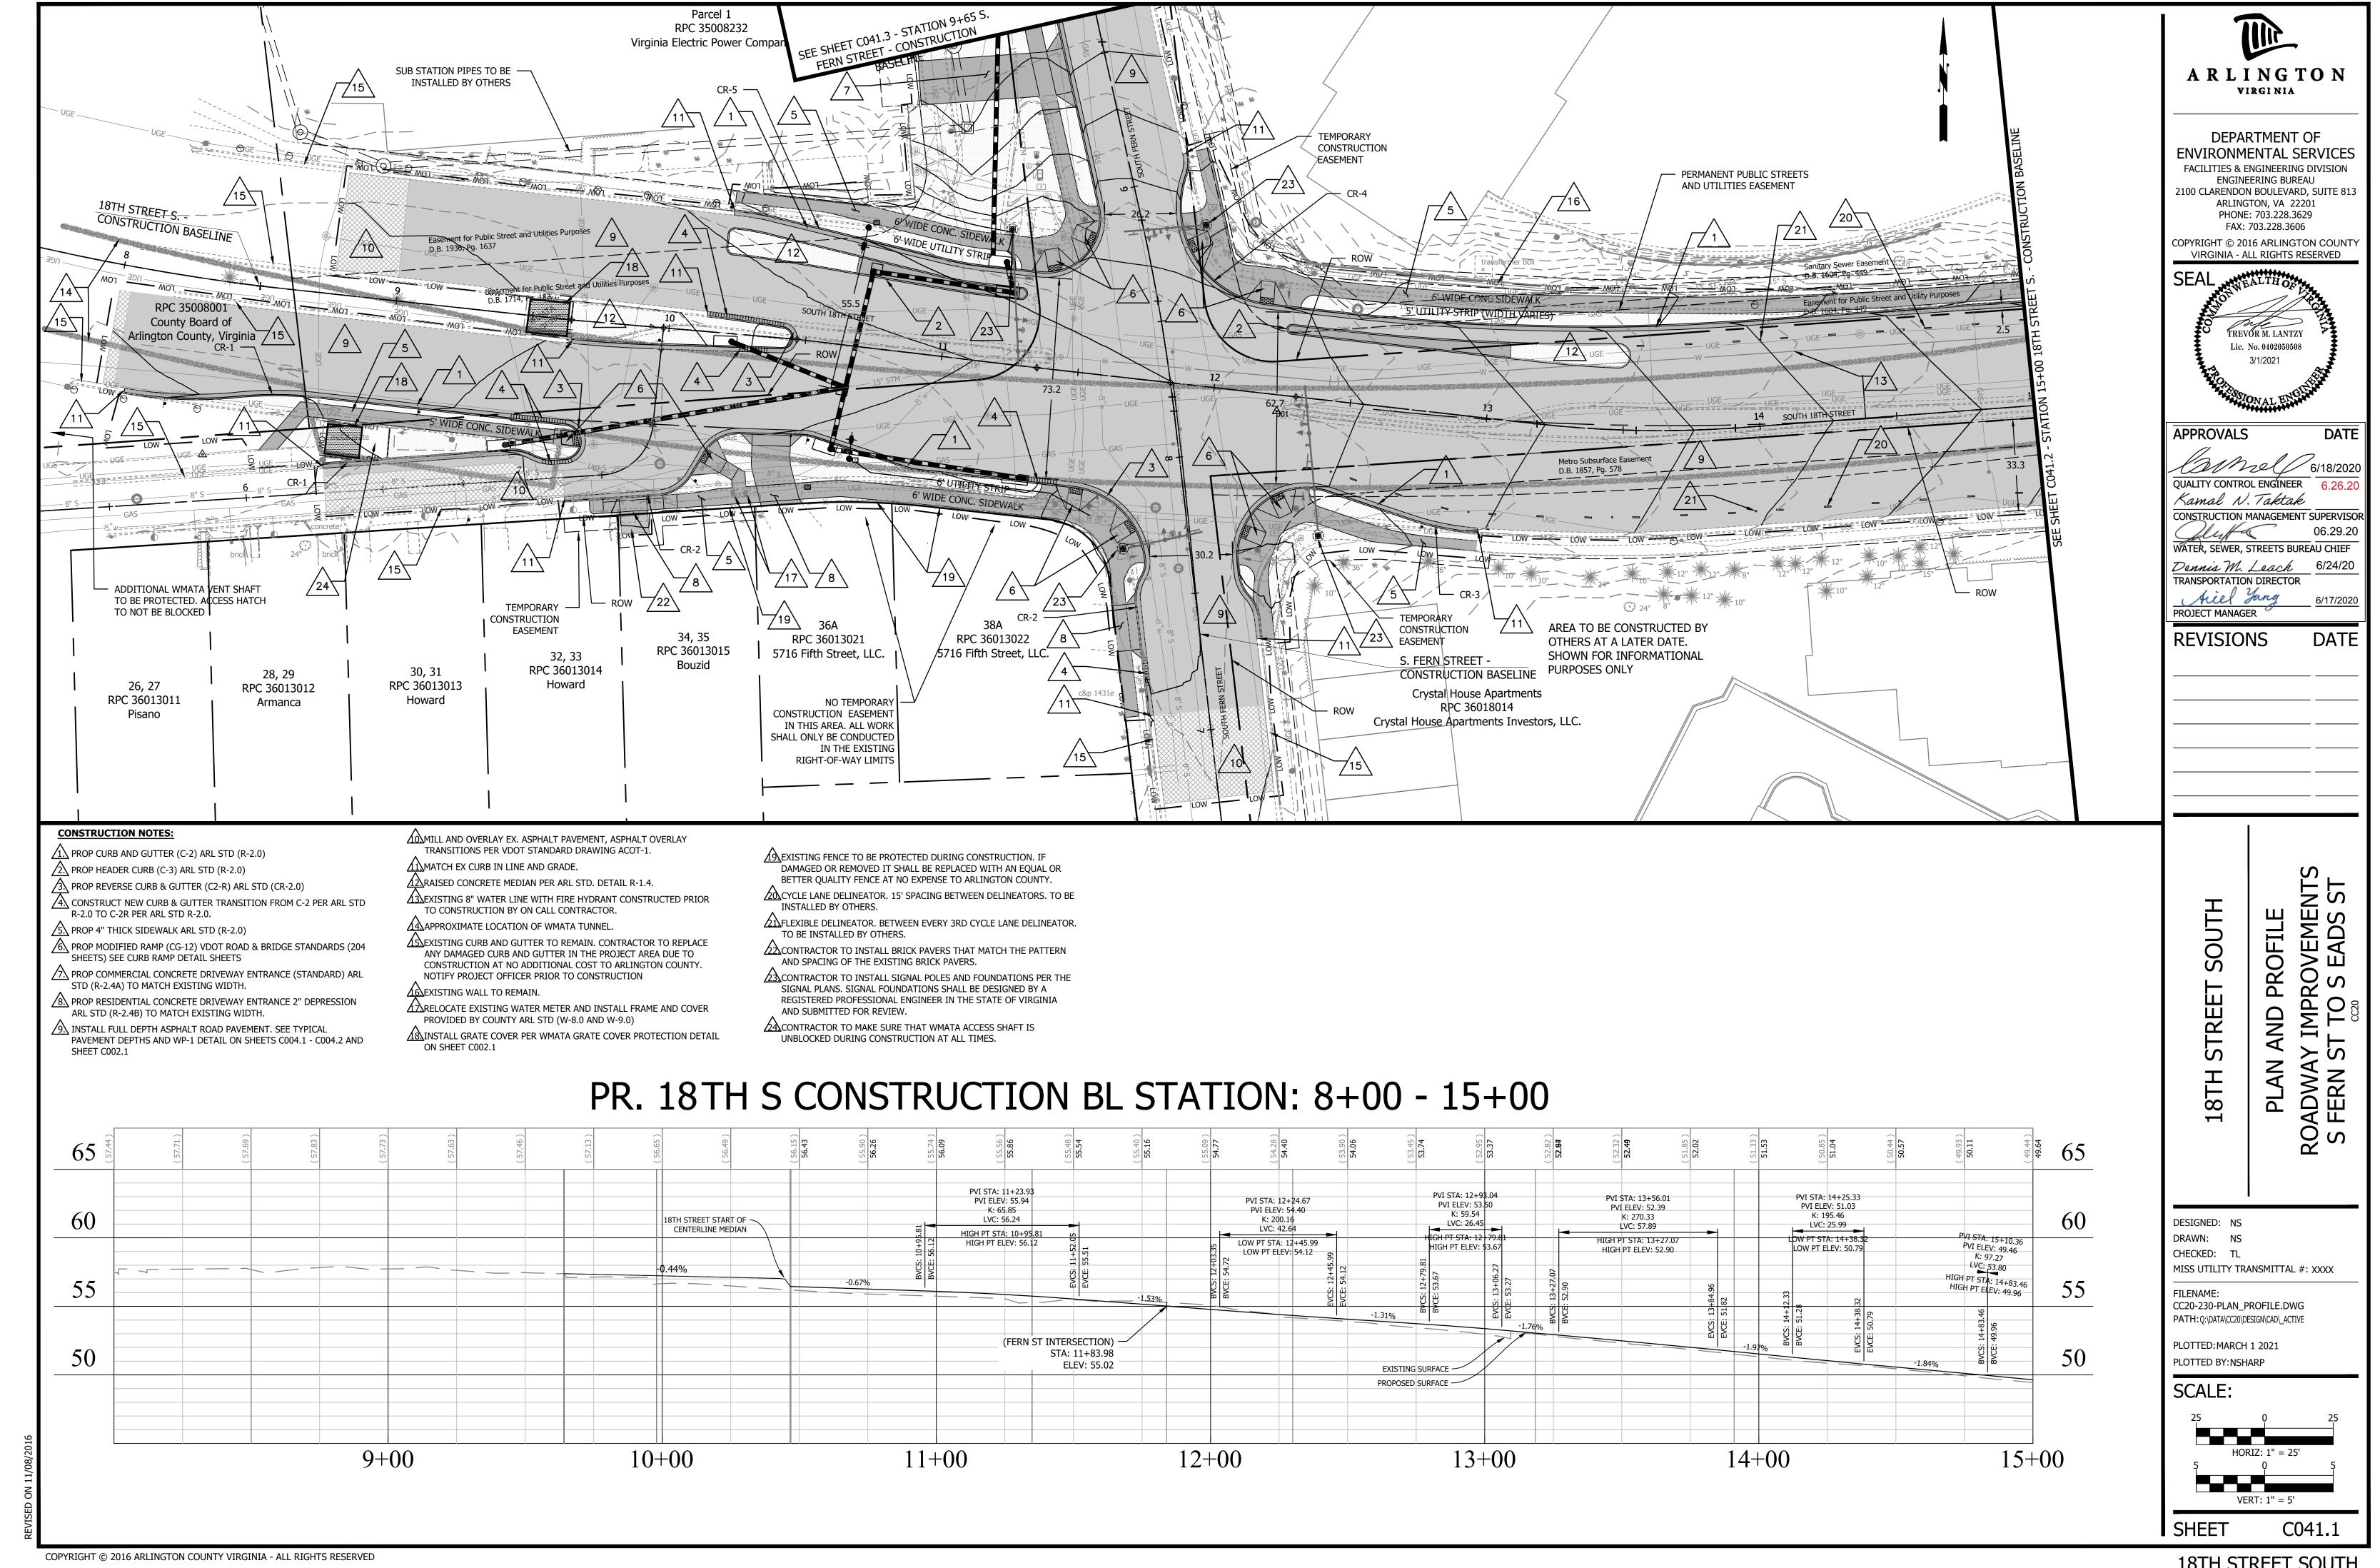


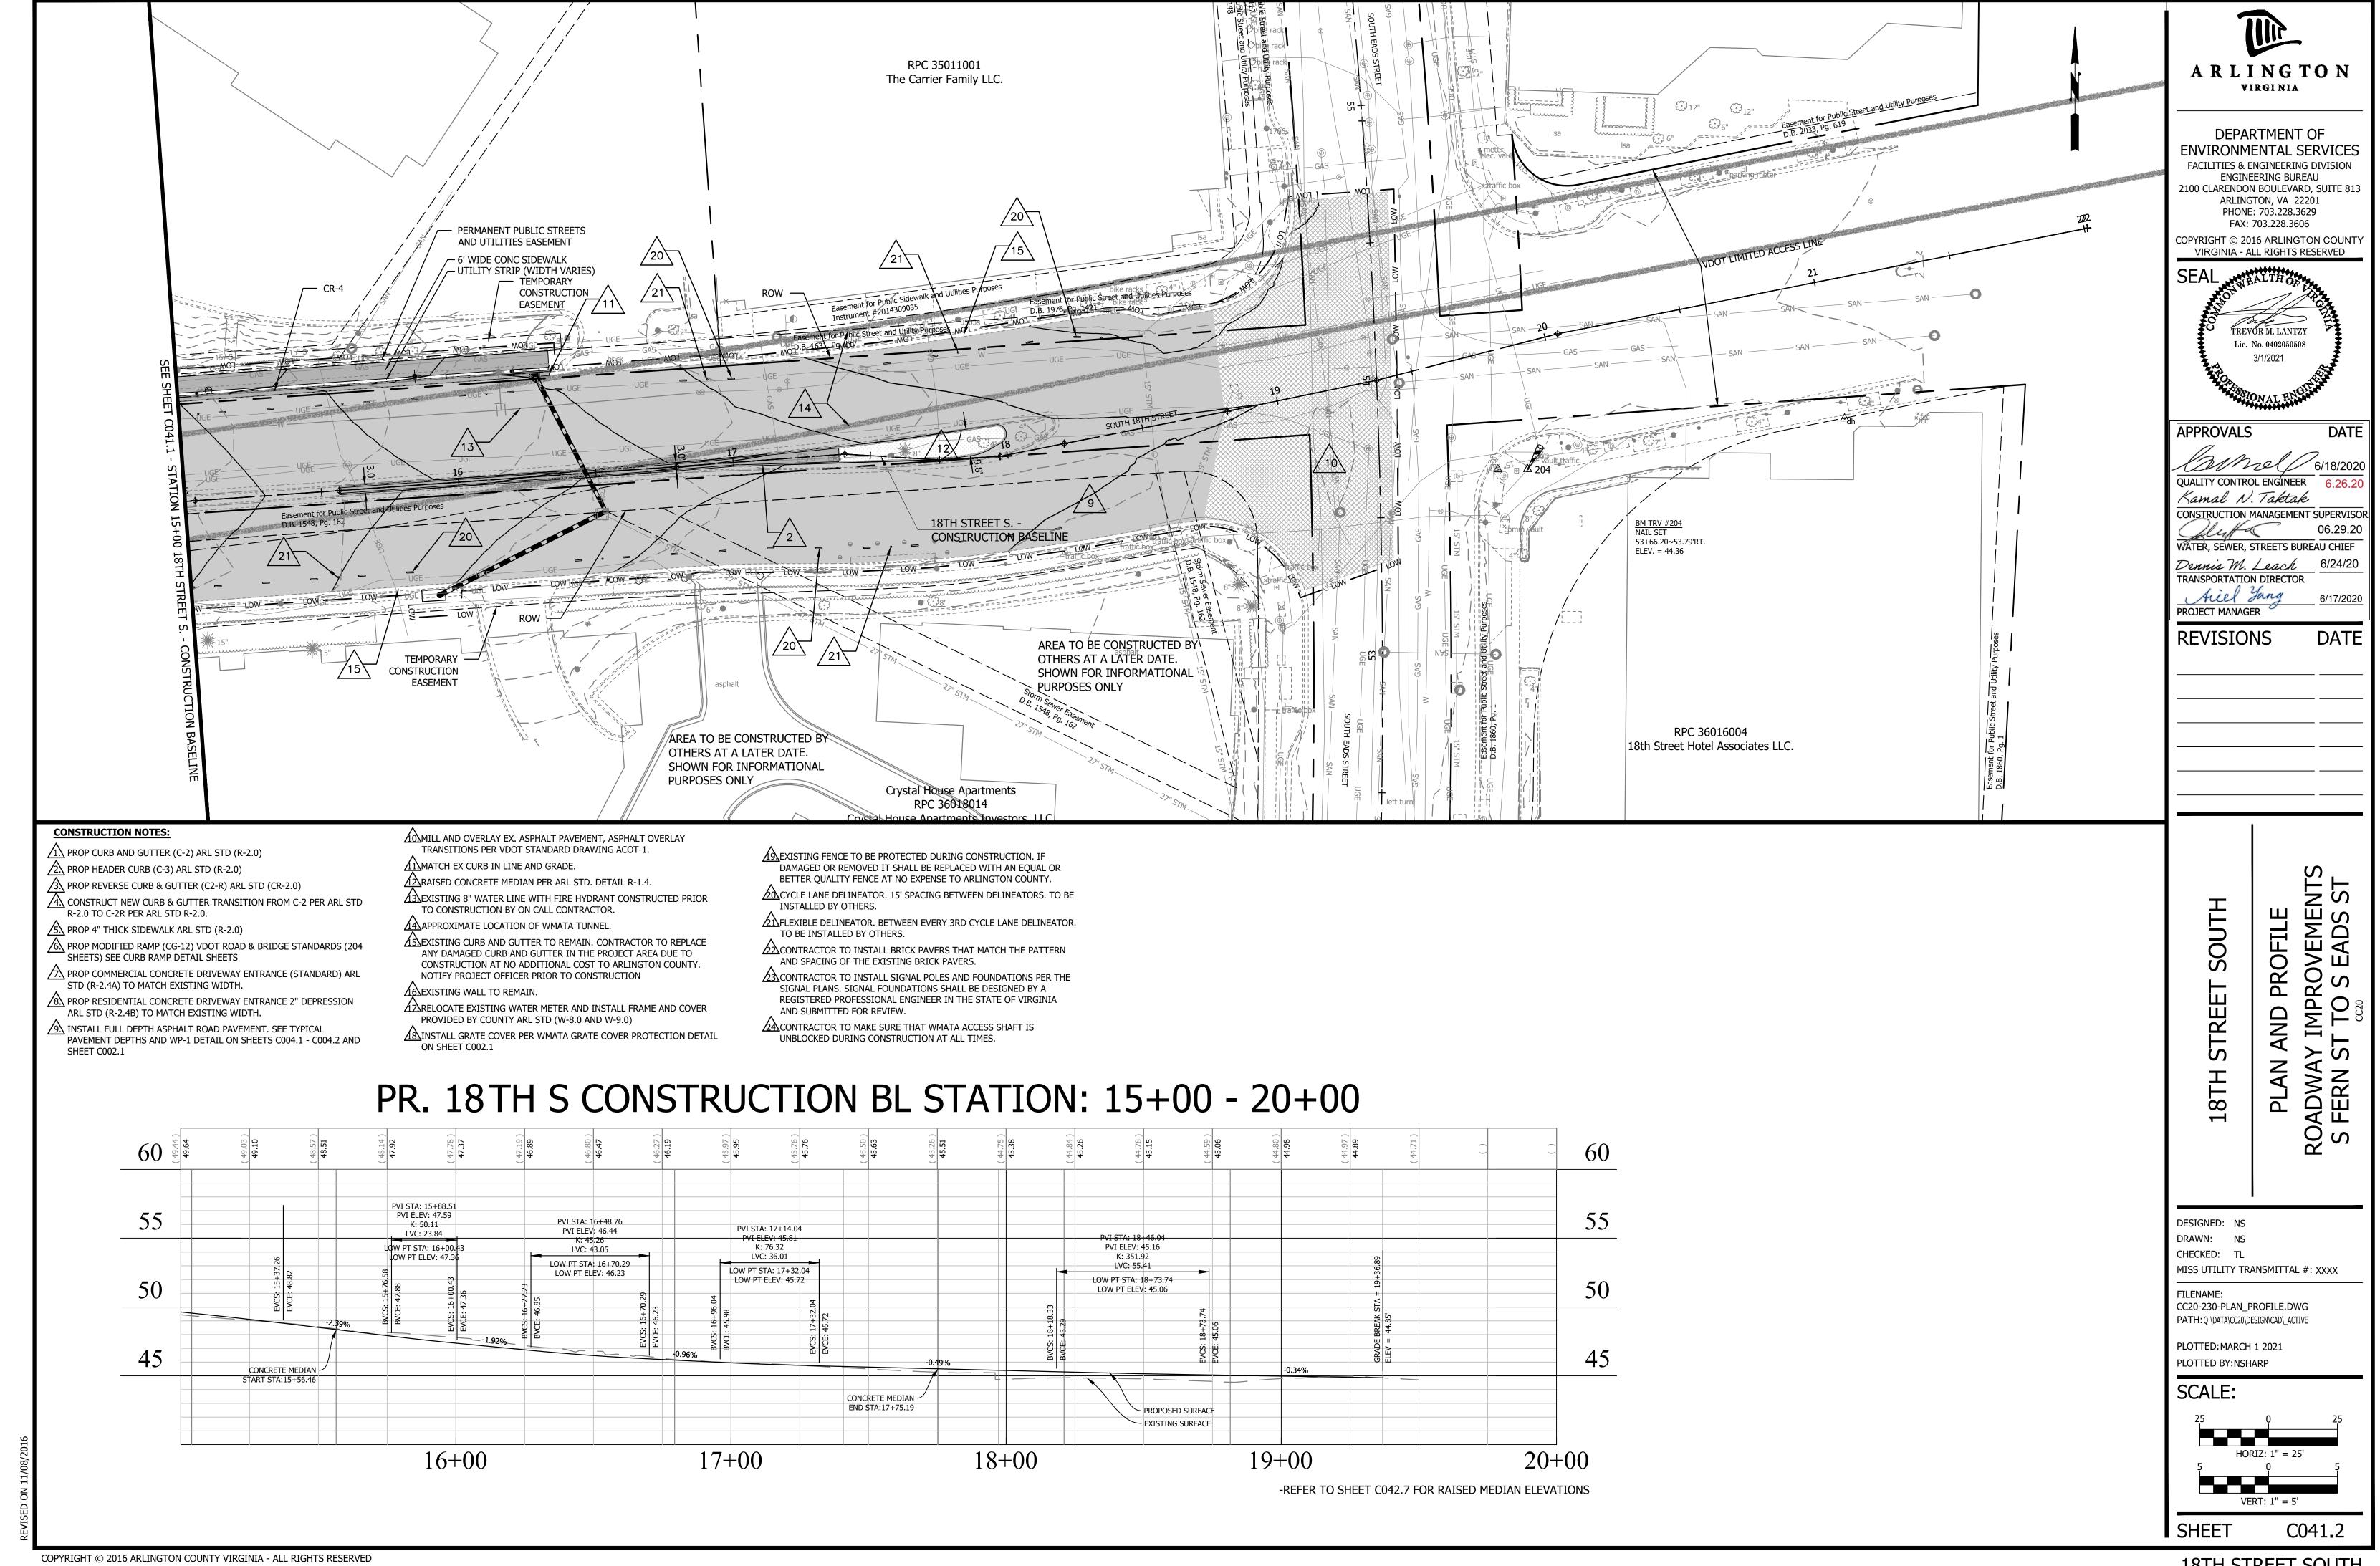



**18TH STREET SOUTH** 

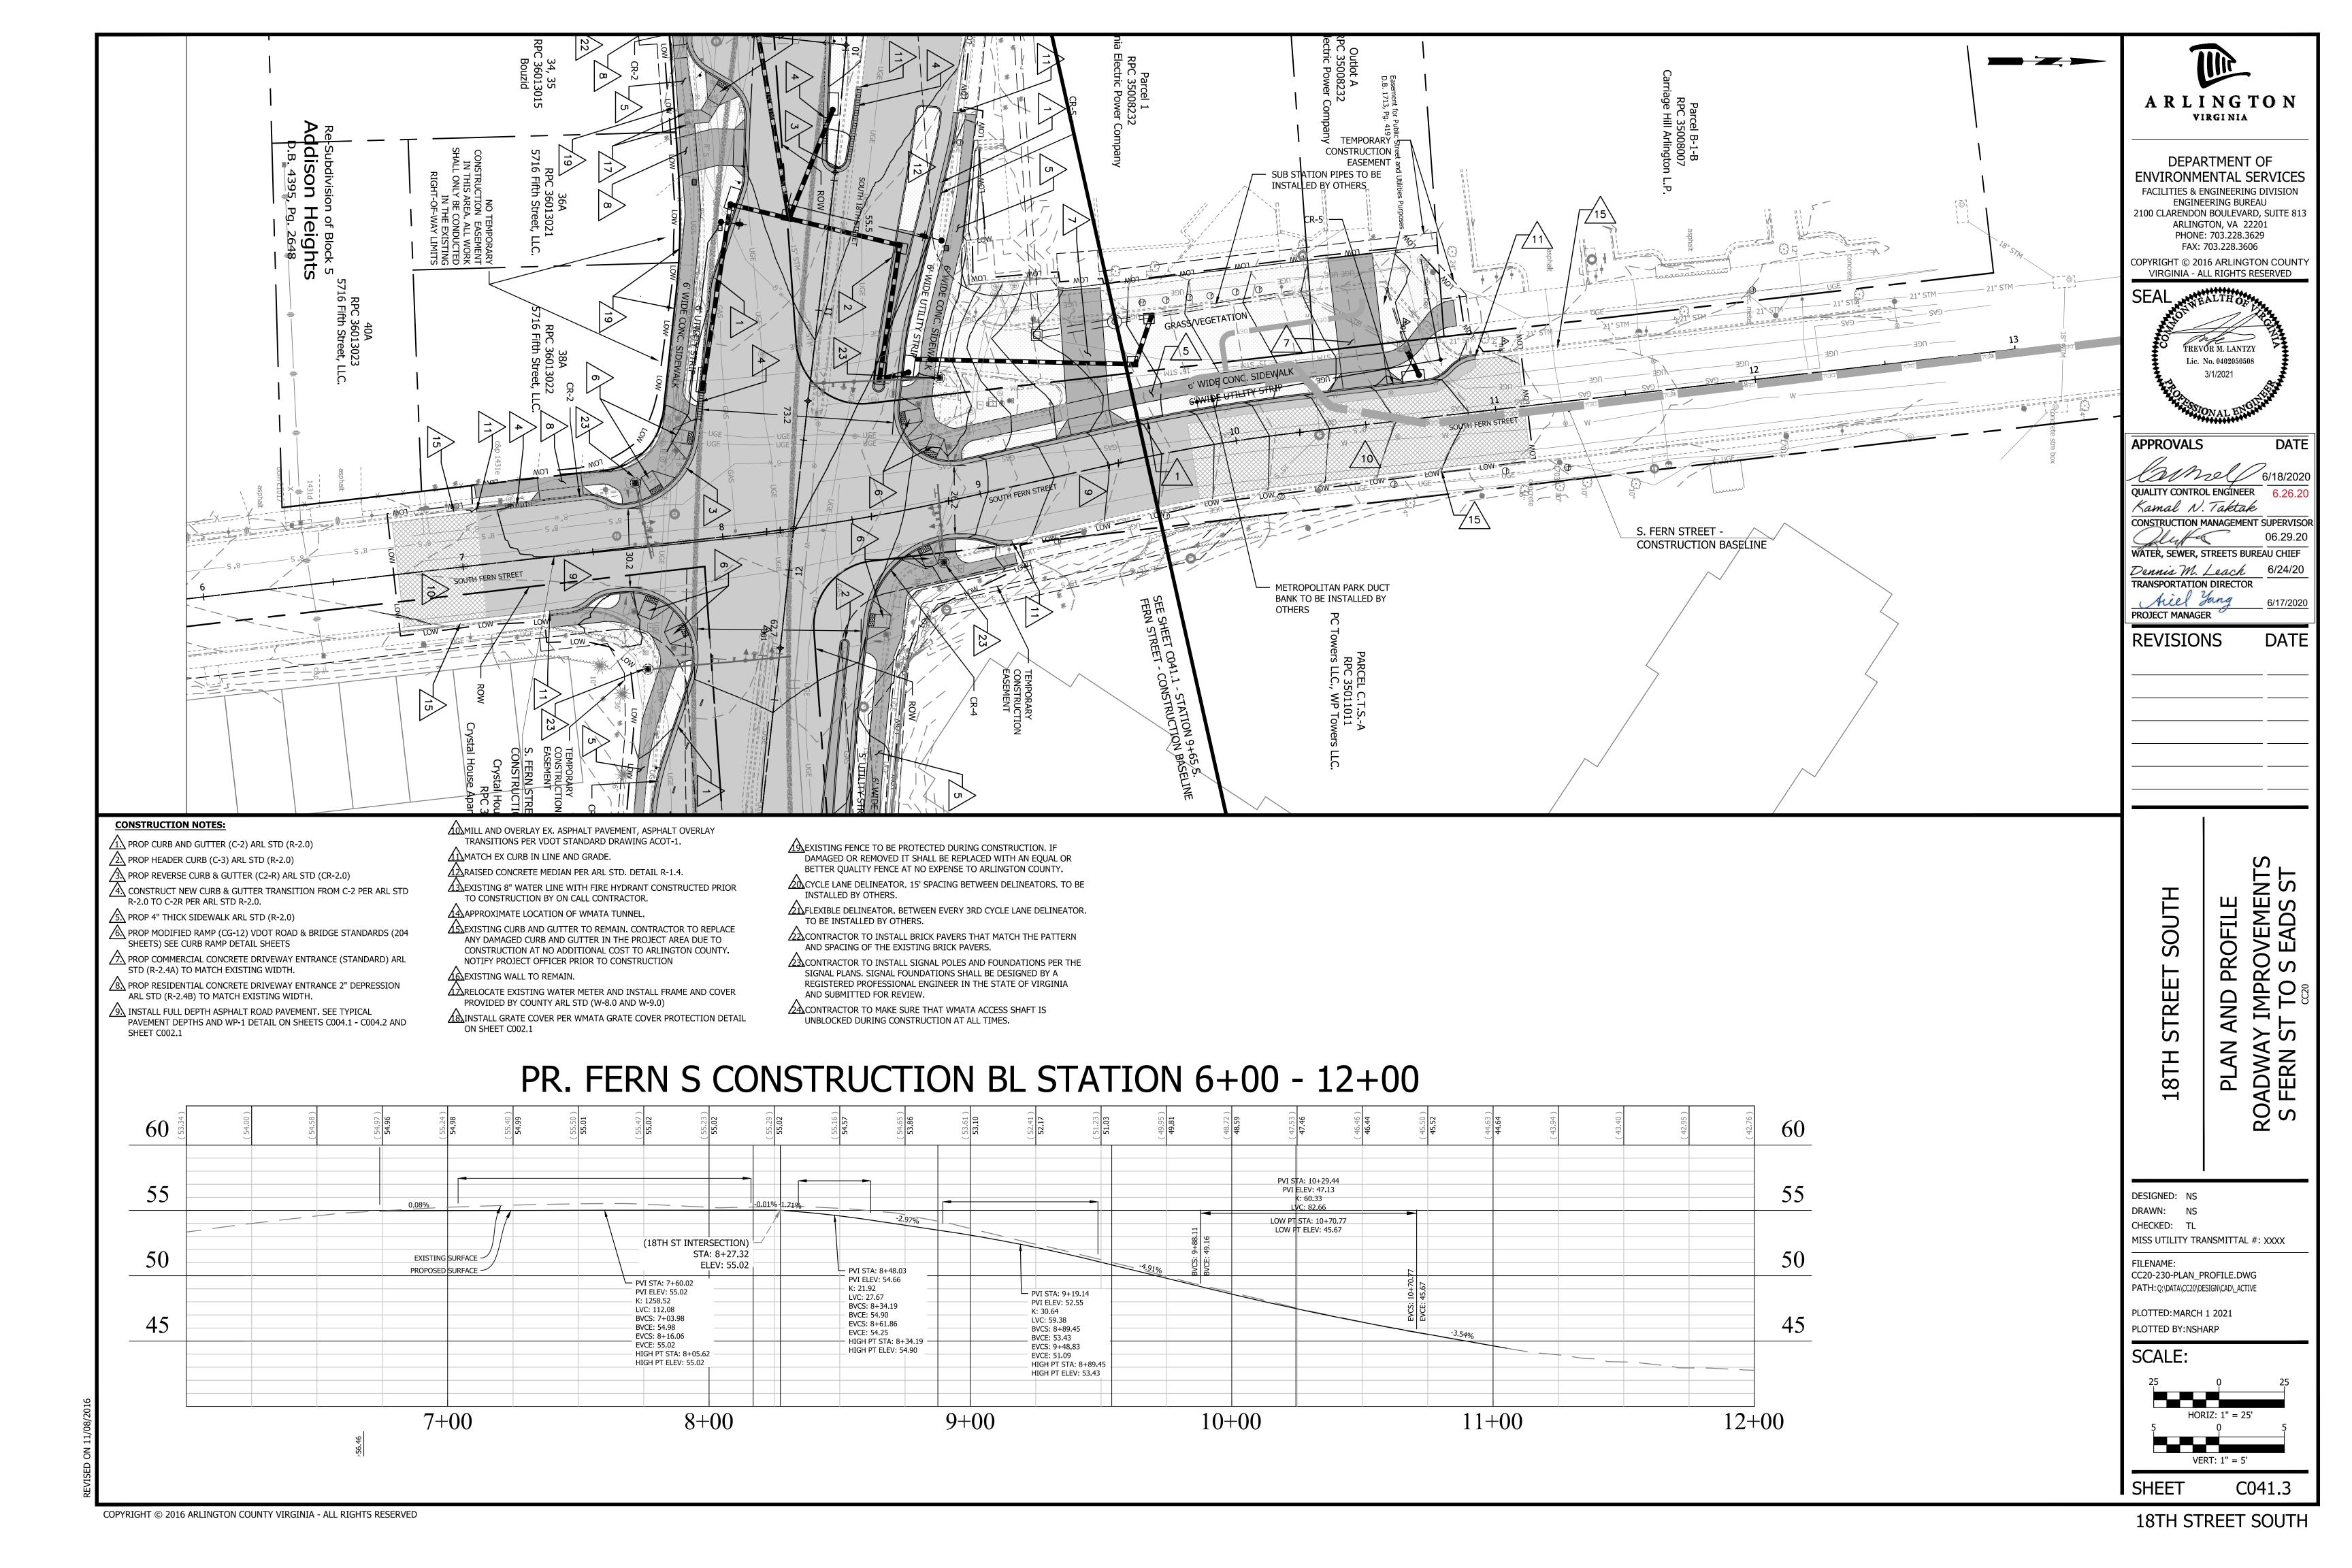


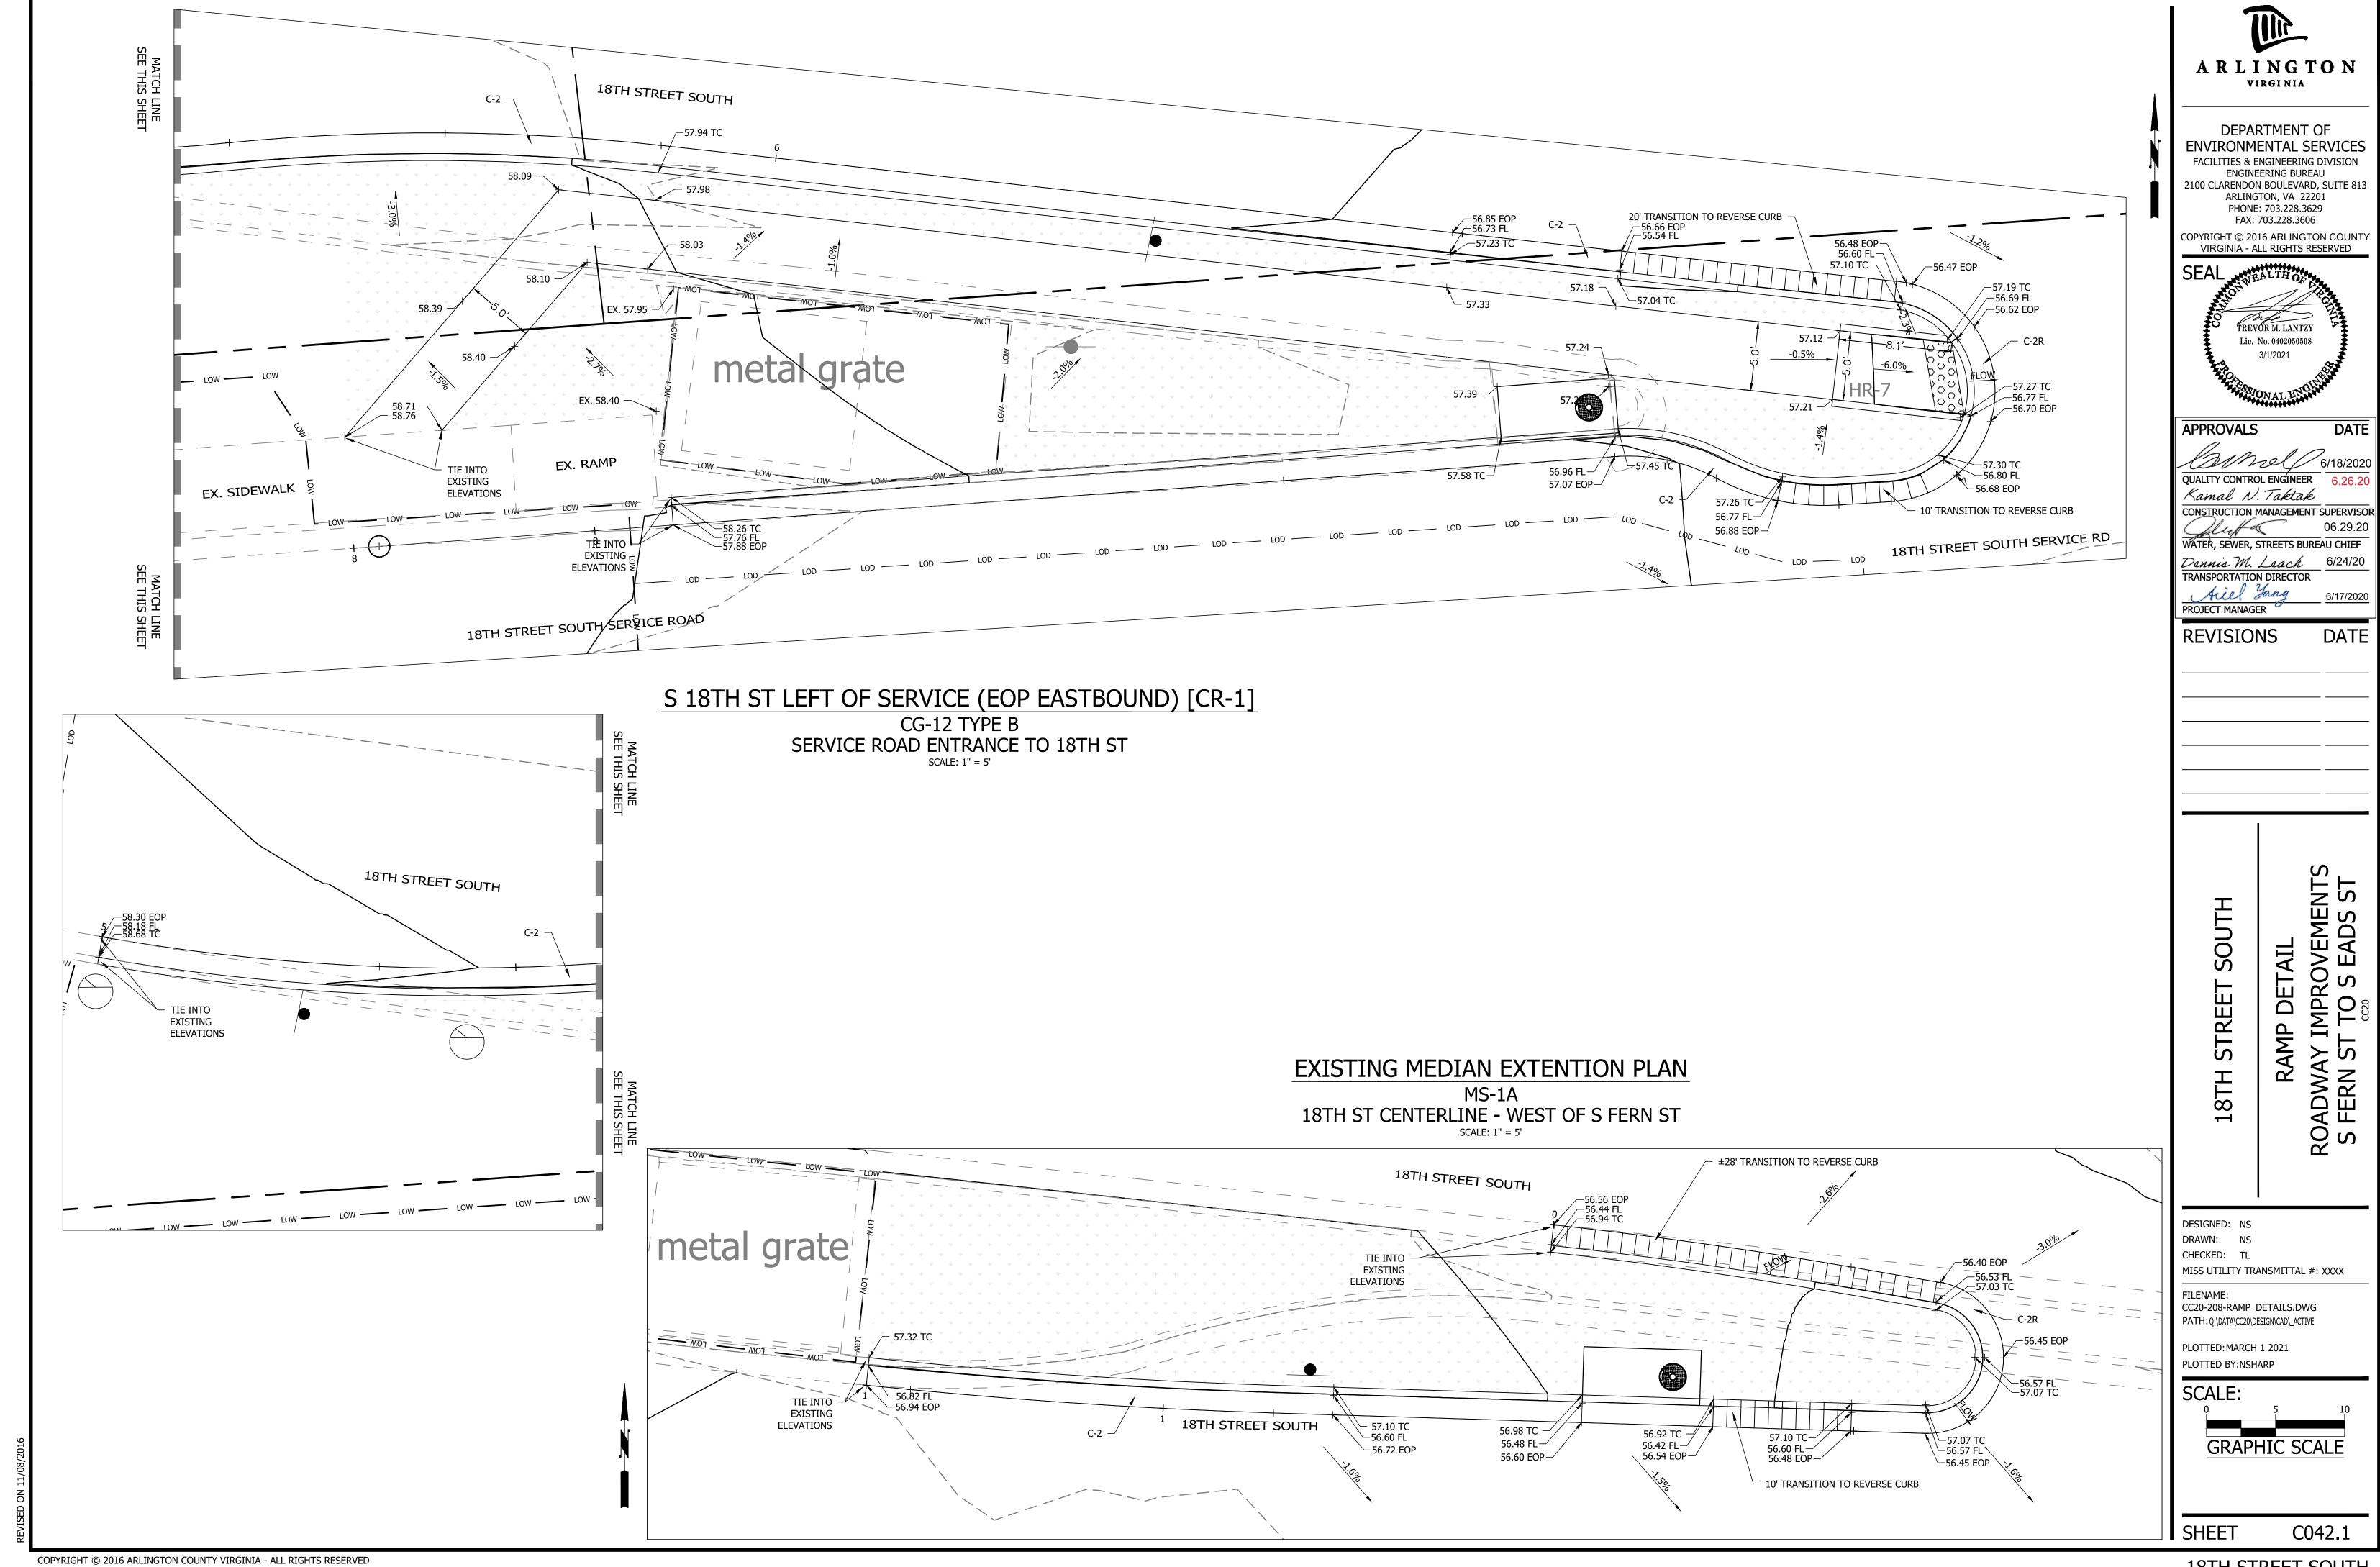


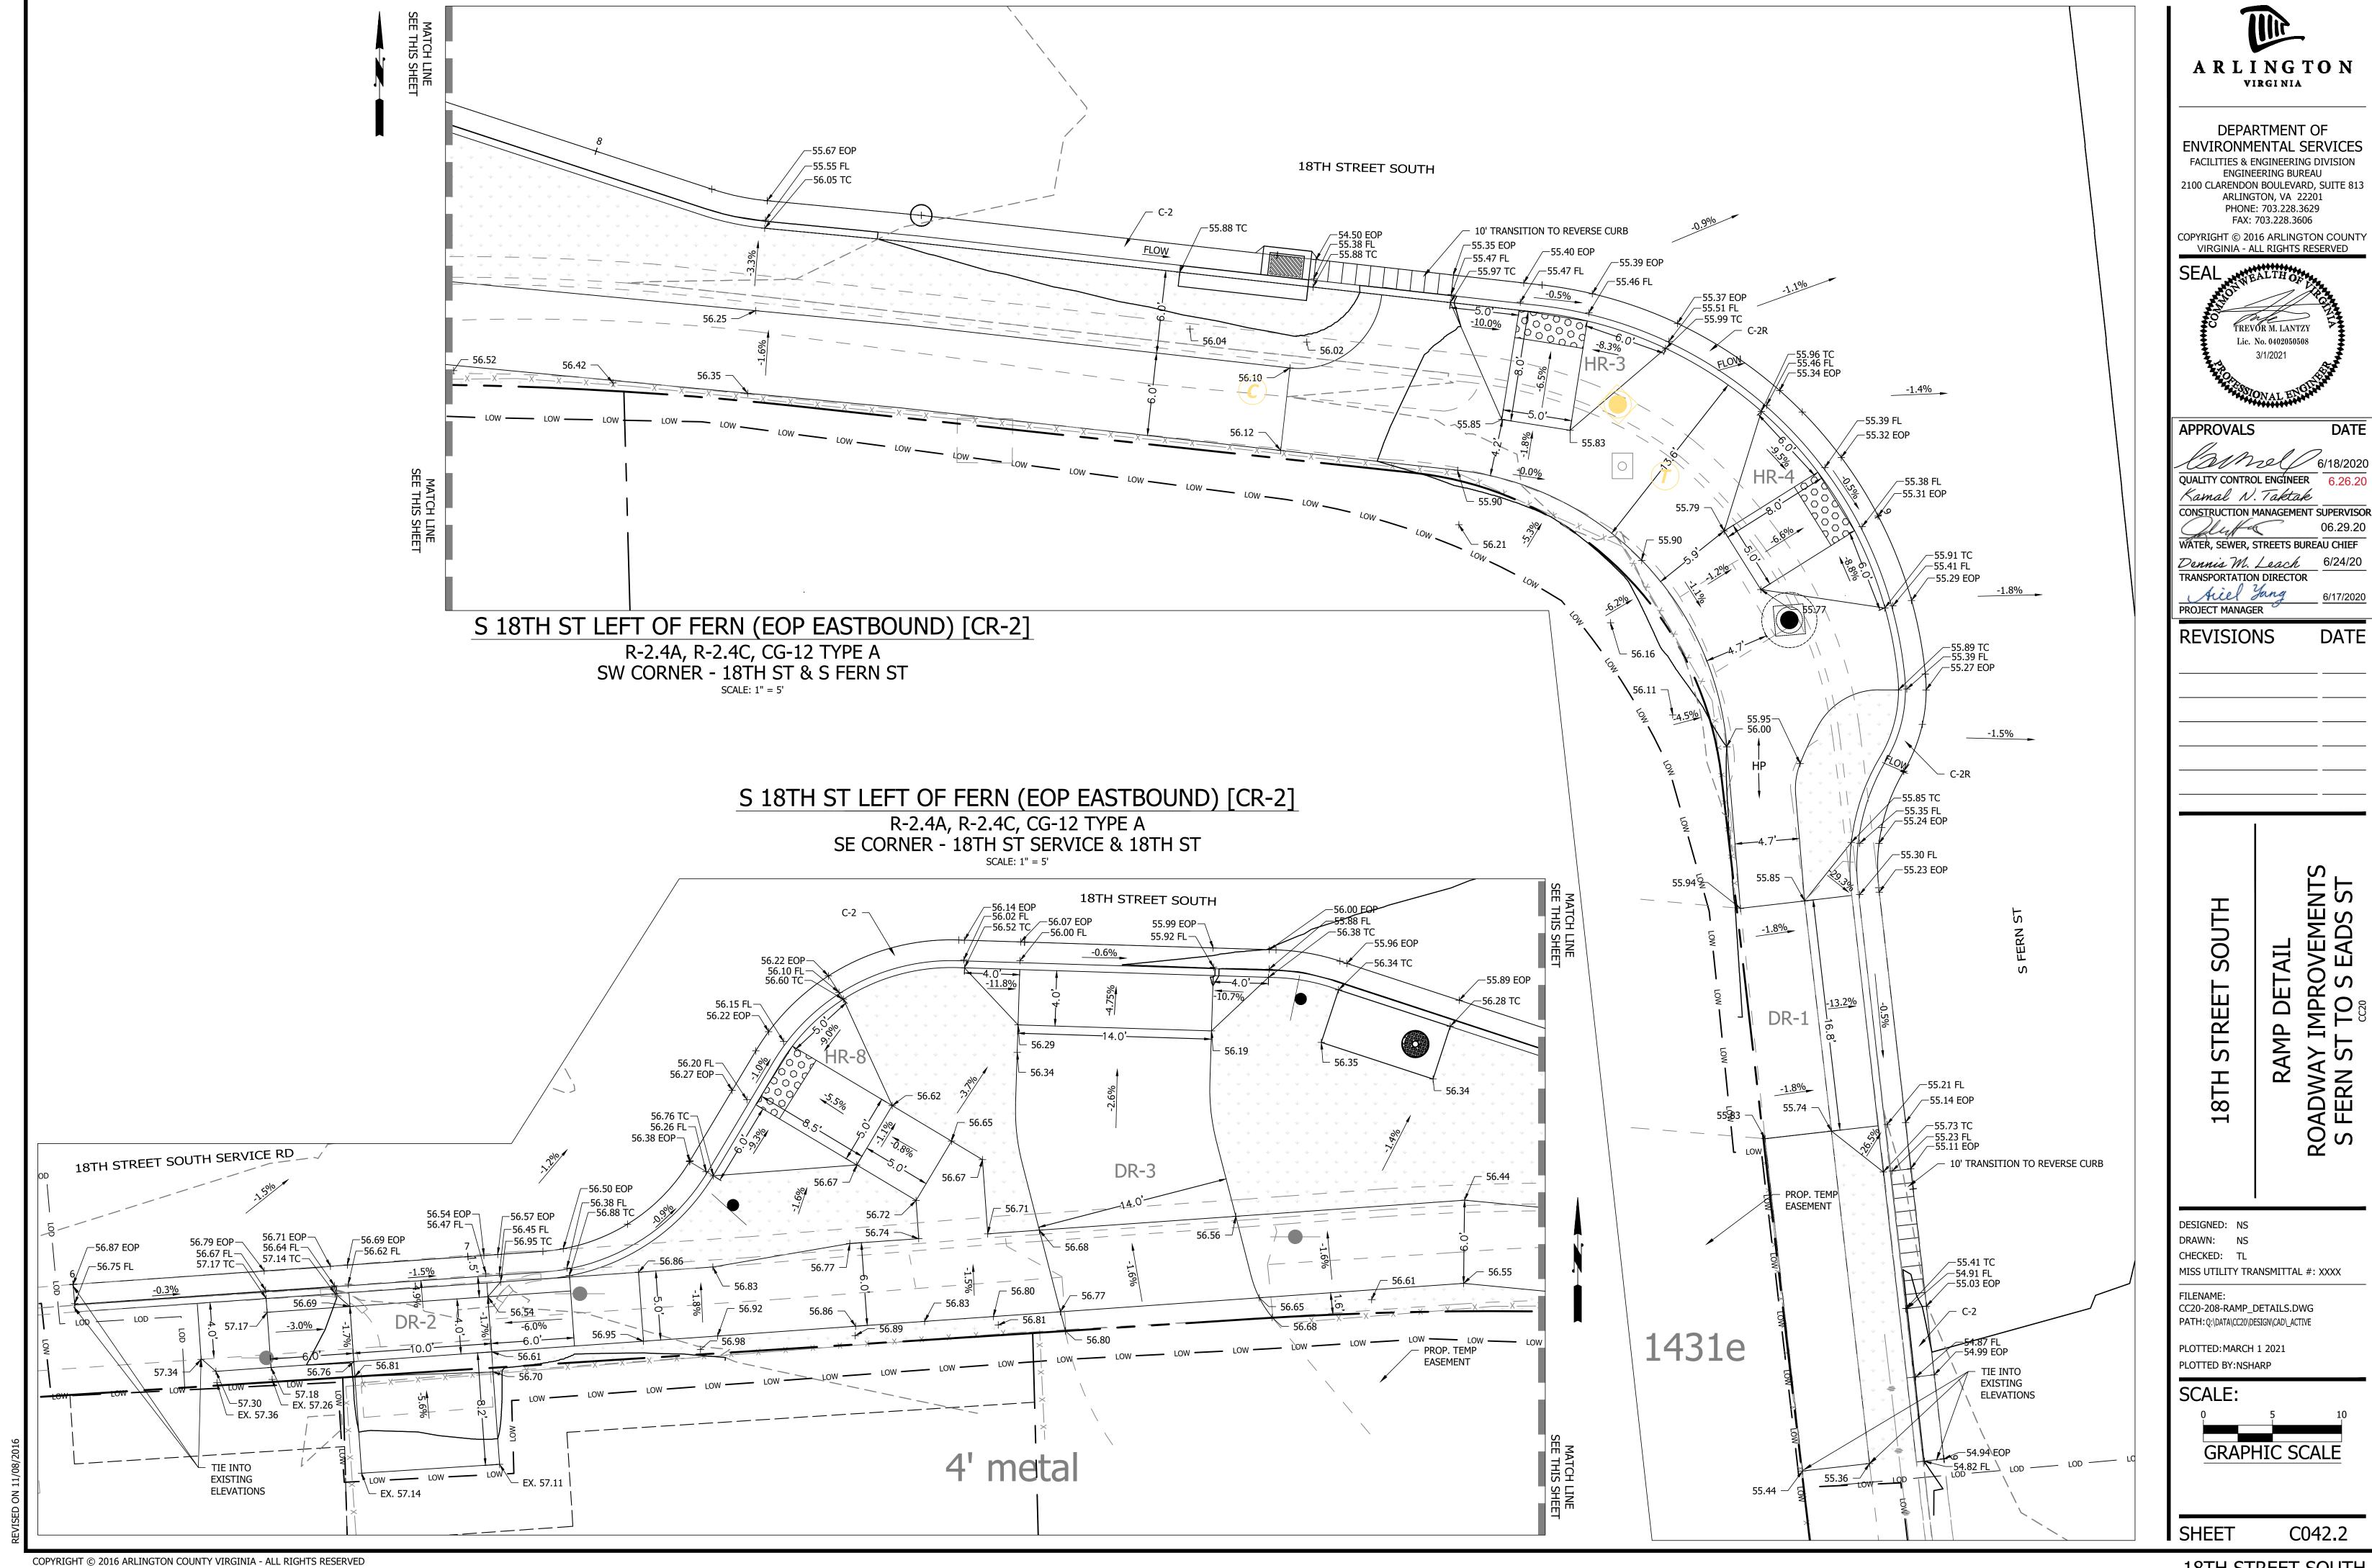


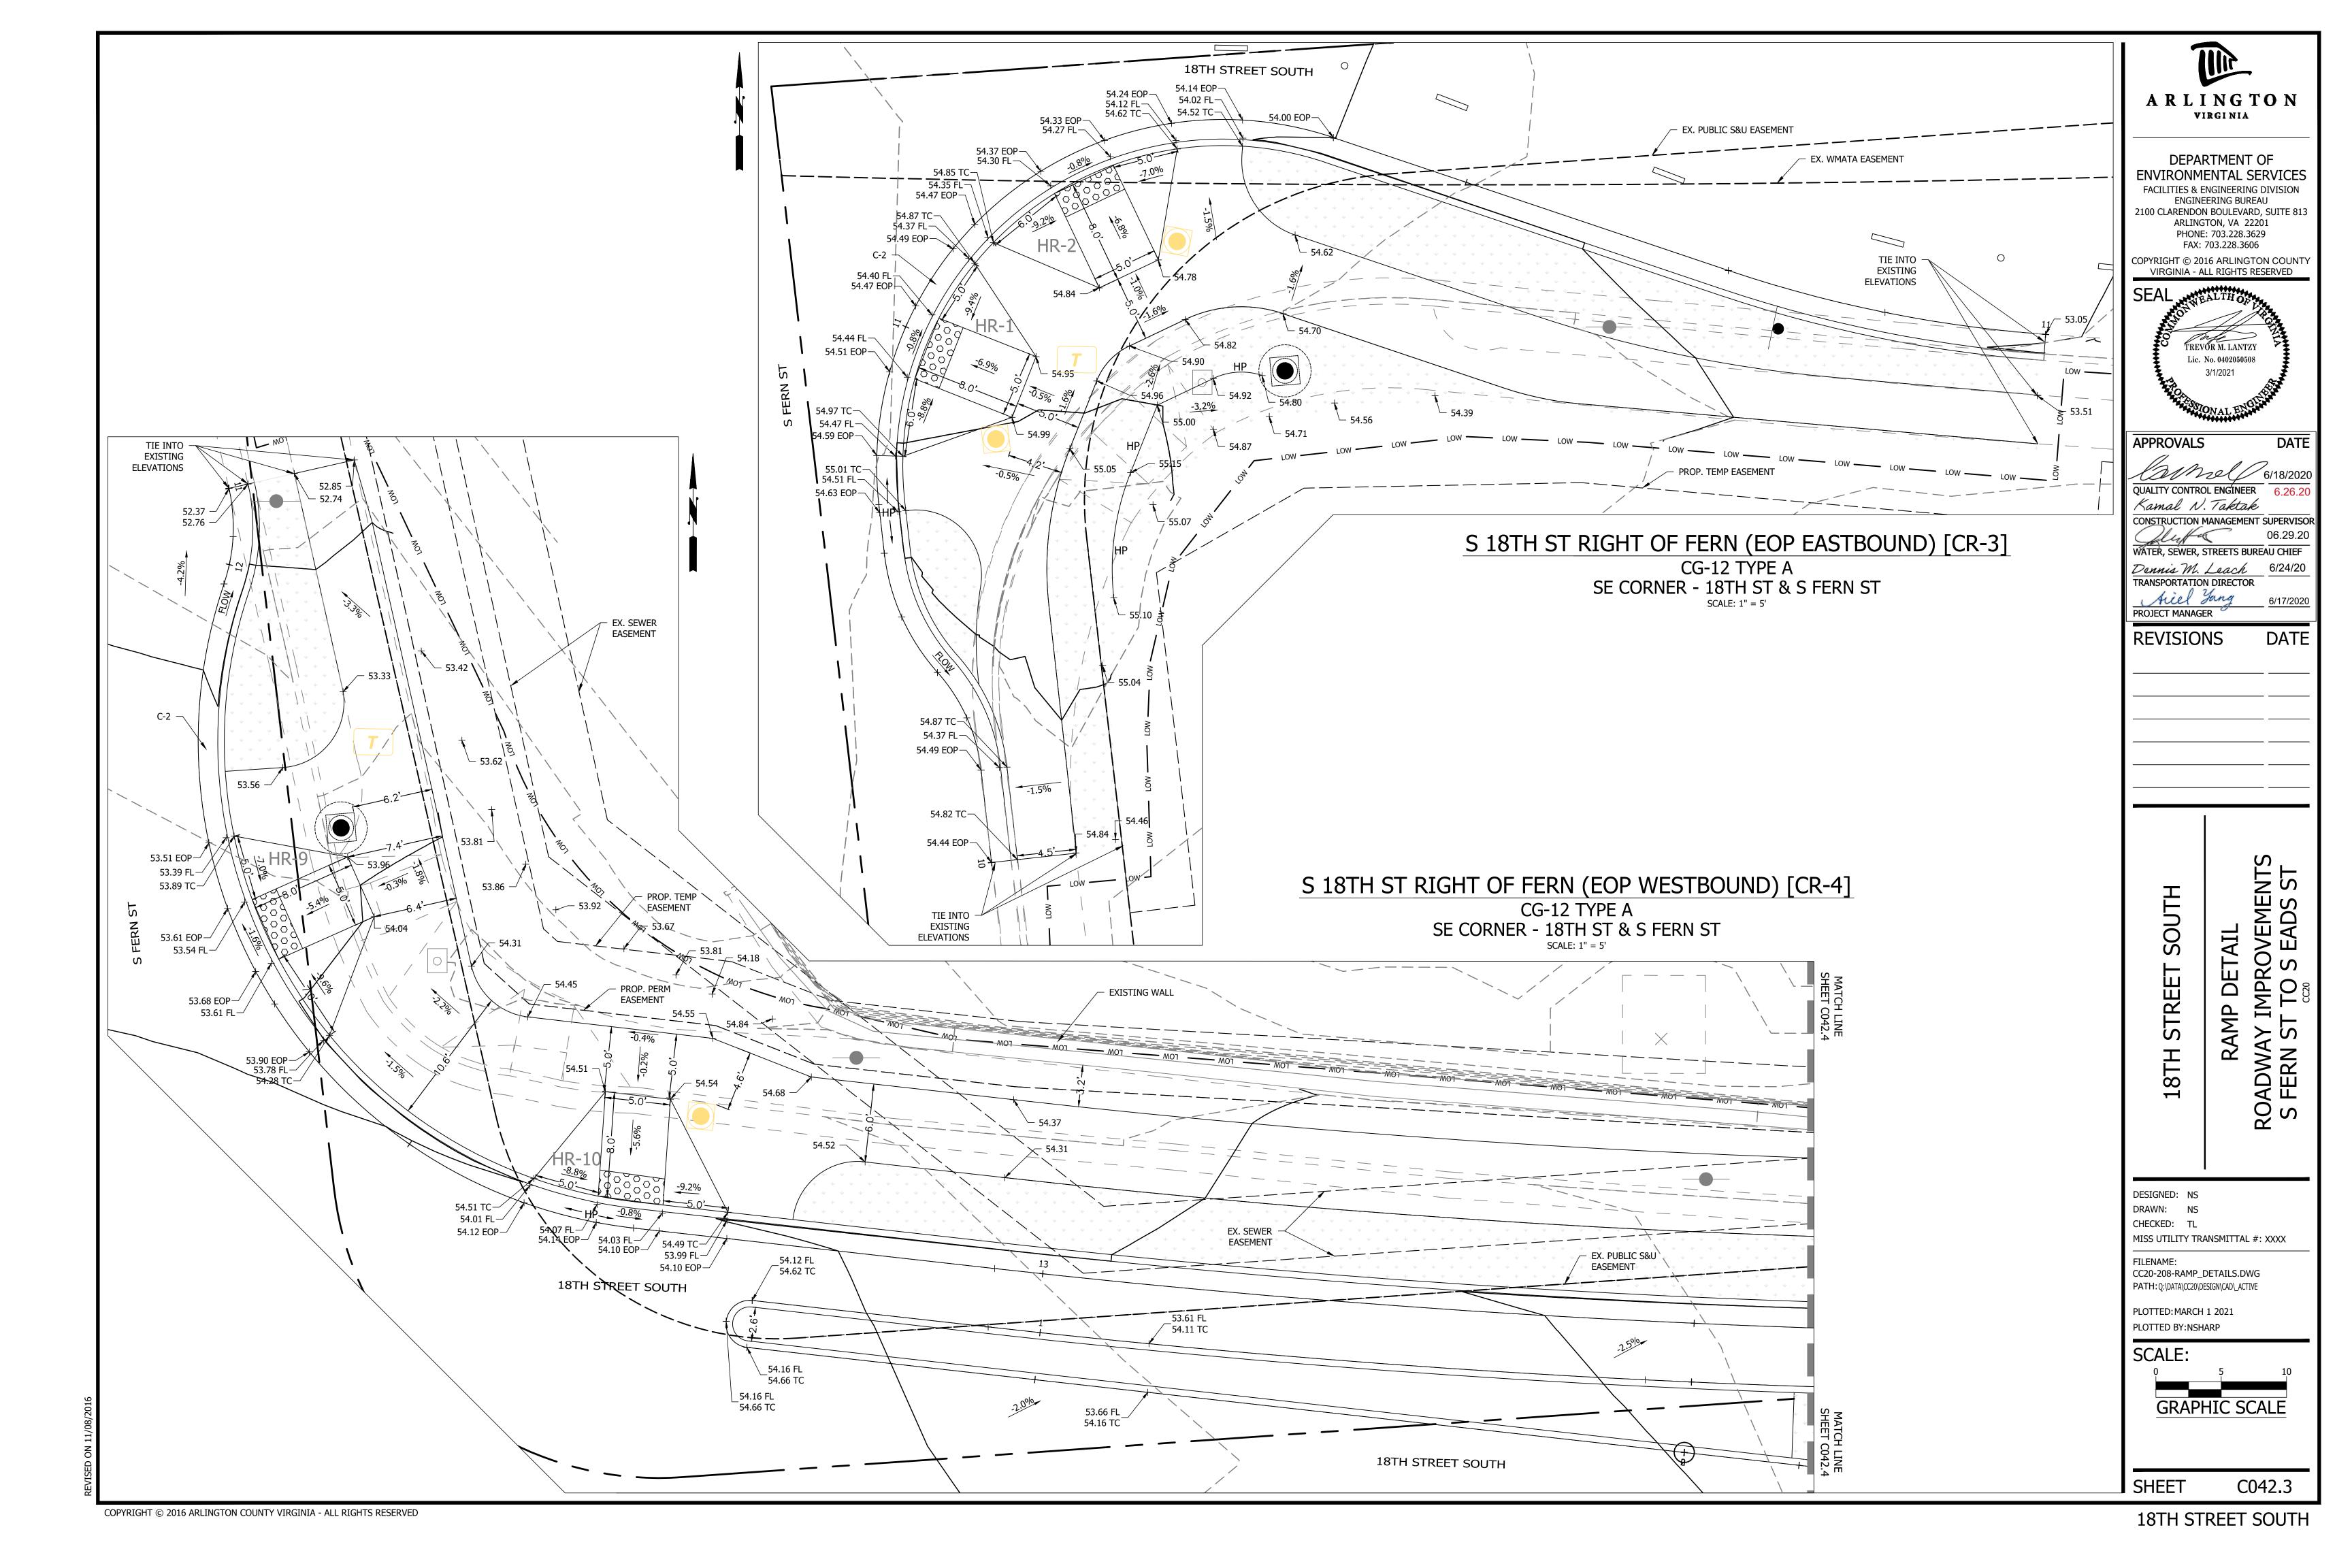


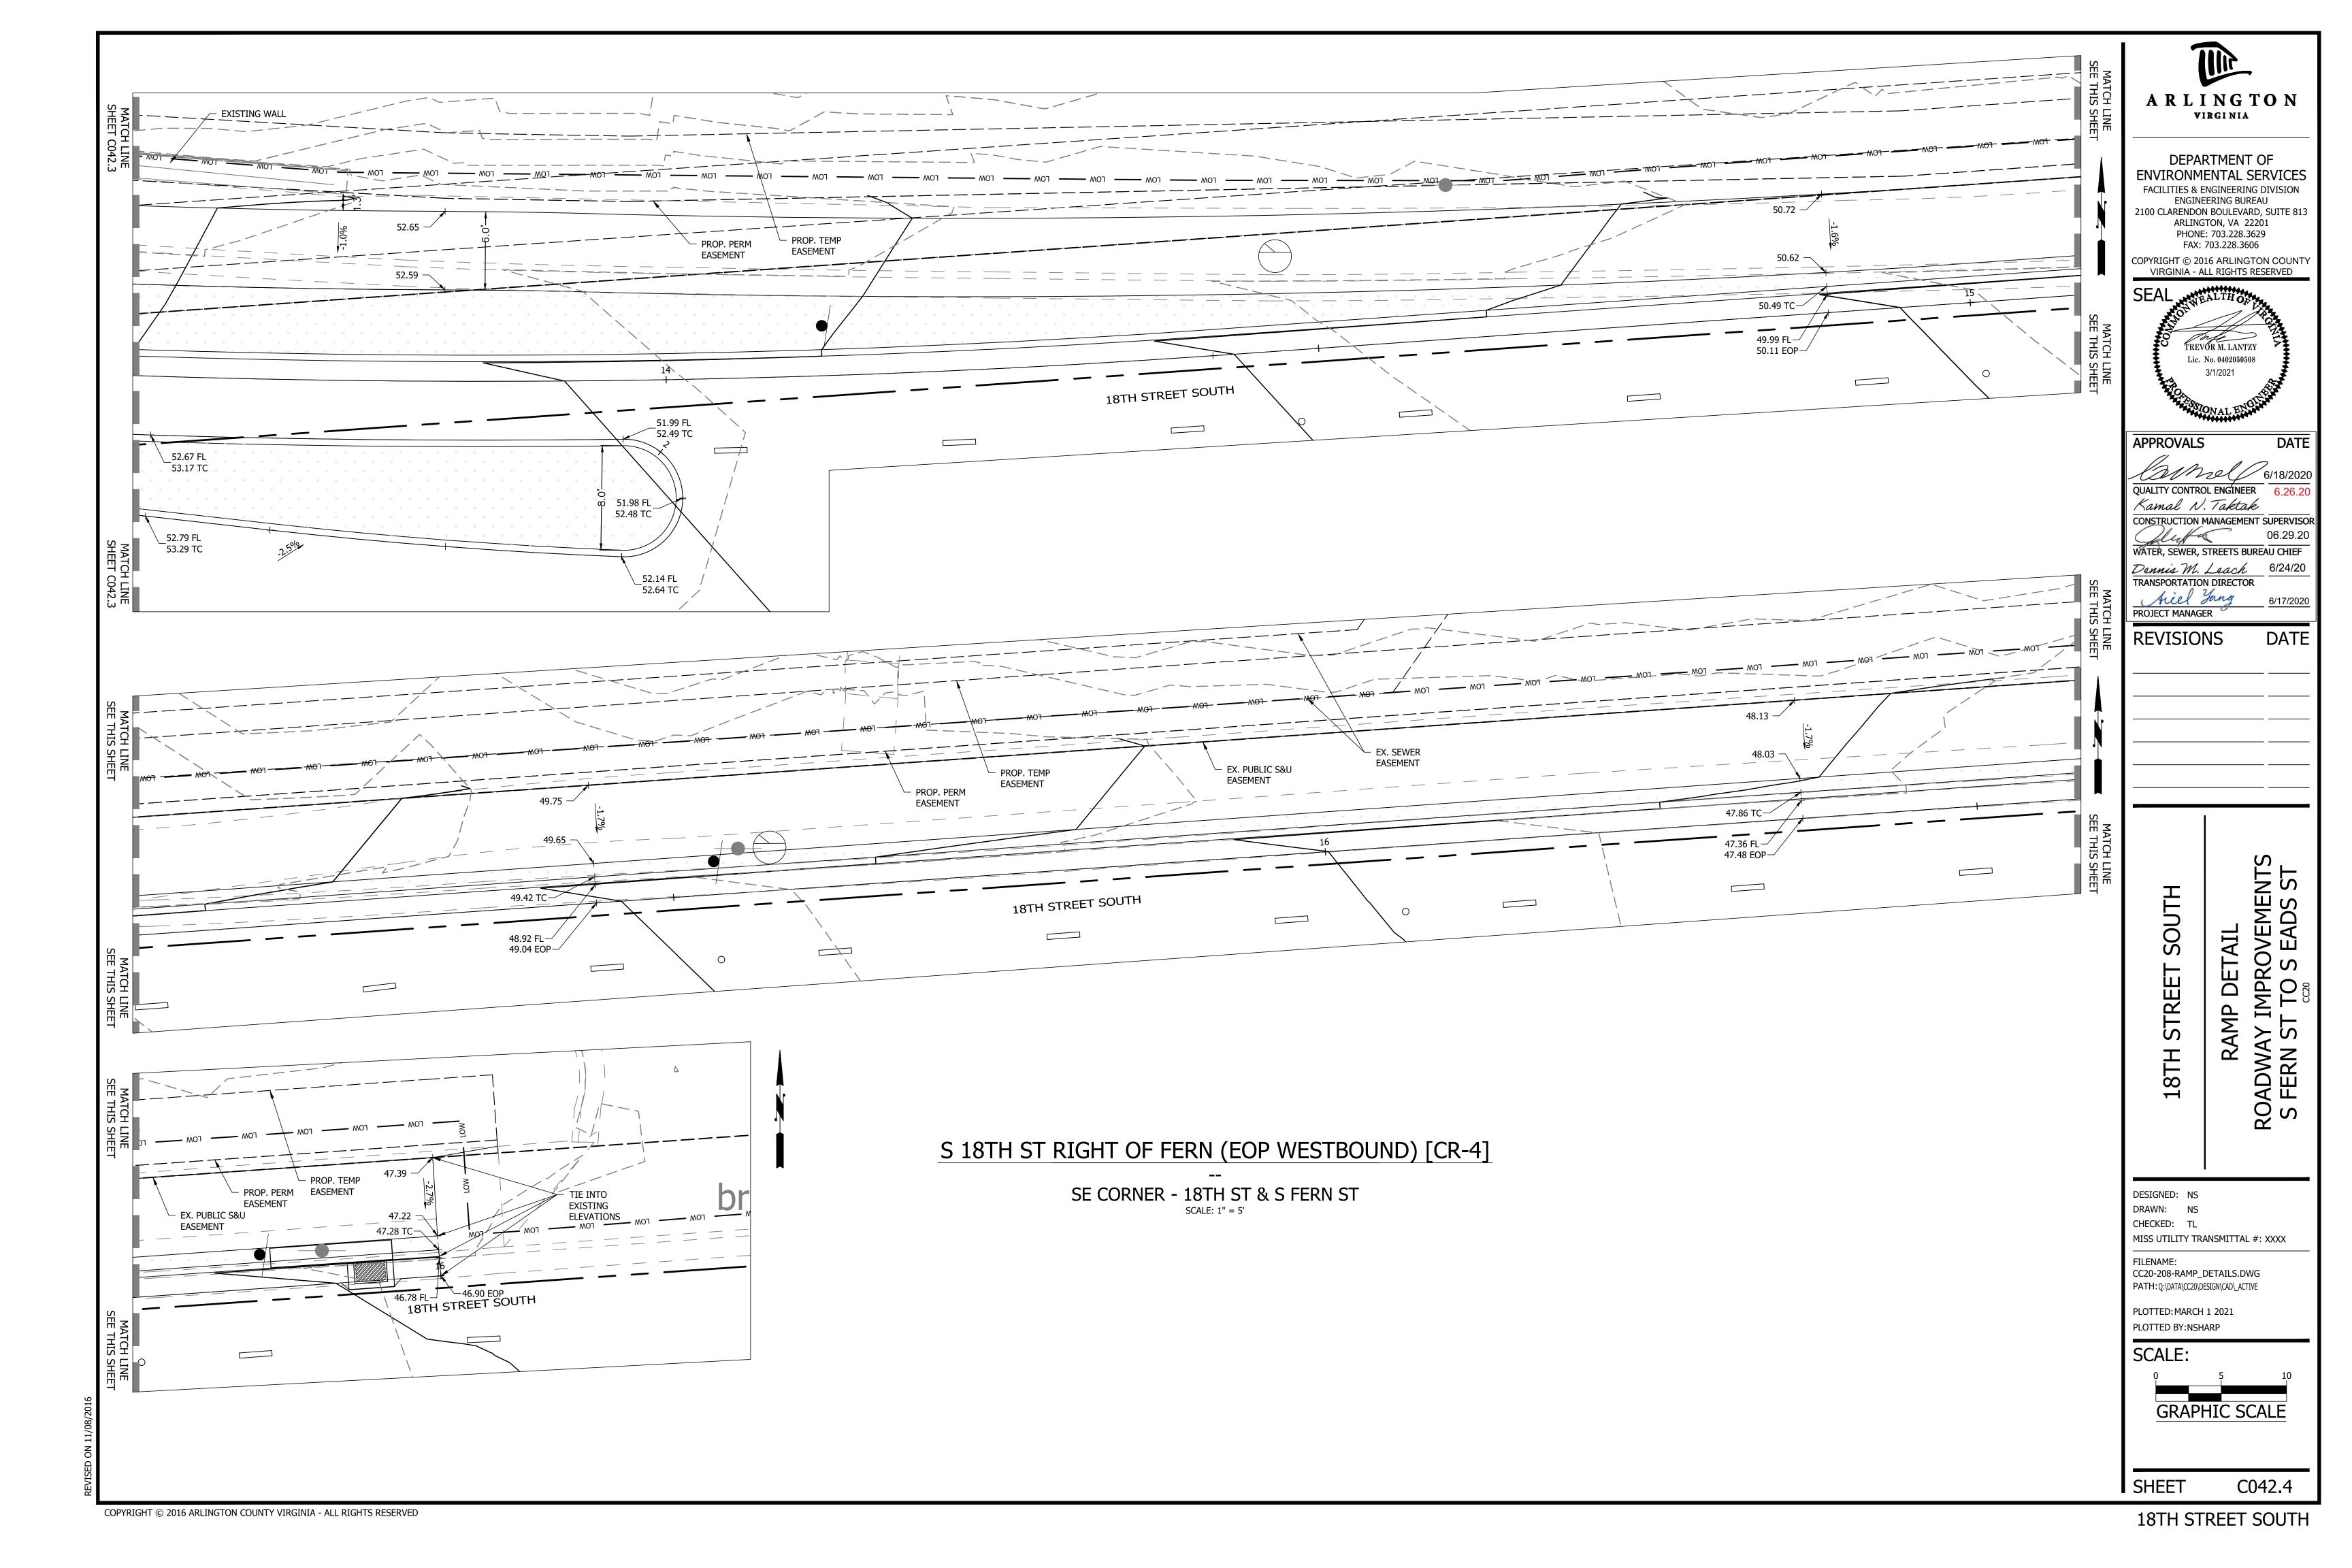


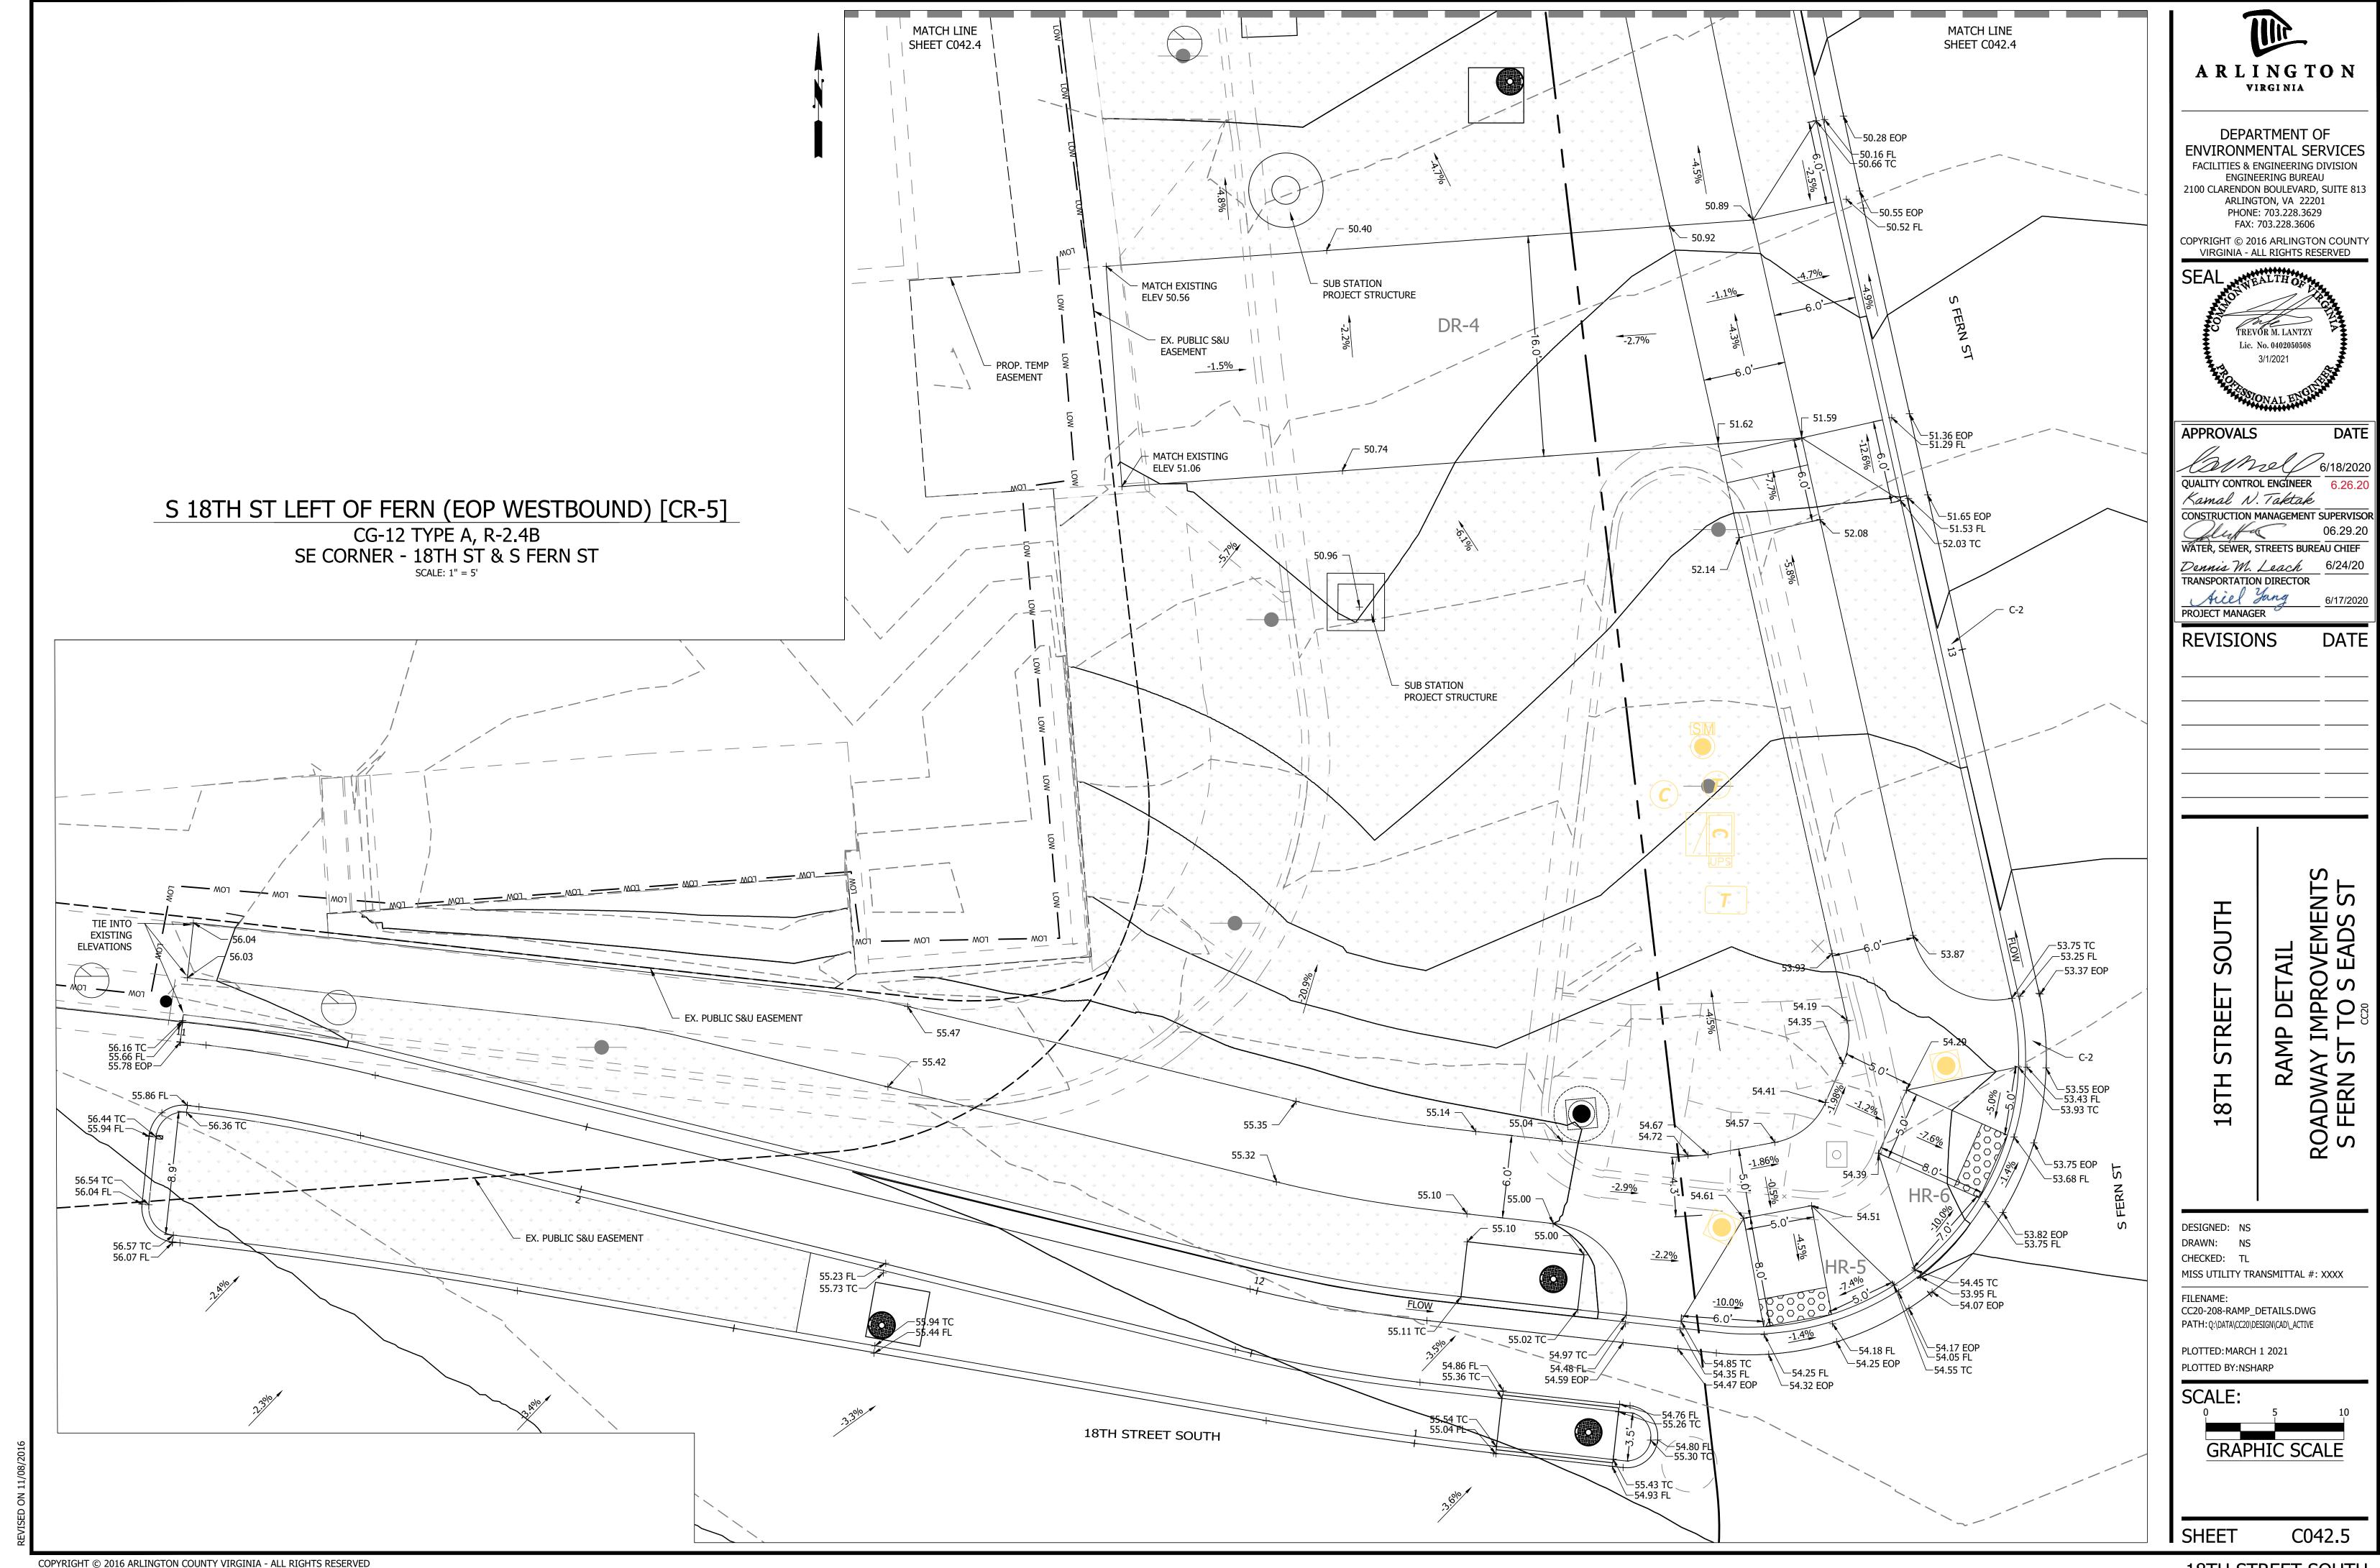

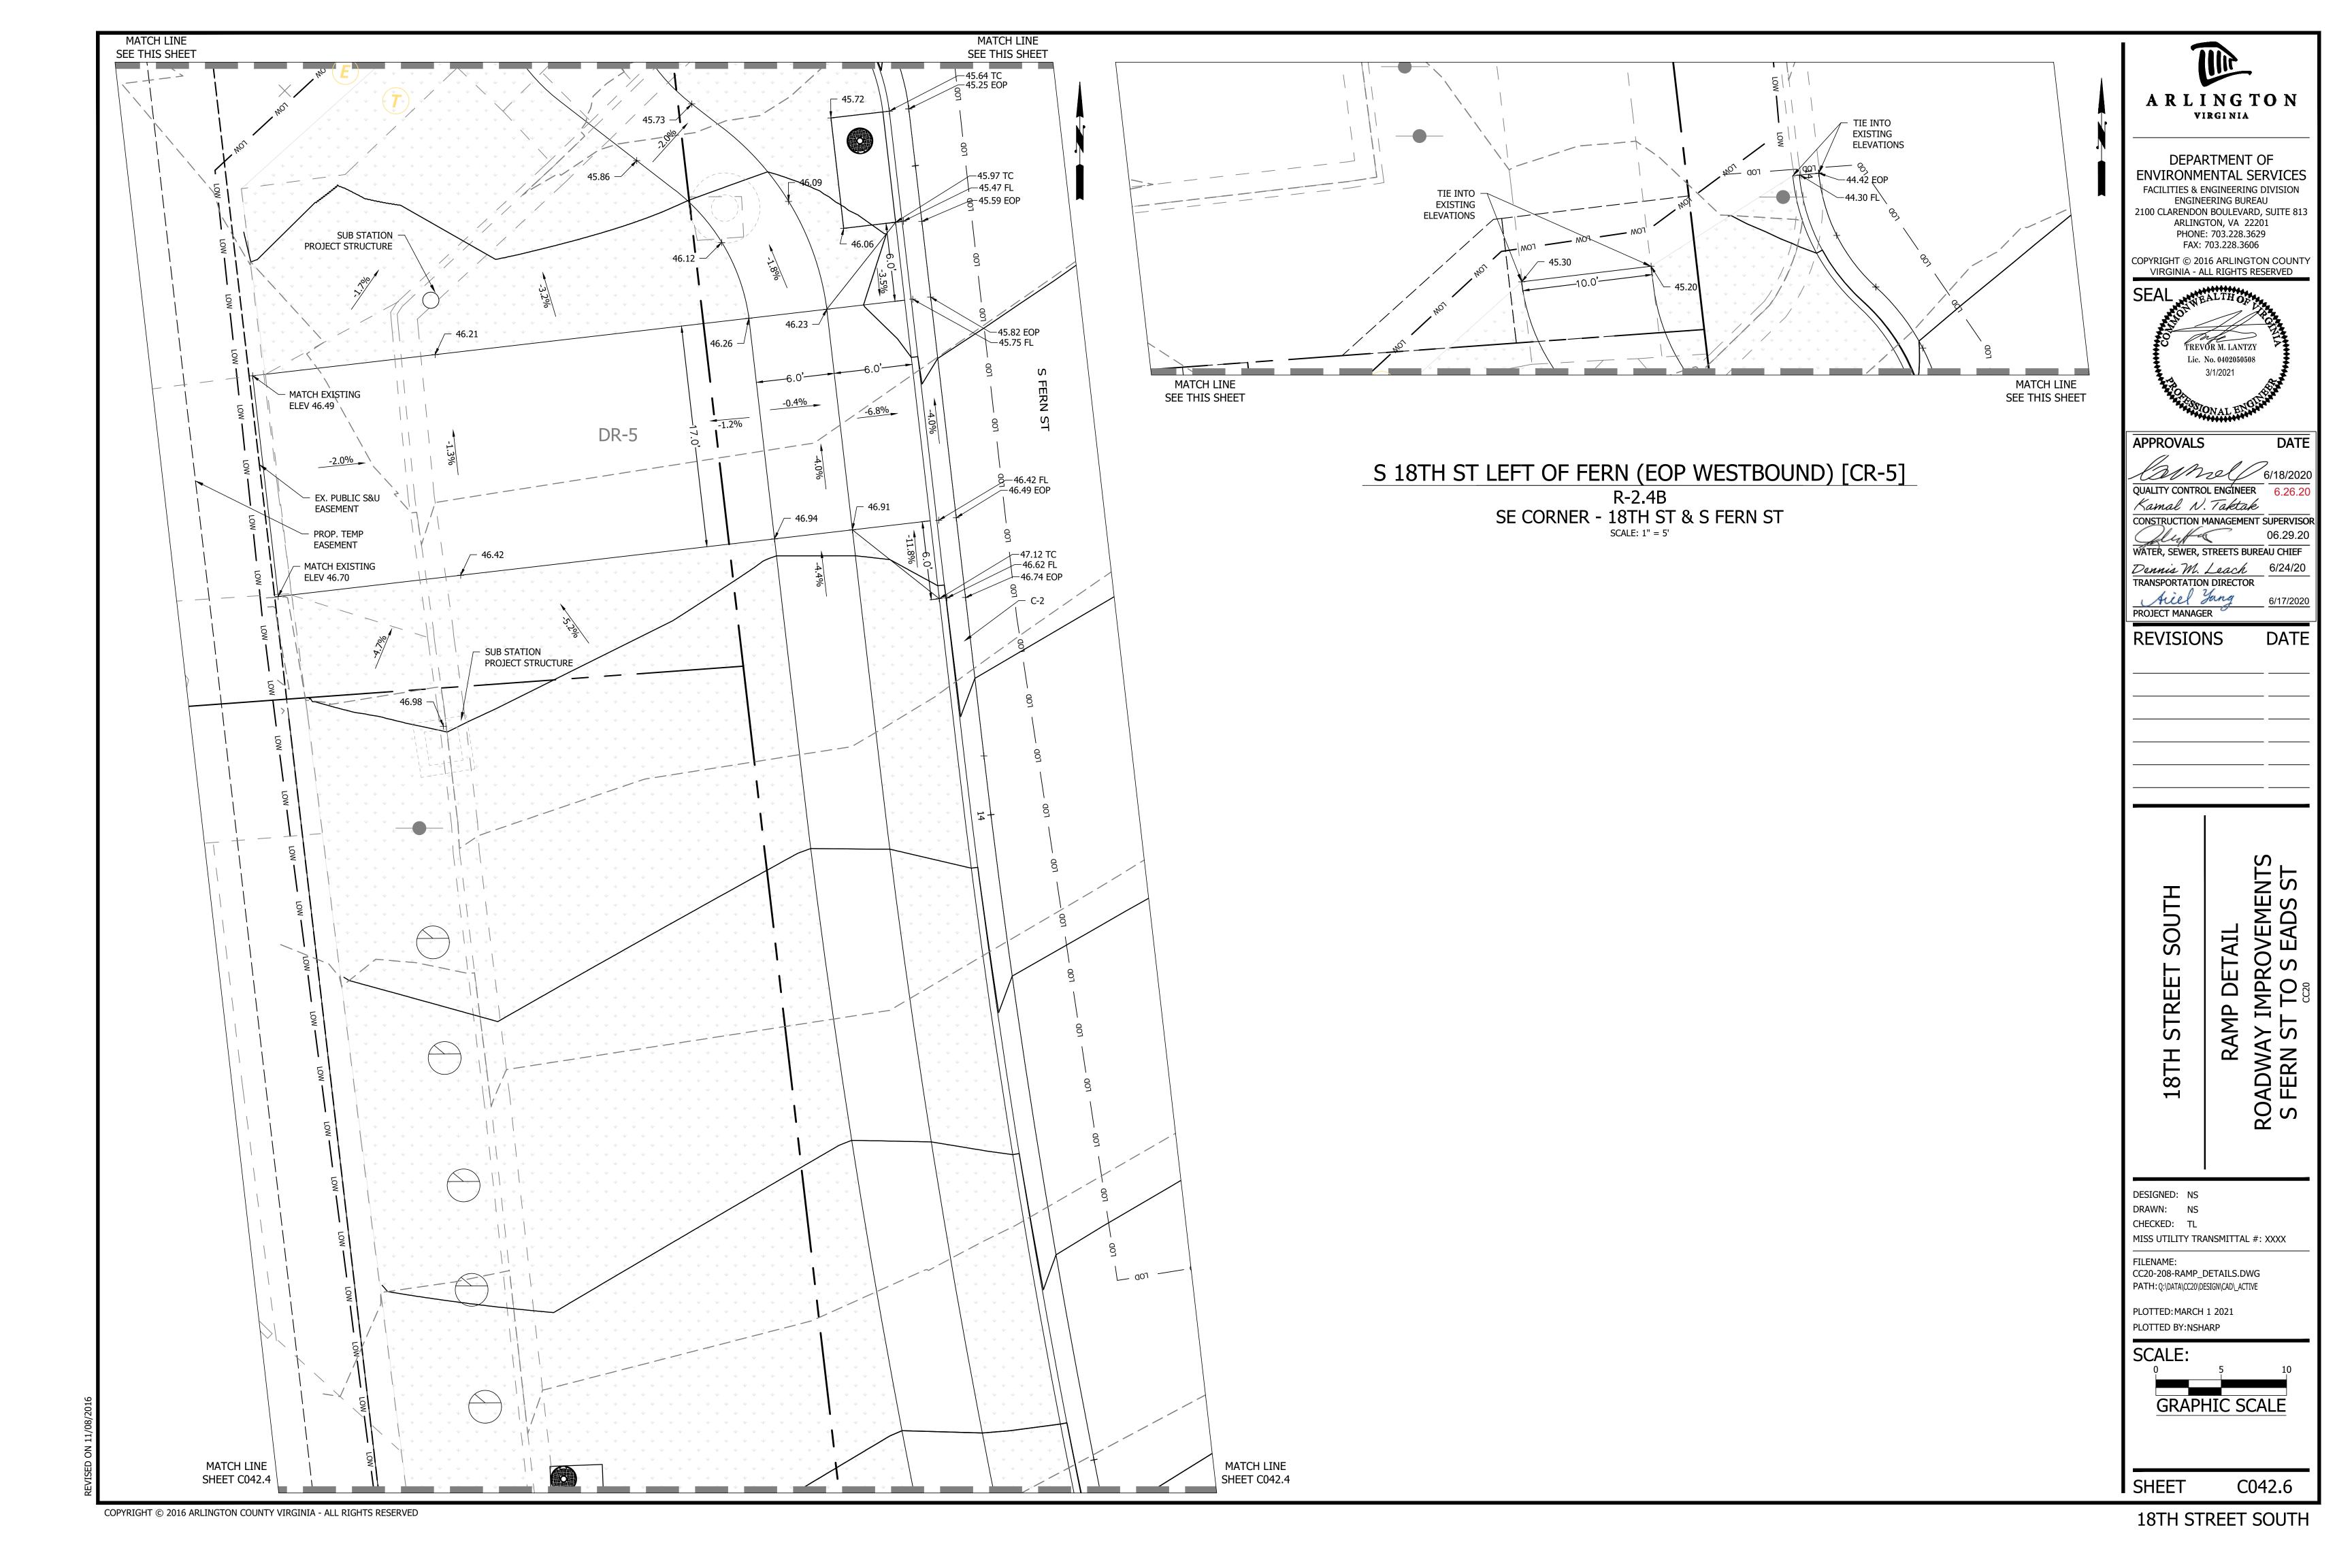


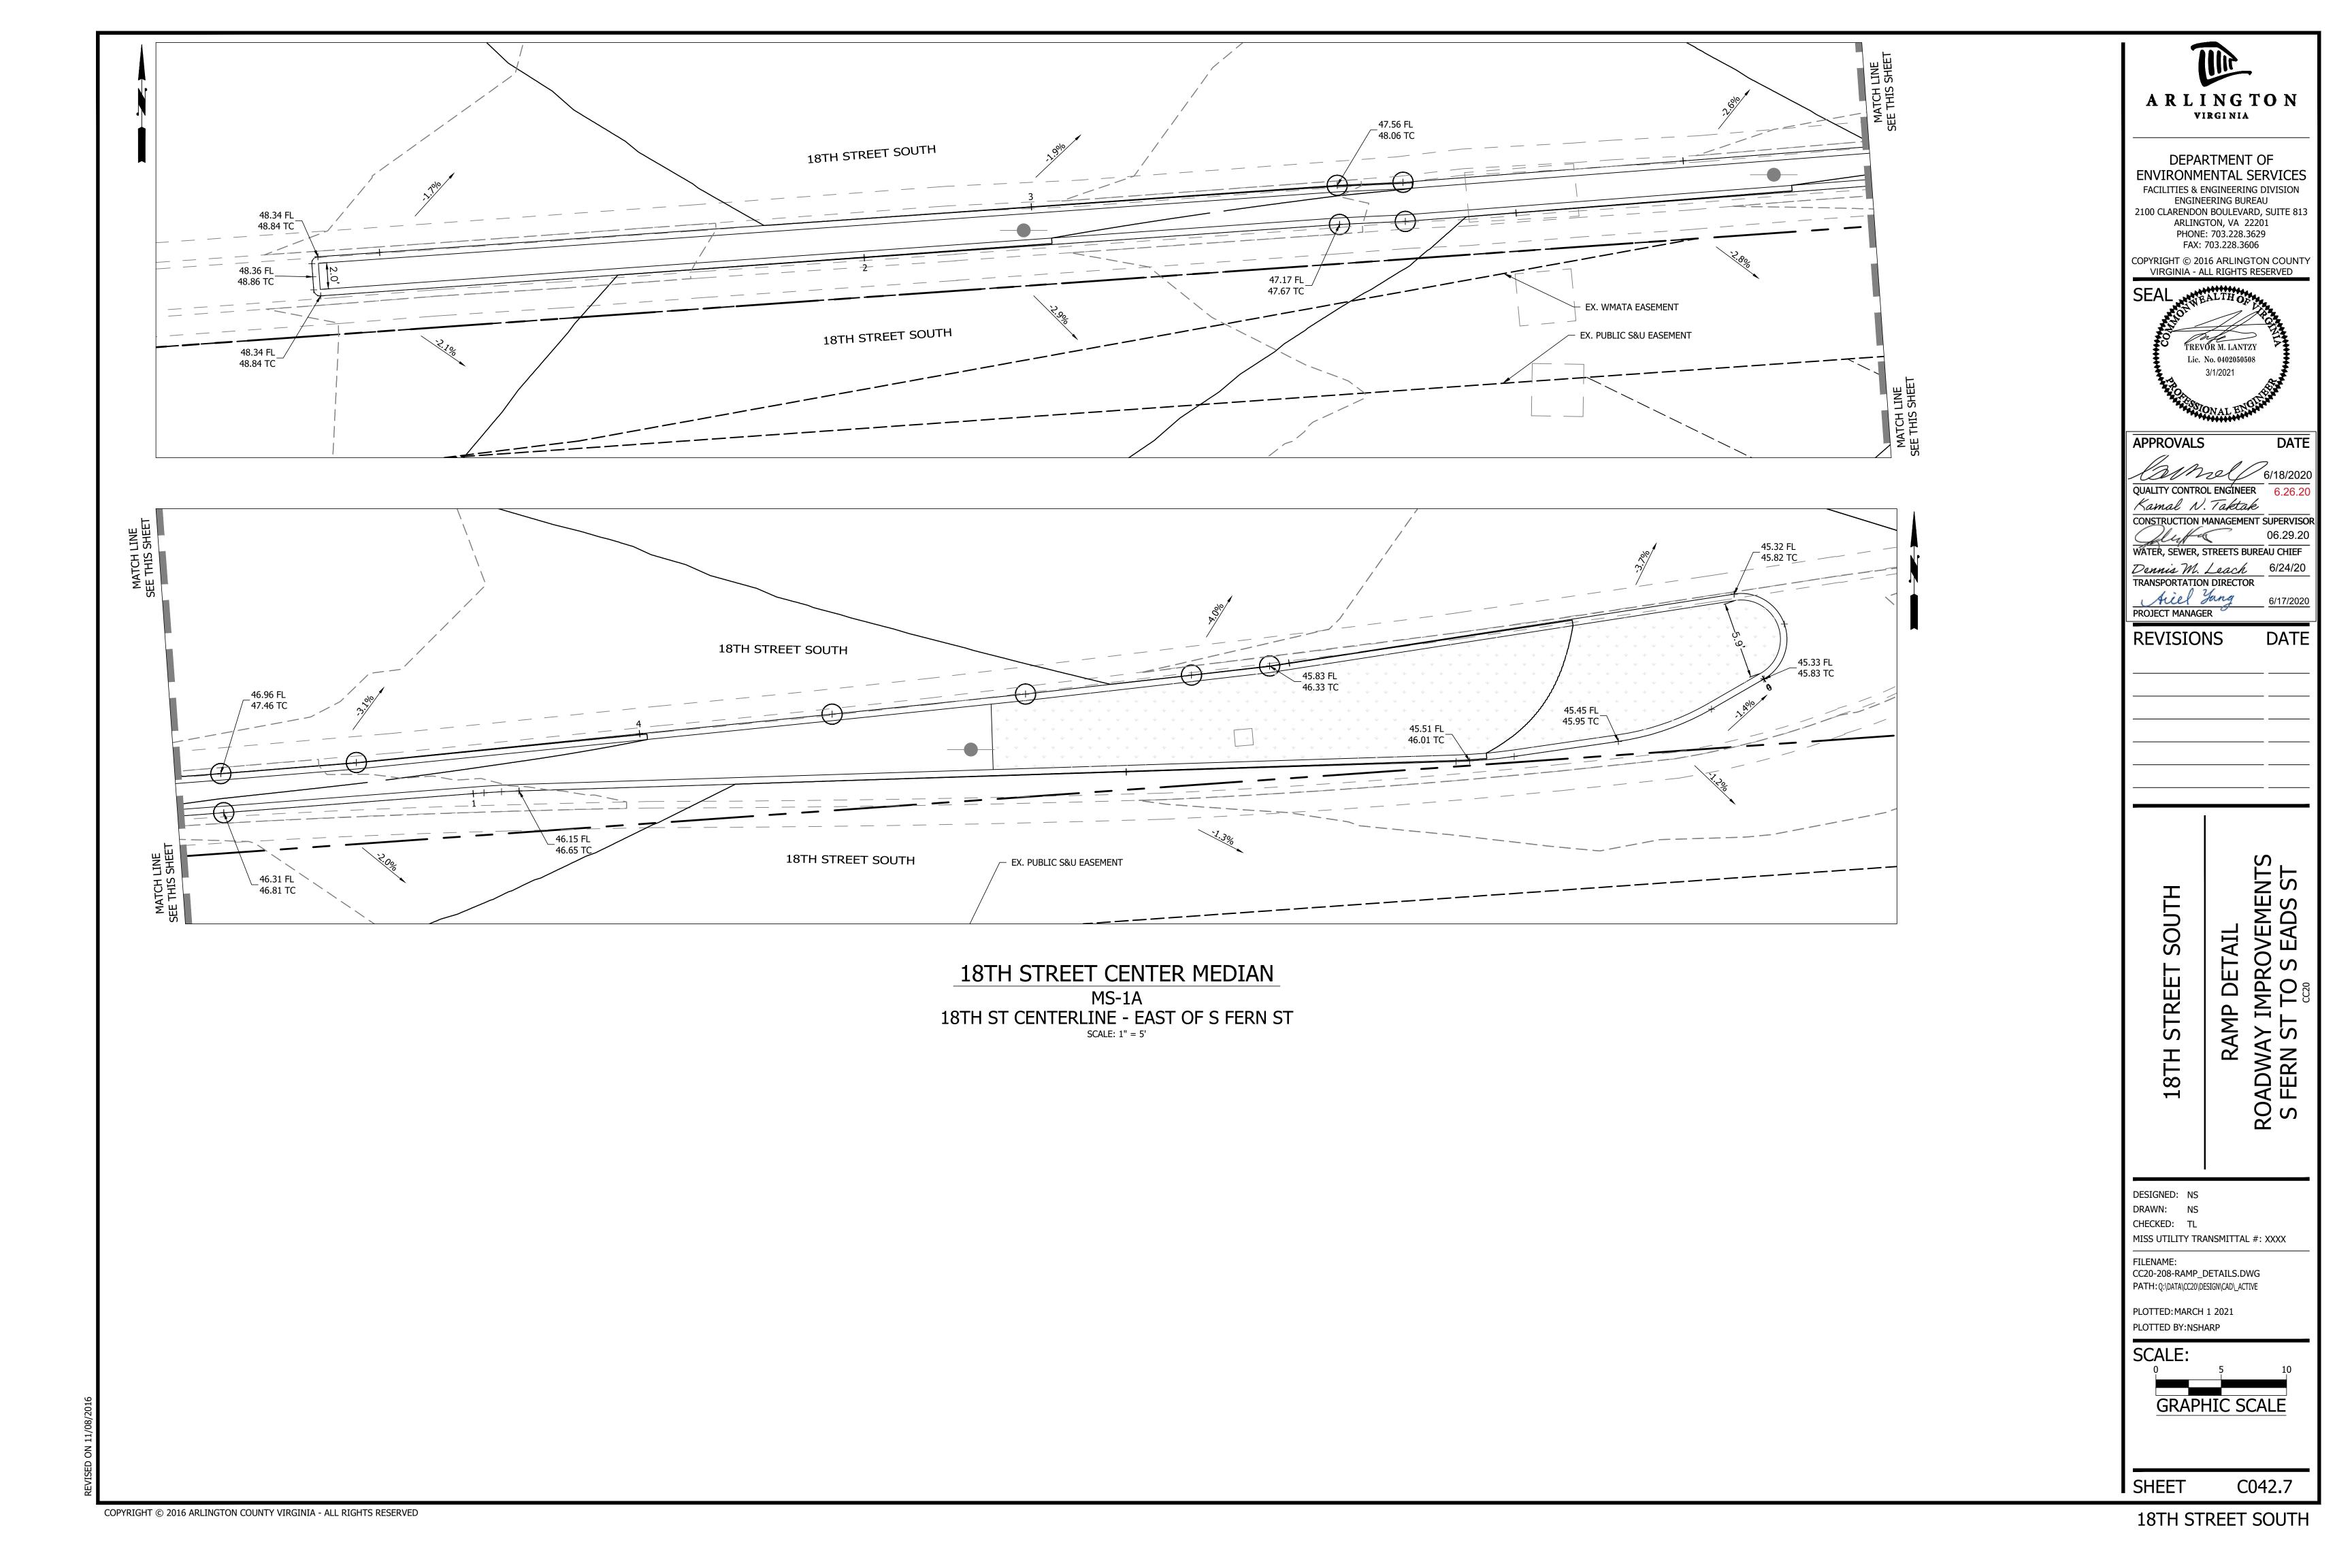


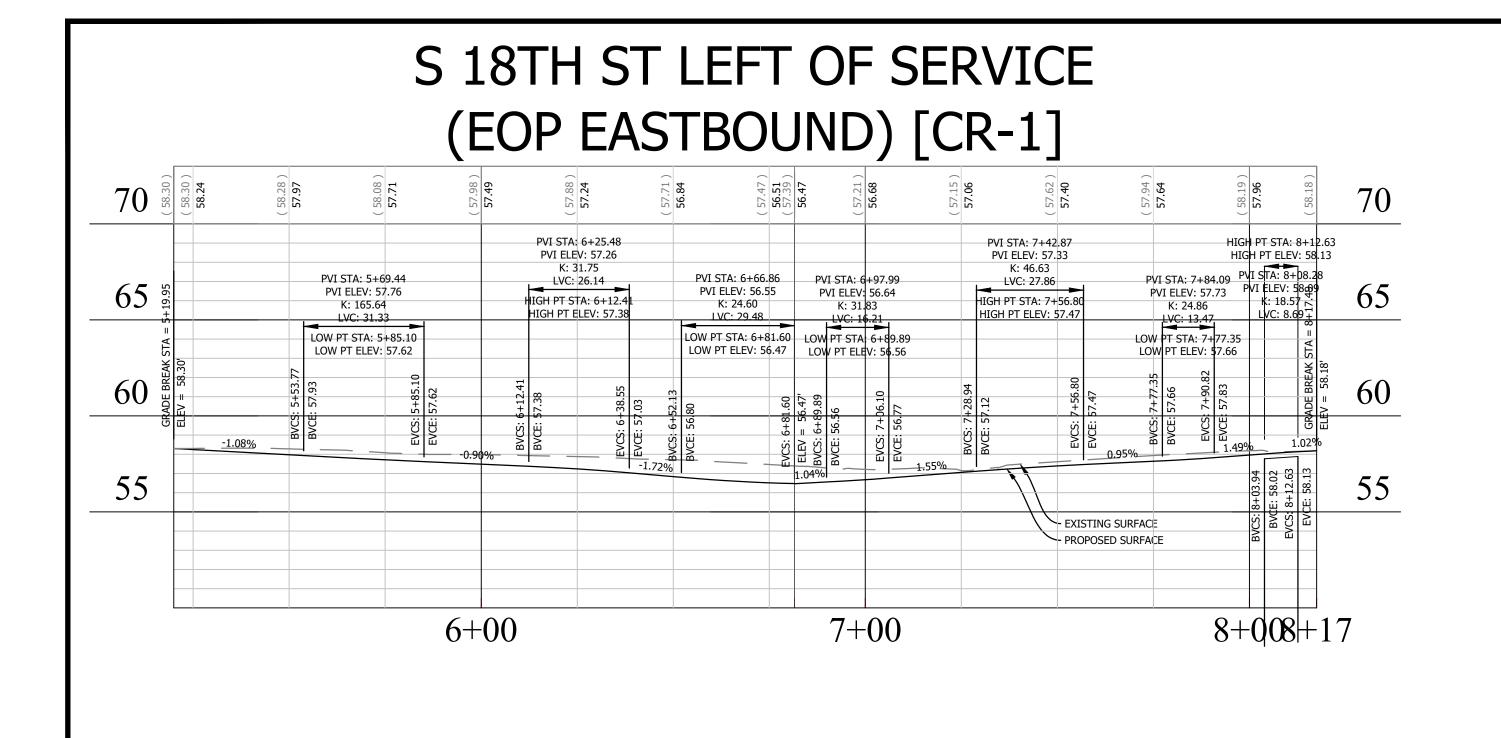


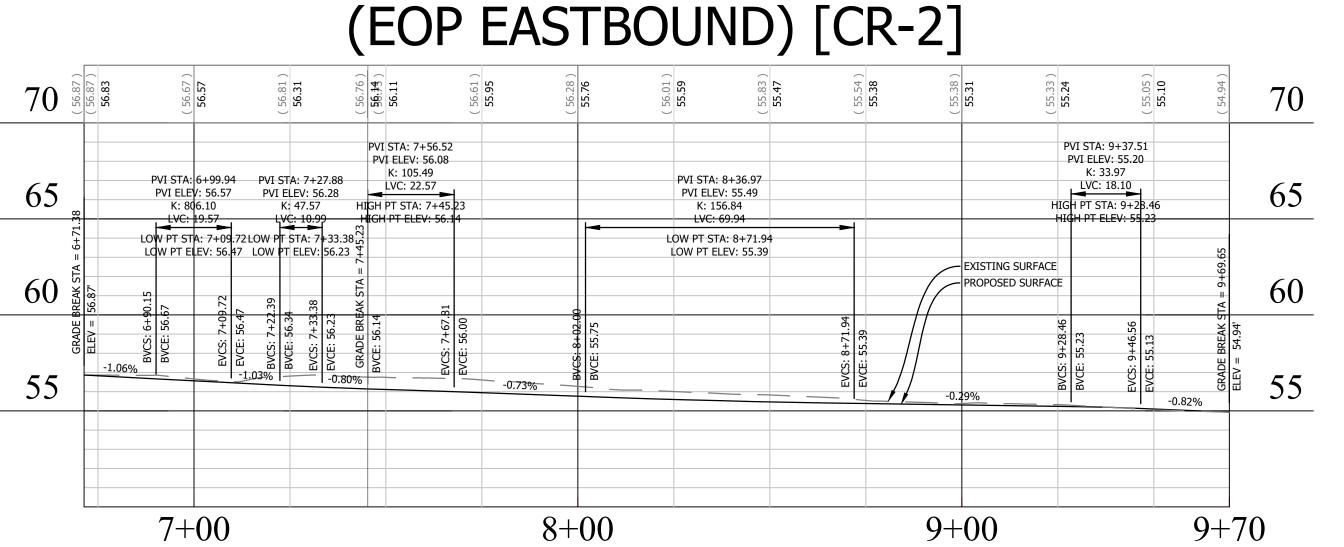


S 18TH ST LEFT OF FERN

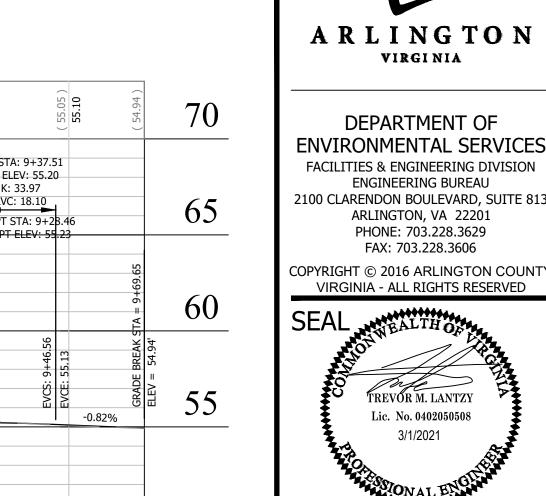


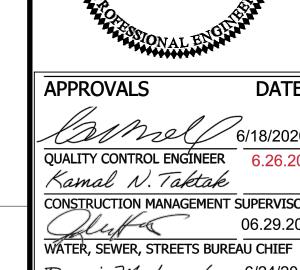

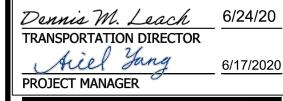


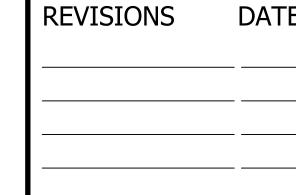

RETURN PROFILE /AY IMPROVEMENTS \text{V ST TO S EADS ST}

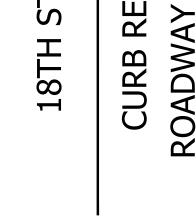


SOUTH

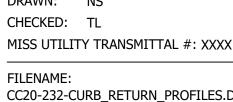


CC20-232-CURB\_RETURN\_PROFILES.DWG PATH: Q:\DATA\CC20\DESIGN\CAD\\_ACTIVE

PLOTTED: MARCH 1 2021 PLOTTED BY: NSHARP


DESIGNED: NS

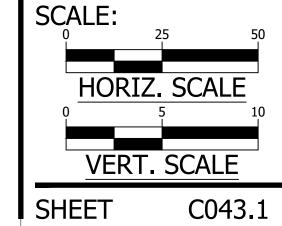


# S 18TH ST RIGHT OF FERN (EOP EASTBOUND) [CR-3]

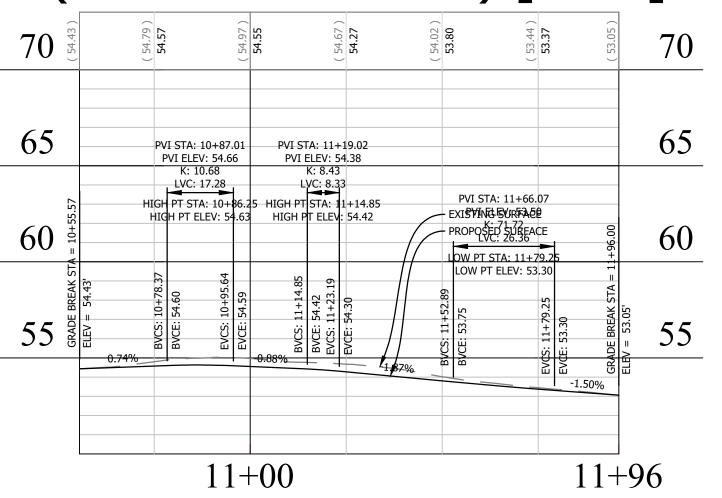





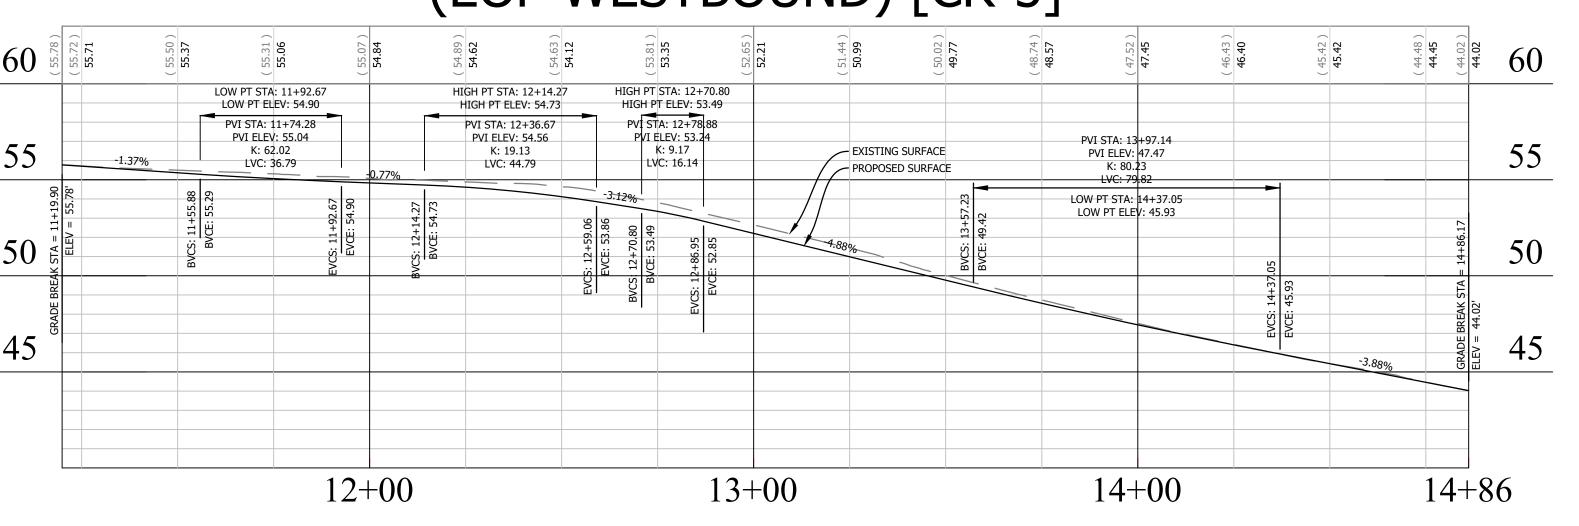



# S 18TH ST RIGHT OF FERN (EOP WESTBOUND) [CR-4]

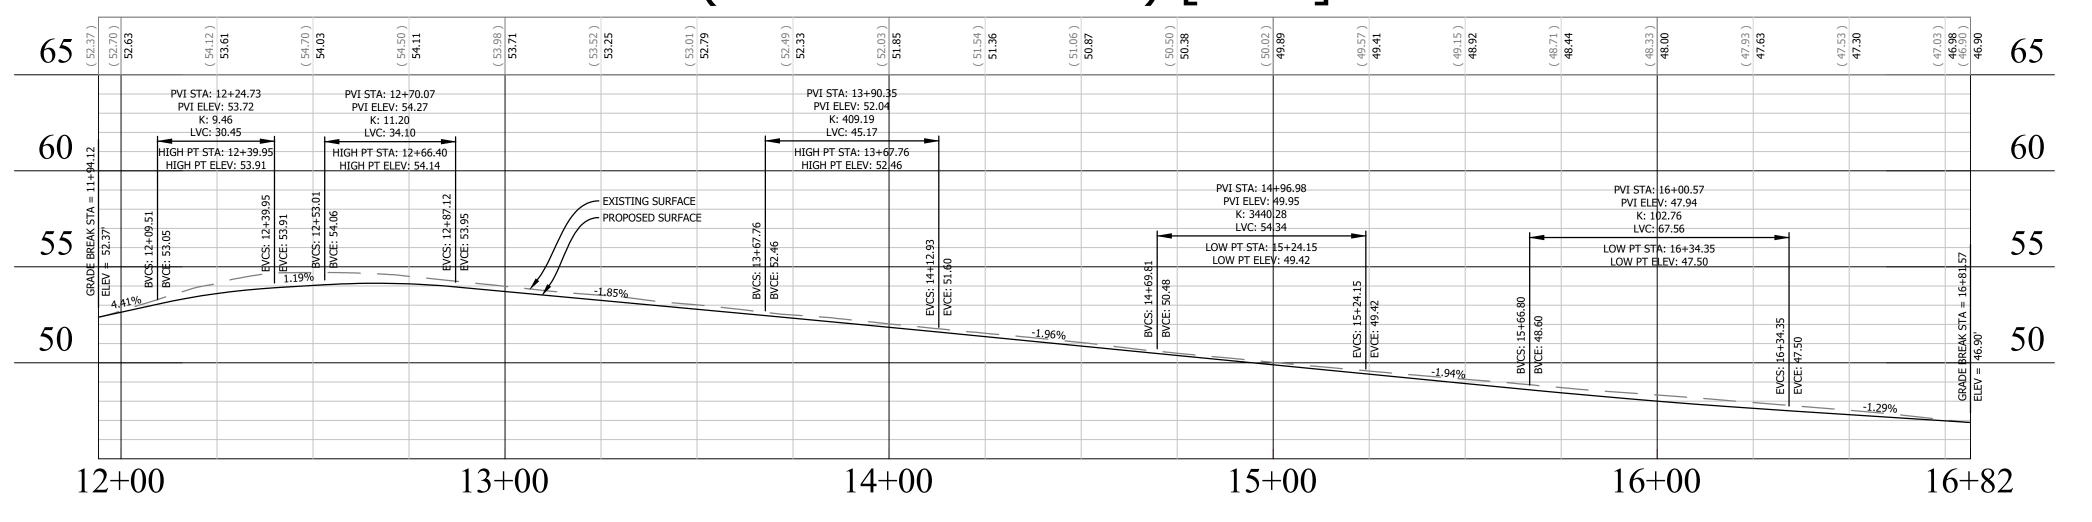

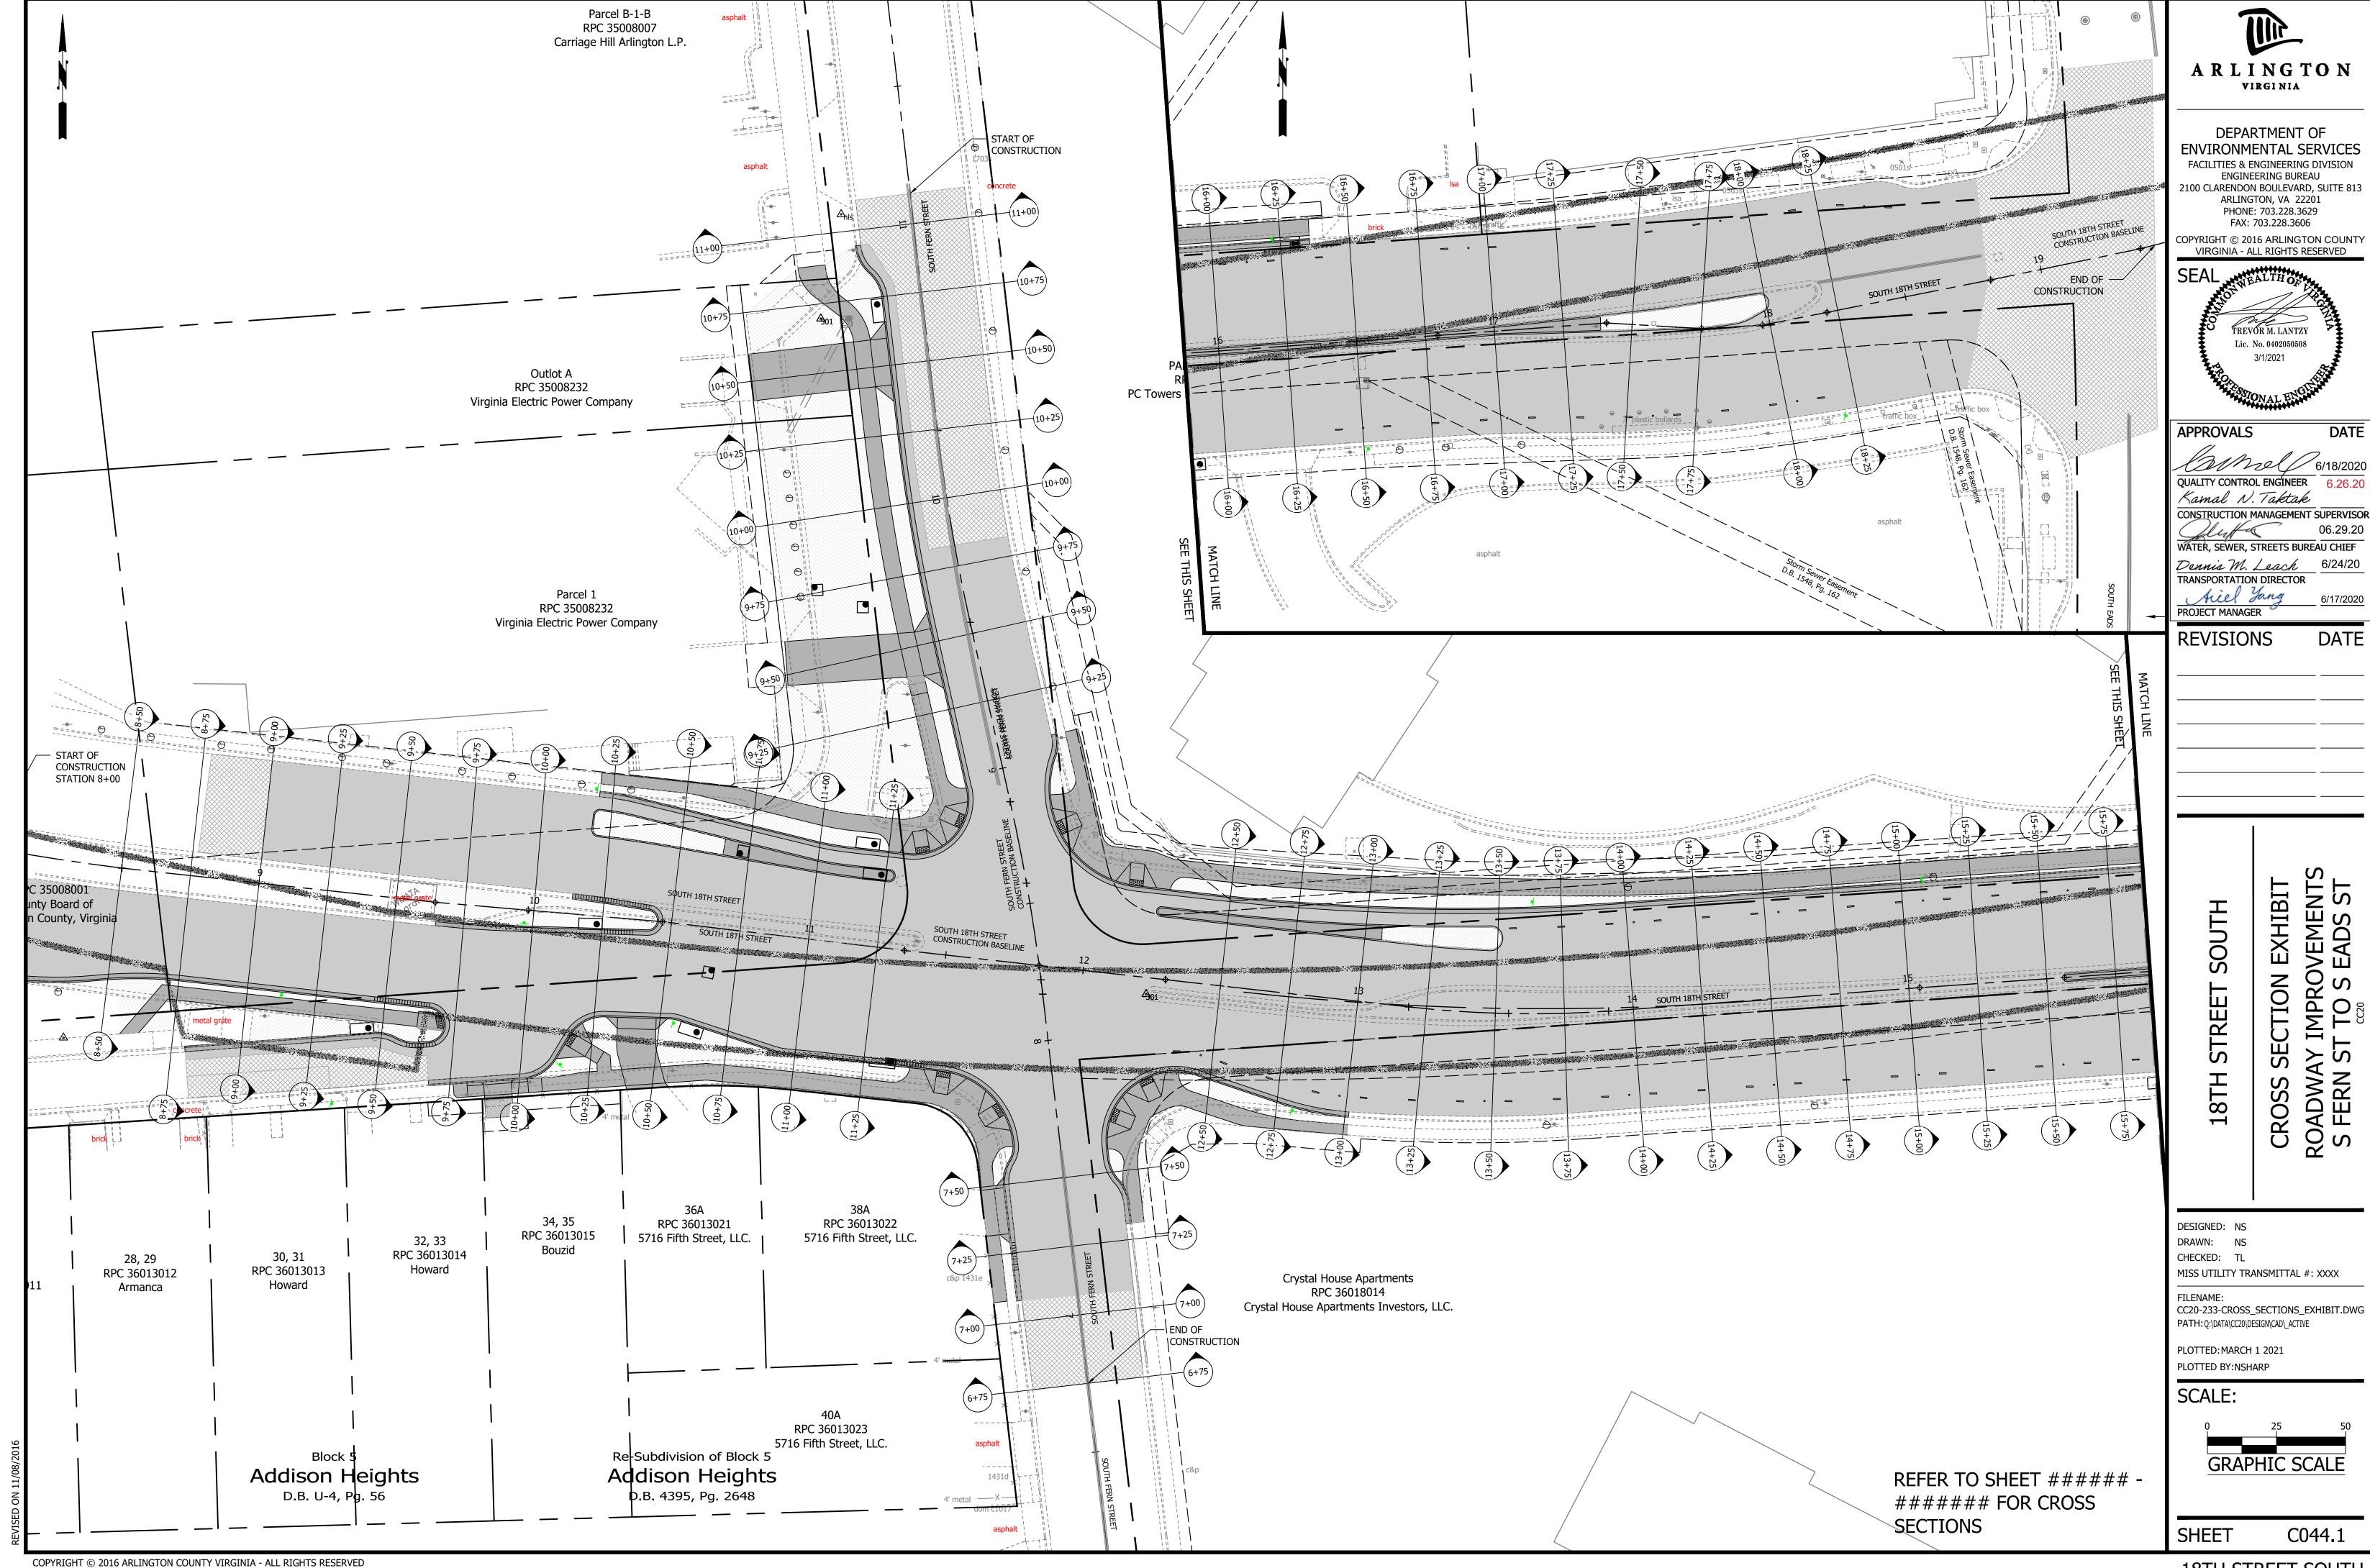

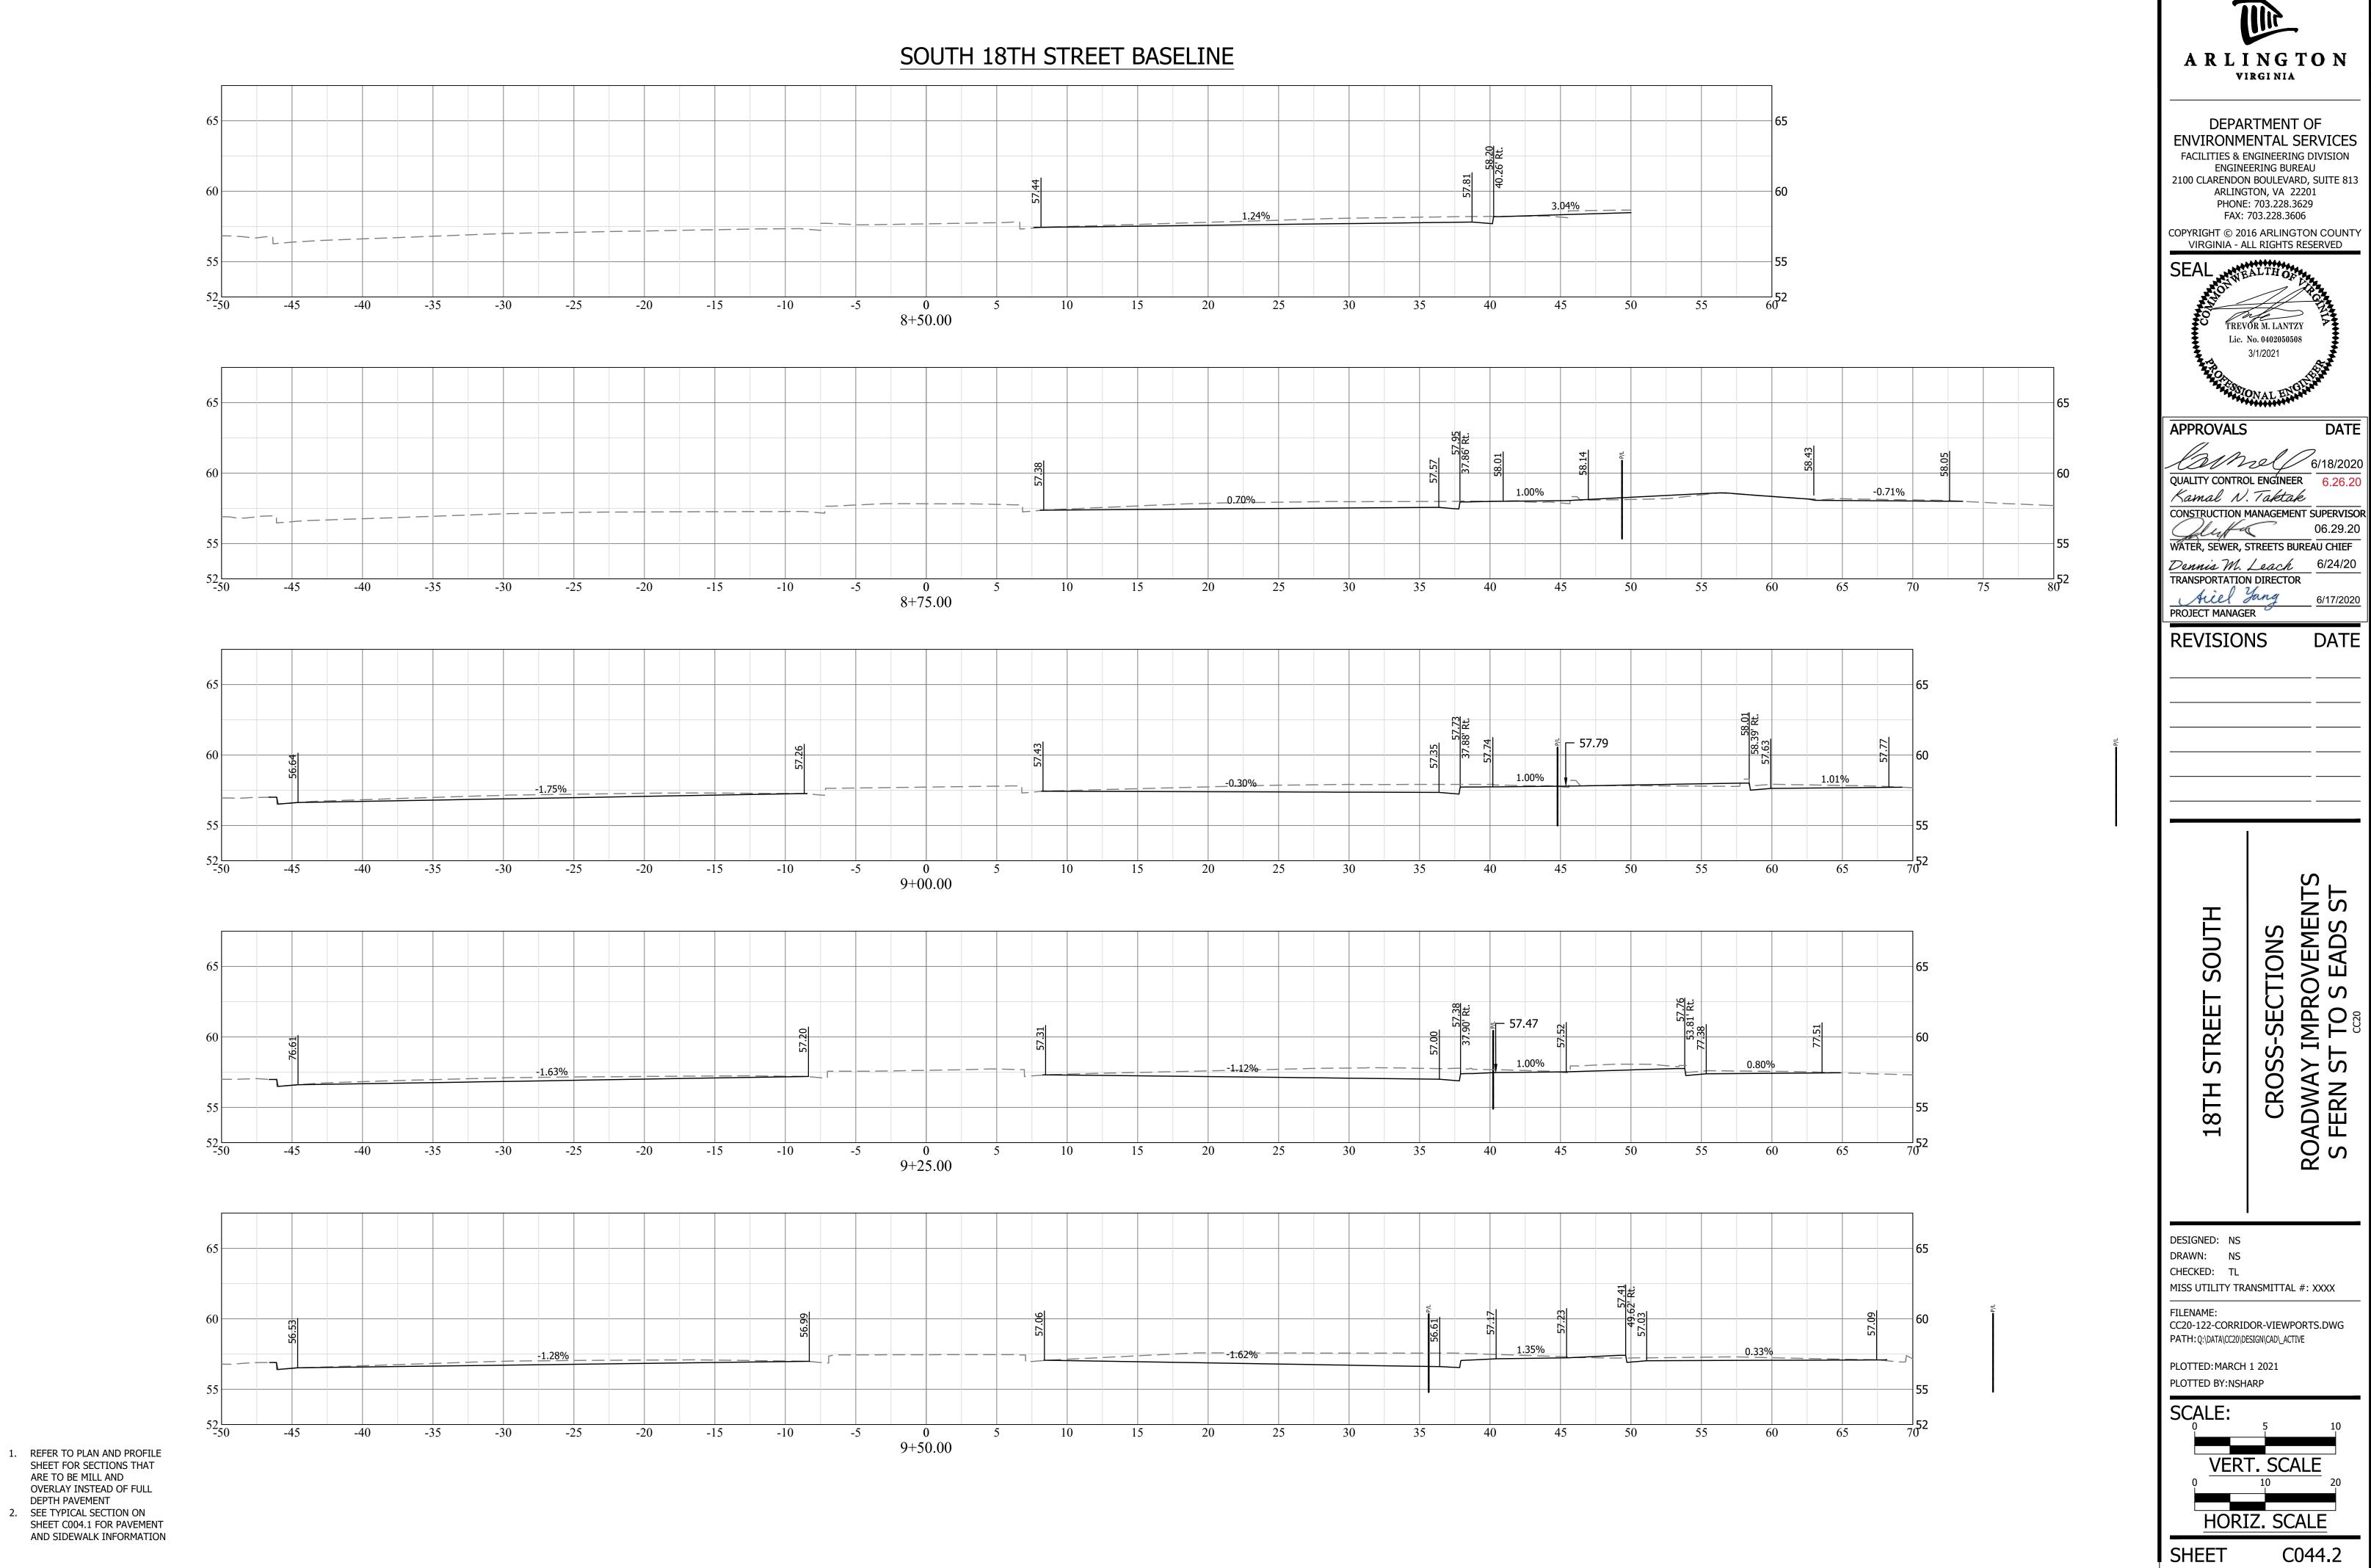

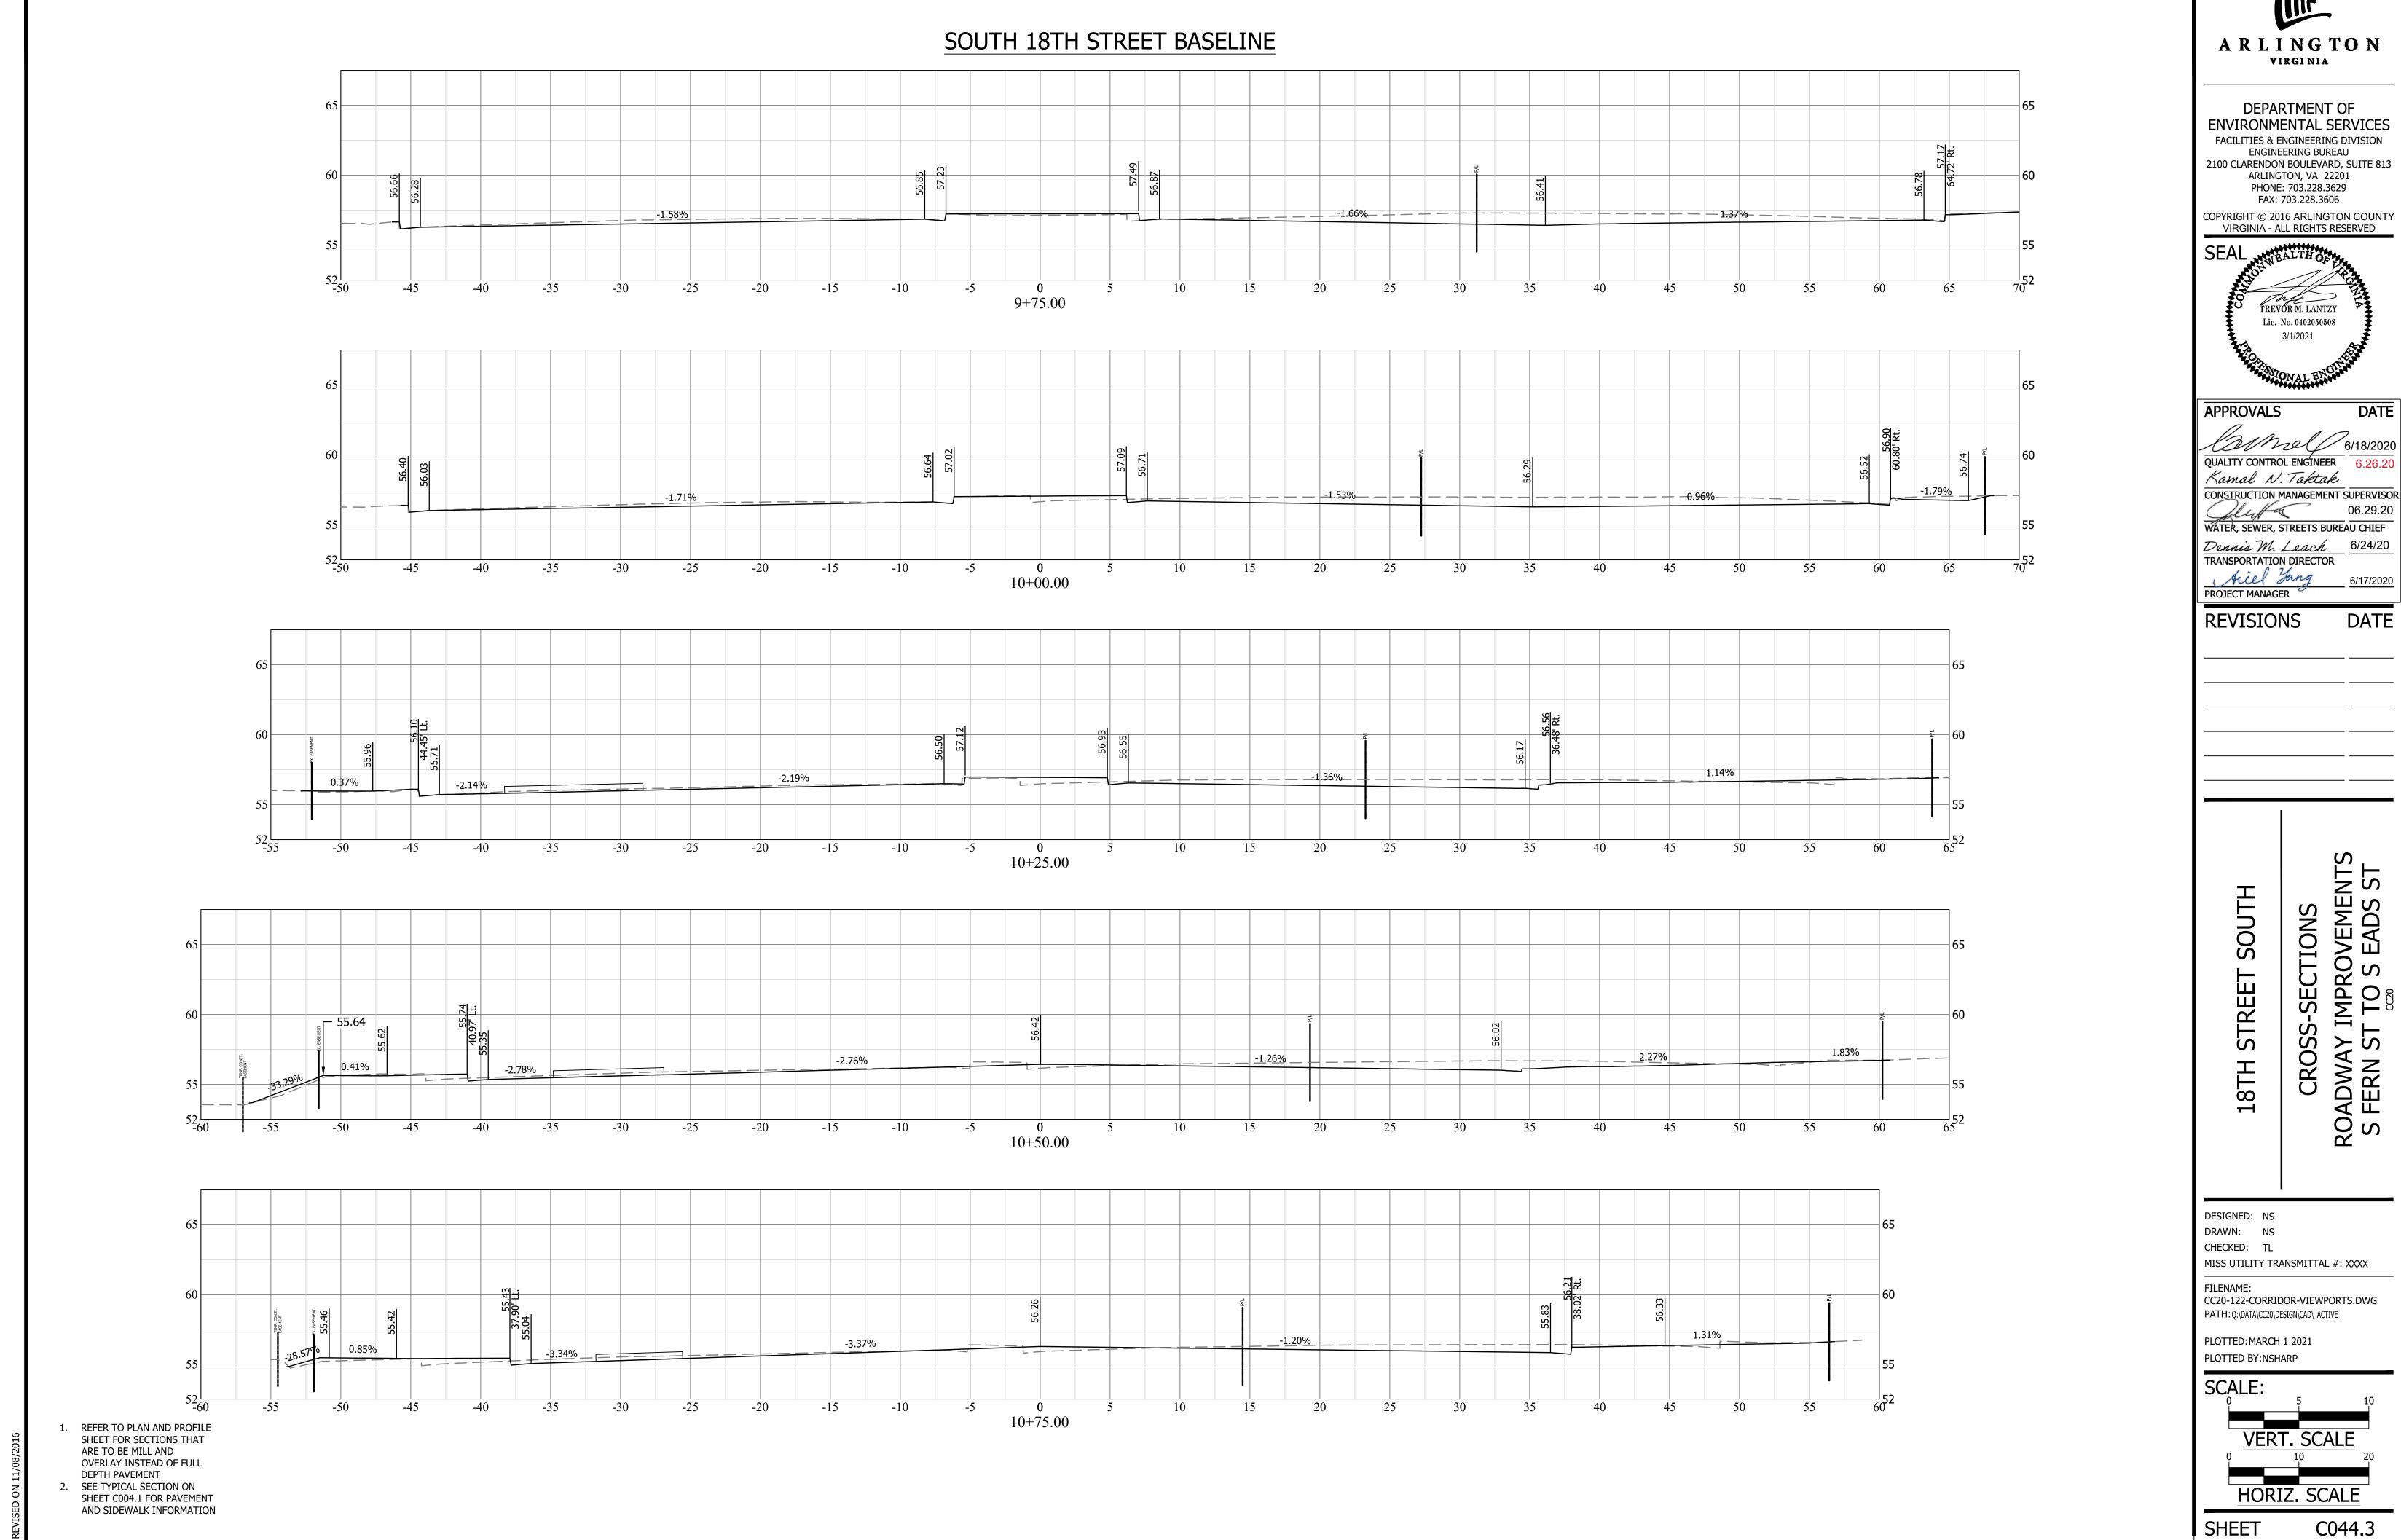

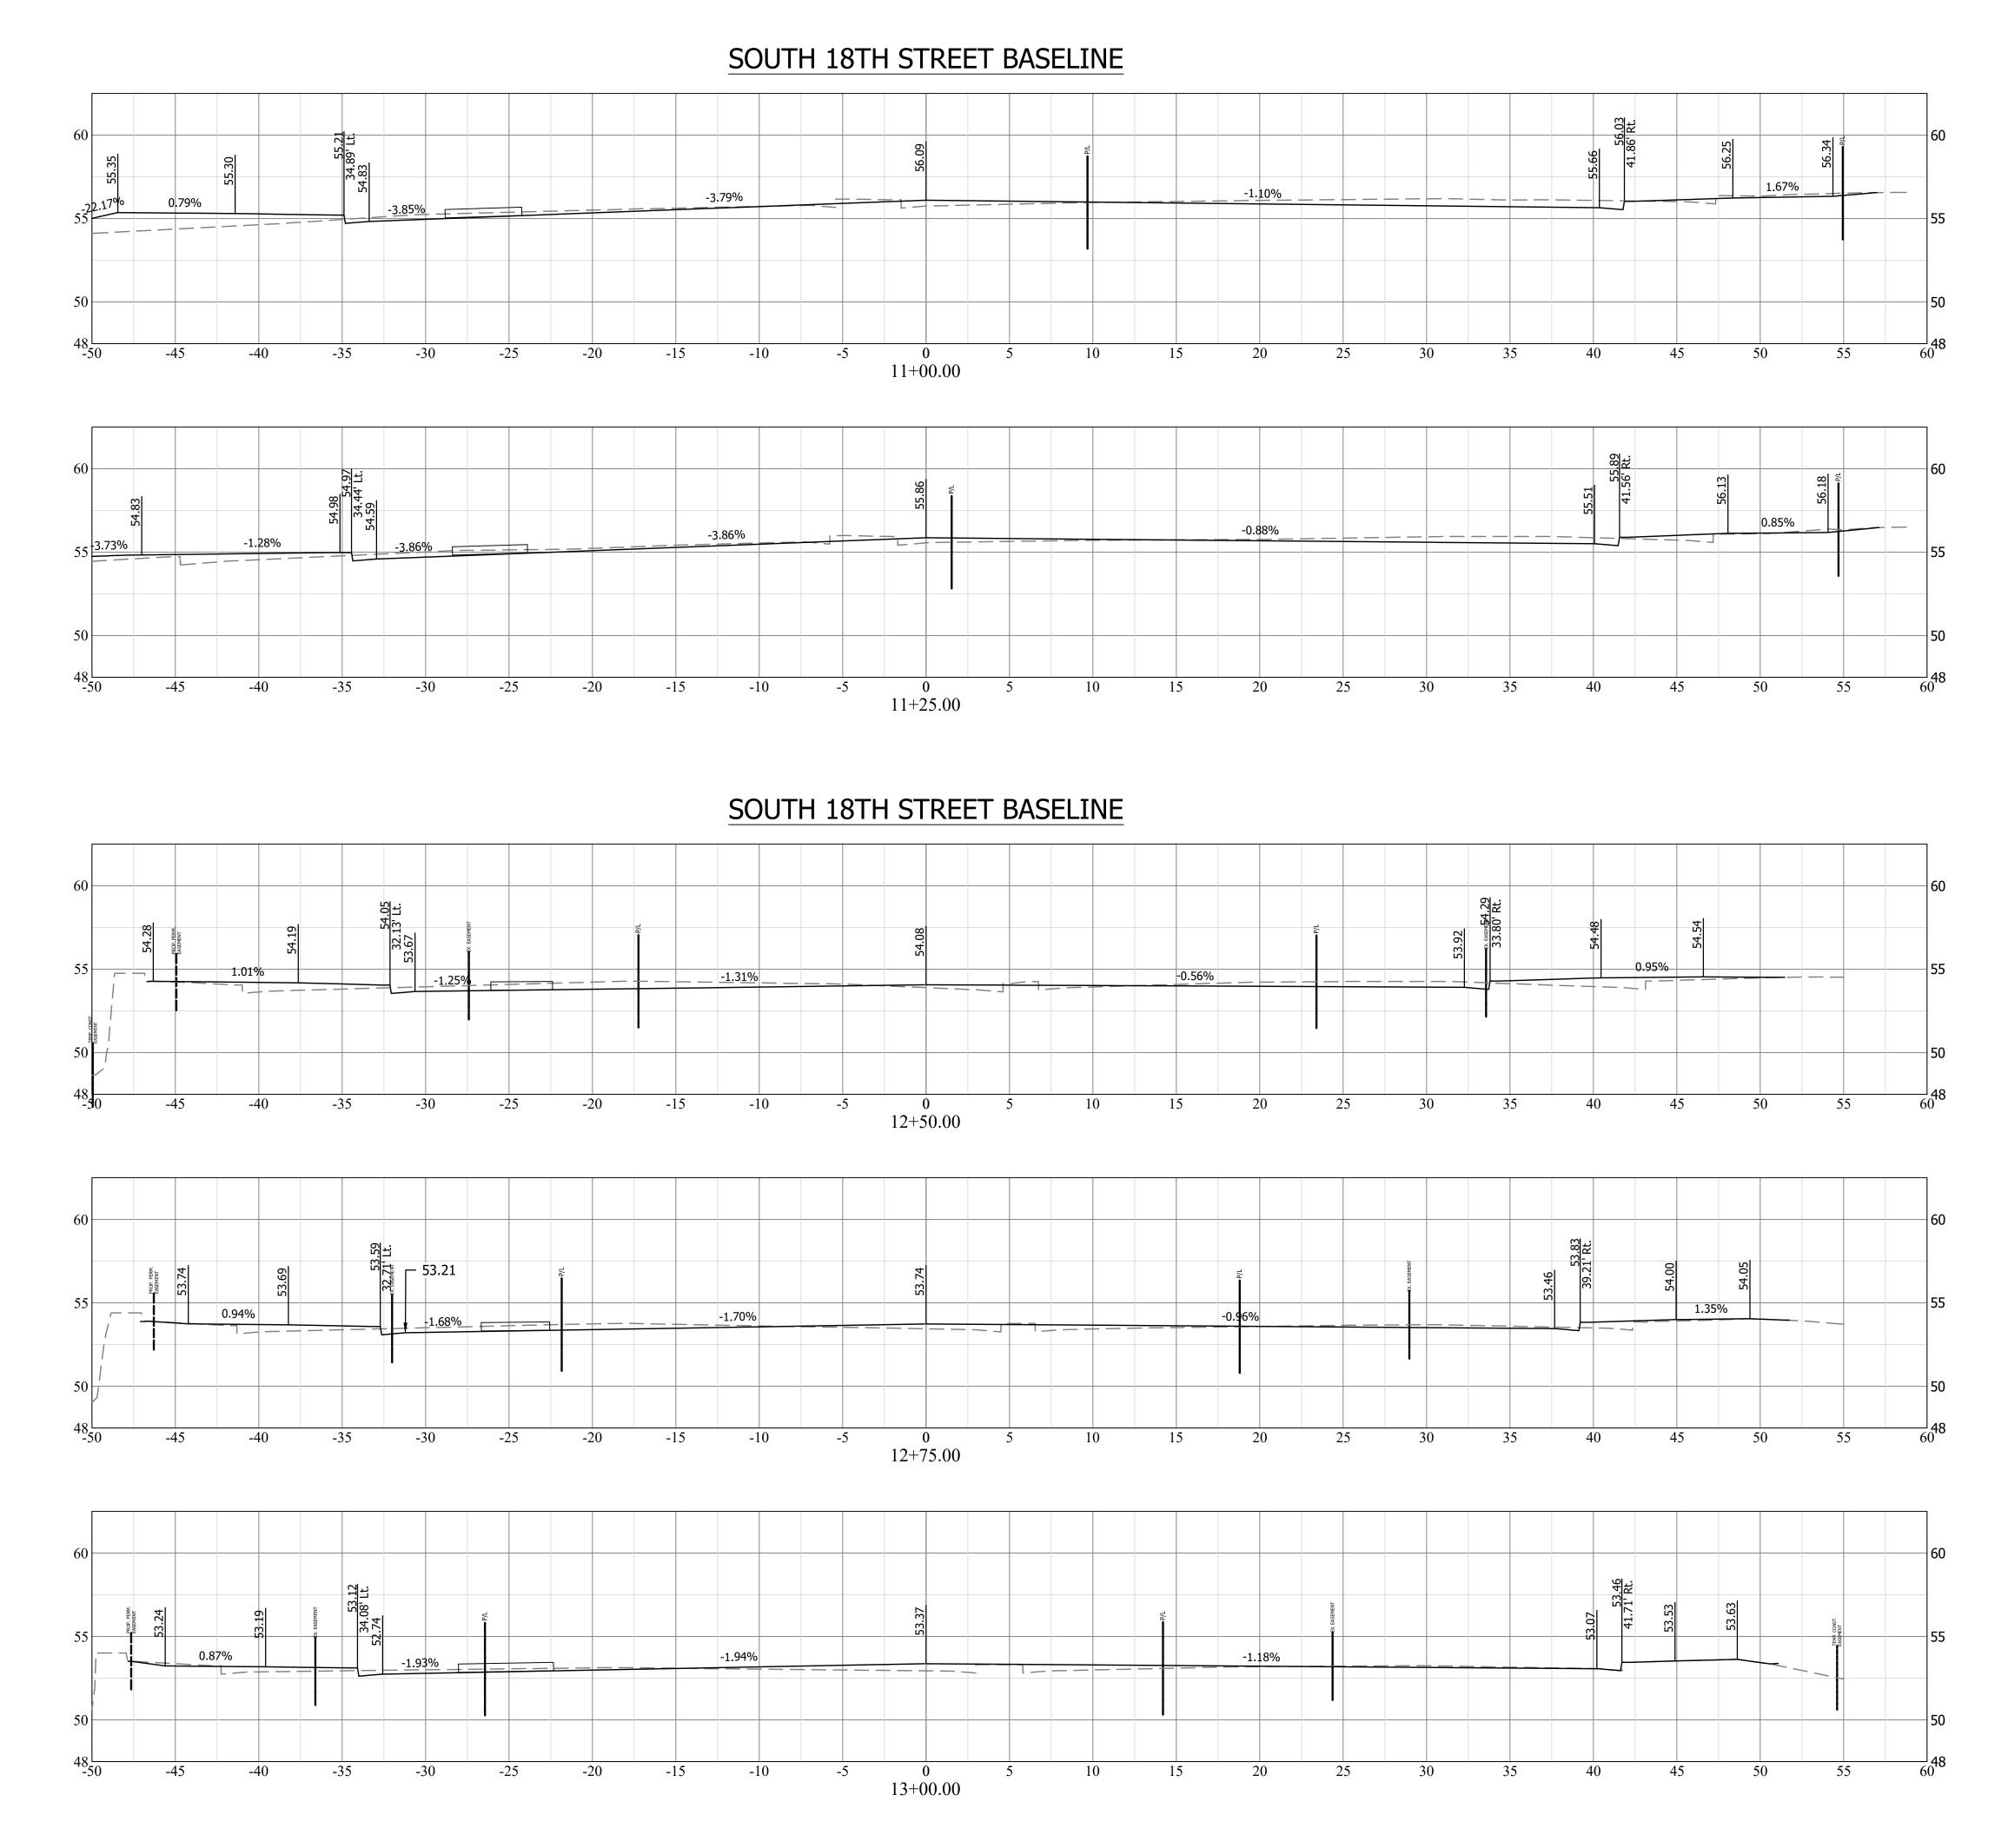

DEPARTMENT OF
ENVIRONMENTAL SERVICES
FACILITIES & ENGINEERING DIVISION
ENGINEERING BUREAU
2100 CLARENDON BOULEVARD, SUITE 813
ARLINGTON, VA 22201
PHONE: 703.228.3629
FAX: 703.228.3606

COPYRIGHT © 2016 ARLINGTON COUNTY
VIRGINIA - ALL RIGHTS RESERVED

SEAL

TREVOR M. LANTZY

APPROVALS

DATE

6/18/2020

QUALITY CONTROL ENGINEER

Kamal N. Taktak

CONSTRUCTION MANAGEMENT SUPERVISOR

WATER, SEWER, STREETS BUREAU CHIEF

Dennis M. Leach
TRANSPORTATION DIRECTOR

Aiel Yang 6/17/2020

REVISIONS

PROJECT MANAGER

\_\_\_\_\_\_

18TH STREET SOUTH
CROSS-SECTIONS
ROADWAY IMPROVEMENTS
S FERN ST TO S EADS ST

DESIGNED: NS
DRAWN: NS
CHECKED: TL

CHECKED: TL
MISS UTILITY TRANSMITTAL #: XXXX

FILENAME:
CC20-122-CORRIDOR-VIEWPORTS.DWG
PATH: Q:\DATA\CC20\DESIGN\CAD\\_ACTIVE

PLOTTED: MARCH 1 2021 PLOTTED BY: NSHARP

VERT. SCALE

O 10 20

HORIZ. SCALE

SHEET C044.4


1. REFER TO PLAN AND PROFILE

2. SEE TYPICAL SECTION ON

SHEET FOR SECTIONS THAT ARE TO BE MILL AND

OVERLAY INSTEAD OF FULL DEPTH PAVEMENT

SHEET C004.1 FOR PAVEMENT AND SIDEWALK INFORMATION

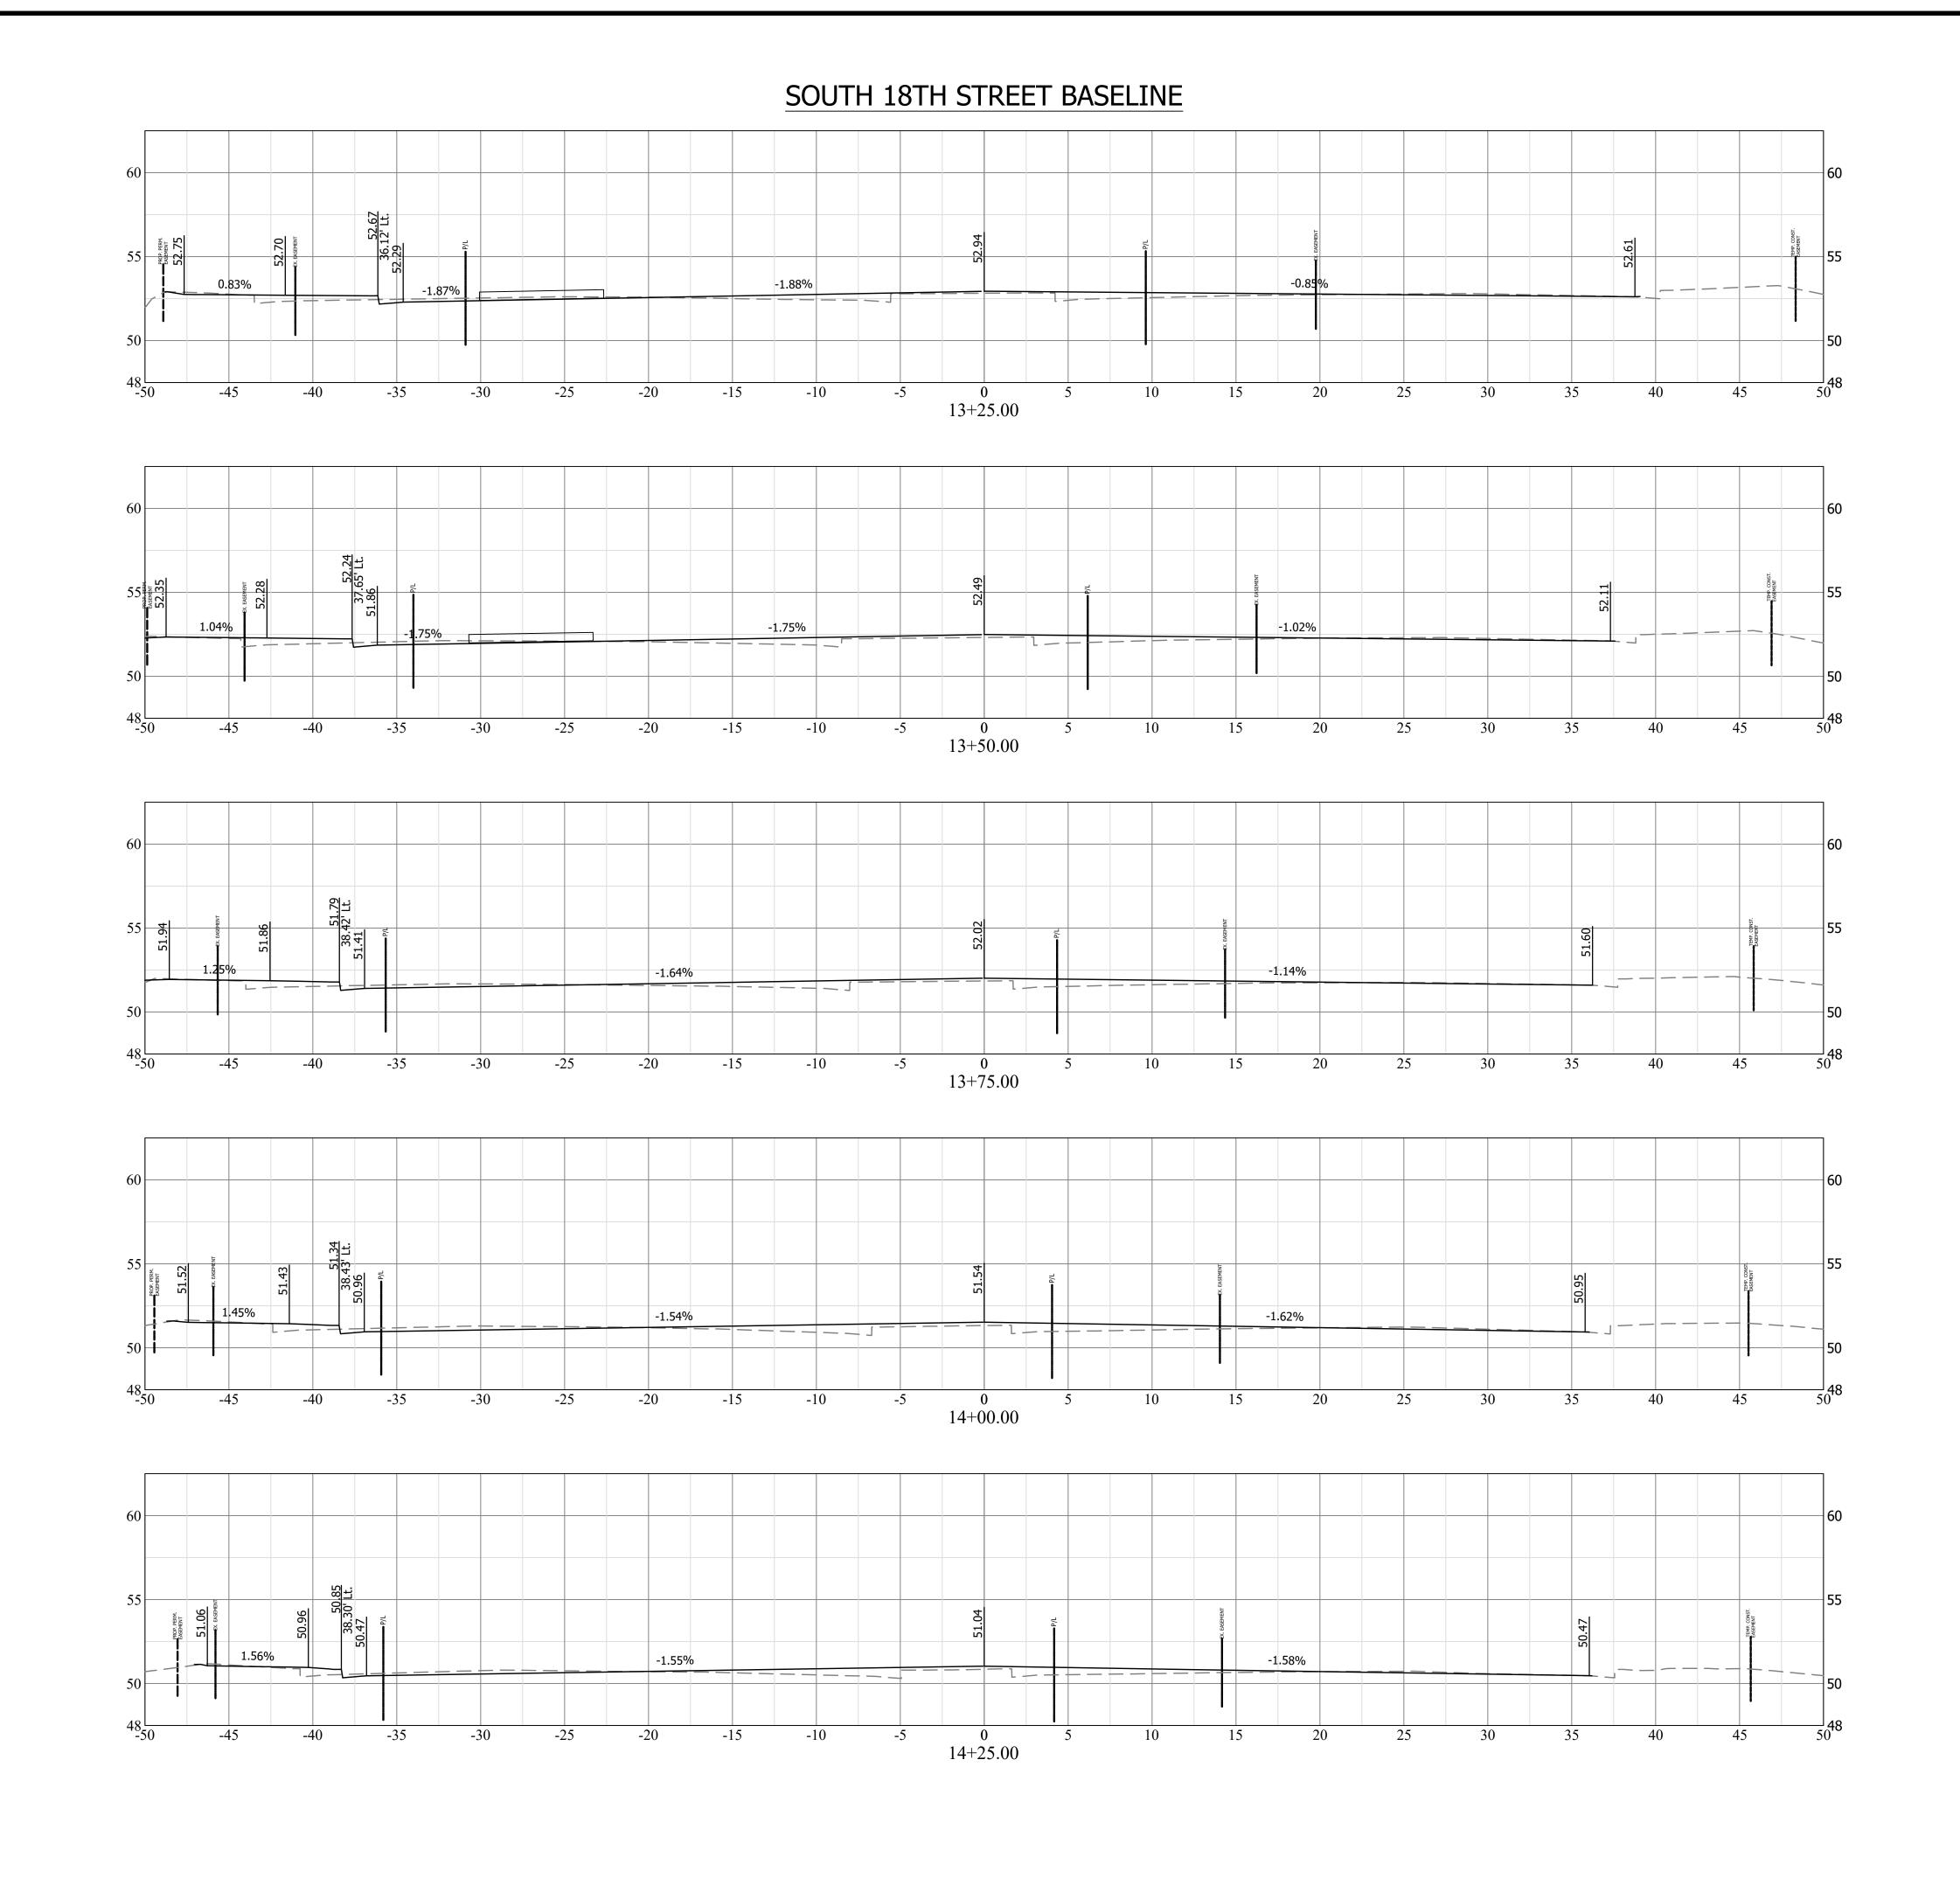

ARLINGTON VIRGINIA DEPARTMENT OF **ENVIRONMENTAL SERVICES** FACILITIES & ENGINEERING DIVISION ENGINEERING BUREAU 2100 CLARENDON BOULEVARD, SUITE 813 ARLINGTON, VA 22201 PHONE: 703.228.3629 FAX: 703.228.3606 COPYRIGHT © 2016 ARLINGTON COUNTY VIRGINIA - ALL RIGHTS RESERVED APPROVALS DATE QUALITY CONTROL ENGINEER 6.26.20 Kamal N. Taktak CONSTRUCTION MANAGEMENT SUPERVISOR WATER, SEWER, STREETS BUREAU CHIEF Dennis M. Leach
TRANSPORTATION DIRECTOR

6/24/20 Sicel Yang PROJECT MANAGER **REVISIONS** CROSS-SECTIONS
ROADWAY IMPROVEMENTS
S FERN ST TO S EADS ST SOUTH STREET 18TH DESIGNED: NS DRAWN: NS CHECKED: TL MISS UTILITY TRANSMITTAL #: XXXX FILENAME: CC20-122-CORRIDOR-VIEWPORTS.DWG PATH: Q:\DATA\CC20\DESIGN\CAD\\_ACTIVE

PLOTTED: MARCH 1 2021 PLOTTED BY:NSHARP

SCALE: VERT. SCALE HORIZ. SCALE

C044.5


REFER TO PLAN AND PROFILE

2. SEE TYPICAL SECTION ON

SHEET FOR SECTIONS THAT ARE TO BE MILL AND

OVERLAY INSTEAD OF FULL DEPTH PAVEMENT

SHEET C004.1 FOR PAVEMENT AND SIDEWALK INFORMATION

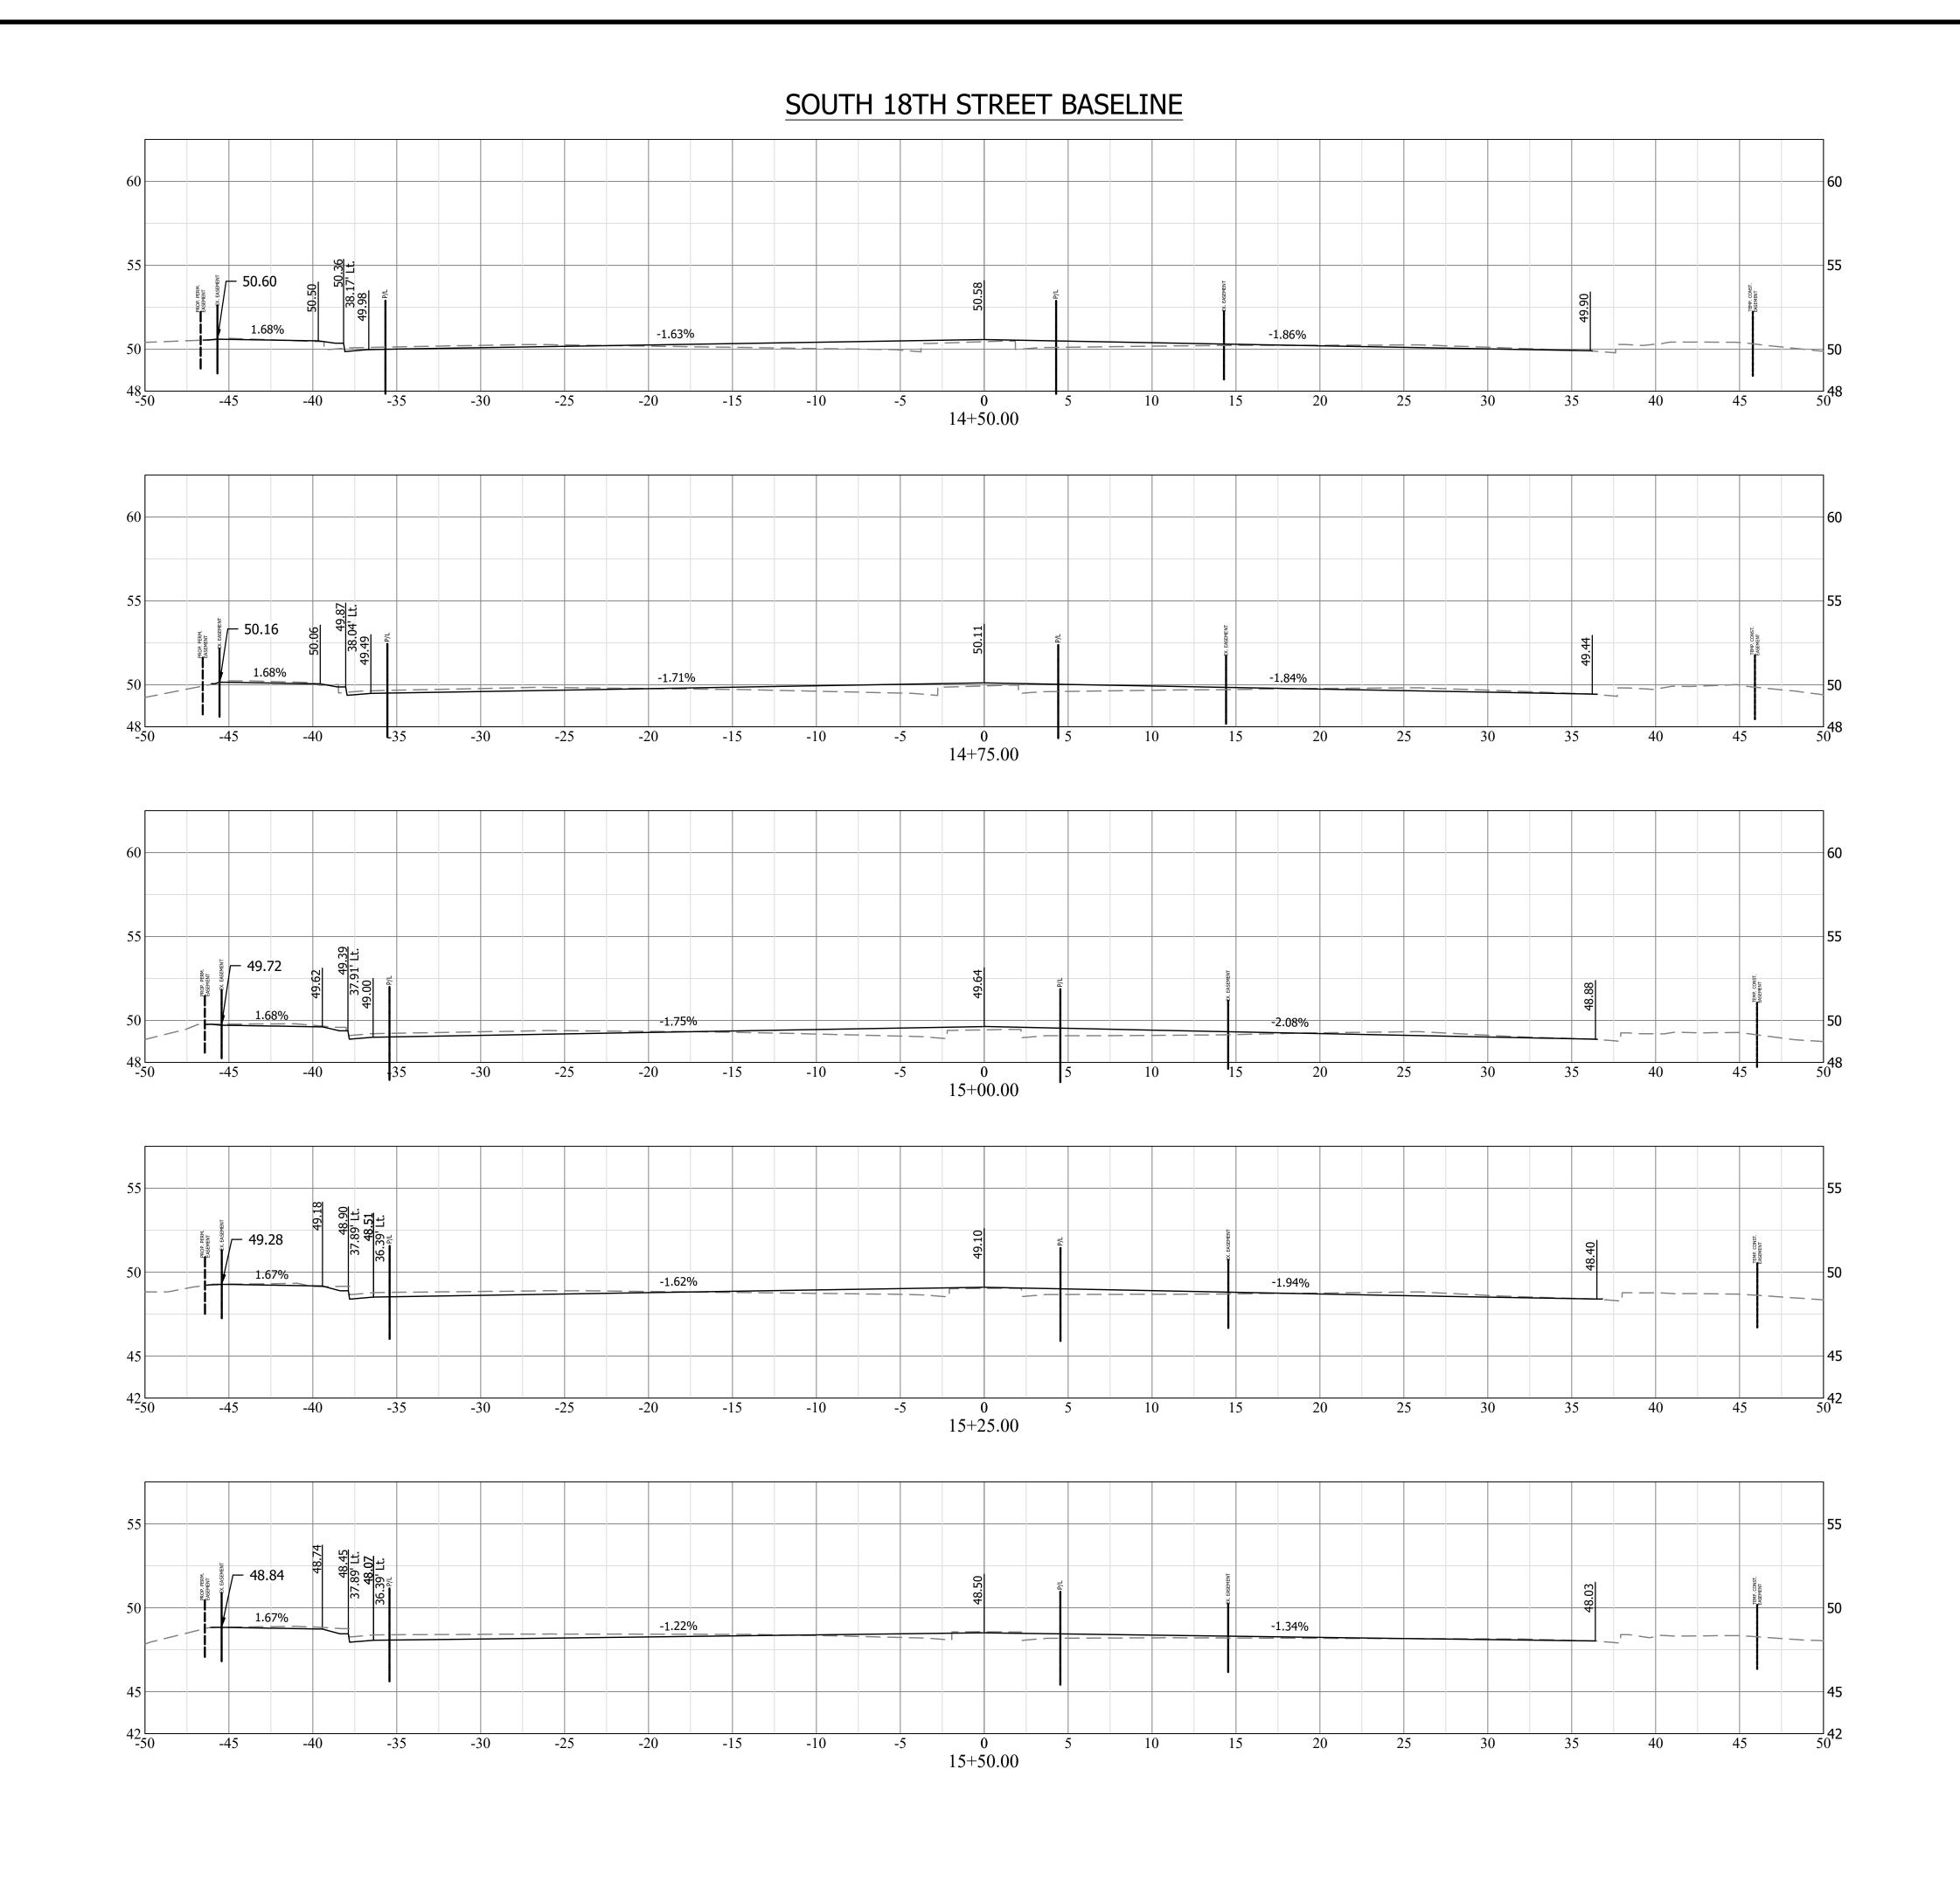

A R L I N G T O N
VIRGINIA

DEPARTMENT OF

ENVIRONMENTAL SERVICES

FACILITIES & ENGINEERING DIVISION
ENGINEERING BUREAU

2100 CLARENDON BOULEVARD, SUITE 813
ARLINGTON, VA 22201
PHONE: 703.228.3629
FAX: 703.228.3606

COPYRIGHT © 2016 ARLINGTON COUNTY VIRGINIA - ALL RIGHTS RESERVED

SEAL TREVOR M. LANTZY
Lic. No. 0402050508
3/1/2021

APPROVALS

DATE

| 6/18/2020 |
| QUALITY CONTROL ENGINEER | 6.26.20 |
| Kamal N. Taktak

CONSTRUCTION MANAGEMENT SUPERVISOR
06.29.20
WATER, SEWER, STREETS BUREAU CHIEF
Dennis W. Leach
6/24/20

Dennis M. Leach
TRANSPORTATION DIRECTOR

Accel Yang
PROJECT MANAGER

6/24/20
6/17/2020

REVISIONS

STREET SOUTH

CROSS-SECTIONS
ROADWAY IMPROVEMENTS
S FERN ST TO S EADS ST

DESIGNED: NS
DRAWN: NS
CHECKED: TL
MISS UTILITY TRANSMITTAL #: XXXX

18TH

FILENAME:
CC20-122-CORRIDOR-VIEWPORTS.DWG
PATH: Q:\Data\cc20\DESIGN\cad\\_ACTIVE

PLOTTED:MARCH 1 2021 PLOTTED BY:NSHARP

SCALE:

VERT. SCALE

10

10

2

SHEET C044.6

REFER TO PLAN AND PROFILE


2. SEE TYPICAL SECTION ON

SHEET FOR SECTIONS THAT ARE TO BE MILL AND

OVERLAY INSTEAD OF FULL DEPTH PAVEMENT

SHEET C004.1 FOR PAVEMENT AND SIDEWALK INFORMATION

HORIZ. SCALE

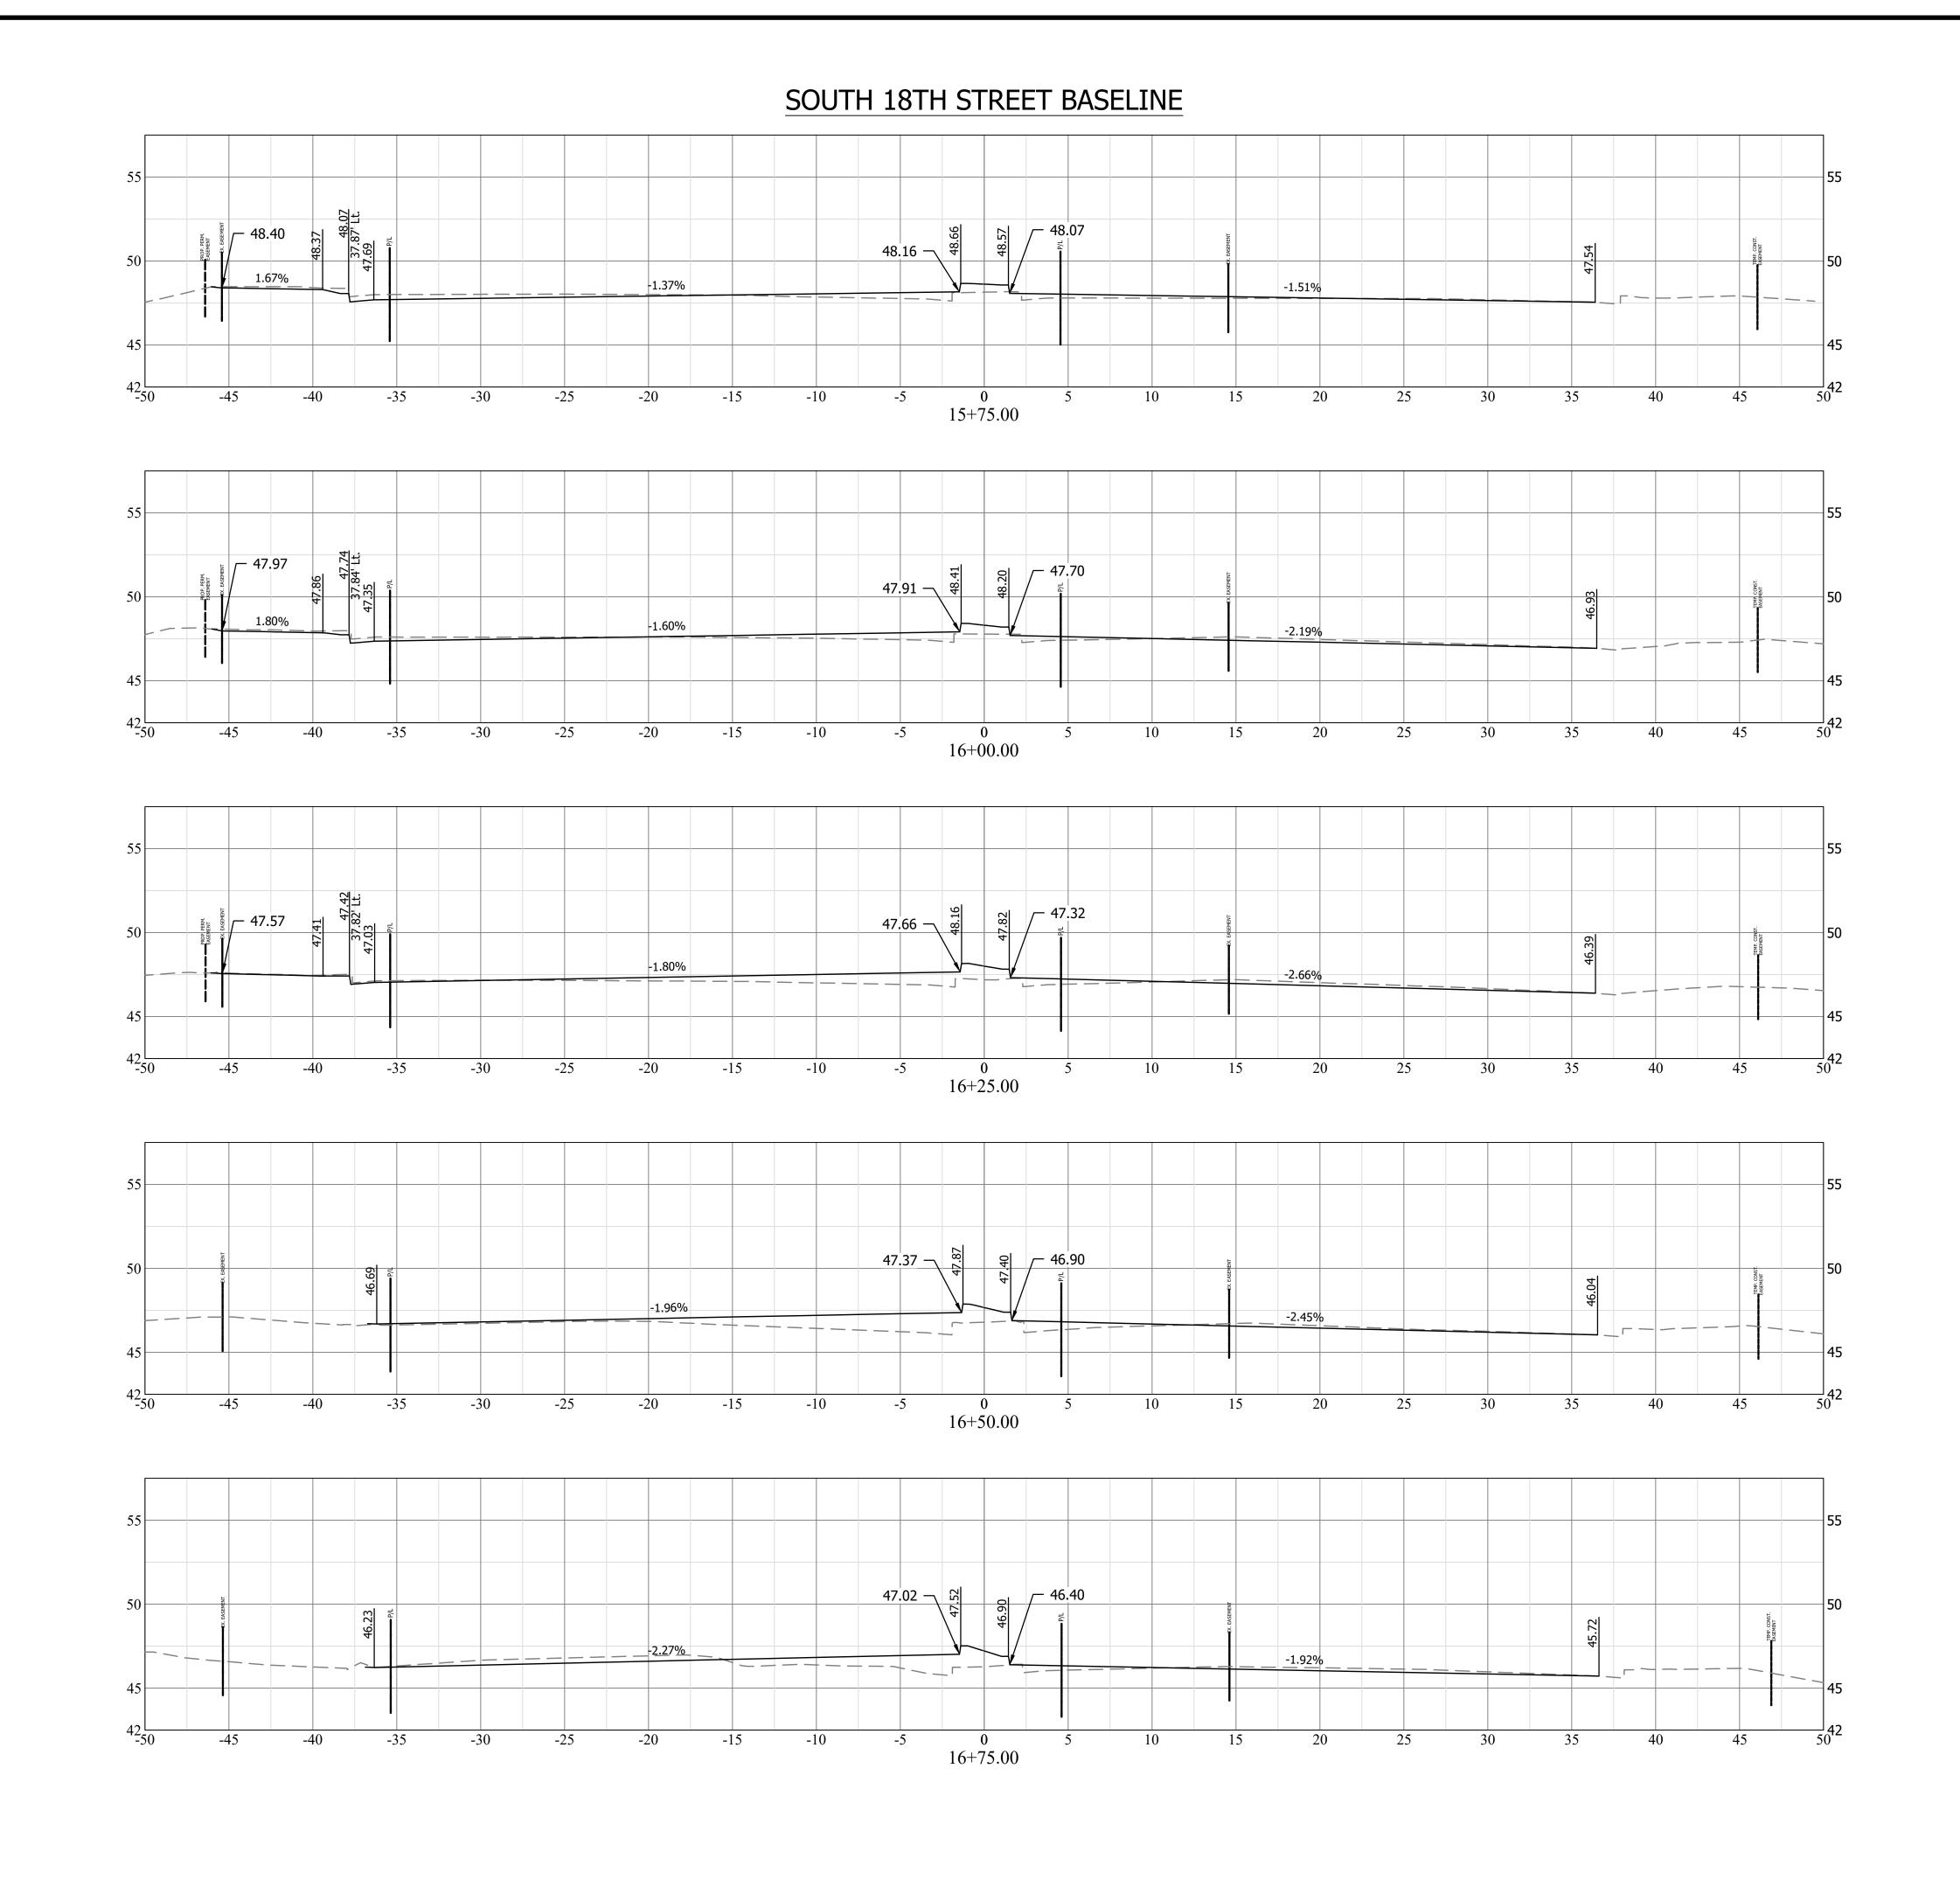

ARLINGTON VIRGINIA DEPARTMENT OF ENGINEERING BUREAU

**ENVIRONMENTAL SERVICES** FACILITIES & ENGINEERING DIVISION 2100 CLARENDON BOULEVARD, SUITE 813 ARLINGTON, VA 22201 PHONE: 703.228.3629 FAX: 703.228.3606

COPYRIGHT © 2016 ARLINGTON COUNTY VIRGINIA - ALL RIGHTS RESERVED

APPROVALS DATE QUALITY CONTROL ENGINEER 6.26.20 Kamal N. Taktak

CONSTRUCTION MANAGEMENT SUPERVISOR WATER, SEWER, STREETS BUREAU CHIEF Dennis M. Leach
TRANSPORTATION DIRECTOR

6/24/20

Siel Yang PROJECT MANAGER

**REVISIONS** 

SOUTH STREET

18TH

CROSS-SECTIONS
ROADWAY IMPROVEMENTS
S FERN ST TO S EADS ST

DESIGNED: NS DRAWN: NS CHECKED: TL

MISS UTILITY TRANSMITTAL #: XXXX FILENAME:

CC20-122-CORRIDOR-VIEWPORTS.DWG PATH: Q:\DATA\CC20\DESIGN\CAD\\_ACTIVE

PLOTTED: MARCH 1 2021 PLOTTED BY:NSHARP

SCALE: VERT. SCALE

HORIZ. SCALE SHEET C044.7


REFER TO PLAN AND PROFILE

2. SEE TYPICAL SECTION ON

SHEET FOR SECTIONS THAT ARE TO BE MILL AND

OVERLAY INSTEAD OF FULL DEPTH PAVEMENT

SHEET C004.1 FOR PAVEMENT AND SIDEWALK INFORMATION

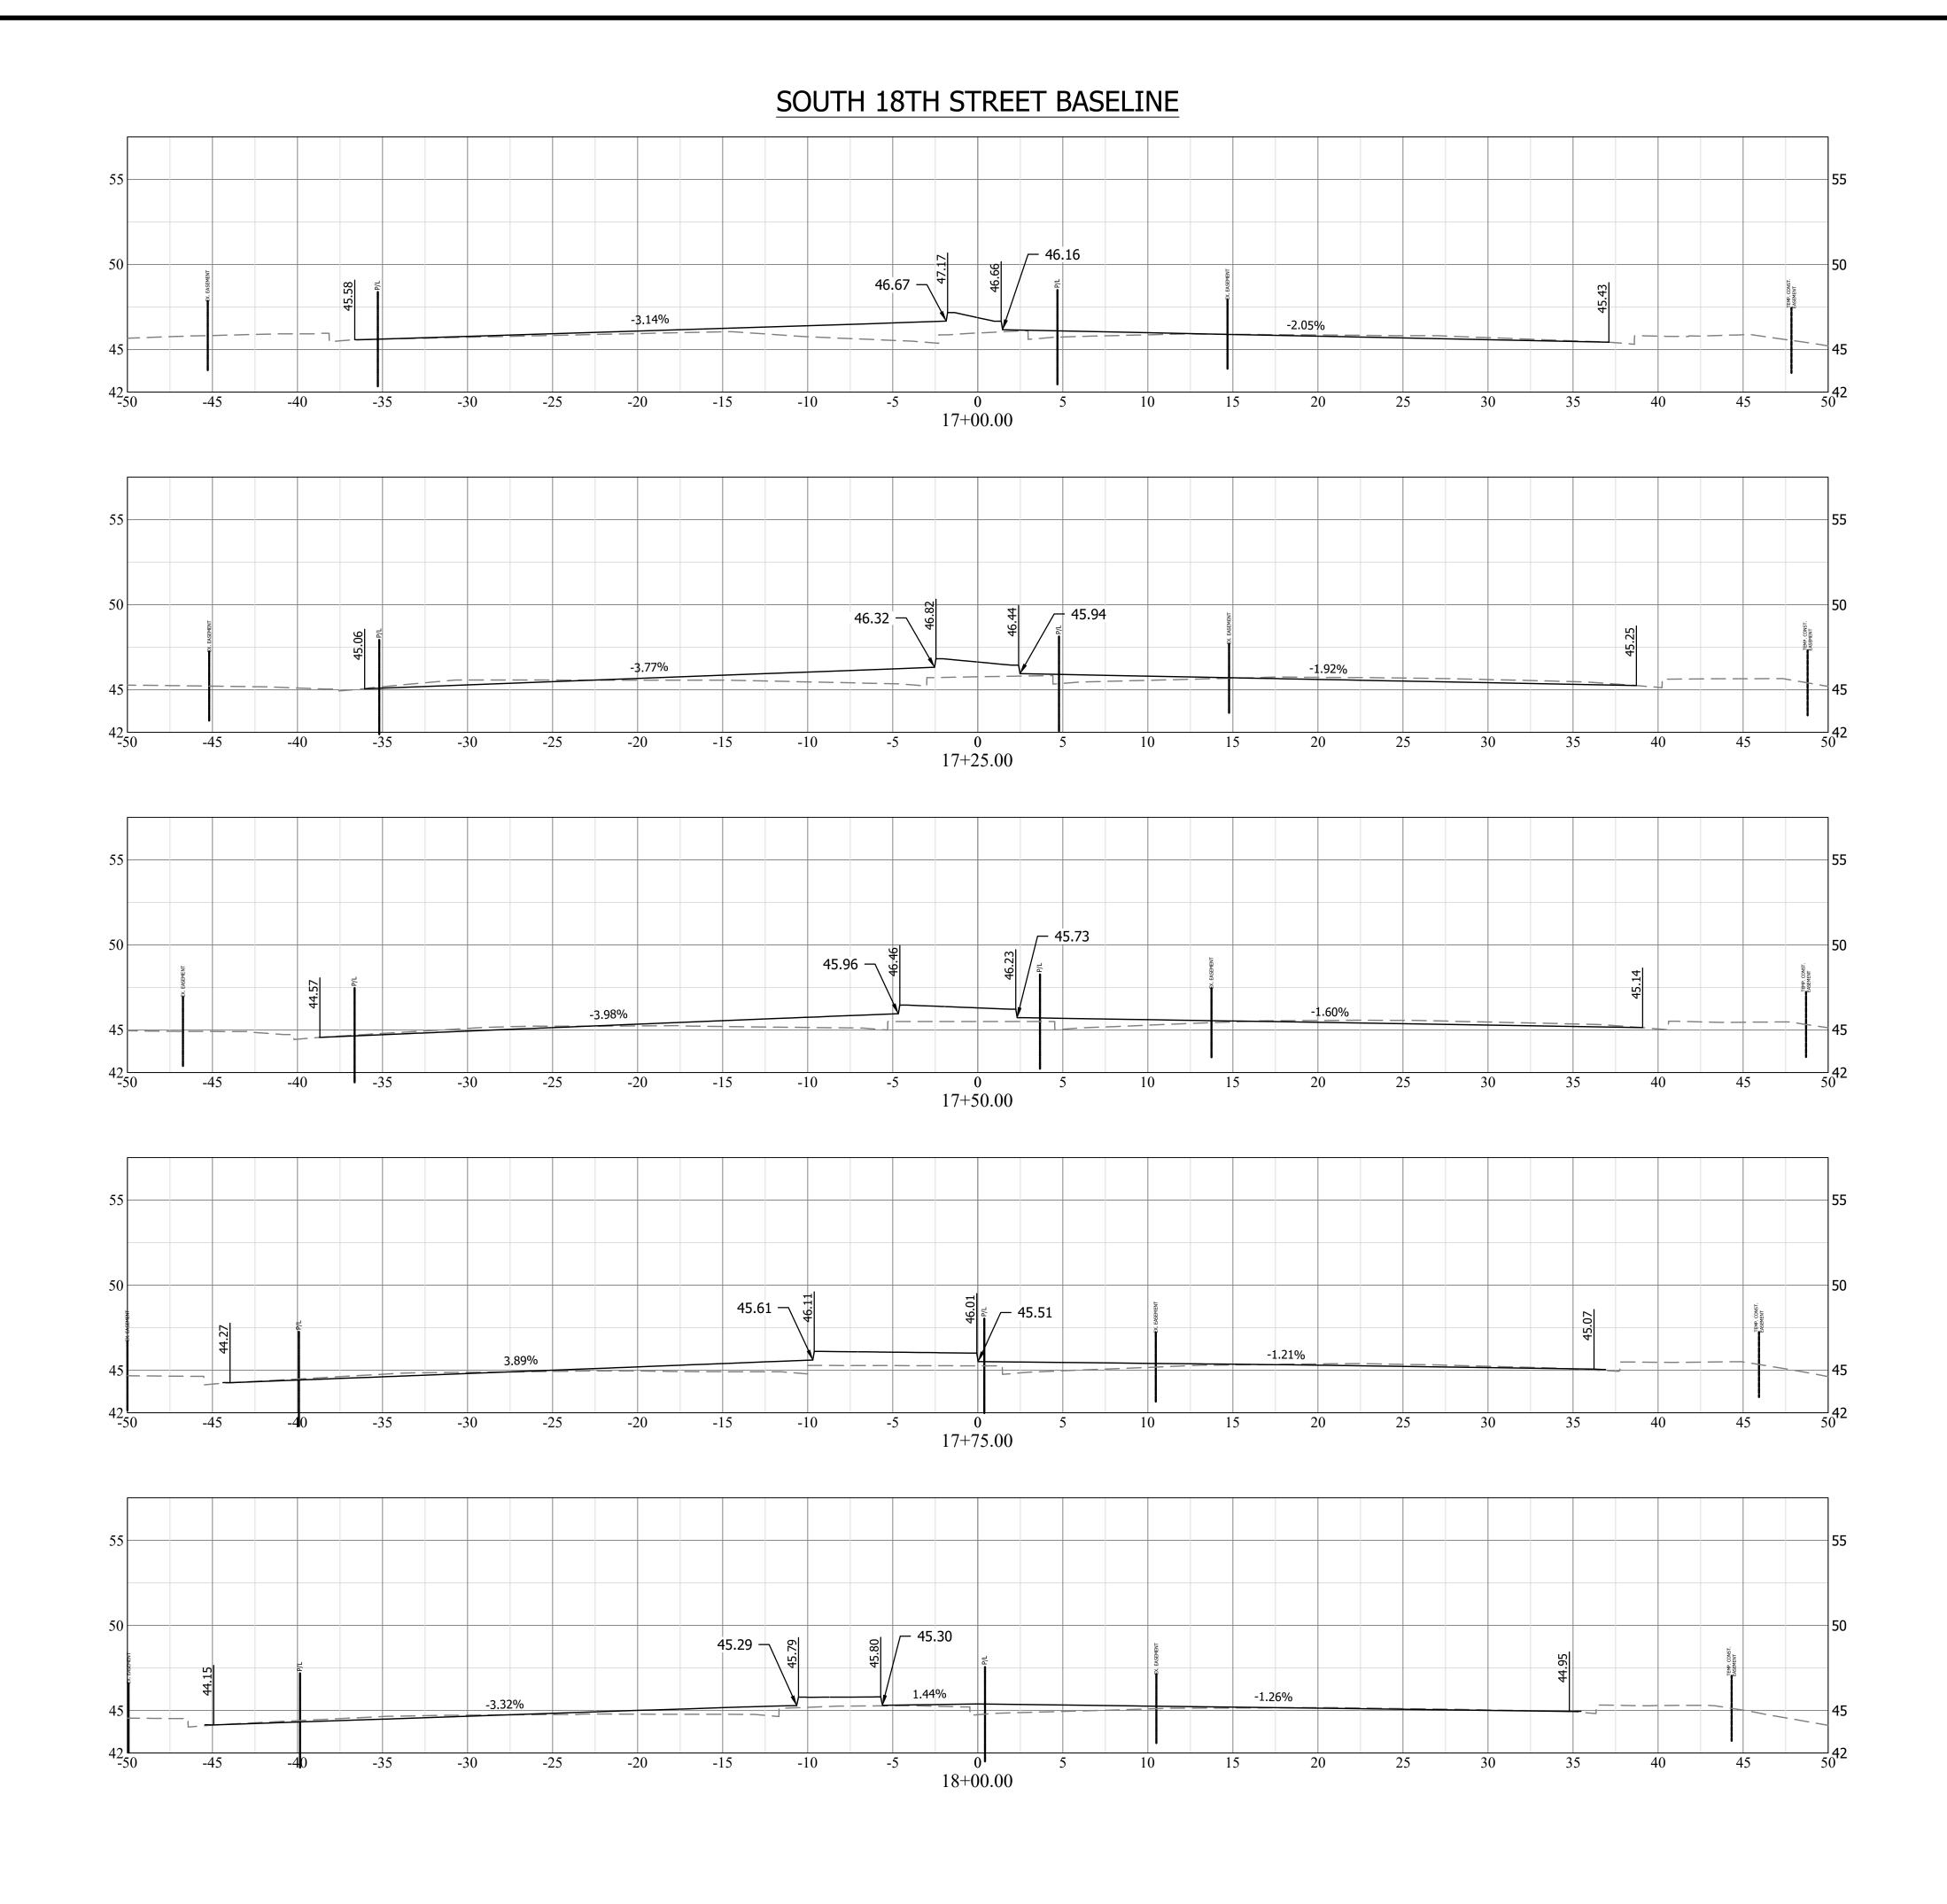

ARLINGTON VIRGINIA

DEPARTMENT OF
ENVIRONMENTAL SERVICES
FACILITIES & ENGINEERING DIVISION
ENGINEERING BUREAU
2100 CLARENDON BOULEVARD, SUITE 813
ARLINGTON, VA 22201
PHONE: 703.228.3629
FAX: 703.228.3606

COPYRIGHT © 2016 ARLINGTON COUNTY VIRGINIA - ALL RIGHTS RESERVED

SEAL TREVOR M. LANTZY
Lic. No. 0402050508
3/1/2021

APPROVALS
DATE

6/18/2020
QUALITY CONTROL ENGINEER
6.26.20

CONSTRUCTION MANAGEMENT SUPERVISOR

O6.29.20

WATER, SEWER, STREETS BUREAU CHIEF

Dennis M. Leach
TRANSPORTATION DIRECTOR

Aciel Yang
PROJECT MANAGER

6/24/20
6/17/2020

REVISIONS

\_\_\_\_\_\_

18TH STREET SOUTH
CROSS-SECTIONS
ROADWAY IMPROVEMENTS
S FERN ST TO S EADS ST

DESIGNED: NS
DRAWN: NS

CHECKED: TL
MISS UTILITY TRANSMITTAL #: XXXX

FILENAME:
CC20-122-CORRIDOR-VIEWPORTS.DWG
PATH: Q:\DATA\CC20\DESIGN\CAD\\_ACTIVE

PLOTTED: MARCH 1 2021 PLOTTED BY: NSHARP

SCALE:


VERT. SCALE

HORIZ. SCALE

SHEET C044.8

SHEET C004.1 FOR PAVEMENT AND SIDEWALK INFORMATION

# SOUTH 18TH STREET BASELINE

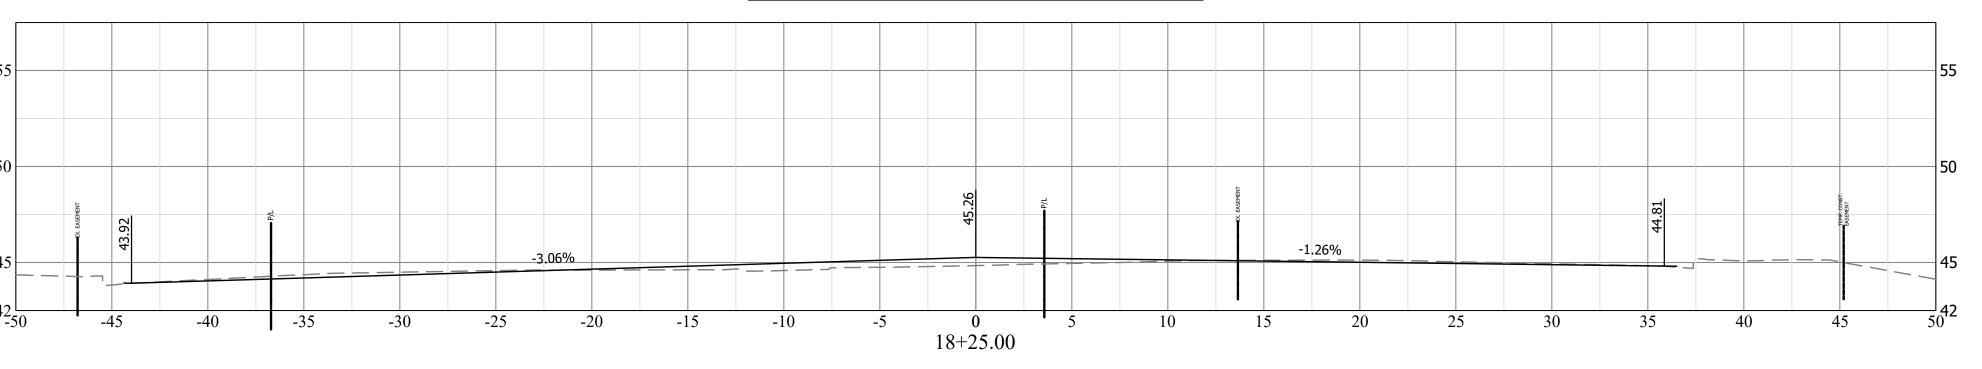

ARLINGTON
VIRGINIA

DEPARTMENT OF **ENVIRONMENTAL SERVICES** FACILITIES & ENGINEERING DIVISION ENGINEERING BUREAU 2100 CLARENDON BOULEVARD, SUITE 813 ARLINGTON, VA 22201 PHONE: 703.228.3629

FAX: 703.228.3606

COPYRIGHT © 2016 ARLINGTON COUNTY VIRGINIA - ALL RIGHTS RESERVED

APPROVALS DATE QUALITY CONTROL ENGINEER 6.26.20

Kamal N. Taktak CONSTRUCTION MANAGEMENT SUPERVISOR WATER, SEWER, STREETS BUREAU CHIEF

Dennis M. Leach
TRANSPORTATION DIRECTOR
Aicel Yang
6/17/2020

PROJECT MANAGER

**REVISIONS** 

SOUTH STREET CROSS-SECTIONS
ROADWAY IMPROVEMENTS
S FERN ST TO S EADS ST

DESIGNED: NS DRAWN: NS

**18TH** 

CHECKED: TL MISS UTILITY TRANSMITTAL #: XXXX

FILENAME: CC20-122-CORRIDOR-VIEWPORTS.DWG PATH: Q:\DATA\CC20\DESIGN\CAD\\_ACTIVE

PLOTTED: MARCH 1 2021 PLOTTED BY:NSHARP

SCALE: VERT. SCALE HORIZ. SCALE


SHEET

C044.9


 REFER TO PLAN AND PROFILE SHEET FOR SECTIONS THAT ARE TO BE MILL AND OVERLAY INSTEAD OF FULL DEPTH PAVEMENT 2. SEE TYPICAL SECTION ON

SHEET C004.1 FOR PAVEMENT AND SIDEWALK INFORMATION


COPYRIGHT © 2016 ARLINGTON COUNTY VIRGINIA - ALL RIGHTS RESERVED

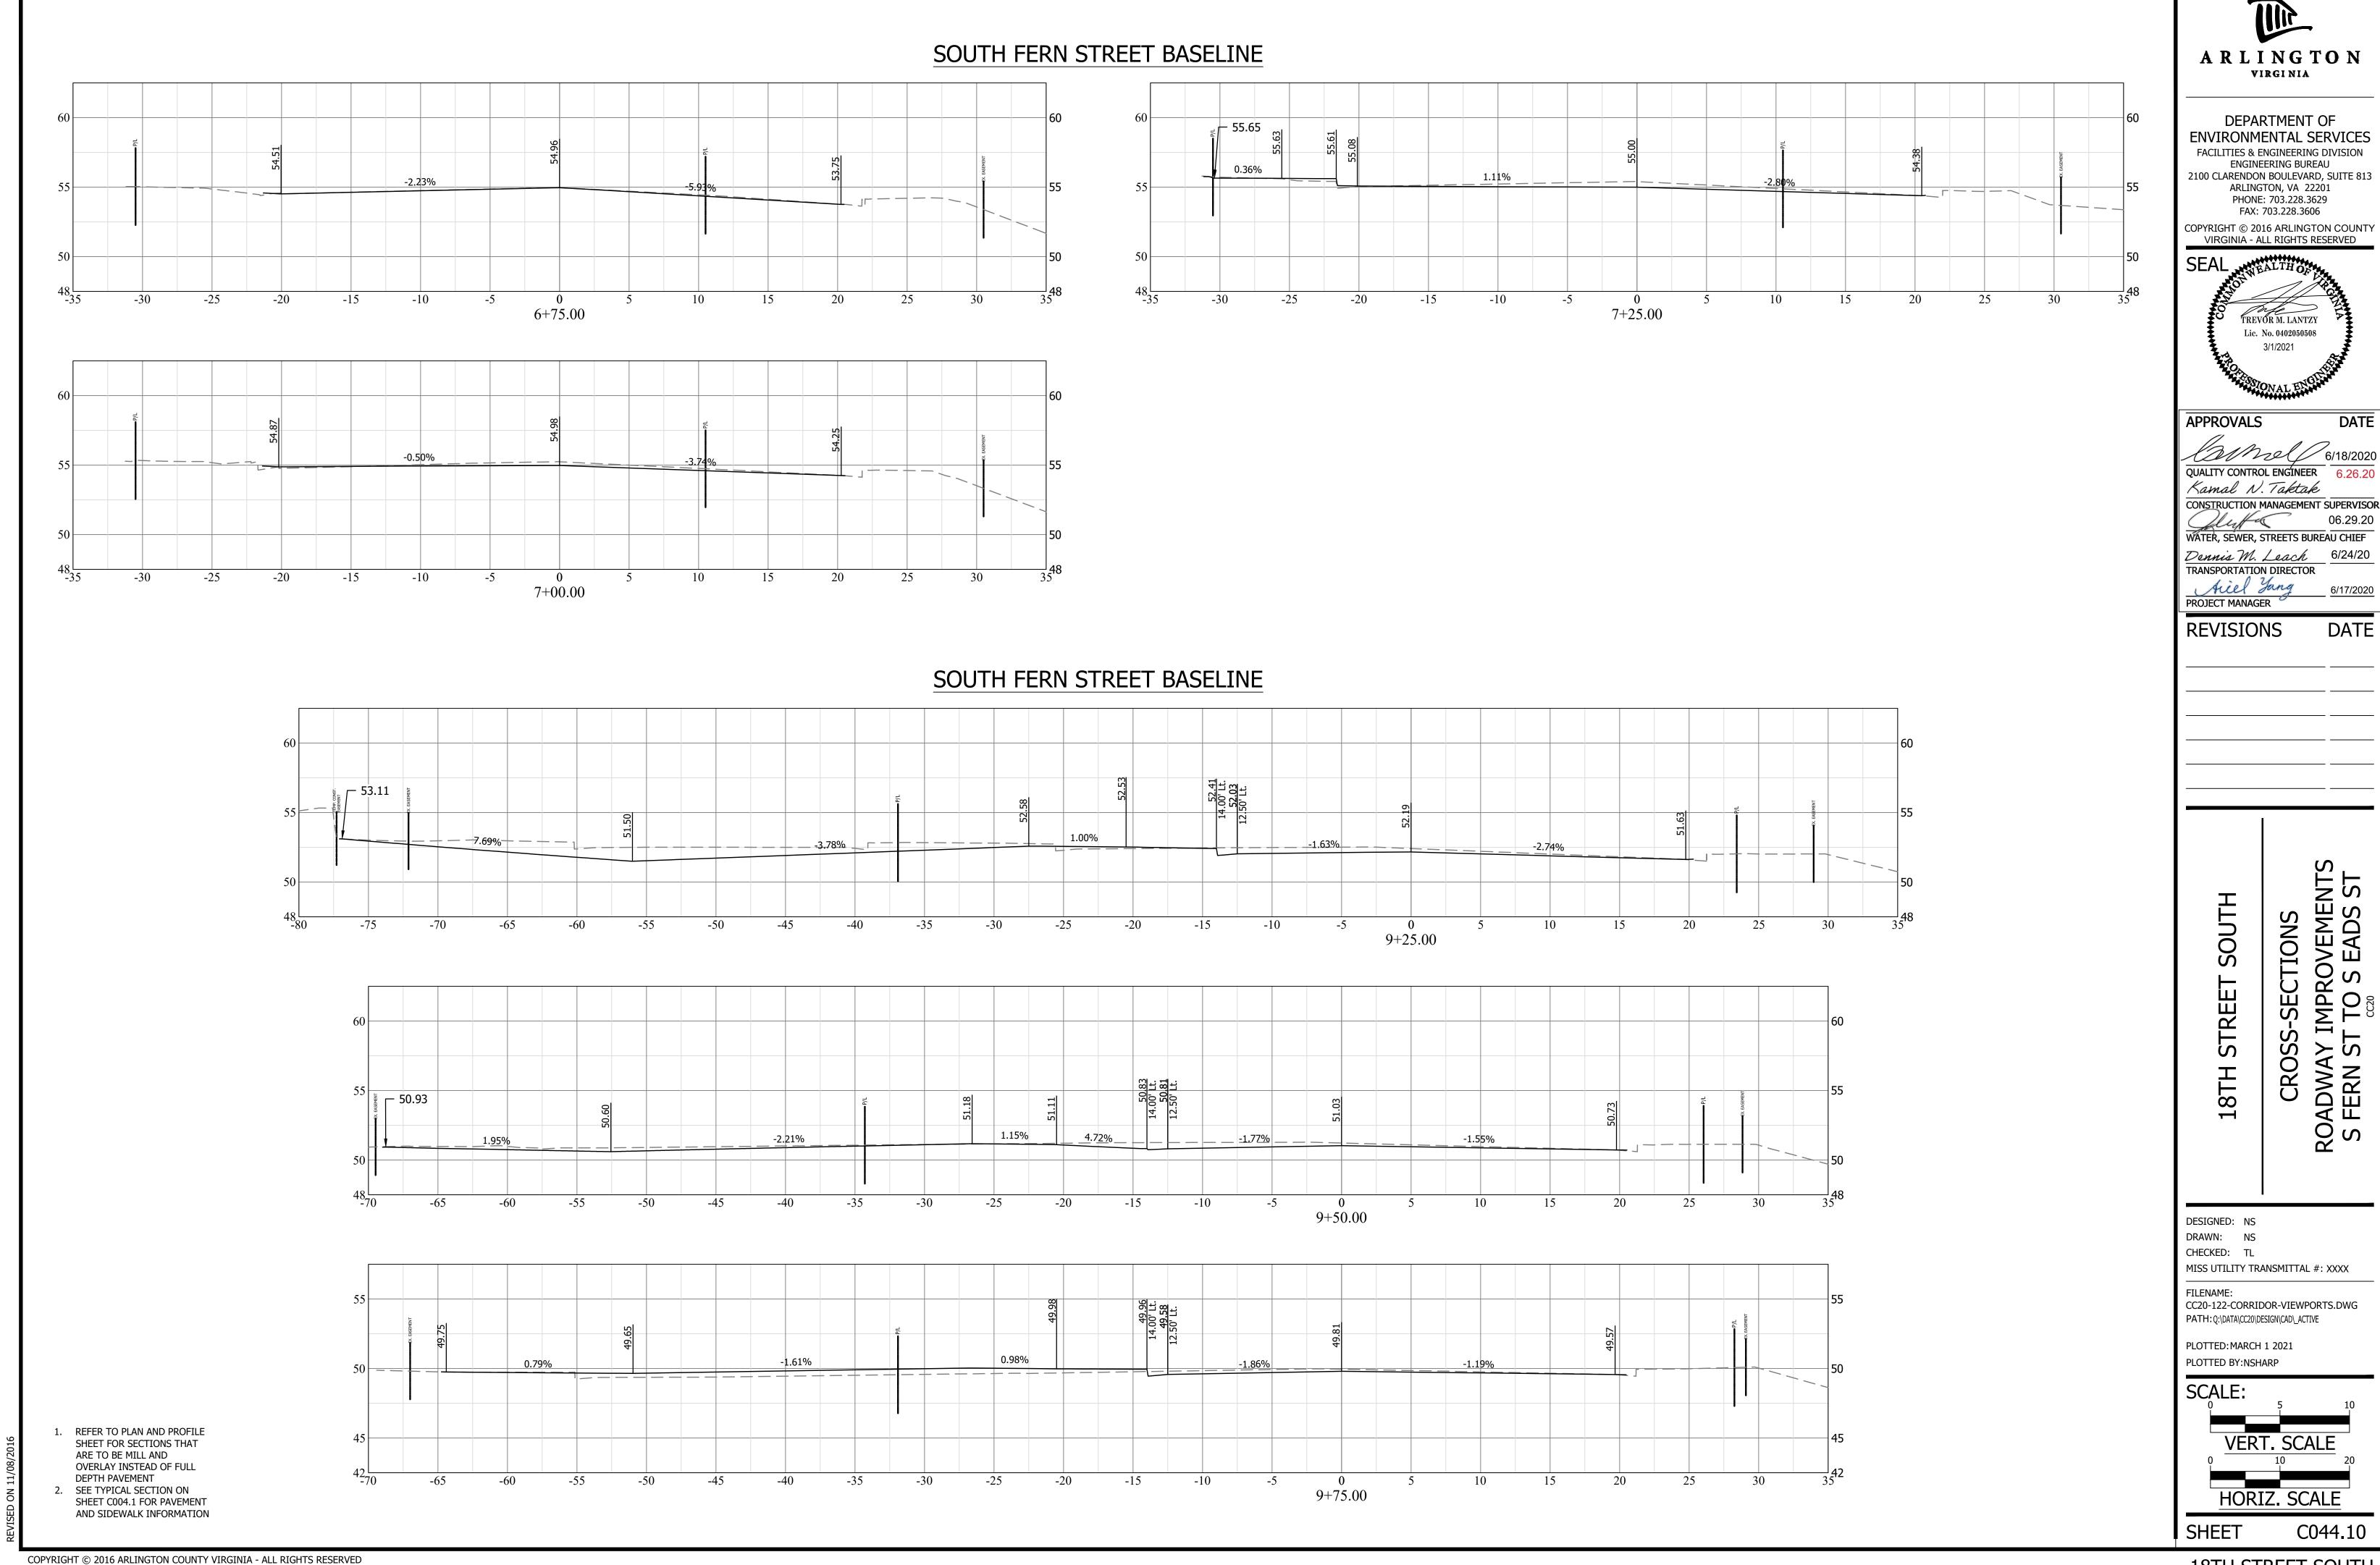

COPYRIGHT © 2016 ARLINGTON COUNTY

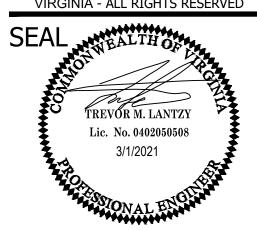

QUALITY CONTROL ENGINEER 6.26.20

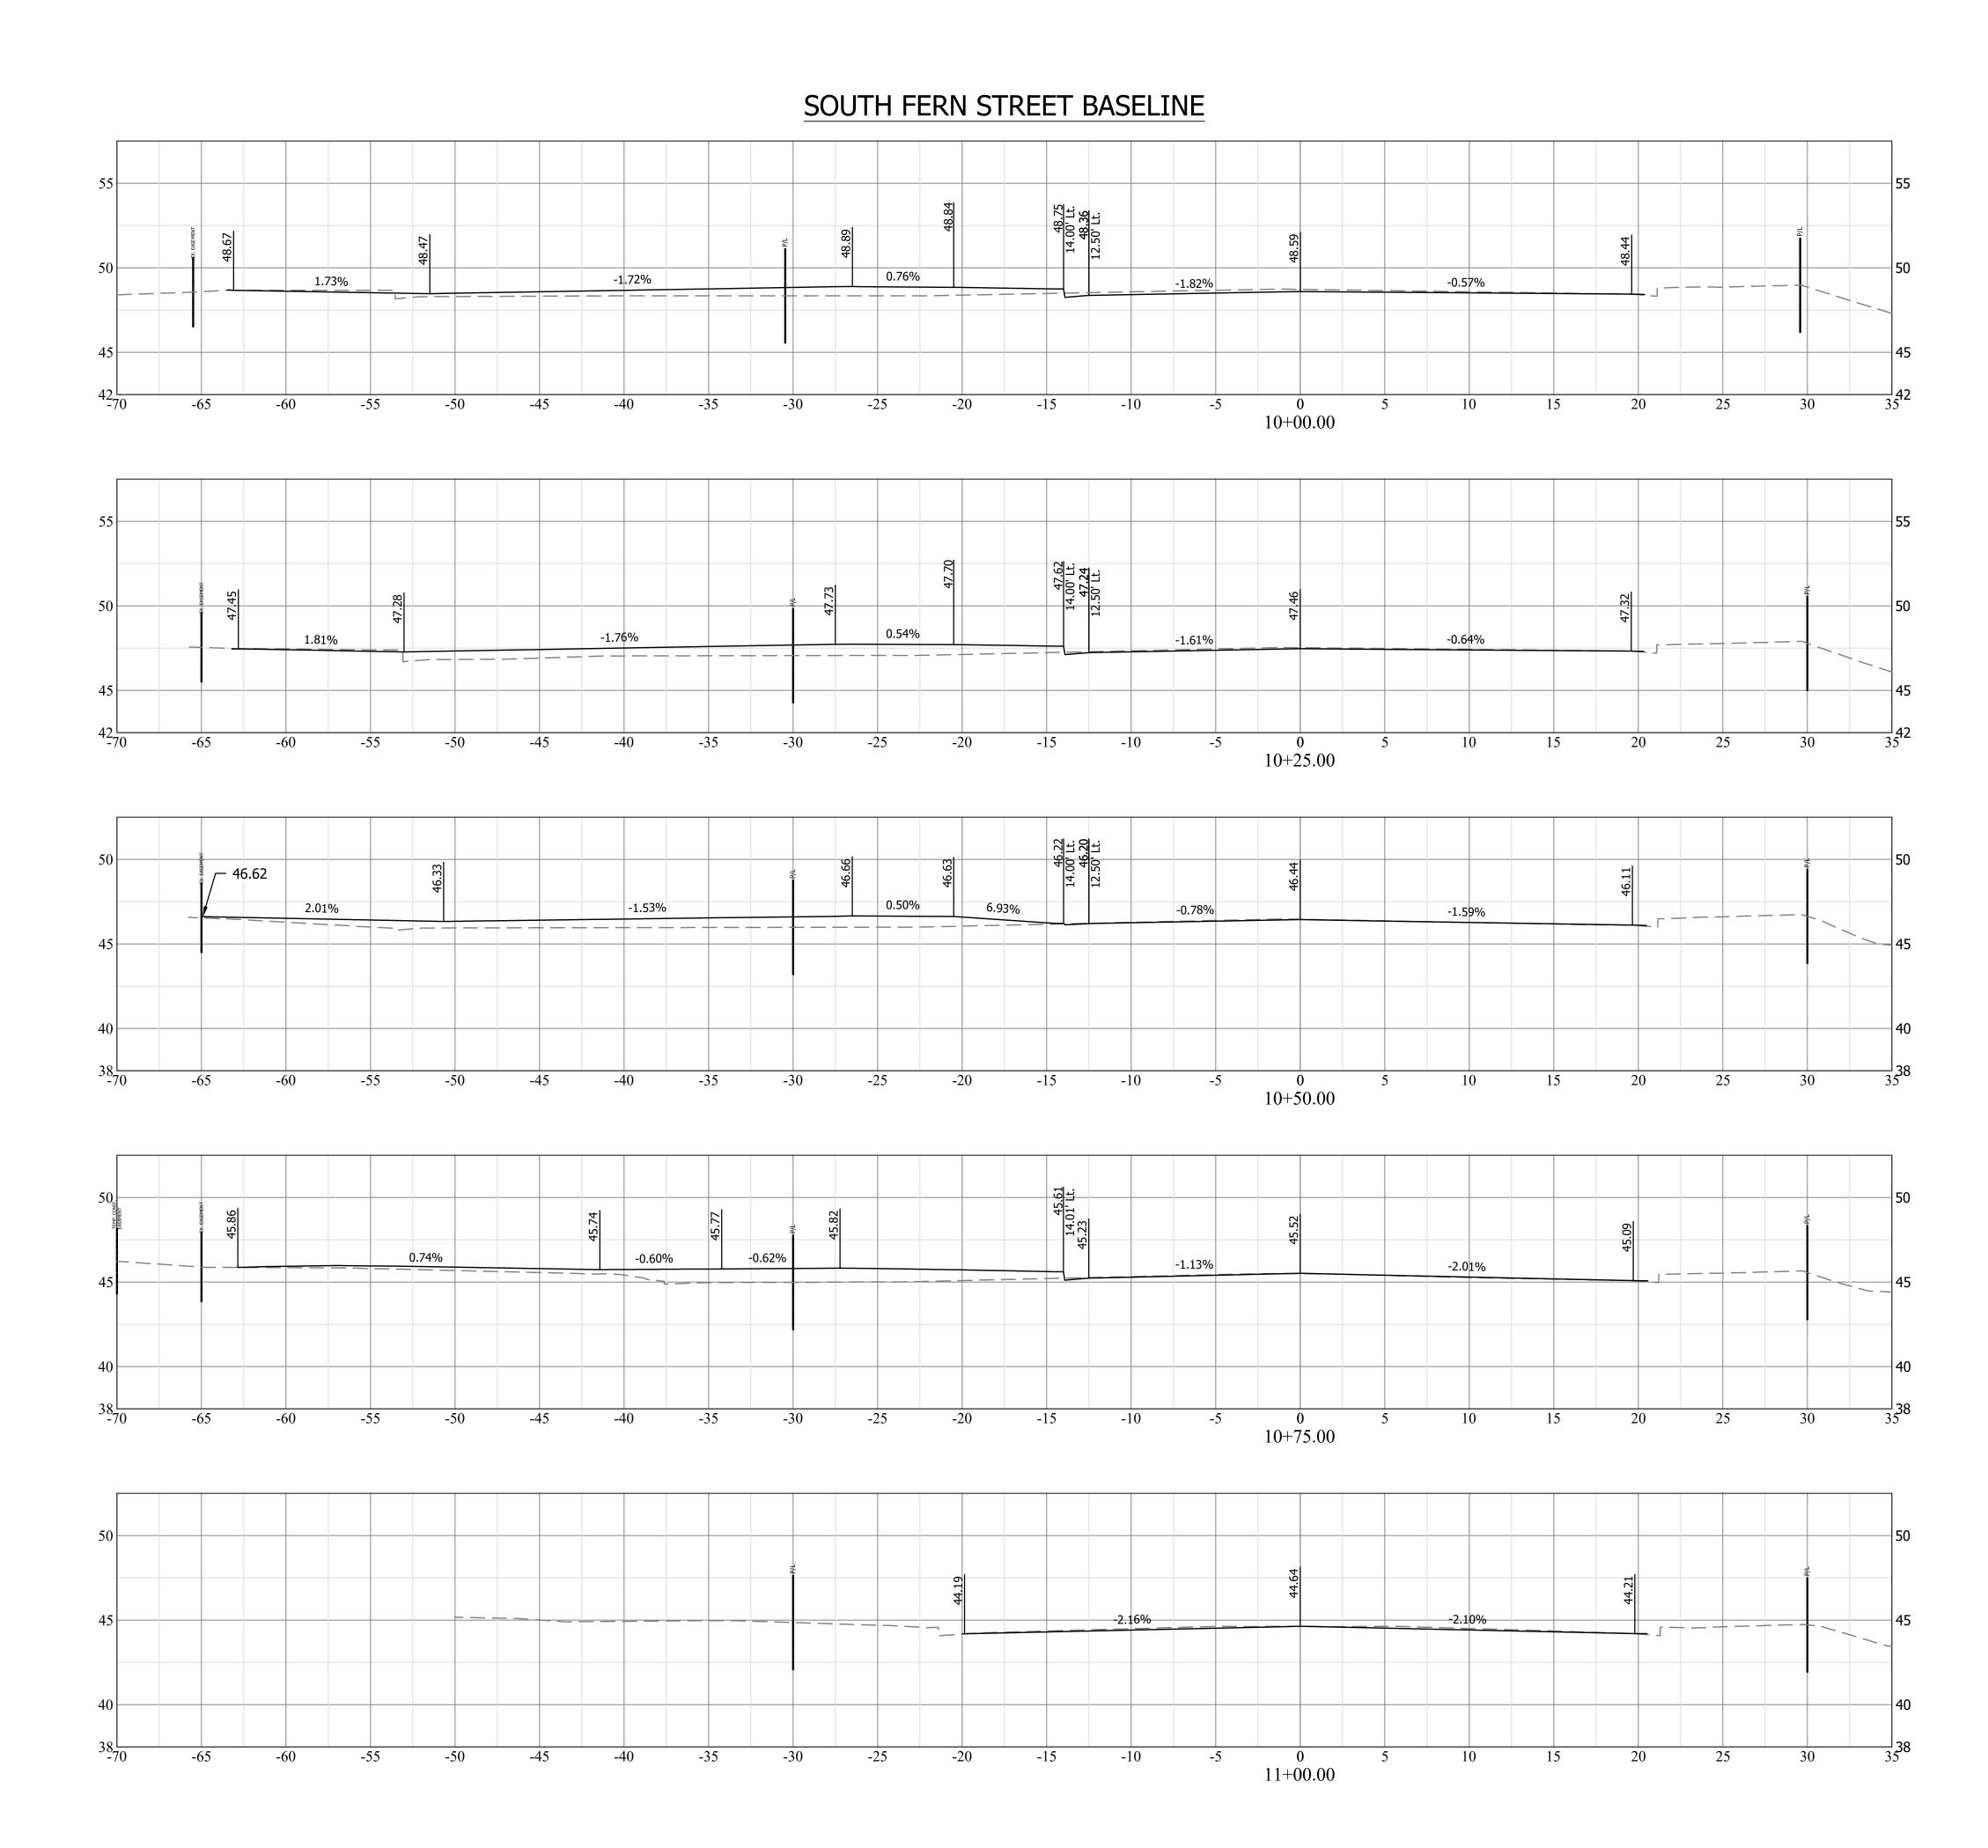

ARLINGTON VIRGINIA DEPARTMENT OF **ENVIRONMENTAL SERVICES** FACILITIES & ENGINEERING DIVISION ENGINEERING BUREAU 2100 CLARENDON BOULEVARD, SUITE 813 ARLINGTON, VA 22201 PHONE: 703.228.3629 FAX: 703.228.3606 COPYRIGHT © 2016 ARLINGTON COUNTY VIRGINIA - ALL RIGHTS RESERVED APPROVALS DATE QUALITY CONTROL ENGINEER 6.26.20 Kamal N. Taktak CONSTRUCTION MANAGEMENT SUPERVISOR WATER, SEWER, STREETS BUREAU CHIEF Dennis M. Leach
TRANSPORTATION DIRECTOR

6/24/20 Ailel Yang PROJECT MANAGER **REVISIONS** ROADWAY IMPROVEMENTS
S FERN ST TO S EADS ST SOUTH STREE 18TH DESIGNED: NS DRAWN: NS MISS UTILITY TRANSMITTAL #: XXXX CC20-122-CORRIDOR-VIEWPORTS.DWG PATH: Q:\DATA\CC20\DESIGN\CAD\\_ACTIVE PLOTTED: MARCH 1 2021 PLOTTED BY:NSHARP

CHECKED: TL

SCALE: VERT. SCALE HORIZ. SCALE

C044.11

1. REFER TO PLAN AND PROFILE


ARE TO BE MILL AND


2. SEE TYPICAL SECTION ON

SHEET FOR SECTIONS THAT

OVERLAY INSTEAD OF FULL DEPTH PAVEMENT

SHEET C004.1 FOR PAVEMENT AND SIDEWALK INFORMATION

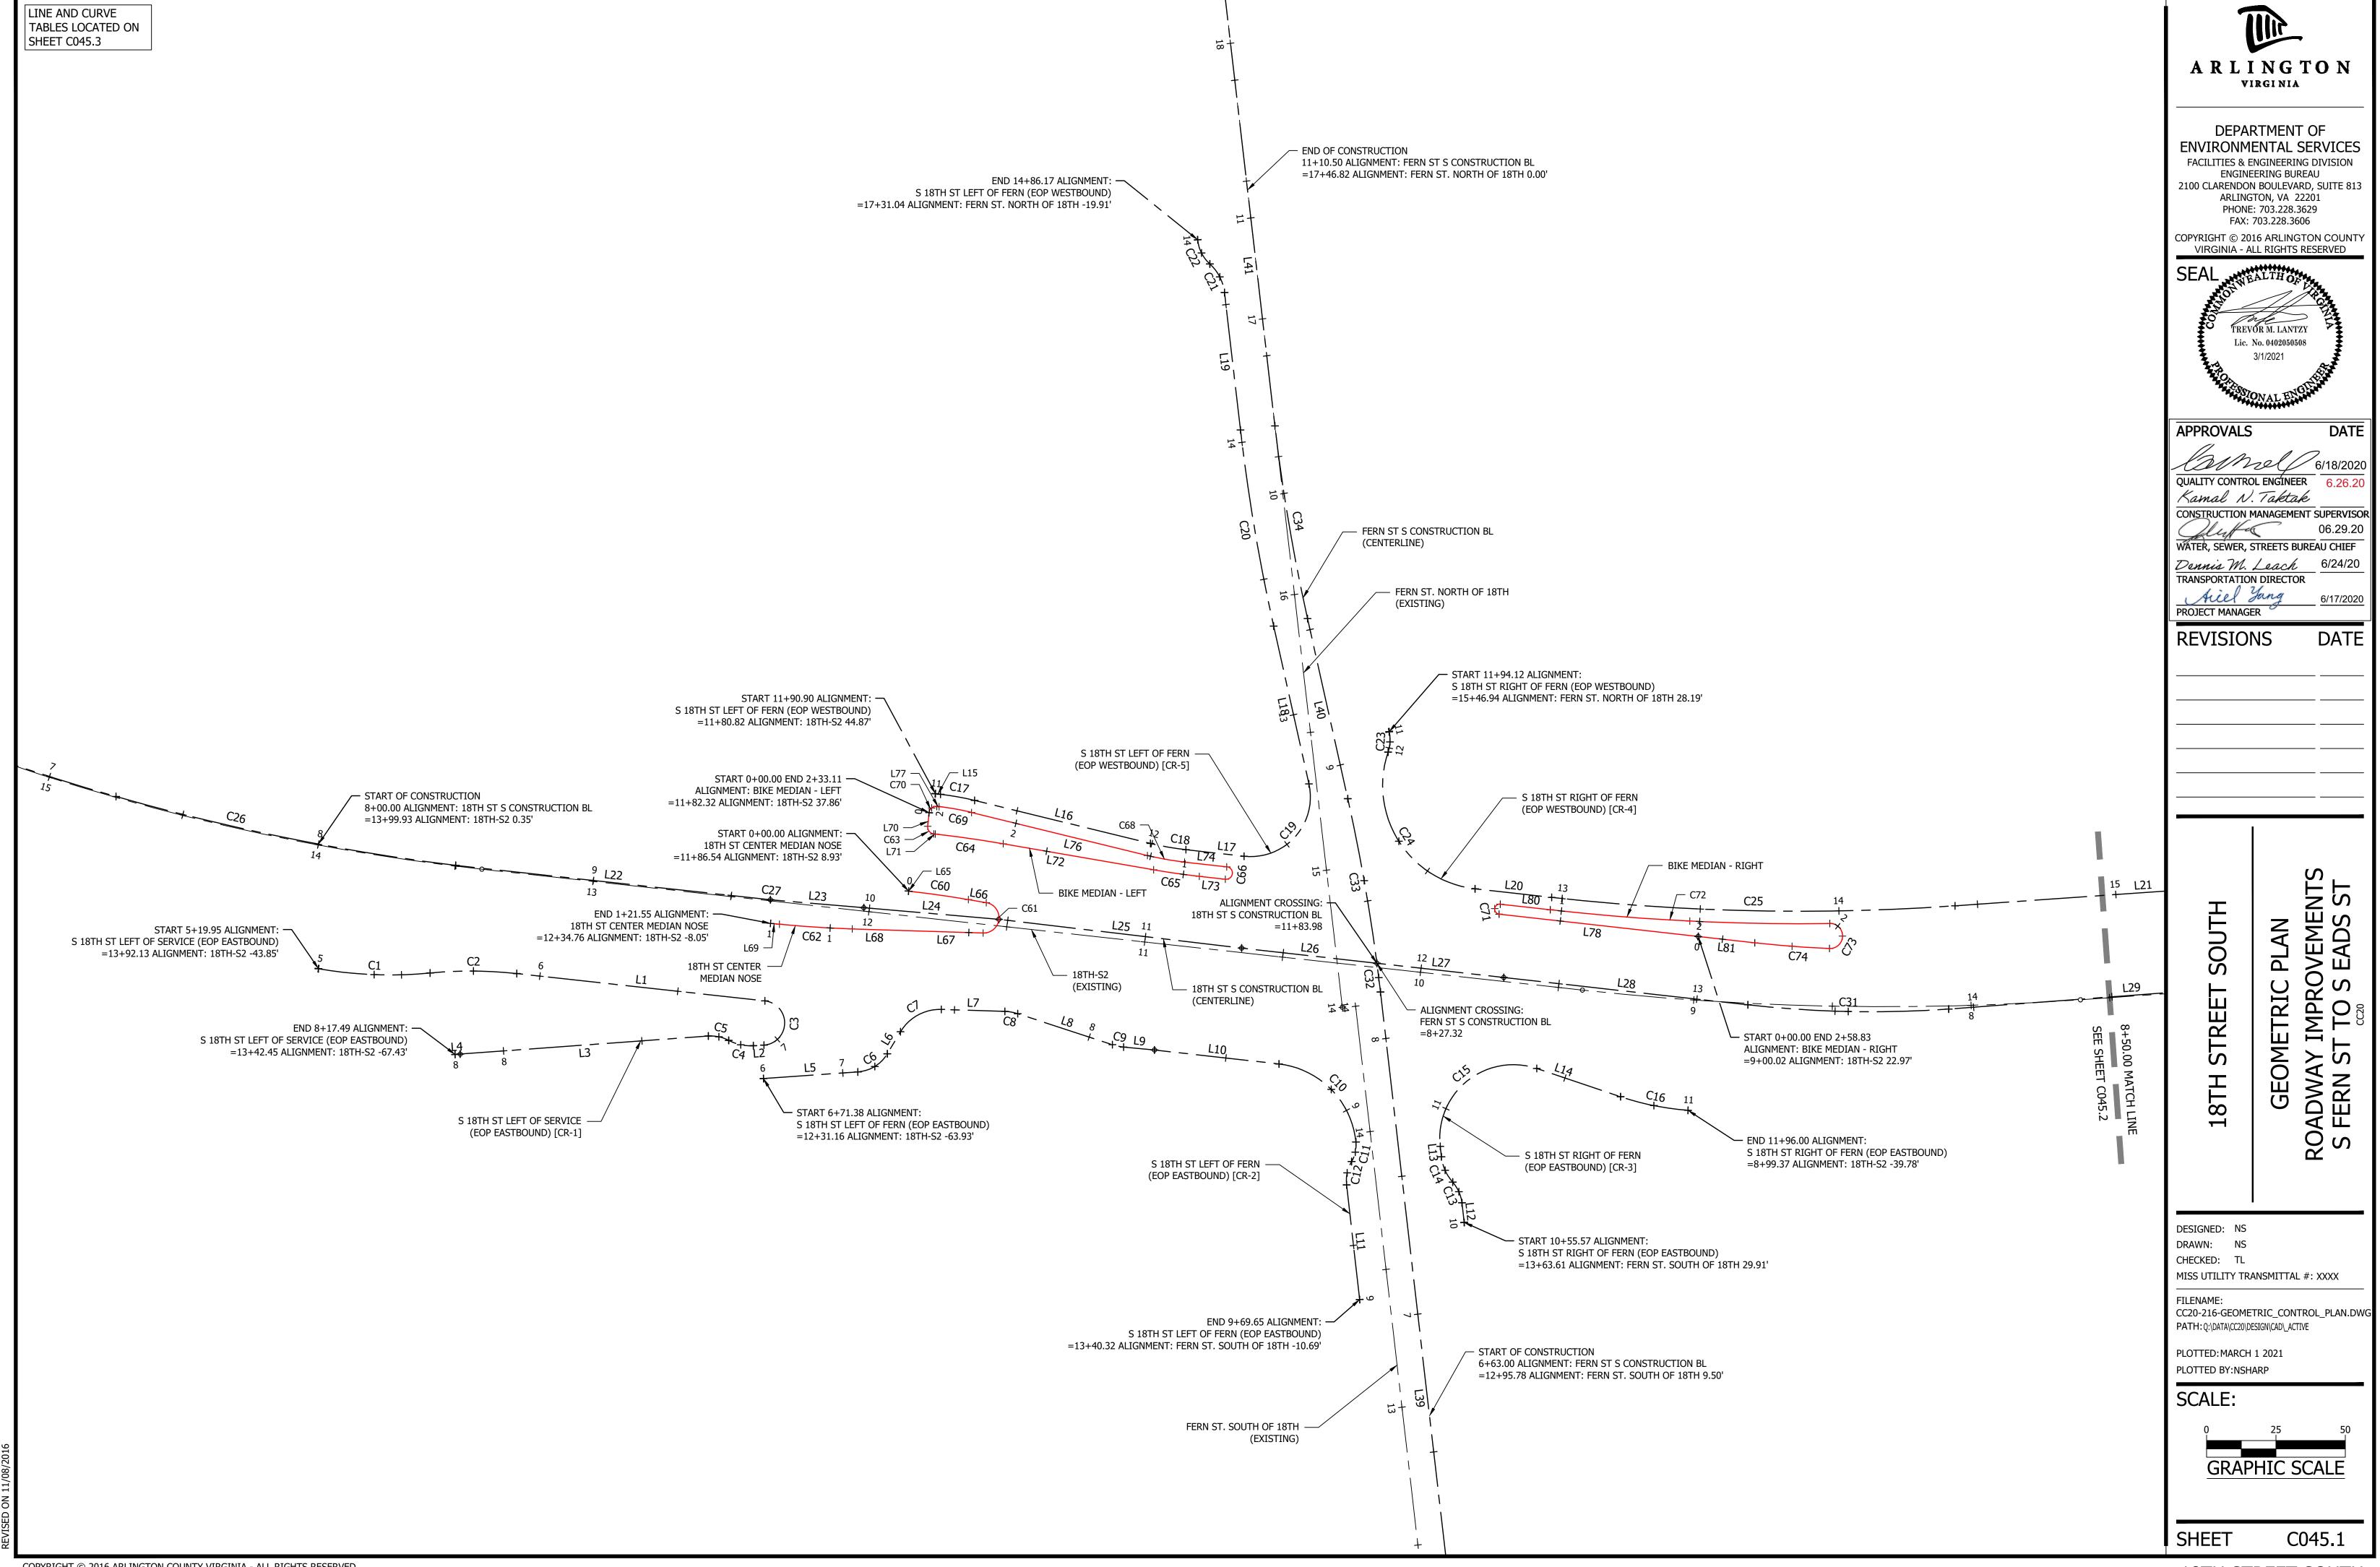

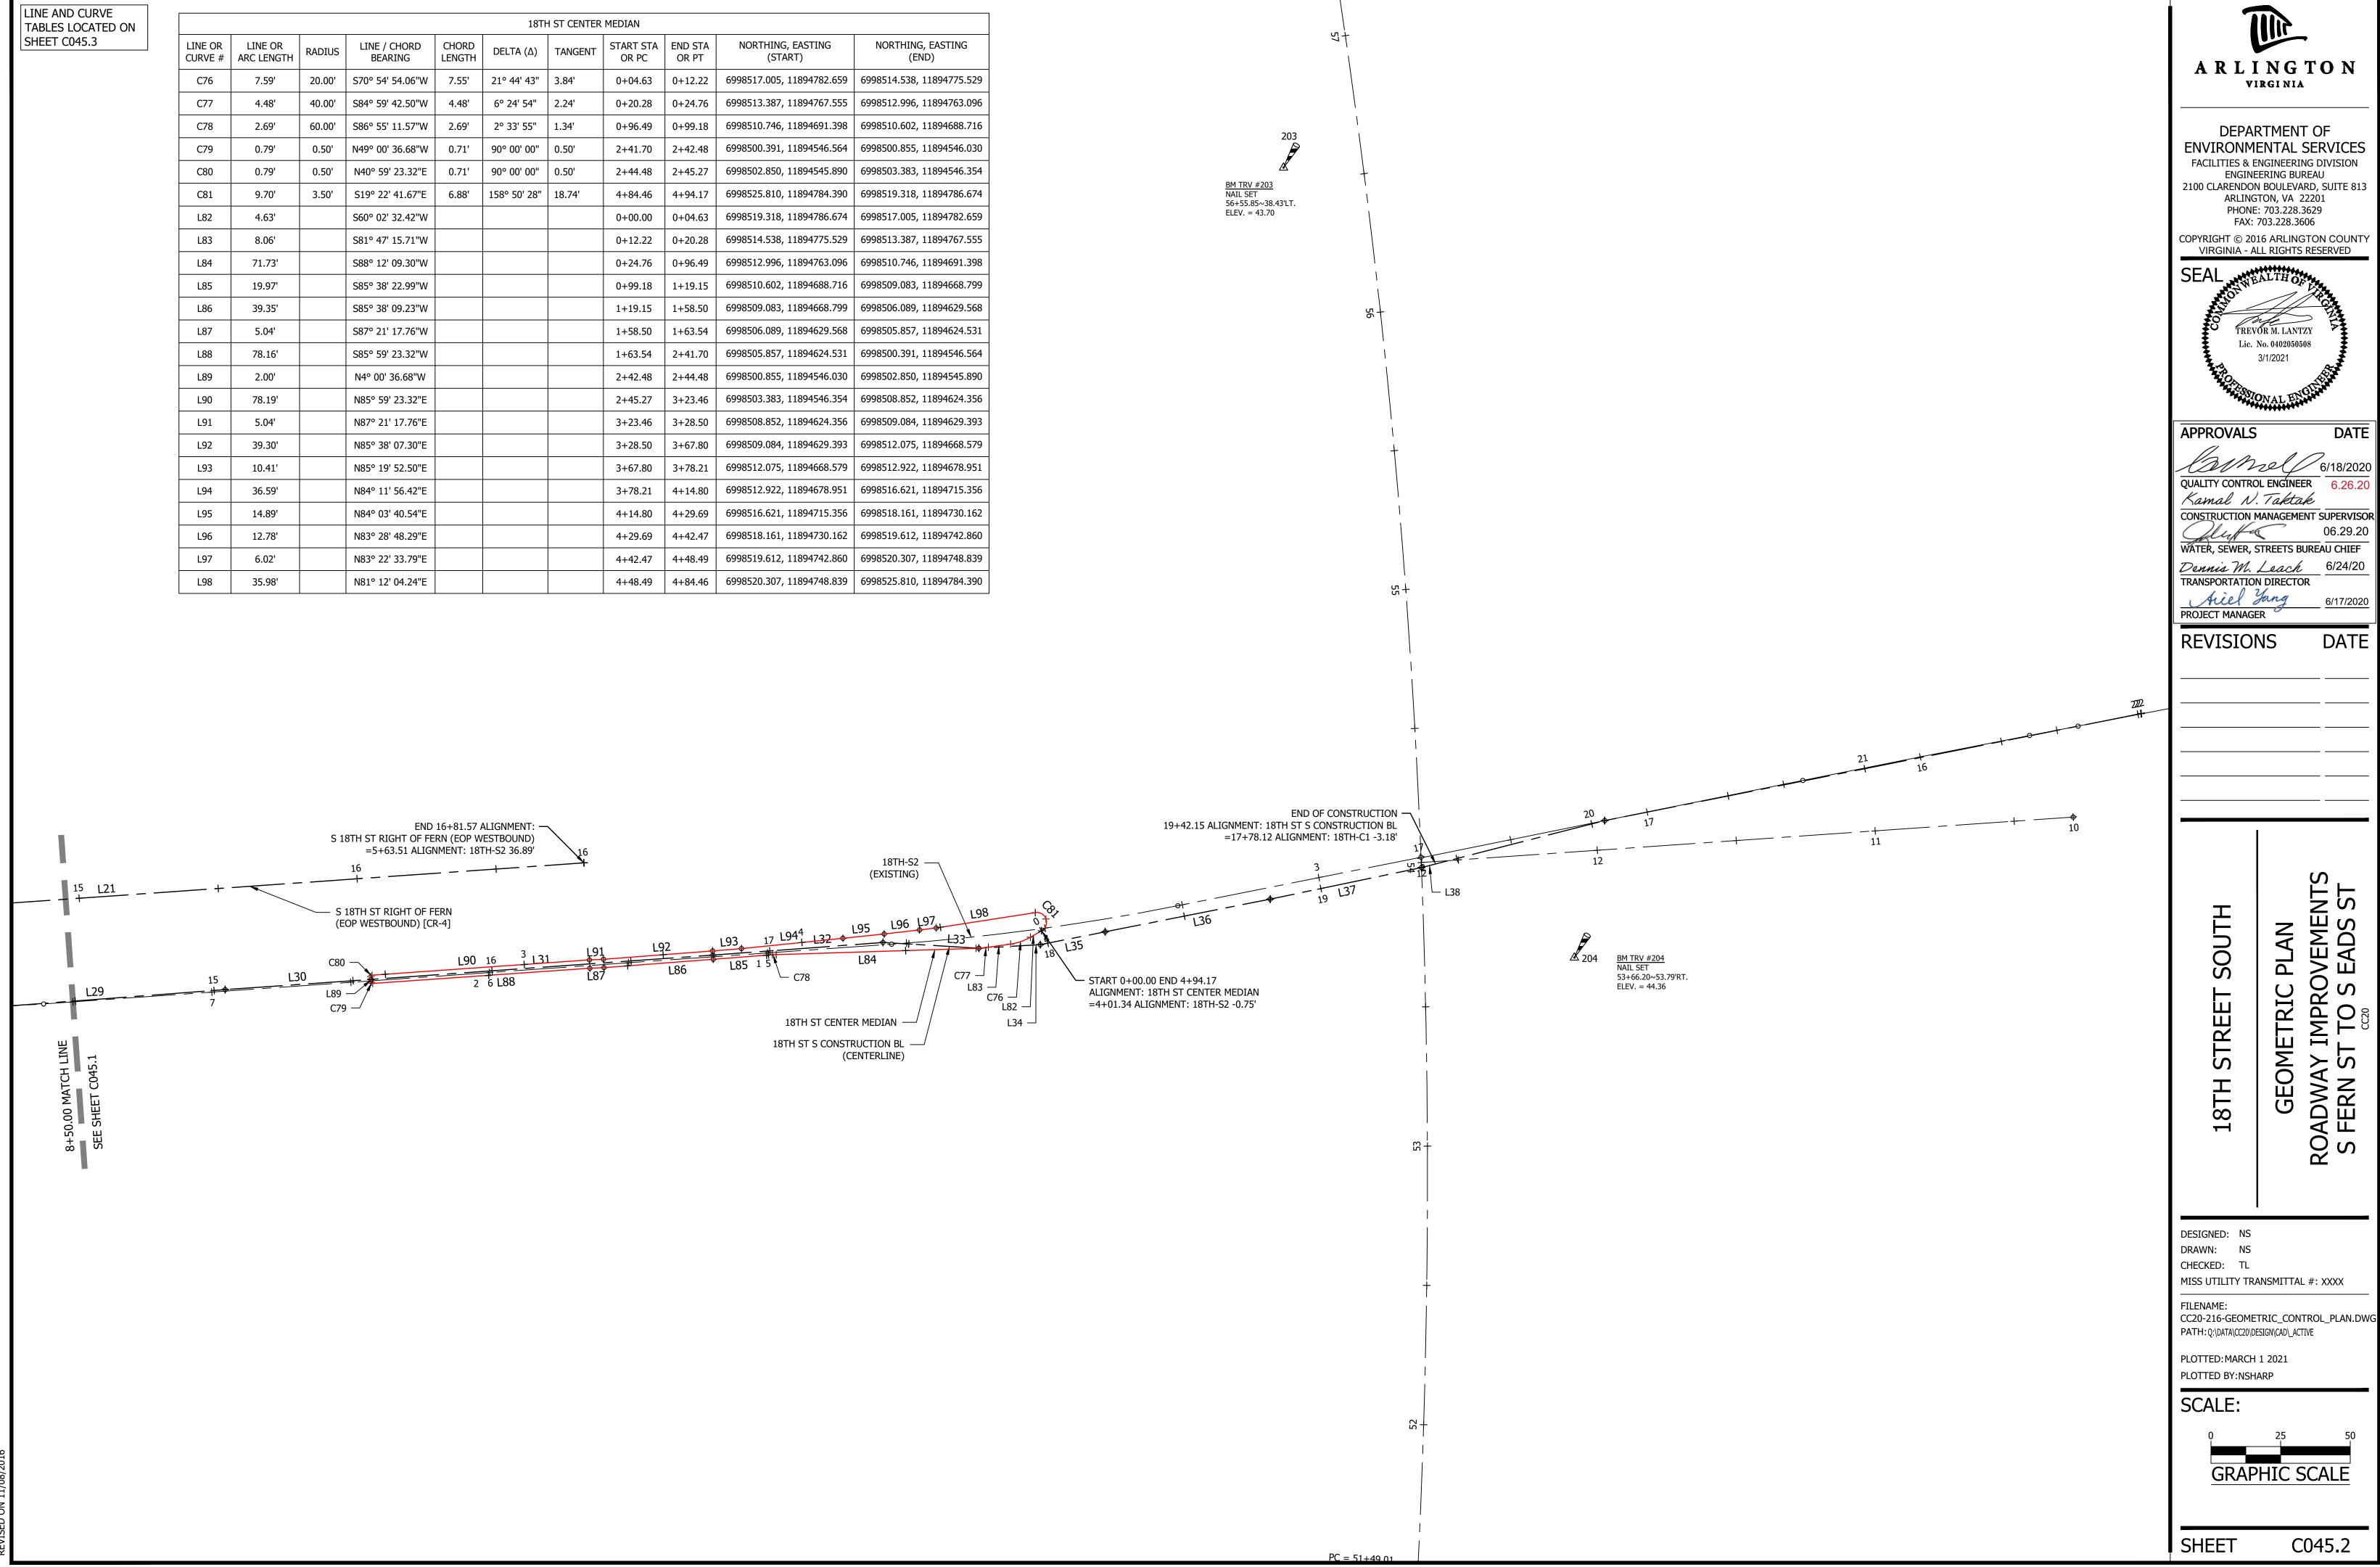

C64 24.70′ 400.00′ S81° 55′ 30.94″E 24.70′ 3° 32′ 17″ 12.35′ 0+09.40 0+34.10 6998552.767, 11894015.716 6998549.298, 11894094.168  C65 16.63′ 276.50′ S81° 52′ 45.52″E 16.63′ 3° 26′ 47″ 8.32′ 0+89.14 1+05.77 6998539.889, 11894094.396 6998537.540, 11894110.858  C66 7.07′ 2.25′ N6° 23′ 51.17″E 4.50′ 180° 00′ 00″ INFINITY′ 1+15.22 1+22.29 6998536.487, 11894120.248 6998540.959, 11894120.749  C68 13.59′ 106.00′ N79° 55′ 51.25″W 13.58′ 7° 20′ 35″ 6.80′ 1+37.60 1+51.18 6998542.665, 11894105.532 6998540.399, 11894020.749  C69 11.89′ 94.00′ N79° 53′ 03.15″W 11.89′ 7° 14′ 59″ 5.95″ 2+16.42 2+28.31 6998542.665, 134, 1189402.749  C70 3.95″ 2.50′ S51° 13′ 44.88″W 3.55′ 90° 31′ 25″ 2.52′ 2+29.16 2+33.11 6998560.534, 11894013.494 6998550.493, 11894013.494  L70 4.95″ S5° 58′ 02.41″W											
Control   Cont						18TH 5	ST S CONSTR	UCTION BL			
Control   Cont	ll .		RADIUS		1	DELTA (Δ)	TANGENT		-	•	·
Control   Cont	C26	250.08'	817.97'	S74° 09' 06.07"E	249.11'	17° 31' 02"	126.02'	6+00.00	8+50.08	6998609.497, 11893603.237	6998541.467, 11893842.878
1	C27	0.24'	10.00'	S84° 27' 03.66"E	0.24'	1° 20' 59"	0.12'	9+64.04	9+64.28	6998529.112, 11893956.165	6998529.090, 11893956.400
The color	C31	72.49'	400.50'	S88° 47' 16.65"E	72.39'	10° 22' 16"	36.35'	13+18.50	13+90.99	6998491.222, 11894308.566	6998489.690, 11894380.944
1	L22	113.96'		S83° 46' 33.95"E				8+50.08	9+64.04	6998541.467, 11893842.878	6998529.112, 11893956.165
1987   1987	L23	33.66'		S85° 07' 33.38"E				9+64.28	9+97.94	6998529.090, 11893956.400	6998526.229, 11893989.942
The color	L24	48.68'		S85° 05' 27.19"E				9+97.95	10+46.63	6998526.229, 11893989.948	6998522.063, 11894038.452
The column	L25	87.92'		S83° 14' 28.24"E				10+46.95	11+34.87	6998522.030, 11894038.773	6998511.683, 11894126.083
The column   The	L26	49.04'		S83° 36' 08.83"E				11+34.94	11+83.98	6998511.675, 11894126.146	6998506.211, 11894174.879
1.75	L27	46.01'		S83° 36' 08.83"E				11+83.98	12+29.99	6998506.211, 11894174.879	6998501.084, 11894220.606
1.0   1.25	L28	88.51'		S83° 36' 08.83"E				12+29.99	13+18.50	6998501.084, 11894220.606	6998491.222, 11894308.566
Line   12   12   10   10   10   10   10   10	L29	112.96'		N85° 41' 22.64"E				13+90.99	15+03.96	6998489.690, 11894380.944	6998498.181, 11894493.589
1.5	L30	52.50'		N85° 59' 23.32"E				15+03.96	15+56.46	6998498.181, 11894493.589	6998501.852, 11894545.960
The column   The	L31	123.04'		N85° 55' 57.18"E				15+56.46	16+79.50	6998501.852, 11894545.960	6998510.579, 11894668.688
Line   1.2.2.8   Line   1.0.1.1.1.1.1   Line   Li	L32	61.23'		N85° 45' 49.70"E				16+79.50	17+40.72	6998510.579, 11894668.688	6998515.102, 11894729.749
13	L33	34.47'		S86° 34' 31.96"E				17+40.72	17+75.19	6998515.102, 11894729.749	6998513.043, 11894764.152
Line   Co.   1.00	L34	22.08'		N86° 41' 18.13"E				17+75.19	17+97.27	6998513.043, 11894764.152	6998514.319, 11894786.196
1.5   1.5	L35	23.76'		N78° 47' 46.51"E				17+97.27	18+21.03	6998514.319, 11894786.196	6998518.936, 11894809.506
1.00	L36	60.39'		N78° 47' 46.51"E				18+21.03	18+81.42	6998518.936, 11894809.506	6998530.669, 11894868.744
Line Cor	L37	55.47'		N78° 13' 45.15"E				18+81.42	19+36.89	6998530.669, 11894868.744	6998541.984, 11894923.043
	L38	67.92'		N75° 36' 29.72"E				19+36.89	20+04.80	6998541.984, 11894923.043	6998558.865, 11894988.828
Marcian   Marc						FERN S	ST S CONSTR	UCTION BL			
Marcian   Marc			DADTHO	· · · · · · · · · · · · · · · · · · ·	1			START STA		•	,
Column   C	CURVE #	ARC LENGTH	KADIUS	BEARING	LENGTH	DELTA (Δ)	TANGENT	OR PC	OR PT	(START)	(END)
Column   C	C32	10.44'	675.00'	N7° 02' 29.55"W	10.44'	0° 53' 10"	5.22'	8+16.88	8+27.32	6998495.852, 11894176.158	6998506.211, 11894174.879
13-6   13-6   13-6   13-6   13-7	C33	60.25'	675.00'	N10° 02' 30.04"W	60.23'	5° 06' 51"	30.15'	8+27.32	8+87.57	6998506.211, 11894174.879	6998565.519, 11894164.377
Column   C	C34	70.45'	675.00'	N9° 36' 32.22"W	70.41'	5° 58' 47"	35.26'	9+54.11	10+24.56	6998630.457, 11894149.863	6998699.884, 11894138.109
Life   Co.	L39	316.88'		N6° 35' 54.70"W				5+00.00	8+16.88	6998181.071, 11894212.572	6998495.852, 11894176.158
CHINE OF	L40	66.54'		N12° 35' 55.69"W				8+87.57	9+54.11	6998565.519, 11894164.377	6998630.457, 11894149.863
INPER OR   ACCEPT   RADIUS   LINE / CFORD   CHORD	L41	275.44'		N6° 37' 08.75"W				10+24.56	13+00.00	6998699.884, 11894138.109	6998973.488, 11894106.359
CINNE # NACLENITH NATURE BEARING LENGTH VELLA (A) LANGEN OR PC OR PT (START) (END)  CRO 21.71 35.10 S817-95 30.947 21.70 75.047 75.18 0.0867 0.0905 0.09532.195, 11891005.130 0.99852.177, 11890027,018  CG2 26.34 400.07 N66*19*06.837 20.33 3*46*22* 13.17* 0.042.01 1-18.35 0.998519.587, 1189985.807 0.99852.278, 1189995.927  LG5 0.05						18TH S	ST CENTER M	EDIAN NOSE			
Color			RADIUS		1	DELTA (Δ)	TANGENT			1	· · · · · · · · · · · · · · · · · · ·
C61			251 50'			20 221 17"	10.96			, ,	, ,
Color										,	·
Line   Color   Line   Color   Line   Color										,	<u>'</u>
1.66			400.00		20.55	3 40 22	15.17	+			·
167   47.19'   N88" 12" 17.93"W   0-44.82   0-92.01   6998517.109, 11894032.969   6998518.587, 11893985.807     168   47.19'   N88" 12" 17.93"W   1-18.35   1+21.55   6998520.278, 11893995.527   6998520.589, 1189395.338     158   3.20'   N84" 25" 55.73"W   1-18.35   1+21.55   6998520.278, 11893995.527   6998520.589, 1189395.338     158   3.20'   N84" 25" 55.73"W   1-18.35   1+21.55   6998520.278, 11893995.527   6998520.589, 1189395.338     158   3.20'   N84" 25" 55.73"W   1-18.35   1+21.55   6998520.278, 11893995.527   6998520.589, 1189395.338     158   3.20'   N84" 25" 55.73"W   1-18.35   N87" 15" 15" 15" 15" 15" 15" 15" 15" 15" 15										,	· ·
Color   Colo								+	+	,	·
EIKE MEDIAN - LEFT										,	· ·
LINE OR CURVE # ARC LENGTH   RADIUS   LINE / CHORD   LENGTH   DELTA (A)   TANGENT   START STA   END STA   OF PT   CITAL OF PT							1			,	· ·
LINE OR CURVE # ARC LENGTH RADIUS LINE / CHORD BEARING LENGTH CENGTH CURVE # ARC LENGTH RADIUS LINE / CHORD BEARING LENGTH CENGTH CENGT	L09	3.20		1104 25 55.75 W				1+10.55	1+21.55	0990320.270, 11093939.327	0990320.309, 11093930.339
CURVE # ARC LENGTH RADUS BEARING LENGTH POLITA (A) PARGEN OR PC (START) (START) (END)  CG3 3.31' 2.50' 538° 51' 48.64"E 3.53' 89° 39' 42" 2.49' 1.04.95 0.08.86 6998555.71, 11894012.790 6998552.826, 11894015.182  CG4 24.70' 400.00' 581° 55' 30.94"E 24.70' 3° 32' 17" 12.35' 0.0940 0.34.10 6998552.767, 11894015.716 6998549.298, 1189400.168  CG5 16.63' 276.50' 581° 52' 45.52"E 16.63' 3° 26' 47" 8.32' 0.09814 1.05.77 6998539.889, 11894094.396 699857.540, 11894110.858  CG6 7.07' 2.25' N6° 23' 51.17"E 4.50' 180° 00' 00' 1NFINITY 1.15.22 1.22.29 6998536.487, 11894120.248 6998540.298, 11894027.749  CG8 13.59' 106.00' N79° 55' 51.25"W 13.58' 7° 20' 35" 6.80' 1.37.60 1.51.18 6998542.665, 11894015.532 6998545.039, 11894027.079  CG9 11.89' 94.00' N79° 53' 03.15"W 11.89' 7° 14' 59" 5.95' 2.16.42 2.28.31 6998560.34, 11894028.798 6998562.21, 11894017.097  C70 3.95' 2.50' 551° 13' 44.89"W 3.55' 90° 31' 25" 2.52' 2.429.16 2.33.11 6998560.34, 11894012.649 6998552.757, 11894013.484  L70 4.95' S58° 02.41"W 1		Ι			T	E	BIKE MEDIAN			1	
C64 24.70' 400.00' S81° 55' 30.94"E 24.70' 3° 32' 17' 12.35' 0+09.40 0+34.10 6998552.76', 11894015.716 6998549.298, 11894094.066 C65 16.63' 276.50' S81° 52' 45.52"E 16.63' 3° 26' 47' 8.32' 0+99.14 1+05.77 6998539.889, 11894094.36 6998537.540, 11894110.858 C66 7.07' 2.25' N6° 23' 51.17"E 4.50' 180° 00' 00' INFINITY' 1+15.22 1+22.29 6998536.487, 11894120.248 6998540.959, 11894120.749 C68 13.59' 106.00' N79° 55' 51.25"W 13.58' 7° 20' 35' 6.80' 1+37.60 1+51.18 6998542.665, 11894105.532 6998545.039, 11894092.166 C69 111.89' 94.00' N79° 53' 03.15"W 11.89' 7° 14' 59' 5.95' 2+16.42 2+28.31 6998560.534, 11894028.798 6998562.621, 11894017.097 C70 3.95' 2.50' S51° 13' 44.88"W 3.55' 90° 31' 25" 2.52' 2+29.16 2+33.11 6998560.534, 11894013.484 6998555.571, 11894012.970 L70 4.95' S5° 56' 02.41"W	l		RADIUS	•	1	DELTA (Δ)	TANGENT	I		1	1
C65 16.63' 276.50' S81° 52' 45.52"E 16.63' 3° 26' 47" 8.32' 0+89.14 1+05.77 6998539.889, 11894094.396 6998537.540, 11894110.858 C66 7.07' 2.25' N6° 23' 51.17"E 4.50' 180° 00' 00" INFINITY' 1+15.22 1+22.29 6998536.487, 11894120.248 6998540.959, 11894120.749 C68 13.59' 106.00' N79° 55' 51.25"W 13.58' 7° 20' 35" 6.80' 1+37.60 1+51.18 6998542.665, 11894105.532 6998545.039, 11894092.166 C69 11.89' 94.00' N79° 53' 03.15"W 11.89' 7° 14' 59" 5.95' 2+16.42 2+28.31 699856.265, 11894105.532 6998542.639, 11894017.097 C70 3.95' 2.50' S51° 13' 44.81"W 3.55' 90° 31' 25" 2.52' 2+29.16 2+33.11 699856.271, 71.1894016.254 699856.493, 11894013.484 699856.493, 11894013.484 6998555.71, 11894015.716 1.70 4.95' S5° 58' 02.41"W 0.000	C63	3.91'	2.50'	S38° 51' 48.64"E	3.53'	89° 39' 42"	2.49'	0+04.95	0+08.86	6998555.571, 11894012.970	6998552.826, 11894015.182
C65 16.63' Z76.50' S81° S2' 45.52"E 16.63' 3° 26' 47" 8.32' 0+89.14 1+05.77 6998539.889, 11894094.396 6998537.540, 11894110.858 C66 7.07' 2.25' N6° 23' 51.17"E 4.50' 180° 00' 0" INFINITY' 1+15.22 1+22.29 6998536.487, 11894120.248 6998540.959, 11894020.749 C68 13.59' 106.00' N79° 55' 51.25"W 13.58' 7° 20' 35" 6.80' 1+37.60 1+51.18 6998542.665, 11894105.532 6998545.039, 11894092.166 C69 11.89' 94.00' N79° 53' 03.15"W 11.89' 7° 14' 59" 5.95' 2+16.42 2+28.31 6998560.534, 1189402.248 6998562.621, 11894017.097 C70 3.95' 2.50' S51° 13' 44.89" 3.55' 90° 31' 25" 2.52' 2+29.16 2+33.11 6998562.717, 11894016.254 6998560.493, 11894013.484 L70 4.95' S5° 58' 02.41"W								+		6998552.767, 11894015.716	6998549.298, 11894040.168
C68 13.59' 106.00' N79° 55' 51.25"W 13.58' 7° 20' 35" 6.80' 1+37.60 1+51.18 6998542.665, 11894105.532 6998545.039, 11894092.166   C69 11.89' 94.00' N79° 53' 03.15"W 11.89' 7° 14' 59" 5.95' 2+16.42 2+28.31 6998560.534, 11894028.798 6998562.621, 11894017.097   C70 3.95' 2.50' S51° 13' 44.88"W 3.55' 90° 31' 25" 2.52' 2+29.16 2+33.11 6998562.717, 11894016.254 6998560.493, 11894013.484   L70 4.95'	C65	16.63'	276.50'	S81° 52' 45.52"E	16.63'	3° 26' 47"	8.32'	0+89.14	1+05.77	6998539.889, 11894094.396	6998537.540, 11894110.858
C68 13.59										6998536.487, 11894120.248	6998540.959, 11894120.749
C69 11.89' 94.00' N79° 53' 03.15"W 11.89' 7° 14' 59" 5.95' 2+16.42 2+28.31 6998560.534, 11894028.798 6998562.621, 11894017.097 C70 3.95' 2.50' \$51° 13' 44.88"W 3.55' 90° 31' 25" 2.52' 2+29.16 2+33.11 6998562.717, 11894016.254 6998560.493, 11894013.484 L70 4.95' \$55° 58' 02.41"W \$ 0+00.00 0+04.95 6998560.493, 11894013.484 6998555.571, 11894012.970 L71 0.54' \$583° 41' 39.68"E \$ 0+08.86 0+09.40 6998552.826, 11894015.182 6998552.767, 11894015.716 L72 \$5.04' \$580° 09' 22.21"E \$ 0+04.41 0+08.86 0+09.40 6998552.826, 11894015.182 6998539.889, 11894094.396 L73 9.45' \$883° 36' 08.83"E \$ 0+04.41 0+05.77 1+15.22 6998537.540, 11894110.858 6998536.487, 11894120.248 L74 15.31' \$N83° 36' 08.83"W \$ 1+22.29 1+37.60 6998540.959, 11894120.749 6998542.665, 11894015.532 L76 65.23' \$N76° 15' 33.66"W \$ 1-40.41 1+51.18 2+16.42 6998545.039, 11894092.166 6998560.534, 1189408.798 L77 0.85' \$N83° 30' 32.65"W \$ 1-40.41 1+51.18 2+16.42 6998545.039, 11894092.166 6998560.534, 11894016.254 LINE OR ARC LENGTH RADIUS LINE / CHORD BEAKING LENGTH DELTA (Δ) TANGENT START STA OR PT (START) (START) (END) C71 5.67' 1.80' N6° 23' 49.92"E 3.61' 180° 00' 00" INFINITY' 0+72.17 0+77.84 6998523.914, 11894218.921 6998527.499, 11894219.323 C72 100.91' 806.00' \$87° 11' 20.63"E 100.84' 7° 10' 24" 50.52' 0+96.00 1+96.91 6998525.475, 11894237.373 6998520.530, 11894338.094 C73 14.38' 4.50' \$0° 45' 56.87"W 9.00' 183° 04' 59" 167.22' 1+96.91 2+11.29 6998520.530, 11894338.094 6998511.534, 11894337.974 6998511.534, 11894337.974 6998511.534, 11894337.974	C68	13.59'	106.00'	N79° 55' 51.25"W	13.58'	7° 20' 35"	6.80'	1+37.60	1+51.18	6998542.665, 11894105.532	6998545.039, 11894092.166
C70 3.95' 2.50' S51° 13' 44.88"W 3.55' 90° 31' 25" 2.52' 2+29.16 2+33.11 6998562.717, 11894016.254 6998560.493, 11894013.484  L70 4.95' S5° 58' 02.41"W 0+00.00 0+04.95 6998560.493, 11894013.484 6998555.571, 11894012.970  L71 0.54' S83° 41' 39.68"E 0+08.86 0+09.40 6998552.826, 11894015.182 6998552.767, 11894015.716  L72 55.04' S80° 09' 22.21"E 0+04.41.0 0+89.14 6998549.298, 1189404.168 6998539.889, 11894094.396  L73 9.45' S83° 36' 08.83"W 1+05.77 1+15.22 6998537.540, 11894110.858 6998536.487, 11894120.248  L74 15.31' N83° 36' 08.83"W 1+22.29 1+37.60 6998540.959, 11894120.749 6998542.665, 11894105.532  L76 65.23' N76° 15' 33.66"W 1+51.18 2+16.42 6998540.959, 11894092.166 6998560.534, 11894028.798  L77 0.85' N83° 30' 32.65"W 2+28.31 2+29.16 6998562.621, 11894017.097 6998562.717, 11894016.254  LINE OR CURVE # ARC LENGTH RADIUS LINE / CHORD BEARING LENGTH DELTA (A) TANGENT OR PC OR PC OR PT (START) 6998527.499, 11894219.323  C72 100.91' 806.00' S87° 11' 20.63"E 100.84' 7° 10' 24" 50.52' 0+96.00 1+96.91 6998520.530, 11894338.094 6998511.534, 11894331.073  C73 14.38' 4.50' S0° 45' 56.87"W 9.00' 183° 04' 59" 167.22' 1+96.91 2+11.29 6998520.530, 11894338.094 6998511.534, 11894331.073  C74 26.98' 378.00' N85° 38' 51.33"W 26.98' 4° 05' 25" 13.50' 2+11.29 2+38.28 6998511.534, 11894331.073	C69	11.89'	94.00'	N79° 53' 03.15"W	11.89'	7° 14' 59"	5.95'	2+16.42	2+28.31	6998560.534, 11894028.798	6998562.621, 11894017.097
L70 4.95' S5° 58' 02.41"W								+		,	·
L71 0.54' S83° 41' 39.68"E 0.0+08.86 0+09.40 6998552.826, 11894015.182 699852.767, 11894015.716 L72 55.04' S80° 09' 22.21"E 0.0+34.10 0+69.14 6998549.298, 11894040.168 6998539.889, 11894094.396 L73 9.45' S83° 36' 08.83"E 1+05.77 1+15.22 6998537.540, 11894110.858 6998536.487, 11894120.248 L74 15.31' N83° 36' 08.83"W 1+22.29 1+37.60 6998540.959, 11894120.749 6998542.665, 11894105.532 L76 65.23' N76° 15' 33.66"W 1+51.18 2+16.42 6998545.039, 11894092.166 6998560.534, 11894028.798 L77 0.85' N83° 30' 32.65"W 2+28.31 2+29.16 6998562.621, 11894017.097 6998562.717, 11894016.254  LINE OR CURVE # ARC LENGTH RADIUS LINE / CHORD BEARING LENGTH LENGTH LENGTH CURVE # N60° 23' 49.92"E 3.61' 180° 00' 00" INFINITY' 0+72.17 0+77.84 6998523.914, 11894218.921 6998527.499, 11894219.323  C72 100.91' 806.00' S87° 11' 20.63"E 100.84' 7° 10' 24" 50.52' 0+96.00 1+96.91 6998525.475, 11894237.373 6998520.530, 11894338.094 6998511.534, 11894337.974 6998513.582, 11894311.073								+		,	·
L72 55.04' S80° 09' 22.21"E										,	6998552.767, 11894015.716
L73 9.45' S83° 36' 08.83"E 1+05.77 1+15.22 6998537.540, 11894110.858 6998536.487, 11894120.248  L74 15.31' N83° 36' 08.83"W 1+22.29 1+37.60 6998540.959, 11894120.749 6998542.665, 11894105.532  L76 65.23' N76° 15' 33.66"W 1+51.18 2+16.42 6998545.039, 11894092.166 6998560.534, 11894016.254  L77 0.85' N83° 30' 32.65"W 2+28.31 2+29.16 6998562.621, 11894017.097 6998562.717, 11894016.254  BIKE MEDIAN - RIGHT  LINE OR ARC LENGTH ARC LENGTH BEARING LENGTH LENGTH LENGTH CHORD SEARING (END)  C71 5.67' 1.80' N6° 23' 49.92"E 3.61' 180° 00' 00" INFINITY' 0+72.17 0+77.84 6998523.914, 11894218.921 6998527.499, 11894219.323  C72 100.91' 806.00' S87° 11' 20.63"E 100.84' 7° 10' 24" 50.52' 0+96.00 1+96.91 6998525.475, 11894237.373 6998520.530, 11894338.094  C73 14.38' 4.50' S0° 45' 56.87"W 9.00' 183° 04' 59" 167.22' 1+96.91 2+11.29 6998520.530, 11894338.094 6998511.534, 11894337.974  C74 26.98' 378.00' N85° 38' 51.33"W 26.98' 4° 05' 25" 13.50' 2+11.29 2+38.28 6998511.534, 11894337.974 6998513.582, 11894311.073										,	6998539.889, 11894094.396
L74 15.31' N83° 36' 08.83"W 1+22.29 1+37.60 6998540.959, 11894120.749 6998542.665, 11894105.532 L76 65.23' N76° 15' 33.66"W 1+51.18 2+16.42 6998545.039, 11894092.166 6998560.534, 11894028.798 L77 0.85' N83° 30' 32.65"W 2+28.31 2+29.16 6998562.621, 11894017.097 6998562.717, 11894016.254  BIKE MEDIAN - RIGHT  LINE OR CURVE # ARC LENGTH RADIUS BEARING LENGTH DELTA (Δ) TANGENT OR PC OR PT (START) (											6998536.487, 11894120.248
LINE OR CURVE # ARC LENGTH RADIUS LINE / CHORD BEARING LENGTH LENGTH CON 1.80° 1.80° 1.60° 1.80										,	6998542.665, 11894105.532
1.77   1.80								+		·	6998560.534, 11894028.798
BIKE MEDIAN - RIGHT  LINE OR ARC LENGTH RADIUS LINE / CHORD BEARING LENGTH DELTA (Δ) TANGENT START STA OR PC OR PT OF PC OR PT OR PT OF PC OR PT OR PT OF PC OR PT OR PT OF PC OR PT OR P										,	6998562.717, 11894016.254
LINE OR CURVE # RADIUS LINE / CHORD BEARING CHORD LENGTH DELTA (Δ) TANGENT START STA OR PC OR PT NORTHING, EASTING (START) NORTHING, EASTING (END)  C71 5.67' 1.80' N6° 23' 49.92"E 3.61' 180° 00' 00" INFINITY' 0+72.17 0+77.84 6998523.914, 11894218.921 6998527.499, 11894219.323  C72 100.91' 806.00' S87° 11' 20.63"E 100.84' 7° 10' 24" 50.52' 0+96.00 1+96.91 6998525.475, 11894237.373 6998520.530, 11894338.094  C73 14.38' 4.50' S0° 45' 56.87"W 9.00' 183° 04' 59" 167.22' 1+96.91 2+11.29 6998520.530, 11894338.094 6998511.534, 11894337.974  C74 26.98' 378.00' N85° 38' 51.33"W 26.98' 4° 05' 25" 13.50' 2+11.29 2+38.28 6998511.534, 11894337.974 6998513.582, 11894311.073		1 2.00			<u> </u>					,	, ==== .525.251
CURVE # ARC LENGTH RADIUS BEARING LENGTH DELTA (A) TANGENT OR PC OR PT (START) (END)  C71 5.67' 1.80' N6° 23' 49.92"E 3.61' 180° 00' 00" INFINITY' 0+72.17 0+77.84 6998523.914, 11894218.921 6998527.499, 11894219.323  C72 100.91' 806.00' \$87° 11' 20.63"E 100.84' 7° 10' 24" 50.52' 0+96.00 1+96.91 6998525.475, 11894237.373 6998520.530, 11894338.094  C73 14.38' 4.50' \$0° 45' 56.87"W 9.00' 183° 04' 59" 167.22' 1+96.91 2+11.29 6998520.530, 11894338.094 6998511.534, 11894337.974  C74 26.98' 378.00' N85° 38' 51.33"W 26.98' 4° 05' 25" 13.50' 2+11.29 2+38.28 6998511.534, 11894337.974 6998513.582, 11894311.073		:				B)	ike median -			NORTHWO TIES	NORTH TO THE
C72 100.91' 806.00' S87° 11' 20.63"E 100.84' 7° 10' 24" 50.52' 0+96.00 1+96.91 6998525.475, 11894237.373 6998520.530, 11894338.094  C73 14.38' 4.50' S0° 45' 56.87"W 9.00' 183° 04' 59" 167.22' 1+96.91 2+11.29 6998520.530, 11894338.094 6998511.534, 11894337.974  C74 26.98' 378.00' N85° 38' 51.33"W 26.98' 4° 05' 25" 13.50' 2+11.29 2+38.28 6998511.534, 11894337.974 6998513.582, 11894311.073			RADIUS		1	DELTA (Δ)	TANGENT				•
C73 14.38' 4.50' S0° 45' 56.87"W 9.00' 183° 04' 59" 167.22' 1+96.91 2+11.29 6998520.530, 11894338.094 6998511.534, 11894337.974  C74 26.98' 378.00' N85° 38' 51.33"W 26.98' 4° 05' 25" 13.50' 2+11.29 2+38.28 6998511.534, 11894337.974 6998513.582, 11894311.073	C71	5.67'	1.80'	N6° 23' 49.92"E	3.61'	180° 00' 00"	INFINITY'	0+72.17	0+77.84	6998523.914, 11894218.921	6998527.499, 11894219.323
C73 14.38' 4.50' S0° 45' 56.87"W 9.00' 183° 04' 59" 167.22' 1+96.91 2+11.29 6998520.530, 11894338.094 6998511.534, 11894337.974  C74 26.98' 378.00' N85° 38' 51.33"W 26.98' 4° 05' 25" 13.50' 2+11.29 2+38.28 6998511.534, 11894337.974 6998513.582, 11894311.073								+		6998525.475, 11894237.373	6998520.530, 11894338.094
C74 26.98' 378.00' N85° 38' 51.33"W 26.98' 4° 05' 25" 13.50' 2+11.29 2+38.28 6998511.534, 11894337.974 6998513.582, 11894311.073		14.38'	4.50'		9.00'	183° 04' 59"	167.22'	1+96.91	+	6998520.530, 11894338.094	6998511.534, 11894337.974
					26.98'	4° 05' 25"		2+11.29		6998511.534, 11894337.974	6998513.582, 11894311.073
	1 70									6998515.872, 11894290.644	6998523.914, 11894218.921

2+38.28 2+58.83 6998513.582, 11894311.073 6998515.872, 11894290.644

					S 18TH ST LEF	T OF SERVICE	·	, 	,	
LINE OR CURVE #	LINE OR ARC LENGTH	RADIUS	LINE / CHORD BEARING	CHORD LENGTH	DELTA (Δ)	TANGENT	START STA OR PC	END STA OR PT	NORTHING, EASTING (START)	NORTHING, EASTING (END)
C1	40.36'	148.50'	S87° 46' 50.45"E	40.24'	15° 34' 22"	20.31'	5+19.95	5+60.31	6998504.248, 11893793.410	6998502.690, 11893833.0
C2	31.33'	151.50'	S89° 38' 35.71"E	31.27'	11° 50' 52"	15.72'	5+60.31	5+91.64	6998502.690, 11893833.617	6998502.495, 11893864.
C3	23.74'	8.00'	S1° 18' 01.09"W	15.94'	170° 02' 22"	91.80'	6+81.60	7+05.34	6998492.654, 11893954.309	6998476.718, 11893953.
C4	9.19'	16.50'	N77° 43' 20.26"W	9.07'	31° 54' 57"	4.72'	7+09.15	7+18.35	6998476.473, 11893950.142	6998478.403, 11893941.
C5	7.63'	13.50'	N77° 57' 34.99"W	7.53'	32° 23' 27"	3.92'	7+18.35	7+25.98	6998478.403, 11893941.277	6998479.973, 11893933.
L1	89.96'		S83° 43' 09.81"E				5+91.64	6+81.60	6998502.495, 11893864.888	6998492.654, 11893954.
L2	3.81'		S86° 19' 12.00"W				7+05.34	7+09.15	6998476.718, 11893953.947	6998476.473, 11893950.
L3	89.67'		S85° 50' 41.45"W				7+25.98	8+15.64	6998479.973, 11893933.912	6998473.476, 11893844.
L4	1.84'		S85° 58' 03.23"W				8+15.64	8+17.49	6998473.476, 11893844.481	6998473.347, 11893842.
					S 18TH ST LEI	T OF FERN (	FOP FASTROLI	ND)		
LINE OR CURVE #	LINE OR ARC LENGTH	RADIUS	LINE / CHORD BEARING	CHORD LENGTH	DELTA (Δ)	TANGENT	START STA OR PC	END STA OR PT	NORTHING, EASTING (START)	NORTHING, EASTING (END)
C6	12.98'	13.50'	N58° 25' 34.07"E	12.48'	55° 04' 57"	7.04'	7+05.44	7+18.41	6998467.049, 11893987.790	6998473.585, 11893998.4
C7	17.54'	16.50'	N61° 20' 24.22"E	16.73'	60° 54' 36"	9.70'	7+27.69	7+45.23	6998481.547, 11894003.188	6998489.569, 11894017.8
C8	4.71'	16.50'	S80° 01' 29.62"E	4.70'	16° 21' 37"	2.37'	7+68.19	7+72.90	6998488.850, 11894040.813	6998488.036, 11894045.4
C9	4.11'	18.50'	S78° 12' 11.84"E	4.10'	12° 43' 01"	2.06'	8+08.81	8+12.92	6998476.848, 11894079.556	6998476.010, 11894083.5
C10	42.69'	31.50'	S44° 33' 35.84"E	39.50'	77° 39' 27"	25.35'	8+69.28	9+11.97	6998469.916, 11894139.597	6998441.771, 11894167.3
C11	7.32'	11.50'	S12° 30' 15.37"W	7.20'	36° 28' 16"	3.79'	9+11.97	9+19.29	6998441.771, 11894167.313	6998434.745, 11894165.7
C12	8.77'	13.53'	S12° 07' 06.31"W	8.62'	37° 08' 56"	4.55'	9+19.29	9+28.07	6998434.745, 11894165.755	6998426.316, 11894163.9
L5	34.06'	13.33	N85° 58' 01.09"E	0.02	37 00 30		6+71.38	7+05.44	6998464.653, 11893953.818	6998467.049, 11893987.7
L6	9.28'		N30° 53' 06.36"E				7+18.41	7+27.69	6998473.585, 11893998.426	6998481.547, 11894003.1
L7	22.96'		S88° 12' 17.93"E				7+45.23	7+68.19	6998489.569, 11894017.865	6998488.850, 11894040.8
L8	35.91'		S71° 50' 41.32"E				7+72.90	8+08.81	6998488.036, 11894045.437	6998476.848, 11894079.5
L9	11.18'		S84° 33' 42.36"E				8+12.92	8+24.10	6998476.010, 11894083.568	6998474.951, 11894094.6
L10	45.18'		S83° 36' 07.83"E				8+24.10	8+69.28	6998474.951, 11894094.698	6998469.916, 11894139.5
L11	41.58'		S6° 30' 10.59"E				9+28.07	9+69.65	6998426.316, 11894163.945	6998385.000, 11894168.6
									,	,
				1	S 18TH ST RIG	GHT OF FERN	Ť	<u>,                                     </u>	1	
LINE OR CURVE #	LINE OR ARC LENGTH	RADIUS	LINE / CHORD BEARING	CHORD LENGTH	DELTA (Δ)	TANGENT	START STA OR PC	END STA OR PT	NORTHING, EASTING (START)	NORTHING, EASTING (END)
C13	8.30'	13.50'	N24° 03' 37.37"W	8.17'	35° 14' 54"	4.29'	10+63.87	10+72.17	6998419.874, 11894205.517	6998427.338, 11894202
C14	10.15'	16.50'	N24° 03' 35.46"W	9.99'	35° 14' 51"	5.24'	10+72.17	10+82.33	6998427.338, 11894202.184	6998436.461, 11894198
C15	53.21'	26.50'	N51° 04' 53.12"E	44.71'	115° 02' 06"	41.62'	10+86.07	11+39.28	6998440.187, 11894197.691	6998468.274, 11894232
C16	24.83'	98.50'	S78° 37' 19.78"E	24.76'	14° 26' 32"	12.48'	11+71.17	11+96.00	6998458.102, 11894262.702	6998453.217, 11894286
L12	7.12'		N6° 26' 09.94"W				10+56.75	10+63.87	6998412.799, 11894206.315	6998419.874, 11894205
L13	3.75'		N6° 26' 09.94"W				10+82.33	10+86.07	6998436.461, 11894198.111	6998440.187, 11894197
L14	31.89'		S71° 24' 03.81"E				11+39.28	11+71.17	6998468.274, 11894232.476	6998458.102, 11894262
									,	,
LINE OR	LINEOD		LINE / CHORD	CHORD	S 181H SI LE	FI OF FERN	(EOP WESTBO	<u>,                                     </u>	NORTHING, EASTING	NORTHING, EASTING
LINE OR CURVE #	LINE OR ARC LENGTH	RADIUS	LINE / CHORD BEARING	CHORD LENGTH	DELTA (Δ)	TANGENT	START STA OR PC	END STA OR PT	(START)	(END)
C17	12.46'	98.50'	S79° 53' 03.15"E	12.46'	7° 14' 59"	6.24'	11+21.78	11+34.24	6998567.093, 11894017.606	6998564.905, 11894029
C18	13.01'	101.50'	S79° 55' 51.25"E	13.00'	7° 20' 35"	6.51'	11+99.48	12+12.49	6998549.410, 11894093.235	6998547.137, 11894106
C19	40.90'	21.50'	N41° 53' 57.74"E	35.01'	108° 59' 47"	30.14'	12+33.58	12+74.48	6998544.786, 11894127.001	6998570.842, 11894150
C20	71.75'	687.50'	N9° 36' 32.22"W	71.72'	5° 58' 47"	35.91'	13+32.78	14+04.53	6998627.731, 11894137.664	6998698.443, 11894125
C21	11.85'	16.50'	N27° 12' 01.21"W	11.60'	41° 09' 45"	6.20'	14+54.38	14+66.23	6998747.961, 11894119.946	6998758.279, 11894114
C22	9.96'	13.50'	N26° 38' 16.88"W	9.74'	42° 17' 14"	5.22'	14+66.23	14+76.20	6998758.279, 11894114.643	6998766.985, 11894110
L15	1.88'		S83° 30' 32.65"E				11+19.90	11+21.78	6998567.305, 11894015.738	6998567.093, 11894017
L16	65.23'		S76° 15' 33.66"E				11+34.24	11+99.48	6998564.905, 11894029.867	6998549.410, 11894093
L17	21.10'		S83° 36' 08.83"E				12+12.49	12+33.58	6998547.137, 11894106.034	6998544.786, 11894127
L18	58.29'		N12° 35' 55.69"W				12+74.48	13+32.78	6998570.842, 11894150.379	6998627.731, 11894137
L19	49.85'		N6° 37' 08.75"W				14+04.53	14+54.38	6998698.443, 11894125.692	6998747.961, 11894119
		<u> </u>	I	1	S 18TH CT DTC	HT OF FEDA	(FOD MESTRO	IIIND)	1	1
I INE OD	LINE OD		LINE / CLIODS		S 18TH ST RIG		`		NORTHING, EASTING	NODTHING EACTING
LINE OR CURVE #	LINE OR ARC LENGTH	RADIUS	LINE / CHORD BEARING	CHORD LENGTH	DELTA (Δ)	TANGENT	START STA OR PC	END STA OR PT	NORTHING, EASTING (START)	NORTHING, EASTING (END)
C23	7.41'	13.50'	S2° 58' 08.39"W	7.32'	31° 28' 05"	3.80'	11+94.12	12+01.53	6998589.649, 11894179.278	6998582.337, 11894178.
C24	66.96'	37.50'	S32° 26' 58.87"E	58.41'	102° 18' 20"	46.56'	12+01.53	12+68.49	6998582.337, 11894178.899	6998533.046, 11894210.
C25	145.59'	801.50'	S88° 48' 22.76"E	145.39'	10° 24' 28"	73.00'	12+96.30	14+41.89	6998529.947, 11894237.875	6998526.918, 11894383.
C25			ļ '					l		l .


S83° 36' 08.83"E

N85° 59' 23.32"E

12+68.49 | 12+96.30 | 6998533.046, 11894210.240 | 6998529.947, 11894237.875 |

14+41.89 | 16+81.61 | 6998526.918, 11894383.235 | 6998543.683, 11894622.369 |

	BENCHMARK T	ABLE
BM#	NORTHING	EASTING
200	6999342.5062	11894165.8183
201	6999438.1307	11894730.9714
202	6999089.9634	11894882.7259
203	6998793.2265	11894873.5154
204	6998509.6607	11894977.9298
300	6998535.6686	11894587.5405
301	6998495.8100	11894213.5573
302	6998480.0643	11893821.7028
303	6998434.8404	11893470.9261
REFER	TO SHEET C011.1-C011.3 S	SURVEY CONTROL TABL

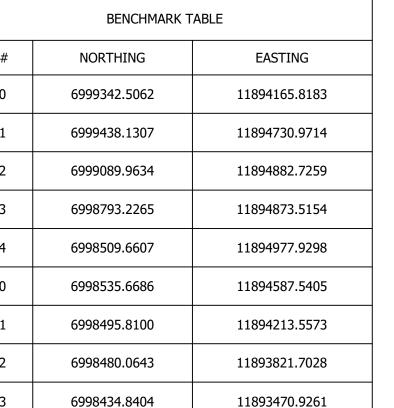



DEPARTMENT OF **ENVIRONMENTAL SERVICES** FACILITIES & ENGINEERING DIVISION ENGINEERING BUREAU 2100 CLARENDON BOULEVARD, SUITE 813 ARLINGTON, VA 22201 PHONE: 703.228.3629 FAX: 703.228.3606

COPYRIGHT © 2016 ARLINGTON COUNTY VIRGINIA - ALL RIGHTS RESERVED

APPROVALS QUALITY CONTROL ENGINEER 6.26.20 Kamal N. Taktak CONSTRUCTION MANAGEMENT SUPERVISOR

WATER, SEWER, STREETS BUREAU CHIEF Dennis M. Leach
TRANSPORTATION DIRECTOR

Aciel Yang
6/17/2020 PROJECT MANAGER

**REVISIONS** 

SOUTH 18TH STREET

GEOMETRIC PLAN ROADWAY IMPROVEMENTS S FERN ST TO S EADS ST

DESIGNED: NS DRAWN: NS CHECKED: TL MISS UTILITY TRANSMITTAL #: XXXX

FILENAME: CC20-216-GEOMETRIC\_CONTROL\_PLAN.DWG PATH: Q:\DATA\CC20\DESIGN\CAD\\_ACTIVE

PLOTTED: MARCH 1 2021 PLOTTED BY:NSHARP

SCALE:


SHEET C045.3


S83° 36' 08.83"E

N83° 36' 08.83"W

18.16'

L80

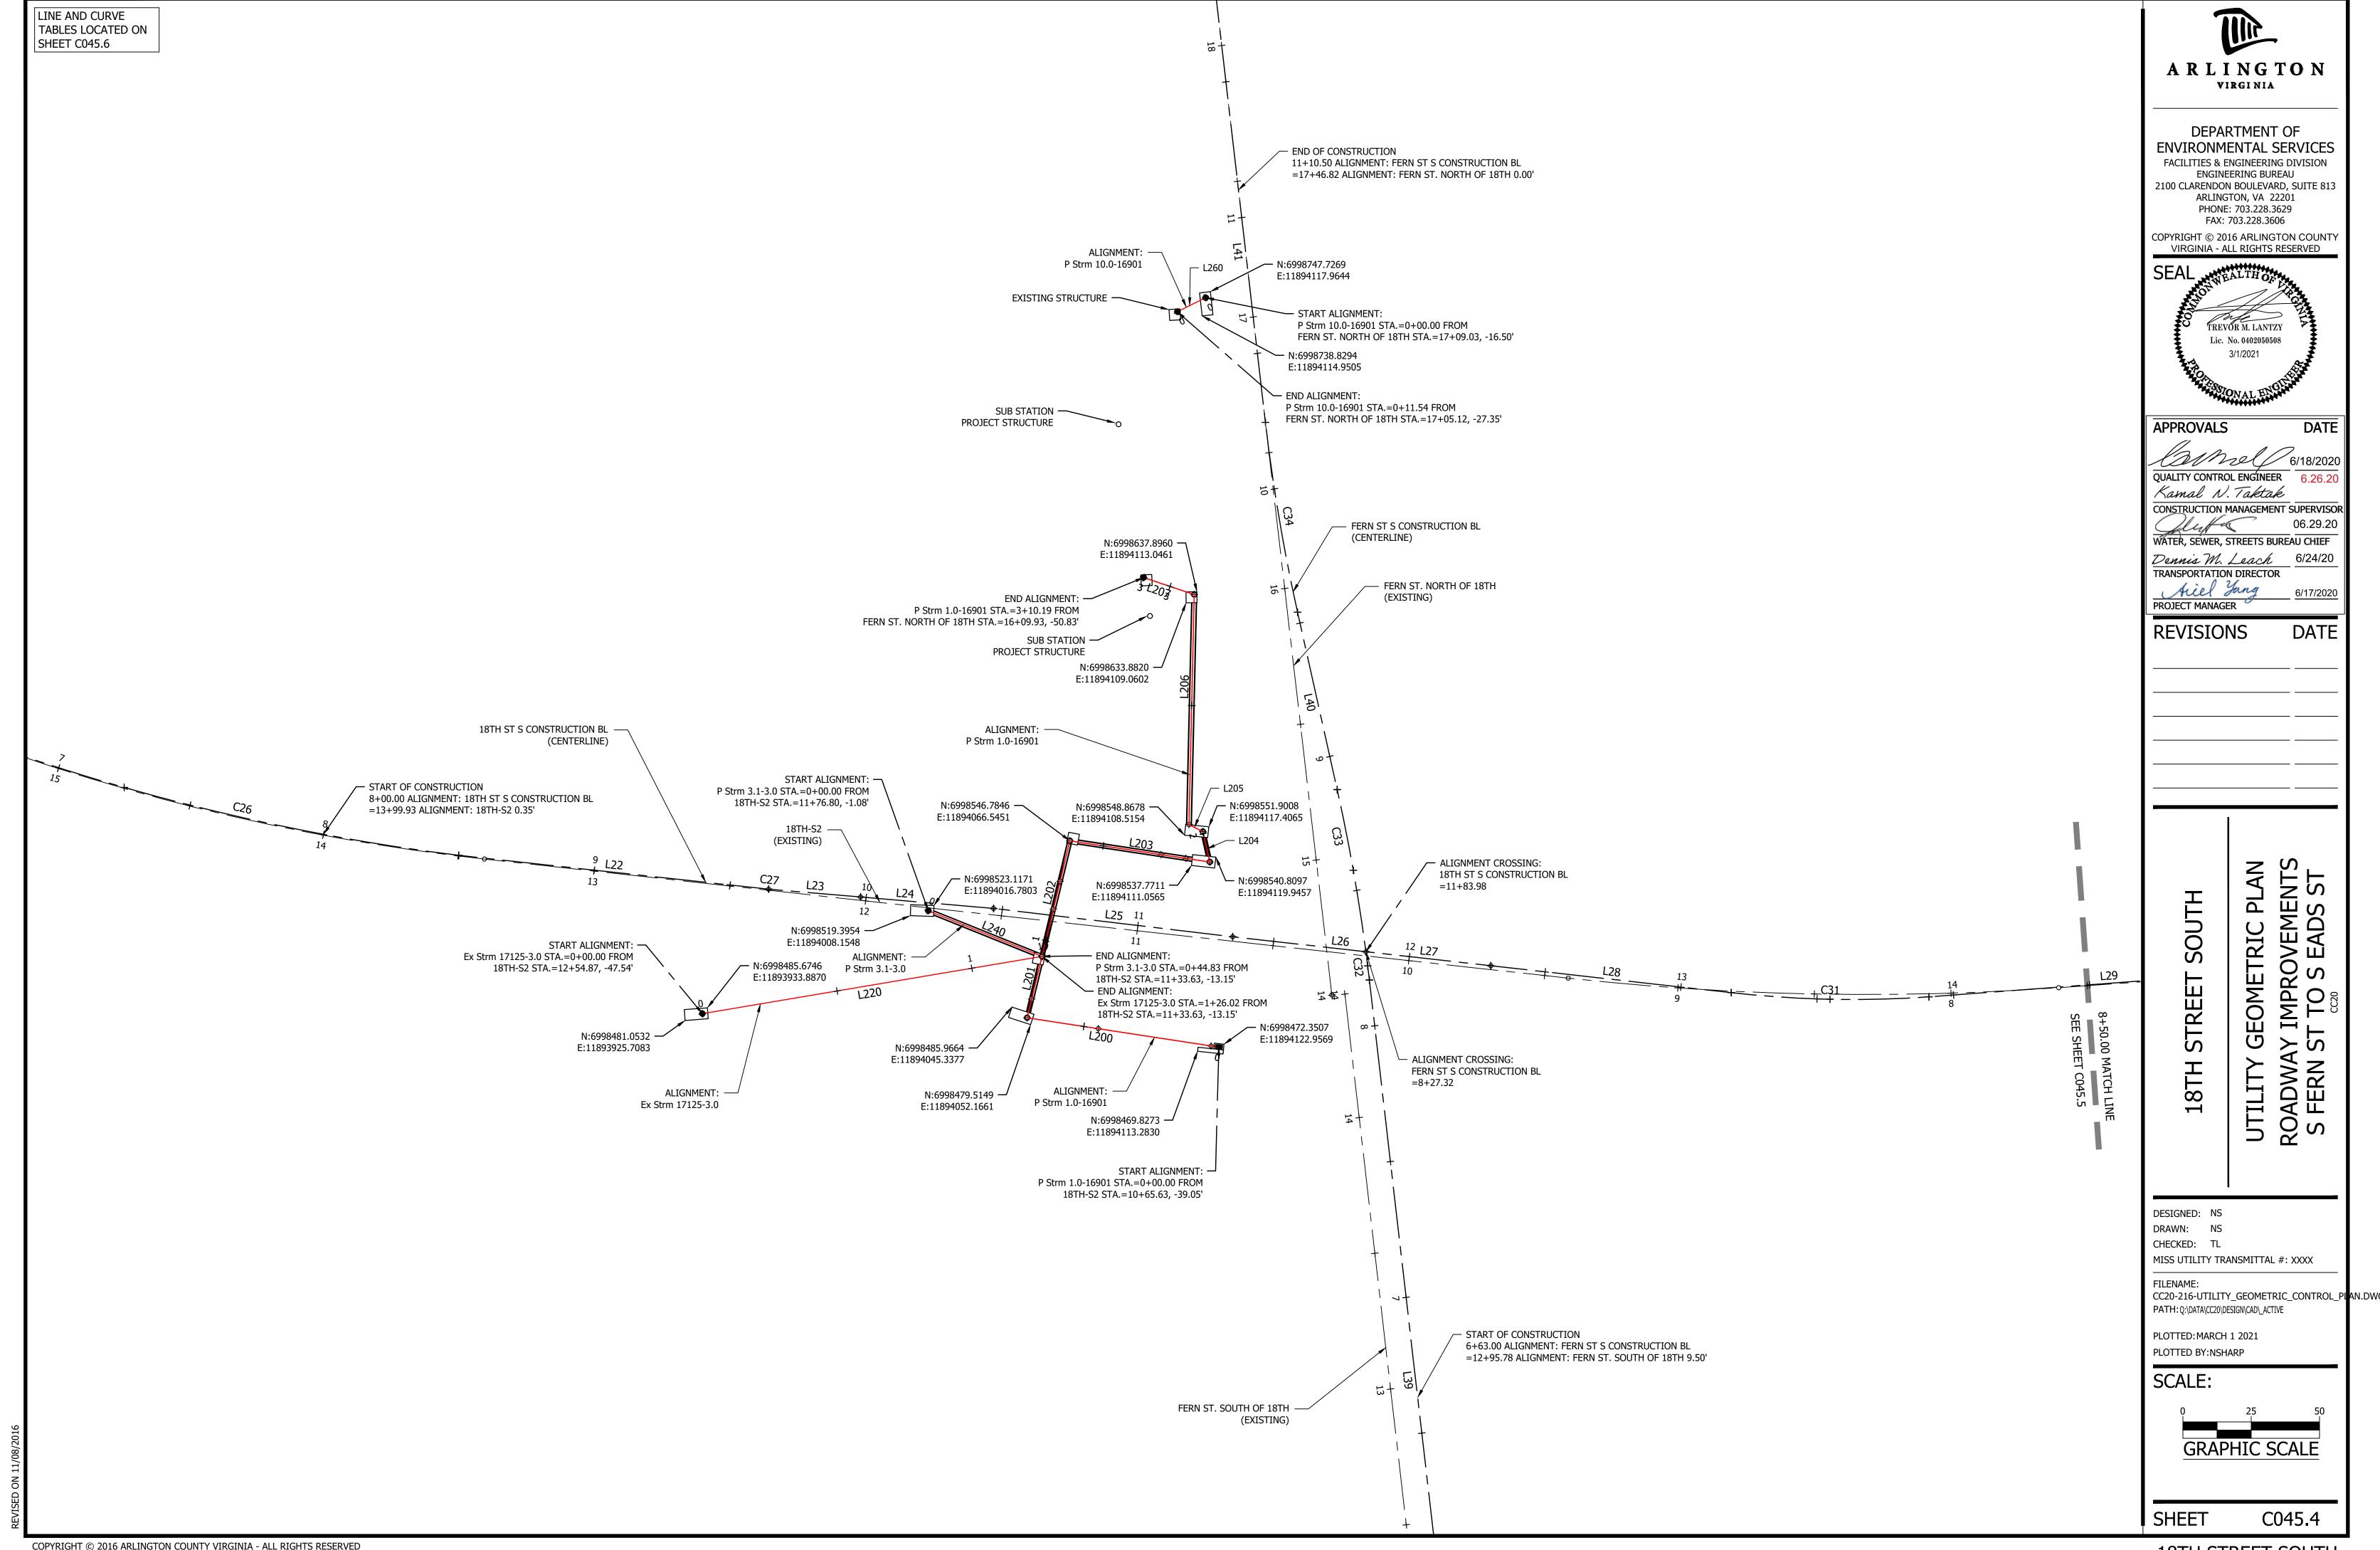

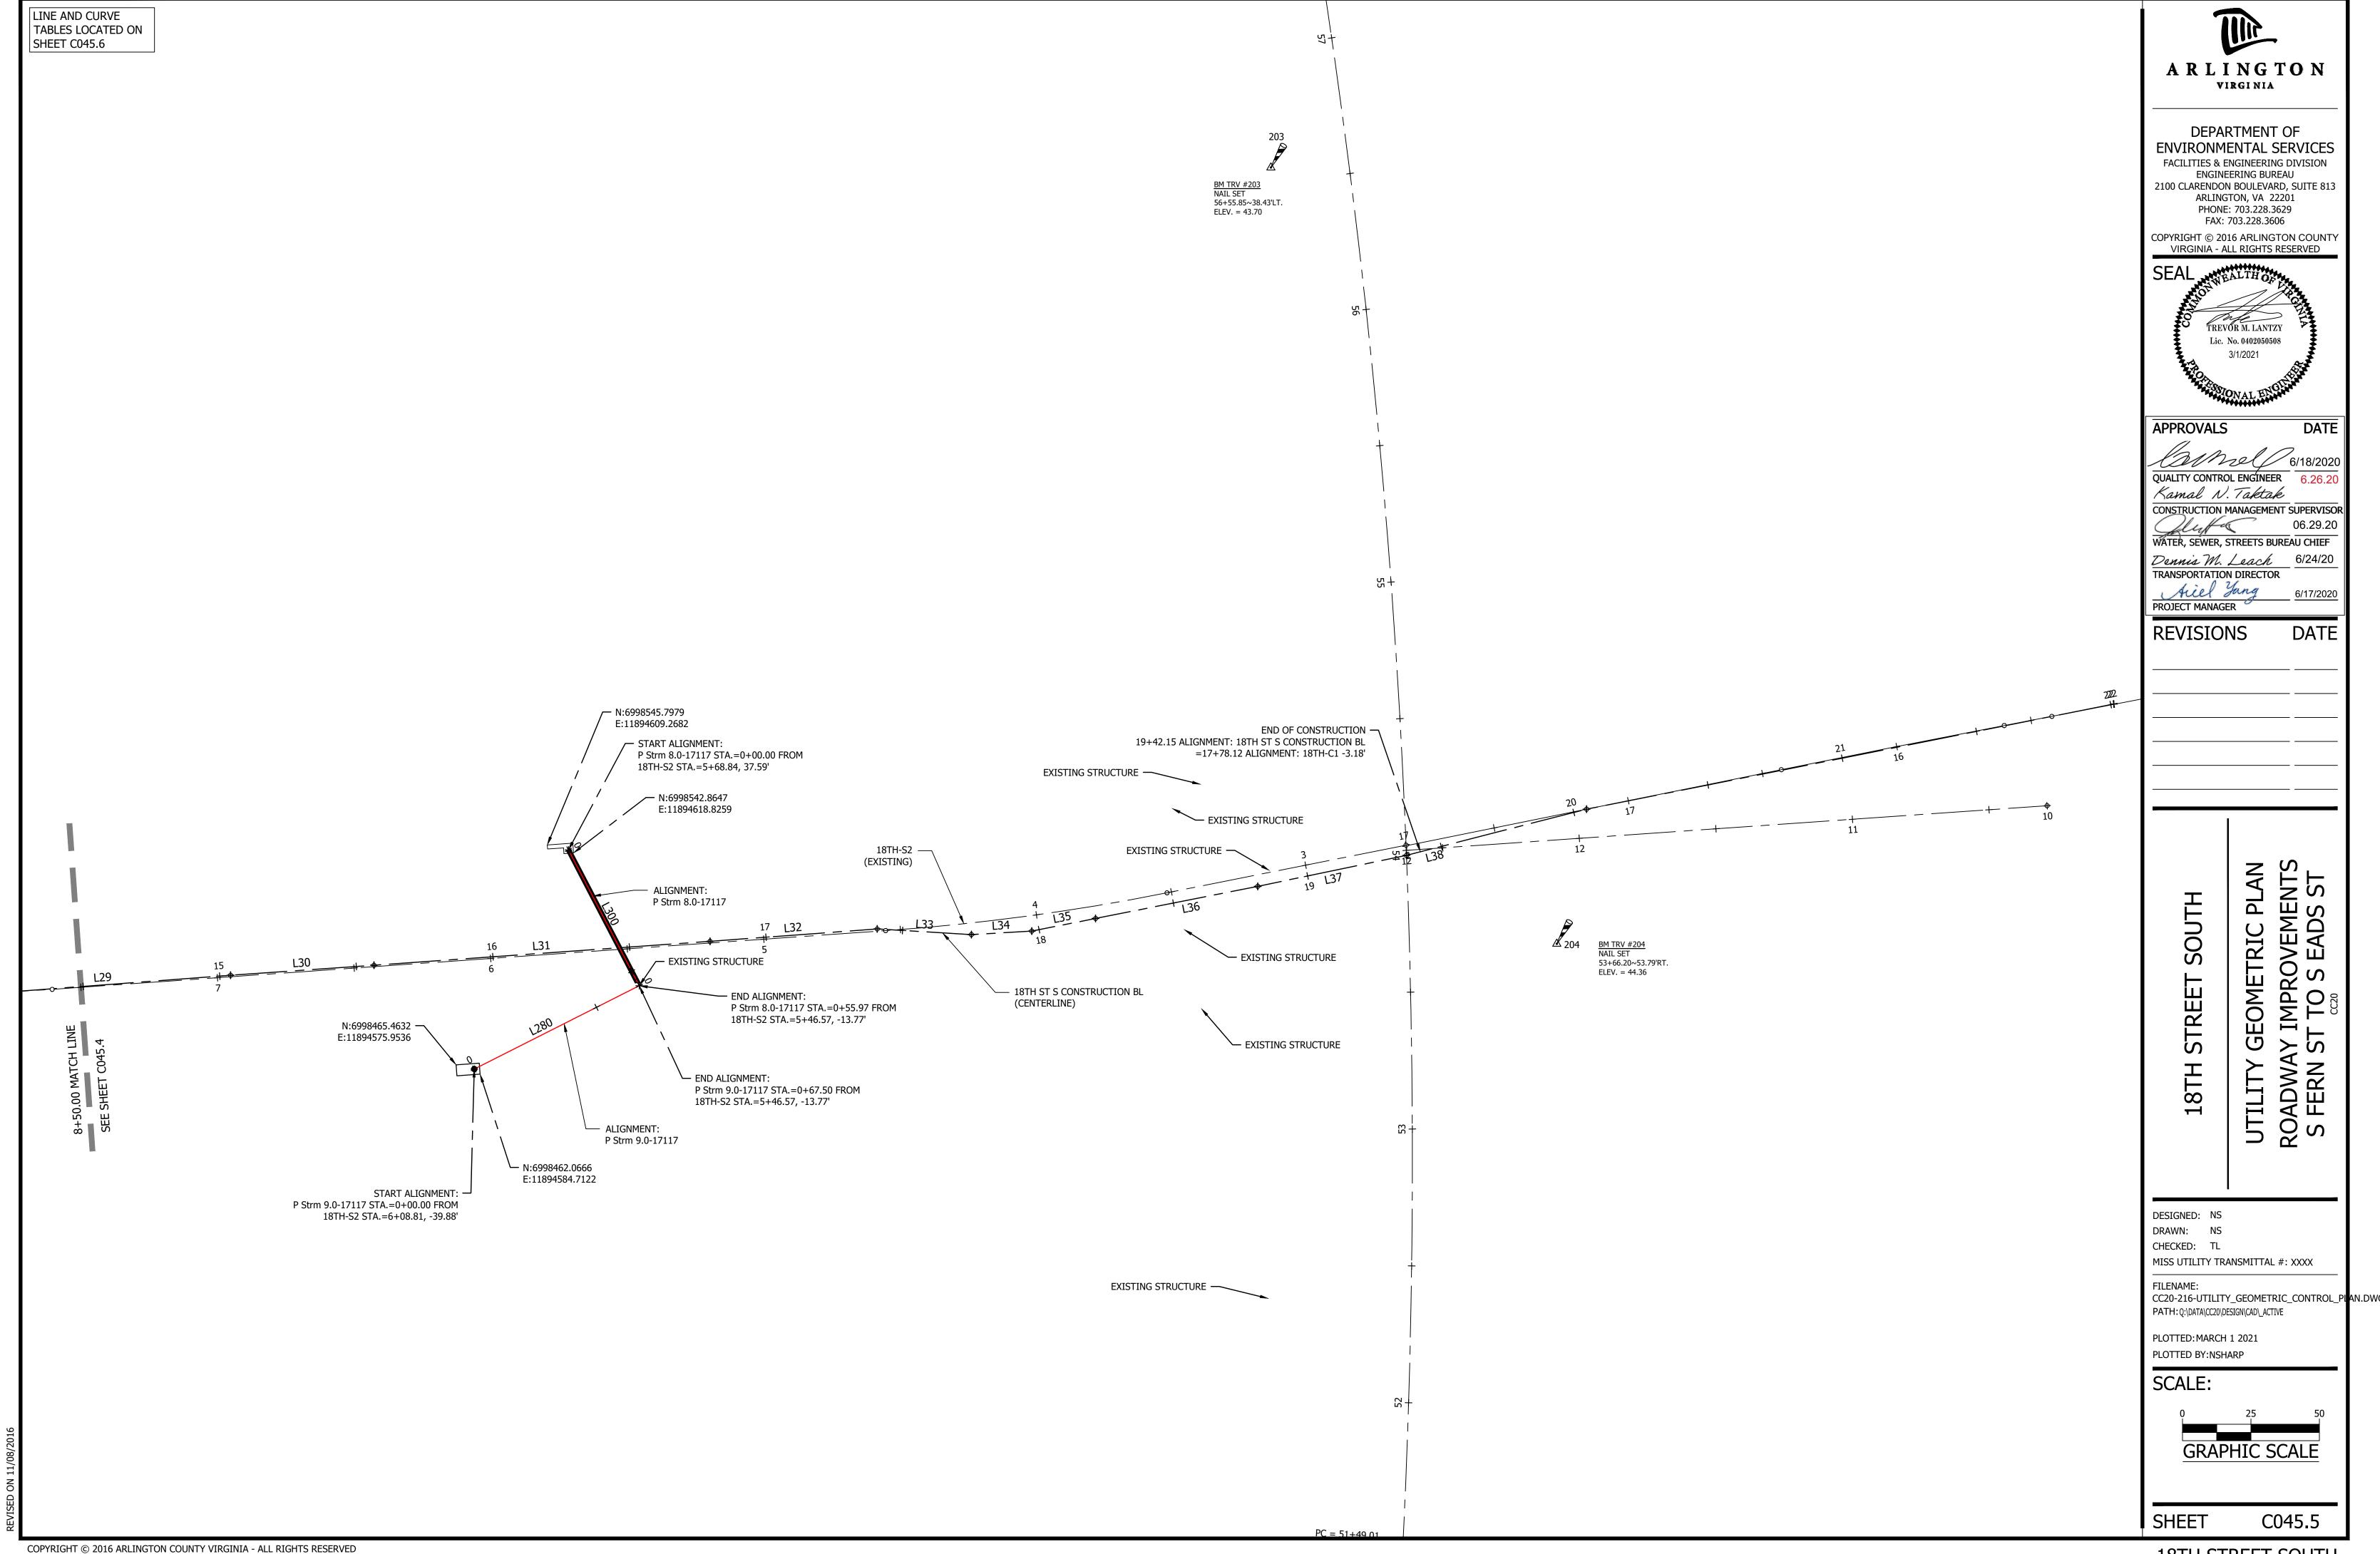

C27	0.24	10.00'	S84° 27' 03.66"E	0.24'	1° 20' 59"	0.12'	9+64.04	9+64.28	6998529.112, 11893956.165	6998529.090, 11893956.400
C31	72.49'	400.50'	S88° 47' 16.65"E	72.39'	10° 22' 16"	36.35'	13+18.50	13+90.99	6998491.222, 11894308.566	6998489.690, 11894380.944
L22	113.96'		S83° 46' 33.95"E				8+50.08	9+64.04	6998541.467, 11893842.878	6998529.112, 11893956.165
L23	33.66'		S85° 07' 33.38"E				9+64.28	9+97.94	6998529.090, 11893956.400	6998526.229, 11893989.947
L24	48.68'		S85° 05' 27.19"E				9+97.95	10+46.63	6998526.229, 11893989.948	6998522.063, 11894038.45
L25	87.92'		S83° 14' 28.24"E				10+46.95	11+34.87	6998522.030, 11894038.773	6998511.683, 11894126.083
L26	49.04'		S83° 36' 08.83"E				11+34.94	11+83.98	6998511.675, 11894126.146	6998506.211, 11894174.879
L27	46.01'		S83° 36' 08.83"E				11+83.98	12+29.99	6998506.211, 11894174.879	6998501.084, 11894220.600
L28	88.51'		S83° 36' 08.83"E				12+29.99	13+18.50	6998501.084, 11894220.606	· ·
									6998489.690, 11894380.944	·
L29	112.96'		N85° 41' 22.64"E				13+90.99	15+03.96	,	
L30	52.50'		N85° 59' 23.32"E				15+03.96	15+56.46	6998498.181, 11894493.589	
L31	123.04'		N85° 55' 57.18"E				15+56.46	16+79.50	6998501.852, 11894545.960	6998510.579, 11894668.688
L32	61.23'		N85° 45' 49.70"E				16+79.50	17+40.72	6998510.579, 11894668.688	6998515.102, 11894729.749
L33	34.47'		S86° 34' 31.96"E				17+40.72	17+75.19	6998515.102, 11894729.749	6998513.043, 11894764.152
L34	22.08'		N86° 41' 18.13"E				17+75.19	17+97.27	6998513.043, 11894764.152	6998514.319, 11894786.196
L35	23.76'		N78° 47' 46.51"E				17+97.27	18+21.03	6998514.319, 11894786.196	6998518.936, 11894809.506
L36	60.39'		N78° 47' 46.51"E				18+21.03	18+81.42	6998518.936, 11894809.506	6998530.669, 11894868.744
L37	55.47'		N78° 13' 45.15"E				18+81.42	19+36.89	6998530.669, 11894868.744	6998541.984, 11894923.043
L38	67.92'		N75° 36' 29.72"E				19+36.89	20+04.80	6998541.984, 11894923.043	6998558.865, 11894988.828
	07.52		1473 30 23.72 E				15130.05	20101.00	03303 11130 1, 1103 132310 13	033033010037 1103 13001020
					FERN	ST S CONST	RUCTION BL			
LINE OR	LINE OR	RADIUS	LINE / CHORD	CHORD	DELTA (Δ)	TANGENT	START STA	END STA	NORTHING, EASTING	NORTHING, EASTING
CURVE #	ARC LENGTH	NADIOS	BEARING	LENGTH	DELIA (A)	TANGLINI	OR PC	OR PT	(START)	(END)
C32	10.44'	675.00'	N7° 02' 29.55"W	10.44'	0° 53' 10"	5.22'	8+16.88	8+27.32	6998495.852, 11894176.158	6998506.211, 11894174.879
C33	60.25'	675.00'	N10° 02' 30.04"W	60.23'	5° 06' 51"	30.15'	8+27.32	8+87.57	6998506.211, 11894174.879	6998565.519, 11894164.377
C34	70.45'	675.00'	N9° 36' 32.22"W	70.41'	5° 58' 47"	35.26'	9+54.11	10+24.56	6998630.457, 11894149.863	6998699.884, 11894138.109
L39	316.88'		N6° 35' 54.70"W				5+00.00	8+16.88	6998181.071, 11894212.572	6998495.852, 11894176.158
L40	66.54'		N12° 35' 55.69"W				8+87.57	9+54.11	6998565.519, 11894164.377	6998630.457, 11894149.863
L41	275.44'		N6° 37' 08.75"W				10+24.56	13+00.00	6998699.884, 11894138.109	6998973.488, 11894106.359
LINE OR CURVE #	LINE OR ARC LENGTH	RADIUS	LINE / CHORD BEARING	CHORD LENGTH	DELTA (Δ)	TANGENT	START STA OR PC	END STA OR PT	NORTHING, EASTING (START)	NORTHING, EASTING (END)
L200	71.01'		N81° 18' 03.50"W	LLINGTIT			0+00.00	0+71.01	6998471.300, 11894121.078	6998482.039, 11894050.890
L201	23.08'		N13° 35' 24.48"E				0+71.01	0+94.09	6998482.039, 11894050.890	6998504.475, 11894056.313
L202	43.53'		N13° 35' 35.15"E				0+94.09	1+37.62	6998504.475, 11894056.313	6998546.784, 11894066.544
L203	51.78'		S81° 24' 02.01"E				1+37.62	1+89.39	6998546.784, 11894066.544	6998539.042, 11894117.737
L204	11.38'		N12° 53' 56.71"W				1+89.39	2+00.77	6998539.042, 11894117.737	6998550.135, 11894115.197
			N62° 58' 06.13"W				-	+	6998550.135, 11894115.197	6998552.714, 11894110.142
L205	5.68'						2+00.77	2+06.45		
L206	84.20'		N1° 17' 54.54"E				2+06.45	2+90.65	6998552.714, 11894110.142	6998636.893, 11894112.050
L207	19.54'		N71° 25' 35.77"W				2+90.65	3+10.19	6998636.893, 11894112.050	6998643.116, 11894093.529
					F	EX STRM 171	25-3 N			
LINE OR	LINE OR		LINE / CHORD	CHORD			START STA	END STA	NORTHING, EASTING	NORTHING, EASTING
CURVE #	ARC LENGTH	RADIUS	BEARING	LENGTH	DELTA (Δ)	TANGENT	OR PC	OR PT	(START)	(END)
L220	126.02'		N80° 26' 02.38"E				0+00.00	1+26.02	6998483.531, 11893932.041	6998504.475, 11894056.313
	l		I							
	T	Т				P STRM 3.1	-3.0			
LINE OR CURVE #	LINE OR ARC LENGTH	RADIUS	LINE / CHORD BEARING	CHORD LENGTH	DELTA (Δ)	TANGENT	START STA OR PC	END STA OR PT	NORTHING, EASTING (START)	NORTHING, EASTING (END)
				LENGIH						· ,
L240	44.83'		S68° 06' 56.69"E				0+00.00	0+44.83	6998521.183, 11894014.716	6998504.475, 11894056.313
						P STRM 10.0-	-16901			
LINE OR	LINE OR		LINE / CHORD	CHORD			START STA	END STA	NORTHING, EASTING	NORTHING, EASTING
CURVE #	ARC LENGTH	RADIUS	BEARING	LENGTH	DELTA (Δ)	TANGENT	OR PC	OR PT	(START)	(END)
L260	11.54'		S63° 32' 50.89"W				0+00.00	0+11.54	6998745.514, 11894116.203	6998740.374, 11894105.873
	1	·	1	1	1			1		1
		T	<u> </u>	T		P STRM 9.0-:	17117			
LINE OR CURVE #	LINE OR ARC LENGTH	RADIUS	LINE / CHORD BEARING	CHORD LENGTH	DELTA (Δ)	TANGENT	START STA OR PC	END STA OR PT	NORTHING, EASTING (START)	NORTHING, EASTING (END)
				LENGIH						
L280	67.50'		N63° 12' 34.07"E				0+00.00	0+67.50	6998463.922, 11894582.577	6998494.346, 11894642.831
						P STRM 8.0-1	 17117			
LINE OR	LINE OR	D	LINE / CHORD	CHORD			START STA	END STA	NORTHING, EASTING	NORTHING, EASTING
CURVE #	ARC LENGTH	RADIUS	BEARING	LENGTH	DELTA (Δ)	TANGENT	OR PC	OR PT	(START)	(END)

18TH ST S CONSTRUCTION BL

9+64.04

9+64.28

NORTHING, EASTING

(START)

6+00.00 | 8+50.08 | 6998609.497, 11893603.237 | 6998541.467, 11893842.878

0+00.00 | 0+55.97 | 6998543.995, 11894616.994 | 6998494.346, 11894642.831

6998529.112, 11893956.165 | 6998529.090, 11893956.400

NORTHING, EASTING

(END)

LINE / CHORD CHORD DELTA (Δ) TANGENT START STA END STA OR PC OR PT

LINE OR LINE OR CURVE # ARC LENGTH

C26

RADIUS

250.08' | 817.97' | S74° 09' 06.07"E | 249.11' | 17° 31' 02" | 126.02'


BM#	NORTHING	EASTING
200	6999342.5062	11894165.8183
201	6999438.1307	11894730.9714
202	6999089.9634	11894882.7259
203	6998793.2265	11894873.5154
204	6998509.6607	11894977.9298
300	6998535.6686	11894587.5405
301	6998495.8100	11894213.5573
302	6998480.0643	11893821.7028
303	6998434.8404	11893470.9261
REFER	TO SHEET C011.1-C011.3 S	SURVEY CONTROL TABLE


ARLINGTON VIRGINIA DEPARTMENT OF **ENVIRONMENTAL SERVICES** FACILITIES & ENGINEERING DIVISION ENGINEERING BUREAU 2100 CLARENDON BOULEVARD, SUITE 813 ARLINGTON, VA 22201 PHONE: 703.228.3629 FAX: 703.228.3606 COPYRIGHT © 2016 ARLINGTON COUNTY VIRGINIA - ALL RIGHTS RESERVED APPROVALS QUALITY CONTROL ENGINEER 6.26.20 Kamal N. Taktak CONSTRUCTION MANAGEMENT SUPERVISOR WATER, SEWER, STREETS BUREAU CHIEF Dennis M. Leach 6/24/20 TRANSPORTATION DIRECTOR Ailel Yang PROJECT MANAGER **REVISIONS** UTILITY GEOMETRIC PLAN ROADWAY IMPROVEMENTS S FERN ST TO S EADS ST SOUTH STREET DESIGNED: NS DRAWN: NS CHECKED: TL MISS UTILITY TRANSMITTAL #: XXXX FILENAME: CC20-216-UTILITY\_GEOMETRIC\_CONTROL\_PLAN.DWG PATH: Q:\DATA\CC20\DESIGN\CAD\\_ACTIVE PLOTTED: MARCH 1 2021 PLOTTED BY:NSHARP SCALE:


SHEET C045.6


S27° 29' 34.02"E

55.97'

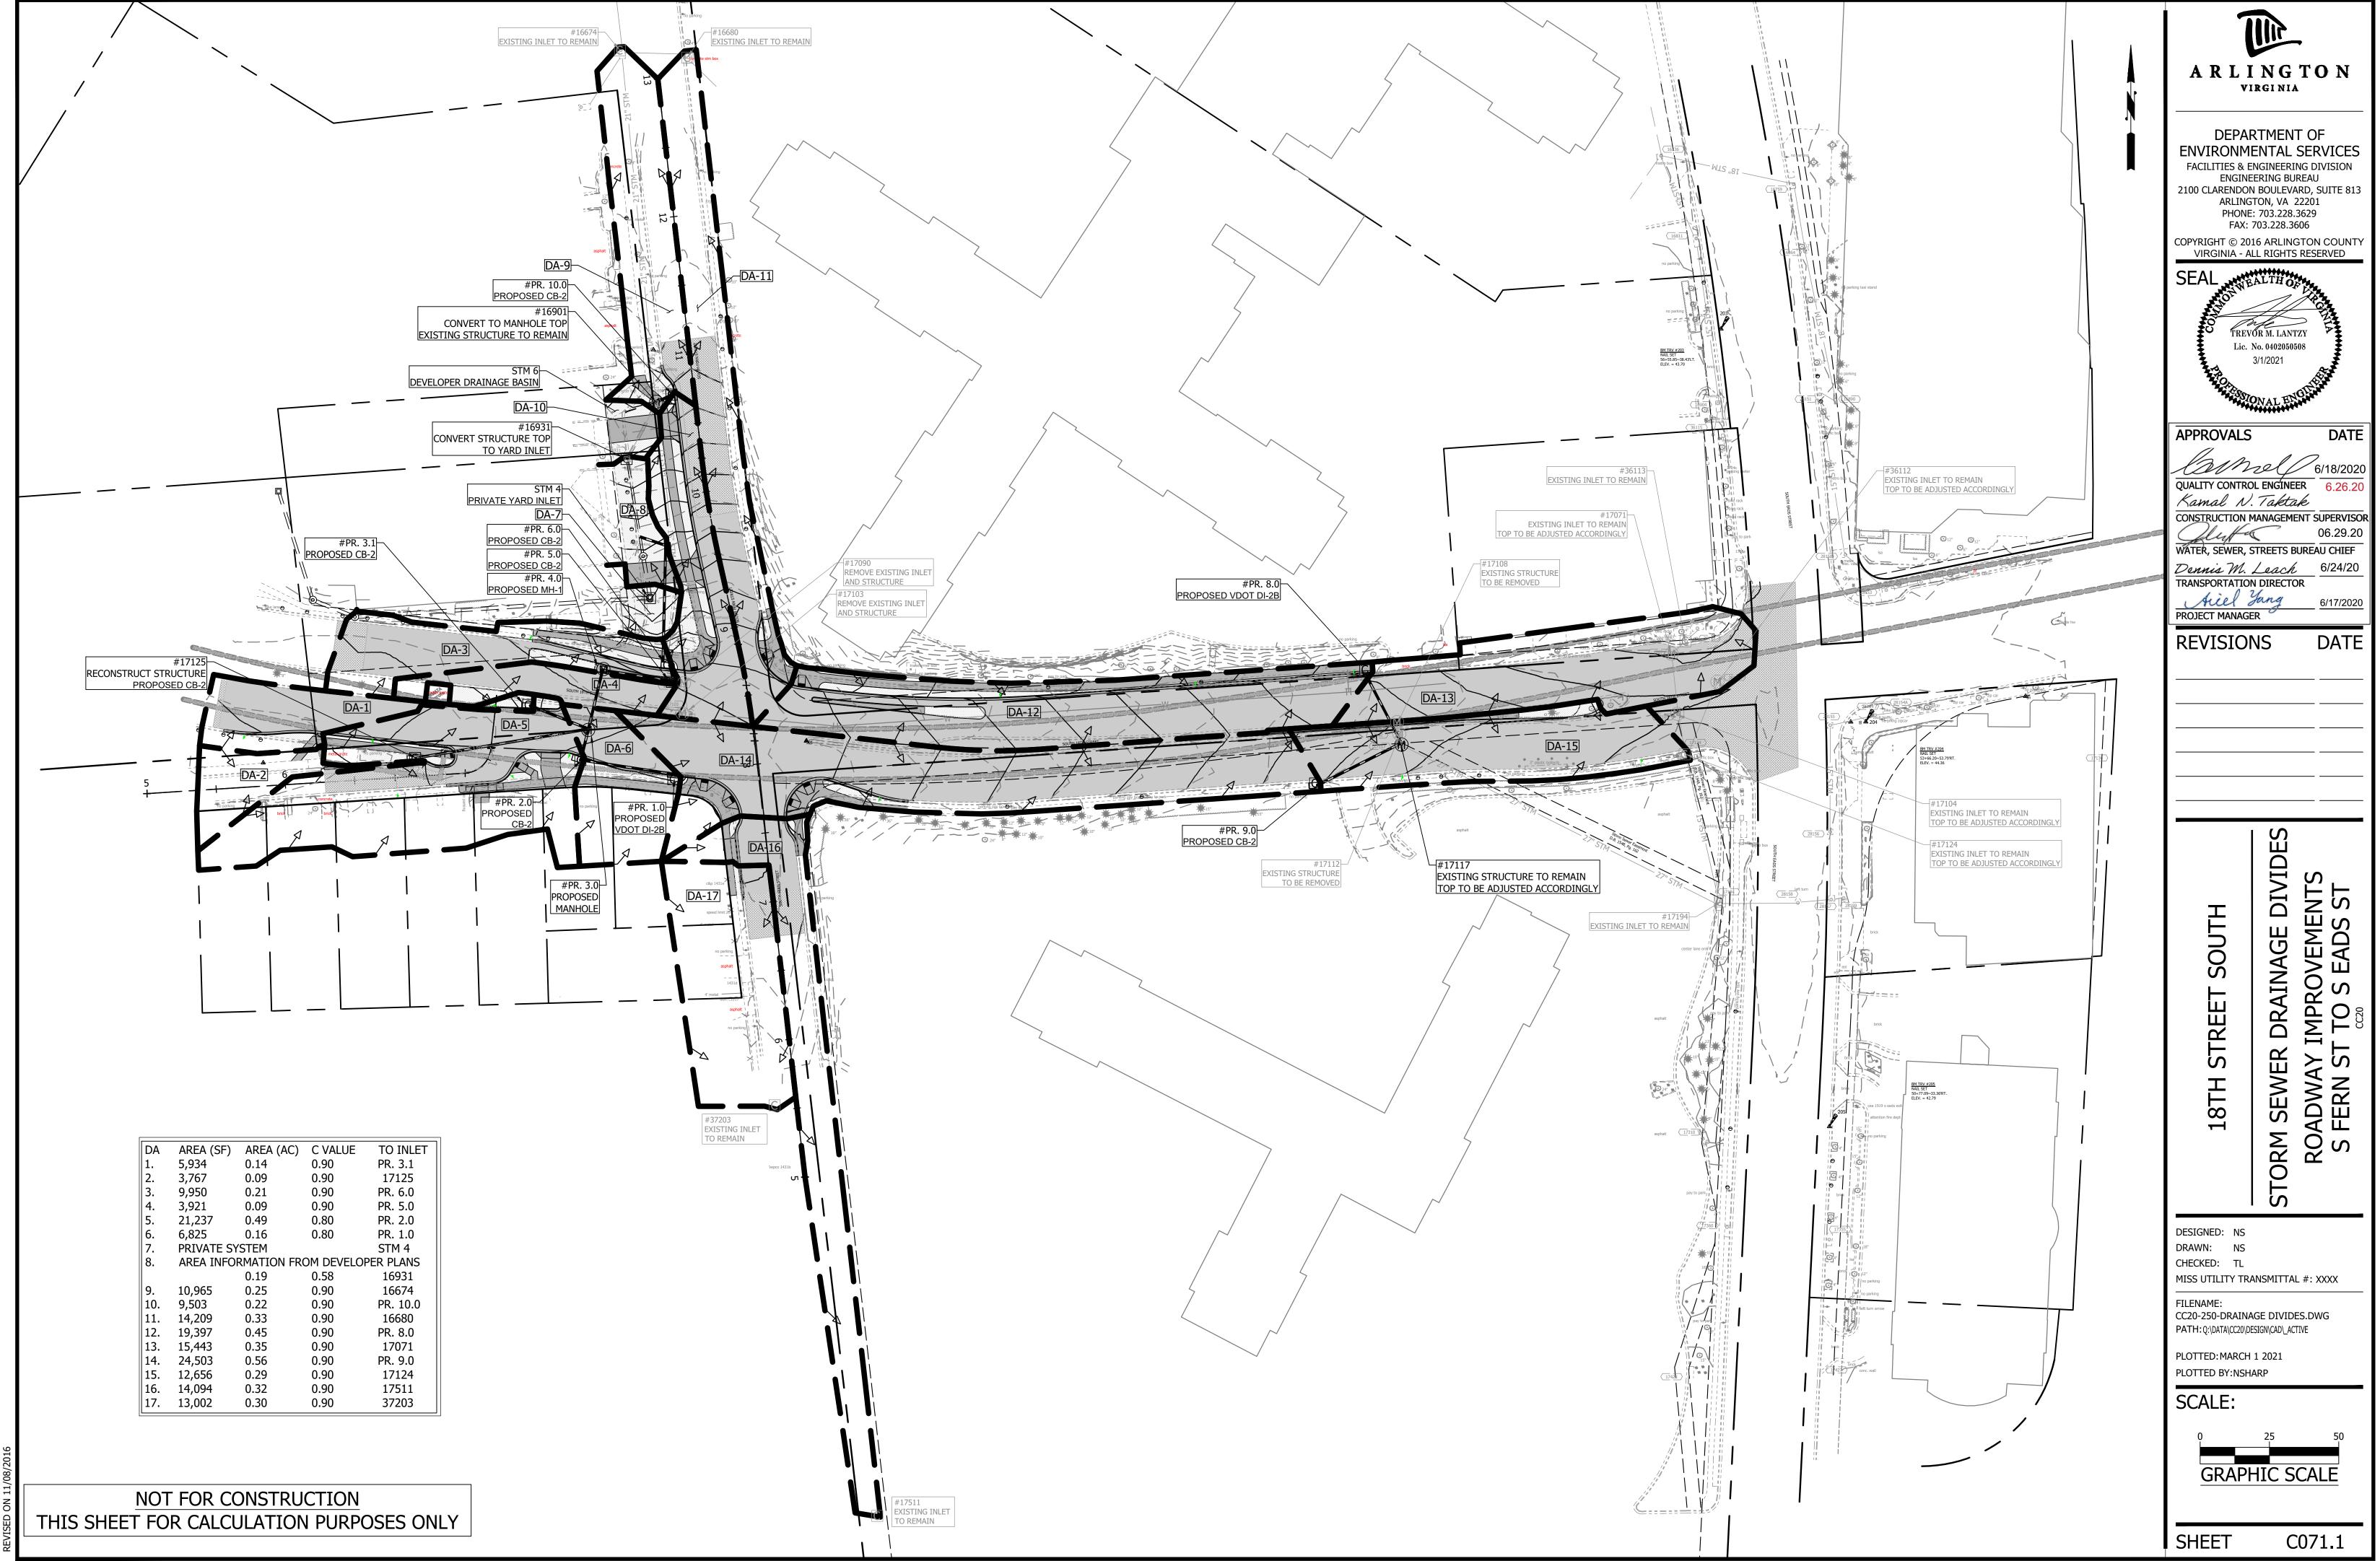

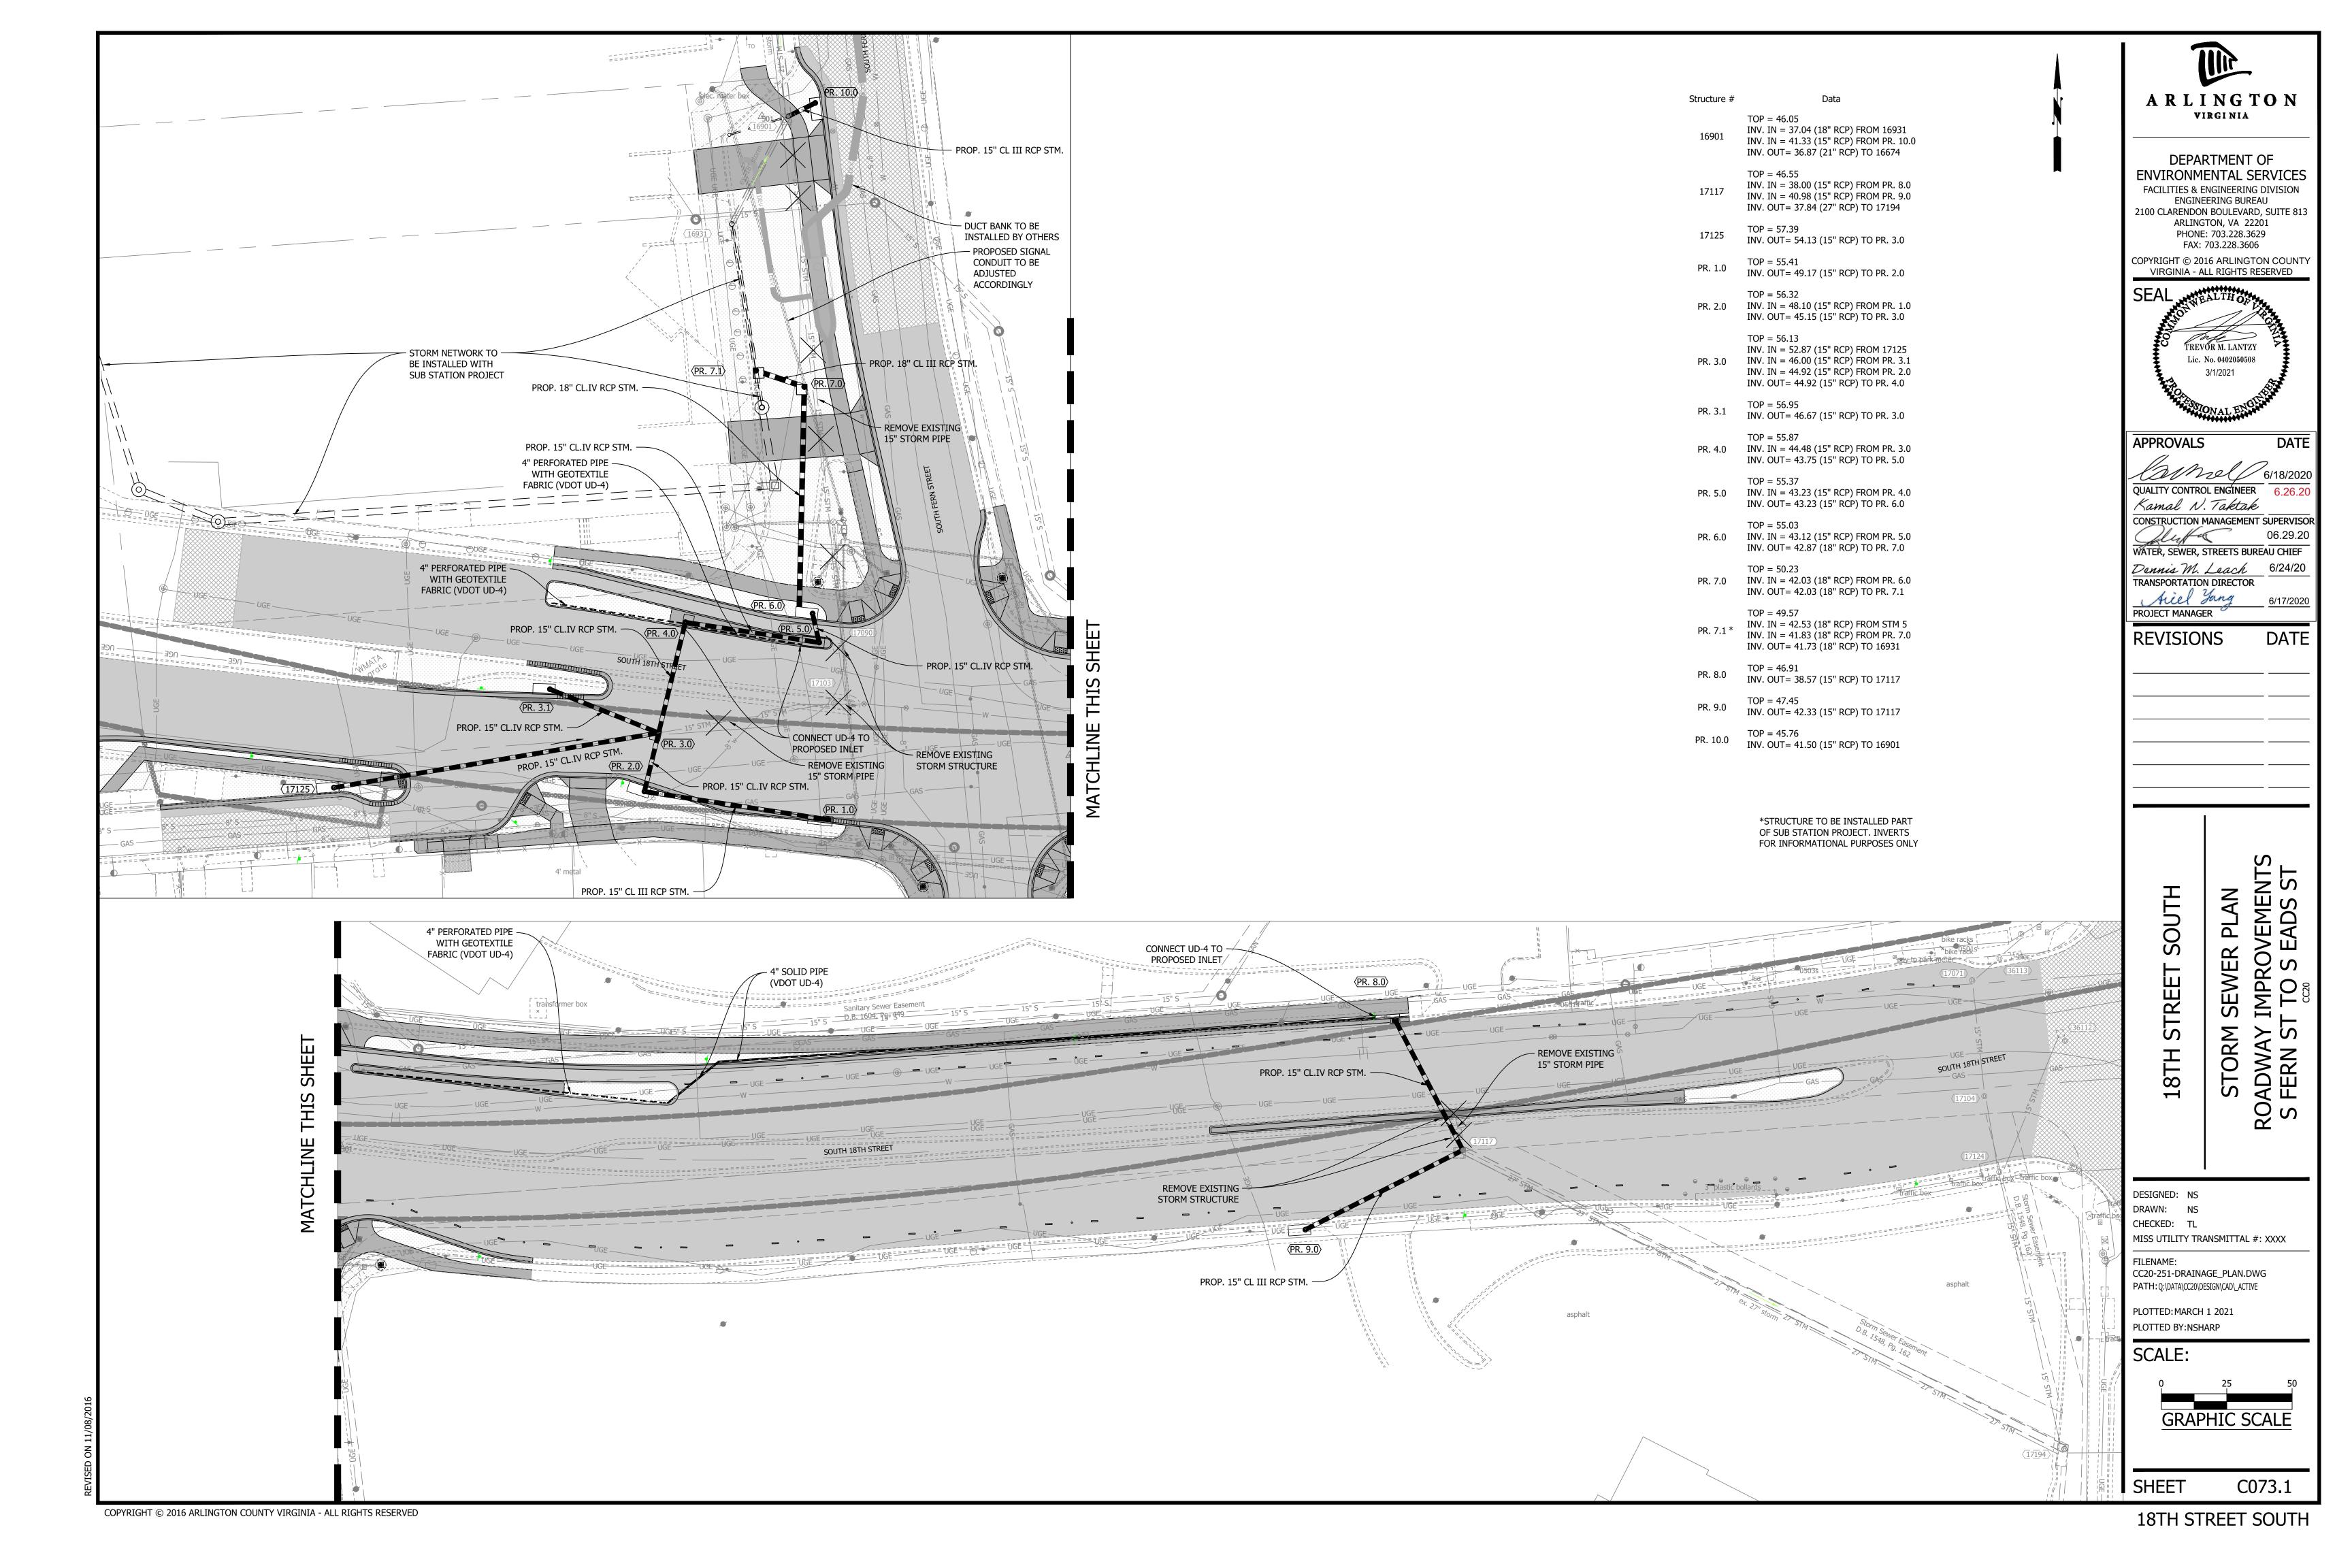

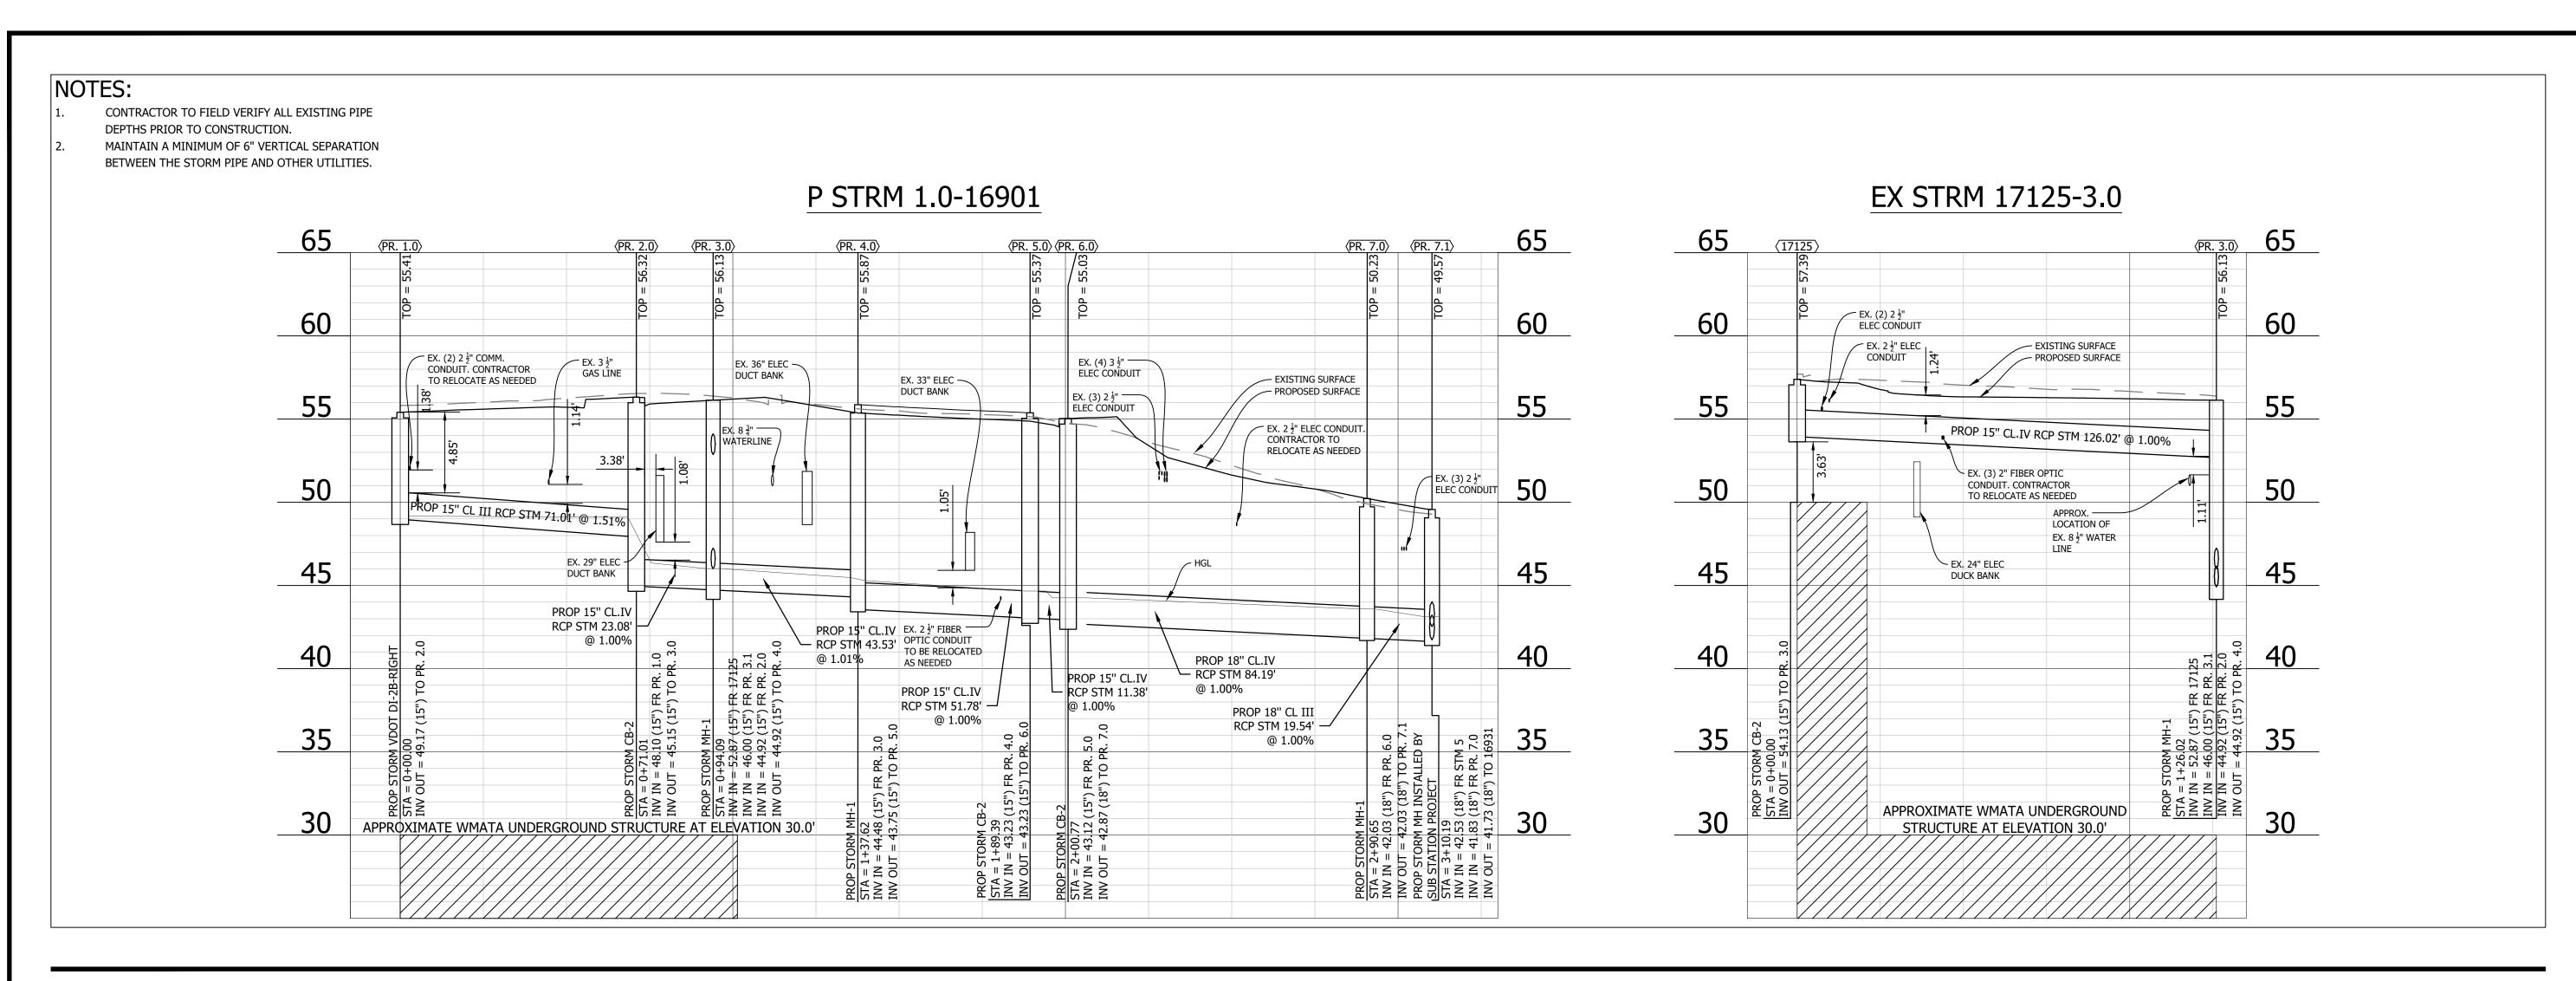


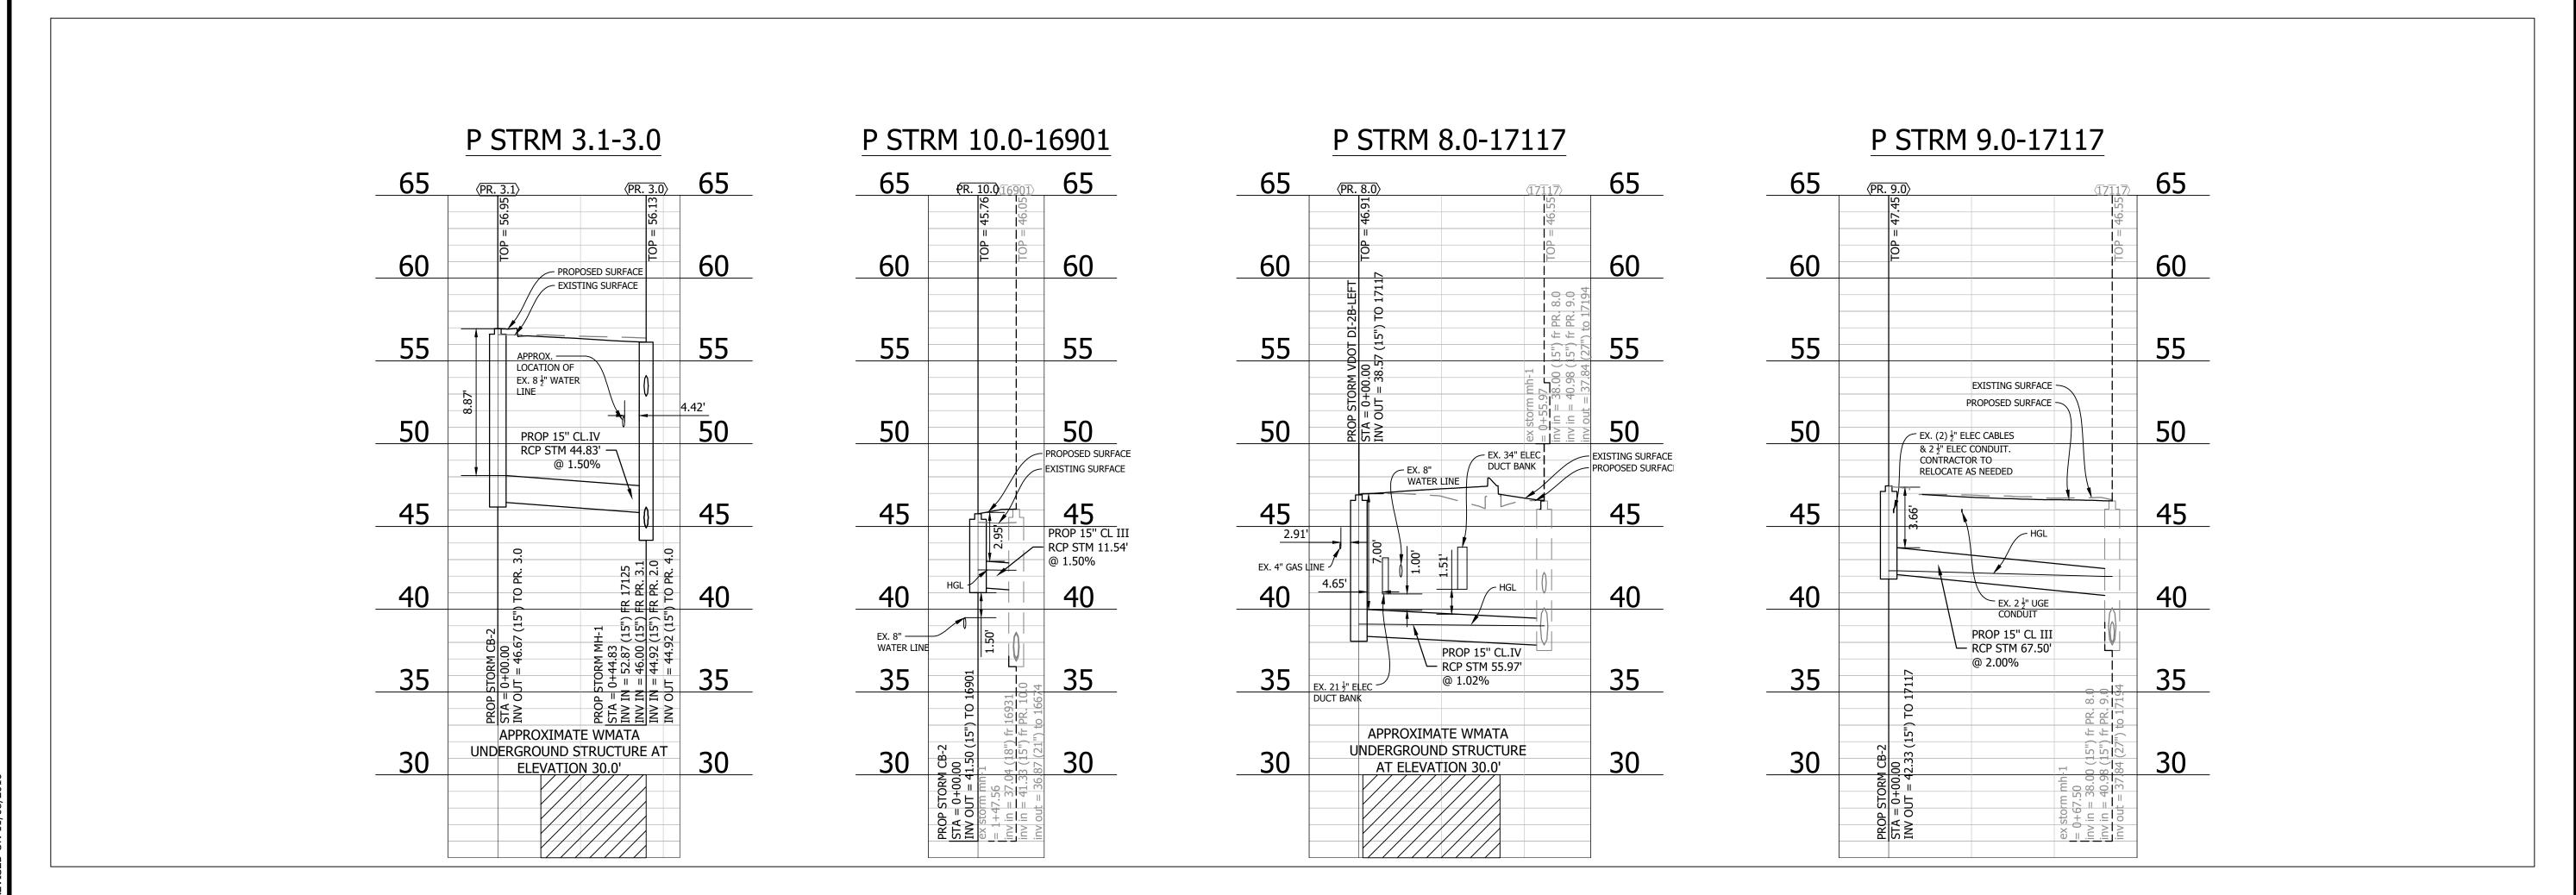



DEPARTMENT OF **ENVIRONMENTAL SERVICES FACILITIES & ENGINEERING DIVISION** ENGINEERING BUREAU 2100 CLARENDON BOULEVARD, SUITE 813 ARLINGTON, VA 22201 PHONE: 703.228.3629 FAX: 703.228.3606

COPYRIGHT © 2016 ARLINGTON COUNTY VIRGINIA - ALL RIGHTS RESERVED

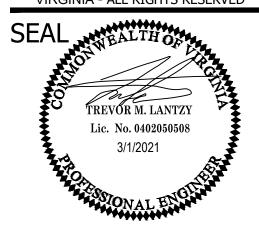

**APPROVALS** 

QUALITY CONTROL ENGINEER 6.26.20 Kamal N. Taktak CONSTRUCTION MANAGEMENT SUPERVISOR

DATE

WATER, SEWER, STREETS BUREAU CHIEF Dennis M. Leach 6/24/20

TRANSPORTATION DIRECTOR Aill Yang PROJECT MANAGER

**REVISIONS** 

IMPROVEMENTS T TO S EADS ST **PROFILES** SEWER ROADWAY I S FERN ST

DESIGNED: NS DRAWN: NS CHECKED: TL

SOUTH

STREE

MISS UTILITY TRANSMITTAL #: XXXX FILENAME:

CC20-252-STORM\_SEWER\_PROFILES.DWG PATH: Q:\DATA\CC20\DESIGN\CAD\\_ACTIVE

PLOTTED: MARCH 1 2021 PLOTTED BY:NSHARP

SCALE: HORIZ. SCALE VERT. SCALE SHEET C073.2

COPYRIGHT © 2016 ARLINGTON COUNTY VIRGINIA - ALL RIGHTS RESERVED



							St	torm D	rain I	Desigi	n Con	putat	tions						
From	То	Drainage Area	Runoff Coefficient		CA		Inlet Time	Time of Conc.	Rainfall	Runoff Q		ert ations	Length	Slope	Diameter	Capacity	Velocity	Flow Time	Remarks
Point	Point	Acres	С	Incr.	Piped In	Accum.	min	min	in/hr	cfs	Upper End	Lower End	ft	%	in	cfs	fps	min	Remarks
PR. 1.0	PR. 2.0	0.16	0.80	0.13	0.00	0.13	5.00	5.00	6.79	0.87	49.17	48.10	71.01	1.51%	15	7.93	4.24	0.28	
PR. 2.0	PR. 3.0	0.49	0.80	0.39	0.00	0.52	5.00	5.28	6.70	3.48	45.15	44.92	23.08	1.00%	15	6.45	5.36	0.07	
17125	PR. 3.0	0.09	0.90	0.08	0.00	0.08	5.00	5.00	6.79	0.55	54.13	52.87	126.02	1.00%	15	6.46	3.21	0.65	Class V Pipe
PR. 3.1	PR. 3.0	0.14	0.90	0.13	0.00	0.13	5.00	5.00	6.79	0.86	46.67	46.00	44.83	1.49%	15	7.90	4.21	0.18	
PR. 3.0	PR. 4.0	0.00	0.00	0.00	0.00	0.73	5.00	5.65	6.57	4.78	44.92	44.48	43.53	1.01%	15	6.49	5.79	0.13	
PR. 4.0	PR. 5.0	0.00	0.00	0.00	0.00	0.73	5.00	5.78	6.53	4.75	43.75	43.23	51.78	1.00%	15	6.47	5.76	0.15	
PR. 5.0	PR. 6.0	0.09	0.90	0.08	0.00	0.81	5.00	5.93	6.49	5.24	43.23	43.12	11.38	0.97%	15	6.35	5.78	0.03	
PR. 6.0	PR. 7.0	0.21	0.90	0.19	0.00	1.00	5.00	5.96	6.48	6.46	42.87	42.03	84.19	1.00%	18	10.49	6.24	0.22	
PR. 7.0	PR. 7.1	0.00	0.00	0.00	0.00	1.00	5.00	6.19	6.41	6.39	42.03	41.83	19.54	1.02%	18	10.63	6.29	0.05	
16931	16901	0.19	0.58	0.11	0.00	1.42	5.00	6.38	6.35	9.00	39.89	37.04	46.47	6.13%	18	26.01	13.37	0.06	Ex. Pipe to Remain
PR. 10.0	16901	0.15	0.90	0.14	0.00	0.14	5.00	5.00	6.79	0.92	41.50	41.33	11.54	1.47%	15	7.84	4.27	0.04	
16901	16674	0.00	0.90	0.00	0.00	1.55	5.00	6.44	6.33	9.83	36.87	35.18	255.32	0.66%	21	12.89	5.90	0.72	
DD 0.0	17117	0.45	0.00	0.41	0.00	0.41	F 00	I 500	L C 70	275	20.57	20.00	T F 07	1 020/	1.5	C F2	F 00	0.10	1
PR. 8.0	17117	0.45	0.90	0.41	0.00	0.41	5.00	5.00	6.79	2.75	38.57	38.00	55.97	1.02%	15	6.52	5.09	0.18	
PR. 9.0	17117	0.56	0.90	0.50	0.00	0.50	5.00	5.00	6.79	3.42	42.33	40.98	67.50	2.00%	15	9.14	6.91	0.16	E. Directo Derecio
17117	17194	0.00	0.00	0.00	0.00	0.91	5.00	5.18	6.73	6.11	37.84	34.89	254.00	1.16%	27	33.38	6.39	0.66	Ex. Pipe to Remain
17124	17194	0.29	0.90	0.26	0.00	0.26	5.00	5.00	6.79	1.77	37.19	36.06	107.00	1.06%	15	6.64	4.58	0.39	Ex. Pipe to Remain
																			Sub Station Pipe (piped in flow of -
PR. 7.1	16931	0.00	0.00	0.00	0.31	1.31	5.00	6.24	6.39	8.36	41.73	41.16	56.82	1.00%	18	10.52	6.61	0.14	1.94cfs)



														St	orm Ti	alet Co	mnut	ations													
		Inlet	t					Flow						<u> </u>	<u> </u>	iict C		Curb Inle	t							Operation			Sag Inlet	s Only	
Numbe	r Ty	ype L	Length (ft)	Station	Drainage Area (acres)	С	CA	i (in/hr)	Q Incr (ft³/s)	Q Carryover (ft³/s)	Q <sub>T</sub> (ft³/s)	S Gutter Slope (ft/ft)	Sx Crossslope (ft/ft)	T Spread (ft)	W (ft)	W/T	Sw (ft/ft)	Sw/Sx	E <sub>0</sub>	a (in)	S'w	Se (ft/ft)	L <sub>T</sub> Computed Length (ft)	L/L <sub>T</sub>	E (%)	Q <sub>i</sub> Intercepted (ft <sup>3</sup> /s)	Q <sub>b</sub> Carryover (ft³/s)	d (ft)	h (ft)	d/h	T Spread @ Sag (ft)
PR. 1.0			8		0.16	0.80	0.128	4.00	0.51	0.00	0.512	0.0050	0.01000	7.83	1.50	0.19	0.0833	8.33	0.676	4.32	0.24	0.17	3.30	2.42	100%	0.51	0.000				
PR. 2.0	CB-2	2B	8		0.49	0.80	0.392	4.00	1.57	0.00	1.568	0.0080	0.01450	9.70	1.50	0.15	0.0833	5.75	0.503	4.24	0.24	0.13	7.10	1.13	100%	1.57	0.000				
PR. 3.0																															
	CB-2		8		0.09	0.90	0.081	4.00	0.32	0.00	0.324	0.0136	0.01250	3.29	1.50	0.46	0.0833	6.67	0.958	4.28	0.24	0.24	3.01	2.66	100%	0.32	0.000				
PR. 3.1			8		0.14	0.90	0.126	4.00	0.50	0.00	0.504	0.0064	0.01540	5.55	1.50	0.27	0.0833	5.41	0.768	4.22	0.23	0.20	3.27	2.45	100%	0.50	0.000				,
PR. 4.0																															
PR. 5.0			8		0.09	0.90	0.081	4.00	0.32	0.00	0.324	0.0094	0.03500	2.46	1.50	0.61	0.0833	2.38	0.963	3.87	0.22	0.24	2.68	2.98	100%	0.32	0.000				
PR. 6.0	CB-2	2	8		0.21	0.90	0.189	4.00	0.76	0.00	0.756	0.0103	0.03500	3.85	1.50	0.39	0.0833	2.38	0.820	3.87	0.22	0.21	4.27	1.87	100%	0.76	0.000				
16931	DI-1				0.19	0.58	0.110	4.00	0.44	0.00	0.441	No Cloggir		Perimeter =	9.00	Area =	2.33	Ponding D	Pepth (d) =		Overland Re	elief Elev. =	47.15	Inlet Top	Elevation =	46.05			ing Elev. =	46.11	
												50% Cloge	ging	Perimeter =	4.50	Area =	1.17	Ponding D	Depth (d) =	0.10								Pond	ing Elev. =	46.15	
16901																															
PR. 10.0	CB-2	2	8		0.15	0.90	0.135	4.00	0.54	0.00	0.540	0.0384	0.04060	2.08	1.50	0.72	0.0833	2.05	0.985	3.77	0.21	0.25	5.01	1.60	100%	0.54	0.000				
PR. 8.0			8		0.45	0.90	0.405	4.00	1.62	0.00	1.620	0.0126	0.02100	7.07	1.50	0.21	0.0833	3.97	0.600	4.12	0.23	0.16	7.42	1.08	100%	1.62	0.000				
PR. 9.0	CB-2	2	8		0.56	0.90	0.504	4.00	2.02	0.00	2.016	0.0278	0.02250	6.25	1.50	0.24	0.0833	3.70	0.651	4.10	0.23	0.17	9.87	0.81	95%	1.92	0.101				
17117																															
17124			8		0.29	0.90	0.261	4.00	1.04	0.00	1.044	0.0148	0.01670	6.28	1.50	0.24	0.0833	4.99	0.695	4.20	0.23	0.18	6.03	1.33	100%	1.04	0.000				
PR. 7.0																								_			_				
PR. 7.1	Manl	hole																									_				

RLIN	E GTON																					
VIRG								Hyd	raulic	Grade	Line Co	mputa	itions									
												-	Junction I	Loss								
Inlet Structure	Upstream Structure	Outlet Water Surface Elev. (ft)	D <sub>o</sub> (in)	Q <sub>o</sub> (cfs)	L <sub>o</sub> (ft)	Sf <sub>o</sub> (%)	H <sub>f</sub> (Ft)	V <sub>o</sub> (ft/s)	H <sub>o</sub> (ft)	Qi	V <sub>i</sub> (ft/s)	$Q_iV_i$	V <sub>i</sub> ²/2g (ft)	H <sub>i</sub> (ft)	Angle (°)	H <sub>∆</sub> (ft)	H <sub>t</sub> (ft)	1.3 H <sub>t</sub> (ft)	0.5 H <sub>t</sub> (ft)	Final H	Inlet Water Surface Elev. (ft)	Rim Elev. (ft)
17194						tlet Pipe Dia. =			Pipe Inv. =	34.89	0.8xDia ⊣	- Pipe Inv. =	= 36.69		let WSEL =				Start	ing WSEL =	36.69	
17117	PR. 8.0	36.69	27	6.11	254.00	0.0390%	0.10	6.39	0.16	2.75	5.09	13.99	0.40	0.26 0.14	90	0.52 0.28	0.94	1.22		1.32	38.01	46.55
	PR. 8.0									3.42	6.91	23.64	0.40	0.14	90	0.28	1					
PR. 8.0	110. 510	39.00	15	2.75	55.97	0.1812%	0.10	5.09	0.12	5.12	1 0.51	23.01	J 3.7 1	0.20	50	0.52	0.12	0.16	0.08	0.18	39.18	46.91
PR. 9.0		41.98	15	3.42	67.50	0.2806%	0.19	6.91	0.22								0.22	0.29		0.48	42.46	47.45
17124		37.06	15	1.77	107.00	0.0752%	0.08	4.58	0.10								0.10	0.13		0.21	37.27	45.11
16674					Ou	tlet Pipe Dia. =	21.00	Outlet	Pipe Inv. =	35.18	0.8xDia ⊣	- Pipe Inv. =	= 36.58	Out	let WSEL =				Start	ing WSEL =	36.58	
16901		36.58	21	9.83	255.32	0.3851%	0.98	5.90	0.14					0.97		1.94	3.05	0.00		4.04	40.62	46.05
	16931									9.00	13.37	120.39	2.78	0.97	90	1.94						
	PR. 10.0	10.10				0 =0 1001			2.12	0.92	4.27	3.92	0.28	0.10	90	0.20						
16931	PR. 7.1	40.62	18	9.00	46.47	0.7343%	0.34	13.37	0.69	0.26	C 61	55.20	0.60	0.24	00	0.47 0.47	1.41	0.00	0.70	1.04	41.66	47.05
PR. 7.1	PR. 7.1	42.36	18	8.36	56.82	0.6329%	0.36	6.61	0.17	8.36	6.61	55.20	0.68	0.24 0.21	90	0.47	0.81	0.00	0.41	0.77	43.13	49.69
FR. 7.1	PR. 7.0	72.50	10	0.50	30.62	0.032970	0.50	0.01	0.17	6.39	6.29	40.19	0.61	0.21	90	0.43	0.01	0.00	0.71	0.77	75.15	T9.03
PR. 7.0	110.7.0	43.13	18	6.39	19.54	0.3701%	0.07	6.29	0.15	0.55	0.23	10.13	0.01	0.21	30	0.42	0.79	0.00	0.39	0.47	43.59	50.94
11(1710	PR. 6.0	13113	10	0.55	13131	0107 01 70	0.07	0,E3	0.15	6.46	6.24	40.32	0.61	0.21	90	0.42	01,75	0100	0.55	0.17	15155	30131
PR. 6.0		43.59	18	6.46	84.19	0.3780%	0.32	6.24	0.15					0.18		0.36	0.70	0.00	0.35	0.67	44.26	55.03
	PR. 5.0									5.24	5.78	30.30	0.52	0.18	90	0.36						
PR. 5.0		44.26	15	5.24	11.38	0.6584%	0.07	5.78	0.13					0.18		0.36	0.67	0.00	0.34	0.41	44.67	55.37
	PR. 4.0									4.75	5.76	27.38	0.52	0.18	90	0.36						
PR. 4.0	DD 2.2	44.67	15	4.75	51.78	0.5407%	0.28	5.76	0.13	1	T = ==	27.45	1 0 50	0.18		0.36	0.67	0.00	0.34	0.62	45.29	55.87
DD 2.0	PR. 3.0	45.40	45	4 70	42.52	0.54720/	1 0 24	F 70	0.13	4.78	5.79	27.65	0.52	0.18	90	0.36	0.60	0.00	0.20	0.54	46.02	FC 12
PR. 3.0	DD 3.0	45.48	15	4.78	43.53	0.5473%	0.24	5.79	0.13	2 40	5.36	10.64	T 0.4F	0.16	00	0.31	0.60	0.00	0.30	0.54	46.02	56.13
	PR. 2.0 17125									3.48 0.55	3.21	18.64 1.77	0.45 0.16	0.16 0.06	90	0.31 0.11	-					
	PR. 3.1									0.55	4.21	3.60	0.16	0.06	90	0.11	1					
PR. 2.0	LL' 2'I	46.02	15	3.48	23.08	0.2905%	0.07	5.36	0.11	0.00	7.21	3,00	0.20	0.10	30	0.19	0.40	0.53	0.26	0.33	46.35	56.32
110. 2.0	PR. 1.0	10.02	13	5.10	25.00	0.230370	0.07	3.30	0.11	0.87	4.24	3.69	0.28	0.10	90	0.20	0.10	0.55	0.20	0.55	10.55	30.32
PR. 1.0		49.10	15	0.87	71.01	0.0181%	0.01	4.24	0.08	3.07		3,03	3120	0.110		0.20	0.08	0.11	0.05	0.07	49.17	55.41
PR. 10.0		42.33	15	0.92	11.54	0.0201%	0.00	4.27	0.09								0.09	0.11	0.06	0.06	42.39	45.76
17125		53.87	15	0.55	126.02	0.0072%	0.01	3.21	0.05								0.05	0.06	0.03	0.04	54.13	57.39
PR. 3.1		47.00	15	0.86	44.83	0.0175%	0.01	4.21	0.08					1			0.08	0.11	0.05	0.06	47.06	56.97



DEPARTMENT OF
ENVIRONMENTAL SERVICES
FACILITIES & ENGINEERING DIVISION
ENGINEERING BUREAU
2100 CLARENDON BOULEVARD, SUITE 813
ARLINGTON, VA 22201
PHONE: 703.228.3629

COPYRIGHT © 2016 ARLINGTON COUNTY VIRGINIA - ALL RIGHTS RESERVED

FAX: 703.228.3606

SEAL TREVOR M. LANTZY
Lic. No. 0402050508
3/1/2021

APPROVALS

QUALITY CONTROL ENGINEER 6.26.20

Kamal N. Taktak

CONSTRUCTION MANAGEMENT SUPERVISOR

WATER, SEWER, STREETS BUREAU CHIEF

Dennis M. Leach
TRANSPORTATION DIRECTOR

Aiel Jang
6/17/2020

PROJECT MANAGER

REVISIONS DAT

STORM SEWER COMPUTATIONS
ROADWAY IMPROVEMENTS
S FERN ST TO S EADS ST

DESIGNED: NS
DRAWN: NS
CHECKED: TL

CHECKED: TL
MISS UTILITY TRANSMITTAL #: XXXX


FILENAME:
CC20-250-DRAINAGE DIVIDES.DWG
PATH: Q:\DATA\CC20\DESIGN\CAD\\_ACTIVE

PLOTTED: MARCH 1 2021 PLOTTED BY: NSHARP

SCALE:

N/A

SHEET C075.1

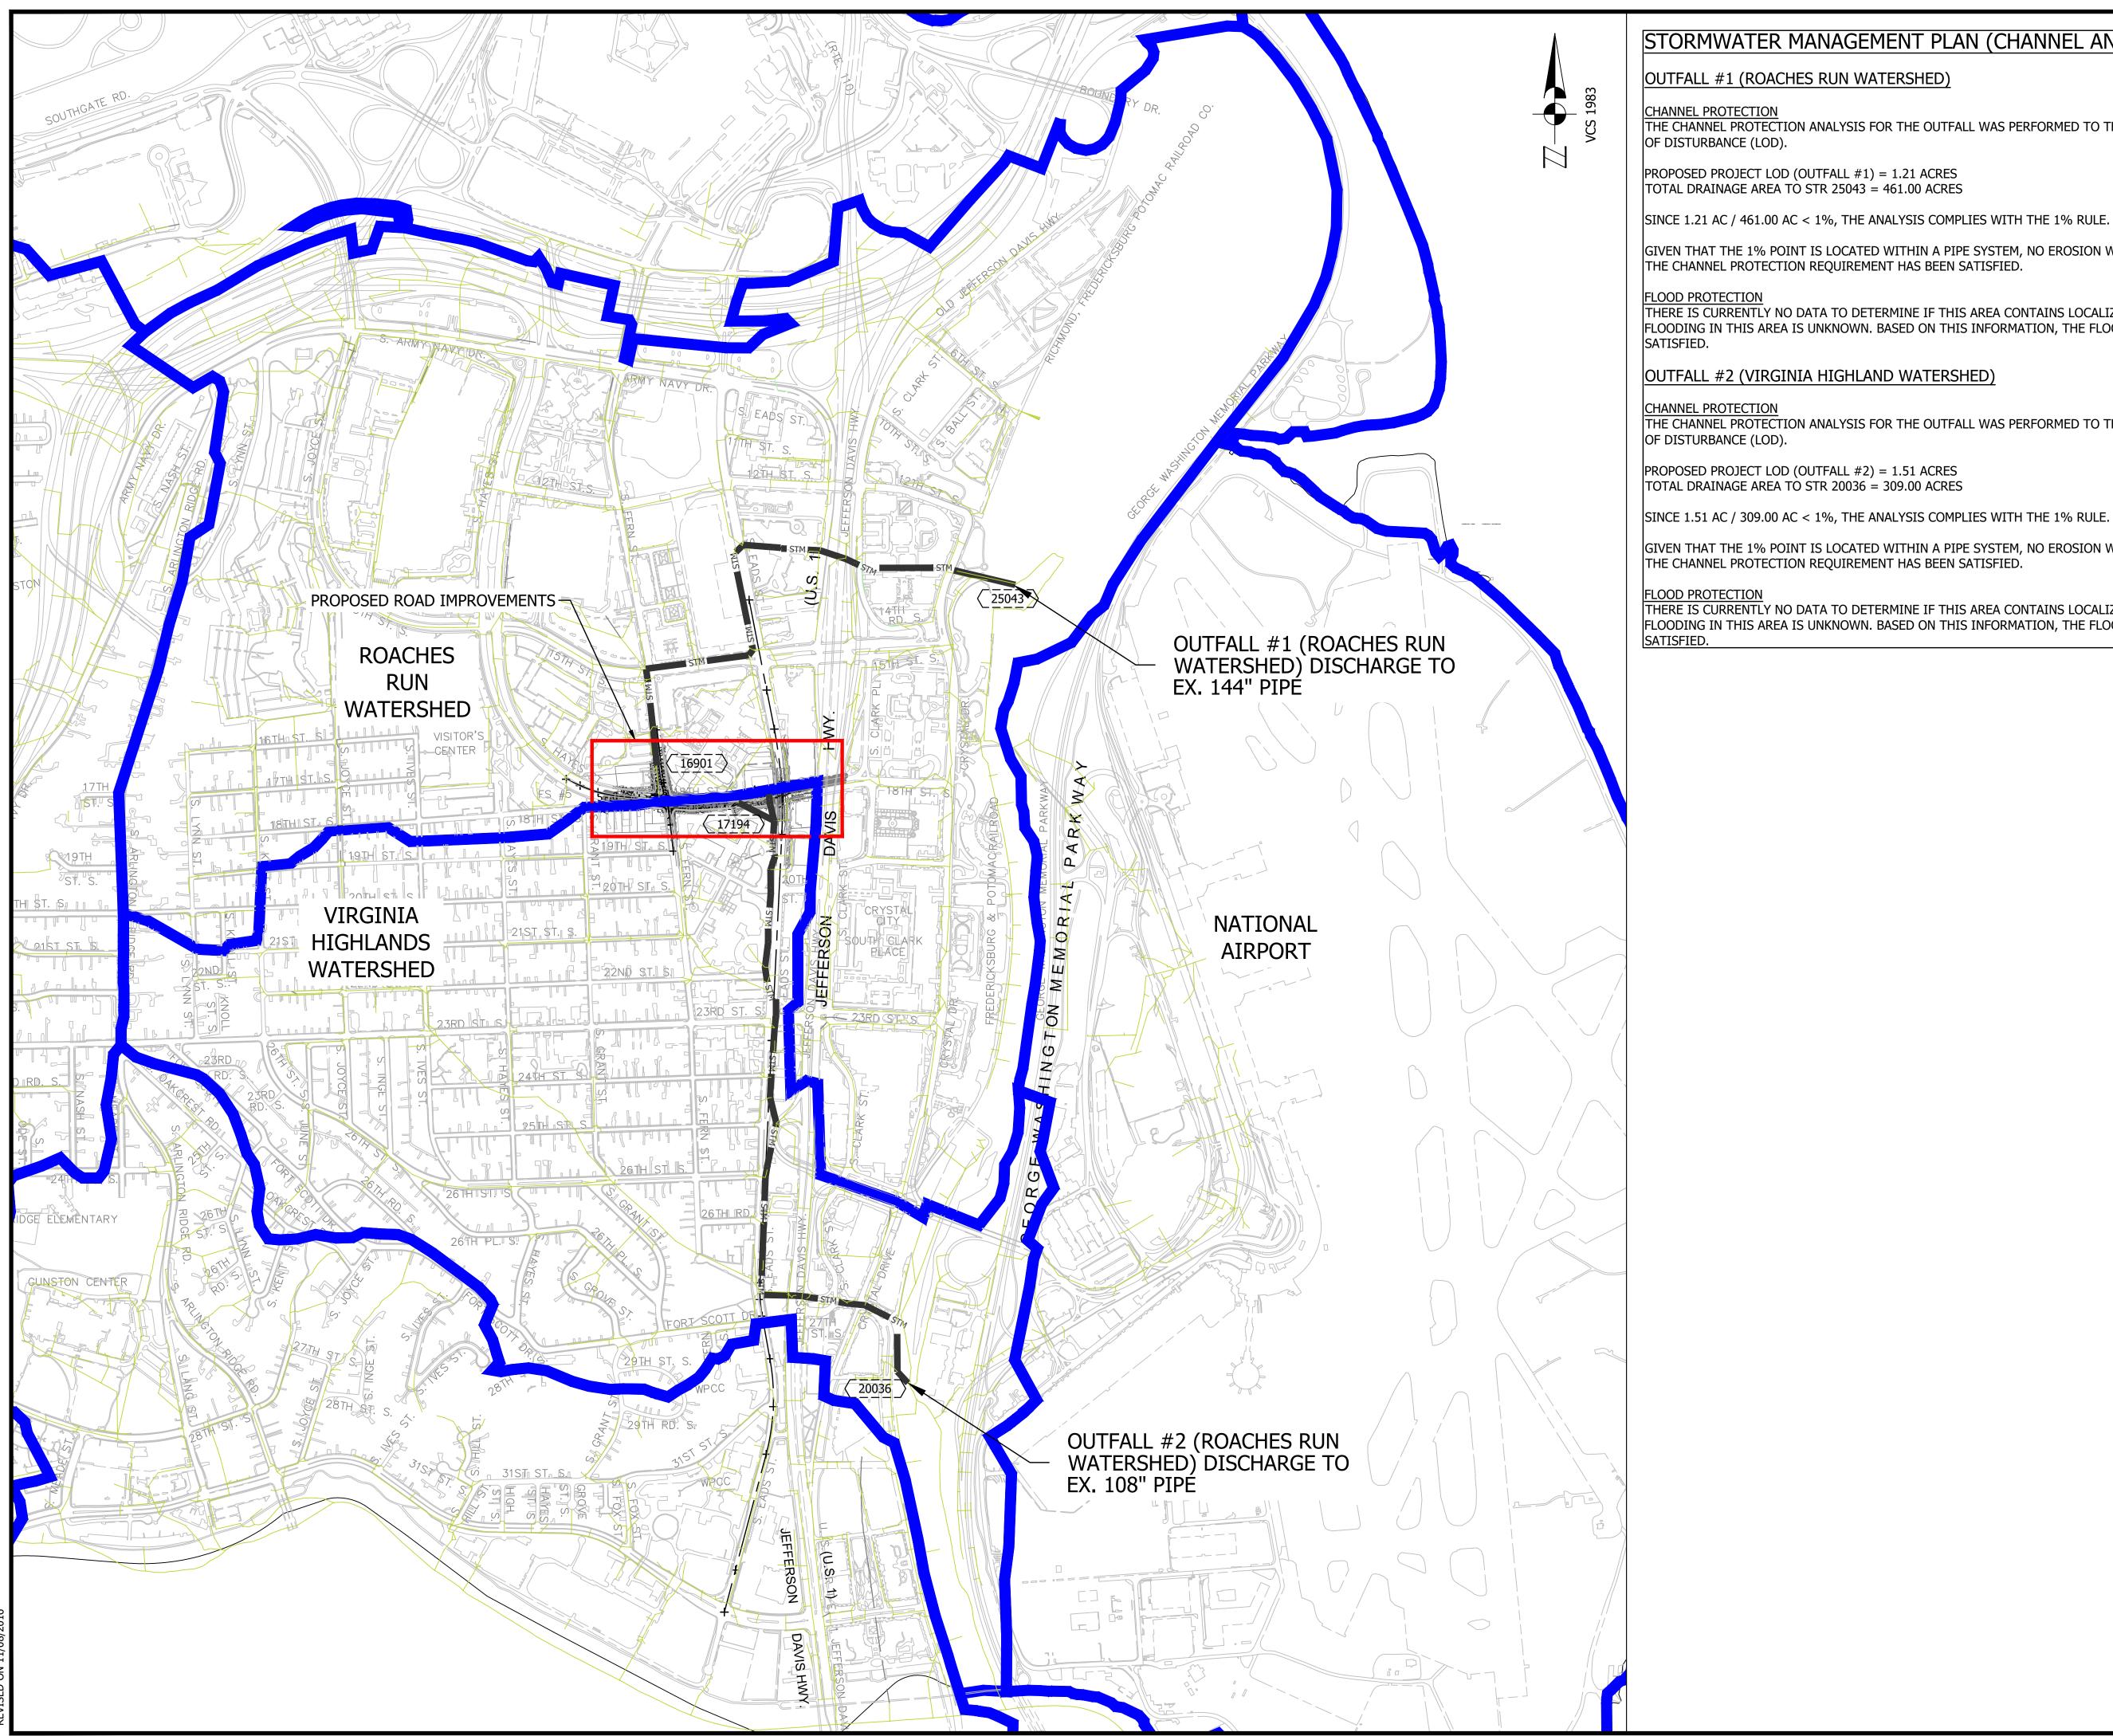

## STORMWATER MANAGEMENT PLAN (CHANNEL AND FLOOD PROTECTION)

OUTFALL #1 (ROACHES RUN WATERSHED)

THE CHANNEL PROTECTION ANALYSIS FOR THE OUTFALL WAS PERFORMED TO THE 1% BASED ON THE PROPOSED LIMITS

### PROPOSED PROJECT LOD (OUTFALL #1) = 1.21 ACRES

TOTAL DRAINAGE AREA TO STR 25043 = 461.00 ACRES

### SINCE 1.21 AC / 461.00 AC < 1%, THE ANALYSIS COMPLIES WITH THE 1% RULE.

GIVEN THAT THE 1% POINT IS LOCATED WITHIN A PIPE SYSTEM, NO EROSION WILL OCCUR AT THIS POINT. THEREFORE, THE CHANNEL PROTECTION REQUIREMENT HAS BEEN SATISFIED.

THERE IS CURRENTLY NO DATA TO DETERMINE IF THIS AREA CONTAINS LOCALIZED FLOODING. THEREFORE, LOCALIZED FLOODING IN THIS AREA IS UNKNOWN. BASED ON THIS INFORMATION, THE FLOOD PROTECTION CRITERIA HAS BEEN

OUTFALL #2 (VIRGINIA HIGHLAND WATERSHED)

#### CHANNEL PROTECTION

THE CHANNEL PROTECTION ANALYSIS FOR THE OUTFALL WAS PERFORMED TO THE 1% BASED ON THE PROPOSED LIMITS OF DISTURBANCE (LOD).

# PROPOSED PROJECT LOD (OUTFALL #2) = 1.51 ACRES TOTAL DRAINAGE AREA TO STR 20036 = 309.00 ACRES

GIVEN THAT THE 1% POINT IS LOCATED WITHIN A PIPE SYSTEM, NO EROSION WILL OCCUR AT THIS POINT. THEREFORE, THE CHANNEL PROTECTION REQUIREMENT HAS BEEN SATISFIED.

#### FLOOD PROTECTION

THERE IS CURRENTLY NO DATA TO DETERMINE IF THIS AREA CONTAINS LOCALIZED FLOODING. THEREFORE, LOCALIZED FLOODING IN THIS AREA IS UNKNOWN. BASED ON THIS INFORMATION, THE FLOOD PROTECTION CRITERIA HAS BEEN



ARLINGTON VIRGINIA

**DEPARTMENT OF ENVIRONMENTAL SERVICES** FACILITIES & ENGINEERING DIVISION ENGINEERING BUREAU 2100 CLARENDON BOULEVARD, SUITE 813

ARLINGTON, VA 22201 PHONE: 703.228.3629 FAX: 703.228.3606

COPYRIGHT © 2016 ARLINGTON COUNTY VIRGINIA - ALL RIGHTS RESERVED



**APPROVALS** 

Camel 6/18/2020 QUALITY CONTROL ENGINEER 6.26.20 Kamal N. Taktak CONSTRUCTION MANAGEMENT SUPERVISOR

WATER, SEWER, STREETS BUREAU CHIEF Dennis W. Leach 6/24/20 TRANSPORTATION DIRECTOR Aill Yang

DATE

PROJECT MANAGER

**REVISIONS** 

SOUTH STREET

DESIGNED: NS CHECKED: TL

CC20-256-SWM\_PLAN.DWG PATH: Q:\DATA\CC20\DESIGN\CAD\\_ACTIVE

MISS UTILITY TRANSMITTAL #: XXXX

PLOTTED: MARCH 1 2021 PLOTTED BY:NSHARP

SCALE:

GRAPHIC SCALE

SHEET C081.1

## SWM NOTES

THE RUNOFF REDUCTION SPREADSHEET INFORMATION ON THIS PLAN IS FOR DATA TRACKING PURPOSES TO DOCUMENT THE AREA OF LAND DISTURBANCE AND TO CHARACTERIZE PRE- AND POST-DEVELOPMENT LAND USE CONDITIONS.

IN ACCORDANCE WITH ARLINGTON COUNTY'S CHESAPEAKE BAY TOTAL MAXIMUM DAILY LOAD (TMDL) ACTION PLAN, APPROVED BY THE VIRGINIA DEPARTMENT OF ENVIRONMENTAL QUALITY (DEQ) ON SEPTEMBER 1, 2015, LINEAR DEVELOPMENT PROJECTS CONDUCTED BY THE COUNTY ARE ADMINISTERED AND TRACKED AS FOLLOWS CONSISTENT WITH 9VAC25-870-69.A.4, 9VAC25-870-76, AND 9VAC25-870-92:

- POLLUTANT LOAD CHANGES WILL BE COMPUTED AS DESCRIBED IN SECTION 3.A OF THE ACTION PLAN.
   RETROFIT OPPORTUNITIES WILL BE EVALUATED FOR EACH PROJECT, USING THE SCREENING AND
- SELECTION CRITERIA APPLIED AND DESCRIBED IN THE ADOPTED STORMWATER MASTER PLAN.

   RETROFIT PROJECTS THAT MEET THE SCREENING CRITERIA AND ARE DETERMINED BY ARLINGTON TO BE FEASIBLE AND COST-EFFECTIVE WILL BE IMPLEMENTED WITH SPECIFIC LINEAR DEVELOPMENT PROJECTS. POLLUTANT LOAD REDUCTIONS FROM RETROFIT PROJECTS WILL BE COMPUTED AS DESCRIBED IN
- SECTION 5 OF THE ACTION PLAN.

  IN CASES WHERE RETROFIT PROJECTS ARE NOT FEASIBLE AND COST-EFFECTIVE FOR A PARTICULAR LINEAR PROJECT, ANY POC LOAD INCREASES THAT MIGHT OCCUR FOR THAT PROJECT WILL BE ADDRESSED BY LARGER OVERALL POC LOAD REDUCTIONS IN PLACE OR ADDED THROUGH TMDL ACTION PLAN IMPLEMENTATION.
- IN THE ABOVE MANNER ARLINGTON, AS THE MS4 OPERATOR AND THE CONSTRUCTION SITE OPERATOR FOR ITS LINEAR DEVELOPMENT PROJECTS, IMPLEMENTS LINEAR PROJECTS AND RETROFIT PROJECTS IN A MANNER THAT ACHIEVES THE MOST TMDL POC REDUCTION FOR THE LEAST COST, WHILE FULLY ACCOUNTING FOR LOAD CHANGES THAT OCCUR WITH LINEAR DEVELOPMENT PROJECT ACTIVITY CONSISTENT WITH THE DEQ CHESAPEAKE BAY TMDL SPECIAL CONDITION GUIDANCE.

#### PRE DEVELOPMENT CONDITIONS

THE PROJECT SITE CONSIST PRIMARILY OF IMPERVIOUS AREA (ASPHALT ROADWAY AND CONCRETE SIDEWALK) AND A SMALL AMOUNT OF PERVIOUS GRASS AREA.

#### POST DEVELOPMENT CONDITIONS

THE PROJECT CONSISTS OF REMOVING AND REPLACING EXISTING CURB, GUTTER AND SIDEWALK; INSTALLING ADA COMPLIANT RAMPS; REMOVING AND REPLACING EXISTING STREETLIGHTS; TRAFFIC SIGNAL WORK AT THE INTERSECTION OF 18TH STREET SOUTH AND SOUTH FERN STREET; AND MILLING AND PAVING THE ASPHALT ROADWAY.


#### VPPM CALCULATIONS

				od Re-Development Co							
BMP Standards and Specification	ons	2013 Draft Bl	MP Standards and S	pecifications	1	ı					
Project Name:		a Description of the Control of the	TREET SOUTH -			CLEAR	ALL	data input cells			
Date:			5-Dec-18 elopment Project?	Yes	9.8			calculation cells			
formation								final results			
evelopment Project	(Treatmen	t Volume a	nd Loads)								
		Ente	er Total Disturbe	d Area (acres) $\rightarrow$	2.7221		PMP Design See	Check:	2012 De	oft Stds P. Sposs	
			Maximum	reduction required:	20%			Linear project?	No No	art stus & specs	
				ous cover (acres) is: tion for Site (lb/yr):	0.0000 0.8756		Land cover areas en	tered correctly? d area entered?	<u> </u>		
		Post-Developi	Hent IP Load Reduc	.tion for Site (ib/yr).	0.8750		Total disturbed	a area enterear			
evelopment Land Cover (acre								<u> </u>			
en Space (acres) undisturbed,	A Soils	B Soils	C Soils	D Soils	0.0000						
orest/open space or reforested land urf (acres) disturbed, graded for					0.1970						
ner turf to be mowed/managed  Cover (acres)				0.1970	2.5251						
Cover (acres)				2.5251	2.7221						
elopment Land Cover (acres)	A Soils	B Soils	C Soils	D Soils	Totals						
n Space (acres) undisturbed, prest/open space or reforested land					0.0000						
urf (acres) disturbed, graded for er turf to be mowed/managed				0.3480	0.3480						
Cover (acres)				2.3741	2.3741						
Area Check	ок.	OK.	ок.	OK.	2.7221						
							2004				
S fall (inches)	10		Runoff Coefficient								
fall (inches) all Event (inches)	43 1.00		Forest/Open Space	A Soils 0.02	0.03	<b>C Soils</b> 0.04	<b>D Soils</b> 0.05				
horus (TP) EMC (mg/L) en (TN) EMC (mg/L)	0.26 1.86		Managed Turf Impervious Cover	0.15 0.95	0.20 0.95	0.22 0.95	0.25 0.95				
ad (lb/acre/yr) orrection factor)	0.41 0.90										
•		ODMENT						OOT DEVELO	DMEN	-	
D COVER SUMMARY P	RE-REDEVEL	OPMENT				LAND COVER	R SUMMARY PC	DST DEVELO	PMEN		
Land Cover Summ Pre-ReDevelopment	nary-Pre Listed	Adjusted <sup>1</sup>		Land Cover Summa Post ReDev. & Nev			Land Cover Sun Post-ReDeve			Land Cover Summ Post-Development Ne	-70
est/Open Space Cover (acres)	0.0000	0.0000		Forest/Open Space	0.0000		Forest/Open Space	0.0000		Post-Development Ne	w impervious
Weighted Rv(forest)	0.0000	0.0000		Cover (acres) Weighted Rv(forest)	0.0000		Cover (acres) Weighted Rv(forest)	0.0000			
% Forest	0%	0%		% Forest	0%		% Forest	0%			
anaged Turf Cover (acres)	0.1970	0.1970		Managed Turf Cover (acres)	0.3480		Managed Turf Cover (acres)	0.3480			
Weighted Rv(turf)	0.2500	0.2500		Weighted Rv (turf)	0.2500		Weighted Rv (turf)	0.2500			
% Managed Turf	7%	7%		% Managed Turf	13%	***	% Managed Turf	13%			
mpervious Cover (acres)	2.5251	2.5251		Impervious Cover (acres)	2.3741		ReDev. Impervious Cover (acres)	2.3741		New Impervious Cover (acres)	0.0000
Rv(impervious)	0.9500	0.9500		Rv(impervious)	0.9500		Rv(impervious)	0.9500		Rv(impervious)	<del></del>
% Impervious	93%	93%		% Impervious	87%		% Impervious  Total ReDev. Site Area	87%			
Total Site Area (acres)	2.7221	2.7221		Final Site Area (acres)	2.7221		(acres)	2.7221			
Site Rv	0.8993	0.8993		Final Post Dev Site Rv	0.8605		ReDev Site Rv	0.8605			
Treatment Volume and	Nutrient Loa	d				Treat	ment Volume and	Nutrient Load	I		
evelopment Treatment Volume (acre-ft)	0.2040	0.2040		Final Post-Development Treatment Volume (acre-ft)	0.1952		Post-ReDevelopment Treatment Volume (acre-ft)	0.1952		Post-Development Treatment Volume (acre-ft)	
Development Treatment Volume (cubic feet)	8,886.5917	8,886.5917		Final Post-Development Treatment Volume (cubic feet)	8,502.8750		Post-ReDevelopment Treatment Volume (cubic feet)	8,502.8750		Post-Development Treatment Volume (cubic feet)	
e-ReDevelopment TP Load (lb/yr)	5.5834	5.5834		Final Post- Development TP Load (lb/yr)	5.3423		Post-ReDevelopment Load (TP) (lb/yr)*	5.3423		Post-Development TP Load (lb/yr)	
ReDevelopment TP Load per acre (lb/acre/yr)	2.0500	2.0500		Final Post-Development TP Load per acre (lb/acre/yr)	1.9600		Post-ReDevelopment TP Load per acre (lb/acre/yr)	1.9600			
Baseline TP Load (lb/yr) cre/yr applied to pre-redevelopment area land proposed for new impervious co		1.1161					Max. Reduction Required (Below Pre- ReDevelopment Load)	0.2000			
and Cover Summary: opment land cover minus pervious land e proposed for new impervious cover.							TP Load Reduction Required for Redeveloped Area (lb/yr)	0.8756		TP Load Reduction Required for New Impervious Area (lb/yr)	0
tal acreage is consistent with Post-ReDious cover).  ows load reduction requriement for ne											
nt load limit, 0.41 lbs/acre/year).											
			Post-Dev	elopment Requi	irement for S	ite Area					
			TP Load	Reduction Required	(lb/yr)	0.8756					

A R L I NG TO N VIRGINIA

DEPARTMENT OF
ENVIRONMENTAL SERVICES
FACILITIES & ENGINEERING DIVISION
ENGINEERING BUREAU
2100 CLARENDON BOULEVARD, SUITE 813
ARLINGTON, VA 22201
PHONE: 703.228.3629
FAX: 703.228.3606

COPYRIGHT © 2016 ARLINGTON COUNTY VIRGINIA - ALL RIGHTS RESERVED

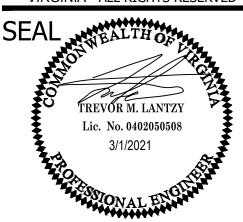

APPROVALS

ONTE

6/18/2020

QUALITY CONTROL ENGINEER

CONSTRUCTION MANAGEMENT SUPERVISOR

06.29.20

WATER, SEWER, STREETS BUREAU CHIEF

WATER, SEWER, STREETS BUREAU CHIEF

Dennis M. Leach 6/24/20

TRANSPORTATION DIRECTOR

Aciel Yang 6/17/2020

PROJECT MANAGER

REVISIONS DAT

SOUTH
ATIONS
OVEMENTS
EADS ST

SWM COMPUTATIONS
ROADWAY IMPROVEMEN
S FERN ST TO S EADS S

DESIGNED: NS
DRAWN: NS
CHECKED: TL
MISS UTILITY TRANSMITTAL #: XXXX

**18TH** 


FILENAME:
CC20-254-SWM\_DIVIDES\_AND\_COMPS.DWG
PATH: Q:\DATA\CC20\DESIGN\CAD\\_ACTIVE


PLOTTED: MARCH 1 2021 PLOTTED BY: NSHARP


SCALE:


N/A

SHEET C085.1

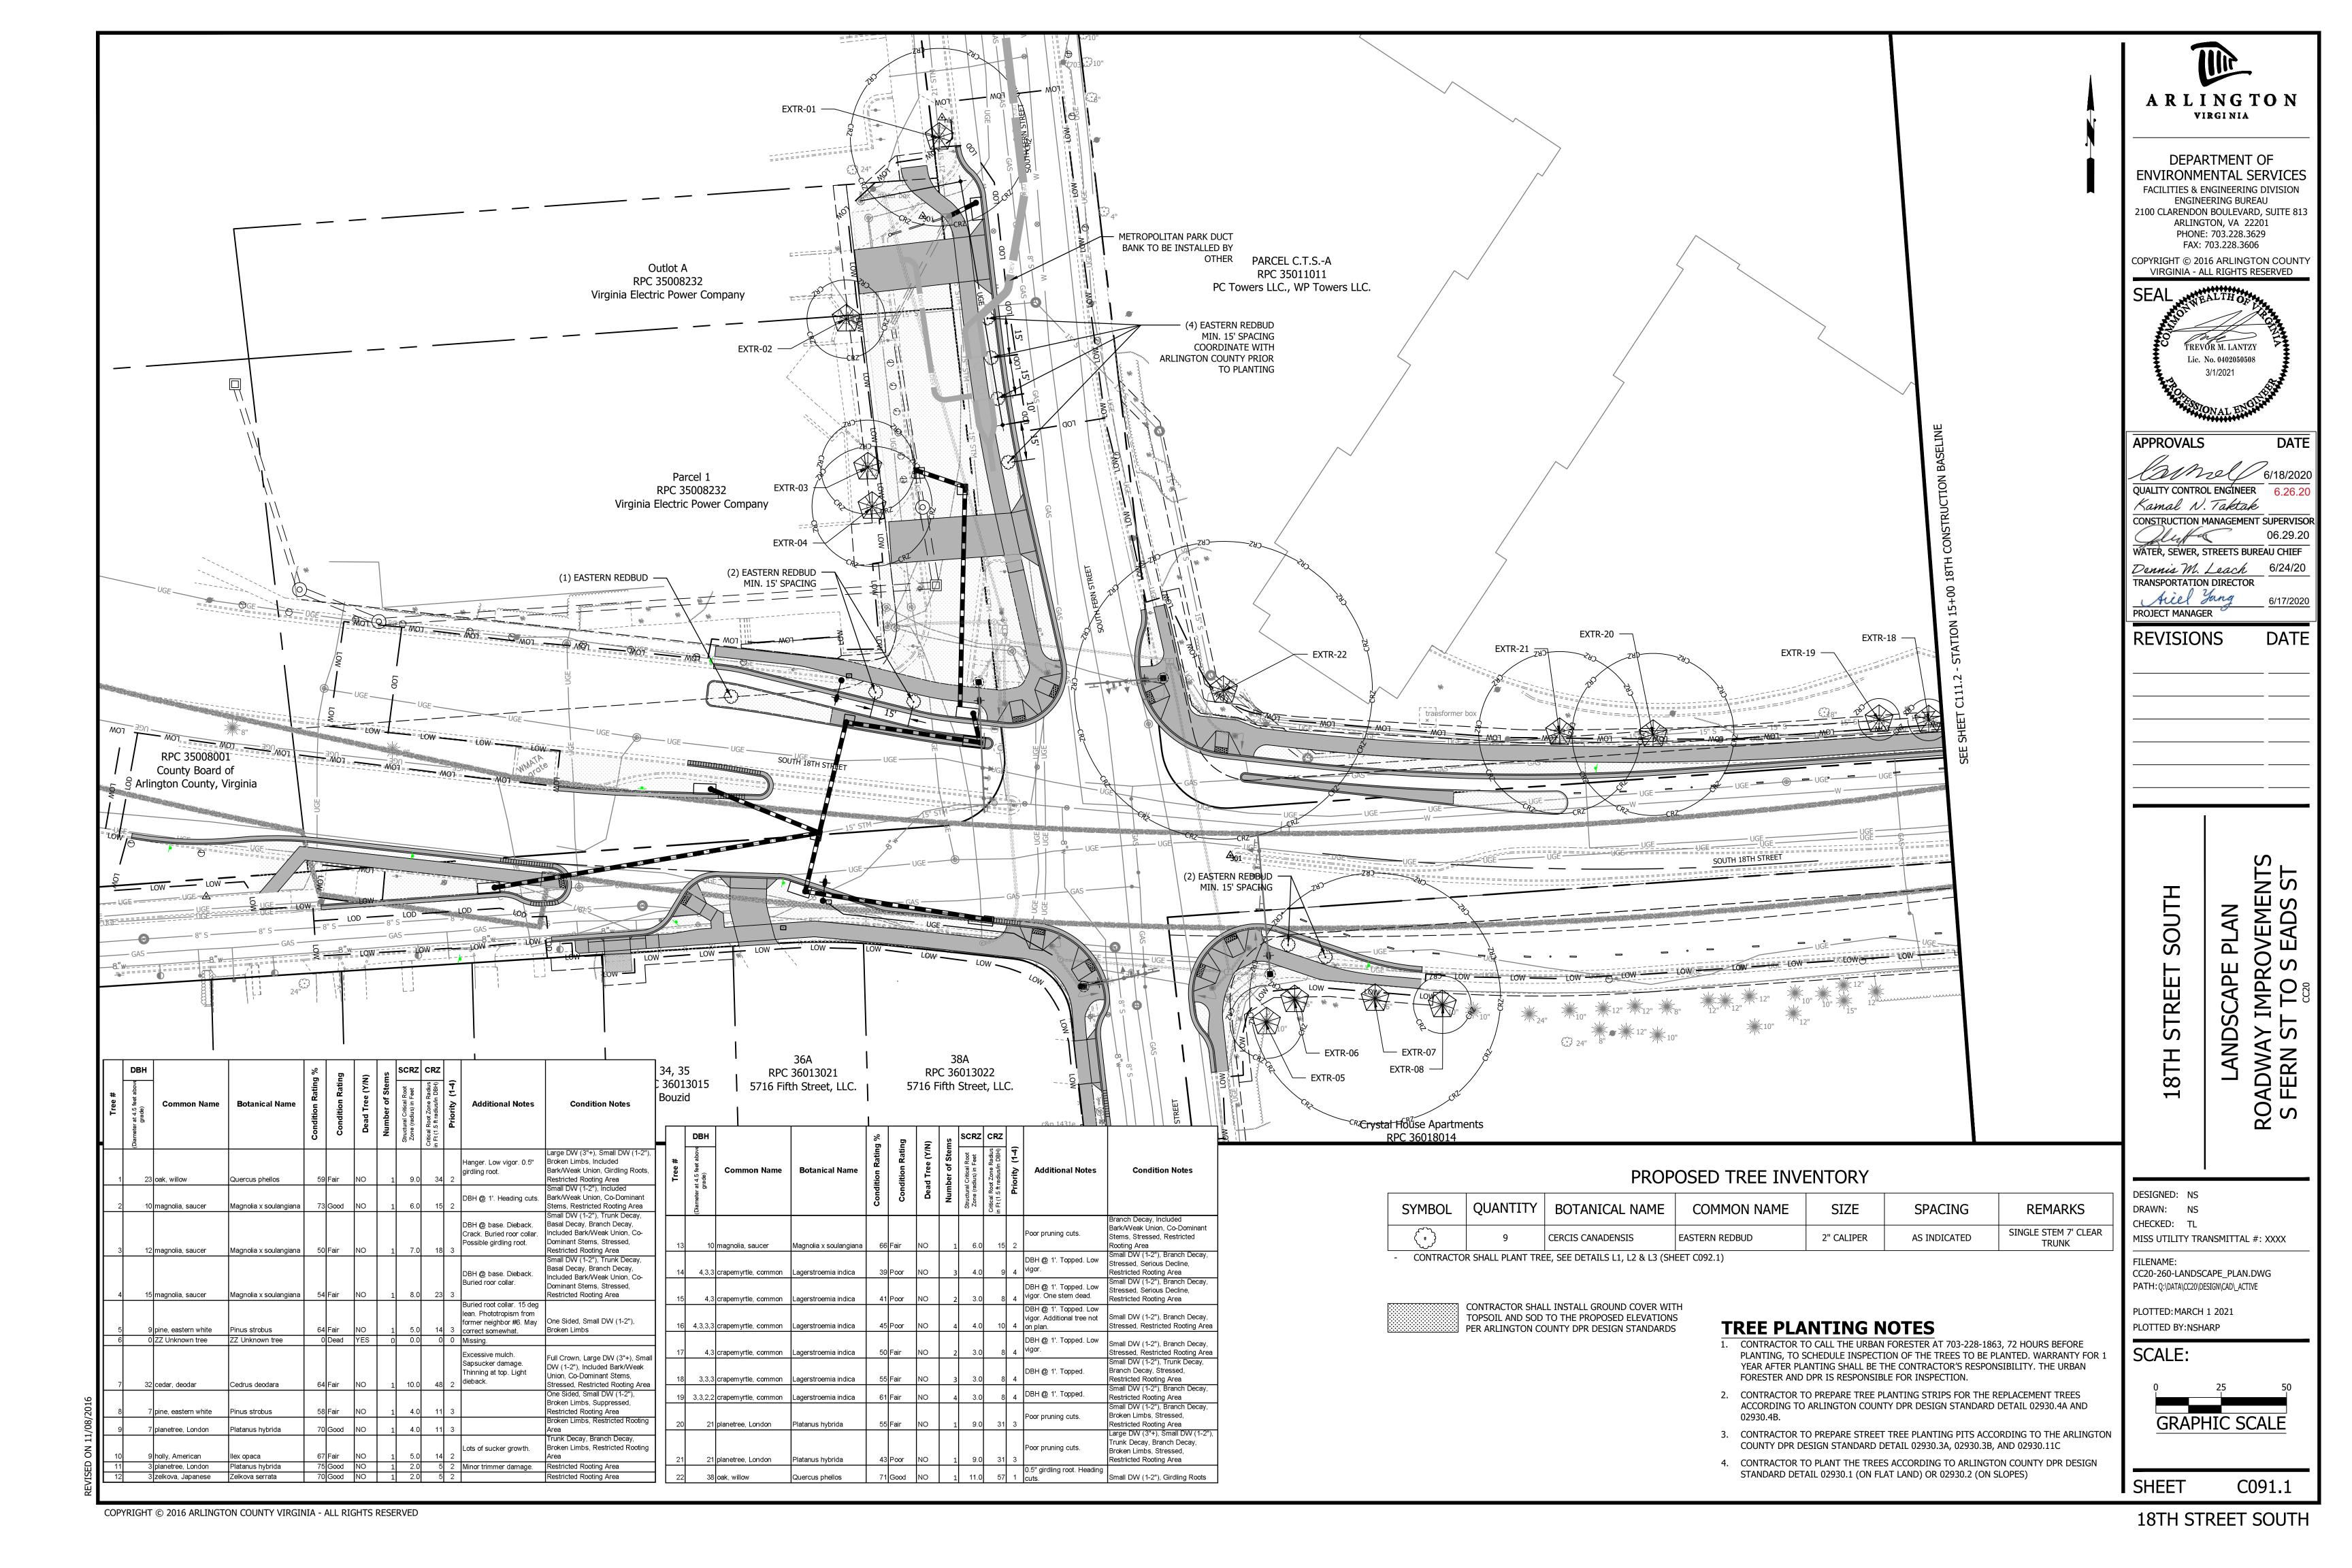

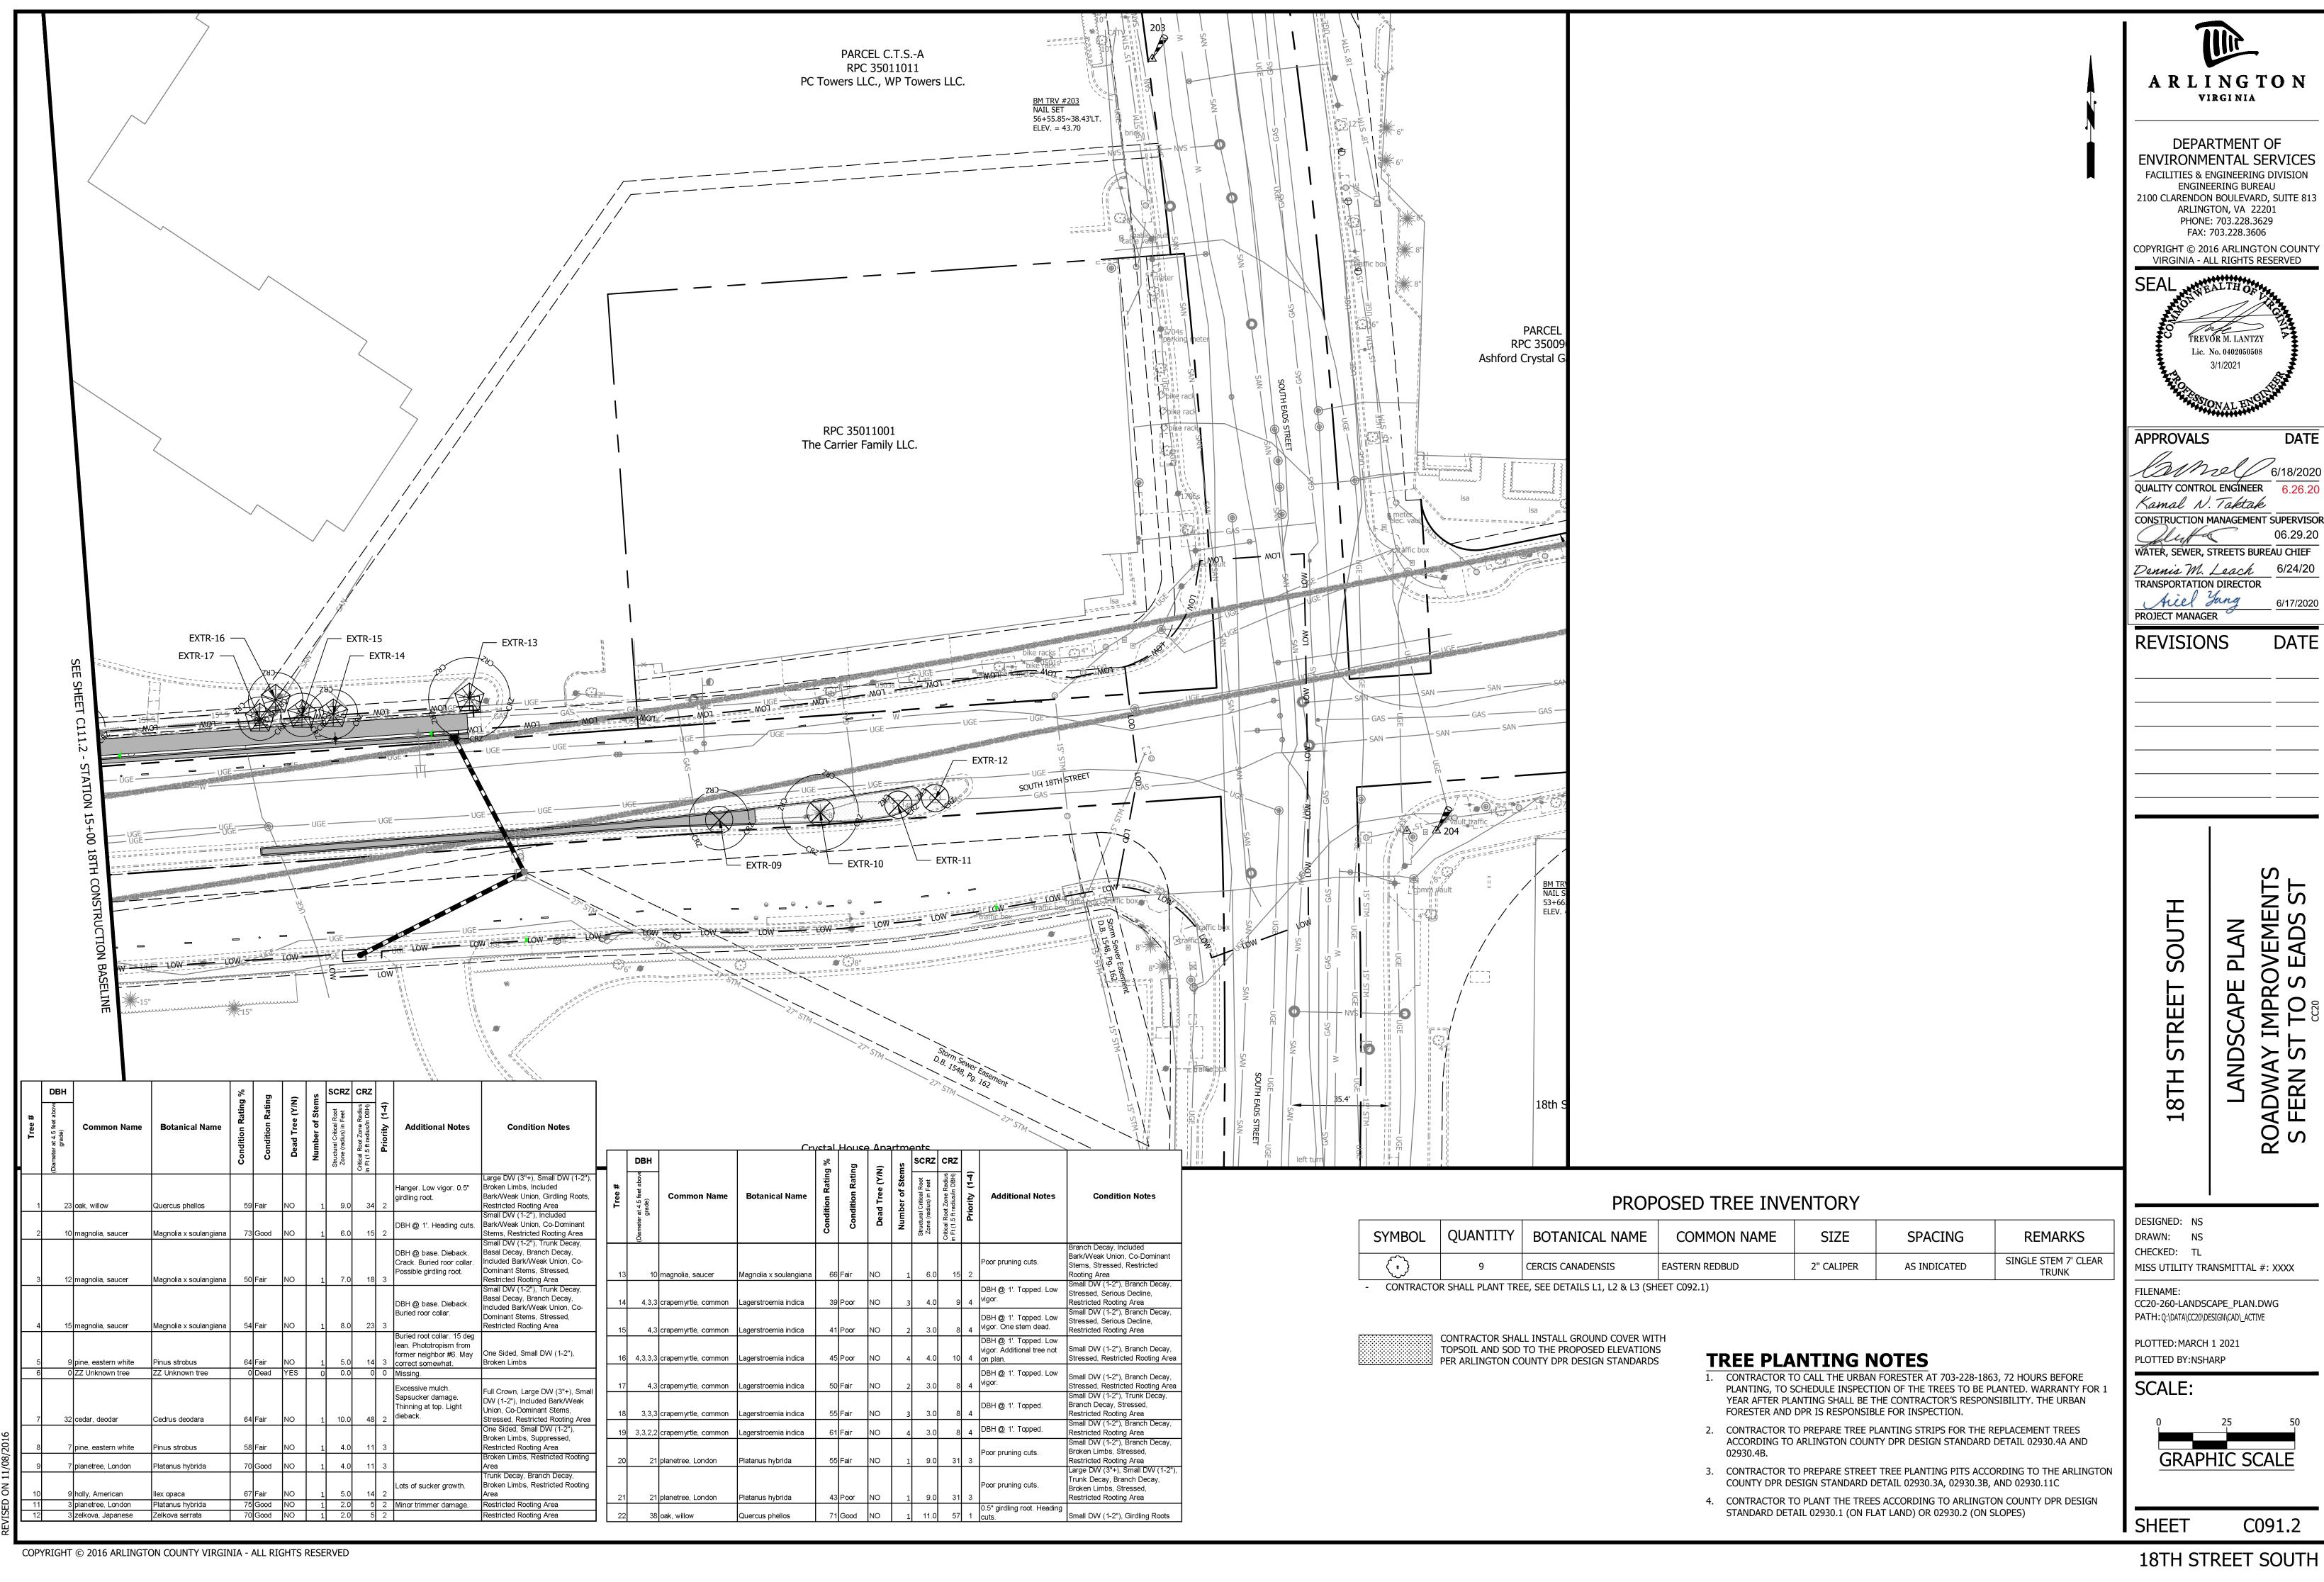

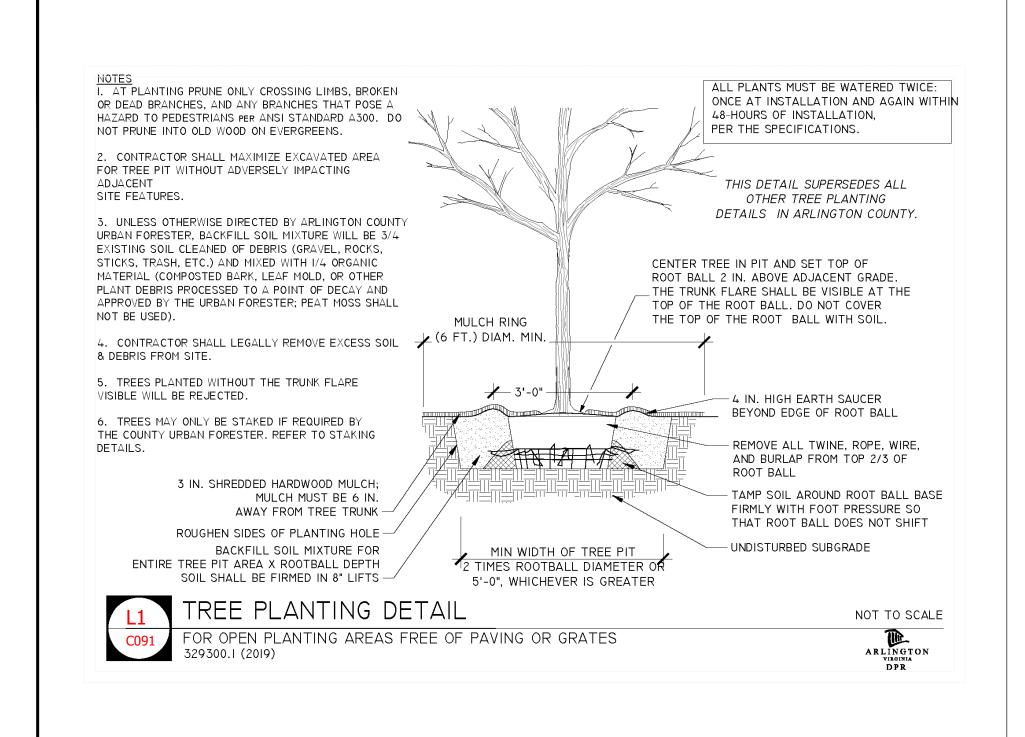

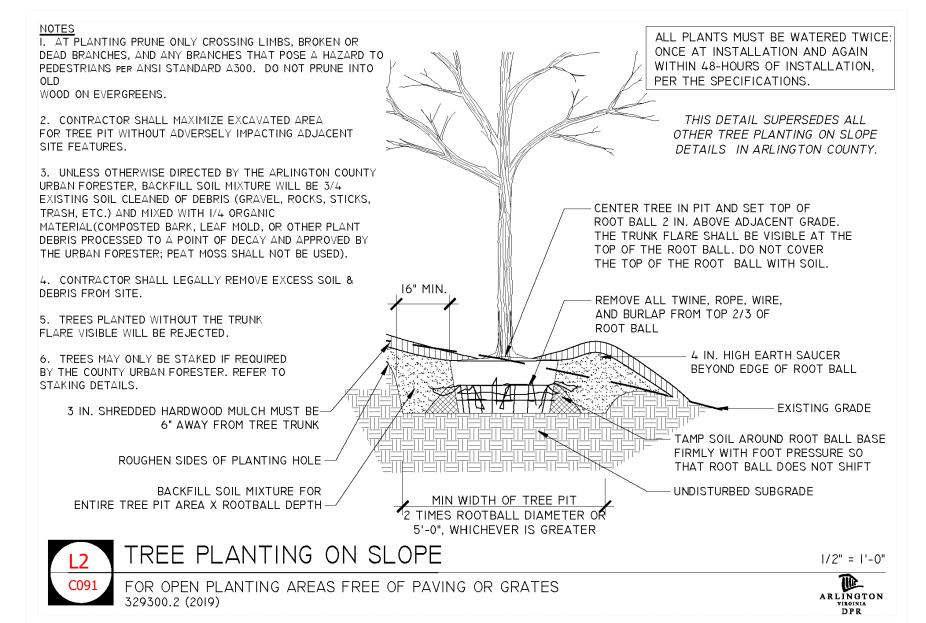

<u>NOTES</u>

I. A PERMIT IS REQUIRED WHEN TREES ARE PLANTED IN PUBLIC RIGHT-OF-WAY OR IN A PUBLIC EASEMENT. THE DEPARTMENT OF ENVIRONMENTAL SERVICES SHALL ISSUE THE PERMIT ACCORDING TO THE PROVISIONS OF THE CURRENT ARLINGTON COUNTY ADMINISTRATIVE REGULATION 4.3.

2. TREE SPECIES SHALL BE SELECTED FROM THE "ARLINGTON COUNTY STREET TREE LIST" OR PER SECTOR PLAN REQUIREMENTS.

3. TREES SHALL BE NURSERY GROWN SPECIMENS THAT MEET THE LATEST EDITION OF THE AMERICAN STANDARDS FOR NURSERY STOCK (ANSI Z60). FOLLOWING SPECIFICATIONS: BALLED AND BURLAPPED TREES SHALL BE SECURELY HELD IN PLACE BY UNTREATED BURLAP AND STOUT ROPE (NYLON ROPE IS NOT ACCEPTABLE).

4. CALL MISS UTILITY AT (800) 552-7001 FOR UTILITY LOCATIONS PRIOR TO EXCAVATION.

LOOSE, BROKEN OR MANUFACTURED BALLS ARE UNACCEPTABLE.

5. AT TIME OF PLANTING PRUNE ONLY CROSSING LIMBS, BROKEN OR DEAD BRANCHES, AND ANY BRANCHES THAT POSE A HAZARD TO PEDESTRIANS. DO NOT PRUNE INTO OLD WOOD ON EVERGREENS.

6. TREE PIT AND TREE STRIP PLANTING AREA DIMENSIONS: (A) 5' X I2' OR LARGER IS STANDARD (B) 4' X 15' MINIMUM IS ALLOWED PER SITE CONDITIONS AND COUNTY URBAN FORESTER'S APPROVAL.

7. SPACE TREES 25'-30' APART OR PER SECTOR PLAN REQUIREMENTS OR SITE CONDITIONS.

8. SITE CHARACTERISTICS, SUCH AS OVERHEAD POWER LINES, EXISTING VEGETATION, AND INFRASTRUCTURE ITEMS SUCH AS CURBS, SIDEWALKS AND UTILITIES SHALL BE CONSIDERED. TREES THAT GROW TALLER THAN 25 FEET SHOULD NOT BE PLANTED DIRECTLY UNDER POWER LINES. WHEN POSSIBLE THE TREE LEADER SHALL BE OFFSET FROM POWER LINES.

9. BACKFILL SOIL MIXTURE SHALL BE 3/4 EXISTING SOIL CLEANED OF DEBRIS (GRAVEL, ROCKS, STICKS, TRASH, ETC.) AND MIXED WITH 1/4 ORGANIC MATERIAL (COMPOSTED BARK, LEAF MOLD, OR OTHER PLANT DEBRIS PROCESSED TO A POINT OF DECAY AND APPROVED BY THE COUNTY URBAN FORESTER. PEAT MOSS MAY NOT BE USED.

10. IF THE QUANTITY OF ACCEPTABLE EXISTING SOIL IS INSUFFICIENT FOR THE PLANTING REQUIREMENTS, THE CONTRACTOR MAY USE TOPSOIL. SOIL TEST REPORT RESULTS FOR THE TOPSOIL WILL BE MADE AVAILABLE TO THE COUNTY URBAN FORESTER UPON REQUEST, CONTRACTOR SHALL SUBMIT TOPSOIL FOR APPROVAL TO COUNTY URBAN FORESTER THAT MEETS THE

(A.) TOPSOIL CONSISTS OF A SANDY LOAM WITH UNIFORM COMPOSITION AND IS FREE OF STONES, LUMPS, PLANTS, ROOTS, AND OTHER DEBRIS OVER I/2" IN LENGTH.

(B.) TOPSOIL HAS A PH RANGE OF 5.5 TO 6.5 AND A MINIMUM CONTENT OF 1.0% ORGANIC MATTER (C.) TOPSOIL DOES NOT CONTAIN TOXIC SUBSTANCES HARMFUL TO PLANT GROWTH. SOLUBLE SALT LEVEL SHALL NOT EXCEED 3 MILLIOHMS PER CENTIMETER.

II. TREES PLANTED WITHOUT THE TRUNK FLARE VISIBLE WILL BE REJECTED.

12. TREES MAY ONLY BE STAKED IF REQUIRED BY THE COUNTY URBAN FORESTER. REFER TO ARLINGTON COUNTY STANDARD STAKING DETAILS.

13. MULCH SHALL BE CLEAN, SCREENED, DOUBLE-HAMMERED HARDWOOD BARK MULCH, UNIFORM IN SIZE AND FREE OF STONES, CLODS, NON-ORGANIC DEBRIS AND OTHER FOREIGN MATERIAL.

14. ALL PLANTS SHALL BE WATERED TWICE: ONCE AT INSTALLATION AND

AGAIN WITHIN 48-HOURS OF INSTALLATION. EACH WATERING WILL CONSIST OF 20 GALLONS PER TREE.

I5. CONTRACTOR SHALL LEGALLY REMOVE EXCESS SOIL & DEBRIS FROM



ARLINGTON



DEPARTMENT OF **ENVIRONMENTAL SERVICES** FACILITIES & ENGINEERING DIVISION

ENGINEERING BUREAU 2100 CLARENDON BOULEVARD, SUITE 813 ARLINGTON, VA 22201 PHONE: 703.228.3629 FAX: 703.228.3606

COPYRIGHT © 2016 ARLINGTON COUNTY VIRGINIA - ALL RIGHTS RESERVED



APPROVALS

QUALITY CONTROL ENGINEER 6.26.20 Kamal N. Taktak

CONSTRUCTION MANAGEMENT SUPERVISOR WATER, SEWER, STREETS BUREAU CHIEF Dennis M. Leach 6/24/20

TRANSPORTATION DIRECTOR Sicel Yang PROJECT MANAGER

**REVISIONS** 

SOUTH

AND

STREET ROADWA'S FERN 5 **ANDSCAPE 18TH** 

DESIGNED: NS DRAWN: NS CHECKED: TL

MISS UTILITY TRANSMITTAL #: XXXX

FILENAME: CC20-260-LANDSCAPE\_PLAN.DWG PATH: Q:\DATA\CC20\DESIGN\CAD\\_ACTIVE

PLOTTED: MARCH 1 2021


PLOTTED BY:NSHARP


SCALE:

**AS SHOWN** 


SHEET C092.1

COPYRIGHT © 2016 ARLINGTON COUNTY VIRGINIA - ALL RIGHTS RESERVED

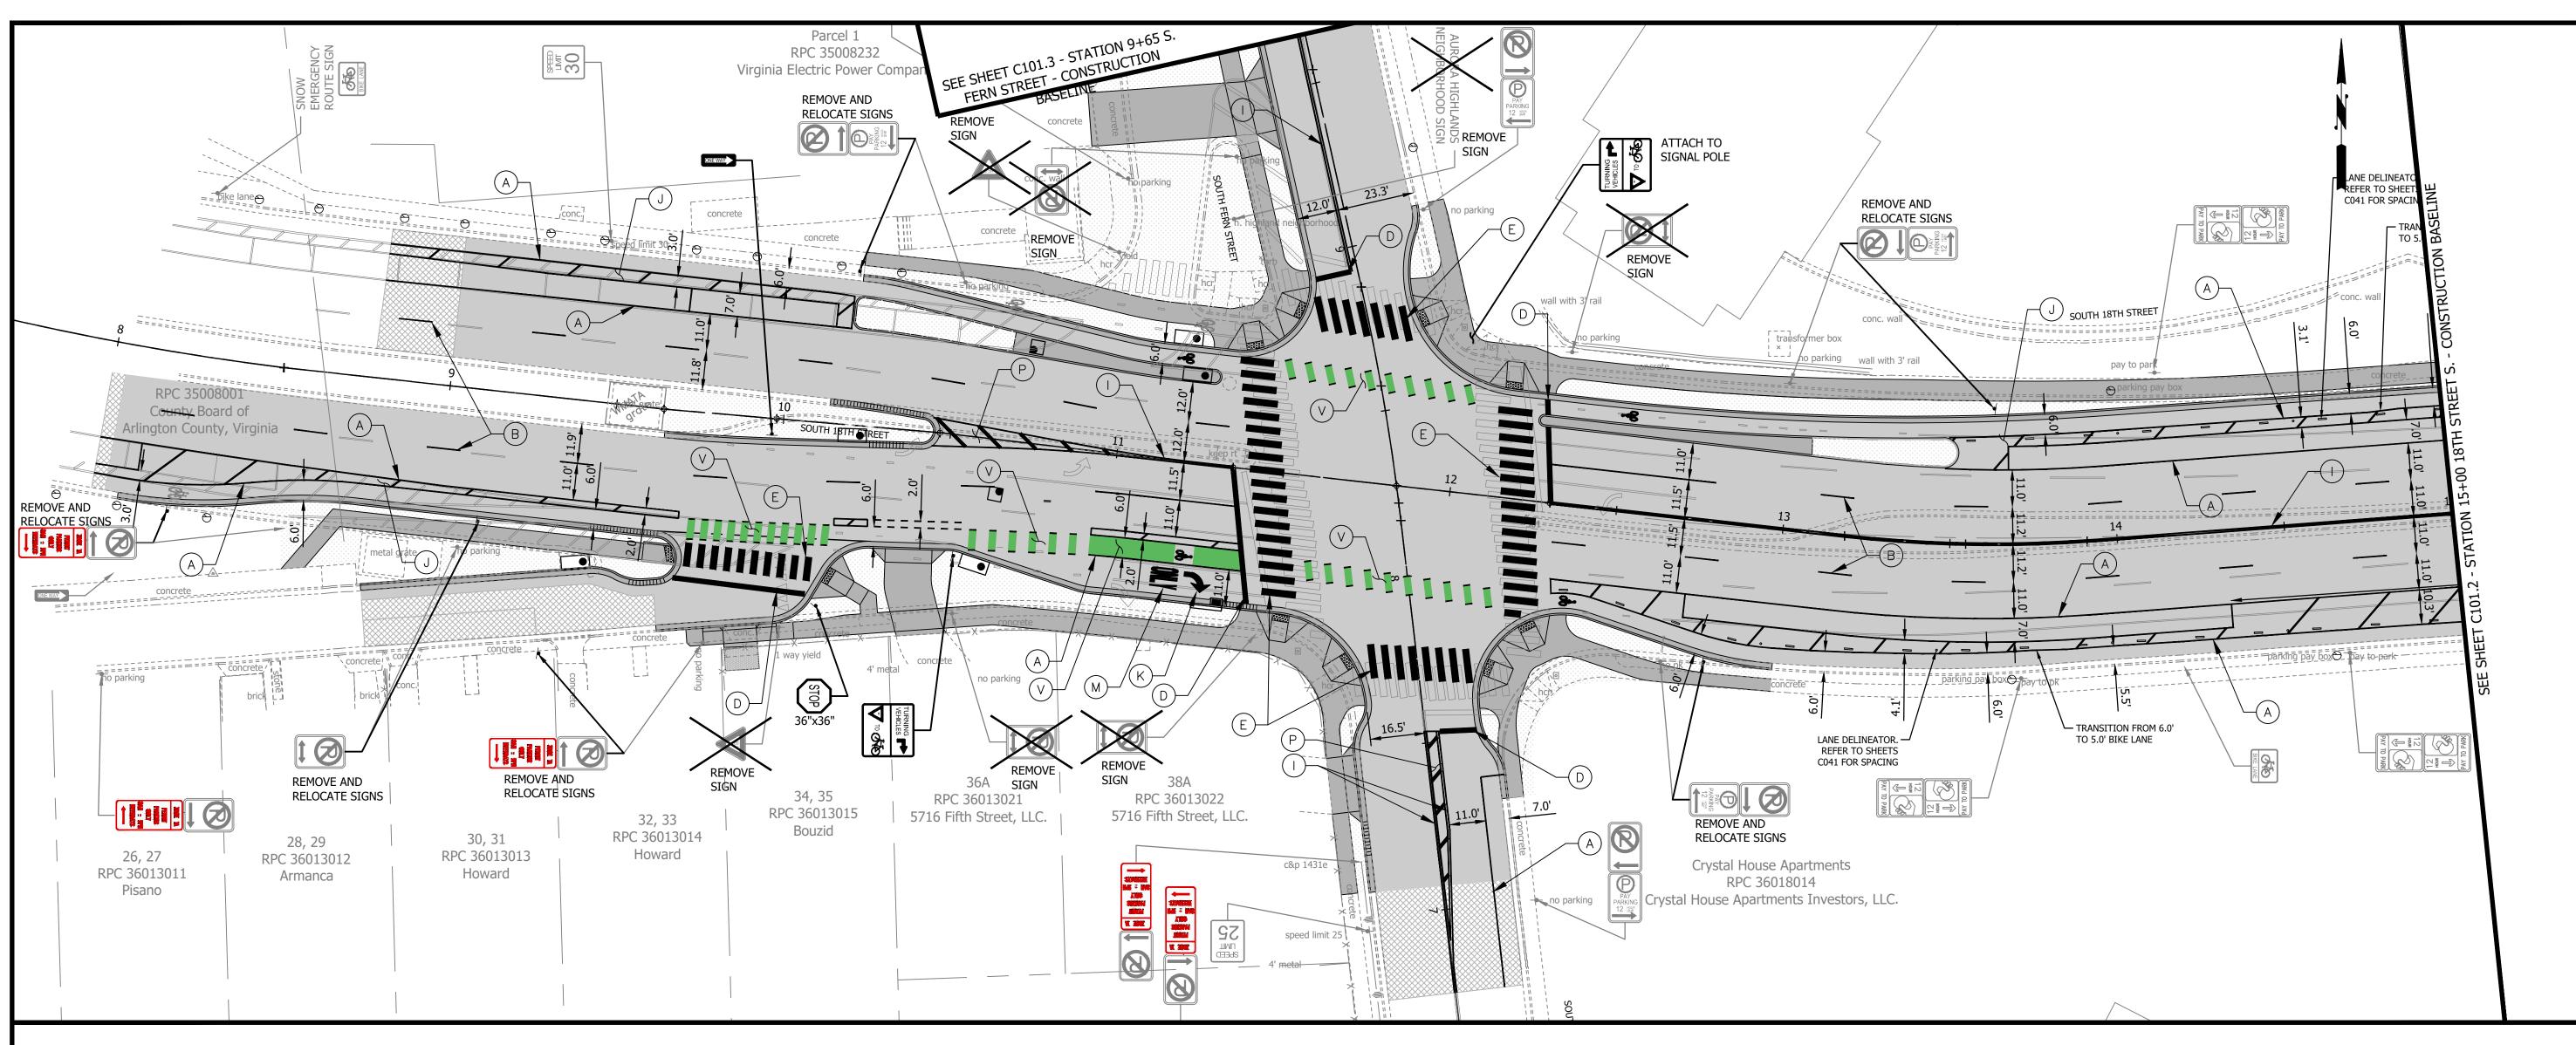

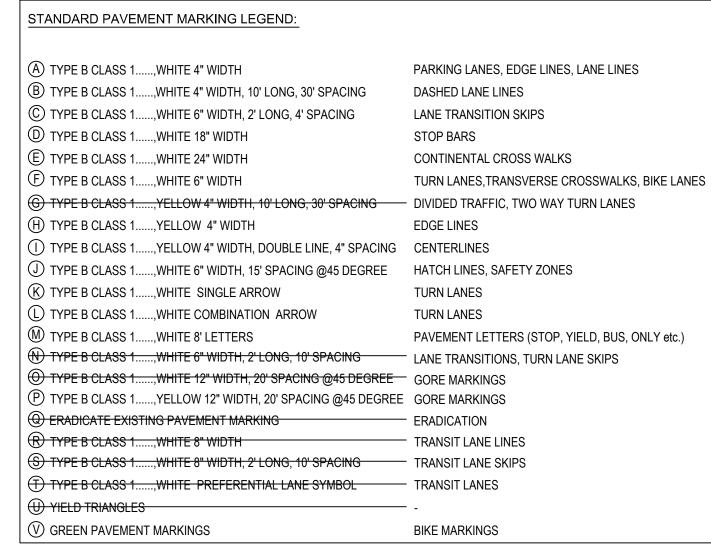





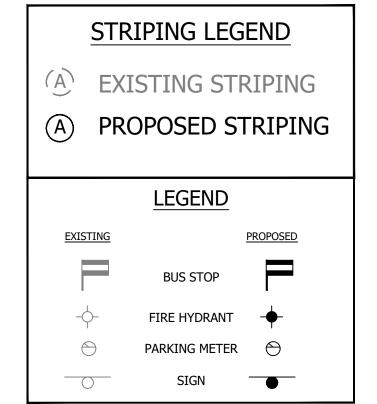

#### **SIGN AND PAVEMENT MARKING NOTES:**

- 1. STREET WIDTH MEASUREMENTS ARE FROM FACE OF CURB TO FACE OF CURB. LANES ARE MEASURED FROM CENTER OF MARKING TO CENTER OF MARKING.
- CONTACT DES-TRANSPORTATION ENGINEERING & OPERATIONS CONSTRUCTION MANAGEMENT SPECIALIST OR HIS
  DESIGNEE AT 703-228-6598 OR 571-437-1077 TO APPROVE MARKING LAYOUT 48 HOURS PRIOR TO INSTALLATION OF
  MARKINGS.
- 3. PAVEMENT MARKINGS TO BE IN ACCORDANCE WITH THE FOLLOWING AND ANY REVISIONS HERE TO:
  A. THE MANUAL ON UNIFORM TRAFFIC CONTROL DEVICES.
  B. ARLINGTON COUNTY MARKING STANDARDS.
- 4. ALL MARKINGS SHALL BE THERMOPLASTIC PER ARLINGTON COUNTY MARKING STANDARDS.
- 5. STOP BARS SHALL BE A MINIMUM OF 4' IN ADVANCE OF A MARKED CROSSWALK. IF THERE IS NO MARKED CROSSWALK, STOP BAR SHALL BE NO MORE THAN 30' FROM THE NEAREST EDGE OF THE INTERSECTED TRAVELED WAY.
- 6. CROSSWALKS SHALL BE 10' WIDE UNLESS OTHERWISE NOTED.
- 7. LEFT TURN ARROWS SHALL BE LOCATED 25' BACK FROM STOP BAR. FOR ADDITIONAL ARROWS FOLLOW COUNTY MARKING STANDARDS.
- 8. ON-STREET PARKING LANE IS 7' WIDE (UNLESS OTHERWISE NOTED) AND MARKED WITH 4" WIDE WHITE LINES. BEGINNING AND END OF PARKING SHALL BE MARKED WITH AN END LINE PERPENDICULAR TO CURB EXCEPT AT NUBS OR WHERE OTHERWISE INDICATED.
- 9. SHARED LANE MARKINGS SHALL BE PLACED IN CENTER OF LANE, 250' APART UNLESS OTHERWISE SPECIFIED.
- 10. BIKE LANE SYMBOLS TO BE PLACED 330' APART UNLESS OTHERWISE SPECIFIED.
- 11. EDGE LINES ARE ONLY REQUIRED WHERE SHOWN ON THE PLANS.
- 12. FOR DETAILS SEE ARLINGTON COUNTY PAVEMENT MARKING SPECIFICATION, DETAILS MK-1 TO MK-12

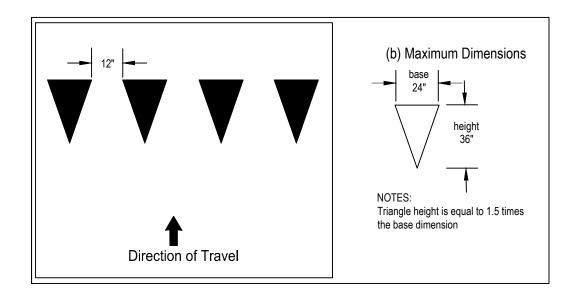

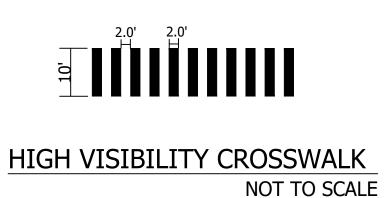

#### NOTES:

1. STRIPING FOR ON-STREET PARKING (ADJACENT TO MID-BLOCK ENTRANCES) IS SHOWN BASED ON GUIDANCE FROM ARLINGTON COUNTY TE&O. PER THE GUIDANCE, STRIPING IS SHOWN IN ORDER TO PROVIDE ADEQUATE STOPPING SIGHT DISTANCE PER THE AASHTO STANDARDS.

TRIPING AND SIGNAGE PLAN ROADWAY IMPROVEMENTS S FERN ST TO S EADS ST

ARLINGTON
VIRGINIA

DEPARTMENT OF ENVIRONMENTAL SERVICES

FACILITIES & ENGINEERING DIVISION ENGINEERING BUREAU 2100 CLARENDON BOULEVARD, SUITE 813 ARLINGTON, VA 22201 PHONE: 703.228.3629 FAX: 703.228.3606

COPYRIGHT © 2016 ARLINGTON COUNTY VIRGINIA - ALL RIGHTS RESERVED

QUALITY CONTROL ENGINEER 6.26.20

CONSTRUCTION MANAGEMENT SUPERVISOR

WATER, SEWER, STREETS BUREAU CHIEF Dennis M. Leach 6/24/20

Kamal N. Taktak

TRANSPORTATION DIRECTOR

Aciel Yang

PROJECT MANAGER

**REVISIONS** 

**APPROVALS** 

DESIGNED: NS
DRAWN: NS
CHECKED: TL

SOUTH


STREE

MISS UTILITY TRANSMITTAL #: XXXX


FILENAME:
CC20-280-SIGNAGE\_AND\_STRIPING.DWG
PATH: Q:\DATA\CC20\DESIGN\CAD\\_ACTIVE

PLOTTED: MARCH 1 2021 PLOTTED BY: NSHARP

SCALE:

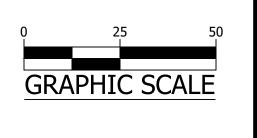

SHEET C101.1

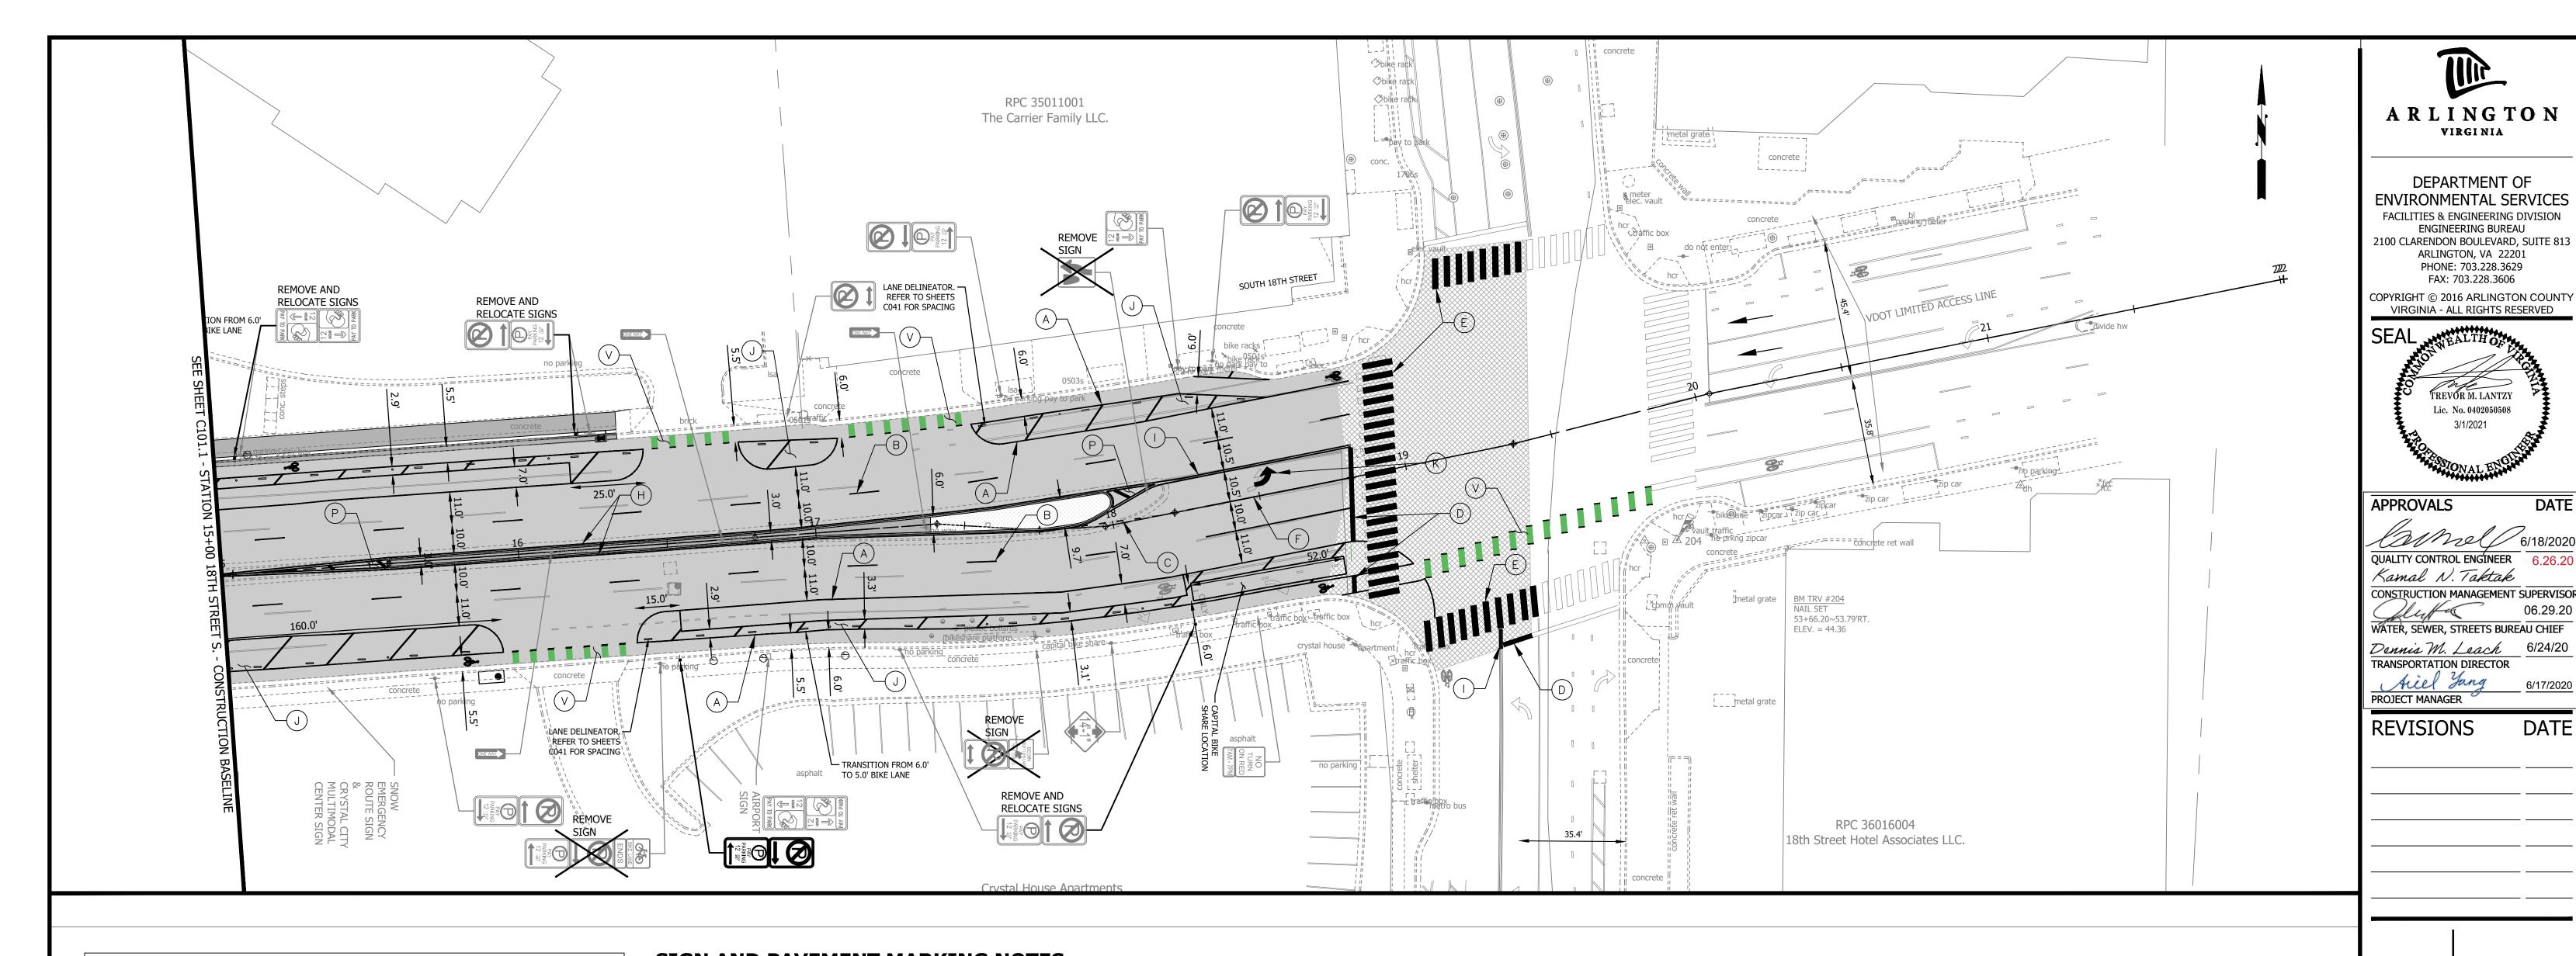



STRIPING FOR ON-STREET PARKING (ADJACENT TO MID-BLOCK ENTRANCES) IS SHOWN BASED ON GUIDANCE FROM ARLINGTON COUNTY TE&O. PER THE GUIDANCE, STRIPING IS SHOWN IN ORDER TO PROVIDE ADEQUATE STOPPING SIGHT DISTANCE PER THE AASHTO STANDARDS.

# :NTS ST IPROVEMENTO S EADS SIGNAGE AND ADWA FERN S 80/ | S

VIRGINIA

**ENGINEERING BUREAU** 

ARLINGTON, VA 22201 PHONE: 703.228.3629

FAX: 703.228.3606

DESIGNED: NS DRAWN: NS

SOUTH


STREE

CHECKED: TL MISS UTILITY TRANSMITTAL #: XXXX

FILENAME: CC20-280-SIGNAGE\_AND\_STRIPING.DWG PATH: Q:\DATA\CC20\DESIGN\CAD\\_ACTIVE

PLOTTED: MARCH 1 2021 PLOTTED BY:NSHARP


SCALE:

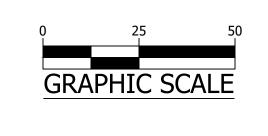


SHEET C101.2

#### **SIGN AND PAVEMENT MARKING NOTES:**

- 1. STREET WIDTH MEASUREMENTS ARE FROM FACE OF CURB TO FACE OF CURB. LANES ARE MEASURED FROM CENTER OF MARKING TO CENTER OF MARKING.
- 2. CONTACT DES-TRANSPORTATION ENGINEERING & OPERATIONS CONSTRUCTION MANAGEMENT SPECIALIST OR HIS DESIGNEE AT 703-228-6598 OR 571-437-1077 TO APPROVE MARKING LAYOUT 48 HOURS PRIOR TO INSTALLATION OF
- 3. PAVEMENT MARKINGS TO BE IN ACCORDANCE WITH THE FOLLOWING AND ANY REVISIONS HERE TO: THE MANUAL ON UNIFORM TRAFFIC CONTROL DEVICES. ARLINGTON COUNTY MARKING STANDARDS.
- 4. ALL MARKINGS SHALL BE THERMOPLASTIC PER ARLINGTON COUNTY MARKING STANDARDS.
- 5. STOP BARS SHALL BE A MINIMUM OF 4' IN ADVANCE OF A MARKED CROSSWALK. IF THERE IS NO MARKED CROSSWALK, STOP BAR SHALL BE NO MORE THAN 30' FROM THE NEAREST EDGE OF THE INTERSECTED TRAVELED
- 6. CROSSWALKS SHALL BE 10' WIDE UNLESS OTHERWISE NOTED.
- 7. LEFT TURN ARROWS SHALL BE LOCATED 25' BACK FROM STOP BAR. FOR ADDITIONAL ARROWS FOLLOW COUNTY
- 8. ON-STREET PARKING LANE IS 7' WIDE (UNLESS OTHERWISE NOTED) AND MARKED WITH 4" WIDE WHITE LINES. BEGINNING AND END OF PARKING SHALL BE MARKED WITH AN END LINE PERPENDICULAR TO CURB EXCEPT AT NUBS OR WHERE OTHERWISE INDICATED.
- 9. SHARED LANE MARKINGS SHALL BE PLACED IN CENTER OF LANE, 250' APART UNLESS OTHERWISE SPECIFIED.
- 10. BIKE LANE SYMBOLS TO BE PLACED 330' APART UNLESS OTHERWISE SPECIFIED.
- 11. EDGE LINES ARE ONLY REQUIRED WHERE SHOWN ON THE PLANS.
- 12. FOR DETAILS SEE ARLINGTON COUNTY PAVEMENT MARKING SPECIFICATION, DETAILS MK-1 TO MK-12

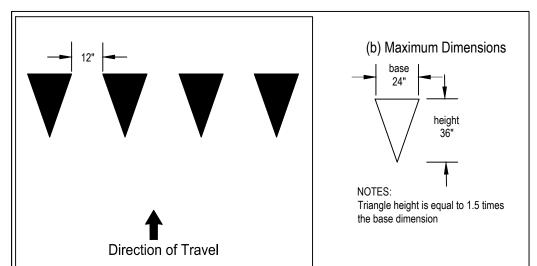

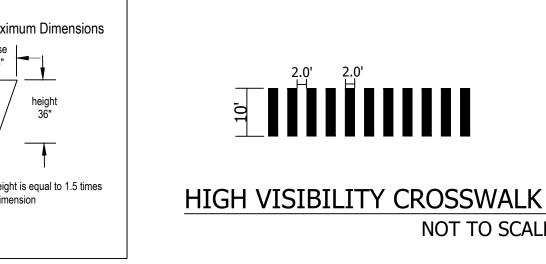

NOT TO SCALE

B TYPE B CLASS 1......,WHITE 4" WIDTH, 10' LONG, 30' SPACING DASHED LANE LINES © TYPE B CLASS 1.....,WHITE 6" WIDTH, 2' LONG, 4' SPACING LANE TRANSITION SKIPS TYPE B CLASS 1.....,WHITE 18" WIDTH STOP BARS E TYPE B CLASS 1.....,WHITE 24" WIDTH CONTINENTAL CROSS WALKS TYPE B CLASS 1.....,WHITE 6" WIDTH TURN LANES, TRANSVERSE CROSSWALKS, BIKE LANES (G) TYPE B CLASS 1....., YELLOW 4" WIDTH, 10' LONG, 30' SPACING DIVIDED TRAFFIC, TWO WAY TURN LANES

PARKING LANES, EDGE LINES, LANE LINES

PAVEMENT LETTERS (STOP, YIELD, BUS, ONLY etc.)

TURN LANES

TURN LANES

**BIKE MARKINGS** 

**EXISTING** 

STRIPING LEGEND

**EXISTING STRIPING** 

LEGEND

**BUS STOP** 

FIRE HYDRANT

PARKING METER

SIGN

PROPOSED STRIPING

PROPOSED

(H) TYPE B CLASS 1....., YELLOW 4" WIDTH EDGE LINES (I) TYPE B CLASS 1....., YELLOW 4" WIDTH, DOUBLE LINE, 4" SPACING CENTERLINES ① TYPE B CLASS 1.....,WHITE 6" WIDTH, 15' SPACING @45 DEGREE HATCH LINES, SAFETY ZONES

(K) TYPE B CLASS 1......WHITE SINGLE ARROW TYPE B CLASS 1....., WHITE COMBINATION ARROW M TYPE B CLASS 1.....,WHITE 8' LETTERS

(N) TYPE B CLASS 1.....,WHITE 6" WIDTH, 2' LONG, 10' SPACING LANE TRANSITIONS, TURN LANE SKIPS ① TYPE B CLASS 1.....,WHITE 12" WIDTH, 20' SPACING @45 DEGREE GORE MARKINGS P TYPE B CLASS 1....., YELLOW 12" WIDTH, 20' SPACING @45 DEGREE GORE MARKINGS ERADICATE EXISTING PAVEMENT MARKING R TYPE B CLASS 1.....,WHITE 8" WIDTH

(S) TYPE B CLASS 1.....,WHITE 8" WIDTH, 2' LONG, 10' SPACING TRANSIT LANE SKIPS (T) TYPE B CLASS 1....., WHITE PREFERENTIAL LANE SYMBOL TRANSIT LANES (U) YIELD TRIANGLES


W GREEN PAVEMENT MARKINGS


STANDARD PAVEMENT MARKING LEGEND:

(A) TYPE B CLASS 1.....,WHITE 4" WIDTH


**BIKE SYMBOL DETAIL** 

COPYRIGHT © 2016 ARLINGTON COUNTY VIRGINIA - ALL RIGHTS RESERVED

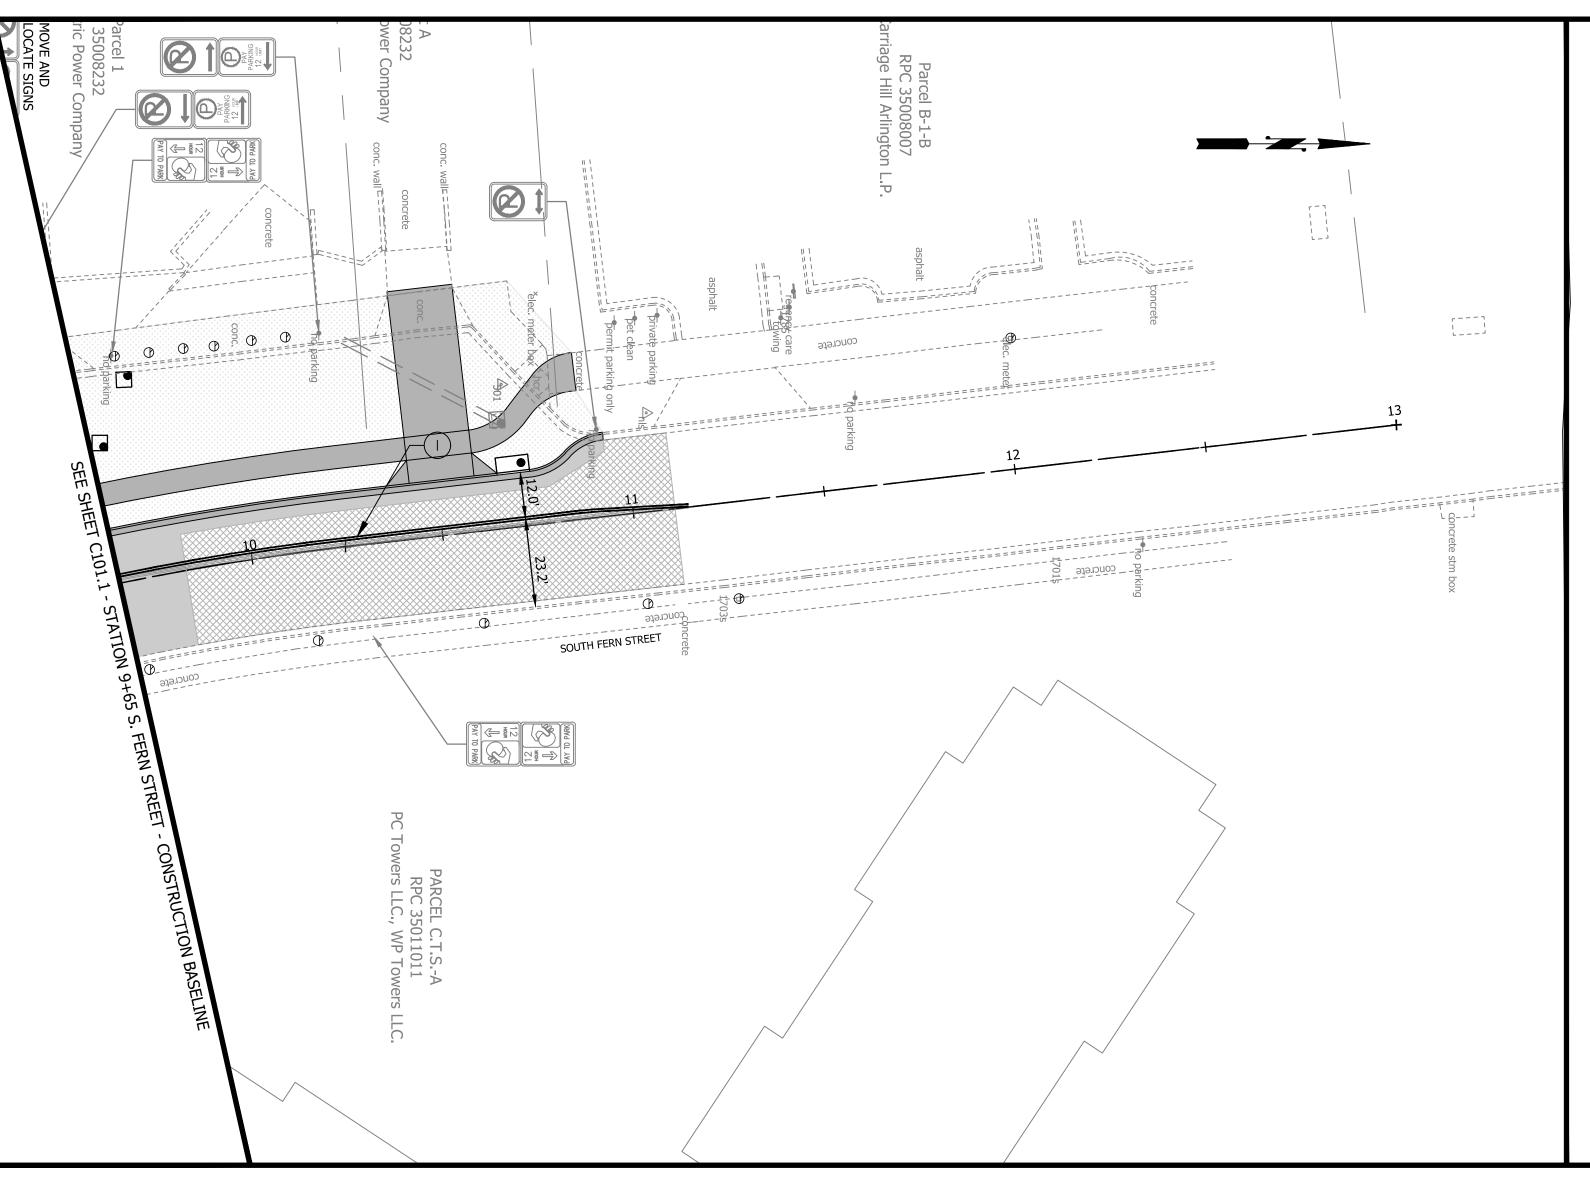

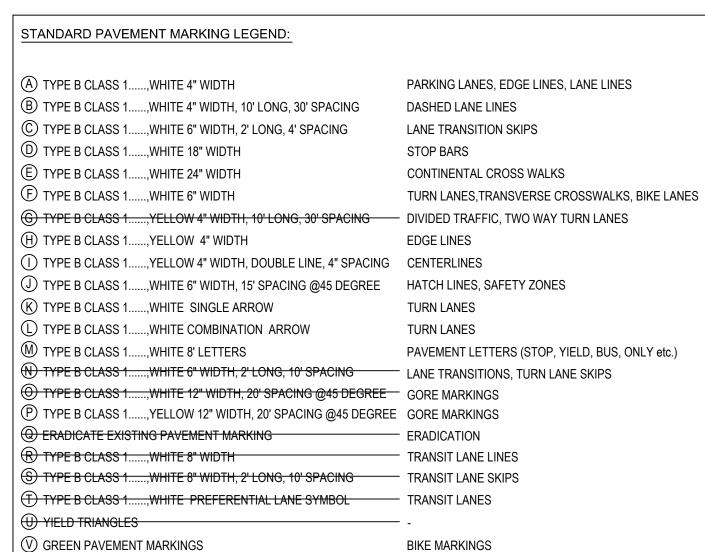





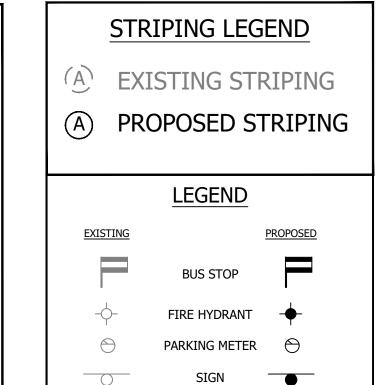

#### **SIGN AND PAVEMENT MARKING NOTES:**

- 1. STREET WIDTH MEASUREMENTS ARE FROM FACE OF CURB TO FACE OF CURB. LANES ARE MEASURED FROM CENTER OF MARKING TO CENTER OF MARKING.
- 2. CONTACT DES-TRANSPORTATION ENGINEERING & OPERATIONS CONSTRUCTION MANAGEMENT SPECIALIST OR HIS DESIGNEE AT 703-228-6598 OR 571-437-1077 TO APPROVE MARKING LAYOUT 48 HOURS PRIOR TO INSTALLATION OF MARKINGS.
- 3. PAVEMENT MARKINGS TO BE IN ACCORDANCE WITH THE FOLLOWING AND ANY REVISIONS HERE TO:
  A. THE MANUAL ON UNIFORM TRAFFIC CONTROL DEVICES.
  B. ARLINGTON COUNTY MARKING STANDARDS.
- 4. ALL MARKINGS SHALL BE THERMOPLASTIC PER ARLINGTON COUNTY MARKING STANDARDS.
- 5. STOP BARS SHALL BE A MINIMUM OF 4' IN ADVANCE OF A MARKED CROSSWALK. IF THERE IS NO MARKED CROSSWALK, STOP BAR SHALL BE NO MORE THAN 30' FROM THE NEAREST EDGE OF THE INTERSECTED TRAVELED WAY.
- 6. CROSSWALKS SHALL BE 10' WIDE UNLESS OTHERWISE NOTED.
- 7. LEFT TURN ARROWS SHALL BE LOCATED 25' BACK FROM STOP BAR. FOR ADDITIONAL ARROWS FOLLOW COUNTY MARKING STANDARDS.
- 8. ON-STREET PARKING LANE IS 7' WIDE (UNLESS OTHERWISE NOTED) AND MARKED WITH 4" WIDE WHITE LINES. BEGINNING AND END OF PARKING SHALL BE MARKED WITH AN END LINE PERPENDICULAR TO CURB EXCEPT AT NUBS OR WHERE OTHERWISE INDICATED.
- 9. SHARED LANE MARKINGS SHALL BE PLACED IN CENTER OF LANE, 250' APART UNLESS OTHERWISE SPECIFIED.
- 10. BIKE LANE SYMBOLS TO BE PLACED 330' APART UNLESS OTHERWISE SPECIFIED.
- 11. EDGE LINES ARE ONLY REQUIRED WHERE SHOWN ON THE PLANS.
- 12. FOR DETAILS SEE ARLINGTON COUNTY PAVEMENT MARKING SPECIFICATION, DETAILS MK-1 TO MK-12

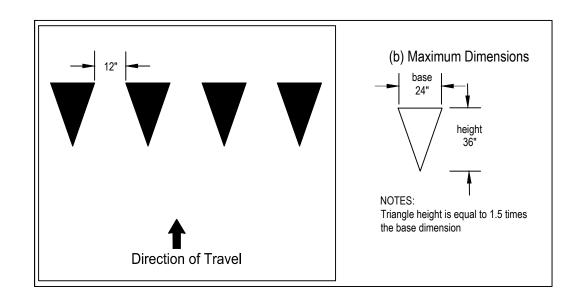

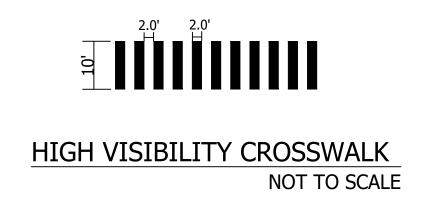

#### NOTES:

1. STRIPING FOR ON-STREET PARKING (ADJACENT TO MID-BLOCK ENTRANCES) IS SHOWN BASED ON GUIDANCE FROM ARLINGTON COUNTY TE&O. PER THE GUIDANCE, STRIPING IS SHOWN IN ORDER TO PROVIDE ADEQUATE STOPPING SIGHT DISTANCE PER THE AASHTO STANDARDS.

STREET SOUTH

APPROVALS

QUALITY CONTROL ENGINEER 6.26.20

CONSTRUCTION MANAGEMENT SUPERVISOR

WATER, SEWER, STREETS BUREAU CHIEF Dennis M. Leach 6/24/20

Kamal N. Taktak

TRANSPORTATION DIRECTOR
Aciel Yang

PROJECT MANAGER

**REVISIONS** 

ARLINGTON
VIRGINIA

DEPARTMENT OF
ENVIRONMENTAL SERVICES
FACILITIES & ENGINEERING DIVISION
ENGINEERING BUREAU
2100 CLARENDON BOULEVARD, SUITE 813
ARLINGTON, VA 22201
PHONE: 703.228.3629
FAX: 703.228.3606

COPYRIGHT © 2016 ARLINGTON COUNTY
VIRGINIA - ALL RIGHTS RESERVED

STRIPING AND SIGNAGE PLAR ROADWAY IMPROVEMENTS
S FERN ST TO S EADS ST


DESIGNED: NS
DRAWN: NS
CHECKED: TL

MISS UTILITY TRANSMITTAL #: XXXX


FILENAME:
CC20-280-SIGNAGE\_AND\_STRIPING.DWG
PATH: Q:\DATA\CC20\DESIGN\CAD\\_ACTIVE


PLOTTED: MARCH 1 2021 PLOTTED BY: NSHARP

SCALE:

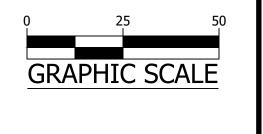

SHEET C101.3

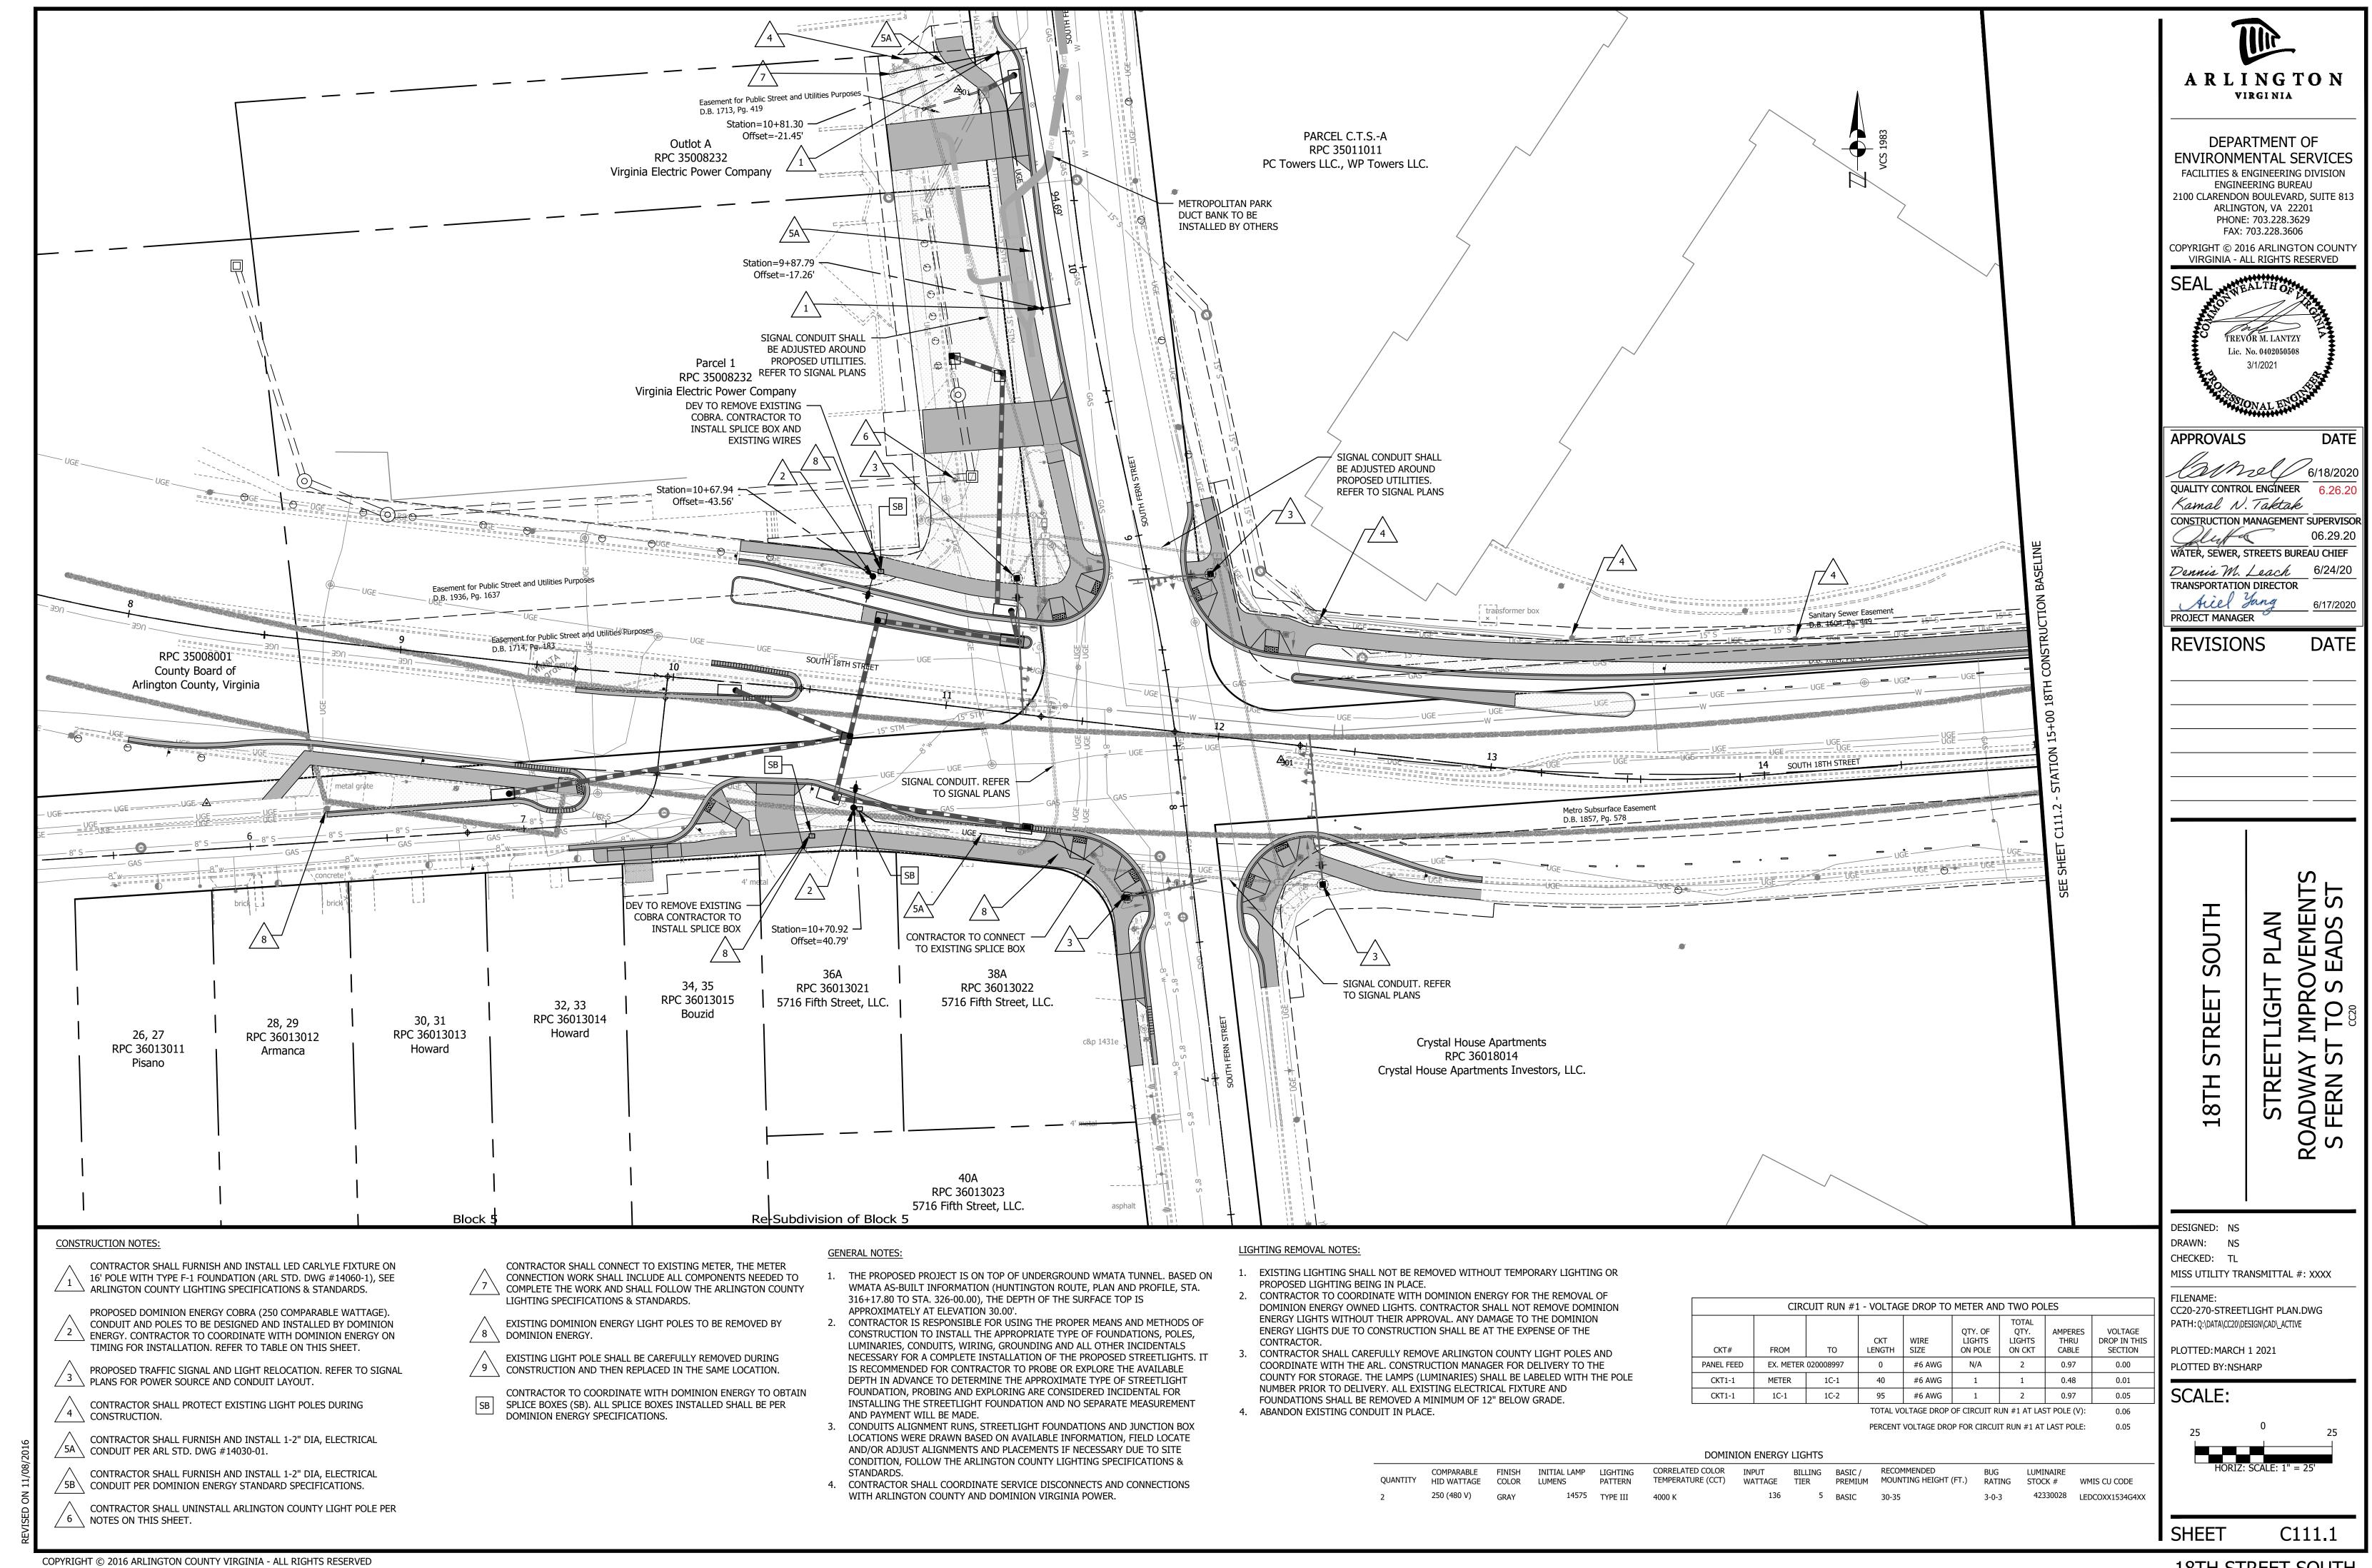

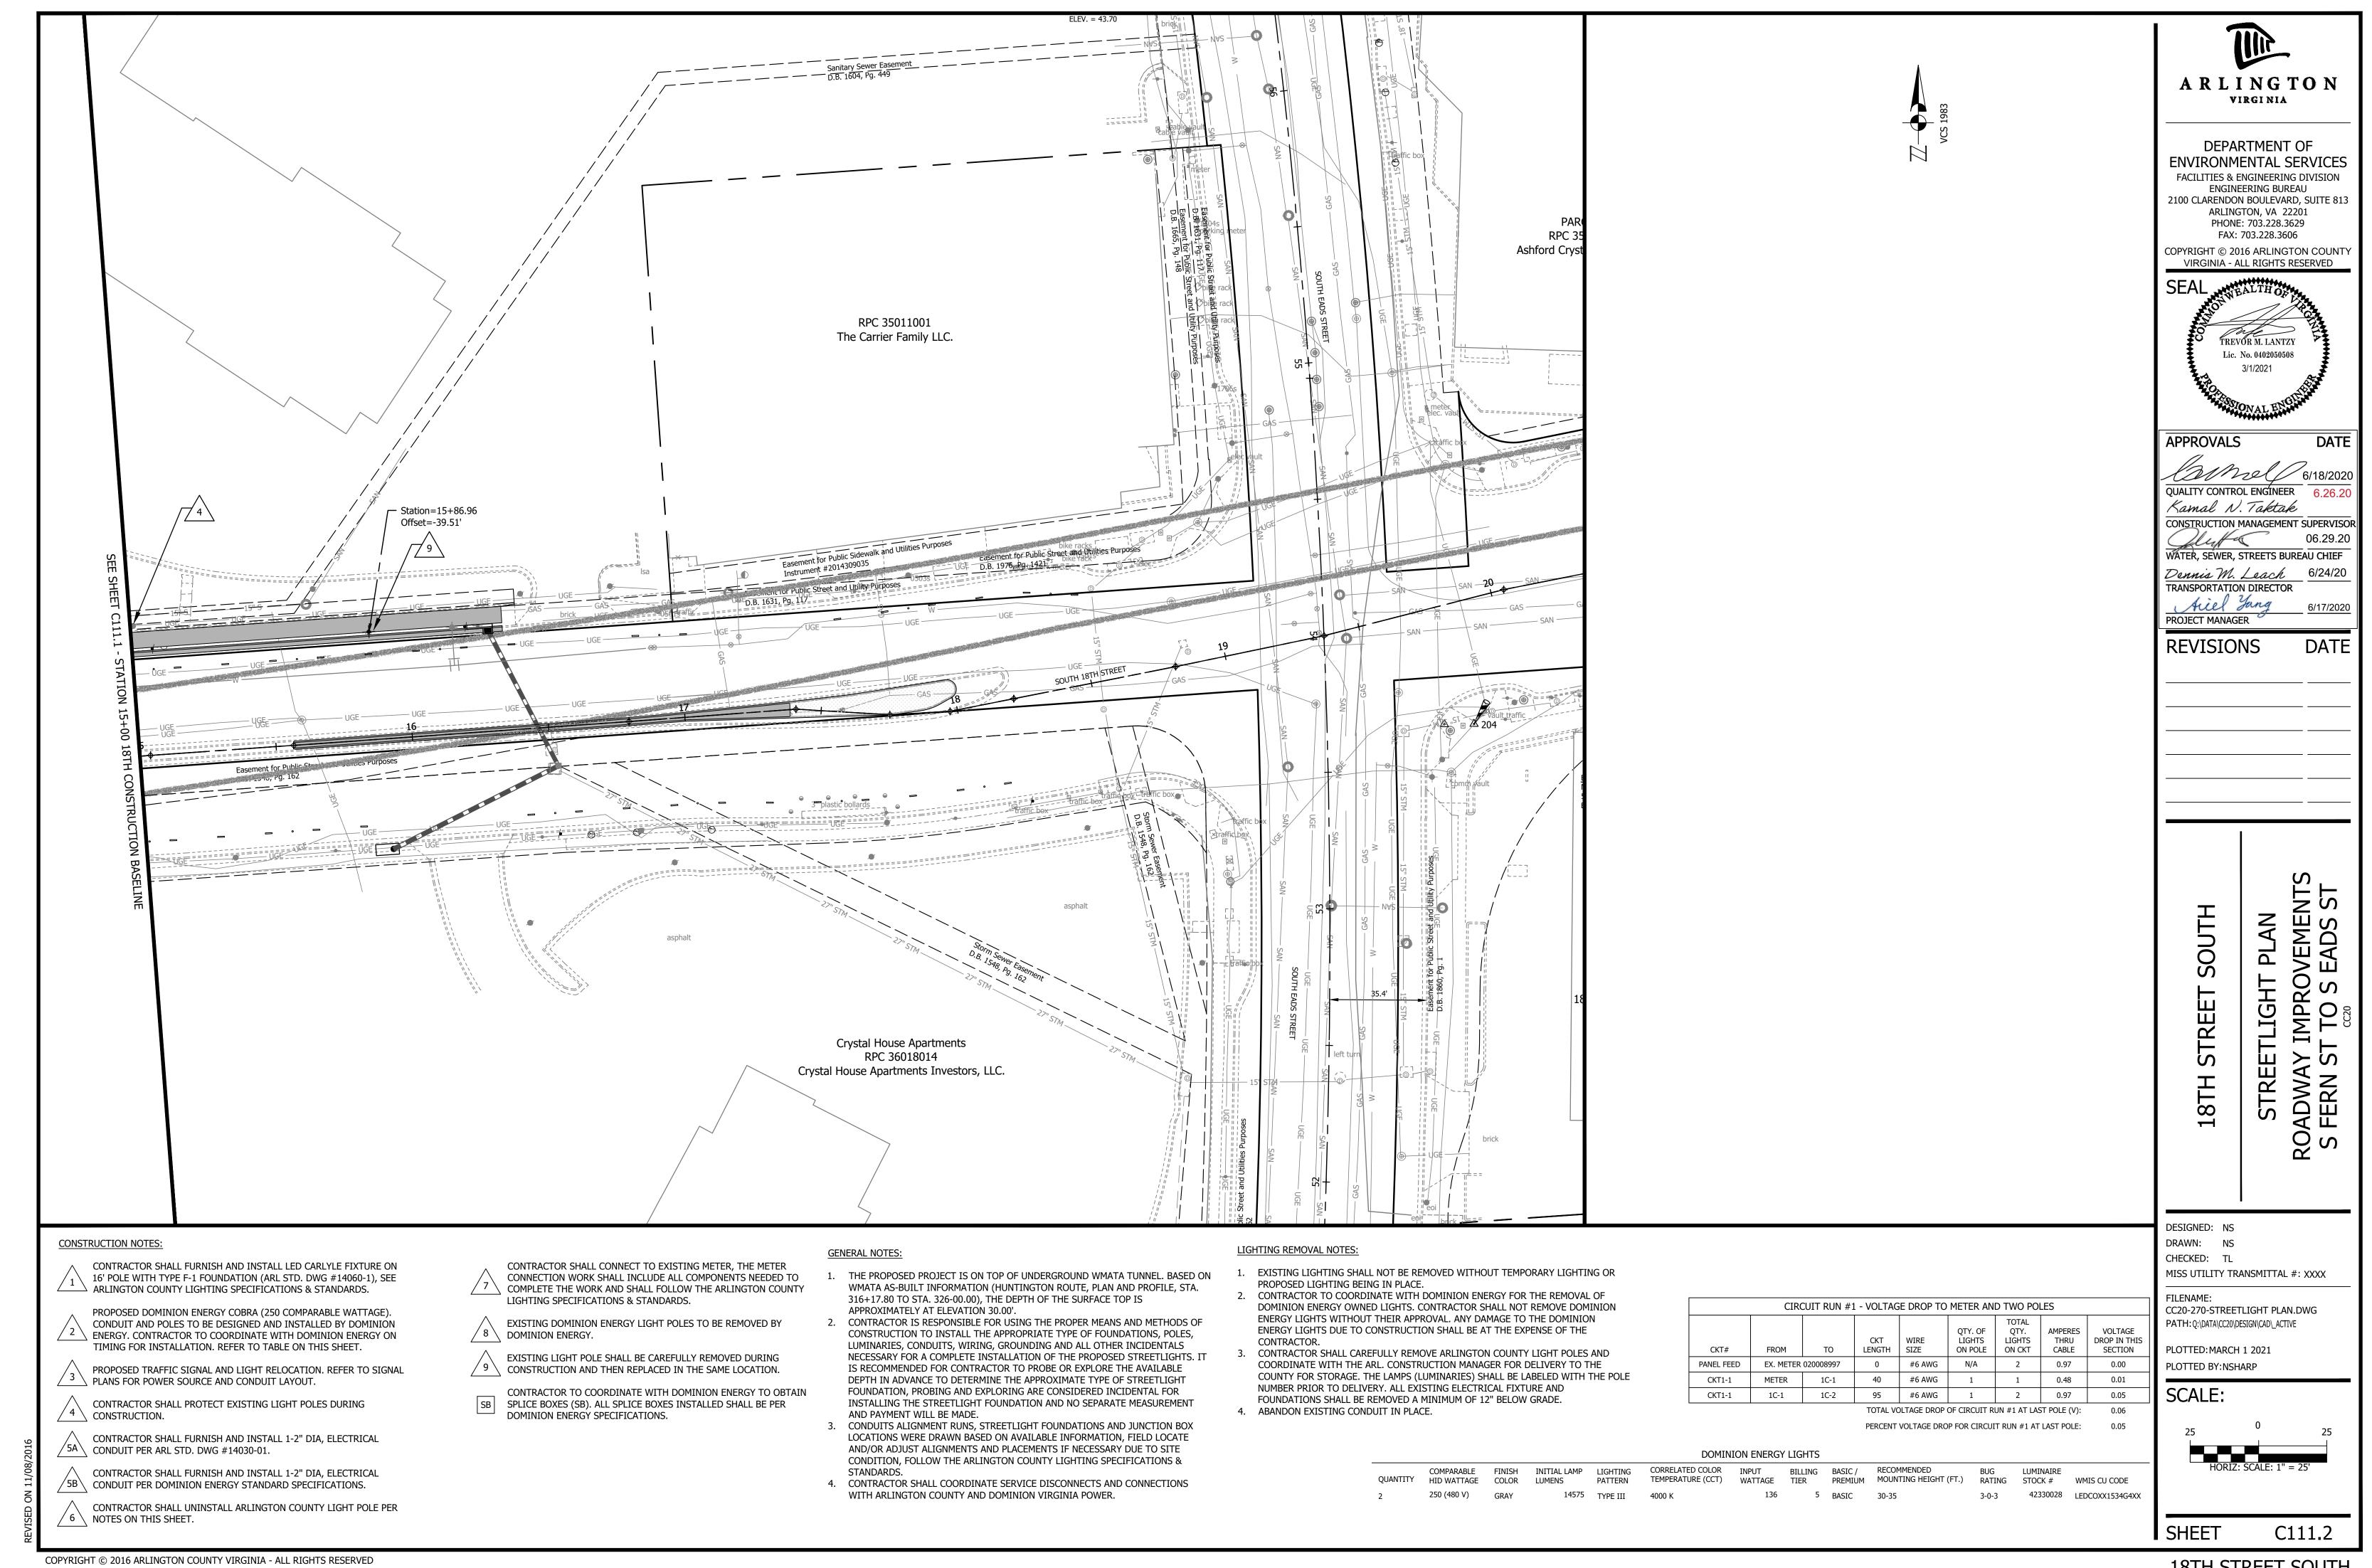

#### **CONSTRUCTION NOTES**

- FOR ALL ARTERIAL STREETS, PORTABLE VARIABLE MESSAGE SIGNS WITH CLOSURE INFORMATION MUST BE INSTALLED AHEAD OF THE PROJECT SITE AT EACH VEHICULAR APPROACH 3 WEEKS PRIOR TO STREET CLOSURE IN LOCATIONS DIRECTED BY THE PROJECT OFFICER.
- CONTRACTOR SHALL REMOVE EXISTING PAVEMENT MARKINGS IN CONFLICT WITH TEMPORARY PAVEMENT MARKINGS.
- CONTACT TRANSPORTATION ENGINEERING OPERATIONS AT 703-228-6598 OR 571-437-1077 AND THE PROJECT OFFICER TO APPROVE MARKING LAYOUT 48 HOURS PRIOR TO INSTALLATION OF MARKINGS.
- 4. ONE LANE CLOSURE IN EACH DIRECTION OF TRAFFIC WILL BE PERMITTED FOR FINAL PAVEMENT OVERLAY.
- 5. DURING CONSTRUCTION, THE CONTRACTOR SHALL MAINTAIN THE FLOW OF TRAFFIC ON ANY INTERSECTION WITHIN THE WORK AREA.
- THE CONTRACTOR SHALL NOTIFY ARLINGTON COUNTY PUBLIC SCHOOLS TWO WEEKS PRIOR TO STARTING CONSTRUCTION.
- THE CONTRACTOR SHALL SUBMIT ANY REQUESTS FOR TEMPORARY "NO PARKING" RESTRICTIONS TO THE PROJECT OFFICER AT LEAST 3 WORKING DAYS PRIOR TO THE DESIRED ONSET OF RESTRICTIONS. PRIOR TO A REQUEST FOR THE REMOVAL OF ACCESS TO ANY ADA PARKING SPACE THE CONTRACTOR MUST HAVE MADE PROVISION FOR ALTERNATIVE ADA PARKING AS INDICATED ON THE APPROVED PLAN OR AS DIRECTED BY THE PROJECT OFFICER
- WHEN THE APPROVED PLAN CALLS FOR THE REMOVAL OF ANY PARKING METER, THE CONTRACTOR MUST MAKE A REQUEST TO THE PROJECT OFFICER AT LEAST ONE WEEK IN ADVANCE OF THE DESIRED REMOVAL. THE PROJECT OFFICER WILL THEN COORDINATE THE PARKING METER REMOVAL WITH TRAFFIC ENGINEERING AND OPERATIONS.
- 9. ALL TEMPORARY BUS TRAVEL LANES TO BE A MINIMUM OF 11 FEET WIDE.

#### **MOT NOTES:**

- PARKING SHALL BE RESTRICTED BY THE COUNTY AS PART OF THE RIGHT OF WAY PERMIT. CONTACT DES-PERMITTING SECTION, 703-228-4798, AT LEAST 72 HOURS PRIOR TO COMMENCEMENT OF WORK.
- COORDINATE WITH DES-TRANSIT BUREAU AT 703-228-3049, AT LEAST 4 WEEKS PRIOR TO COMMENCEMENT OF WORK, IF TRANSIT IS AFFECTED OR IF THERE ARE ANY IMPACTS TO TRANSIT STOPS OR ROUTES. NOTE: ALL TEMPORARY AND FINAL BUS TRAVEL LANES MUST BE MINIMUM 11' WIDE.
- THE CONTRACTOR SHALL MAINTAIN ADA ACCESSIBLE PARKING SPACES AT ALL TIMES DURING CONSTRUCTION. THE CONTRACTOR SHALL CONTACT DES - PERMITING, 703-228-4798, TO COORDINATE RELOCATION OF EXISTING ADA ACCESSIBLE PARKING SPACES OR TO INSTALL TEMPORARY SIGNAGE OUT OF AND ADJACENT TO THE WORK ZONE AS CONSTRUCTION PROGRESSES. MULTIPLE RELOCATIONS MAY BE NECESSARY DURING EACH PHASE.
- 4. NO WORK OR STORAGE SHALL BE CONDUCTED IN THE BUFFER AND TAPER AREAS.
- ALL PROJECT SIGNAGE AND TEMPORARY STRIPING SHALL FOLLOW TTC-53.0 AND TTC-60.0 OF THE VIRGINIA WORK AREA PROTECTION MANUAL (LATEST EDITION).

#### **PEDESTRIAN NOTE:**

- PEDESTRIANS SHALL BE APPROPRIATELY DIRECTED WITH ADVANCED WARNING SIGNS PLACED AT INTERSECTIONS, TO CROSS TO THE OPPOSITE SIDE OF THE ROADWAY IN ORDER TO PREVENT CONFLICT WITH MIDBLOCK WORK SITES.
- A SAFE PEDESTRIAN PATH MUST BE MAINTAINED AROUND THE EXISTING AND PROPOSED TRAFFIC SIGNALS DURING CONSTRUCTION. IF A PEDESTRIAN PATH CAN NOT BE MAINTAINED DURING CONSTRUCTION, THE CONTRACTOR SHALL CONTACT THE PROJECT OFFICER FOR APPROVAL ON AN ALTERATIVE PATH. ADDITIONAL MOT MIGHT BE REQUIRED.

#### **MOT WARNING SIGNAGE:**

ROAD WORK AHEAD (W20-1) AND END ROAD WORK (G20-2) SIGNAGE SHALL BE PLACED AT THE AT THE BEGINNING AND END OF THE TOTAL PROJECT AREA. THESE SIGNS SHALL NOT BE REMOVED UNTIL THE CONSTRUCTION IS FINALIZED AND ALL MOT SIGNAGE MAY BE TAKEN





- 2. IF W20-1 AND G20-2 SIGNS NEED TO BE RELOCATED FOR ANY REASON, APPROVAL BY THE PROJECT OFFICER IS REQUIRED.
- 3. REFER TO SHEET C121.2 FOR W20-1 AND G20-2 SIGN PLACEMENT, PLACEMENTS OF SIGNS SHALL BE AT THE EXTENTS OF THE PROJECT AREA

#### **LEGEND**

WORK ZONE AREAS



BUFFER AND TAPER AREAS

PEDESTRIAN PATH




LONGITUDINAL CHANNELIZING DEVICES (JERSEY BARRIER)



FLAGGER



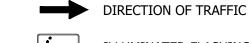


ILLUMINATED FLASHING ARROW BOARD

ARLINGTON VIRGINIA

DEPARTMENT OF ENVIRONMENTAL SERVICES FACILITIES & ENGINEERING DIVISION ENGINEERING BUREAU 2100 CLARENDON BOULEVARD, SUITE 813 ARLINGTON, VA 22201 PHONE: 703.228.3629

FAX: 703.228.3606

COPYRIGHT © 2016 ARLINGTON COUNTY VIRGINIA - ALL RIGHTS RESERVED

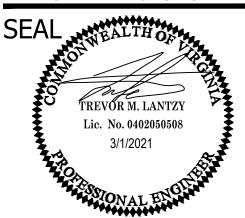

**APPROVALS** QUALITY CONTROL ENGINEER 6.26.20 Kamal N. Taktak

CONSTRUCTION MANAGEMENT SUPERVISOR WATER, SEWER, STREETS BUREAU CHIEF

Dennis M. Leach 6/24/20 TRANSPORTATION DIRECTOR Aciel Yang PROJECT MANAGER

**REVISIONS** 

IMPROVEMENTS
- TO S EADS ST PLAN NO SOUTH


ROADWA S FERN OF

DESIGNED: NS CHECKED: TL MISS UTILITY TRANSMITTAL #: XXXX


FILENAME: CC20-286-MOT-LEGEND\_NOTES.DWG PATH: Q:\DATA\CC20\DESIGN\CAD\\_ACTIVE

PLOTTED: MARCH 1 2021 PLOTTED BY:NSHARP

SCALE:

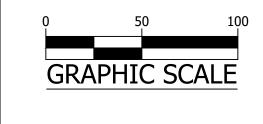

SHEET

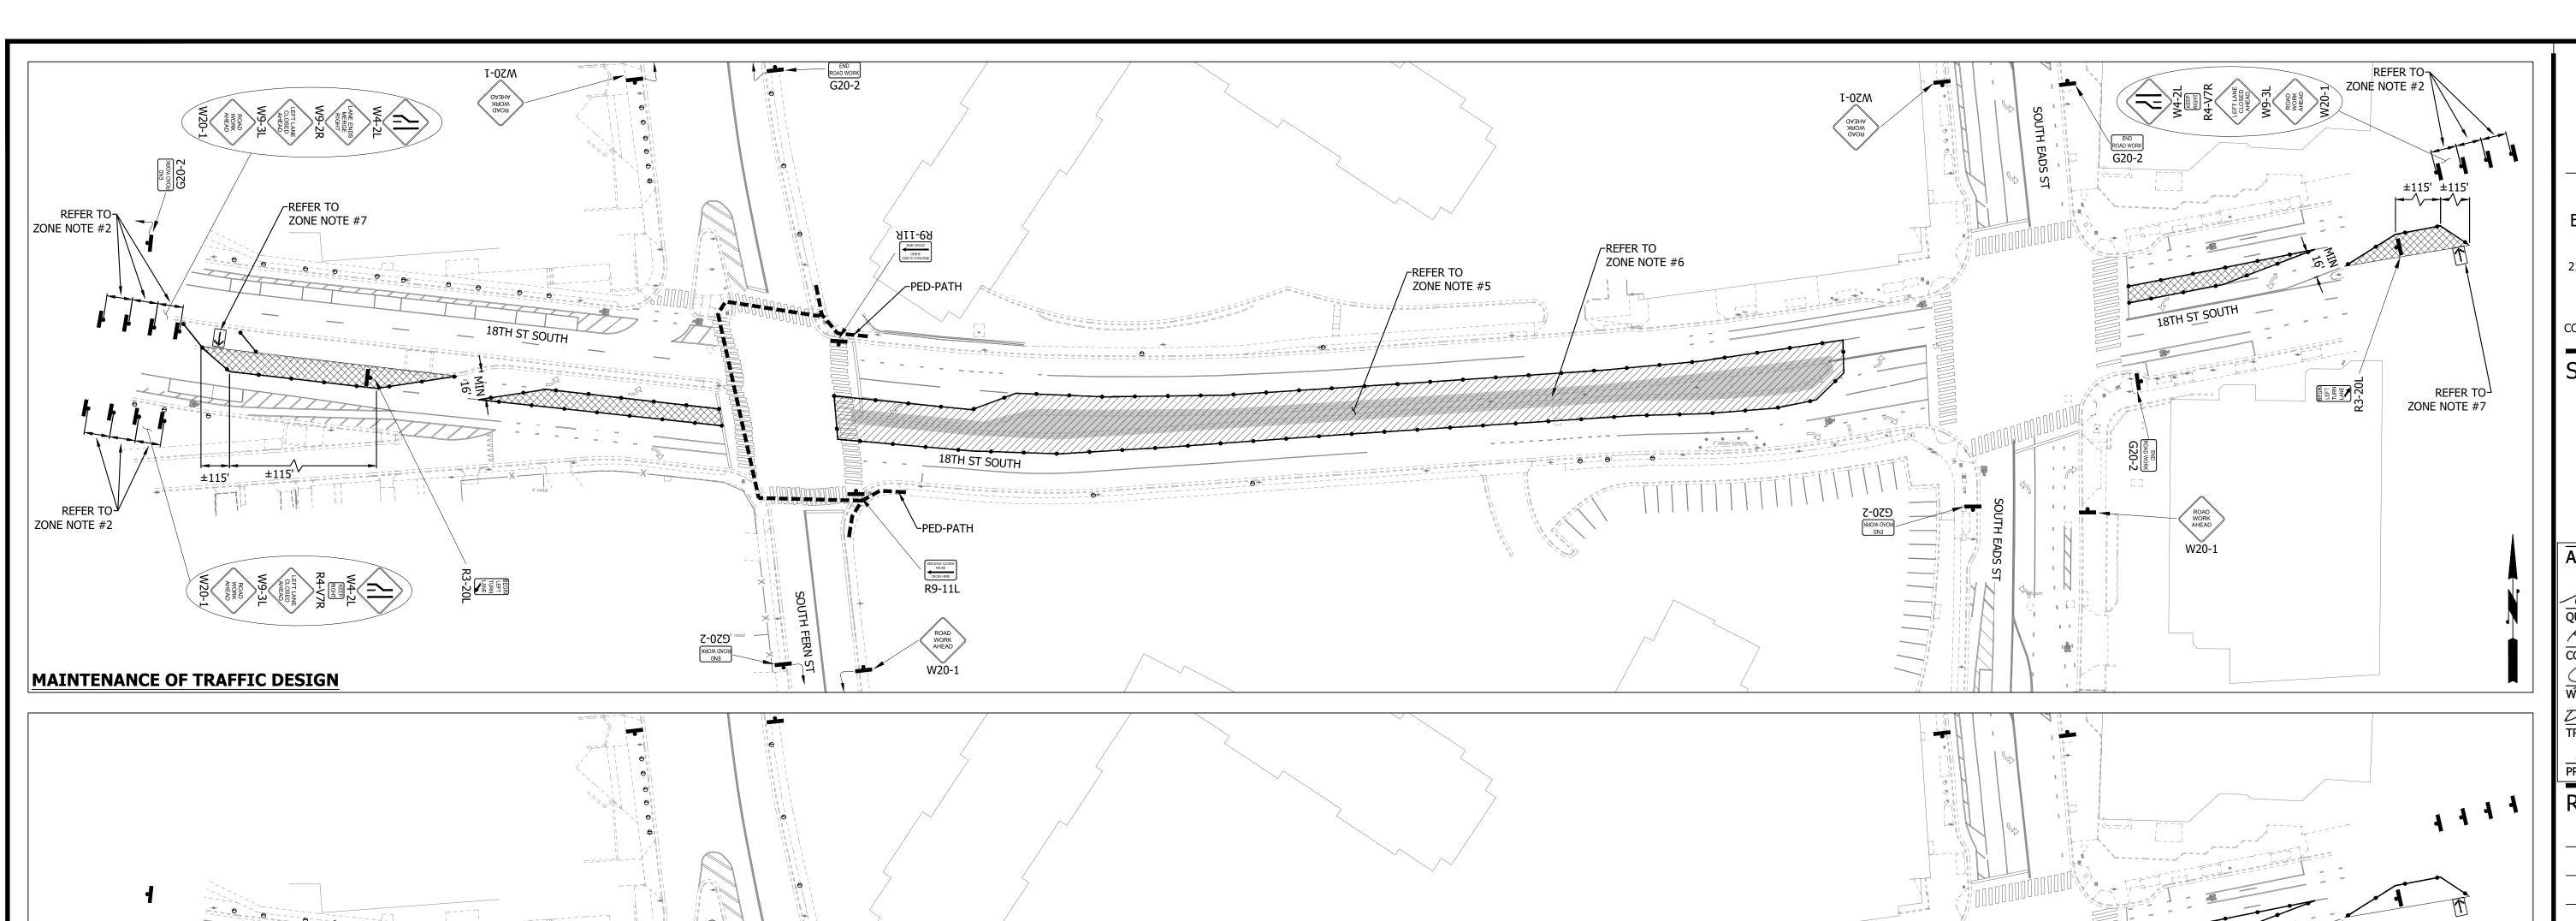


└4" YELLOW CONSTRUCTION
PAVEMENT MARKINGS PAVEMENT MARKINGS **TEMPORARY STRIPING DESIGN** 

	MOT ZONE TABLE:								
	MOT ZONE#	TTC#		COMMENTS	DURATION	WORK			
	MOT ZONE#	VEHICULAR	PEDESTRIAN	COMMINITY	DURATION	HOURS			
		TTC-27.2	TTC-36.2 *	REMOVE EXISTING MEDIAN AND REPAVE WITH TEMP. ASPHALT. RAISING EXISTING STORM SEWER INFRASTRUCTURE.					
	ZONE# 01			CONTRACTOR TO PULL BACK CHANNELING DEVICES AT THE END OF THE WORK DAY AND REOPEN CLOSED LANES.	2 WEEKS - 1 MONTH	MONFRI. 9:00AM-4:00PM			
				SHADOW VEHICLES SHALL BE UTILIZED AS SHOWN IN THE TTC					

#### **ZONE NOTES:**

- 1. SPEED REDUCTION: CONTRACTOR SHALL PLACE W3-5A SIGN, WITH SPEED LIMIT OF 25 MPH, ON ALL APPROACHES FOR 18TH STREET.
- WARNING SIGN SPACING: MINIMUM 100' SPACING BETWEEN WARNING SIGNS UNLESS OTHERWISE DIRECTED BY THE CONSTRUCTION MANAGER AND TE&O.
- 3. TEMPORARY STRIPING: MAINTAIN ALL EXISTING DIRECTIONAL ARROWS. IF DIRECTIONAL ARROW GETS
- 4. OPTIONAL TTC'S: REQUIRES APPROVAL BY THE PROJECT OFFICER PRIOR TO IMPLEMENTATION 42.2 INTERIOR LANE CLOSURE OPERATIONS ON A MULTI-LANE ROADWAY
- -FIRST CHANNELING DEVICE SHALL BE PLACED GREATER THAN 50' FROM AN INTERSECTION 5. INSTALL A DRIVABLE TEMPORARY PAVEMENT SURFACE THAT SHALL BE PLACED WHERE THE EXISTING
- MEDIAN WAS REMOVED.
- ADJUST STORM STRUCTURE TOP TO BE LEVEL WITH THE TEMPORARY PAVEMENT.
- 7. ILLUMINATED FLASHING ARROW BOARDS SHALL BE PLACED IN THE EXISTING MEDIANS.
- \* PEDESTRIAN ACCESS SHALL BE MAINTAINED AS SHOWN ON THIS SHEET, UTILIZING THE REFERENCED TTC IN THE ABOVE TABLE

AT THE END OF EACH WORKING DAY, THE CONTRACTOR SHALL PULL BACK **MOT CHANNELIZING DEVICES TO MAINTAIN TWO TRAVEL LANES IN EACH DIRECTION ON 18TH STREET.** 

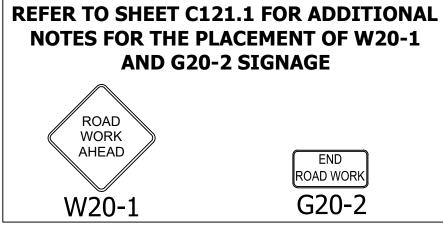

SCALE: **GRAPHIC SCALE** 

COPYRIGHT © 2016 ARLINGTON COUNTY VIRGINIA - ALL RIGHTS RESERVED


**18TH STREET SOUTH** 

ARLINGTON VIRGINIA

DEPARTMENT OF **ENVIRONMENTAL SERVICES FACILITIES & ENGINEERING DIVISION** ENGINEERING BUREAU 2100 CLARENDON BOULEVARD, SUITE 813 ARLINGTON, VA 22201

PHONE: 703.228.3629

FAX: 703.228.3606 COPYRIGHT © 2016 ARLINGTON COUNT

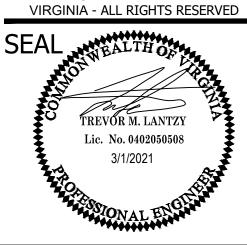

APPROVALS

QUALITY CONTROL ENGINEER 6.26.20 Kamal N. Taktak

WATER, SEWER, STREETS BUREAU CHIEF Dennis M. Leach 6/24/20

TRANSPORTATION DIRECTOR PROJECT MANAGER

REVISIONS

DESIGNED: NS CHECKED: TL MISS UTILITY TRANSMITTAL #: XXXX


FILENAME: CC20-286-MOT - ZONE 01.DWG


PATH: Q:\DATA\CC20\DESIGN\CAD\\_ACTIVE

PLOTTED: MARCH 1 2021 PLOTTED BY:NSHARP

C121.2

SHEET

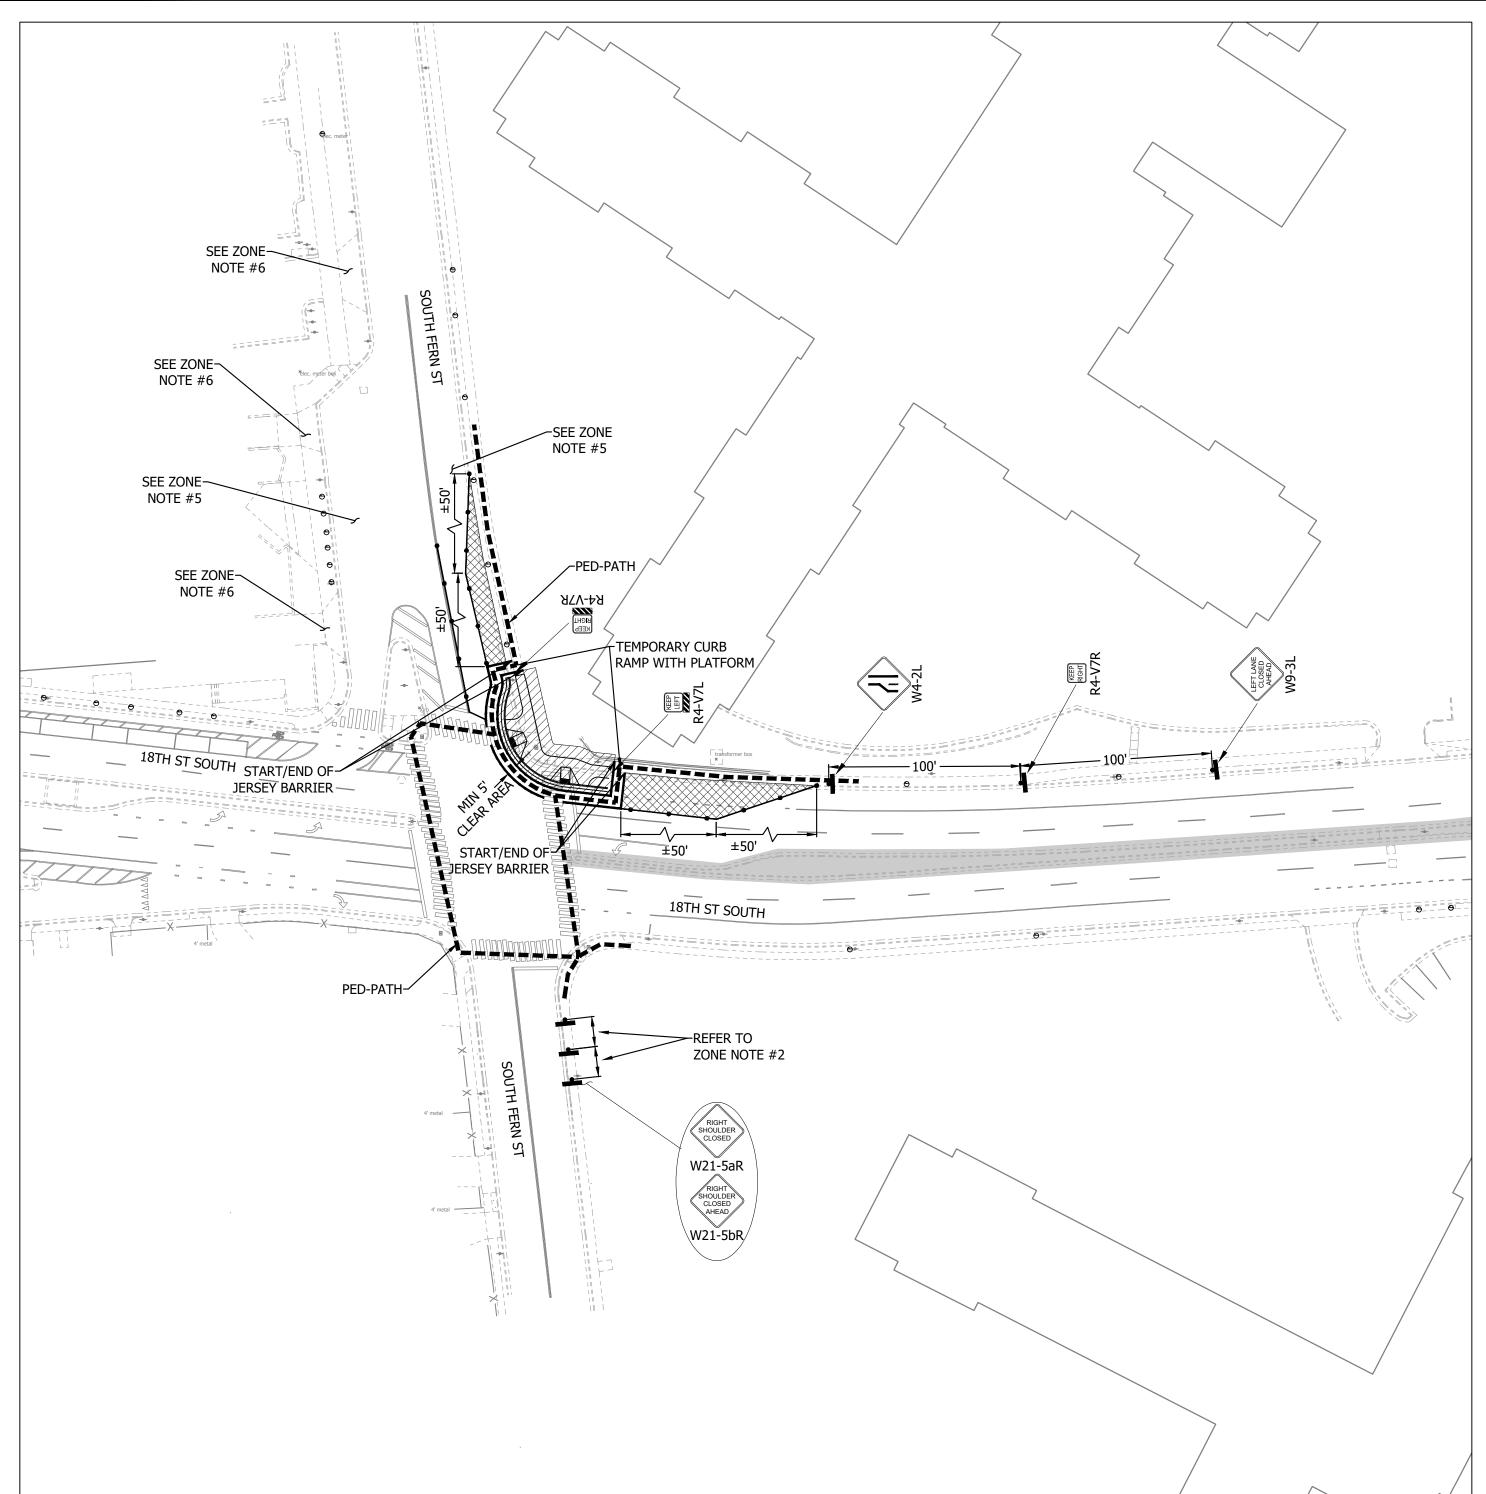

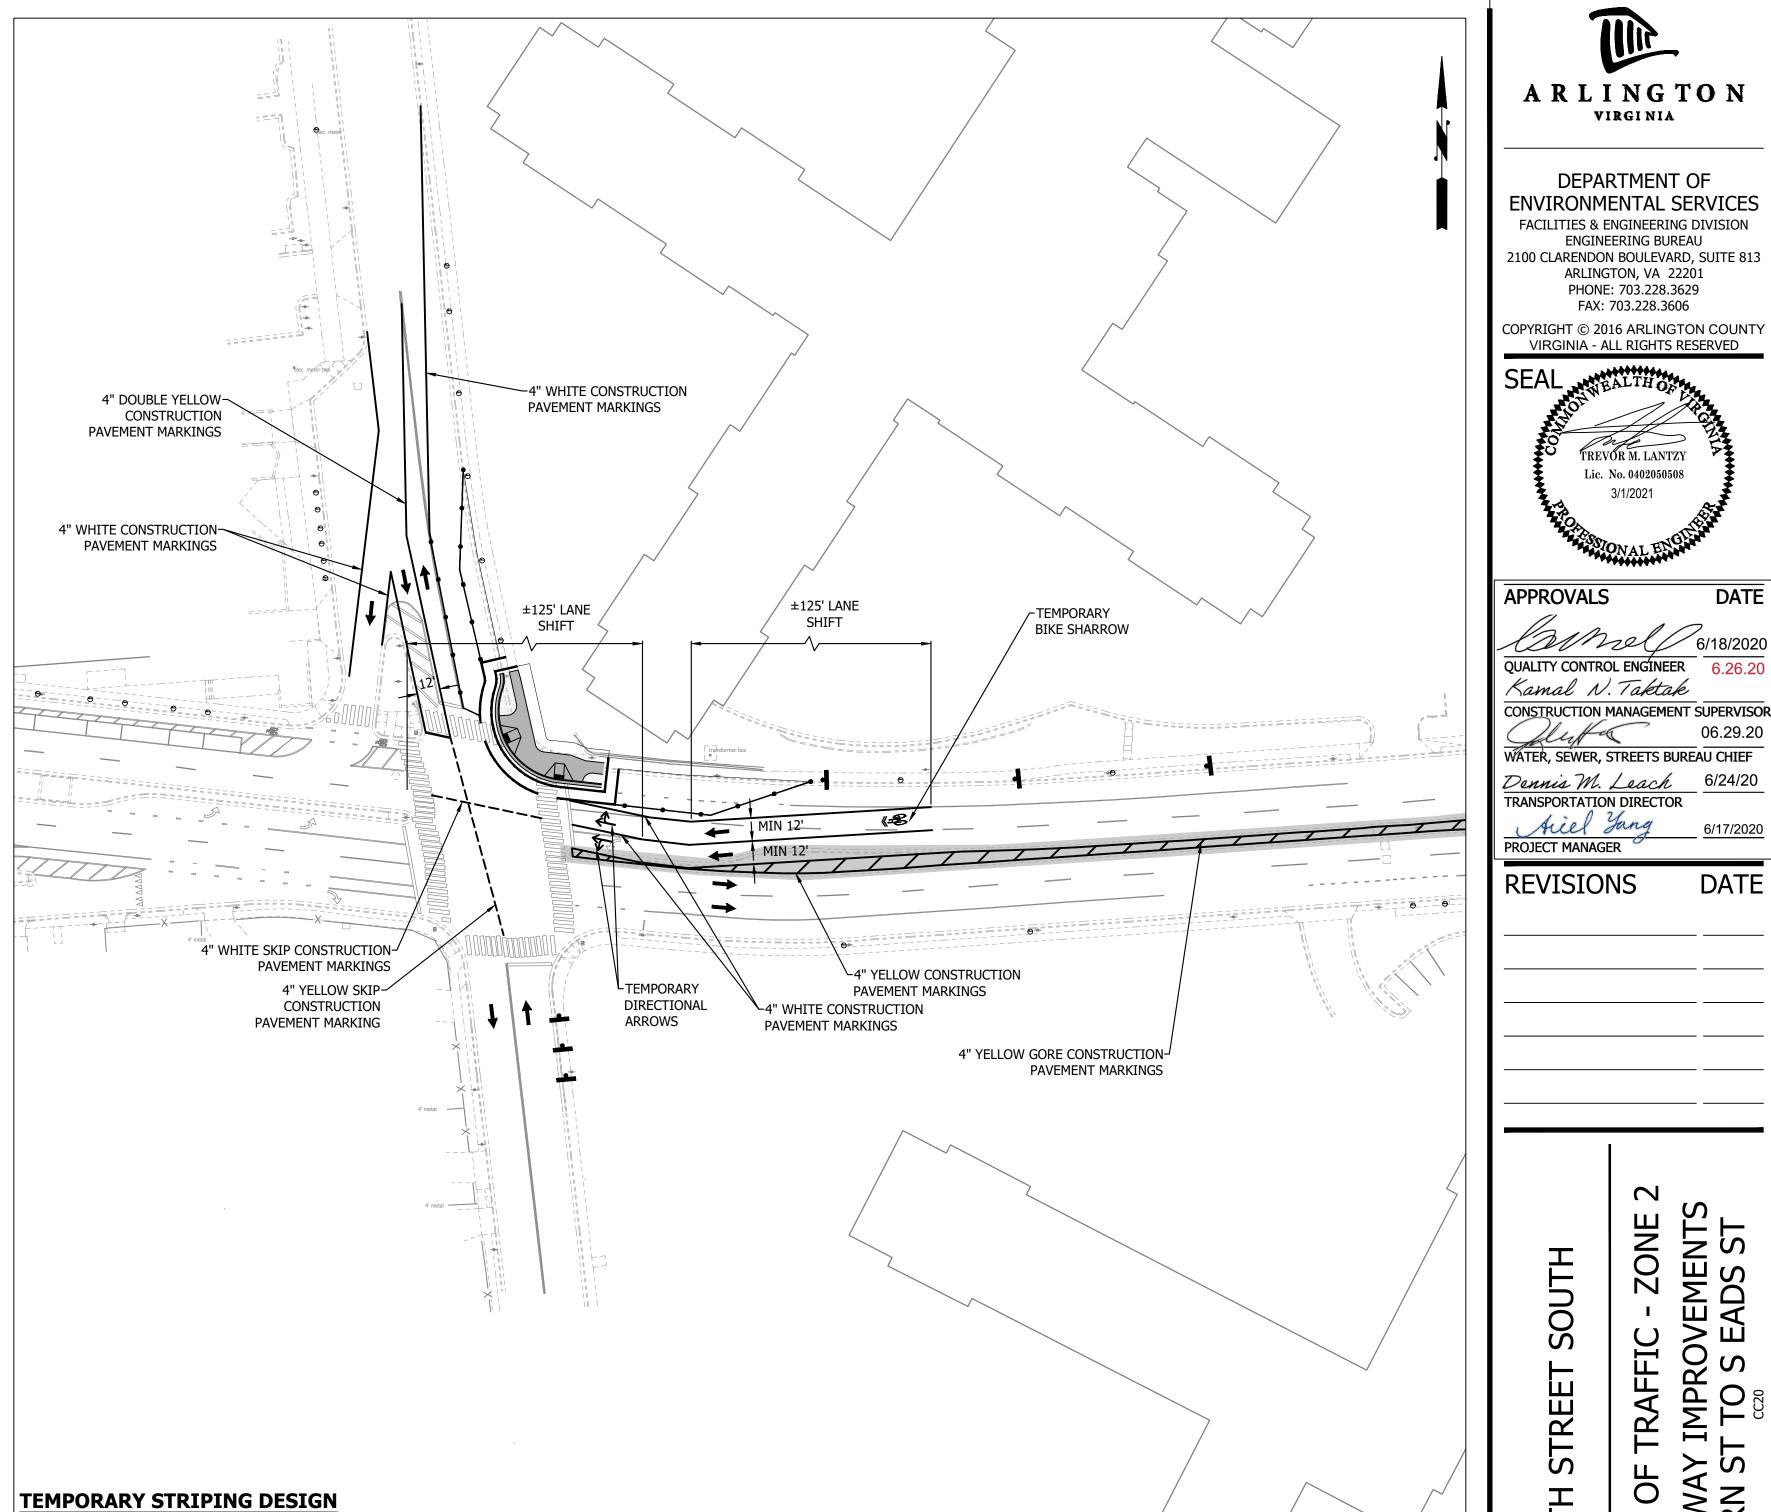

		MOT ZONE TABLE:							
	MOT ZONE#	TTC#		COMMENTS	DURATION	WORK			
	MOT ZONE#	VEHICULAR	PEDESTRIAN	COMMENTS	DUNATION	HOURS			
	ZONE# 02	TTC-28.2	TTC-35.1 TTC-36.2 *	LONGITUDINAL CHANNELIZING DEVICES SHOULD BE IN PLACE TO PROTECT PEDESTRIANS AROUND THE WORK ZONE  SHADOW VEHICLES SHALL BE UTILIZED AS SHOWN IN THE TTC	2 WEEKS - 1 MONTH	MONFRI. 9:00AM-4:00PM			

#### **ZONE NOTES:**

- 1. SPEED REDUCTION: CONTRACTOR SHALL PLACE W3-5A SIGN, WITH SPEED LIMIT OF 25 MPH, ON ALL APPROACHES FOR 18TH STREET.
- WARNING SIGN SPACING: MINIMUM 100' SPACING BETWEEN WARNING SIGNS UNLESS OTHERWISE
- DIRECTED BY THE CONSTRUCTION MANAGER AND TE&O. TEMPORARY STRIPING: REFER TO PLAN FOR STRIPING.
- OPTIONAL TTC'S: REQUIRES APPROVE BY THE CONSTRUCTION MANAGER PRIOR TO IMPLEMENTATION
- PARKING IN THIS AREA SHOULD BE BLOCKED OFF.
- CONTRACTOR TO MAINTAIN DRIVEWAY ACCESS AT ALL TIME.
- \* PEDESTRIAN ACCESS SHALL BE MAINTAINED AS SHOWN ON THIS SHEET, UTILIZING THE REFERENCED TTC IN THE ABOVE TABLE AND THE SIDEWALK BYPASS AT AN INTERSECTION, FROM THE VIRGINIA DEPARTMENT OF TRANSPORTATION WORK ZONE PEDESTRIAN AND BICYCLE GUIDANCE (LATEST

AT THE END OF EACH WORKING DAY, THE CONTRACTOR SHALL PULL BACK **MOT CHANNELIZING DEVICES TO** 

MAINTAIN TWO TRAVEL LANES IN

**EACH DIRECTION ON 18TH STREET.** 

ARLINGTON VIRGINIA

DEPARTMENT OF **ENVIRONMENTAL SERVICES FACILITIES & ENGINEERING DIVISION** ENGINEERING BUREAU 2100 CLARENDON BOULEVARD, SUITE 813 ARLINGTON, VA 22201 PHONE: 703.228.3629

FAX: 703.228.3606 COPYRIGHT © 2016 ARLINGTON COUNTY



APPROVALS

QUALITY CONTROL ENGINEER 6.26.20 Kamal N. Taktak

WATER, SEWER, STREETS BUREAU CHIEF Dennis M. Leach 6/24/20 TRANSPORTATION DIRECTOR

Siel Yang PROJECT MANAGER

**REVISIONS** 

SOUTH


DESIGNED: NS DRAWN: NS

CHECKED: TL MISS UTILITY TRANSMITTAL #: XXXX


FILENAME: CC20-286-MOT - ZONE 02.DWG PATH: Q:\DATA\CC20\DESIGN\CAD\\_ACTIVE

PLOTTED: MARCH 1 2021 PLOTTED BY:NSHARP

SCALE:

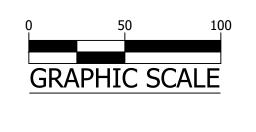

SHEET C121.3

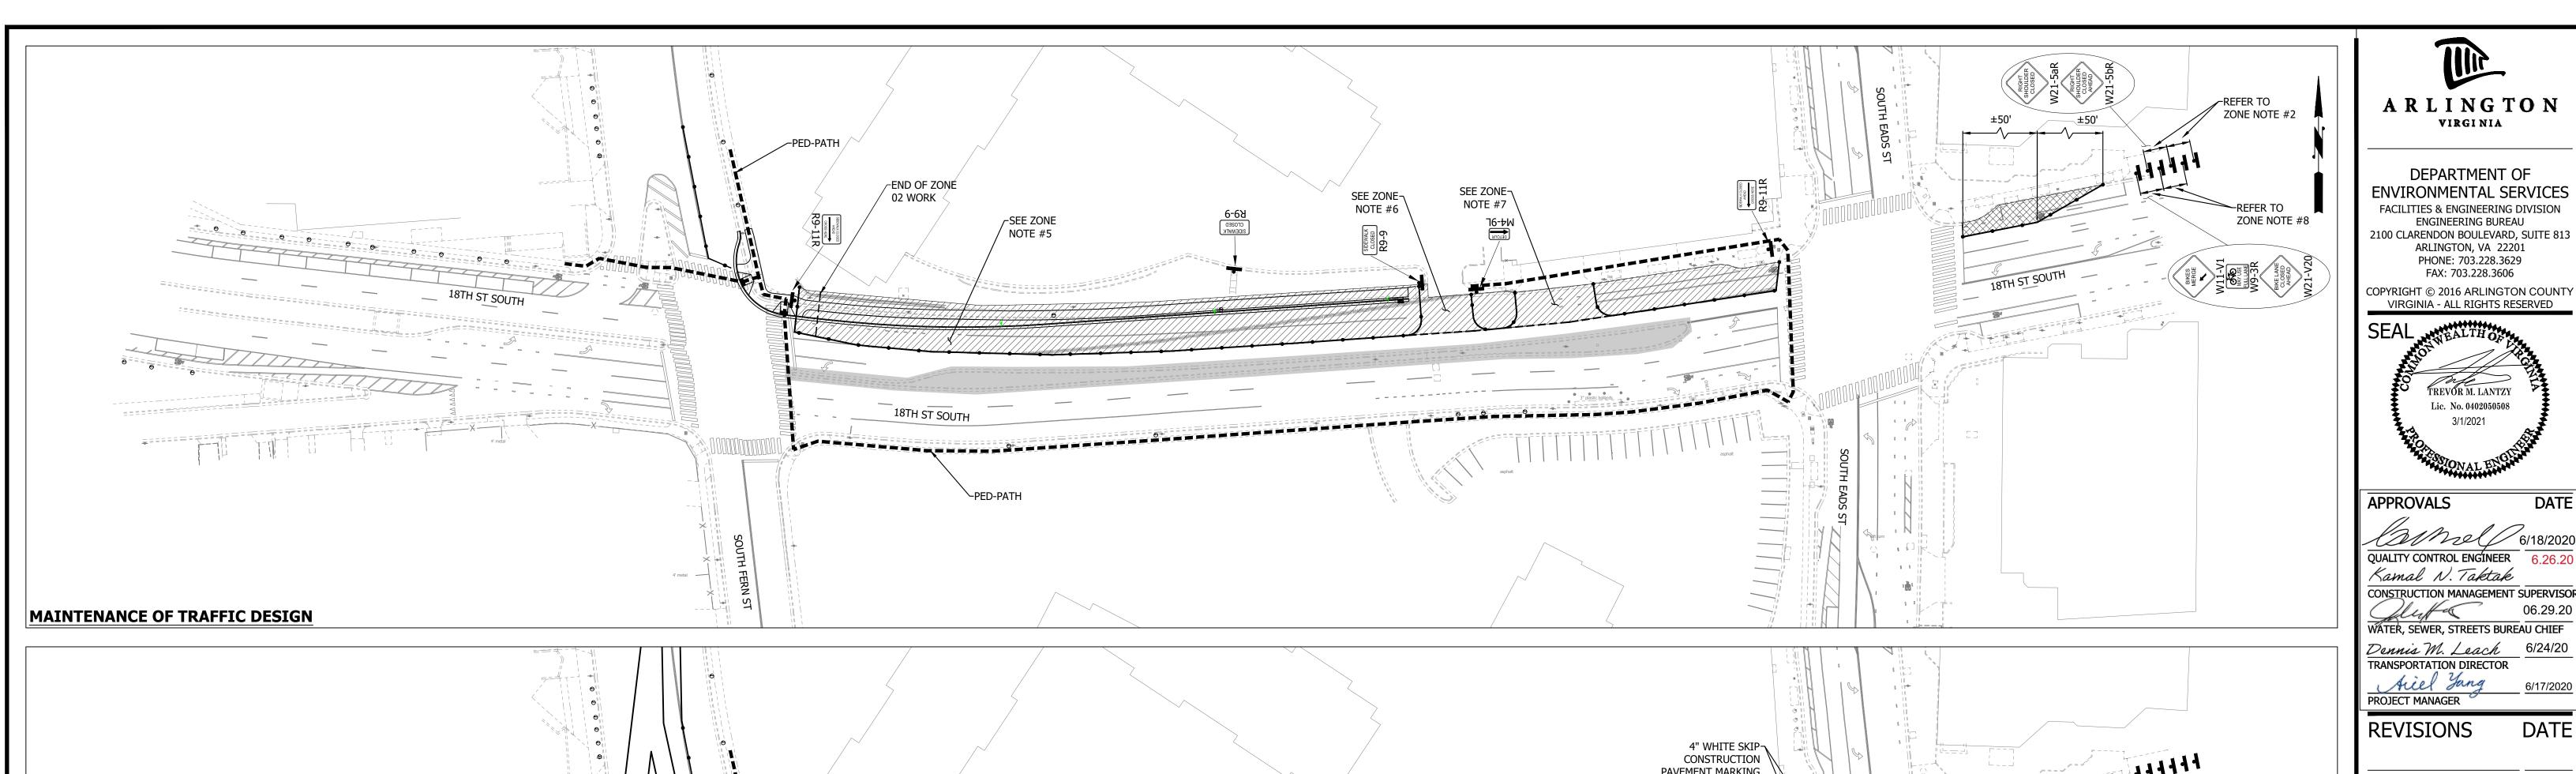

#### PAVEMENT MARKING -END OF ZONÉ 4" WHITE SKIP-02 WORK CONSTRUCTION -TEMPORARY DIRECTIONAL 4" DOUBLE YELLOW CONSTRUCTION 4" WHITE CONSTRUCTION PAVEMENT MARKINGS ±125' LANE SHIFT DIRECTIONAL ARROWS PAVEMENT MARKINGS <sup>1</sup>−4" WHITE GORE CONSTRUCTION PAVEMENT MARKINGS TEMPORARY STRIPING DESIGN

MOT ZONE TABLE:

			1101 ZONE 17 DELI		
MOT ZONE#	TTC#		COMMENTS	DUDATION	WORK
MOT ZONE#	VEHICULAR	PEDESTRIAN	COMMENTS	DURATION	HOURS
ZONE# 03	TTC-4.2	TTC-35.1 *	M.O.T. DEVICES MAY REMAIN IN PLACE AS LONG AS TWO LANES IN EACH DIRECTION ARE MAINTAINED.  SHADOW VEHICLES SHALL BE UTILIZED AS SHOWN IN THE TTC	1 MONTH - 3 MONTHS	MONFRI. 9:00AM-4:00PM

#### **ZONE NOTES:**

- 1. SPEED REDUCTION: CONTRACTOR SHALL PLACE W3-5A SIGN, WITH SPEED LIMIT OF 25 MPH, ON ALL APPROACHES FOR 18TH STREET.
- WARNING SIGN SPACING: MINIMUM 100' SPACING BETWEEN WARNING SIGNS UNLESS OTHERWISE DIRECTED BY THE CONSTRUCTION MANAGER AND TE&O.
- TEMPORARY STRIPING: REFER TO PLAN FOR STRIPING.
- OPTIONAL TTC'S: REQUIRES APPROVE BY THE CONSTRUCTION MANAGER PRIOR TO IMPLEMENTATION
- 5. CONSTRUCTION OF THE BIKE MEDIAN SHALL NOT BE DONE IN THIS ZONE. PAVE THE AREA SO THAT IT HAS A DRIVABLE SURFACE. MEDIAN SHALL BE CONSTRUCTED IN A LATER ZONE.
- 6. COORDINATE WITH THE PROJECT OFFICER PRIOR TO WORK AND CLOSURE OF DRIVEWAY. PROPERTY OWNER SHALL BE NOTIFIED THREE WEEKS BEFORE DRIVEWAY CLOSURE. ADDITIONAL SIGNAGE AND CHANNELIZATION DEVICES MAY BE REQUIRED FOR THE CLOSURE. WORK IN THE DRIVEWAY AREA SHOULD TAKE NO MORE THEN 3-5 DAYS.
- 7. COORDINATE WITH THE PROJECT OFFICER PRIOR TO WORK AND CLOSURE OF DRIVEWAY. PROPERTY OWNER SHALL BE NOTIFIED THREE WEEKS BEFORE DRIVEWAY CLOSURE. ONLY HALF OF THE DRIVEWAY SHALL BE CLOSED AT A TIME TO ALLOW FOR VEHICLES TO ENTER AND EXIT. ADDITIONAL SIGNAGE AND CHANNELIZATION DEVICES MAY BE REQUIRED FOR THE CLOSURE. WORK ON EACH HALF OF THE DRIVEWAY SHOULD TAKE NO MORE THEN 2-3 DAYS.
- 8. BIKE LANE CLOSURE SIGNAGE TO BE PLACED IN BETWEEN ROAD WARNING SIGNS AND BE VISIBLE FOR BOTH VEHICLES AND BIKES.
- \* PEDESTRIAN ACCESS SHALL BE MAINTAINED AS SHOWN ON THIS SHEET, UTILIZING THE REFERENCED TTC IN THE ABOVE TABLE AND THE BICYCLE LANE CLOSURE, FROM THE VIRGINIA DEPARTMENT OF TRANSPORTATION WORK ZONE PEDESTRIAN AND BICYCLE GUIDANCE (LATEST EDITION)


AT THE END OF EACH WORKING DAY, THE CONTRACTOR SHALL PULL BACK **MOT CHANNELIZING DEVICES TO** MAINTAIN TWO TRAVEL LANES IN **EACH DIRECTION ON 18TH STREET.** 

ARLINGTON

DEPARTMENT OF **ENVIRONMENTAL SERVICES FACILITIES & ENGINEERING DIVISION** ENGINEERING BUREAU 2100 CLARENDON BOULEVARD, SUITE 813

PHONE: 703.228.3629 FAX: 703.228.3606 COPYRIGHT © 2016 ARLINGTON COUNT

ARLINGTON, VA 22201

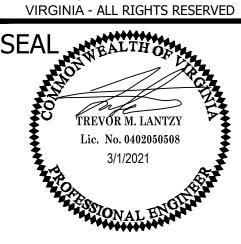

APPROVALS

QUALITY CONTROL ENGINEER 6.26.20 Kamal N. Taktak

WATER, SEWER, STREETS BUREAU CHIEF Dennis M. Leach 6/24/20 TRANSPORTATION DIRECTOR

PROJECT MANAGER

**REVISIONS** 

SOUTH

DESIGNED: NS DRAWN: NS

CHECKED: TL MISS UTILITY TRANSMITTAL #: XXXX


FILENAME: CC20-286-MOT - ZONE 03.DWG PATH: Q:\DATA\CC20\DESIGN\CAD\\_ACTIVE


PLOTTED: MARCH 1 2021

PLOTTED BY:NSHARP SCALE:

**GRAPHIC SCALE** 

SHEET

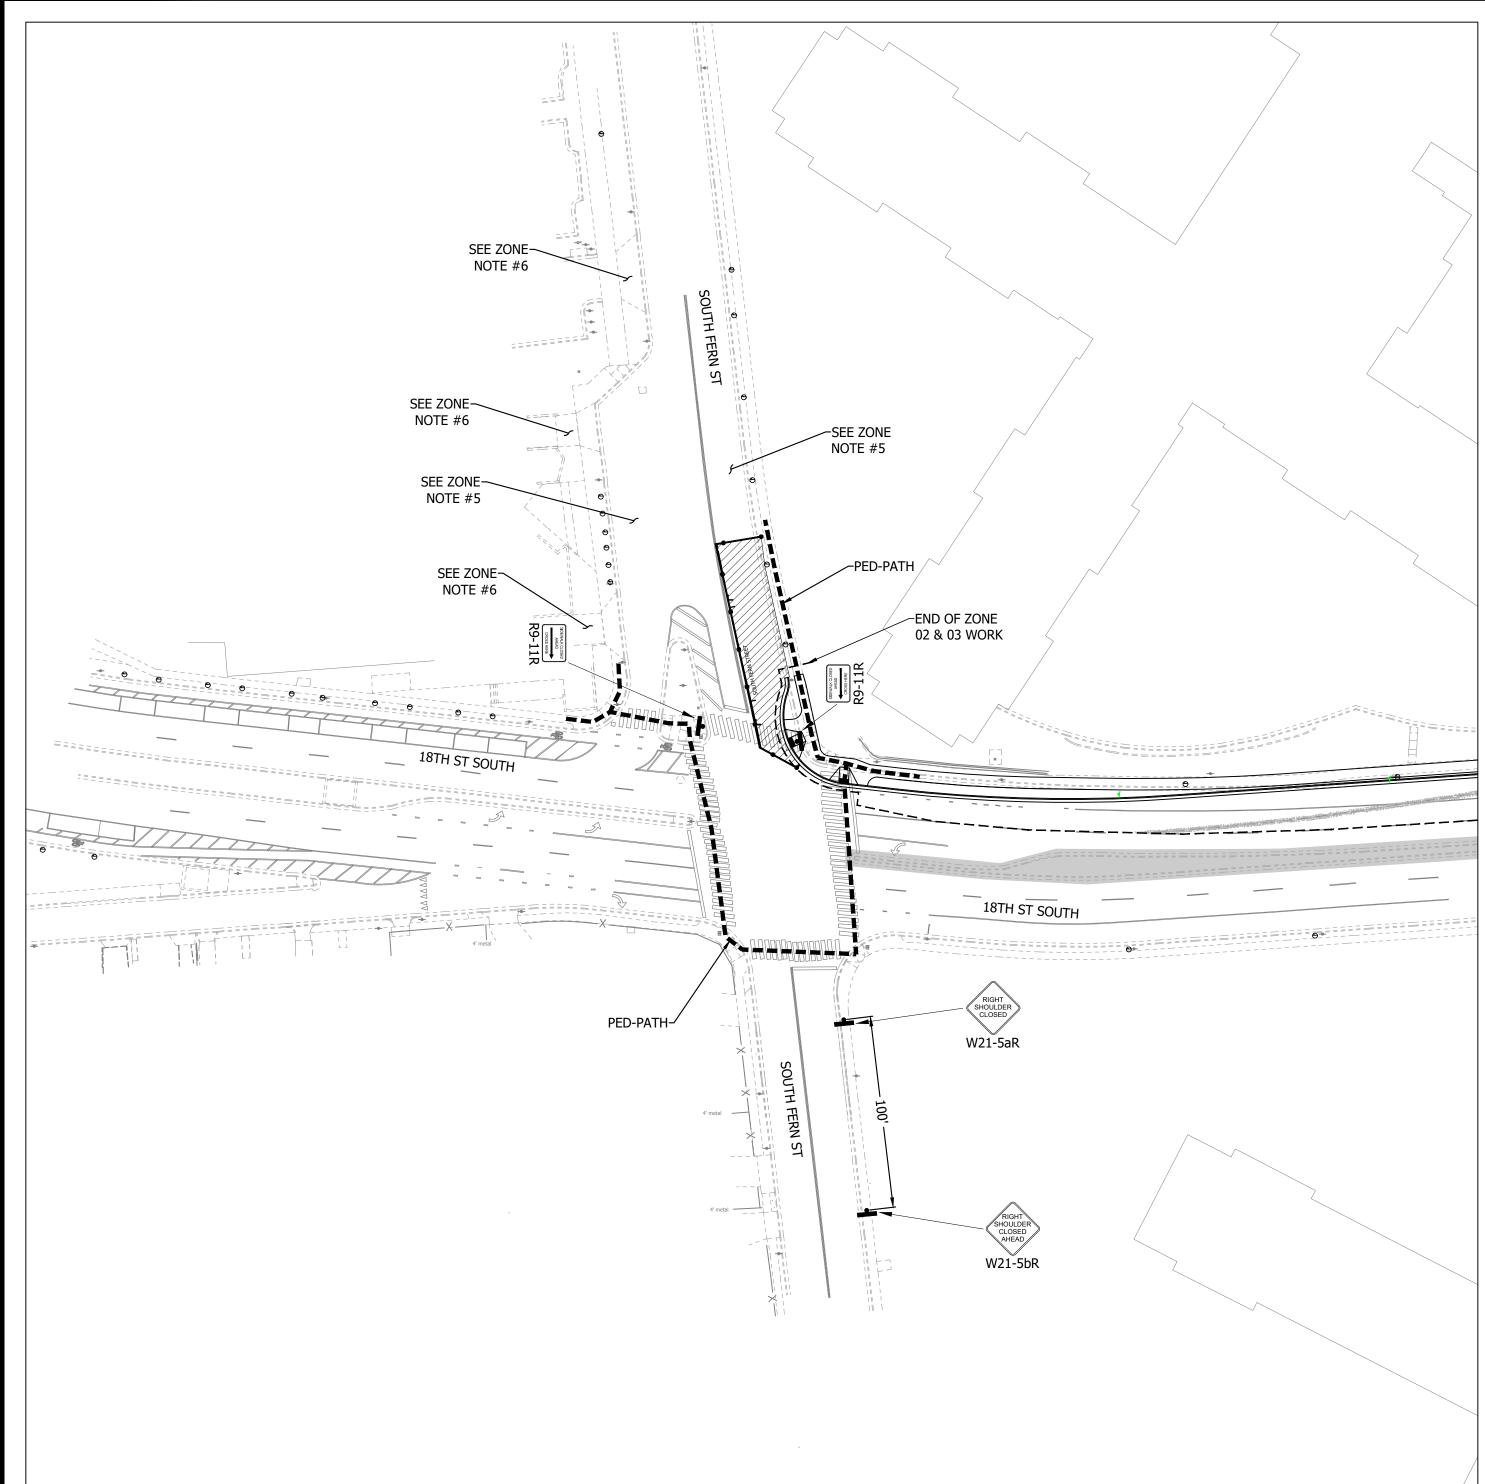

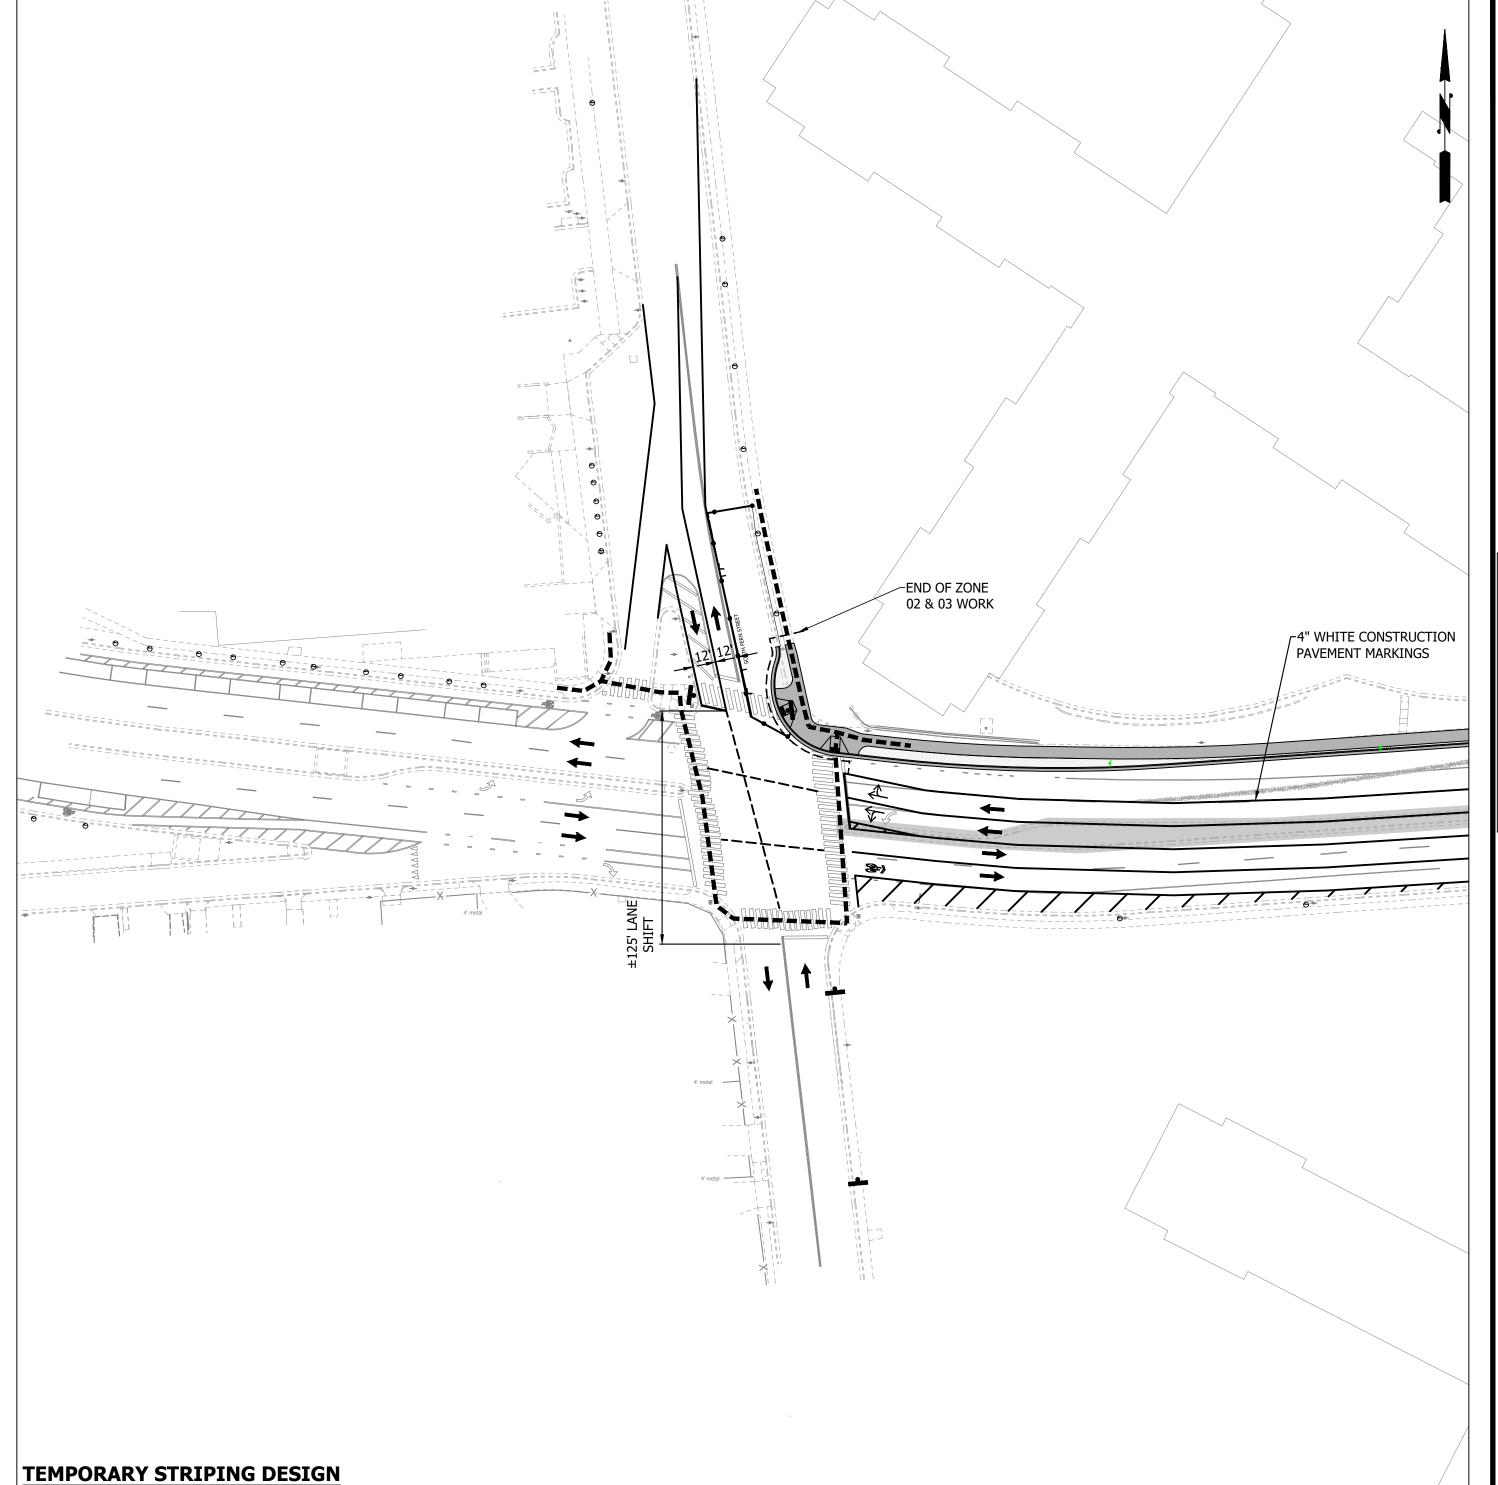

MAINTENANCE OF TRAFFIC DESIGN

MOT ZONE TABLE:							
MOT ZONE#	TTC#		COMMENTS	DURATION	WORK		
1101 2011211	VEHICULAR	PEDESTRIAN		DOIVITOR	HOURS		
ZONE# 04	TTC-4.2	TTC-35.1 TTC-36.2 *	M.O.T. DEVICES MAY REMAIN IN PLACE AS LONG AS A LANE IN EACH DIRECTION ARE MAINTAINED ON FERN.  SHADOW VEHICLES SHALL BE UTILIZED AS SHOWN IN THE TTC	1 WEEK - 2 WEEKS	MONFRI. 9:00AM-4:00PM		

- 1. SPEED REDUCTION: CONTRACTOR SHALL PLACE W3-5A SIGN, WITH SPEED LIMIT OF 25 MPH, ON ALL APPROACHES FOR 18TH STREET.
- 2. <u>WARNING SIGN SPACING:</u> MINIMUM 100' SPACING BETWEEN WARNING SIGNS UNLESS OTHERWISE DIRECTED BY THE CONSTRUCTION MANAGER AND TE&O.
- 3. <u>TEMPORARY STRIPING:</u> REFER TO PLAN FOR STRIPING.
- -STRIPING FROM PREVIOUS ZONE TO REMAIN UNLESS NOTED FOR REMOVAL.
- 4. OPTIONAL TTC'S: REQUIRES APPROVE BY THE CONSTRUCTION MANAGER PRIOR TO IMPLEMENTATION
- 5. PARKING IN THIS AREA SHOULD BE BLOCKED OFF.
- 6. CONTRACTOR TO MAINTAIN DRIVEWAY ACCESS AT ALL TIME.
- \* PEDESTRIAN ACCESS SHALL BE MAINTAINED AS SHOWN ON THIS SHEET, UTILIZING THE REFERENCED TTC IN THE ABOVE TABLE.


AT THE END OF EACH WORKING DAY, THE CONTRACTOR SHALL PULL BACK **MOT CHANNELIZING DEVICES TO** MAINTAIN TWO TRAVEL LANES IN **EACH DIRECTION ON 18TH STREET.** 

ARLINGTON VIRGINIA DEPARTMENT OF

**ENVIRONMENTAL SERVICES** FACILITIES & ENGINEERING DIVISION ENGINEERING BUREAU 2100 CLARENDON BOULEVARD, SUITE 813 ARLINGTON, VA 22201 PHONE: 703.228.3629

FAX: 703.228.3606

COPYRIGHT © 2016 ARLINGTON COUNTY VIRGINIA - ALL RIGHTS RESERVED

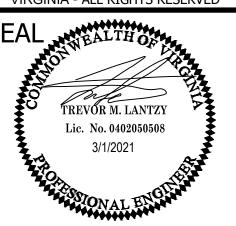

APPROVALS

QUALITY CONTROL ENGINEER 6.26.20 Kamal N. Taktak

CONSTRUCTION MANAGEMENT SUPERVISOR WATER, SEWER, STREETS BUREAU CHIEF Dennis M. Leach 6/24/20

TRANSPORTATION DIRECTOR Sicel Yang PROJECT MANAGER

**REVISIONS** 

SOUTH


DESIGNED: NS DRAWN: NS

CHECKED: TL MISS UTILITY TRANSMITTAL #: XXXX


CC20-286-MOT - ZONE 04.DWG PATH: Q:\DATA\CC20\DESIGN\CAD\\_ACTIVE


PLOTTED: MARCH 1 2021 PLOTTED BY:NSHARP

SCALE:

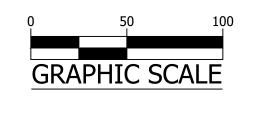

SHEET

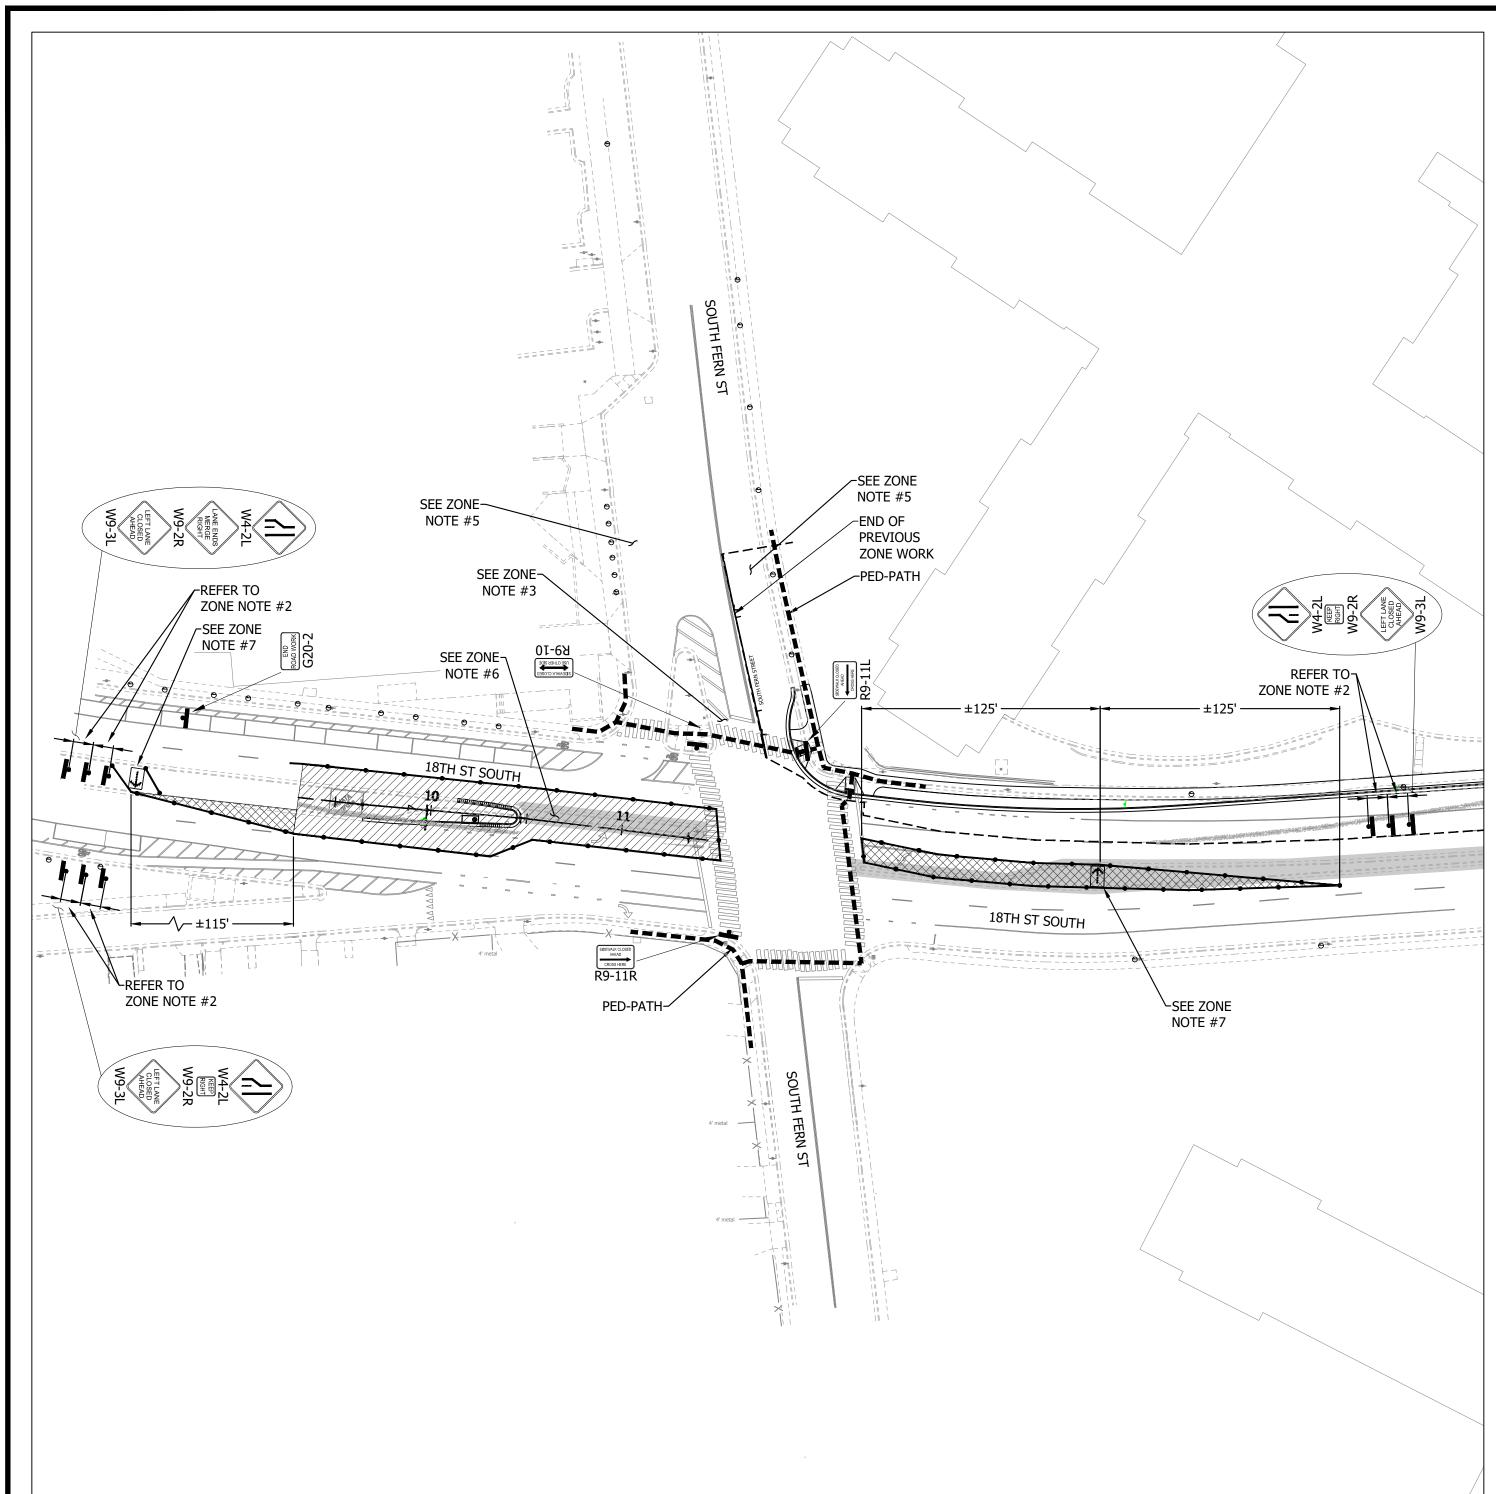

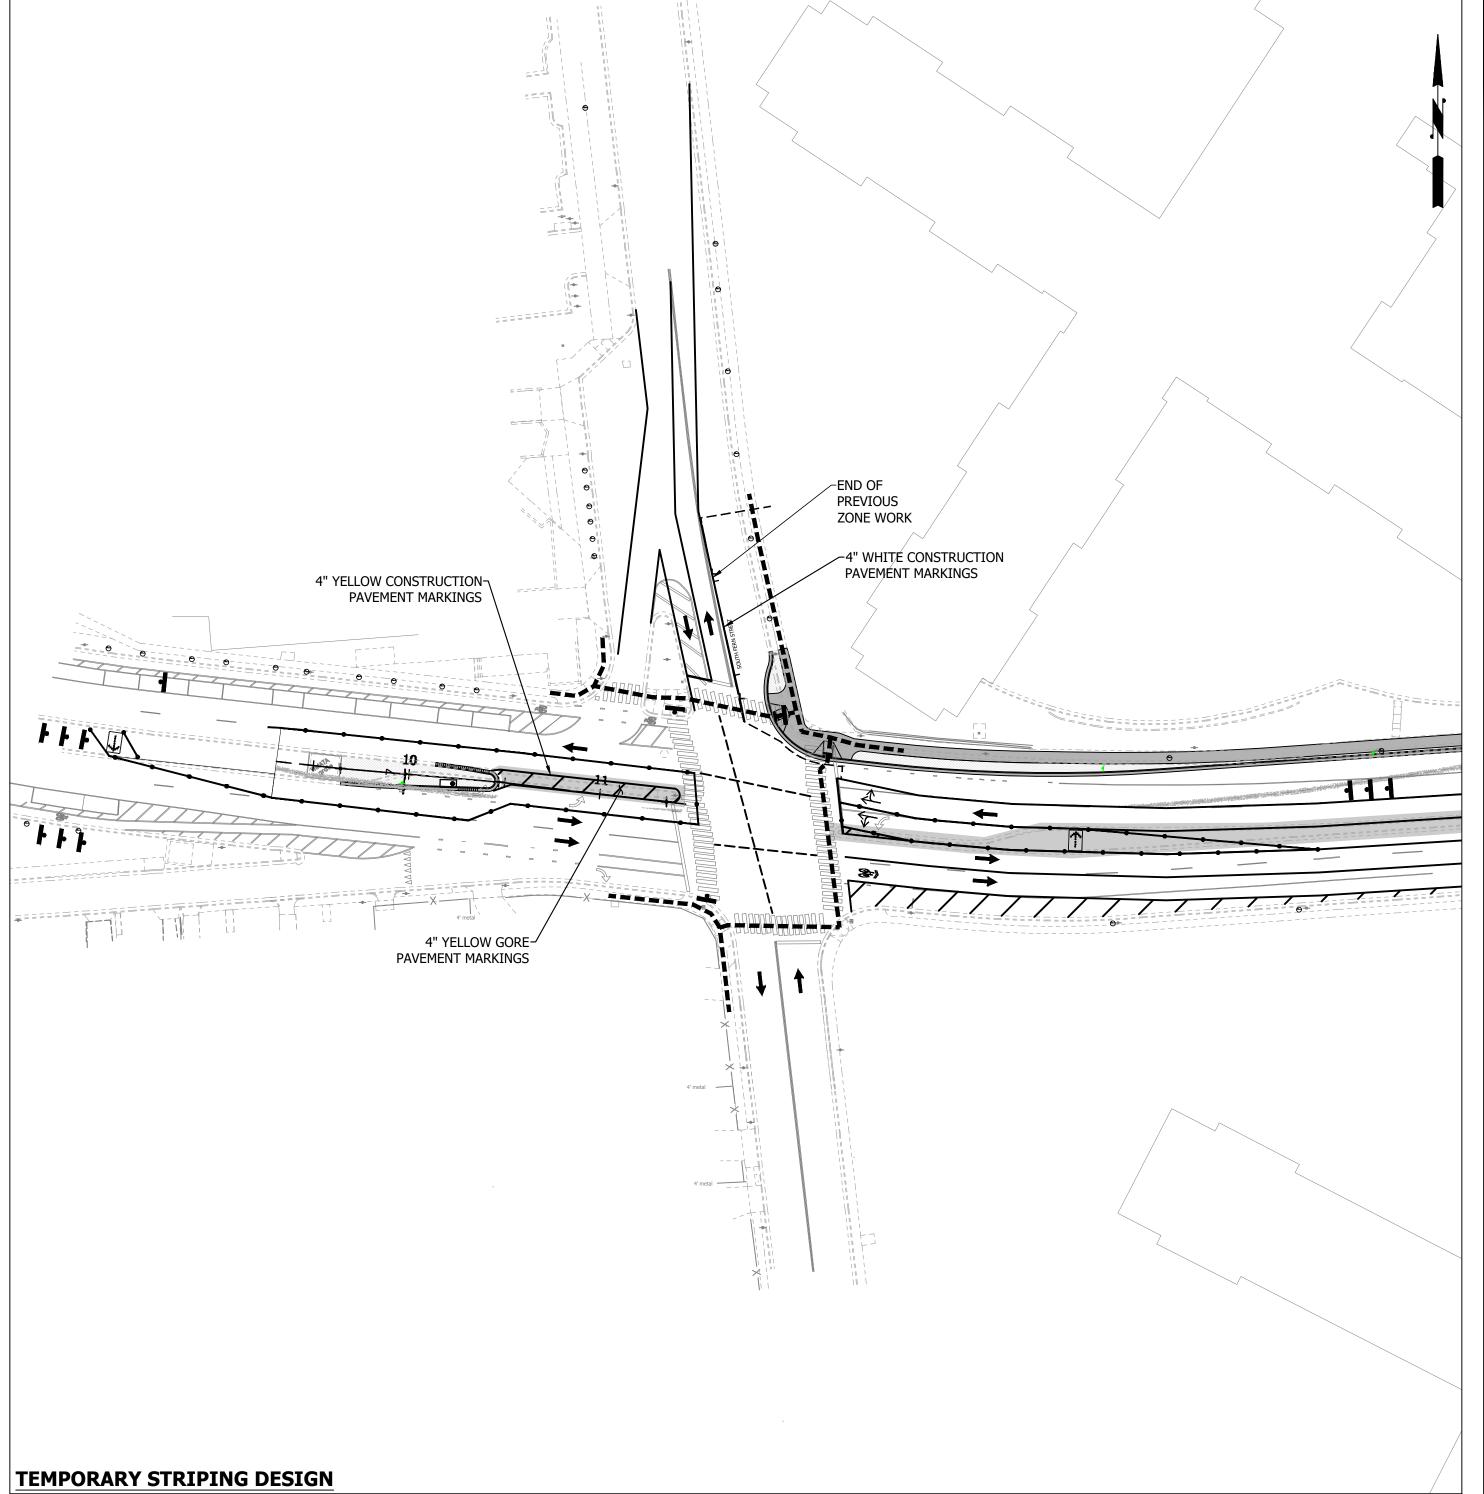

MOT ZONE TABLE:								
MOT ZONE#	TTC#		COMMENTS	DURATION	WORK			
MOT ZONE#	VEHICULAR	PEDESTRIAN	COMMENTS DURATION	DUNATION	HOURS			
ZONE# 04	TTC-17.2 TTC-27.2	TTC-35.1 TTC-36.2 *	REMOVE EXISTING MEDIAN AND REPAVE WITH TEMP. ASPHALT AS SHOWN ABOVE. ADJUST THE EXISTING STORM STRUCTURE AS NECESSARY. PROPOSED MEDIAN DESIGN SHALL BE CONSTRUCTED IN THIS ZONE AS WELL AS THE TEMP ASPHALT PAVING. THE ELEVATION DIFFERENCE BETWEEN THE PROPOSED CURB AND PAVEMENT SHALL BE TAPERED AT A 1:3 RATIO TO THE TEMP. AND EXISTING PAVEMENT.  CONTRACTOR TO PULL BACK CHANNELING DEVICES AT THE END OF THE WORK DAY AND RE OPEN CLOSED LANES.  SHADOW VEHICLES SHALL BE UTILIZED AS SHOWN IN THE TTC	1 WEEK - 3 WEEKS	MONFRI. 9:00AM-4:00PM			

#### **ZONE NOTES:**

- 1. SPEED REDUCTION: CONTRACTOR SHALL PLACE W3-5A SIGN, WITH SPEED LIMIT OF 25 MPH, ON ALL APPROACHES FOR 18TH STREET.
- 2. <u>WARNING SIGN SPACING:</u> MINIMUM 100' SPACING BETWEEN WARNING SIGNS UNLESS OTHERWISE
- DIRECTED BY THE CONSTRUCTION MANAGER AND TE&O. 3. <u>TEMPORARY STRIPING:</u> REFER TO PLAN FOR STRIPING.
- -STRIPING FROM PREVIOUS ZONE TO REMAIN UNLESS NOTED FOR REMOVAL.
- -ADJUST SOUTHBOUND FERN LANE STOP BAR AND ADD TEMP CROSS WALK 4. OPTIONAL TTC'S: REQUIRES APPROVE BY THE CONSTRUCTION MANAGER PRIOR TO IMPLEMENTATION
- 5. PARKING IN THIS AREA SHOULD BE BLOCKED OFF.
- 6. INSTALL A DRIVABLE TEMPORARY PAVEMENT SURFACE. 7. ILLUMINATED FLASHING ARROW BOARDS SHALL BE PLACED IN THE BUFFER AREAS.
- \* PEDESTRIAN ACCESS SHALL BE MAINTAINED AS SHOWN ON THIS SHEET, UTILIZING THE REFERENCED TTC IN THE MOT ZONE TABLE.

AT THE END OF EACH WORKING DAY, THE CONTRACTOR SHALL PULL BACK **MOT CHANNELIZING DEVICES TO** MAINTAIN TWO TRAVEL LANES IN EACH DIRECTION ON 18TH STREET.

DESIGNED: NS DRAWN: NS CHECKED: TL MISS UTILITY TRANSMITTAL #: XXXX

ARLINGTON VIRGINIA

DEPARTMENT OF **ENVIRONMENTAL SERVICES** FACILITIES & ENGINEERING DIVISION ENGINEERING BUREAU 2100 CLARENDON BOULEVARD, SUITE 813 ARLINGTON, VA 22201 PHONE: 703.228.3629 FAX: 703.228.3606 COPYRIGHT © 2016 ARLINGTON COUNTY VIRGINIA - ALL RIGHTS RESERVED

APPROVALS

QUALITY CONTROL ENGINEER 6.26.20

CONSTRUCTION MANAGEMENT SUPERVISOR

WATER, SEWER, STREETS BUREAU CHIEF Dennis M. Leach 6/24/20

Kamal N. Taktak

TRANSPORTATION DIRECTOR Ailel Yang

PROJECT MANAGER


**REVISIONS** 

SOUTH


CC20-286-MOT - ZONE 05.DWG PATH: Q:\DATA\CC20\DESIGN\CAD\\_ACTIVE


PLOTTED: MARCH 1 2021 PLOTTED BY:NSHARP

SCALE:

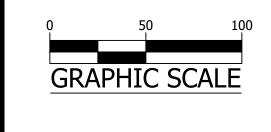

SHEET

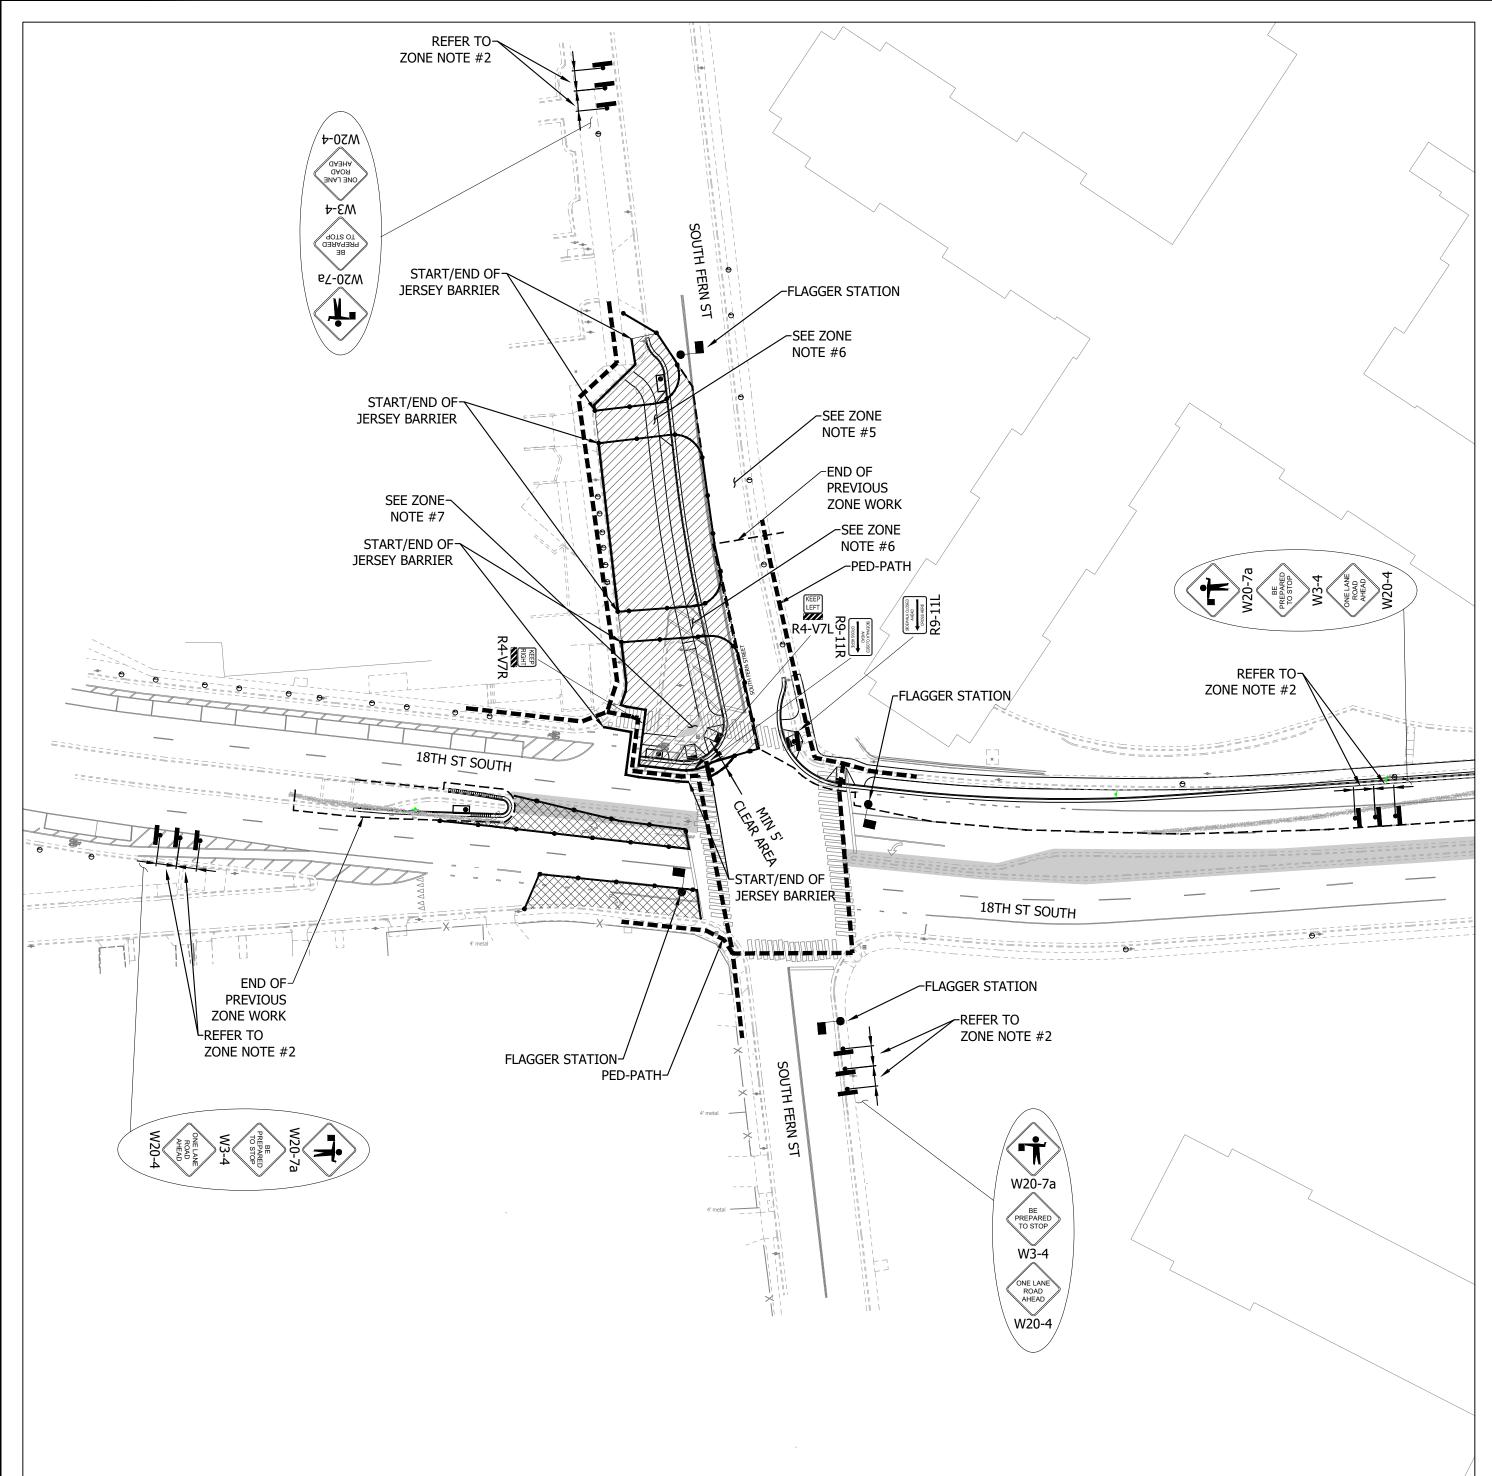

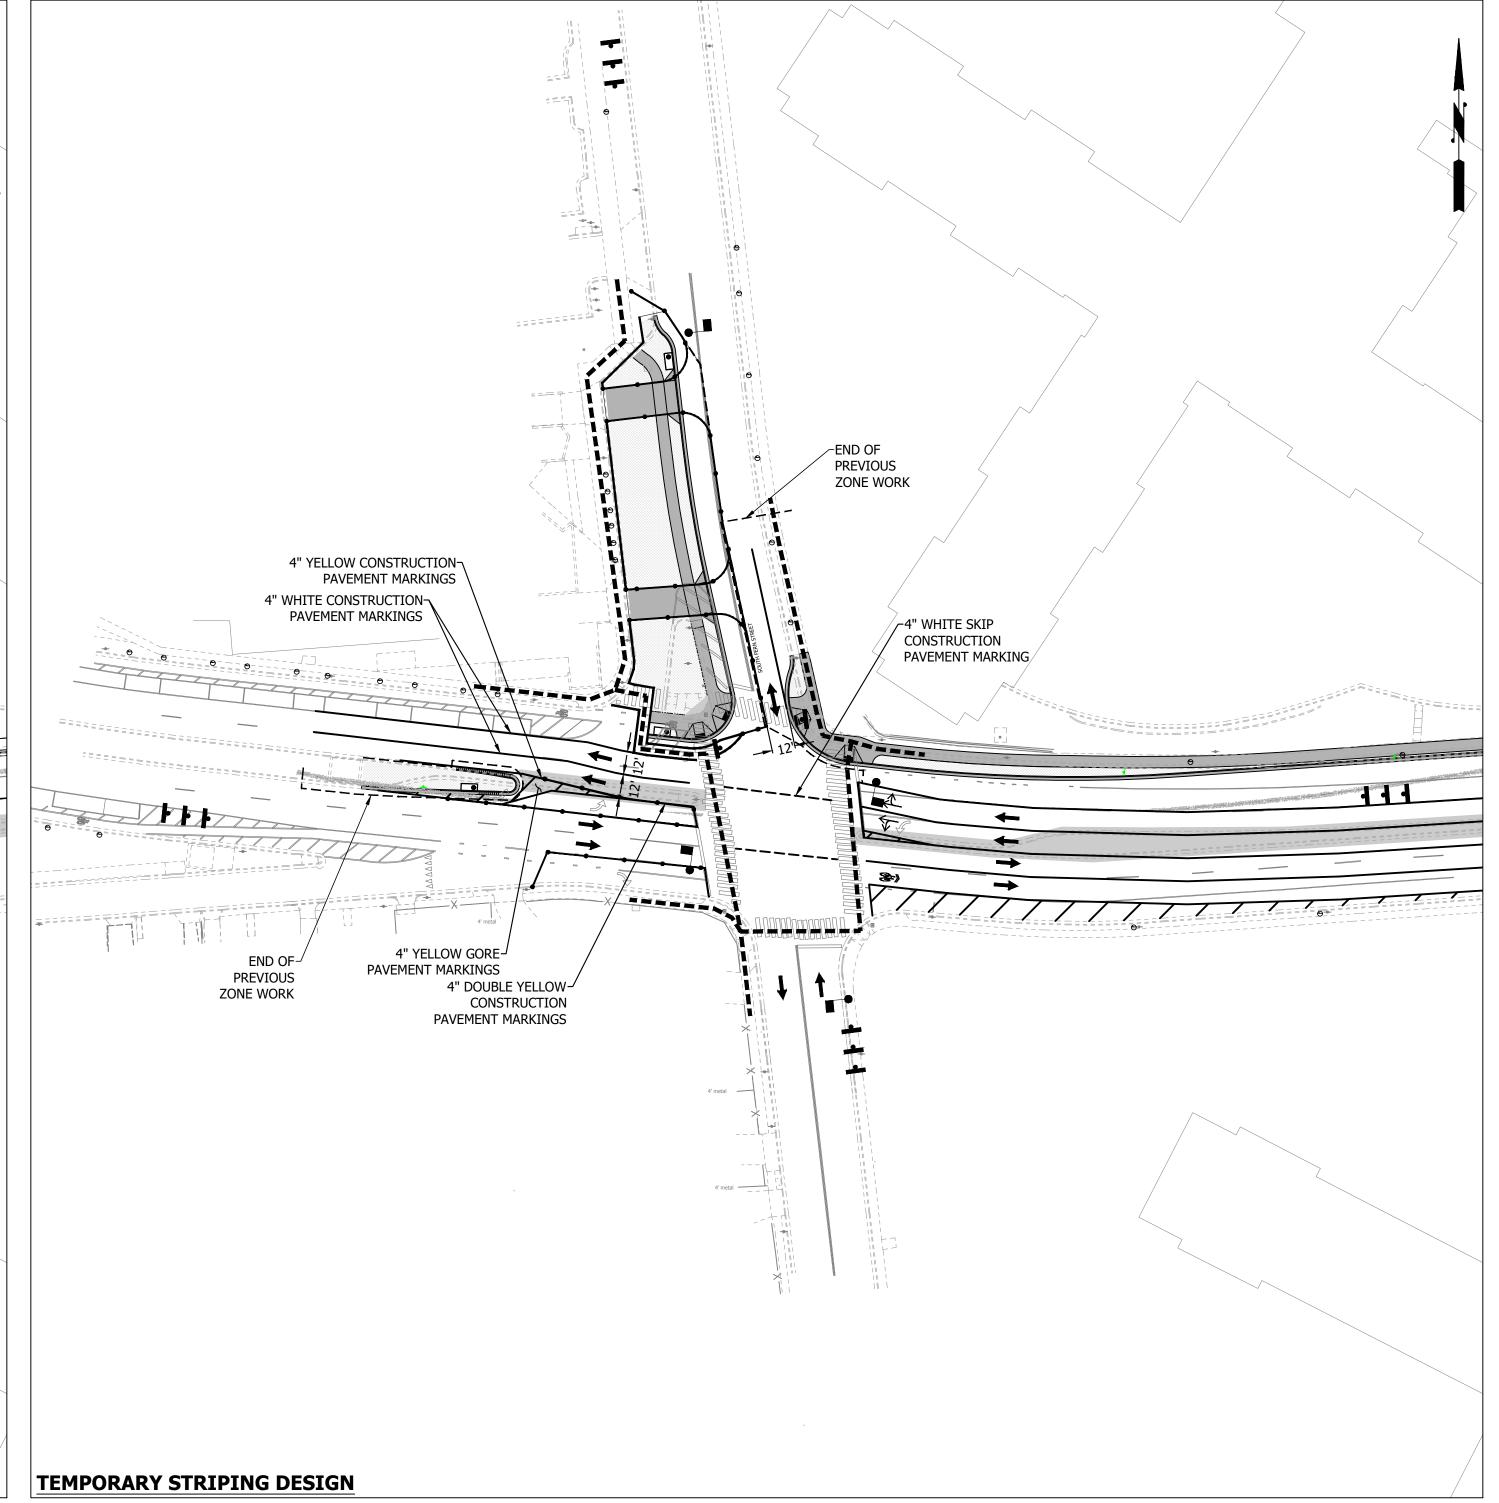

		MOT ZONE TABLE:							
	MOT ZONE#	TTC#		COMMENTS	DURATION	WORK			
		VEHICULAR	PEDESTRIAN			HOURS			
	ZONE# 06	NE# 06 TTC-30.2	( -	CONTRACTOR TO PULL BACK CHANNELING DEVICES AT THE END OF THE WORK DAY AND RE OPEN CLOSED LANES.	1 MONTH - 3 MONTHS	MONFRI. 9:00AM-4:00PM			
				SHADOW VEHICLES SHALL BE UTILIZED AS SHOWN IN THE TTC					

## **ZONE NOTES:**

- 1. <u>SPEED REDUCTION:</u> CONTRACTOR SHALL PLACE W3-5A SIGN, WITH SPEED LIMIT OF 25 MPH, ON ALL APPROACHES FOR 18TH STREET.
- 2. <u>WARNING SIGN SPACING:</u> MINIMUM 100' SPACING BETWEEN WARNING SIGNS UNLESS OTHERWISE
- DIRECTED BY THE CONSTRUCTION MANAGER AND TE&O.

  3. TEMPORARY STRIPING: REFER TO PLAN FOR STRIPING.

-STRIPING FROM PREVIOUS ZONE TO REMAIN UNLESS NOTED FOR REMOVAL.
-REMOVE AND RESTRIPE THE WESTBOUND SKIP LANE ON 18TH STREET.
-REMOVE THE FERN STREET SKIP LANE. AT THE END OF EACH DAY, THE CONTRACTOR SHALL MAKE

SURE THAT IT IS CLEAR FOR DRIVES ON THE LANE CONFIGURATION.

- 4. <u>OPTIONAL TTC'S:</u> REQUIRES APPROVE BY THE CONSTRUCTION MANAGER PRIOR TO IMPLEMENTATION
- 5. PARKING IN THIS AREA SHOULD BE BLOCKED OFF.
- 6. COORDINATE WITH THE PROJECT OFFICER PRIOR TO WORK AND CLOSURE OF DRIVEWAY. PROPERTY OWNER SHALL BE NOTIFIED THREE WEEKS BEFORE DRIVEWAY CLOSURE. ADDITIONAL SIGNAGE AND CHANNELIZATION DEVICES MAY BE REQUIRED FOR THE CLOSURE. WORK IN THE DRIVEWAY AREA SHOULD TAKE NO MORE THEN 7-14 DAYS. MAINTAIN AT LEAST ONE DRIVEWAY ENTRANCE OPEN AT ALL TIMES.
- 7. CONTRACTOR TO ADD AN ASPHALT PATCH TO PROVIDE A SAFE ADA PEDESTRIAN PATH AROUND THE EXISTING POLE UNTIL POLE REMOVAL.
- \* PEDESTRIAN ACCESS SHALL BE MAINTAINED AS SHOWN ON THIS SHEET, UTILIZING THE REFERENCED TTC IN THE MOT ZONE TABLE.

AT THE END OF EACH WORKING DAY,
THE CONTRACTOR SHALL PULL BACK
MOT CHANNELIZING DEVICES TO
MAINTAIN TWO TRAVEL LANES IN
EACH DIRECTION ON 18TH STREET.

DESIGNED: NS

CHECKED: TL
MISS UTILITY TRANSMITTAL #: XXXX

DRAWN: NS

ARLINGTON
VIRGINIA

DEPARTMENT OF ENVIRONMENTAL SERVICES FACILITIES & ENGINEERING DIVISION

ENGINEERING BUREAU 2100 CLARENDON BOULEVARD, SUITE 813

ARLINGTON, VA 22201

PHONE: 703.228.3629 FAX: 703.228.3606 COPYRIGHT © 2016 ARLINGTON COUNTY

VIRGINIA - ALL RIGHTS RESERVED

QUALITY CONTROL ENGINEER 6.26.20

CONSTRUCTION MANAGEMENT SUPERVISOR

WATER, SEWER, STREETS BUREAU CHIEF

Dennis M. Leach 6/24/20

Kamal N. Taktak

TRANSPORTATION DIRECTOR

Sicel Yang

PROJECT MANAGER

**REVISIONS** 


SOUTH

APPROVALS


FILENAME:
CC20-286-MOT - ZONE 06.DWG
PATH: Q:\Data\cc20\DESIGN\cad\\_ACTIVE


PLOTTED: MARCH 1 2021 PLOTTED BY: NSHARP

SCALE:

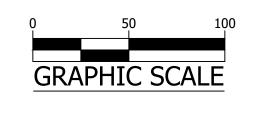

SHEET C121.7

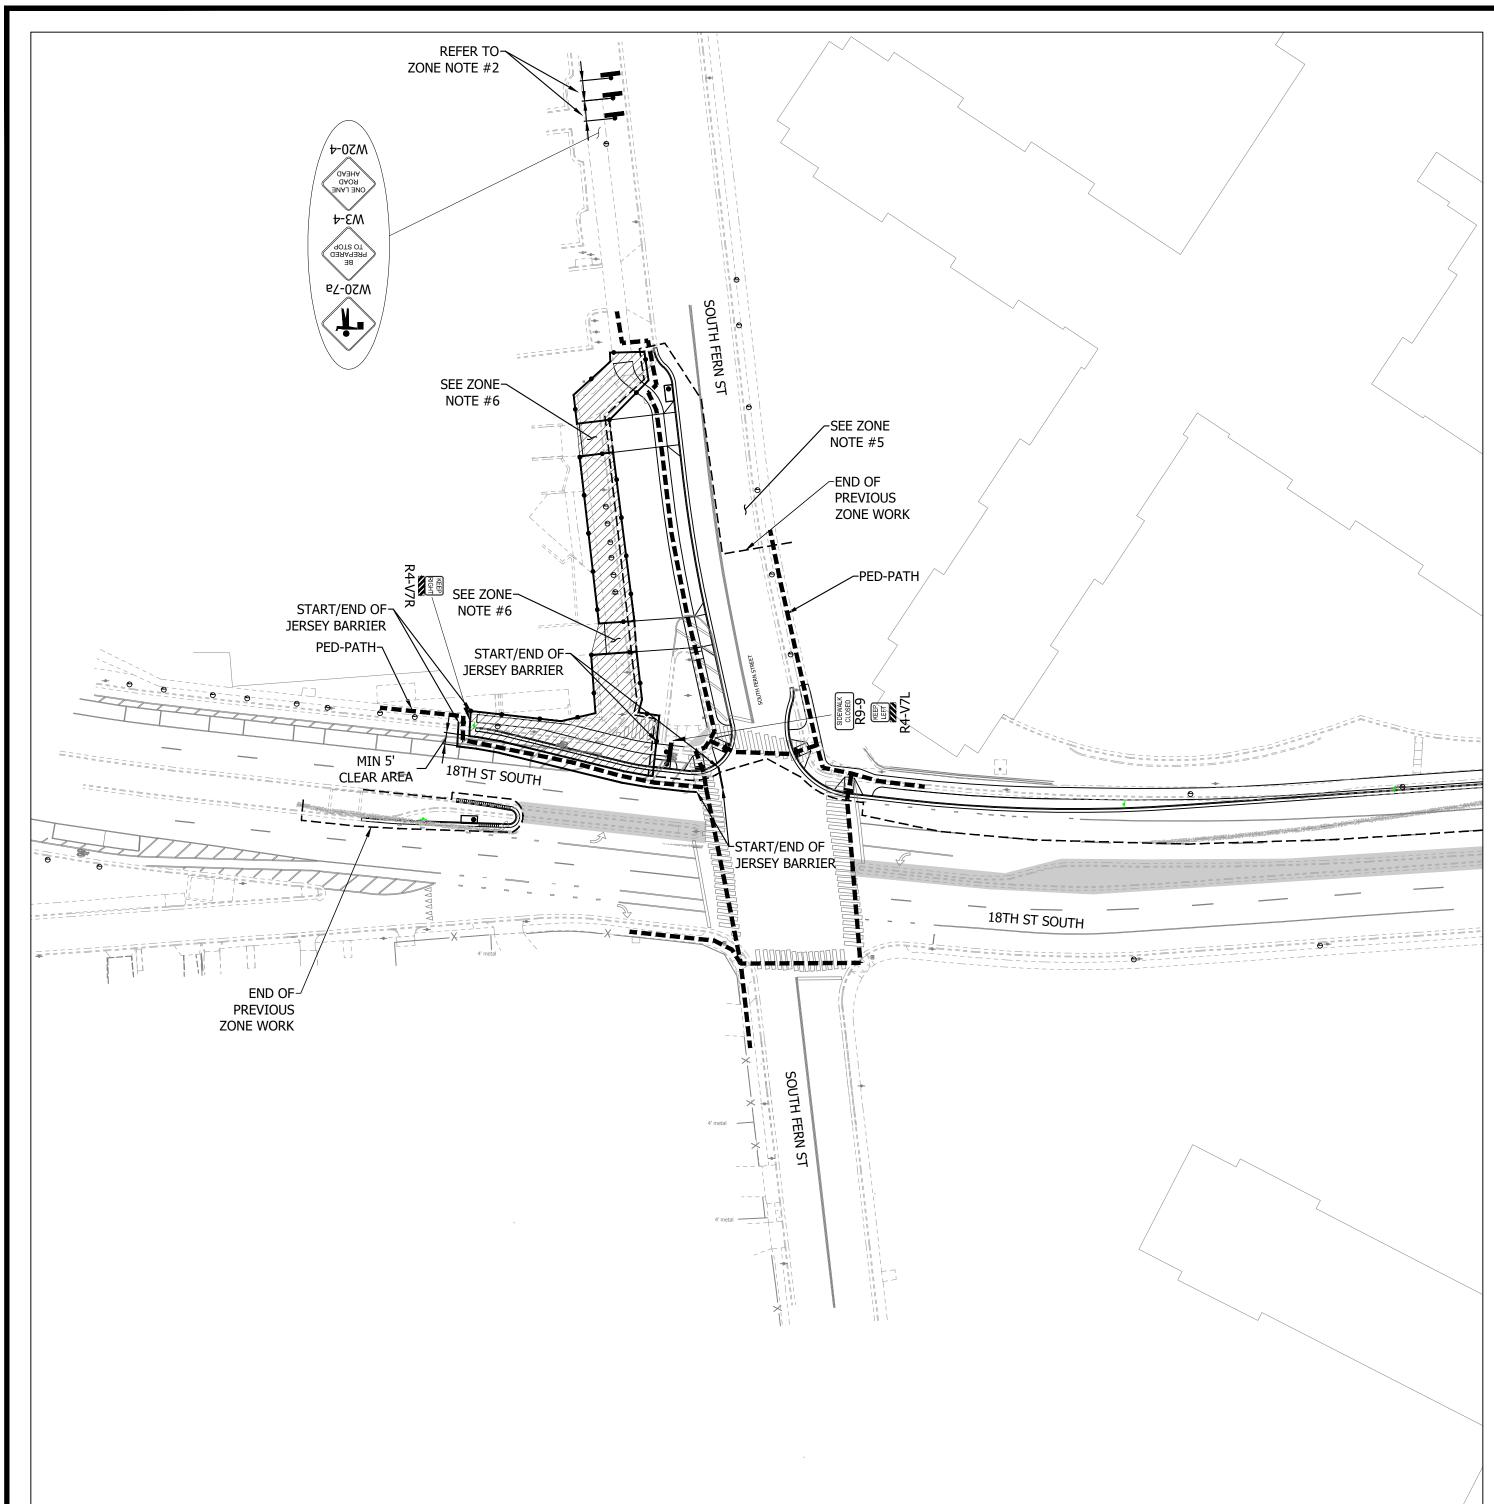

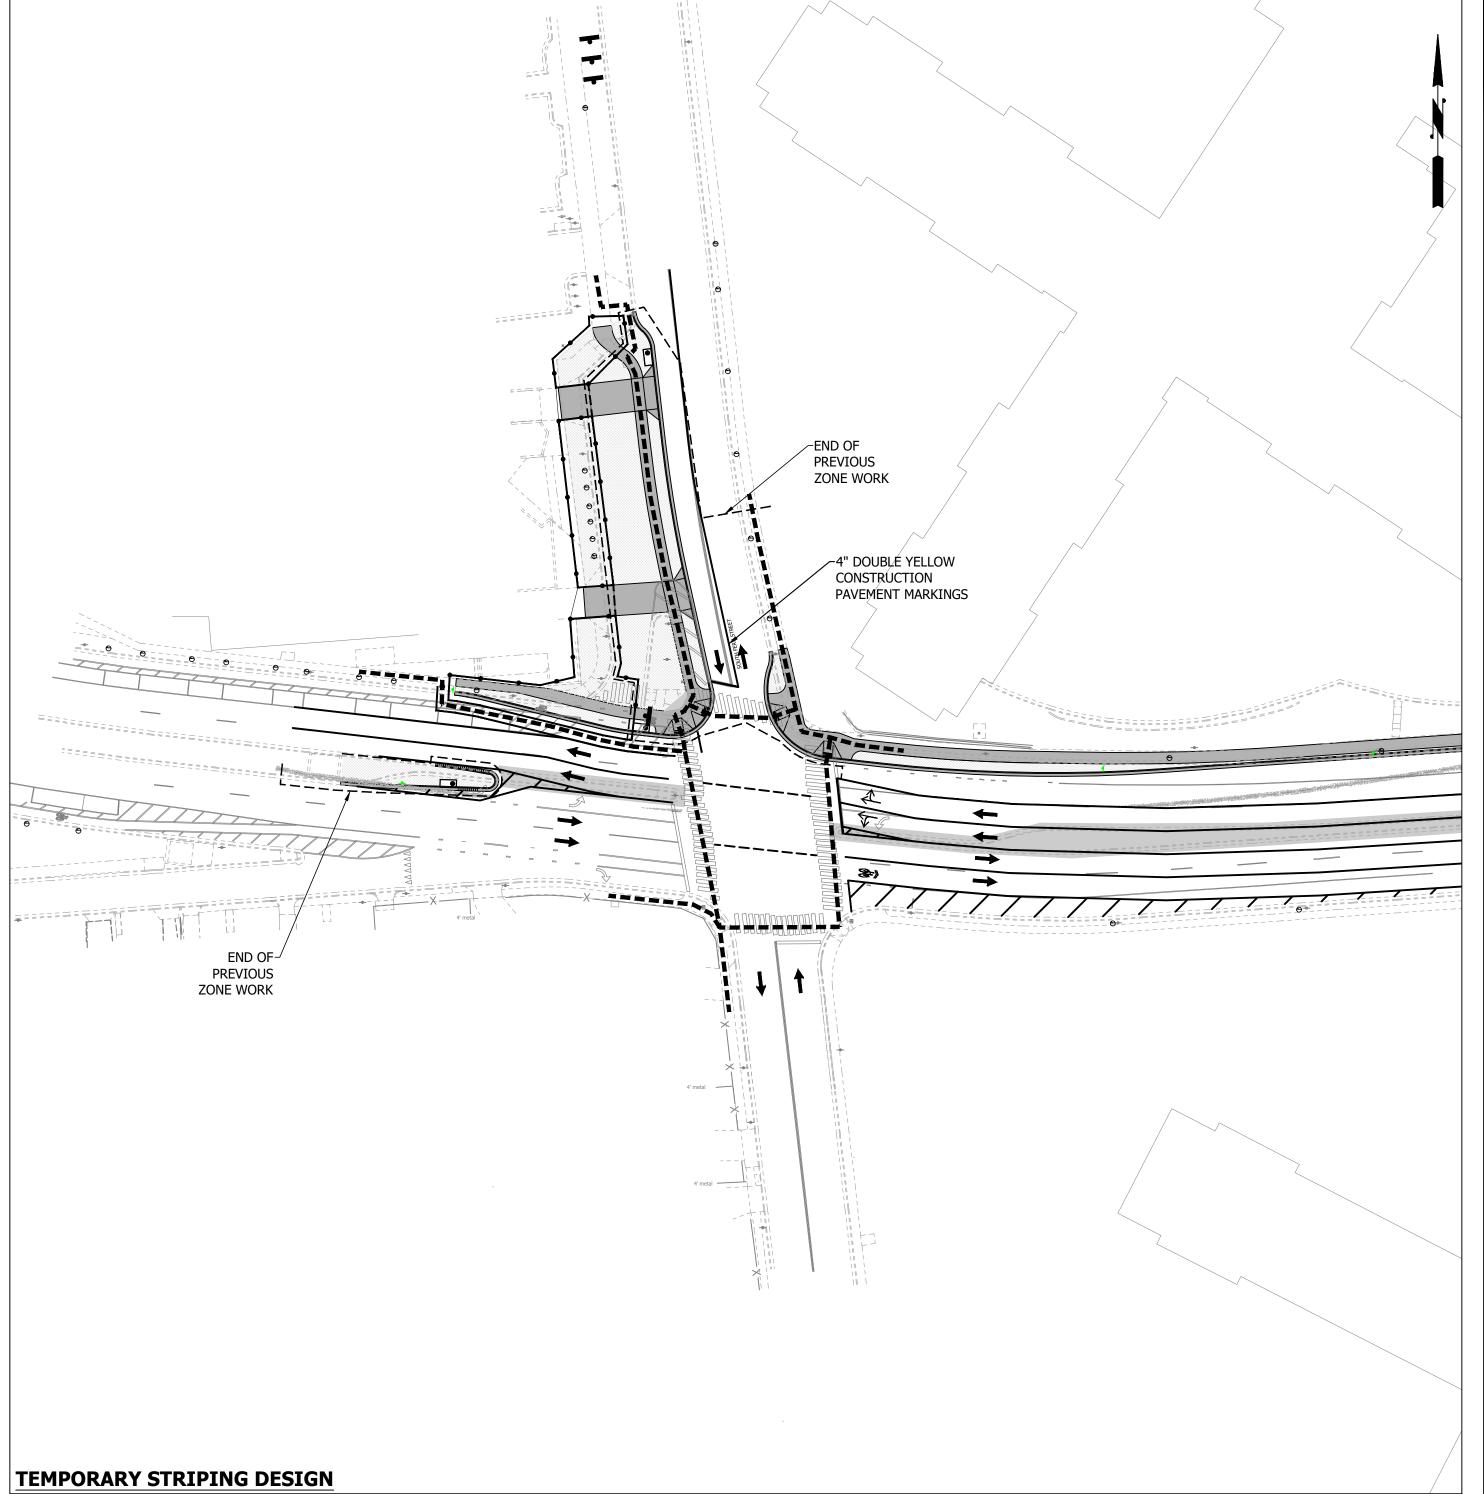

			MOT ZONE TABLE:		
MOT ZONE#	ТТ	-C#	COMMENTS	DURATION	WORK
	VEHICULAR	PEDESTRIAN			HOURS
ZONE# 07	TTC-23.2	TTC-35.1 TTC-36.2	CONTRACTOR TO PULL BACK CHANNELING DEVICES AT THE END OF THE WORK DAY AND RE OPEN CLOSED LANES.	1 MONTH - 3 MONTHS	MONFRI. 9:00AM-4:00PM
			SHADOW VEHICLES SHALL BE UTILIZED AS SHOWN IN THE TTC		

#### **ZONE NOTES:**

- SPEED REDUCTION: CONTRACTOR SHALL PLACE W3-5A SIGN, WITH SPEED LIMIT OF 25 MPH, ON ALL
- 2. <u>WARNING SIGN SPACING:</u> MINIMUM 100' SPACING BETWEEN WARNING SIGNS UNLESS OTHERWISE
- 3. TEMPORARY STRIPING: REFER TO PLAN FOR STRIPING.

-REMOVE AND RESTRIPE THE WESTBOUND SKIP LANE ON 18TH STREET. -REMOVE THE FERN STREET SKIP LANE. AT THE END OF EACH DAY, THE CONTRACTOR SHALL MAKE SURE THAT IT IS CLEAR FOR DRIVES ON THE LANE CONFIGURATION.

- 4. OPTIONAL TTC'S: REQUIRES APPROVE BY THE CONSTRUCTION MANAGER PRIOR TO IMPLEMENTATION
- 5. PARKING IN THIS AREA SHOULD BE BLOCKED OFF.
- 6. COORDINATE WITH THE PROJECT OFFICER PRIOR TO WORK AND CLOSURE OF DRIVEWAY. PROPERTY OWNER SHALL BE NOTIFIED THREE WEEKS BEFORE DRIVEWAY CLOSURE. ADDITIONAL SIGNAGE AND CHANNELIZATION DEVICES MAY BE REQUIRED FOR THE CLOSURE. WORK IN THE DRIVEWAY AREA SHOULD TAKE NO MORE THEN 7-14 DAYS. MAINTAIN AT LEAST ONE DRIVEWAY ENTRANCE OPEN AT ALL
- \* PEDESTRIAN ACCESS SHALL BE MAINTAINED AS SHOWN ON THIS SHEET, UTILIZING THE REFERENCED TTC IN THE MOT ZONE TABLE.

AT THE END OF EACH WORKING DAY, THE CONTRACTOR SHALL PULL BACK **MOT CHANNELIZING DEVICES TO MAINTAIN TWO TRAVEL LANES IN EACH DIRECTION ON 18TH STREET.** 

APPROACHES FOR 18TH STREET.

DIRECTED BY THE CONSTRUCTION MANAGER AND TE&O.


-STRIPING FROM PREVIOUS ZONE TO REMAIN UNLESS NOTED FOR REMOVAL.

ARLINGTON VIRGINIA

DEPARTMENT OF **ENVIRONMENTAL SERVICES** FACILITIES & ENGINEERING DIVISION ENGINEERING BUREAU 2100 CLARENDON BOULEVARD, SUITE 813 ARLINGTON, VA 22201

FAX: 703.228.3606 COPYRIGHT © 2016 ARLINGTON COUNTY

PHONE: 703.228.3629

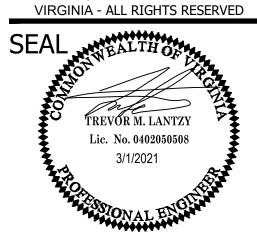

APPROVALS

QUALITY CONTROL ENGINEER 6.26.20 Kamal N. Taktak

CONSTRUCTION MANAGEMENT SUPERVISOR WATER, SEWER, STREETS BUREAU CHIEF Dennis M. Leach 6/24/20

TRANSPORTATION DIRECTOR Sicel Yang PROJECT MANAGER

**REVISIONS** 

SOUTH


DESIGNED: NS DRAWN: NS CHECKED: TL

MISS UTILITY TRANSMITTAL #: XXXX


CC20-286-MOT - ZONE 07.DWG PATH: Q:\DATA\CC20\DESIGN\CAD\\_ACTIVE


PLOTTED: MARCH 1 2021 PLOTTED BY:NSHARP

SCALE:

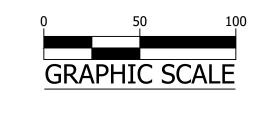

SHEET

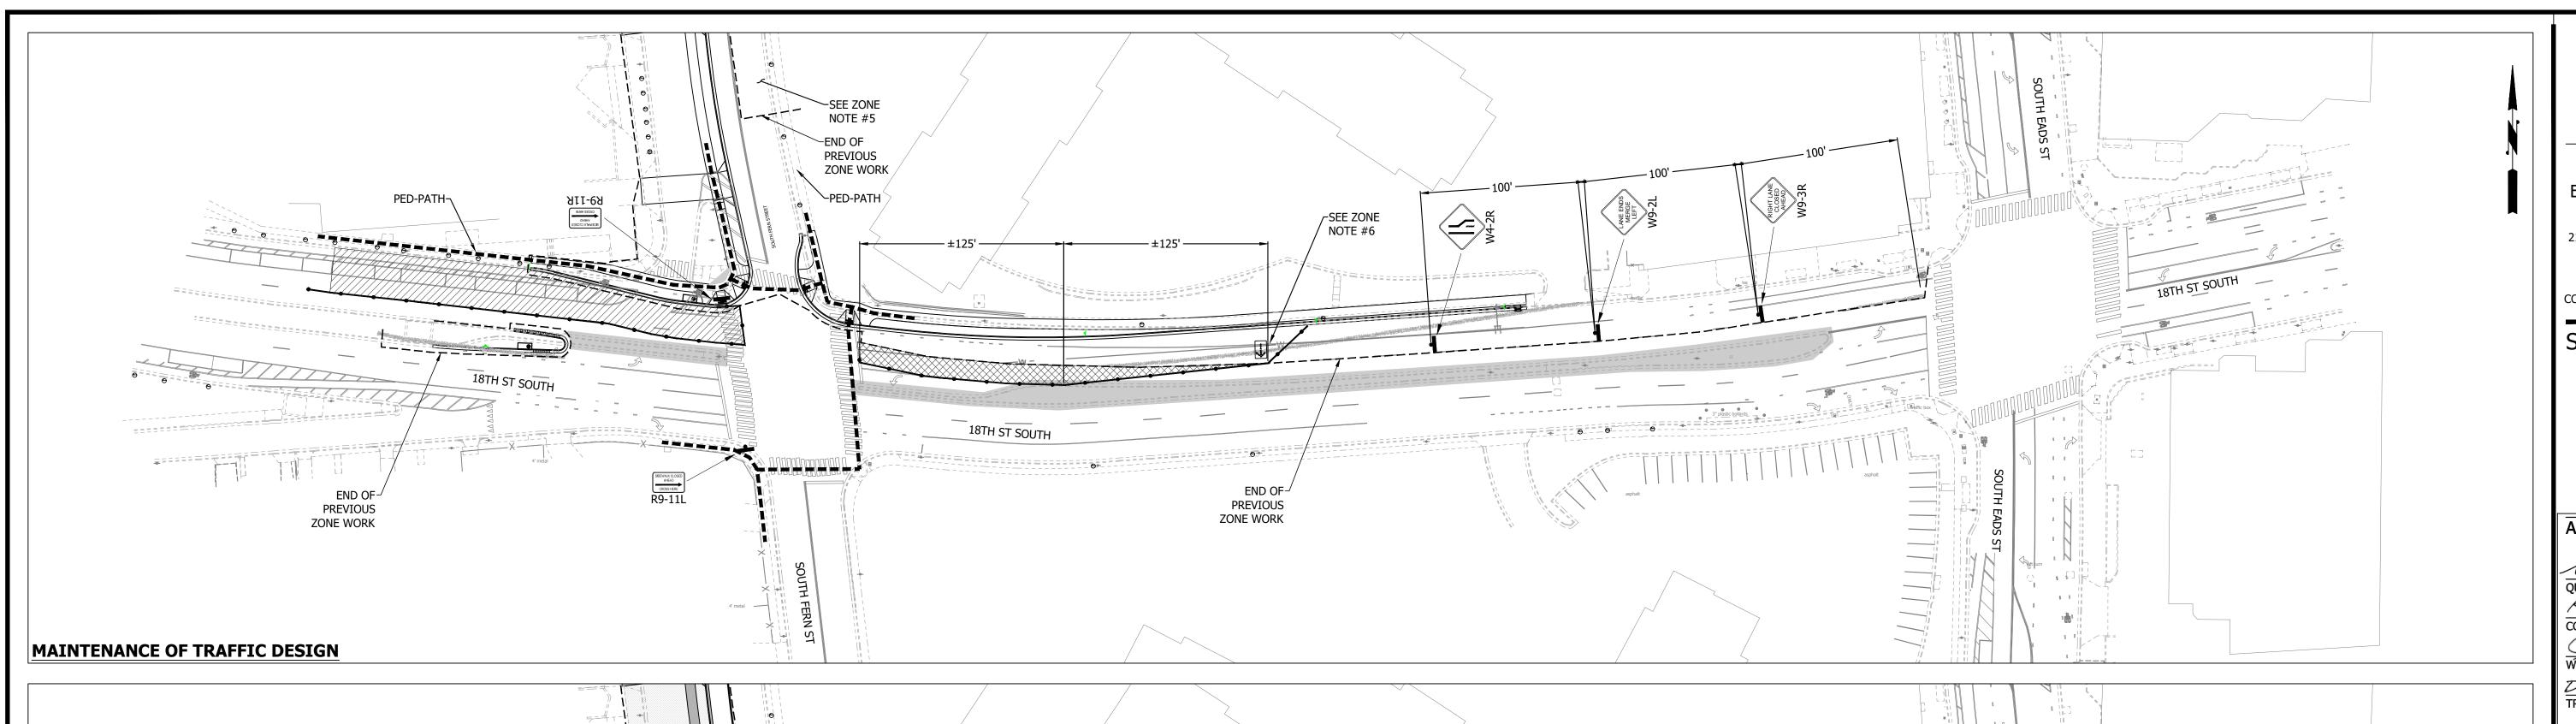

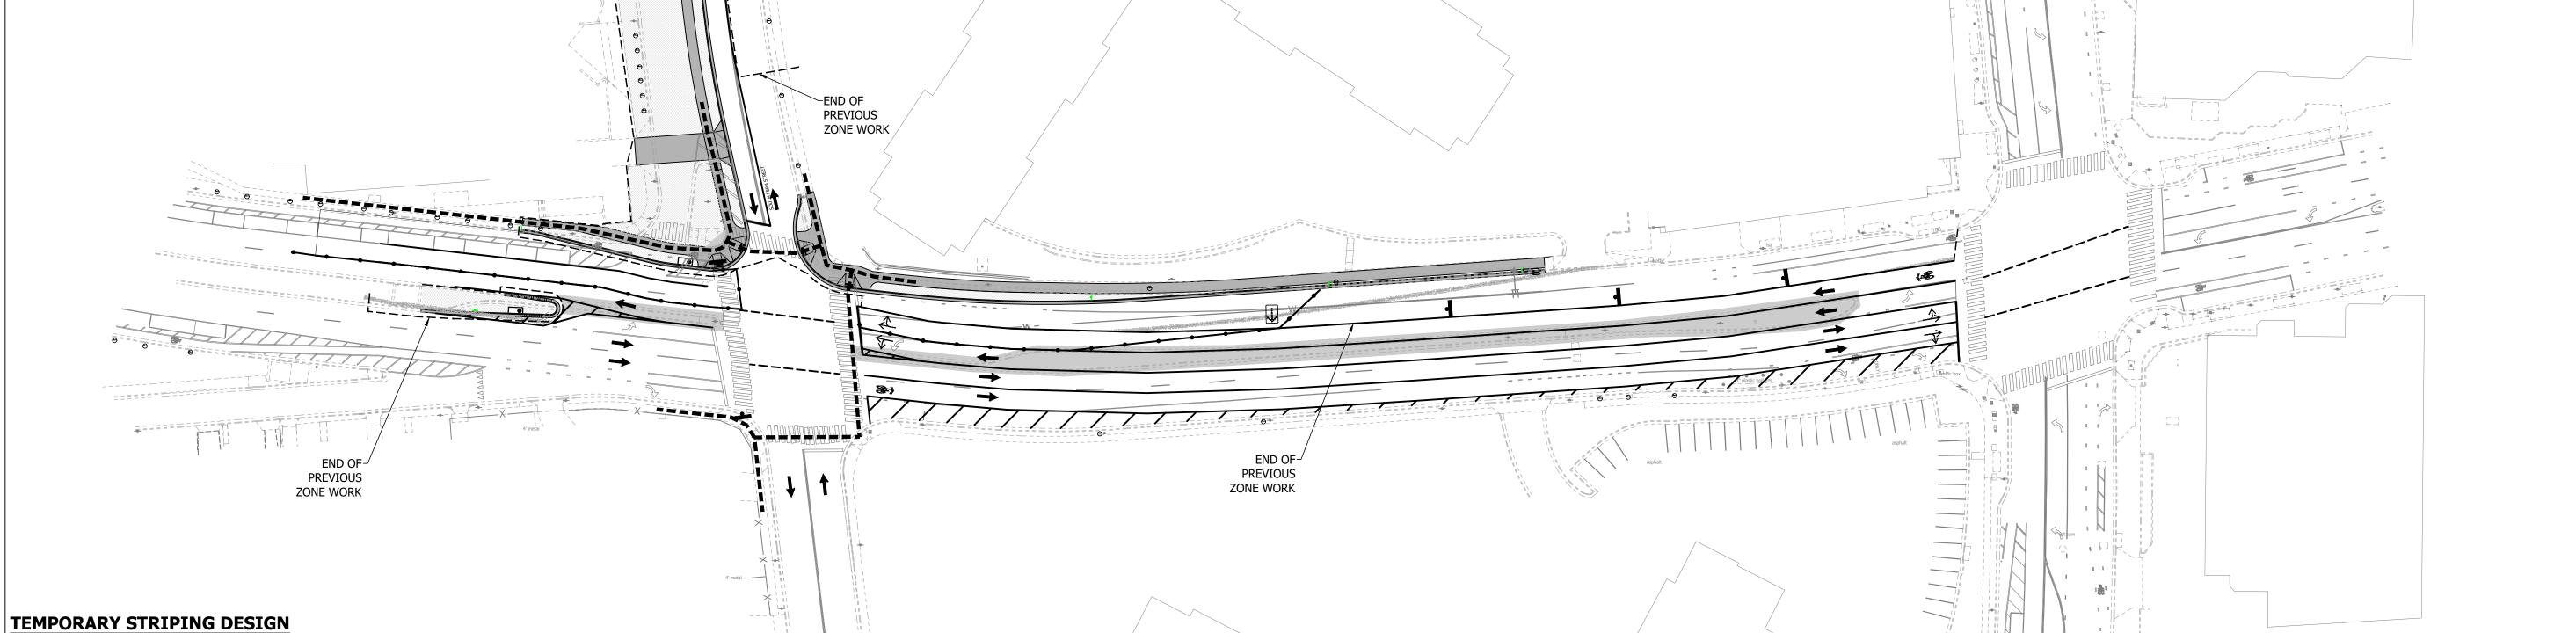

 <u> </u>	<u> </u>		

MOT ZONE TABLE:							
MOT ZONE#	TT	C#	COMMENTS	DURATION	WORK HOURS		
	VEHICULAR	PEDESTRIAN					
ZONE# 08	TTC-27.2	TTC-35.1 TTC-36.2 *	CONTRACTOR TO PULL BACK CHANNELING DEVICES AT THE END OF THE WORK DAY AND REOPEN CLOSED LANES  SHADOW VEHICLES SHALL BE UTILIZED AS SHOWN IN THE TTC	2 WEEKS - 1 MONTH	MONFRI. 9:00AM-4:00PM		

- 1. SPEED REDUCTION: CONTRACTOR SHALL PLACE W3-5A SIGN, WITH SPEED LIMIT OF 25 MPH, ON ALL APPROACHES FOR 18TH STREET.
- WARNING SIGN SPACING: MINIMUM 100' SPACING BETWEEN WARNING SIGNS UNLESS OTHERWISE
- DIRECTED BY THE CONSTRUCTION MANAGER AND TE&O. 3. TEMPORARY STRIPING: REFER TO PLAN FOR STRIPING.
- -STRIPING FROM PREVIOUS ZONE TO REMAIN UNLESS NOTED FOR REMOVAL.
- 5. PARKING IN THIS AREA SHOULD BE BLOCKED OFF.
- 6. ILLUMINATED FLASHING ARROW BOARDS SHALL BE PLACED OUTSIDE TRAVEL LANE
- \* PEDESTRIAN ACCESS SHALL BE MAINTAINED AS SHOWN ON THIS SHEET, UTILIZING THE REFERENCED TTC IN THE MOT ZONE TABLE.

AT THE END OF EACH WORKING DAY, THE CONTRACTOR SHALL PULL BACK **MOT CHANNELIZING DEVICES TO MAINTAIN TWO TRAVEL LANES IN EACH DIRECTION ON 18TH STREET.** 

ARLINGTON

DEPARTMENT OF **ENVIRONMENTAL SERVICES FACILITIES & ENGINEERING DIVISION** ENGINEERING BUREAU 2100 CLARENDON BOULEVARD, SUITE 813 ARLINGTON, VA 22201

COPYRIGHT © 2016 ARLINGTON COUNTY VIRGINIA - ALL RIGHTS RESERVED

PHONE: 703.228.3629 FAX: 703.228.3606



APPROVALS

QUALITY CONTROL ENGINEER 6.26.20 Kamal N. Taktak

WATER, SEWER, STREETS BUREAU CHIEF Dennis M. Leach
TRANSPORTATION DIRECTOR

6/24/20

PROJECT MANAGER

**REVISIONS** 


DESIGNED: NS DRAWN: NS

CHECKED: TL MISS UTILITY TRANSMITTAL #: XXXX


FILENAME: CC20-286-MOT - ZONE 08.DWG PATH: Q:\DATA\CC20\DESIGN\CAD\\_ACTIVE


PLOTTED: MARCH 1 2021 PLOTTED BY:NSHARP

SCALE:

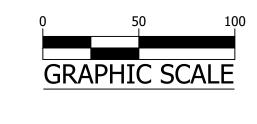

SHEET

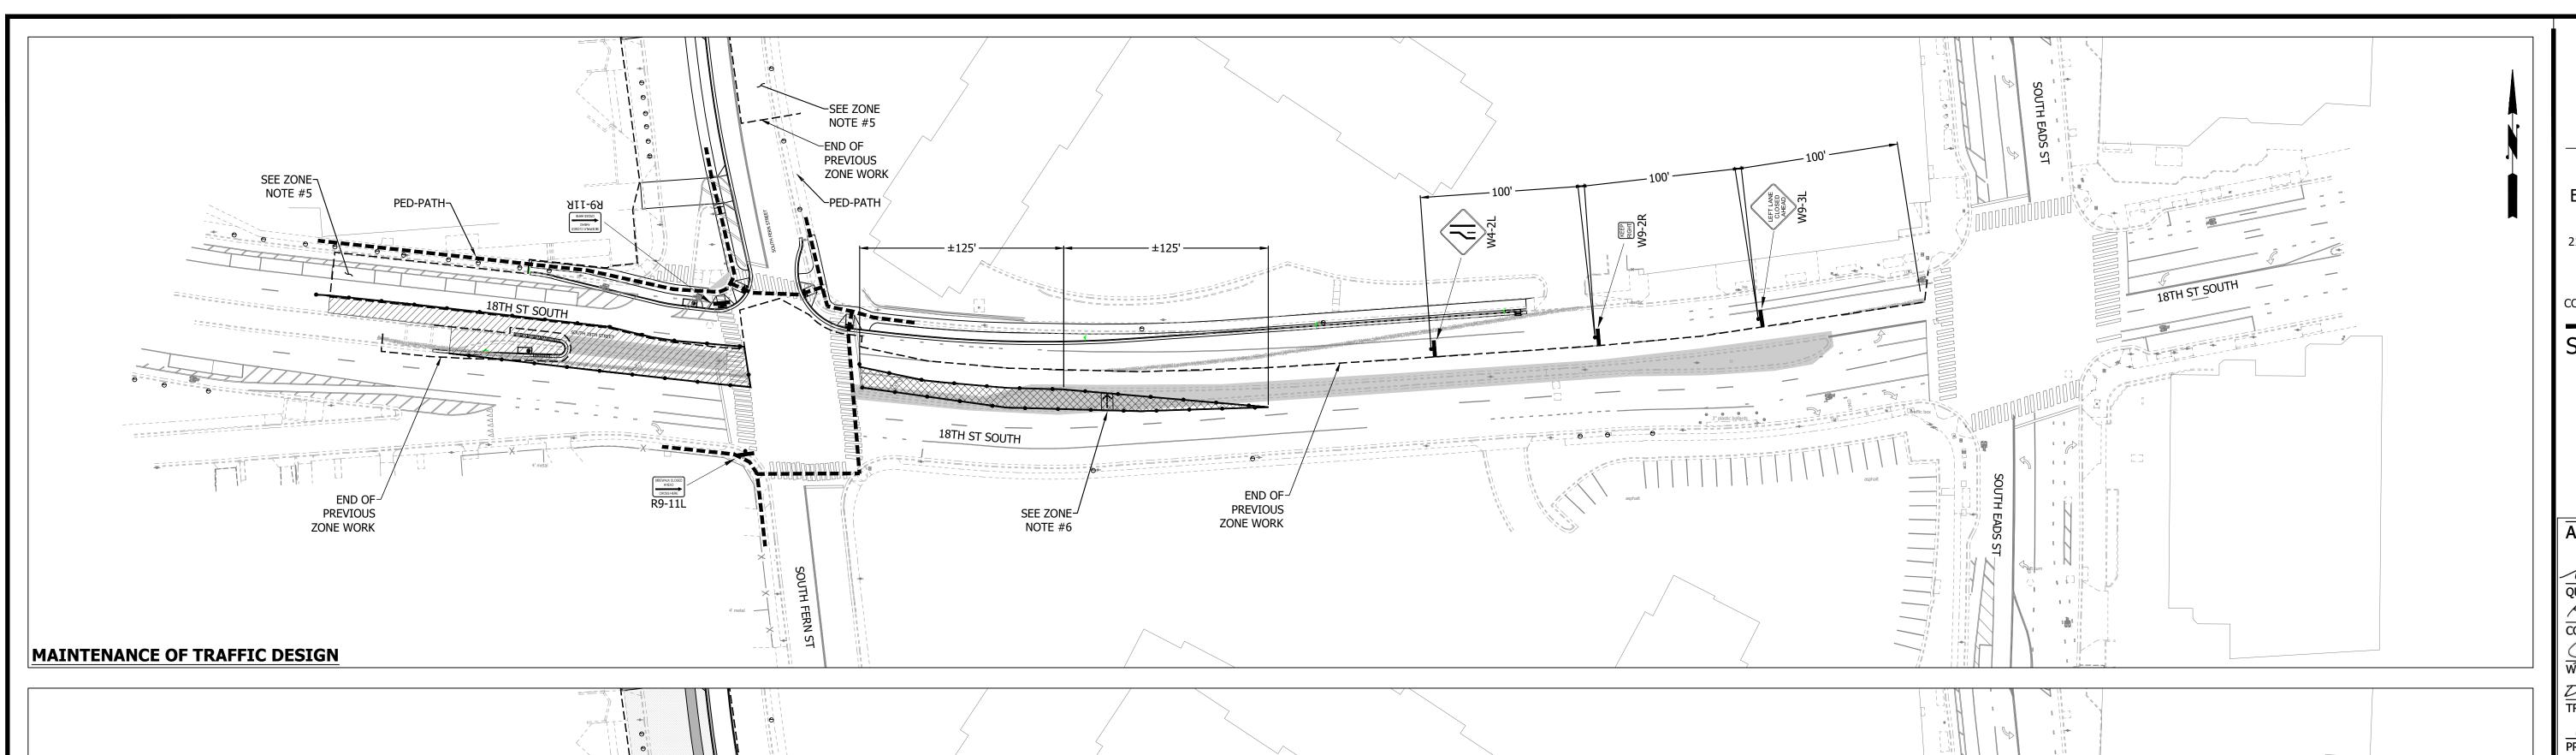

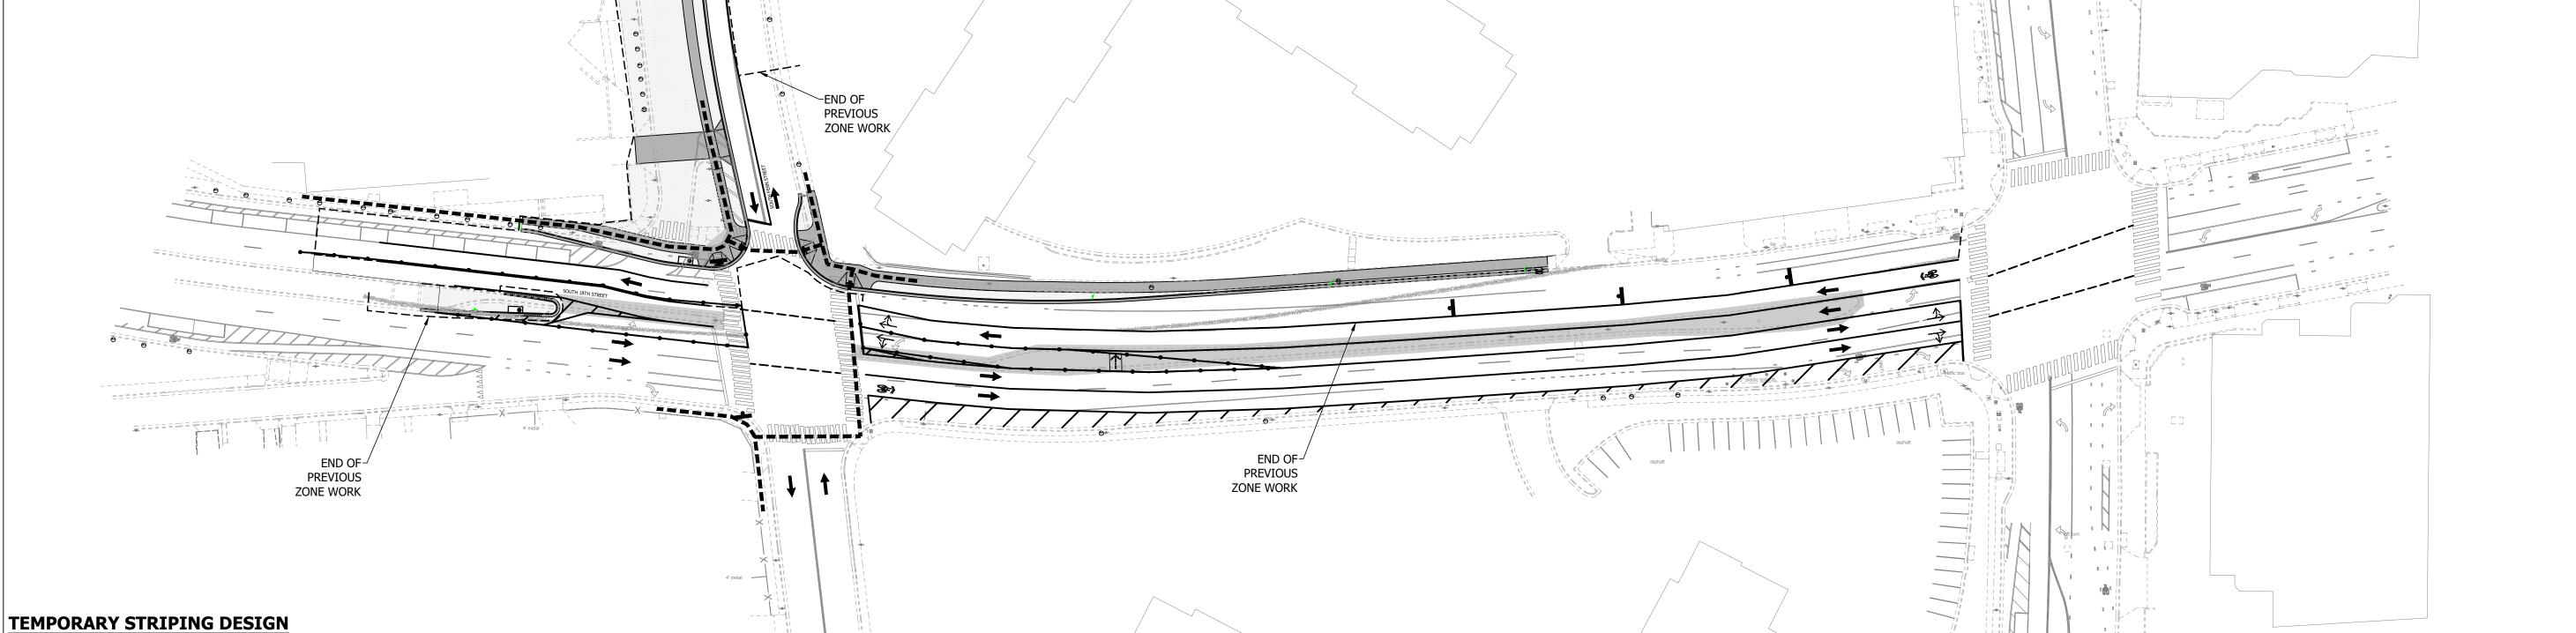

	MOT ZONE TABLE:								
MOT ZONE#	П	TTC# COMMENTS		DURATION	WORK				
	VEHICULAR	PEDESTRIAN		DOIGNION	HOURS				
ZONE# 09	TTC-27.2	TTC-35.1 TTC-36.2	CONTRACTOR TO PULL BACK CHANNELING DEVICES AT THE END OF THE WORK DAY AND REOPEN CLOSED LANES	2 WEEKS -	MONFRI.				

SHADOW VEHICLES SHALL BE UTILIZED AS SHOWN IN THE TTC

#### **ZONE NOTES:**

9:00AM-4:00PM

1 MONTH

- 1. SPEED REDUCTION: CONTRACTOR SHALL PLACE W3-5A SIGN, WITH SPEED LIMIT OF 25 MPH, ON ALL APPROACHES FOR 18TH STREET.
- WARNING SIGN SPACING: MINIMUM 100' SPACING BETWEEN WARNING SIGNS UNLESS OTHERWISE
- DIRECTED BY THE CONSTRUCTION MANAGER AND TE&O. 3. TEMPORARY STRIPING: REFER TO PLAN FOR STRIPING.
- -STRIPING FROM PREVIOUS ZONE TO REMAIN UNLESS NOTED FOR REMOVAL.
- 4. OPTIONAL TTC'S: REQUIRES APPROVE BY THE CONSTRUCTION MANAGER PRIOR TO IMPLEMENTATION
- 5. PARKING IN THIS AREA SHOULD BE BLOCKED OFF.
- 6. ILLUMINATED FLASHING ARROW BOARDS SHALL BE PLACED OUTSIDE TRAVEL LANE
- \* PEDESTRIAN ACCESS SHALL BE MAINTAINED AS SHOWN ON THIS SHEET, UTILIZING THE REFERENCED TTC IN THE MOT ZONE TABLE.


AT THE END OF EACH WORKING DAY, THE CONTRACTOR SHALL PULL BACK **MOT CHANNELIZING DEVICES TO MAINTAIN TWO TRAVEL LANES IN EACH DIRECTION ON 18TH STREET.** 

ARLINGTON

DEPARTMENT OF **ENVIRONMENTAL SERVICES FACILITIES & ENGINEERING DIVISION** ENGINEERING BUREAU 2100 CLARENDON BOULEVARD, SUITE 813 ARLINGTON, VA 22201

COPYRIGHT © 2016 ARLINGTON COUNTY VIRGINIA - ALL RIGHTS RESERVED

PHONE: 703.228.3629 FAX: 703.228.3606

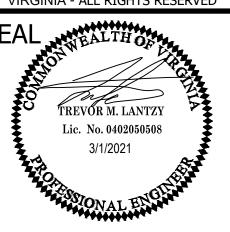

APPROVALS

QUALITY CONTROL ENGINEER 6.26.20 Kamal N. Taktak

WATER, SEWER, STREETS BUREAU CHIEF Dennis W. Leach
TRANSPORTATION DIRECTOR

6/24/20

PROJECT MANAGER

**REVISIONS** 


DESIGNED: NS CHECKED: TL

MISS UTILITY TRANSMITTAL #: XXXX FILENAME:


CC20-286-MOT - ZONE 09.DWG PATH: Q:\DATA\CC20\DESIGN\CAD\\_ACTIVE


PLOTTED: MARCH 1 2021 PLOTTED BY:NSHARP

SCALE:

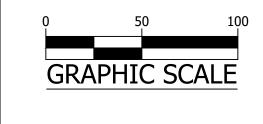

SHEET

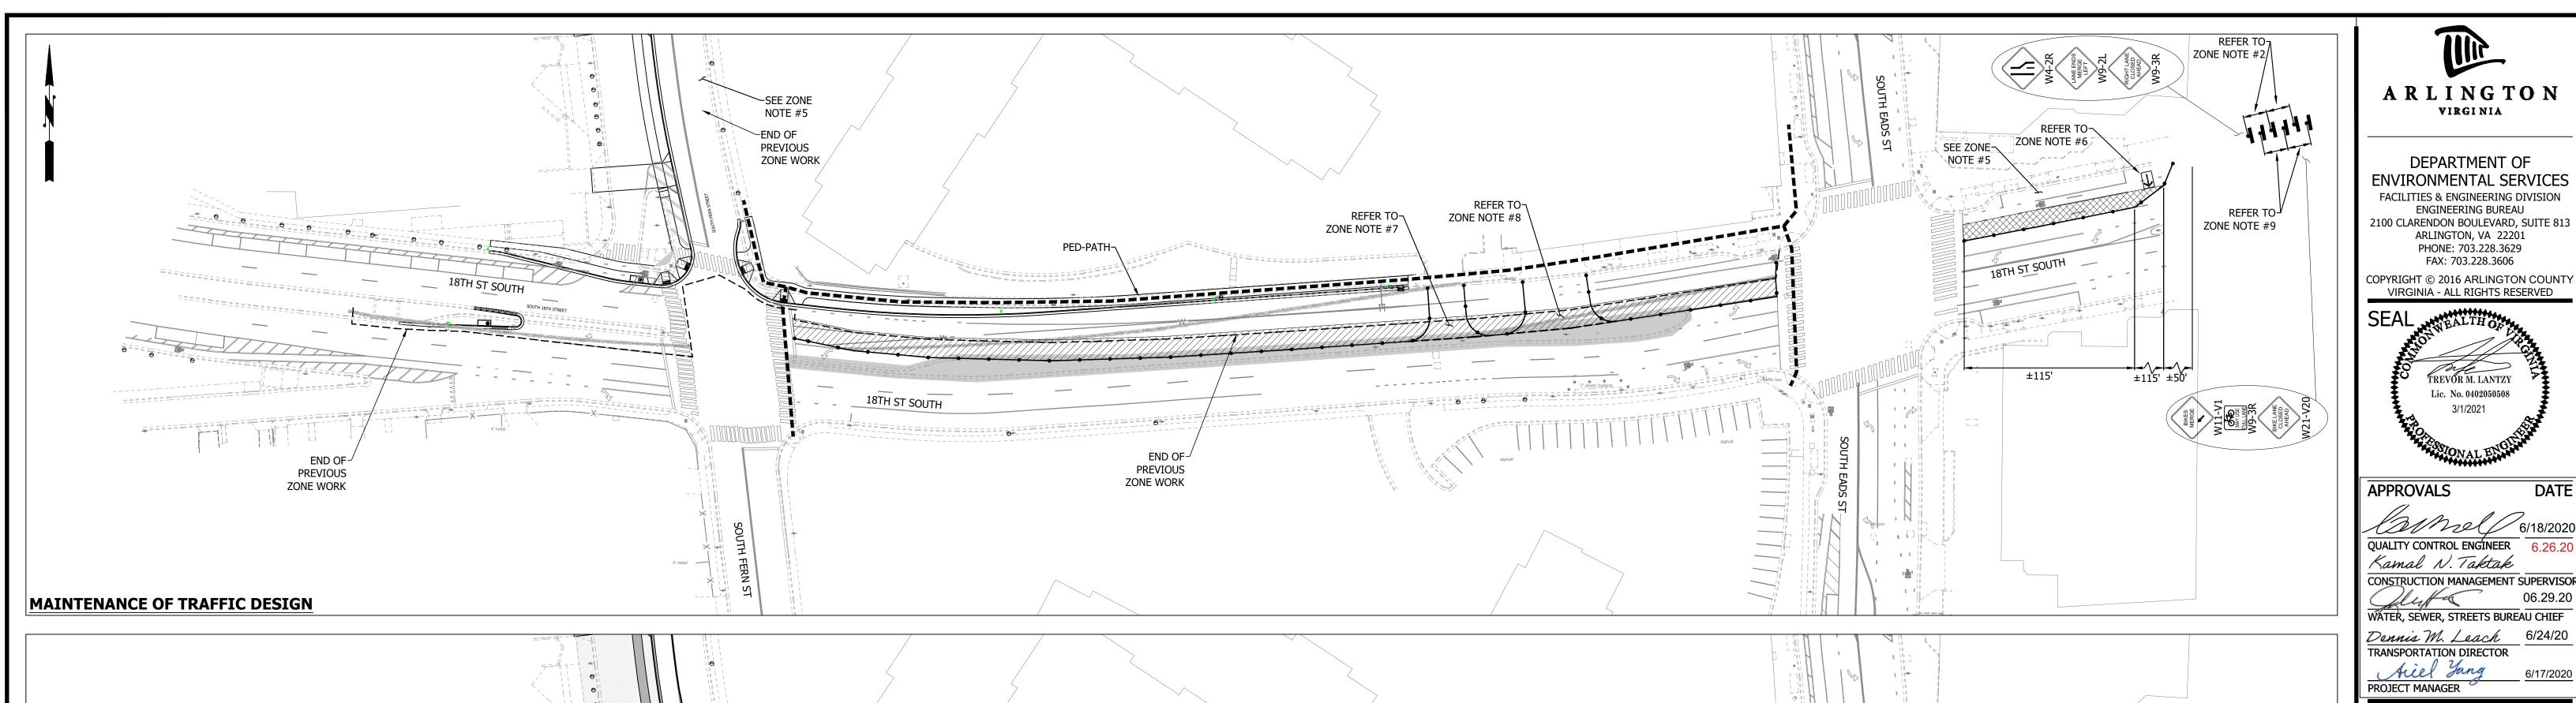

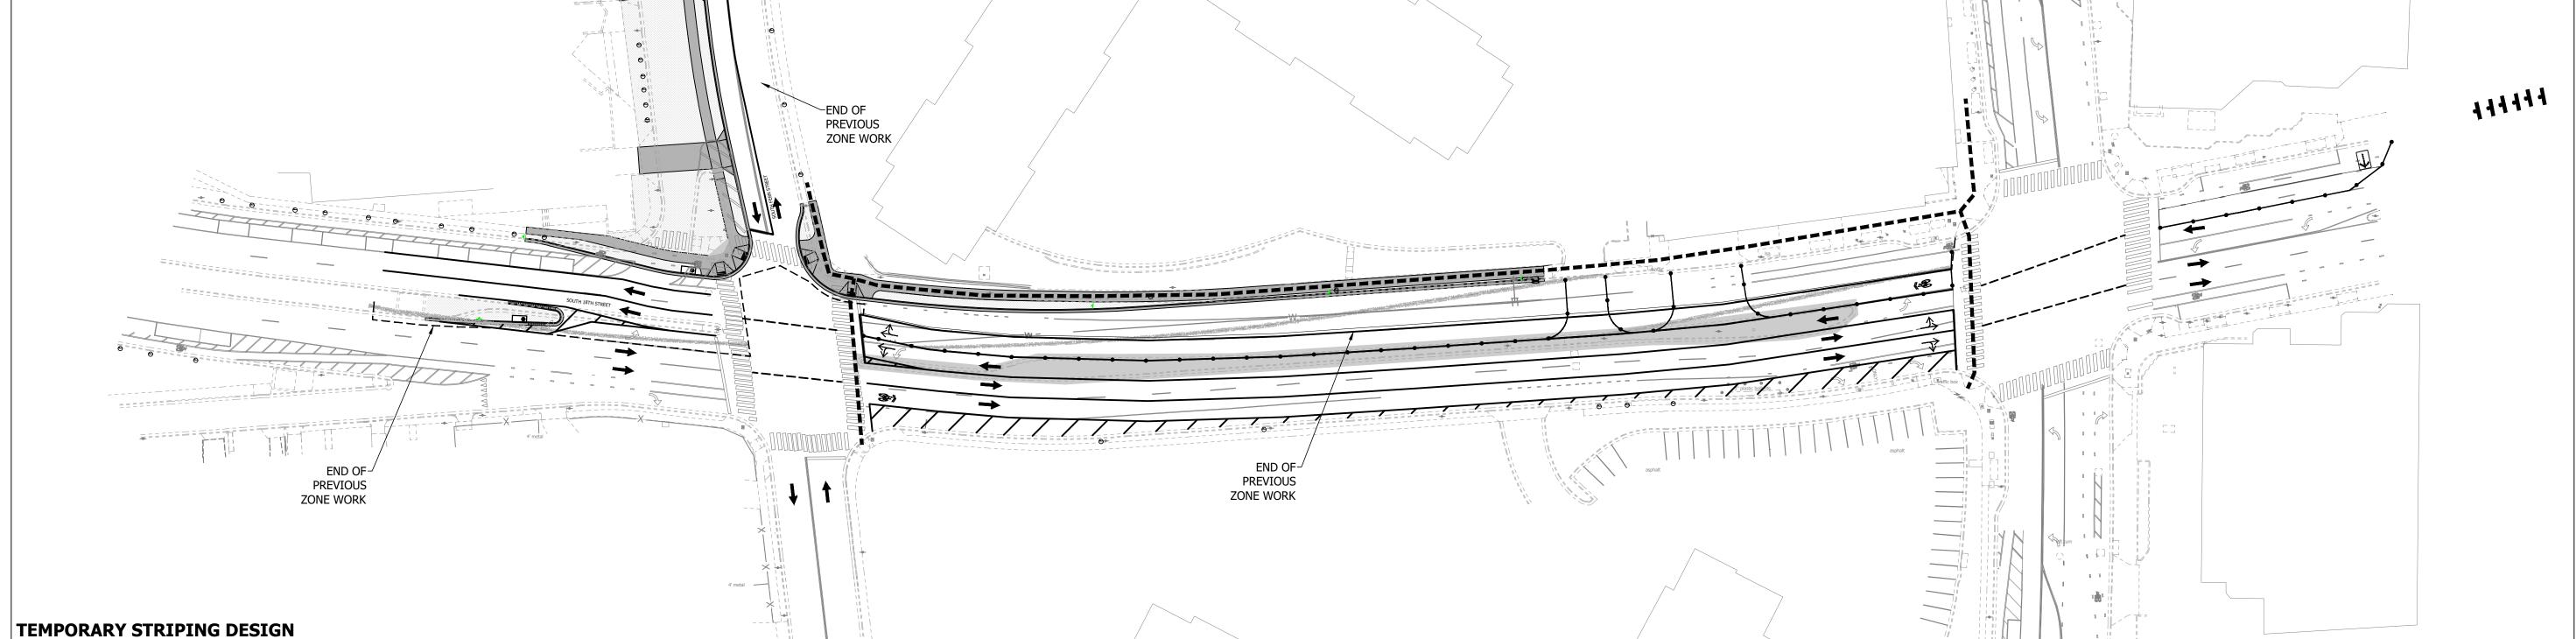

			MOT ZONE TABLE:	
MOT ZONE#	TTC#		COMMENTS	DURATION
	VEHICULAR	PEDESTRIAN		DOIVITOR

MOT ZONE#	:#   П	-C#	COMMENTS	DURATION	WORK HOURS
		PEDESTRIAN			
ZONE# 10	TTC-27.2		CONTRACTOR TO PULL BACK CHANNELING DEVICES AT THE END OF THE WORK DAY AND REOPEN CLOSED LANES SHADOW VEHICLES SHALL BE UTILIZED AS SHOWN IN THE TTC	1 MONTH - 3 MONTHS	MONFRI. 9:00AM-4:00PM

AT THE END OF EACH WORKING DAY, THE CONTRACTOR SHALL PULL BACK **MOT CHANNELIZING DEVICES TO** MAINTAIN TWO TRAVEL LANES IN **EACH DIRECTION ON 18TH STREET.** 

#### **ZONE NOTES:**


- 1. SPEED REDUCTION: CONTRACTOR SHALL PLACE W3-5A SIGN, WITH SPEED LIMIT OF 25 MPH, ON ALL APPROACHES FOR 18TH STREET.
- WARNING SIGN SPACING: MINIMUM 100' SPACING BETWEEN WARNING SIGNS UNLESS OTHERWISE
- DIRECTED BY THE CONSTRUCTION MANAGER AND TE&O. 3. TEMPORARY STRIPING: REFER TO PLAN FOR STRIPING.
- -STRIPING FROM PREVIOUS ZONE TO REMAIN UNLESS NOTED FOR REMOVAL.
- 4. OPTIONAL TTC'S: REQUIRES APPROVE BY THE CONSTRUCTION MANAGER PRIOR TO IMPLEMENTATION 16.2 OUTSIDE LANE CLOSURE OPERATIONS ON A FOUR-LANE ROADWAY
- -FIRST CHANNELING DEVICE DEVICE SHALL BE PLACED GREATER THAN 50' FROM AN INTERSECTION 5. PARKING IN THIS AREA SHOULD BE BLOCKED OFF.
- 6. ILLUMINATED FLASHING ARROW BOARDS SHALL BE PLACED OUTSIDE TRAVEL LANE
- COORDINATE WITH THE PROJECT OFFICER PRIOR TO WORK AND CLOSURE OF THE DRIVEWAY. PROPERTY OWNER SHALL BE NOTIFIED THREE WEEKS BEFORE DRIVEWAY CLOSURE. ADDITIONAL SIGNAGE AND CHANNELIZATION DEVICES MAY BE REQUIRED FOR THE CLOSURE. WORK IN THE DRIVEWAY AREA SHOULD TAKE NOT MORE THE 3-5 DAYS.
- 8. COORDINATE WITH THE PROJECT OFFICER PRIOR TO WORK AND CLOSURE OF THE DRIVEWAY. ONLY HALF OF THE DRIVEWAY SHALL BE CLOSED AT A TIME TO ALLOW FOR VEHICLES TO ENTER AND EXIT. PROPERTY OWNER SHALL BE NOTIFIED THREE WEEKS BEFORE DRIVEWAY CLOSURE. ADDITIONAL SIGNAGE AND CHANNELIZATION DEVICES MAY BE REQUIRED FOR THE CLOSURE. WORK ON EACH HALF OF THE DRIVEWAY SHOULD TAKE NO MORE THEN 2-3 DAYS.
- 9. BIKE LANE CLOSURE SIGNAGE TO BE PLACED IN BETWEEN ROAD WARNING SIGNS AND BE VISIBLE FOR BOTH VEHICLES AND BIKES.
- \* PEDESTRIAN ACCESS SHALL BE MAINTAINED AS SHOWN ON THIS SHEET, UTILIZING THE REFERENCED TTC IN THE MOT ZONE TABLE AND THE BICYCLE LANE CLOSURE, FROM THE VIRGINIA DEPARTMENT OF TRANSPORTATION WORK ZONE PEDESTRIAN AND BICYCLE GUIDANCE (LATEST EDITION)



DEPARTMENT OF **ENVIRONMENTAL SERVICES FACILITIES & ENGINEERING DIVISION** ENGINEERING BUREAU 2100 CLARENDON BOULEVARD, SUITE 813 ARLINGTON, VA 22201

> PHONE: 703.228.3629 FAX: 703.228.3606

COPYRIGHT © 2016 ARLINGTON COUNT VIRGINIA - ALL RIGHTS RESERVED

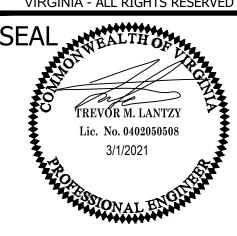

APPROVALS

QUALITY CONTROL ENGINEER Kamal N. Taktak

WATER, SEWER, STREETS BUREAU CHIEF Dennis M. Leach 6/24/20 TRANSPORTATION DIRECTOR

PROJECT MANAGER

REVISIONS

SOUTH

0

DESIGNED: NS DRAWN: NS CHECKED: TL

MISS UTILITY TRANSMITTAL #: XXXX FILENAME:


CC20-286-MOT - ZONE 10.DWG PATH: Q:\DATA\CC20\DESIGN\CAD\\_ACTIVE


PLOTTED: MARCH 1 2021 PLOTTED BY:NSHARP

SCALE:

**GRAPHIC SCALE** 

SHEET

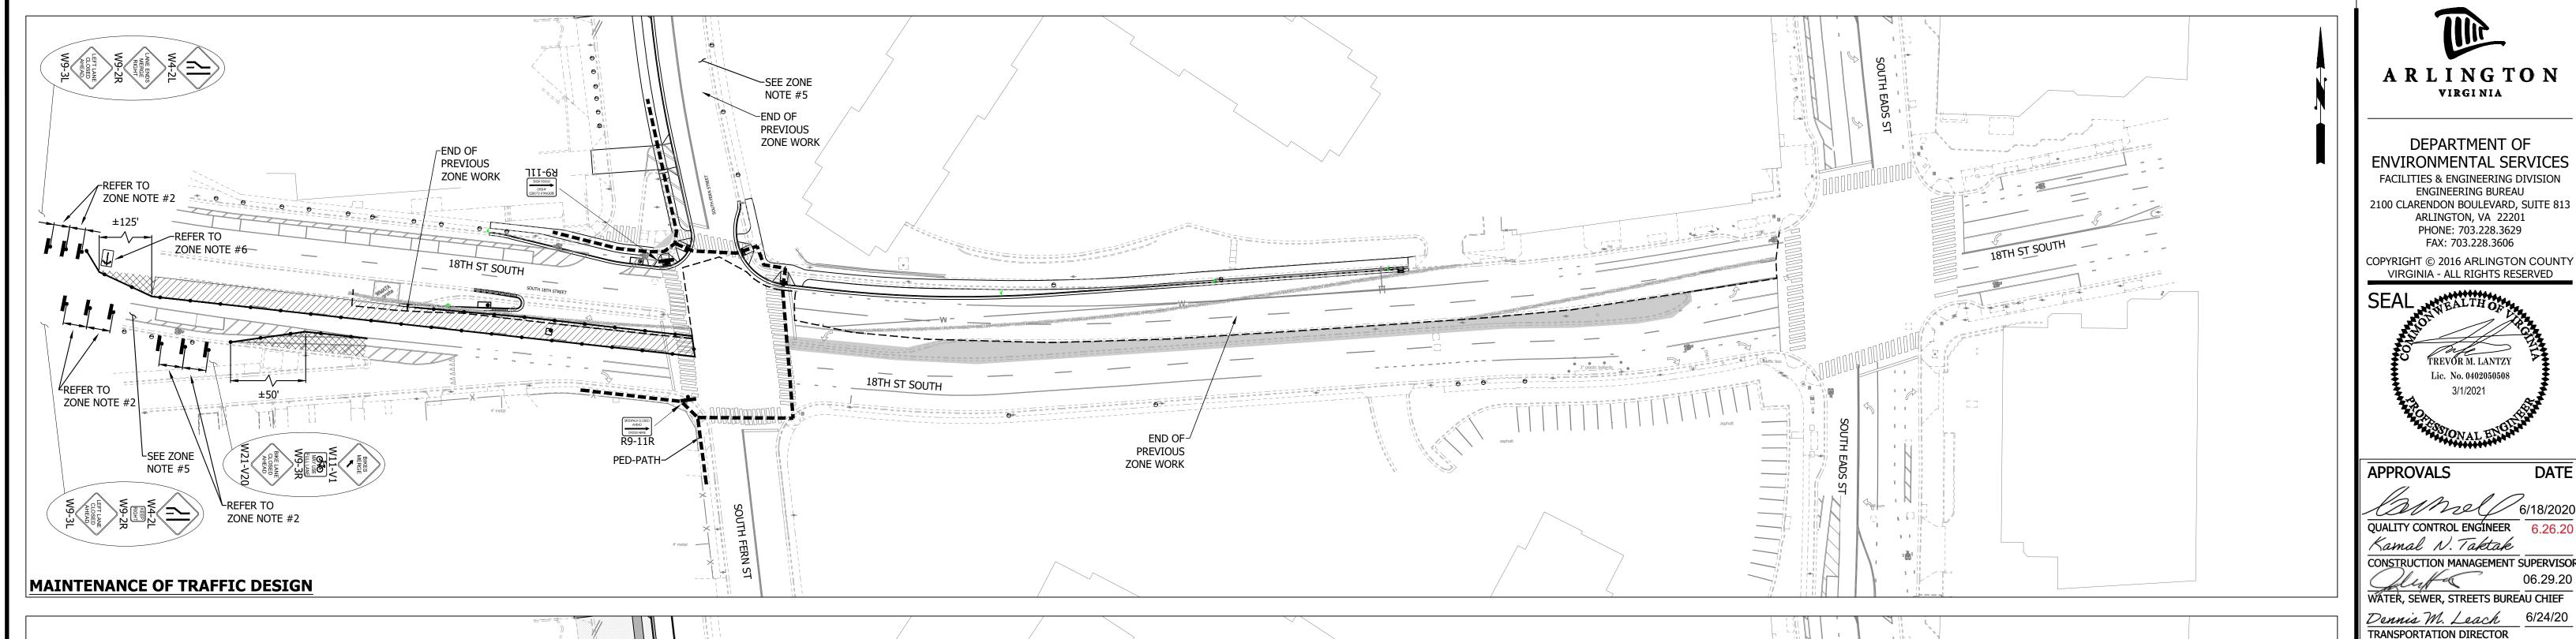

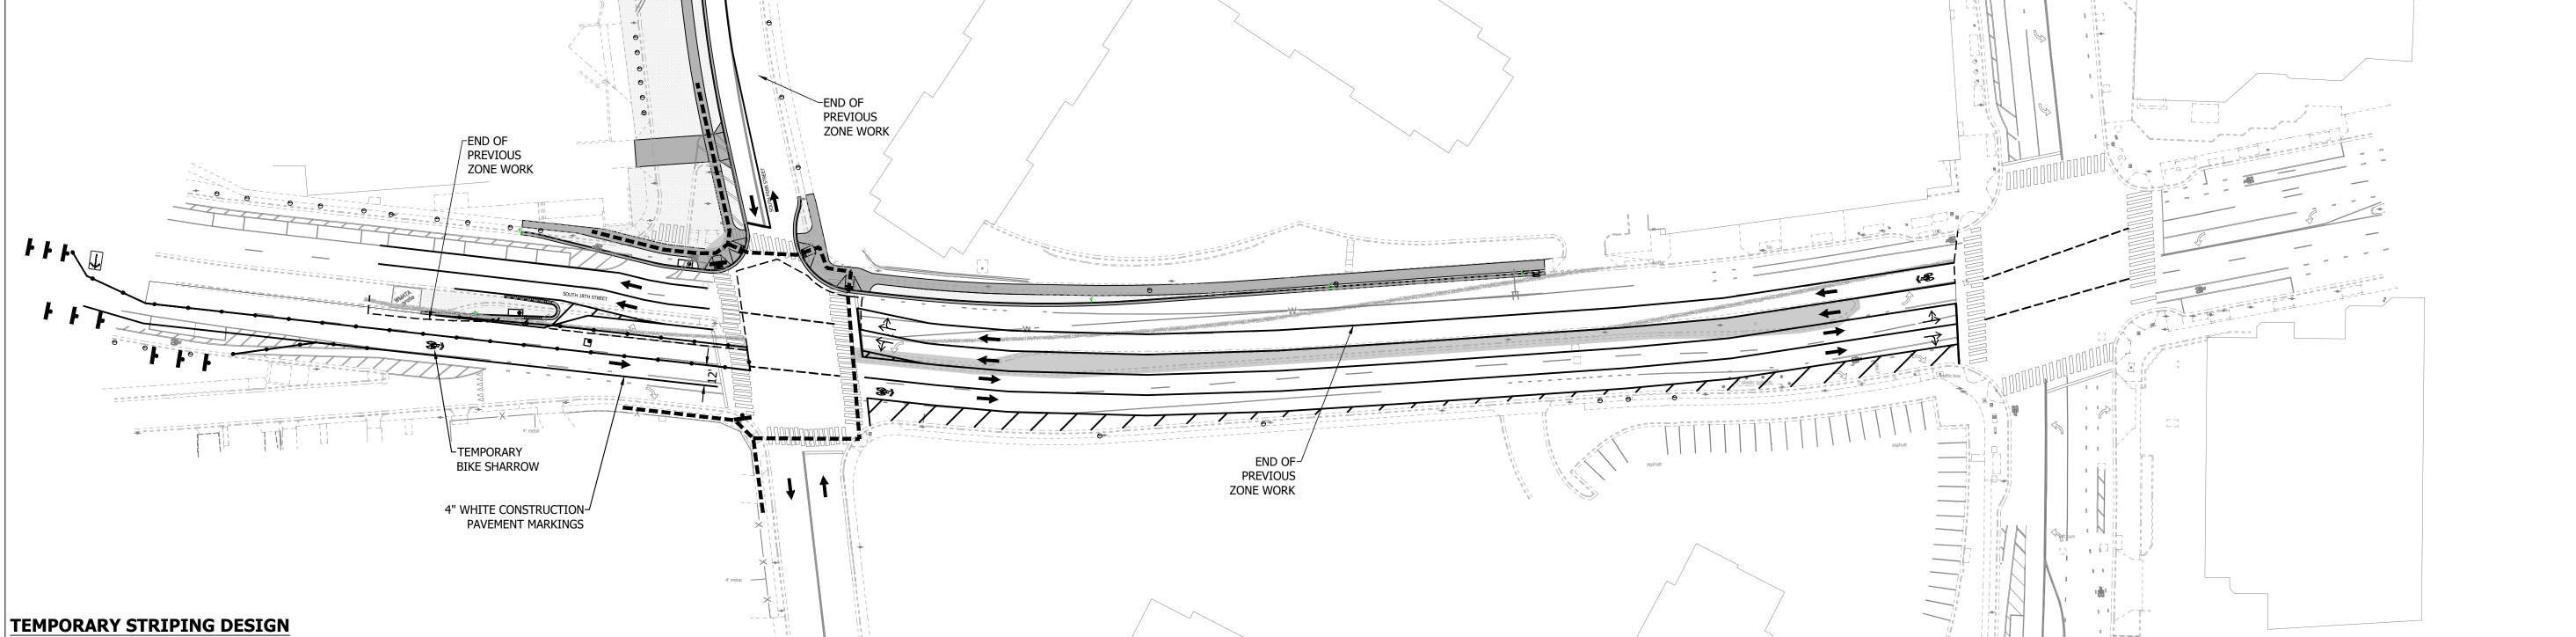

MOT ZONE TABLE:										
MOT ZONE#	TTC#		COMMENTS	DURATION	WORK HOURS					
	VEHICULAR PEDESTRIAN									
ZONE# 11	TTC-26.2	TTC-35.1 TTC-36.2 *	CONTRACTOR TO PULL BACK CHANNELING DEVICES AT THE END OF THE WORK DAY AND REOPEN CLOSED LANES  SHADOW VEHICLES SHALL BE UTILIZED AS SHOWN IN THE TTC	1 MONTH - 2 MONTHS	MONFRI. 9:00AM-4:00PM					

- 1. SPEED REDUCTION: CONTRACTOR SHALL PLACE W3-5A SIGN, WITH SPEED LIMIT OF 25 MPH, ON ALL APPROACHES FOR 18TH STREET.
- WARNING SIGN SPACING: MINIMUM 100' SPACING BETWEEN WARNING SIGNS UNLESS OTHERWISE
- DIRECTED BY THE CONSTRUCTION MANAGER AND TE&O.
- 3. TEMPORARY STRIPING: REFER TO PLAN FOR STRIPING.
- -STRIPING FROM PREVIOUS ZONE TO REMAIN UNLESS NOTED FOR REMOVAL. -MINIMUM 50' TAPER FROM EXISTING STRIPING TO PROPOSED TEMP. STRIPING ON EASTBOUND
- -MAKE SURE THAT TEMP. CROSSWALK STRIPING IS IN PLACE AS NEEDED. 4. OPTIONAL TTC'S: REQUIRES APPROVE BY THE CONSTRUCTION MANAGER PRIOR TO IMPLEMENTATION
- 5. PARKING IN THIS AREA SHOULD BE BLOCKED OFF.
- 6. ILLUMINATED FLASHING ARROW BOARDS SHALL BE PLACED OUTSIDE TRAVEL LANE
- \* PEDESTRIAN ACCESS SHALL BE MAINTAINED AS SHOWN ON THIS SHEET, UTILIZING THE REFERENCED TTC IN THE MOT ZONE TABLE AND THE BICYCLE LANE CLOSURE, FROM THE VIRGINIA DEPARTMENT OF TRANSPORTATION WORK ZONE PEDESTRIAN AND BICYCLE GUIDANCE (LATEST EDITION)


AT THE END OF EACH WORKING DAY, THE CONTRACTOR SHALL PULL BACK **MOT CHANNELIZING DEVICES TO MAINTAIN TWO TRAVEL LANES IN EACH DIRECTION ON 18TH STREET.** 

ARLINGTON VIRGINIA

DEPARTMENT OF **ENVIRONMENTAL SERVICES FACILITIES & ENGINEERING DIVISION** ENGINEERING BUREAU 2100 CLARENDON BOULEVARD, SUITE 813 ARLINGTON, VA 22201 PHONE: 703.228.3629

FAX: 703.228.3606

COPYRIGHT © 2016 ARLINGTON COUNTY VIRGINIA - ALL RIGHTS RESERVED

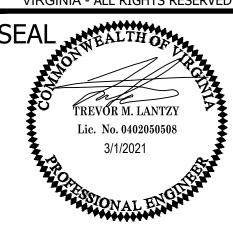

APPROVALS

QUALITY CONTROL ENGINEER 6.26.20 Kamal N. Taktak

WATER, SEWER, STREETS BUREAU CHIEF Dennis M. Leach 6/24/20 TRANSPORTATION DIRECTOR

PROJECT MANAGER

**REVISIONS** 

SOUTH


DESIGNED: NS

CHECKED: TL MISS UTILITY TRANSMITTAL #: XXXX


FILENAME: CC20-286-MOT - ZONE 11.DWG PATH: Q:\DATA\CC20\DESIGN\CAD\\_ACTIVE


PLOTTED: MARCH 1 2021 PLOTTED BY:NSHARP

SCALE:

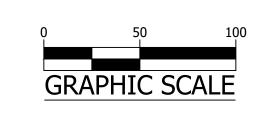

SHEET

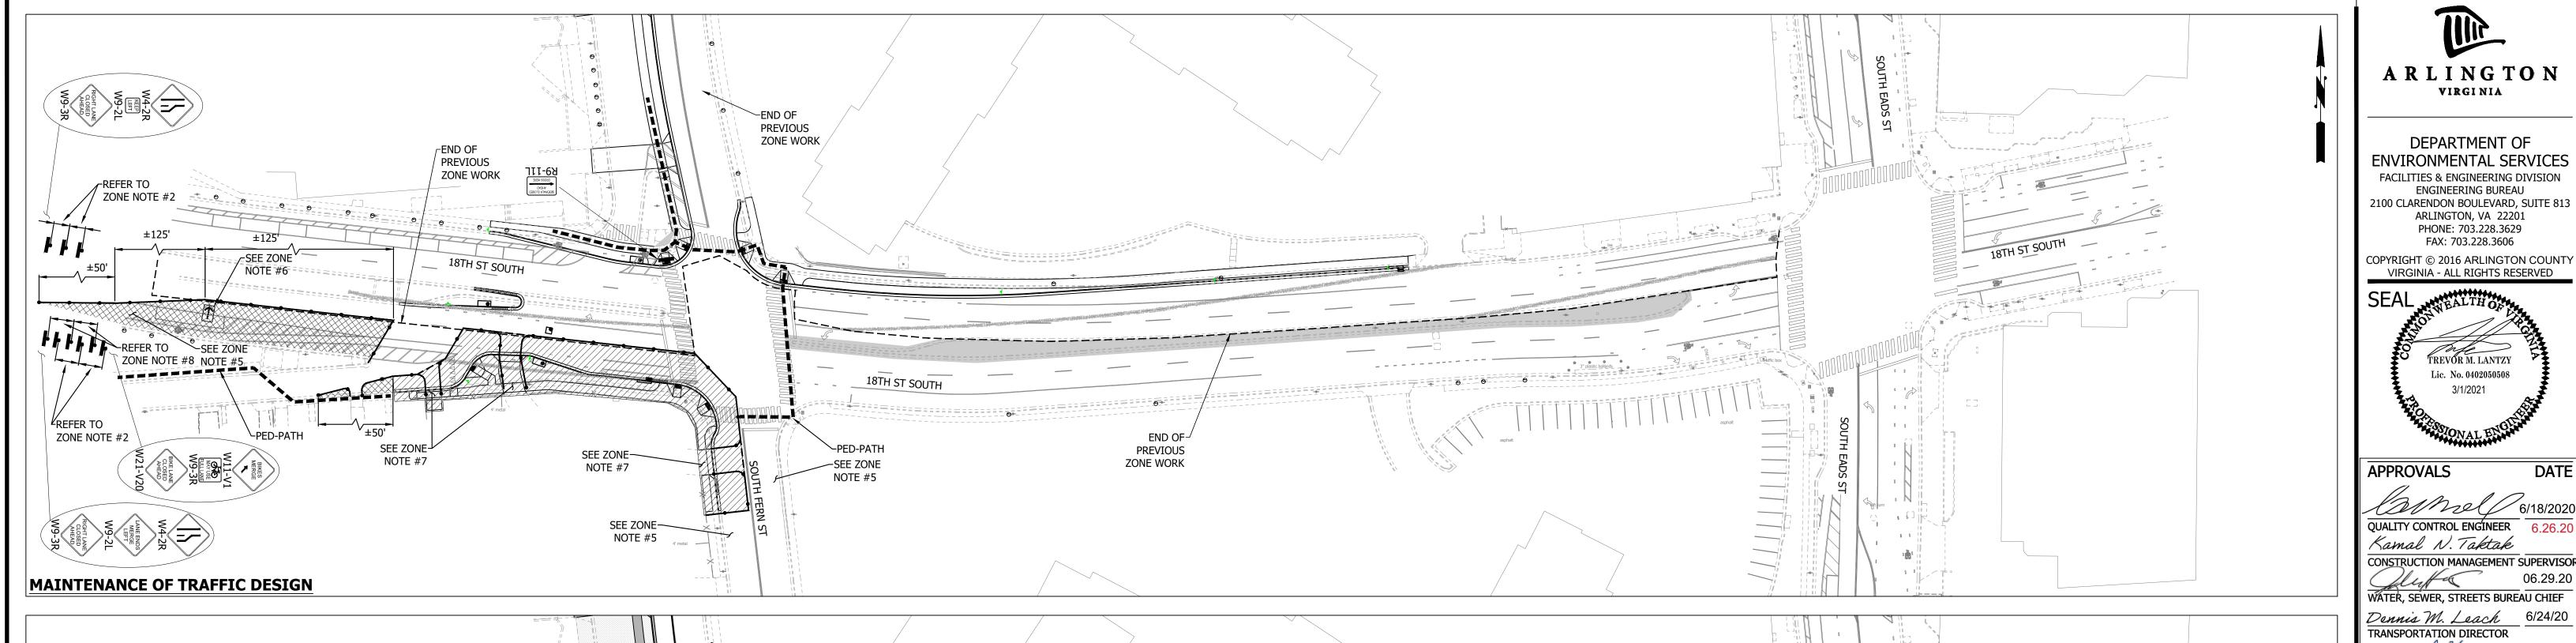

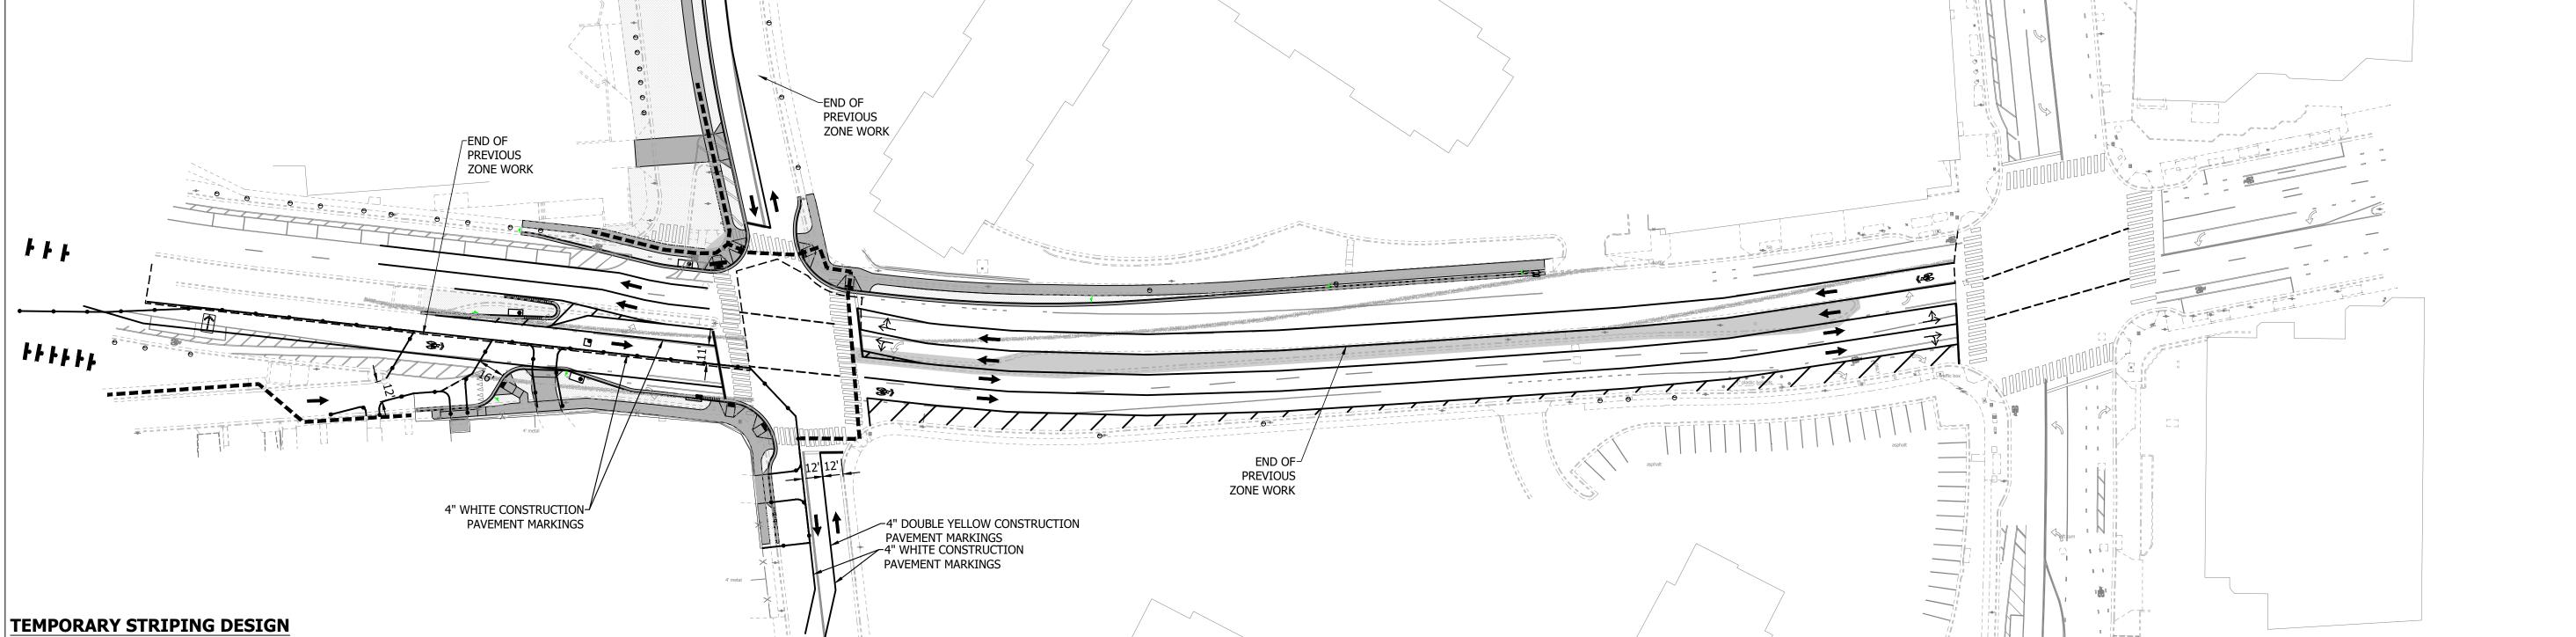

	MOT ZONE TABLE:										
MOT ZONE#	MOT ZONE#	TTC#		COMMENTS	DURATION	WORK					
		VEHICULAR	PEDESTRIAN	99111 = 1119		HOURS					
	ZONE# 12	TTC-16.2	TTC-35.1 TTC-36.2 *	CONTRACTOR TO PULL BACK CHANNELING DEVICES AT THE END OF THE WORK DAY AND REOPEN CLOSED LANES  A PEDESTRIAN PATH MUST BE MAINTAINED AT ALL TIMES DURING THIS ZONE. ONE SUGGESTION IS TO CONSTRUCT THE PROPOSED SIDEWALK FIRST AND ROUTE PEDESTRIANS THROUGH A 5' MIN CLEAR PROTECTED PATH IN THE STREET. AFTER, CONSTRUCT THE REST OF THE ZONE AND HAVE PEDESTRIANS UTILIZING THE NEWLY CONSTRUCTED SIDEWALK. OTHER OPTIONS ARE AVAILABLE WITH THE APPROVAL OF THE PROJECT OFFICER.  SHADOW VEHICLES SHALL BE UTILIZED AS SHOWN IN THE TTC	2 MONTHS - 3 MONTHS	MONFRI. 9:00AM-4:00PM					

AT THE END OF EACH WORKING DAY, THE CONTRACTOR SHALL PULL BACK **MOT CHANNELIZING DEVICES TO** MAINTAIN TWO TRAVEL LANES IN **EACH DIRECTION ON 18TH STREET.** 

#### **ZONE NOTES:**


- 1. SPEED REDUCTION: CONTRACTOR SHALL PLACE W3-5A SIGN, WITH SPEED LIMIT OF 25 MPH, ON ALL APPROACHES FOR 18TH STREET.
- 2. WARNING SIGN SPACING: MINIMUM 100' SPACING BETWEEN WARNING SIGNS UNLESS OTHERWISE
- DIRECTED BY THE CONSTRUCTION MANAGER AND TE&O. 3. TEMPORARY STRIPING: REFER TO PLAN FOR STRIPING.
- -STRIPING FROM PREVIOUS ZONE TO REMAIN UNLESS NOTED FOR REMOVAL. -MINIMUM 50' TAPER FROM EXISTING STRIPING TO PROPOSED TEMP. STRIPING ON SOUTH FERN
- 4. OPTIONAL TTC'S: REQUIRES APPROVE BY THE CONSTRUCTION MANAGER PRIOR TO IMPLEMENTATION
- PARKING IN THIS AREA SHOULD BE BLOCKED OFF.
- 6. ILLUMINATED FLASHING ARROW BOARDS SHALL BE PLACED OUTSIDE TRAVEL LANE
- COORDINATE WITH THE PROJECT OFFICER PRIOR TO WORK AND CLOSURE OF THE DRIVEWAY. PROPERTY OWNER SHALL BE NOTIFIED THREE WEEKS BEFORE DRIVEWAY CLOSURE. ADDITIONAL SIGNAGE AND CHANNELIZATION DEVICES MAY BE REQUIRED FOR THE CLOSURE. WORK IN THE DRIVEWAY AREA SHOULD TAKE NO MORE THEN 2-3 DAYS. AT THE END OF EACH WORKING DAY THE PROPERTY OWNER SHALL BE ABLE TO UTILIZE THEIR DRIVEWAY.
- 8. BIKE LANE CLOSURE SIGNAGE TO BE PLACED IN BETWEEN ROAD WARNING SIGNS AND BE VISIBLE FOR BOTH VEHICLES AND BIKES.
- \* PEDESTRIAN ACCESS SHALL BE MAINTAINED AS SHOWN ON THIS SHEET, UTILIZING THE REFERENCED TTC IN THE MOT ZONE TABLE AND THE BICYCLE LANE CLOSURE, FROM THE VIRGINIA DEPARTMENT OF TRANSPORTATION WORK ZONE PEDESTRIAN AND BICYCLE GUIDANCE (LATEST EDITION)



DEPARTMENT OF **ENVIRONMENTAL SERVICES FACILITIES & ENGINEERING DIVISION** ENGINEERING BUREAU 2100 CLARENDON BOULEVARD, SUITE 813 ARLINGTON, VA 22201 PHONE: 703.228.3629

FAX: 703.228.3606

COPYRIGHT © 2016 ARLINGTON COUNTY VIRGINIA - ALL RIGHTS RESERVED

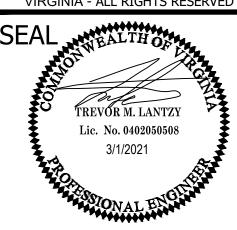

APPROVALS

QUALITY CONTROL ENGINEER 6.26.20 Kamal N. Taktak

WATER, SEWER, STREETS BUREAU CHIEF Dennis M. Leach 6/24/20 TRANSPORTATION DIRECTOR

Aiel Yang PROJECT MANAGER

**REVISIONS** 

SOUTH

DESIGNED: NS

DRAWN: NS CHECKED: TL MISS UTILITY TRANSMITTAL #: XXXX

FILENAME: CC20-286-MOT - ZONE 12.DWG PATH: Q:\DATA\CC20\DESIGN\CAD\\_ACTIVE


PLOTTED: MARCH 1 2021


PLOTTED BY:NSHARP

SCALE:

**GRAPHIC SCALE** 

SHEET

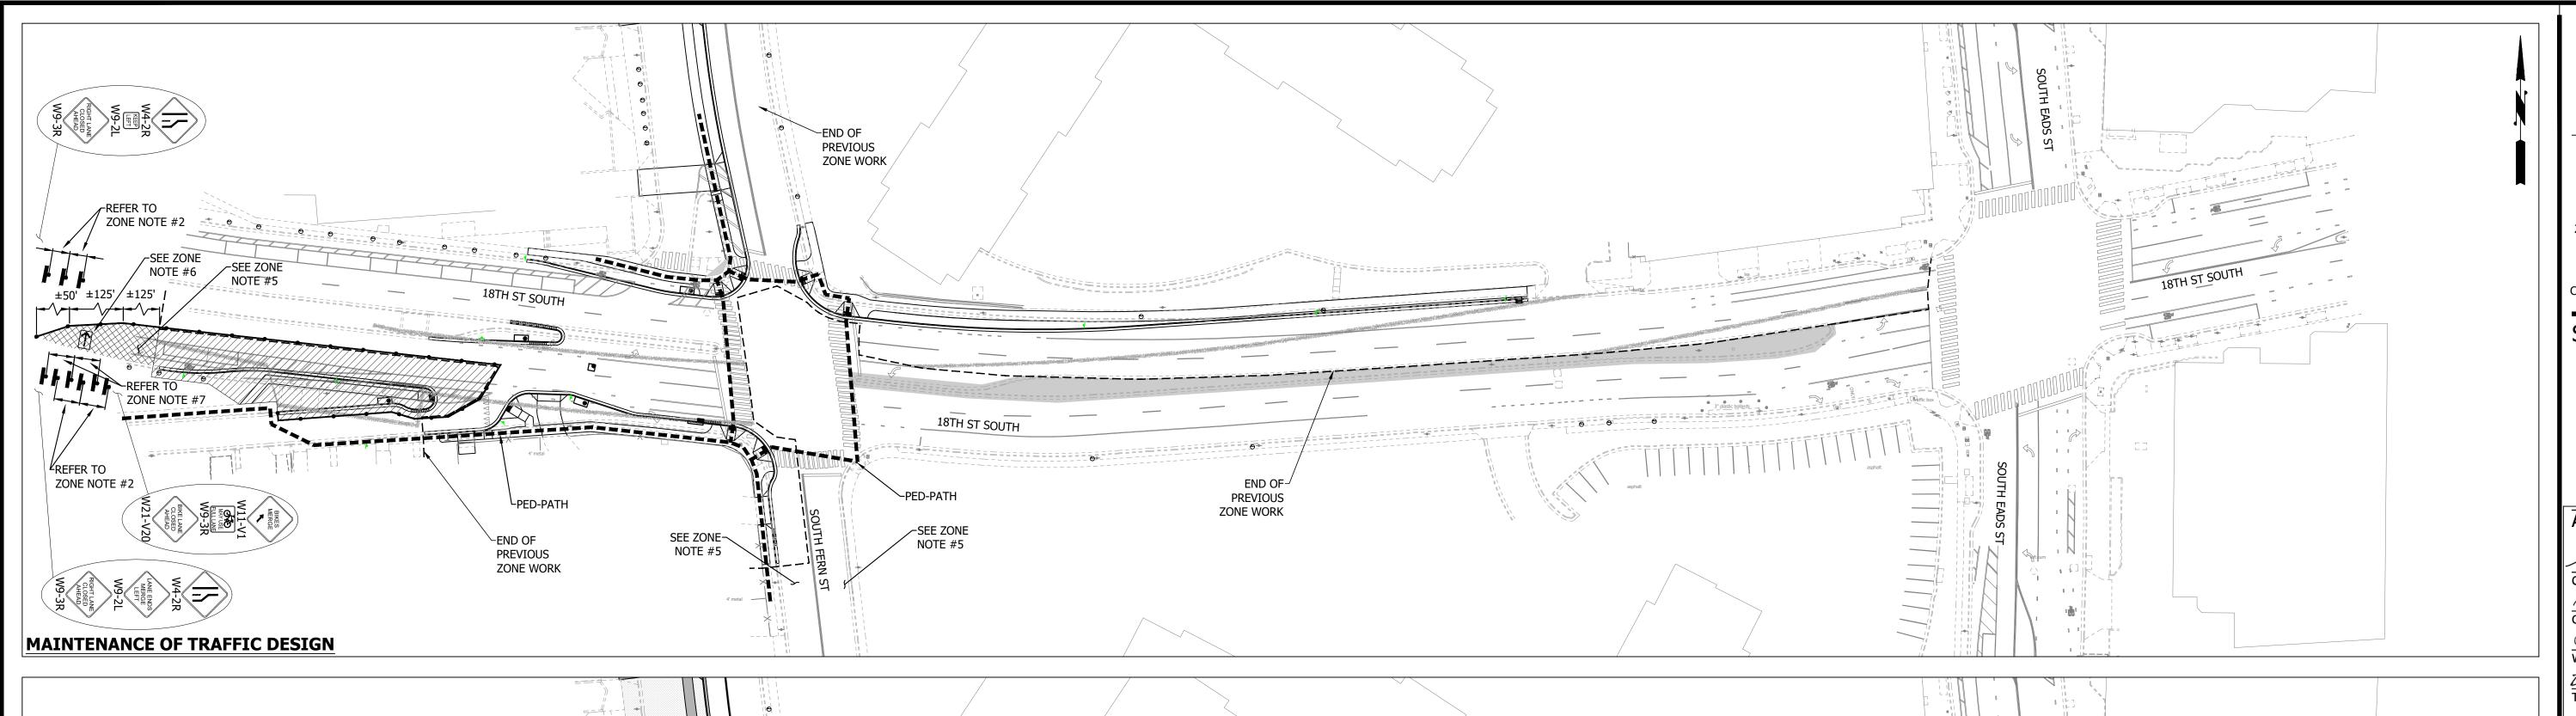

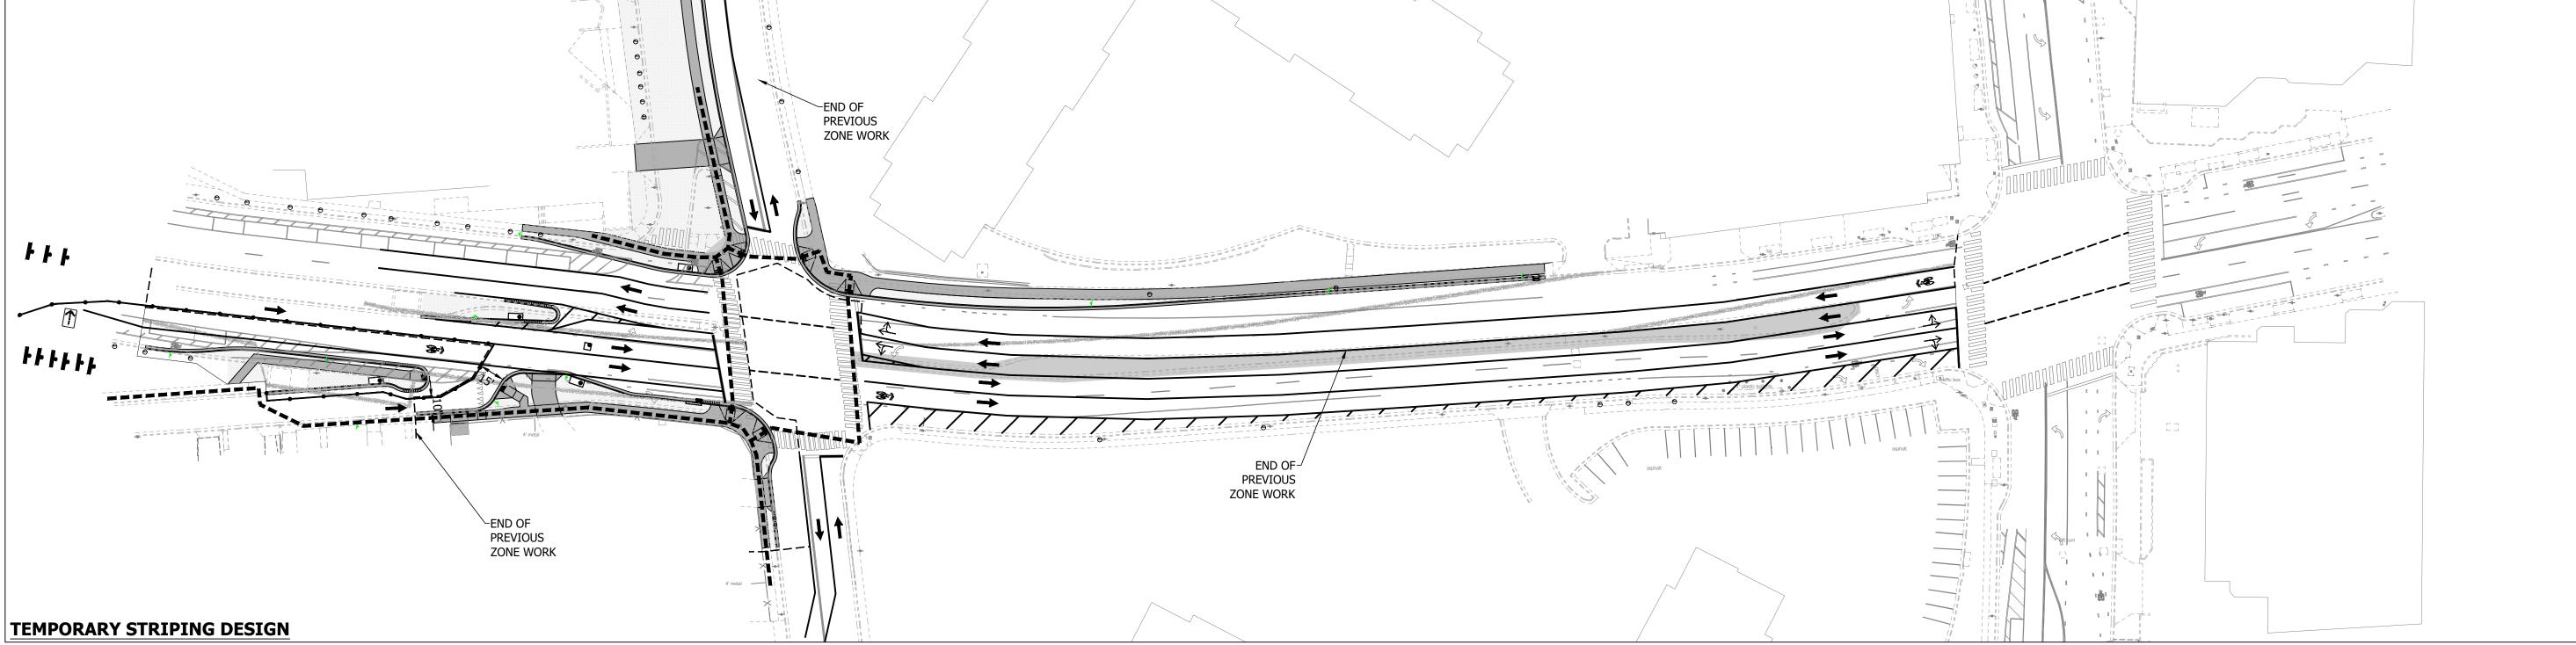

MOT ZONE TABLE:									
MOT ZONE#	TTC# VEHICULAR PEDESTRIAN		COMMENTS	DURATION	WORK HOURS				
ZONE# 13	TTC-16.2	TTC-35.1 TTC-36.2	CONTRACTOR TO PULL BACK CHANNELING DEVICES AT THE END OF THE WORK DAY AND REOPEN CLOSED LANES						
			A PEDESTRIAN PATH MUST BE MAINTAINED AT ALL TIMES DURING THIS ZONE. WHEN CONNECTING THE EXISTING SIDEWALK MAKE SURE TO MAINTAIN A SAFE PEDESTRIAN PATH	1 MONTH - 2 MONTHS	MONFRI. 9:00AM-4:00PI				
			SHADOW VEHICLES SHALL BE UTILIZED AS SHOWN IN THE TTC						


- 1. SPEED REDUCTION: CONTRACTOR SHALL PLACE W3-5A SIGN, WITH SPEED LIMIT OF 25 MPH, ON ALL APPROACHES FOR 18TH STREET.
- 2. WARNING SIGN SPACING: MINIMUM 100' SPACING BETWEEN WARNING SIGNS UNLESS OTHERWISE
- DIRECTED BY THE CONSTRUCTION MANAGER AND TE&O. 3. TEMPORARY STRIPING: REFER TO PLAN FOR STRIPING.
- -STRIPING FROM PREVIOUS ZONE TO REMAIN UNLESS NOTED FOR REMOVAL.
- -ADD/ADJUST CROSSWALK STRIPING AS NEEDED. 4. OPTIONAL TTC'S: REQUIRES APPROVE BY THE CONSTRUCTION MANAGER PRIOR TO IMPLEMENTATION
- 5. PARKING IN THIS AREA SHOULD BE BLOCKED OFF.
- 6. ILLUMINATED FLASHING ARROW BOARDS SHALL BE PLACED OUTSIDE TRAVEL LANE 7. BIKE LANE CLOSURE SIGNAGE TO BE PLACED IN BETWEEN ROAD WARNING SIGNS AND BE VISIBLE FOR
- BOTH VEHICLES AND BIKES.
- \* PEDESTRIAN ACCESS SHALL BE MAINTAINED AS SHOWN ON THIS SHEET, UTILIZING THE REFERENCED TTC IN THE MOT ZONE TABLE AND THE BICYCLE LANE CLOSURE, FROM THE VIRGINIA DEPARTMENT OF TRANSPORTATION WORK ZONE PEDESTRIAN AND BICYCLE GUIDANCE (LATEST EDITION)

AT THE END OF EACH WORKING DAY, THE CONTRACTOR SHALL PULL BACK **MOT CHANNELIZING DEVICES TO** MAINTAIN TWO TRAVEL LANES IN **EACH DIRECTION ON 18TH STREET.** 

ARLINGTON VIRGINIA

DEPARTMENT OF **ENVIRONMENTAL SERVICES** FACILITIES & ENGINEERING DIVISION ENGINEERING BUREAU 2100 CLARENDON BOULEVARD, SUITE 813 ARLINGTON, VA 22201 PHONE: 703.228.3629

FAX: 703.228.3606 COPYRIGHT © 2016 ARLINGTON COUNTY VIRGINIA - ALL RIGHTS RESERVED

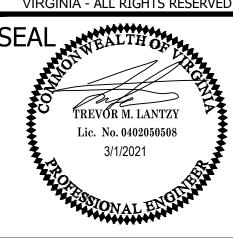

APPROVALS

QUALITY CONTROL ENGINEER 6.26.20 Kamal N. Taktak

CONSTRUCTION MANAGEMENT SUPERVISOR WATER, SEWER, STREETS BUREAU CHIEF Dennis M. Leach 6/24/20

TRANSPORTATION DIRECTOR Sicel Yang PROJECT MANAGER

**REVISIONS** 

SOUTH


DESIGNED: NS DRAWN: NS

CHECKED: TL MISS UTILITY TRANSMITTAL #: XXXX


FILENAME: CC20-286-MOT - ZONE 13.DWG PATH: Q:\DATA\CC20\DESIGN\CAD\\_ACTIVE


PLOTTED: MARCH 1 2021 PLOTTED BY:NSHARP

SCALE:

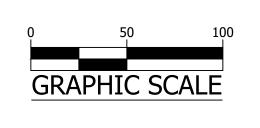

SHEET

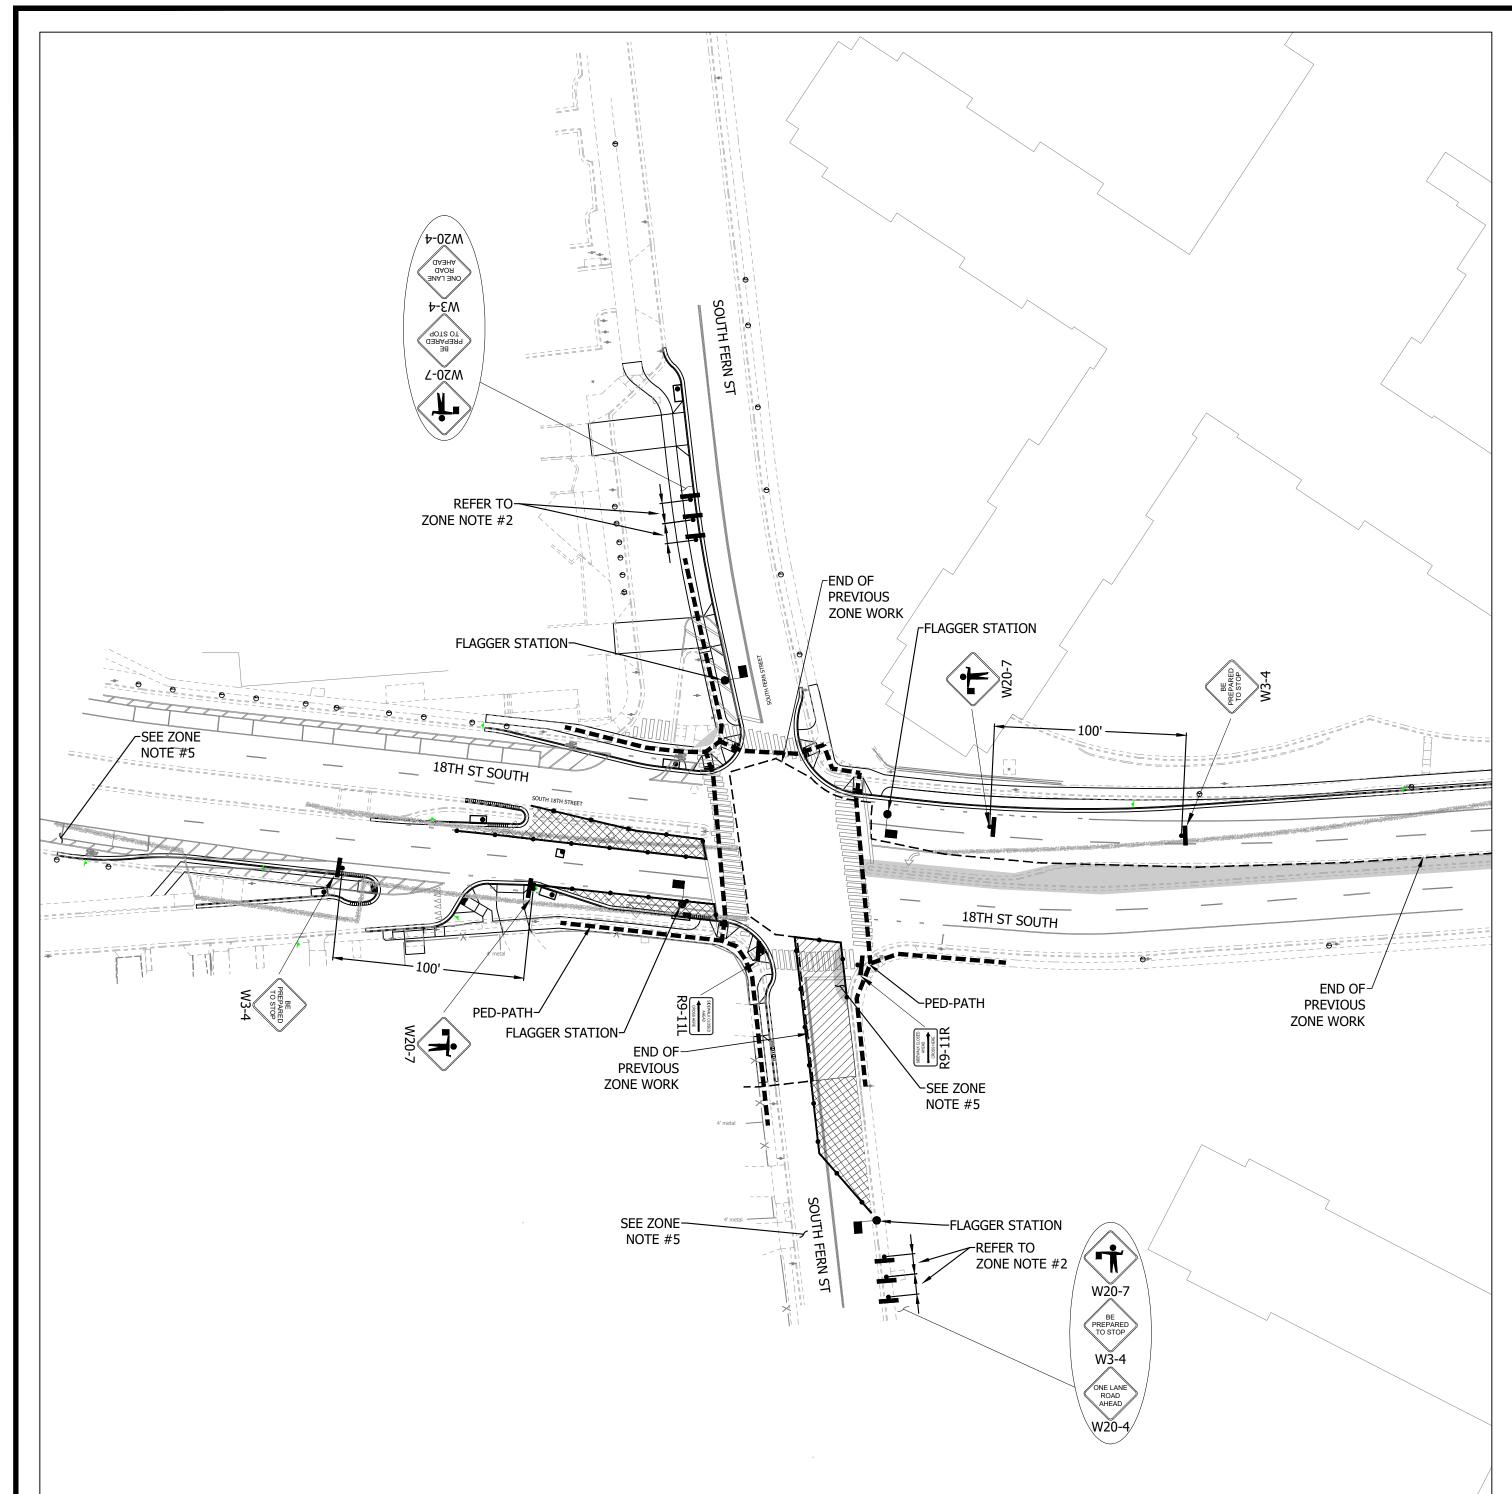

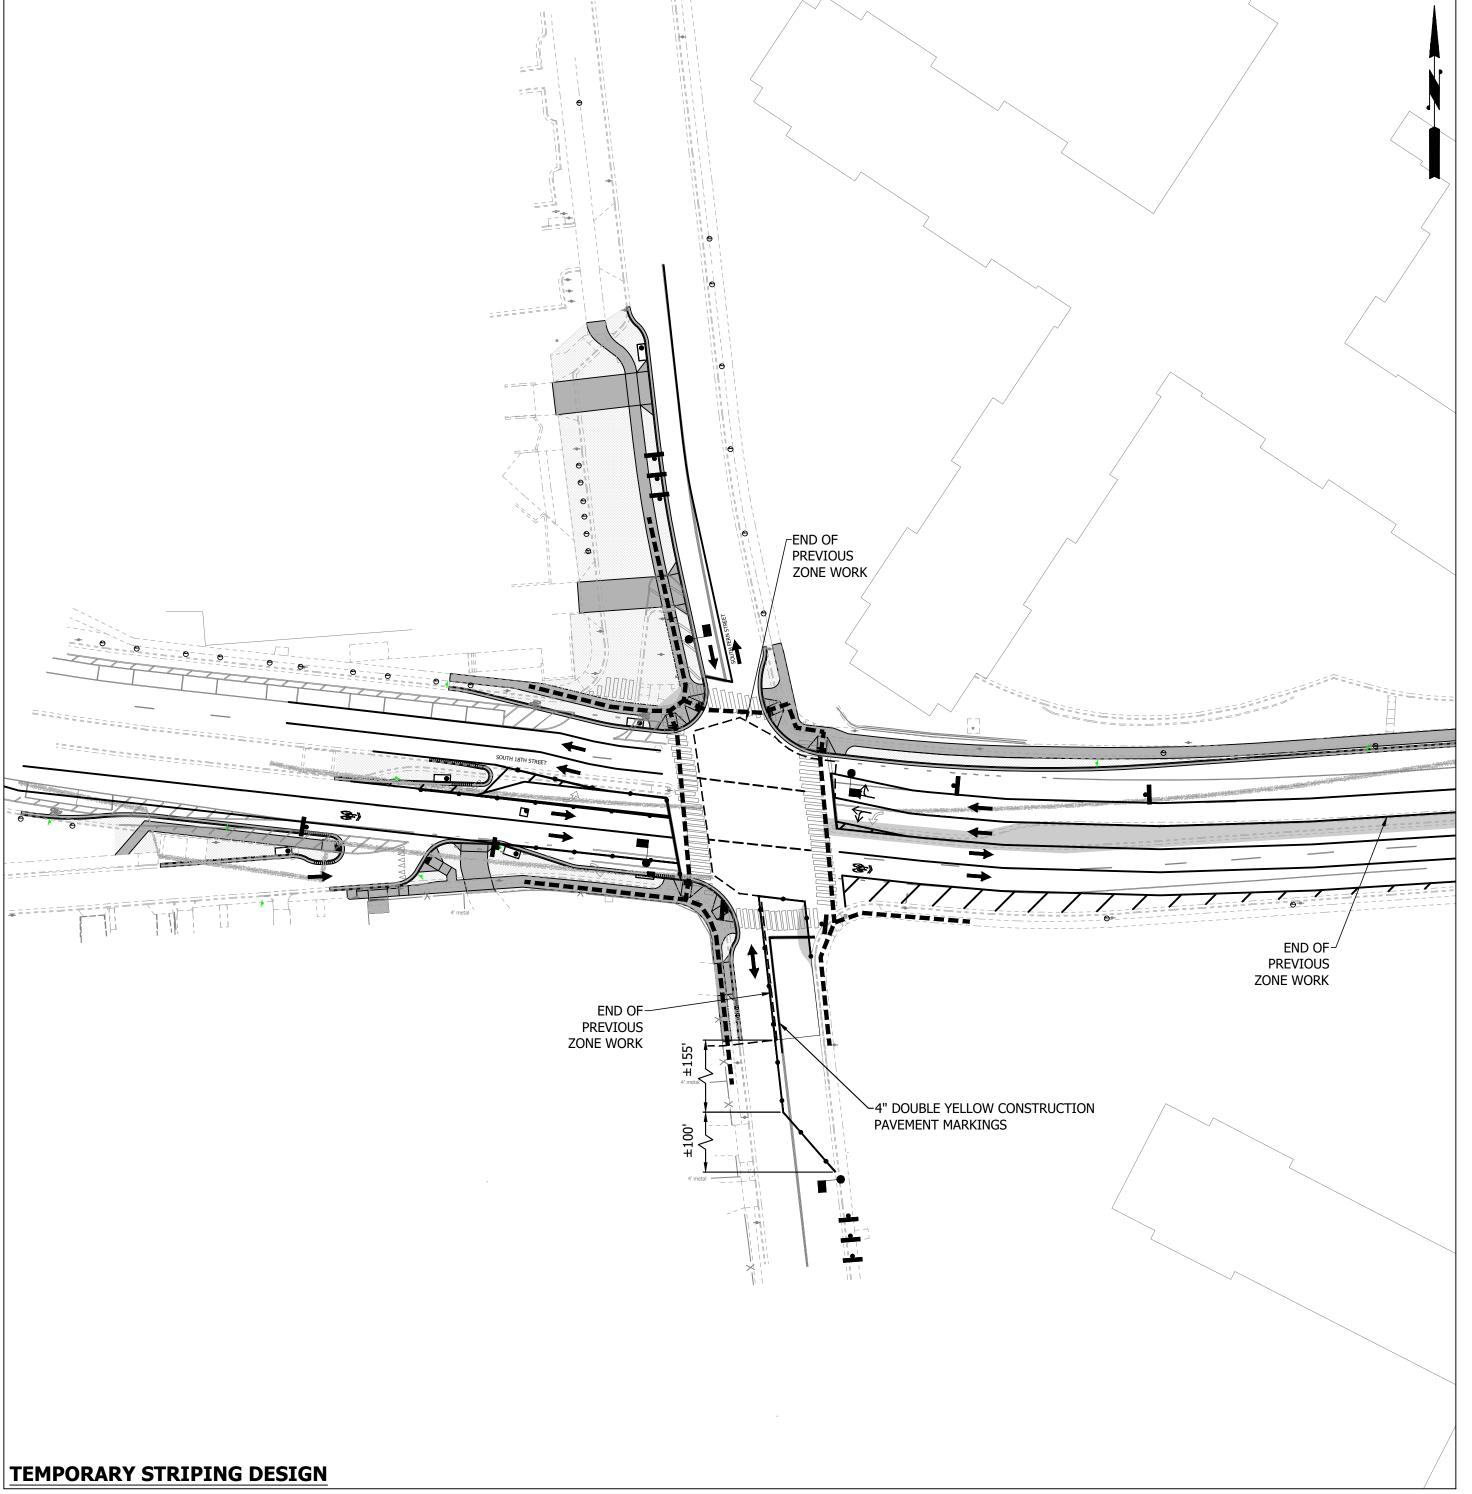

	MOT ZONE TABLE:										
MOT ZONE#	TTC# VEHICULAR PEDESTRIAN		COMMENTS	DURATION	WORK HOURS						
1101 20112#				DOIGNION							
ZONE# 14	TTC-30.2	1 11(-35 1	CONTRACTOR TO PULL BACK CHANNELING DEVICES AT THE END OF THE WORK DAY AND REOPEN CLOSED LANES	2 WEEKS - 1 MONTH	MONFRI. 9:00AM-4:00PM						
		7	SHADOW VEHICLES SHALL BE UTILIZED AS SHOWN IN THE TTC								

#### **ZONE NOTES:**

- 1. SPEED REDUCTION: CONTRACTOR SHALL PLACE W3-5A SIGN, WITH SPEED LIMIT OF 25 MPH, ON ALL
- 3. TEMPORARY STRIPING: REFER TO PLAN FOR STRIPING.

-STRIPING FROM PREVIOUS ZONE TO REMAIN UNLESS NOTED FOR REMOVAL. -REMOVE FERN STREET TEMP STRIPING AROUND WORK ZONE AND REPLACE WITH 4" DOUBLE

- 4. OPTIONAL TTC'S: REQUIRES APPROVE BY THE CONSTRUCTION MANAGER PRIOR TO IMPLEMENTATION
- PARKING IN THIS AREA SHOULD BE BLOCKED OFF.

AT THE END OF EACH WORKING DAY, THE CONTRACTOR SHALL PULL BACK **MOT CHANNELIZING DEVICES TO** MAINTAIN TWO TRAVEL LANES IN **EACH DIRECTION ON 18TH STREET.** 

APPROACHES FOR 18TH STREET.

2. WARNING SIGN SPACING: MINIMUM 100' SPACING BETWEEN WARNING SIGNS UNLESS OTHERWISE DIRECTED BY THE CONSTRUCTION MANAGER AND TE&O.

YELLOW CONSTRUCTION MARKING.

6. INSTALL A DRIVABLE TEMPORARY PAVEMENT SURFACE

\* PEDESTRIAN ACCESS SHALL BE MAINTAINED AS SHOWN ON THIS SHEET, UTILIZING THE REFERENCED TTC IN THE MOT ZONE TABLE

ARLINGTON VIRGINIA

DEPARTMENT OF **ENVIRONMENTAL SERVICES** FACILITIES & ENGINEERING DIVISION ENGINEERING BUREAU 2100 CLARENDON BOULEVARD, SUITE 813

ARLINGTON, VA 22201 PHONE: 703.228.3629 FAX: 703.228.3606

COPYRIGHT © 2016 ARLINGTON COUNTY VIRGINIA - ALL RIGHTS RESERVED



APPROVALS

QUALITY CONTROL ENGINEER 6.26.20 Kamal N. Taktak

CONSTRUCTION MANAGEMENT SUPERVISOR WATER, SEWER, STREETS BUREAU CHIEF Dennis M. Leach 6/24/20

TRANSPORTATION DIRECTOR Sicel Yang PROJECT MANAGER

**REVISIONS** 


SOUTH

DESIGNED: NS DRAWN: NS CHECKED: TL MISS UTILITY TRANSMITTAL #: XXXX


FILENAME: CC20-286-MOT - ZONE 14.DWG PATH: Q:\DATA\CC20\DESIGN\CAD\\_ACTIVE


PLOTTED: MARCH 1 2021 PLOTTED BY:NSHARP

SCALE:

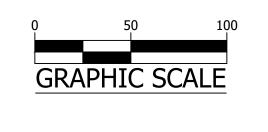

SHEET

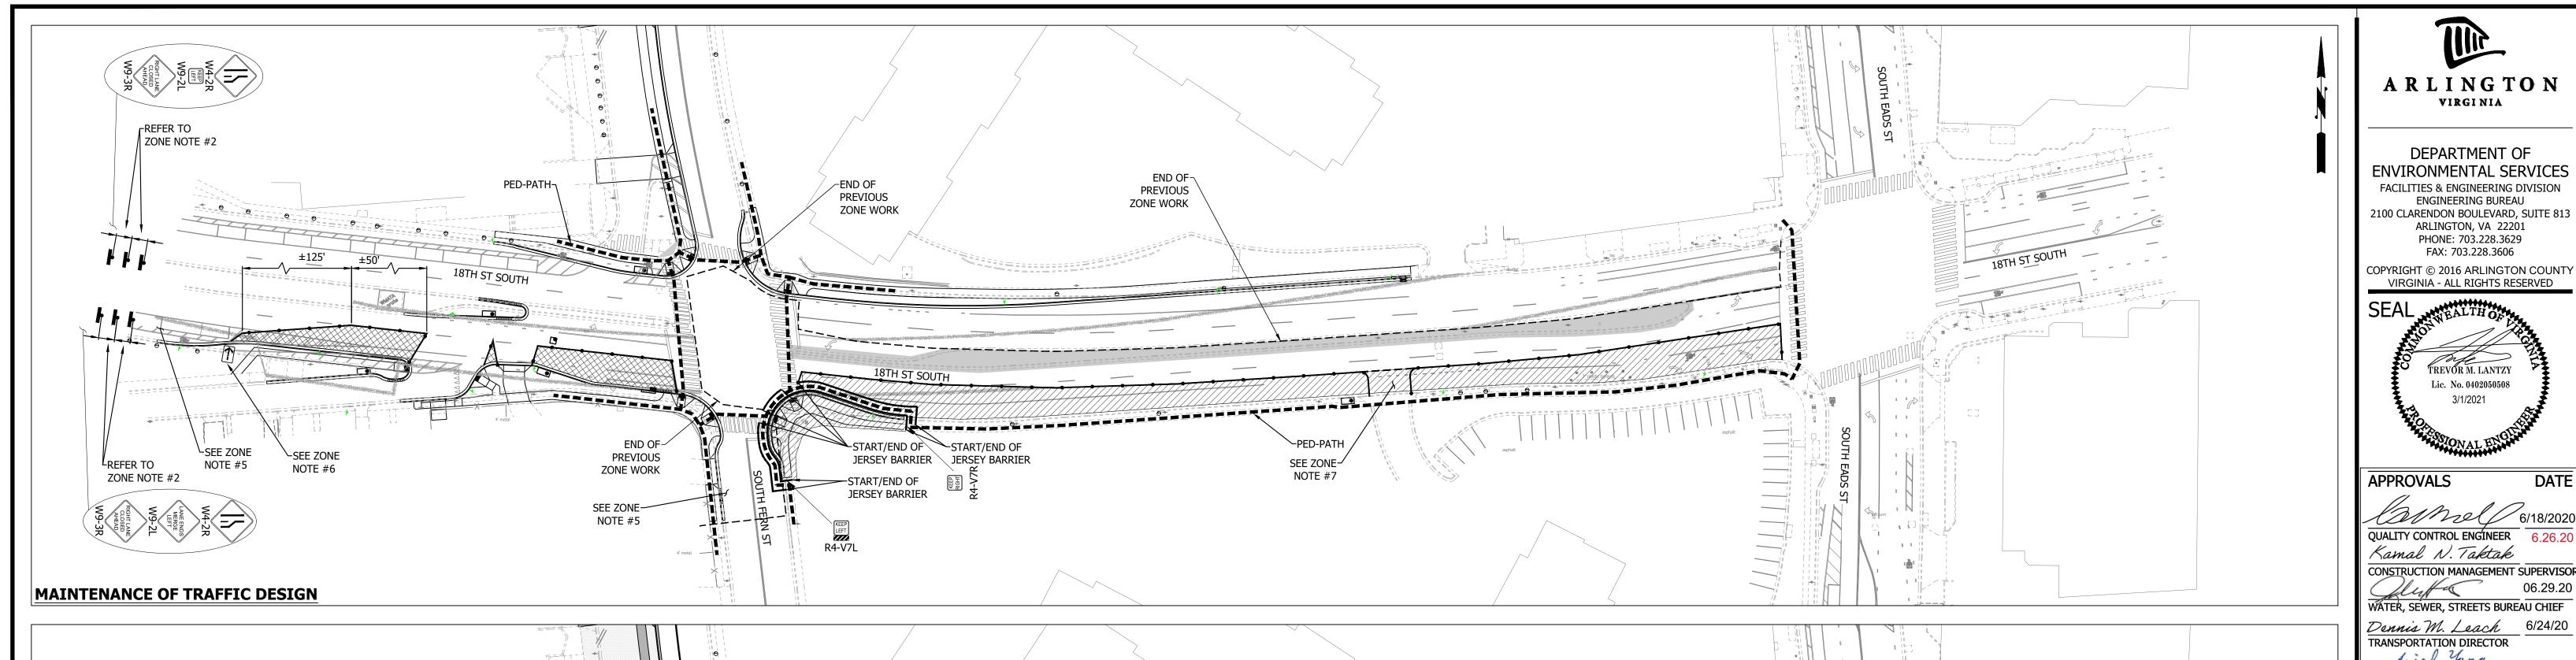

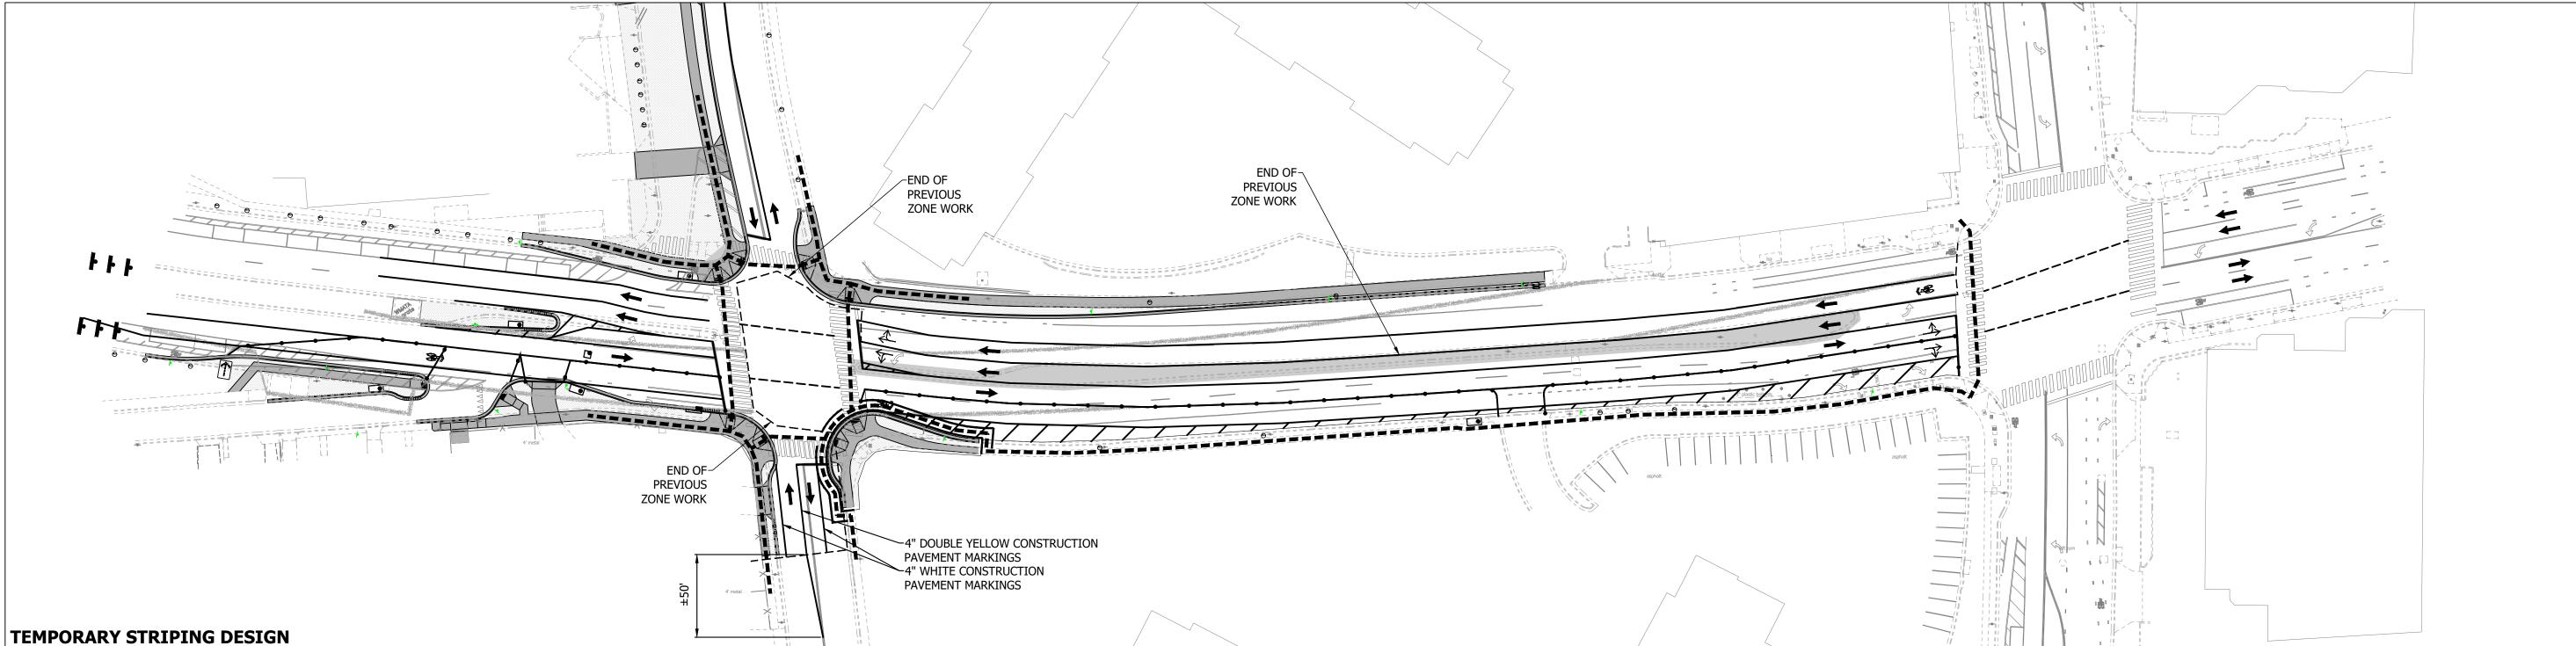

	MOT ZONE TABLE:										
MOT ZONE#	TTC#  VEHICULAR PEDESTRIAN		COMMENTS	DURATION	WORK HOURS						
1101 2011211											
ZONE# 15	TTC-16.2 TTC-35.1		CONTRACTOR TO PULL BACK CHANNELING DEVICES AT THE END OF THE WORK DAY AND REOPEN CLOSED LANES	2 MONTHS - 3 MONTHS	MONFRI. 9:00AM-4:00PM						
			SHADOW VEHICLES SHALL BE UTILIZED AS SHOWN IN THE TTC								

- 1. SPEED REDUCTION: CONTRACTOR SHALL PLACE W3-5A SIGN, WITH SPEED LIMIT OF 25 MPH, ON ALL APPROACHES FOR 18TH STREET.
- 2. WARNING SIGN SPACING: MINIMUM 100' SPACING BETWEEN WARNING SIGNS UNLESS OTHERWISE
- DIRECTED BY THE CONSTRUCTION MANAGER AND TE&O. 3. TEMPORARY STRIPING: REFER TO PLAN FOR STRIPING.
- -STRIPING FROM PREVIOUS ZONE TO REMAIN UNLESS NOTED FOR REMOVAL.
- 4. OPTIONAL TTC'S: REQUIRES APPROVE BY THE CONSTRUCTION MANAGER PRIOR TO IMPLEMENTATION
- 5. PARKING IN THIS AREA SHOULD BE BLOCKED OFF.
- ILLUMINATED FLASHING ARROW BOARDS SHALL BE PLACED OUTSIDE TRAVEL LANE. COORDINATE WITH THE PROJECT OFFICER PRIOR TO WORK AND CLOSURE OF THE DRIVEWAY. PROPERTY OWNER SHALL BE NOTIFIED THREE WEEKS BEFORE DRIVEWAY CLOSURE. ADDITIONAL SIGNAGE AND CHANNELIZATION DEVICES MAY BE REQUIRED FOR FOR THE CLOSURE. WORK IN THE DRIVEWAY AREA SHOULD TAKE NO MORE THE 3-5 DAYS.
- \* PEDESTRIAN ACCESS SHALL BE MAINTAINED AS SHOWN ON THIS SHEET, UTILIZING THE REFERENCED TTC IN THE MOT ZONE TABLE


AT THE END OF EACH WORKING DAY, THE CONTRACTOR SHALL PULL BACK **MOT CHANNELIZING DEVICES TO** MAINTAIN TWO TRAVEL LANES IN **EACH DIRECTION ON 18TH STREET.** 

ARLINGTON

DEPARTMENT OF **ENVIRONMENTAL SERVICES** FACILITIES & ENGINEERING DIVISION ENGINEERING BUREAU 2100 CLARENDON BOULEVARD, SUITE 813 ARLINGTON, VA 22201 PHONE: 703.228.3629

FAX: 703.228.3606

COPYRIGHT © 2016 ARLINGTON COUNTY VIRGINIA - ALL RIGHTS RESERVED

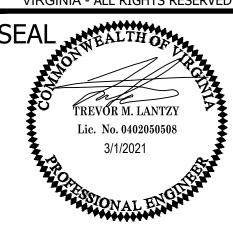

APPROVALS

QUALITY CONTROL ENGINEER 6.26.20 Kamal N. Taktak

WATER, SEWER, STREETS BUREAU CHIEF Dennis M. Leach 6/24/20 TRANSPORTATION DIRECTOR Aiel Yang

PROJECT MANAGER

**REVISIONS** 

SOUTH

DESIGNED: NS DRAWN: NS

CHECKED: TL MISS UTILITY TRANSMITTAL #: XXXX


FILENAME: CC20-286-MOT - ZONE 15.DWG PATH: Q:\DATA\CC20\DESIGN\CAD\\_ACTIVE


PLOTTED: MARCH 1 2021 PLOTTED BY:NSHARP

SCALE:

**GRAPHIC SCALE** 

SHEET

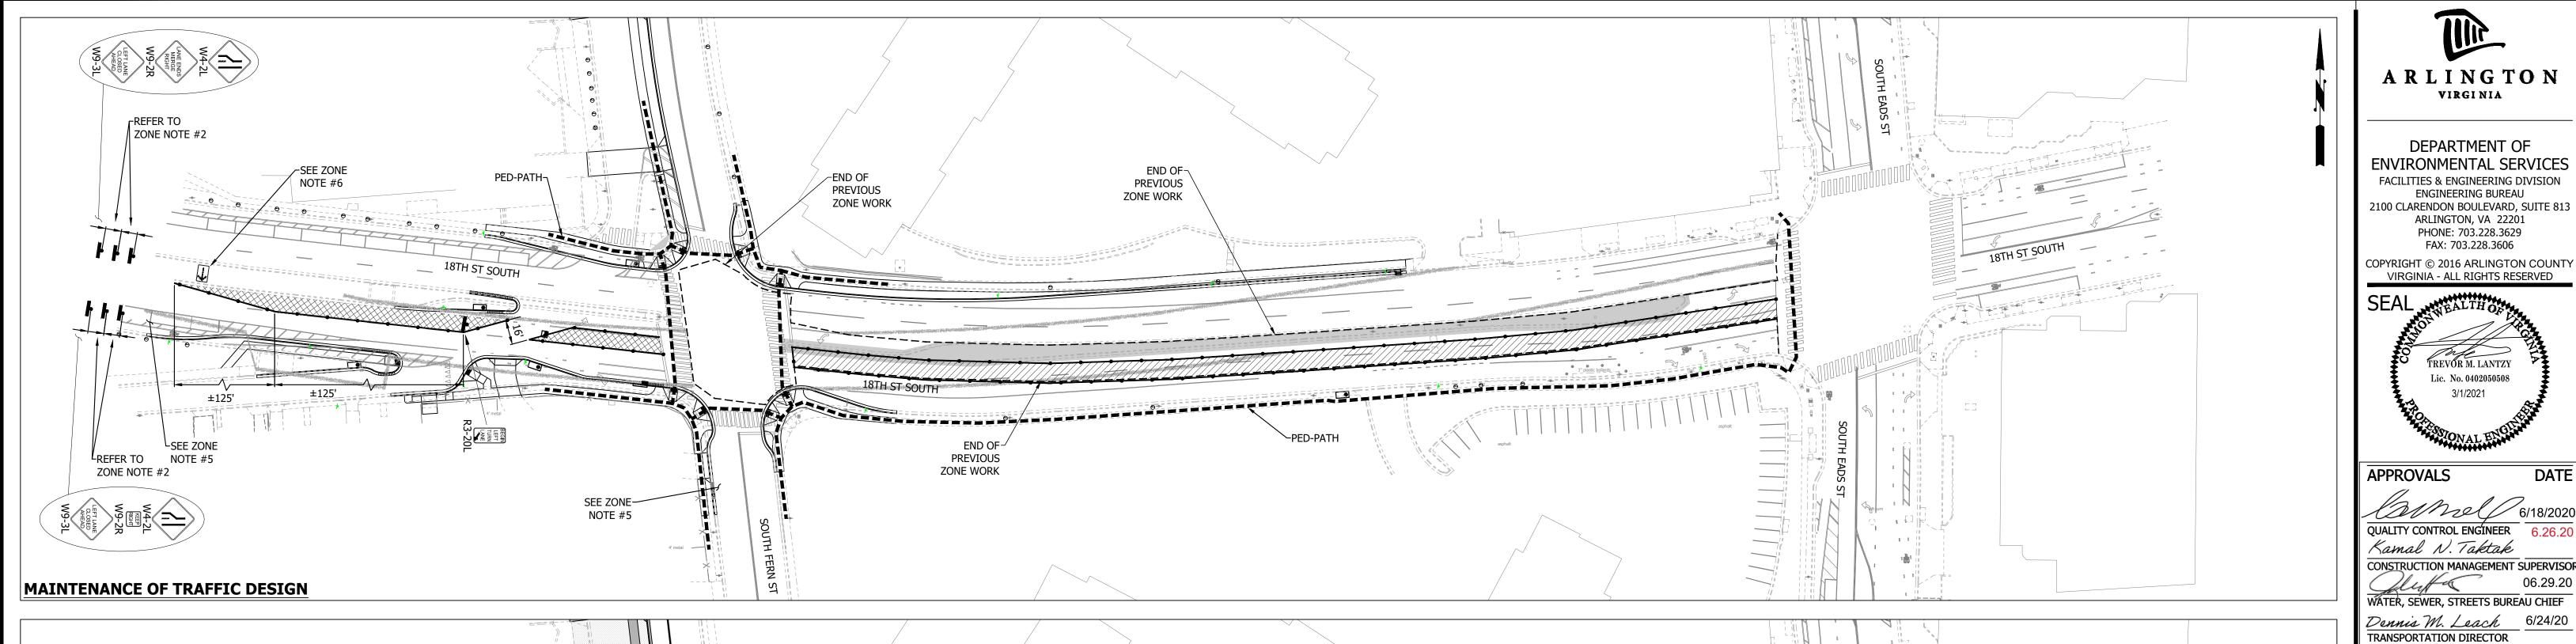

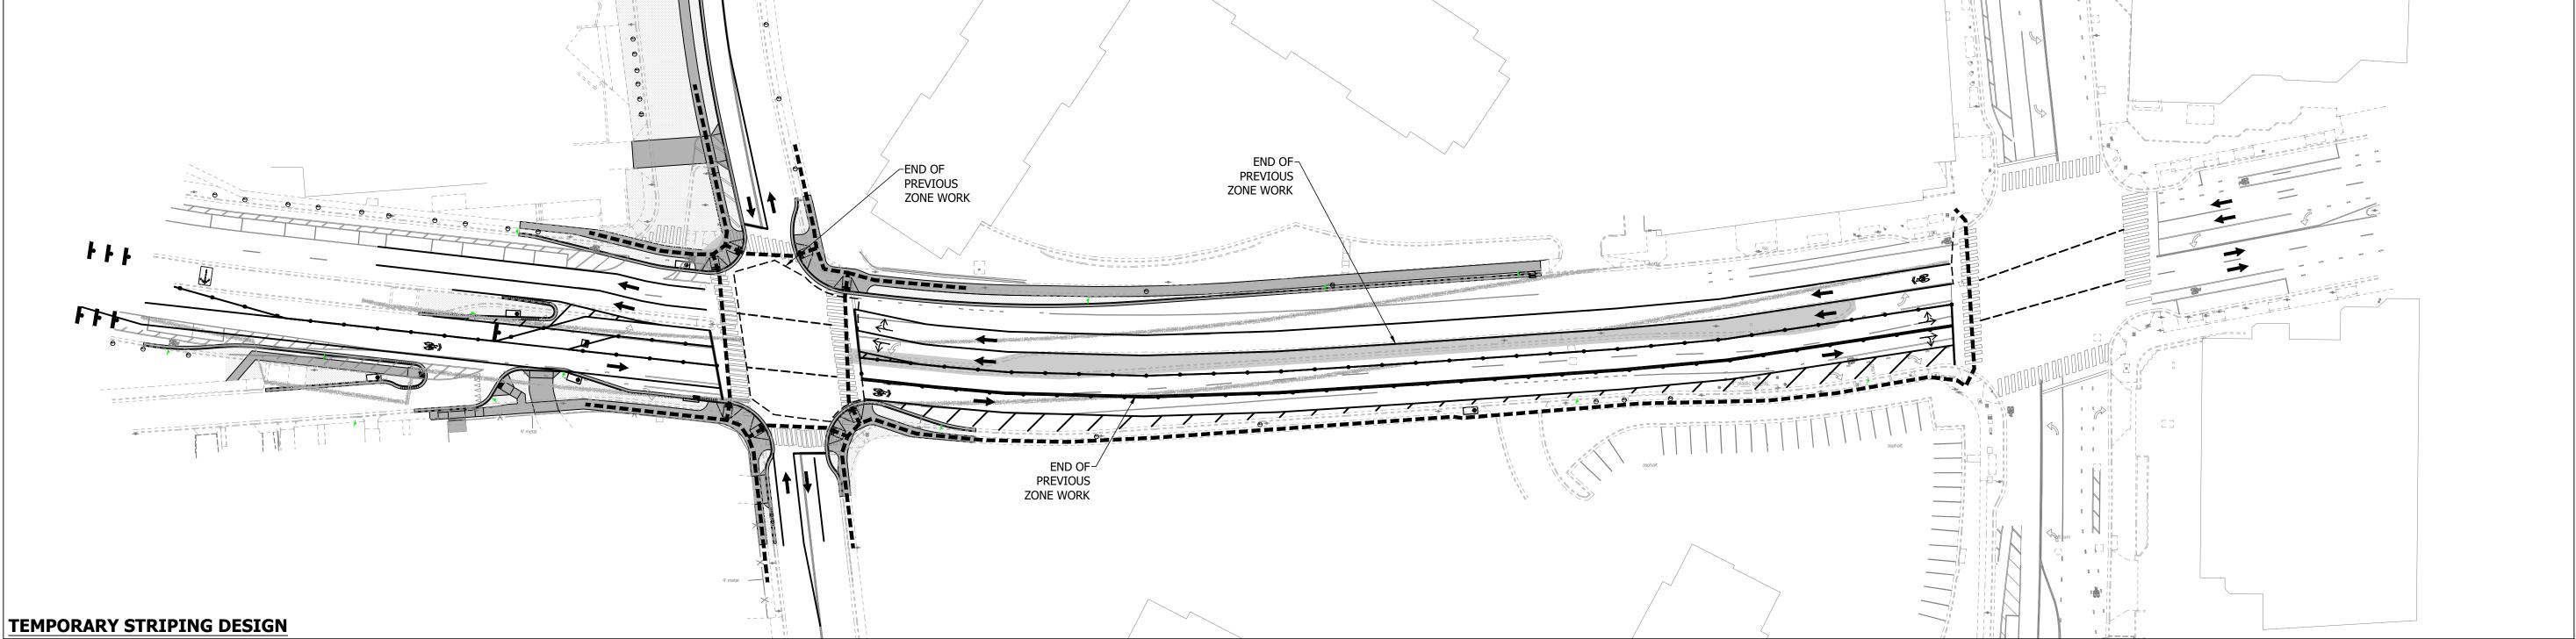

	MOT ZONE TABLE:									
MOT ZONE#	TTC#		COMMENTS	DURATION	WORK					
TIOT ZOINE	VEHICULAR PEDESTRIAN		• • · · · <del>- · · · · · · · · · · · · · · · </del>	DOIVITOR	HOURS					
ZONE# 16 TTC-27.2 * REOF		*	CONTRACTOR TO PULL BACK CHANNELING DEVICES AT THE END OF THE WORK DAY AND REOPEN CLOSED LANES  SHADOW VEHICLES SHALL BE UTILIZED AS SHOWN IN THE TTC	2 MONTHS - 3 MONTHS	MONFRI. 9:00AM-4:00PM					

- 1. SPEED REDUCTION: CONTRACTOR SHALL PLACE W3-5A SIGN, WITH SPEED LIMIT OF 25 MPH, ON ALL APPROACHES FOR 18TH STREET.
- 2. WARNING SIGN SPACING: MINIMUM 100' SPACING BETWEEN WARNING SIGNS UNLESS OTHERWISE
- DIRECTED BY THE CONSTRUCTION MANAGER AND TE&O.
- 3. TEMPORARY STRIPING: REFER TO PLAN FOR STRIPING. -STRIPING FROM PREVIOUS ZONE TO REMAIN UNLESS NOTED FOR REMOVAL.
- 4. OPTIONAL TTC'S: REQUIRES APPROVE BY THE CONSTRUCTION MANAGER PRIOR TO IMPLEMENTATION 17.2 INSIDE LANE CLOSURE OPERATIONS ON A FOUR-LANE ROADWAY
- -FIRST CHANNELING DEVICE SHALL BE PLACED GREATER THAN 50' FROM AN INTERSECTION 5. PARKING IN THIS AREA SHOULD BE BLOCKED OFF.
- 6. ILLUMINATED FLASHING ARROW BOARDS SHALL BE PLACED OUTSIDE TRAVEL LANE.
- \* PEDESTRIAN ACCESS SHALL BE MAINTAINED AS SHOWN ON THIS SHEET, UTILIZING THE REFERENCED TTC IN THE MOT ZONE TABLE


AT THE END OF EACH WORKING DAY, THE CONTRACTOR SHALL PULL BACK **MOT CHANNELIZING DEVICES TO MAINTAIN TWO TRAVEL LANES IN EACH DIRECTION ON 18TH STREET.** 

ARLINGTON

DEPARTMENT OF **ENVIRONMENTAL SERVICES** FACILITIES & ENGINEERING DIVISION ENGINEERING BUREAU 2100 CLARENDON BOULEVARD, SUITE 813 ARLINGTON, VA 22201

> PHONE: 703.228.3629 FAX: 703.228.3606

COPYRIGHT © 2016 ARLINGTON COUNTY VIRGINIA - ALL RIGHTS RESERVED

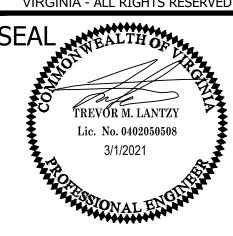

APPROVALS

QUALITY CONTROL ENGINEER 6.26.20 Kamal N. Taktak

WATER, SEWER, STREETS BUREAU CHIEF Dennis M. Leach 6/24/20 TRANSPORTATION DIRECTOR Sicel Yang

PROJECT MANAGER **REVISIONS** 

SOUTH


DESIGNED: NS DRAWN: NS

CHECKED: TL MISS UTILITY TRANSMITTAL #: XXXX


FILENAME: CC20-286-MOT - ZONE 16.DWG PATH: Q:\DATA\CC20\DESIGN\CAD\\_ACTIVE


PLOTTED: MARCH 1 2021 PLOTTED BY:NSHARP

SCALE:

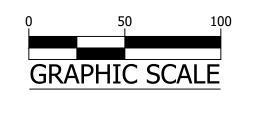

SHEET

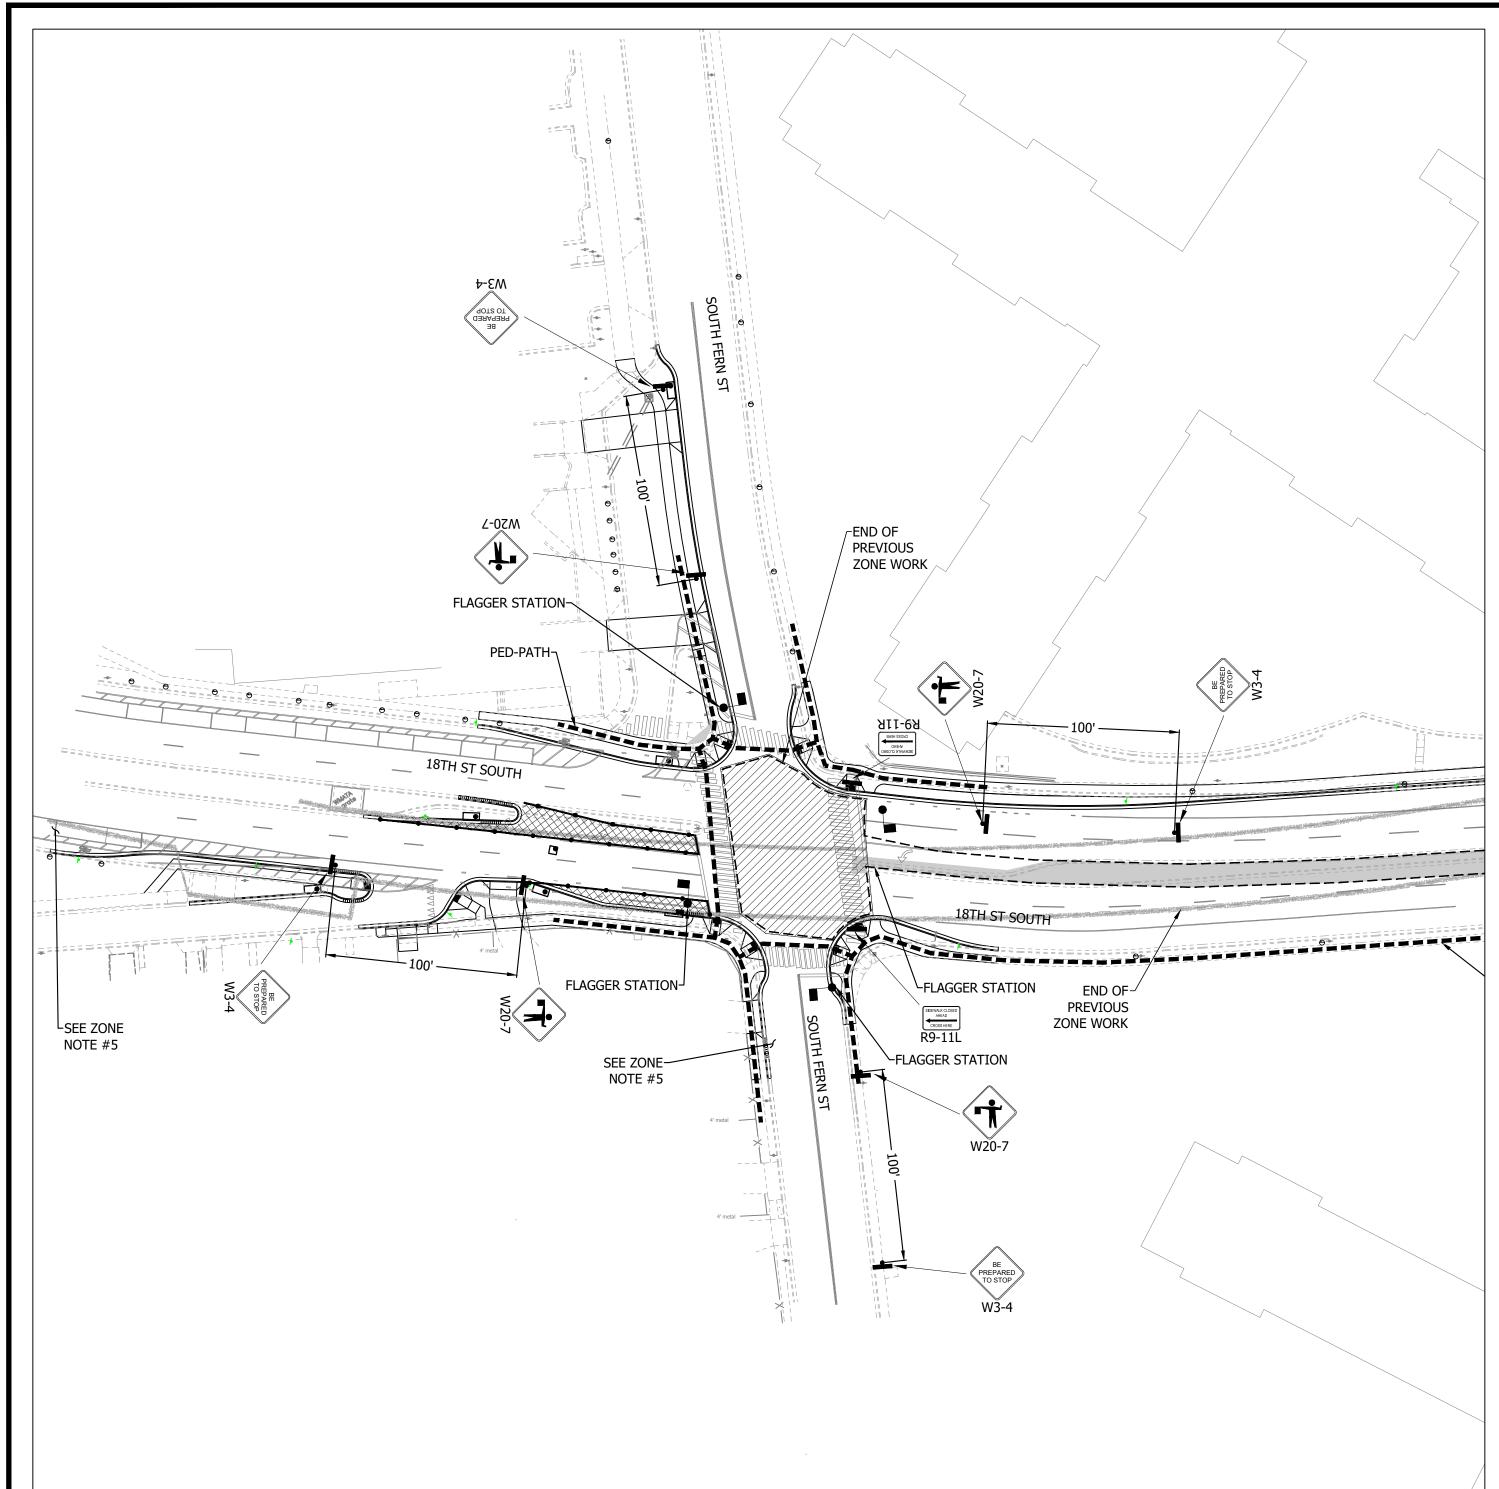

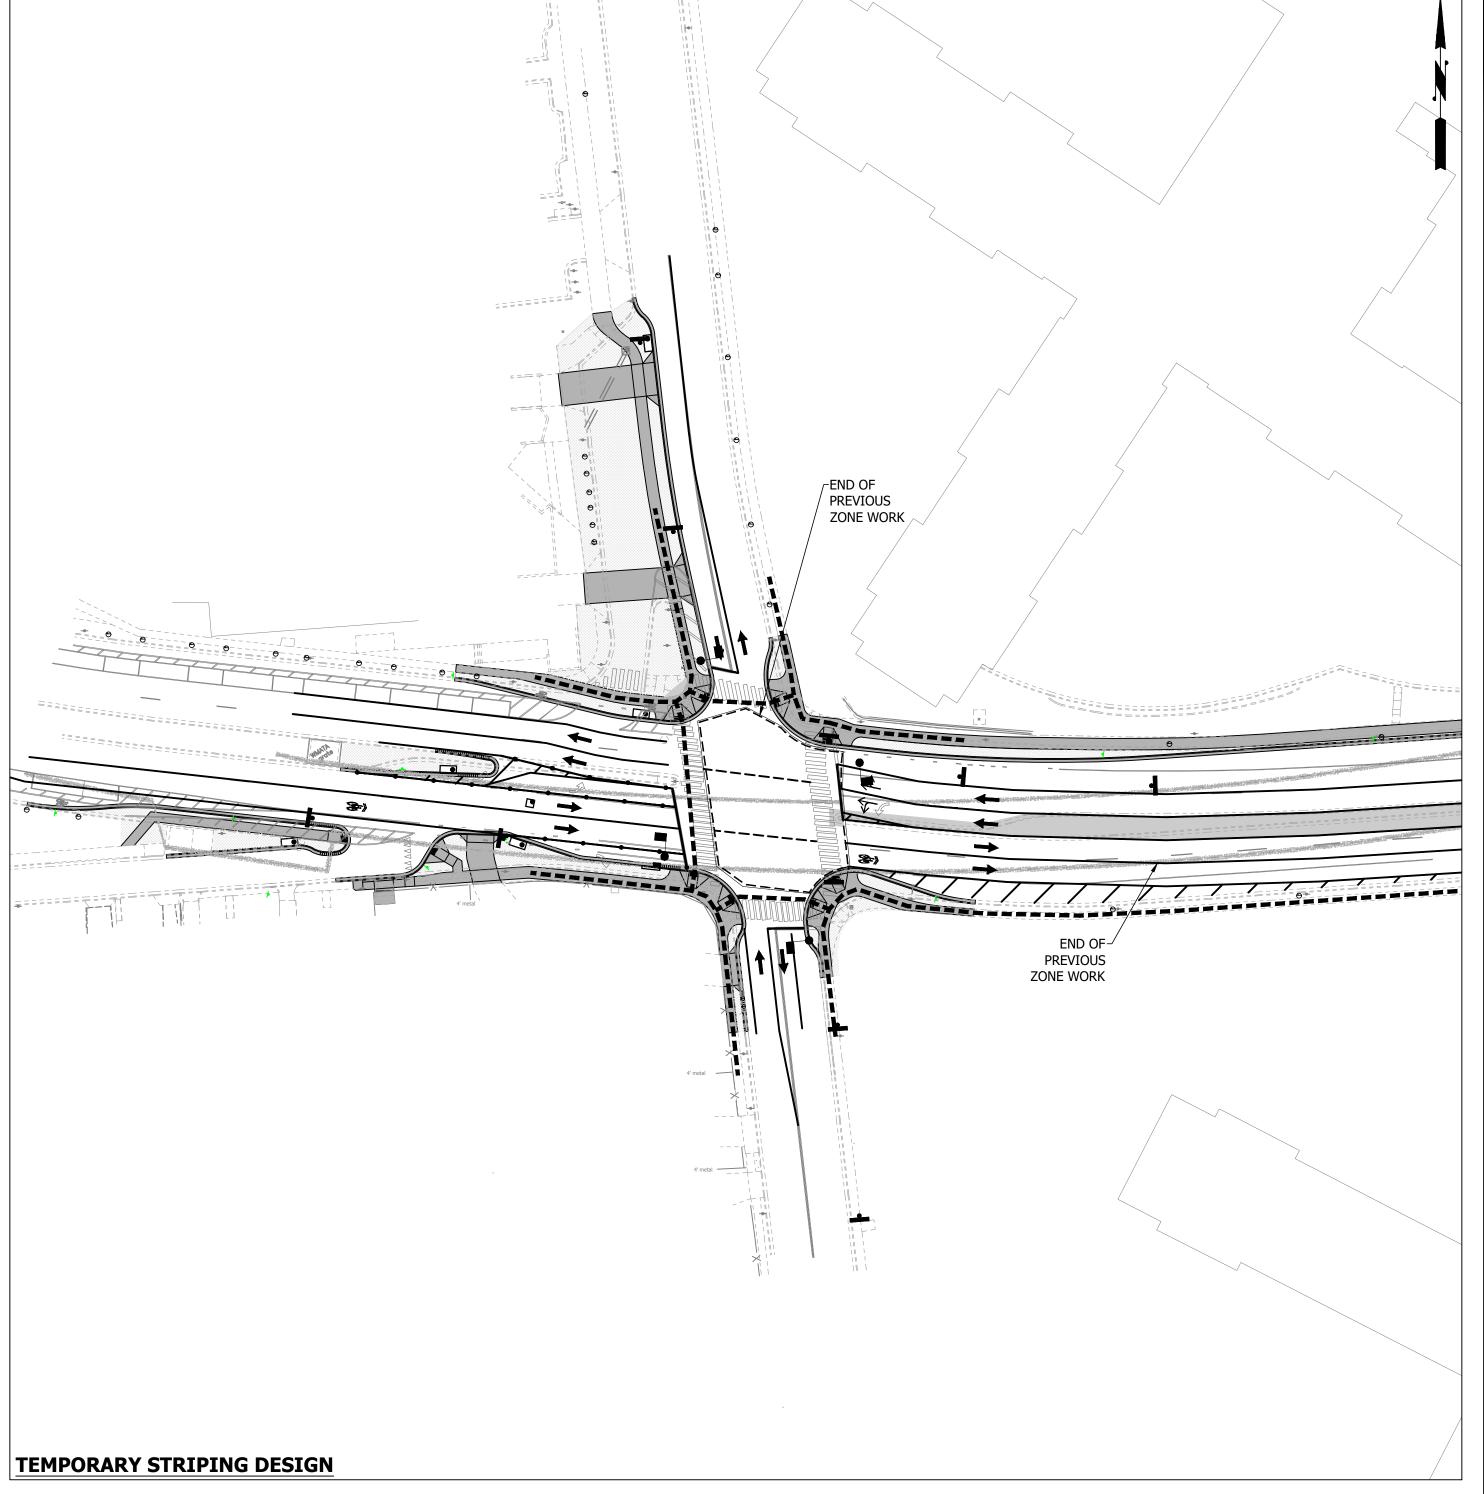

	MOT ZONE TABLE:									
MOT ZONE#	TTC# VEHICULAR PEDESTRIAN		COMMENTS	DURATION	WORK HOURS					
1101 20112#			99111 = 1119	DOIG (110)(						
ZONE# 17	TTC-30.2	1 11(-35 1	CONTRACTOR TO PULL BACK CHANNELING DEVICES AT THE END OF THE WORK DAY AND REOPEN CLOSED LANES	1 MONTH - 2 MONTHS	MONFRI. 9:00AM-4:00PM					
		-1	SHADOW VEHICLES SHALL BE UTILIZED AS SHOWN IN THE TTC							

#### **ZONE NOTES:**

- 1. <u>SPEED REDUCTION:</u> CONTRACTOR SHALL PLACE W3-5A SIGN, WITH SPEED LIMIT OF 25 MPH, ON ALL APPROACHES FOR 18TH STREET.
- 2. WARNING SIGN SPACING: MINIMUM 100' SPACING BETWEEN WARNING SIGNS UNLESS OTHERWISE
- DIRECTED BY THE CONSTRUCTION MANAGER AND TE&O.


  3. TEMPORARY STRIPING: REFER TO PLAN FOR STRIPING.
- -STRIPING FROM PREVIOUS ZONE TO REMAIN UNLESS NOTED FOR REMOVAL.

  4. OPTIONAL TTC'S: REQUIRES APPROVE BY THE CONSTRUCTION MANAGER PRIOR TO IMPLEMENTATION
- CHIONAL TICS. REQUIRES ATTROVE BY THE CONSTRUCTION PLANAGER TRIOR
- 5. PARKING IN THIS AREA SHOULD BE BLOCKED OFF.
- \* PEDESTRIAN ACCESS SHALL BE MAINTAINED AS SHOWN ON THIS SHEET, UTILIZING THE REFERENCED TTC IN THE MOT ZONE TABLE

ARLINGTON VIRGINIA

DEPARTMENT OF
ENVIRONMENTAL SERVICES
FACILITIES & ENGINEERING DIVISION
ENGINEERING BUREAU
2100 CLARENDON BOULEVARD, SUITE 813
ARLINGTON, VA 22201

PHONE: 703.228.3629 FAX: 703.228.3606 COPYRIGHT © 2016 ARLINGTON COUNTY

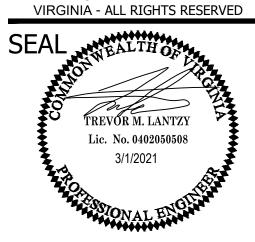

APPROVALS

QUALITY CONTROL ENGINEER

Kamal N. Taktak

CONSTRUCTION MANAGEMENT SUPERVISOR
06.29.20
WATER, SEWER, STREETS BUREAU CHIEF
Dennis M. Leach 6/24/20

TRANSPORTATION DIRECTOR

Aciel Yang

6/17/2020

PROJECT MANAGER

REVISIONS

CVISIONS

18TH STREET SOUTH

AAINT, OF TRAFFIC - ZONE 17

ROADWAY IMPROVEMENTS

S FERN ST TO S EADS ST

DESIGNED: NS

CHECKED: TL

MISS UTILITY TRANSMITTAL #: XXXX


FILENAME:

DRAWN: NS

CC20-286-MOT - ZONE 17.DWG
PATH: Q:\DATA\CC20\DESIGN\CAD\\_ACTIVE

PLOTTED: MARCH 1 2021 PLOTTED BY: NSHARP


SCALE:

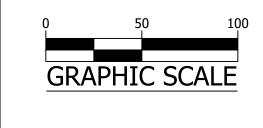


SHEET

C121.18

AT THE END OF EACH WORKING DAY,
THE CONTRACTOR SHALL PULL BACK
MOT CHANNELIZING DEVICES TO
MAINTAIN TWO TRAVEL LANES IN
EACH DIRECTION ON 18TH STREET.

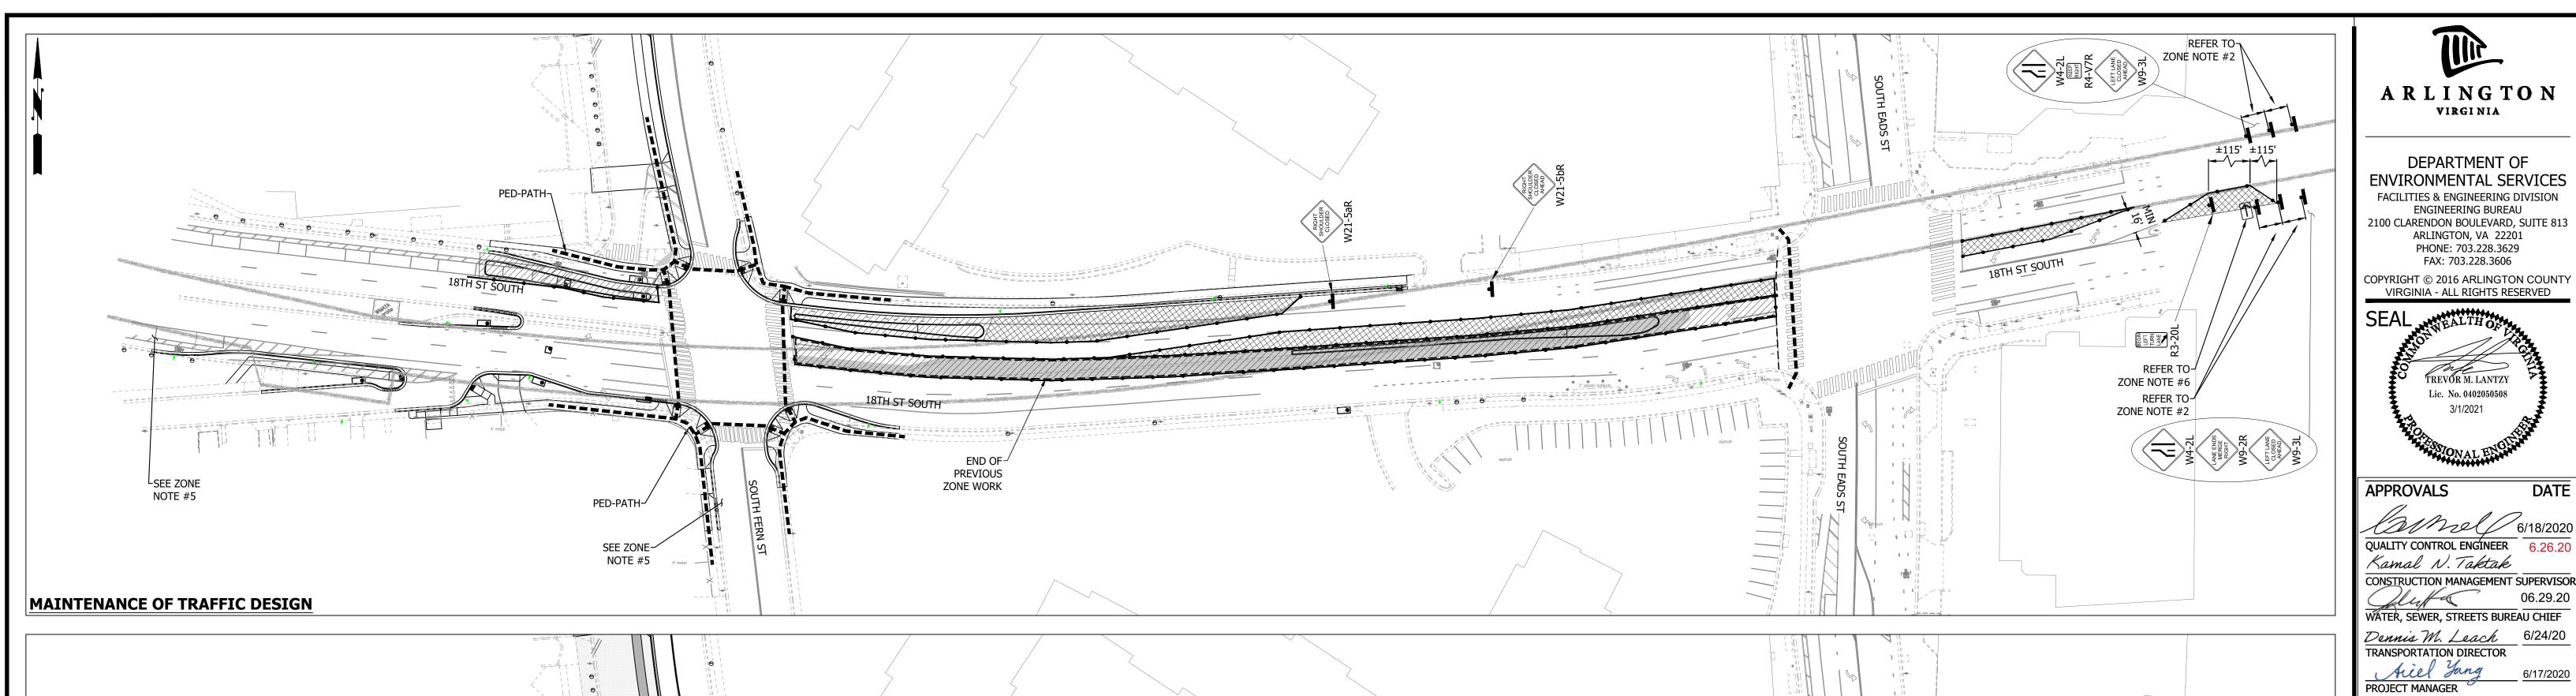

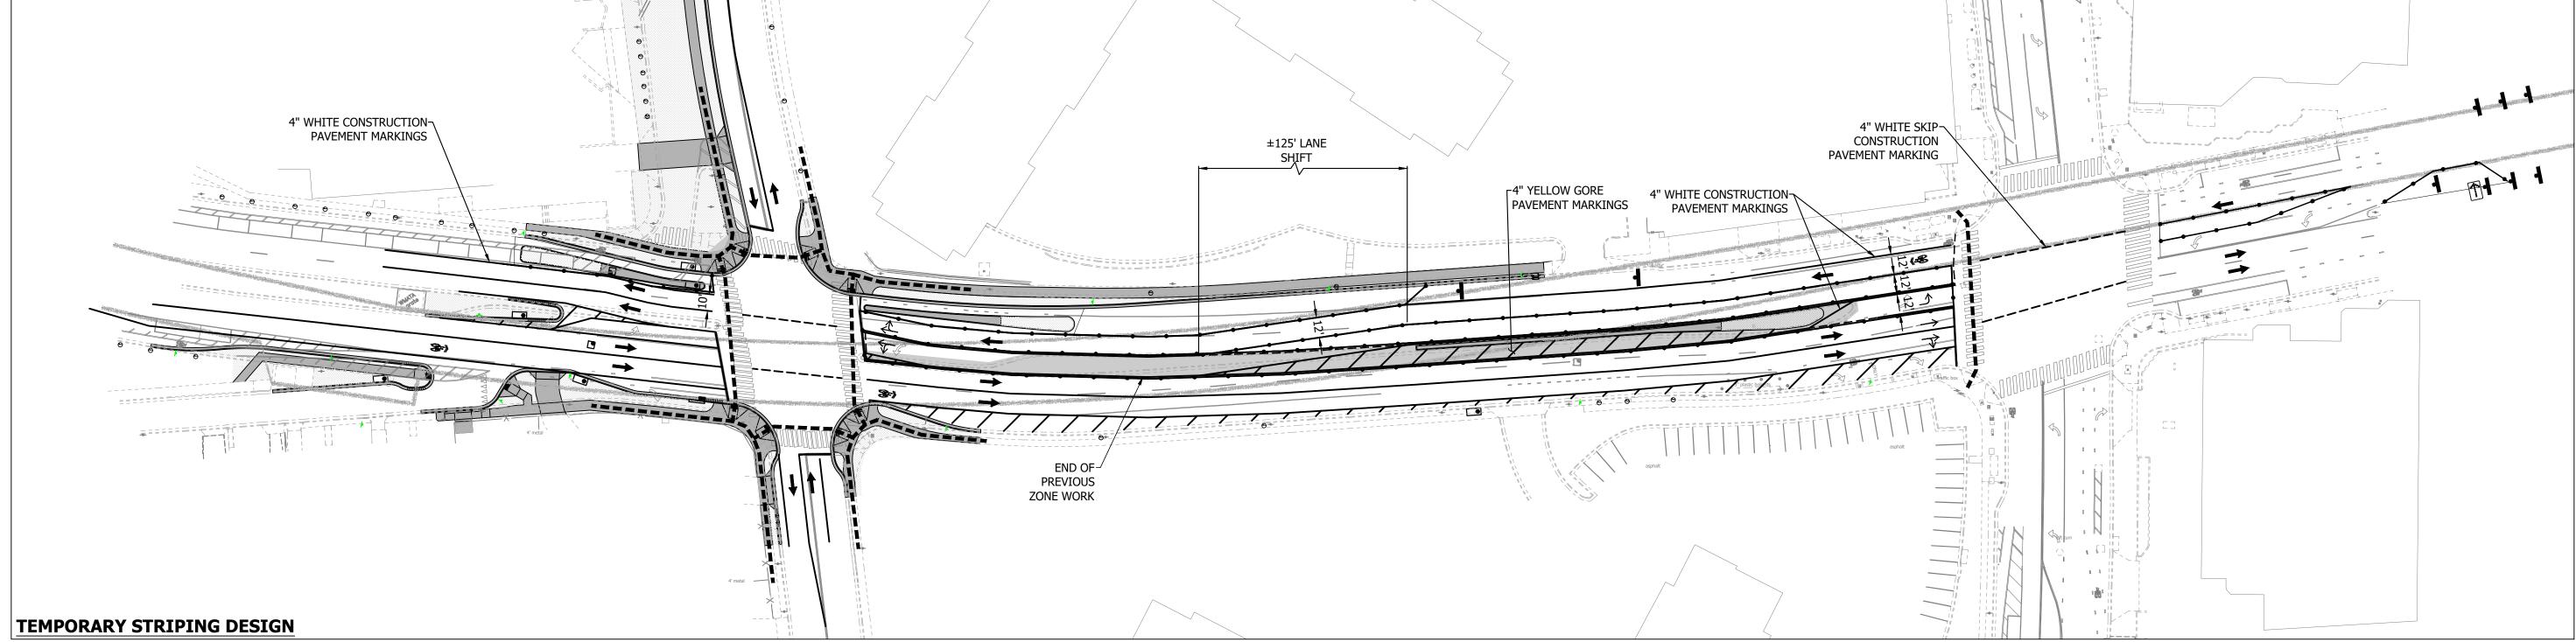

	MOT ZONE TABLE:										
MOT ZONE#	TTC# VEHICULAR PEDESTRIAN		COMMENTS	DURATION	WORK						
1101 20112"				BOILTION	HOURS						
ZONE# 18 TTC-4.2 TTC-36.2 RI		IIC-35.1	CONTRACTOR TO PULL BACK CHANNELING DEVICES AT THE END OF THE WORK DAY AND REOPEN CLOSED LANES  SHADOW VEHICLES SHALL BE UTILIZED AS SHOWN IN THE TTC	2 MONTHS - 3 MONTHS	MONFRI. 9:00AM-4:00PM						

- 1. SPEED REDUCTION: CONTRACTOR SHALL PLACE W3-5A SIGN, WITH SPEED LIMIT OF 25 MPH, ON ALL APPROACHES FOR 18TH STREET.
- WARNING SIGN SPACING: MINIMUM 100' SPACING BETWEEN WARNING SIGNS UNLESS OTHERWISE
- DIRECTED BY THE CONSTRUCTION MANAGER AND TE&O.
- 3. TEMPORARY STRIPING: REFER TO PLAN FOR STRIPING.
- -STRIPING FROM PREVIOUS ZONE TO REMAIN UNLESS NOTED FOR REMOVAL. -ADJUST THE DIRECTIONAL ARROWS AS SHOWN ABOVE.
- 4. OPTIONAL TTC'S: REQUIRES APPROVE BY THE CONSTRUCTION MANAGER PRIOR TO IMPLEMENTATION 17.2 INSIDE LANE CLOSURE OPERATIONS ON A FOUR-LANE ROADWAY
- -FIRST CHANNELING DEVICE SHALL BE PLACED GREATER THAN 50' FROM AN IMPLEMENTATION
- PARKING IN THIS AREA SHOULD BE BLOCKED OFF. 6. ILLUMINATED FLASHING ARROW BOARDS SHALL BE PLACED OUTSIDE TRAVEL LANE.
- \* PEDESTRIAN ACCESS SHALL BE MAINTAINED AS SHOWN ON THIS SHEET, UTILIZING THE REFERENCED TTC IN THE MOT ZONE TABLE


AT THE END OF EACH WORKING DAY, THE CONTRACTOR SHALL PULL BACK **MOT CHANNELIZING DEVICES TO MAINTAIN TWO TRAVEL LANES IN EACH DIRECTION ON 18TH STREET.** 

ARLINGTON
VIRGINIA

DEPARTMENT OF **ENVIRONMENTAL SERVICES** FACILITIES & ENGINEERING DIVISION ENGINEERING BUREAU 2100 CLARENDON BOULEVARD, SUITE 813

FAX: 703.228.3606 COPYRIGHT © 2016 ARLINGTON COUNTY

ARLINGTON, VA 22201 PHONE: 703.228.3629

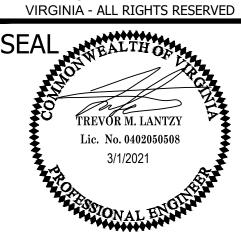

APPROVALS

QUALITY CONTROL ENGINEER 6.26.20 Kamal N. Taktak

WATER, SEWER, STREETS BUREAU CHIEF Dennis M. Leach 6/24/20 TRANSPORTATION DIRECTOR

Aiel Yang PROJECT MANAGER

REVISIONS

SOUTH


DESIGNED: NS DRAWN: NS

CHECKED: TL MISS UTILITY TRANSMITTAL #: XXXX


FILENAME: CC20-286-MOT - ZONE 18.DWG PATH: Q:\DATA\CC20\DESIGN\CAD\\_ACTIVE


PLOTTED: MARCH 1 2021 PLOTTED BY:NSHARP

SCALE:

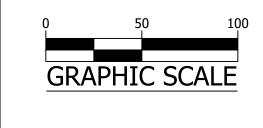

SHEET

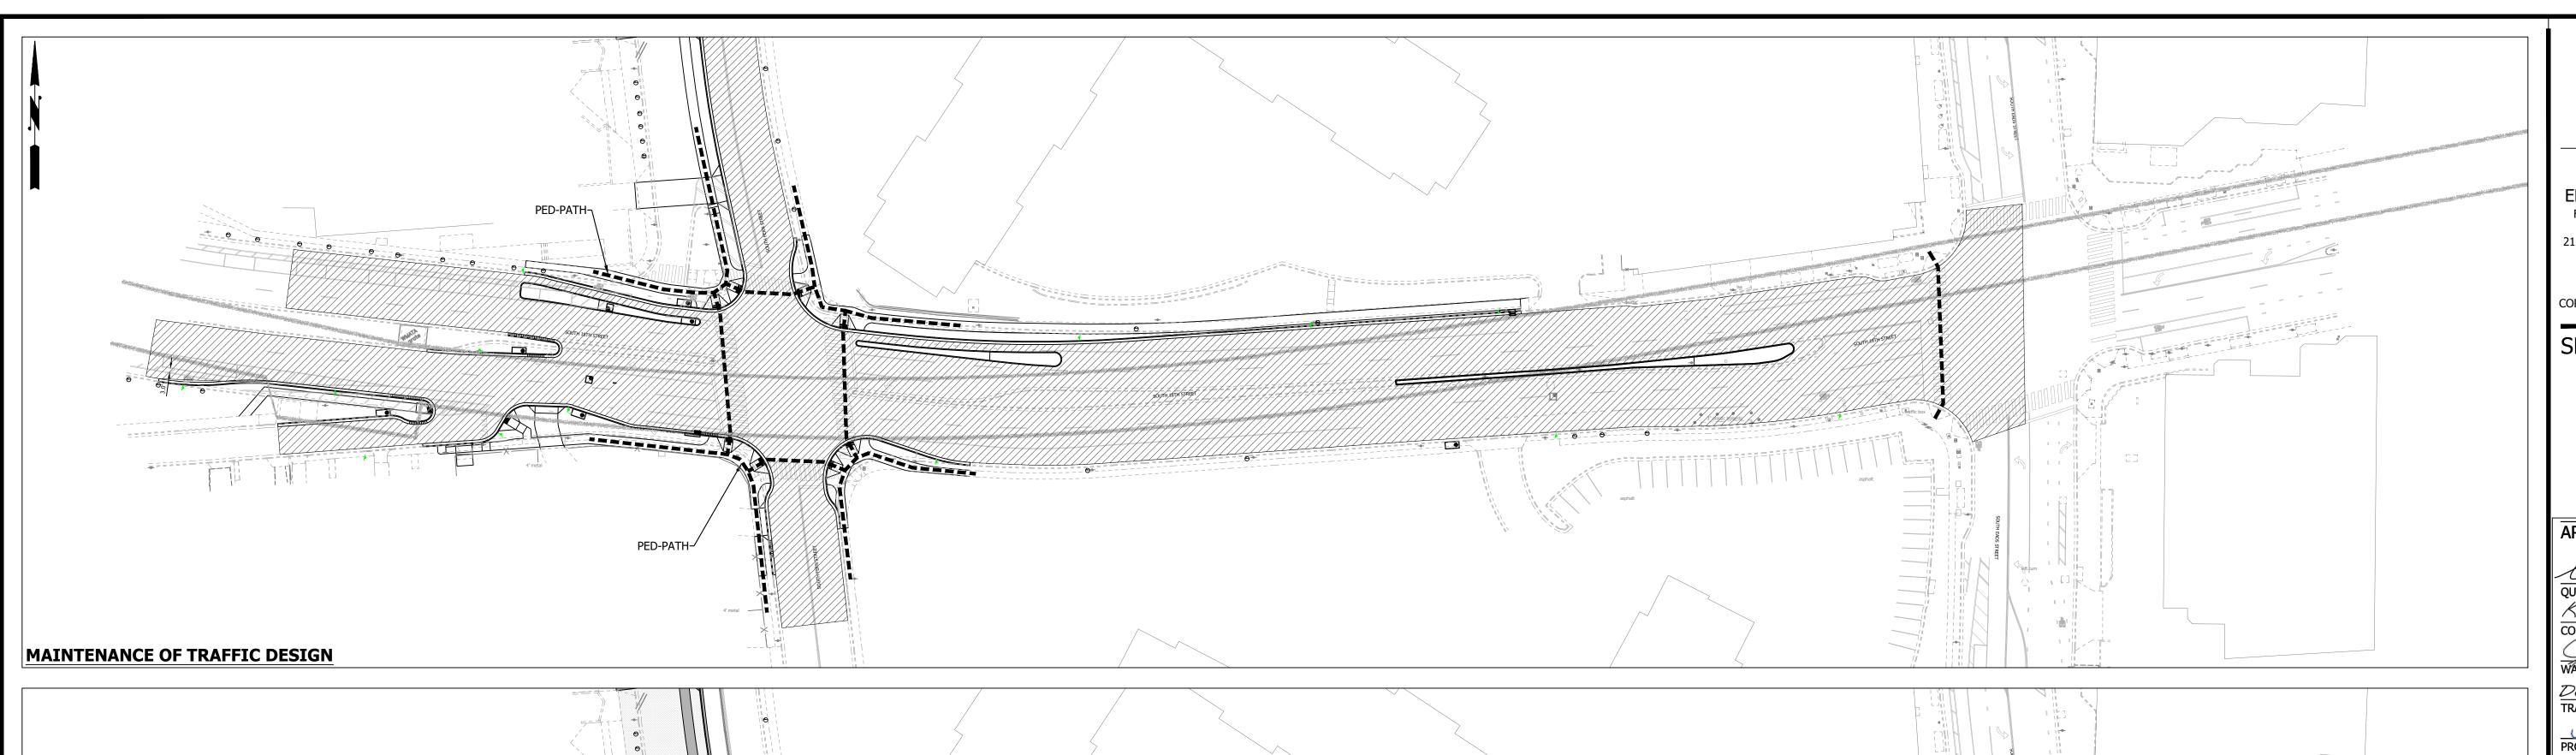

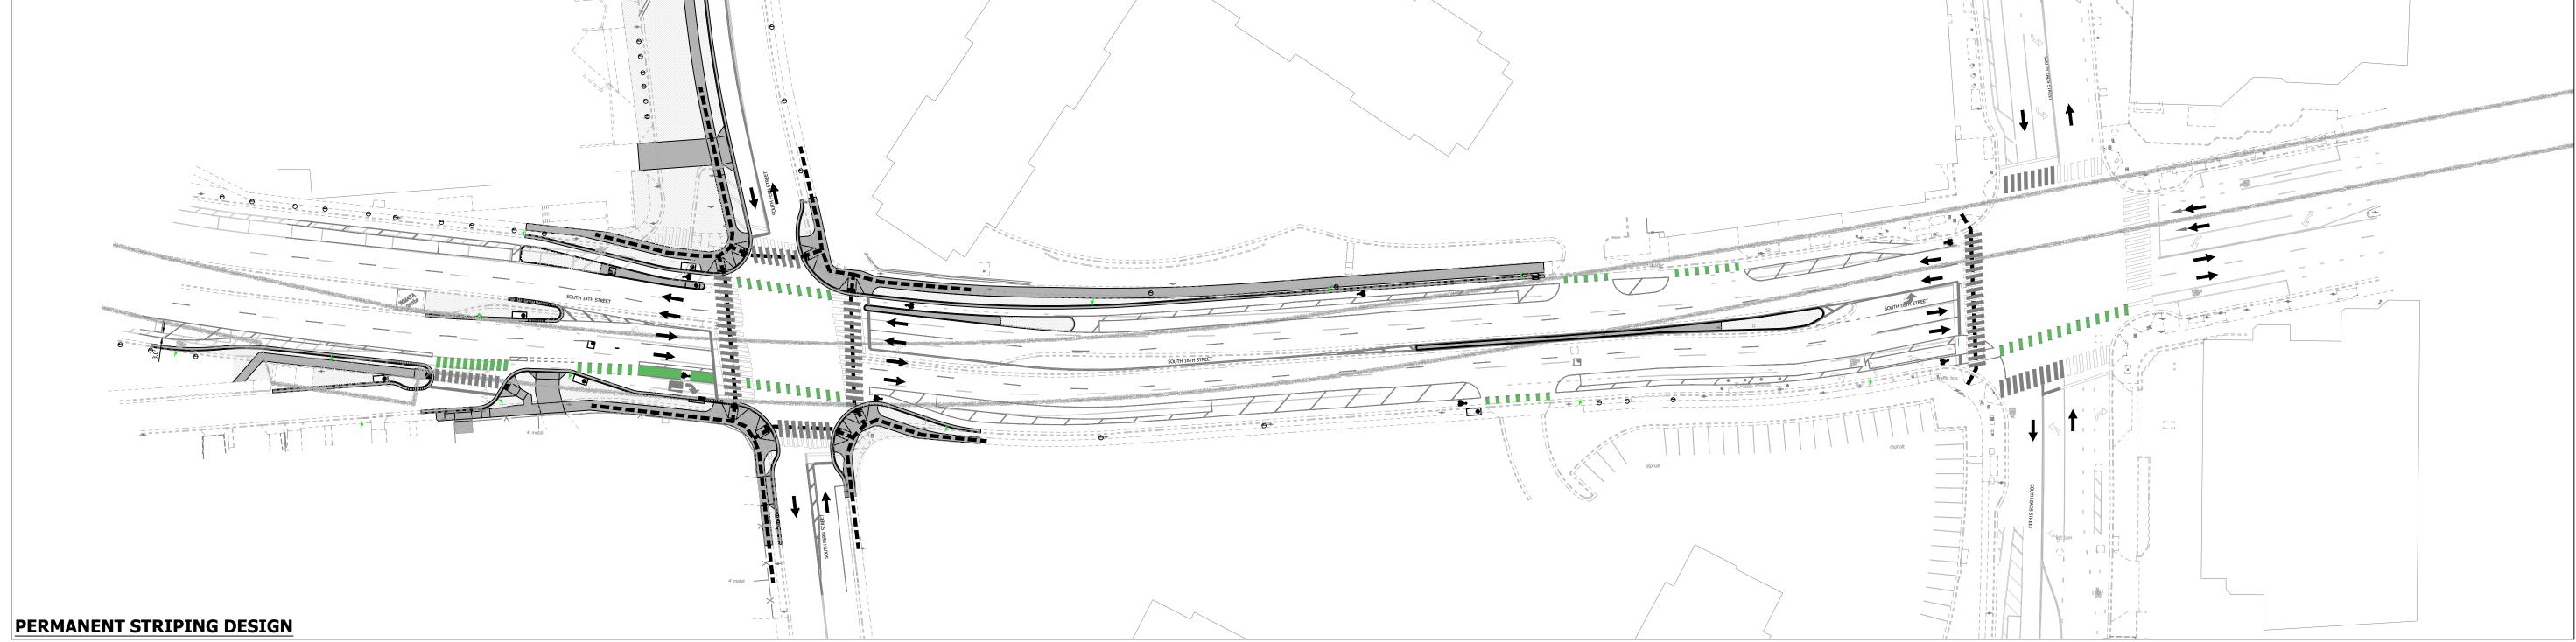

	MOT ZONE TABLE:										
MOT ZONE#	TTC#		COMMENTS	DURATION	WORK						
1101 20142#	VEHICULAR	PEDESTRIAN		DOIVITOR	HOURS						
ZONE# 19 TTC-13.2 TTC-35.1 SURFA			MILL AND OVERLAY ALL ASPHALT PAVEMENT IN THE PROJECT AREA FOR A FINISHED SURFACE COURSE.	1 WEEK - 2 WEEKS	MONFRI. 9:00AM-4:00PM						

APPLY PERMANENT STRIPING.

#### **ZONE NOTES:**

- 1. <u>SPEED REDUCTION:</u> CONTRACTOR SHALL PLACE W3-5A SIGN, WITH SPEED LIMIT OF 25 MPH, ON ALL APPROACHES FOR 18TH STREET.
- WARNING SIGN SPACING: MINIMUM 100' SPACING BETWEEN WARNING SIGNS UNLESS OTHERWISE DIRECTED BY THE CONSTRUCTION MANAGER AND TE&O.
- PERMANENT STRIPING: REFER TO STRIPING PLAN.
- OPTIONAL TTC'S: REQUIRES APPROVE BY THE CONSTRUCTION MANAGER PRIOR TO IMPLEMENTATION
- \* PEDESTRIAN ACCESS SHALL BE MAINTAINED AS SHOWN ON THIS SHEET, UTILIZING THE REFERENCED TTC IN THE MOT ZONE TABLE.

AT THE END OF EACH WORKING DAY, THE CONTRACTOR SHALL PULL BACK **MOT CHANNELIZING DEVICES TO MAINTAIN TWO TRAVEL LANES IN EACH DIRECTION ON 18TH STREET.** 

ARLINGTON
VIRGINIA

DEPARTMENT OF **ENVIRONMENTAL SERVICES** FACILITIES & ENGINEERING DIVISION ENGINEERING BUREAU 2100 CLARENDON BOULEVARD, SUITE 813 ARLINGTON, VA 22201 PHONE: 703.228.3629

COPYRIGHT © 2016 ARLINGTON COUNTY VIRGINIA - ALL RIGHTS RESERVED

FAX: 703.228.3606

APPROVALS

QUALITY CONTROL ENGINEER 6.26.20 Kamal N. Taktak

WATER, SEWER, STREETS BUREAU CHIEF

Dennis M. Leach
TRANSPORTATION DIRECTOR PROJECT MANAGER

**REVISIONS** 

SOUTH


DESIGNED: NS CHECKED: TL

MISS UTILITY TRANSMITTAL #: XXXX FILENAME: CC20-286-MOT - ZONE 19.DWG

PATH: Q:\DATA\CC20\DESIGN\CAD\\_ACTIVE

PLOTTED: MARCH 1 2021 PLOTTED BY:NSHARP

SCALE:

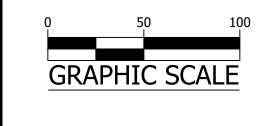


SHEET

C121.20



# Location Map

# Vicinity

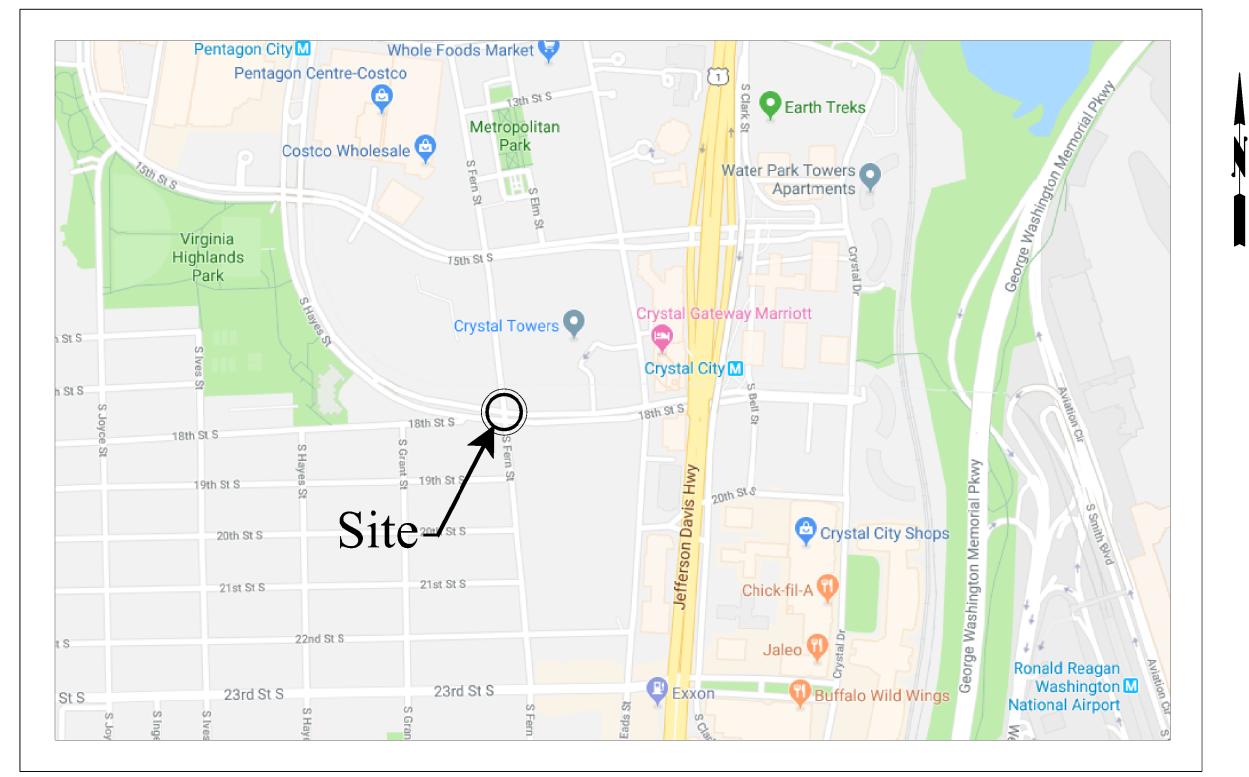

## DEPARTMENT OF **ENVIRONMENTAL SERVICES**

Transportation Engineering and **Operations Bureau** 2100 Clarendon Boulevard, Suite 900, Arlington, VA 22201 Phone: 703.228.3344 Fax: 703.228.3719 www.arlingtonva.us

# Construction Drawings For: Traffic Signal Modification

18th Street South & South Fern Street (TS#210)

Project Number: 241-CC20

- MAST ARM LENGTH IS TO BE AS SHOWN ON PLAN AND ALL MAST ARMS ARE TO BE FIELD
- MAST ARM POLES SHALL BE DESIGNED TO THE PROPER HEIGHT TO ACCOMMODATE A STREET LIGHT LUMINAIRE AND INSTALLED IN ACCORDANCE WITH ARLINGTON COUNTY TRAFFIC SIGNAL & STREETLIGHT SPECIFICATIONS.
- MAST ARM POLE FOUNDATIONS SHALL BE INSTALLED IN ACCORDANCE WITH ARLINGTON COUNTY STANDARDS AND SPECIFICATIONS. ALL POLES SHALL HAVE A 6-BOLT PATTERN.
- AT THE COUNTY'S REQUEST, THE CONTRACTOR SHALL DIG TEST PITS TO VERIFY THAT SIGNAL POLE FOUNDATIONS WILL NOT CONFLICT WITH UNDERGROUND UTILITIES AND THAT FOUNDATIONS WILL FIT WITHIN THE EXISTING RIGHT-OF-WAY.
- SIGNAL POLES AND MAST ARMS SHALL BE NON-ORNAMENTAL. COBRA LIGHTING SHALL BE LED.
- COBRA LIGHTING SHALL BE LED TYPE RFL-145W64LED4K-T-R2M-UNIV-DMG-PH8-RCD7-[USA-003]-BK. DECORATIVE POST-TOP LIGHTING SHALL BE HADCO DECORATIVE POST-TOP LUMINAIRE WITH RELUME LED KIT (UAZ XRE LED 57.69W).
- B. CONTROLLER AND FOUNDATION
- NEW CONTROLLER CABINETS SHALL BE TS2, P TYPE WITH BATTERY BACKUP PER ARLINGTON COUNTY REQUIREMENTS.
- CONTROLLER SHALL BE INTELIGHT X-3 AND SHALL BE INSTALLED AND SET AS FOLLOWS: 2.1 TO REST IN PHASE 2 & 6 GREEN INTERVAL 2.2 TO START/RESTART IN PHASE 2 & 6 YELLOW CHANGE INTERVAL
- THE CONTROLLER CABINET AND FOUNDATION SHALL BE INSTALLED IN ACCORDANCE WITH ARLINGTON COUNTY TRAFFIC SIGNAL & STREETLIGHT SPECIFICATIONS 66-01. 66-02, AND 70-01.
- 4. THE COUNTY WILL PROVIDE SIGNAL TIMINGS TO THE CONTRACTOR FOR THE CONTROLLER WHEN THE INTERSECTION IS TOTALLY PREPARED FOR OPERATION. THE CONTRACTOR SHALL NOTIFY THE COUNTY IN WRITING 10 DAYS IN ADVANCE OF REQUIRING FINAL TIMINGS.
- C. TRAFFIC SIGNAL HEADS
- ALL NEW VEHICULAR SIGNAL SECTIONS SHALL BE 12 INCHES IN DIAMETER CAST ALUMINUM WITH LED DISPLAYS.
- 2. PEDESTRIAN SIGNAL HEAD SECTIONS SHALL BE CAST ALUMINUM WITH LED DISPLAYS (COUNTDOWN).
- 3. ALL SIGNAL HEADS SHALL BE YELLOW IN COLOR.

# Signal Notes

- 1. ALL NEW PEDESTRIAN PUSH BUTTON STATIONS SHALL CONFORM TO ARLINGTON COUNTY'S SPECIFICATIONS FOR ACCESSIBLE SIGNAL DESIGN AND SHALL USE POLAR. NAVIGATOR VIBRO-TACTILE/AUDIO PUSH BUTTON ASSEMBLIES UNLESS OTHERWISE
- NEW OVERHEAD VIDEO DETECTION SHALL BE FLIR CAMERAS AND SHALL BE INSTALLED IN ACCORDANCE WITH COUNTY REQUIREMENTS.
- EMERGENCY VEHICLE PRE-EMPTION (EVP) EQUIPMENT (GTT MODEL M711 OR M721), OR APPROVED SUBSTITUTE, SHALL BE INSTALLED COMPLETE WITH DISCRIMINATOR CARDS, WIRING, ETC. IN ACCORDANCE WITH ARLINGTON COUNTY STANDARDS.
- 4. EVP TO BE MOUNTED ON VEHICLE HEAD MOUNTING BRACKET OR AS APPROVED BY THE ENGINEER IN THE FIELD.
- CONDUIT, CONDUCTORS, AND ELECTRICAL
- 1. ALL JUNCTION BOXES SHALL HAVE THE WORDS "ARLINGTON COUNTY TRANSPORTATION" CAST IN THE LID. ALL JUNCTION BOXES SHALL BE INSTALLED PER STANDARDS 61-01, 61-02, 61-03, AND 61-04.
- METER PEDESTAL SHALL BE INSTALLED PER COUNTY STANDARDS. UNDERGROUND SERVICE SHALL BE OBTAINED FROM THE NEAREST UTILITY POLE OR SERVICE POINT. CONTRACTOR IS RESPONSIBLE FOR OBTAINING APPROVAL AND COORDINATING WITH POWER SERVICE COMPANY FOR CONNECTION.
- 3. CONDUIT SYSTEM SHALL BE ADDED TO CONNECT EXISTING COMMUNICATION CABLE PLANT TO THE NEW CONTROLLER CABINET LOCATION AS DIRECTED BY THE COUNTY
- 4. ALL CONDUIT ENTERING INTO JUNCTION BOXES SHALL NOT EXTEND OVER 3" MAXIMUM NOR 2" MINIMUM INSIDE THE JUNCTION BOXES, AND SHALL BE FITTED WITH BELL ENDS
- 5. ALL JUNCTION BOXES SHALL HAVE A GROUND ROD INSTALLED. ALL JUNCTION BOXES SHALL BE PROPERLY CONNECTED TO THE INTERSECTION GROUNDING SYSTEM. METAL LIDS SHALL BE BONDED TO THE GROUNDING SYSTEM.
- 6. CONTRACTOR IS TO VERIFY DEPTHS OF UTILITIES AT PROPOSED CONDUIT CROSSINGS PRIOR TO EXCAVATING CONDUIT TRENCHES OR BORING.
- 7. ALL CONDUITS BENEATH ROADWAYS SHALL BE DIRECTIONAL DRILLED UNLESS DIRECTED OTHERWISE BY THE COUNTY CONSTRUCTION MANAGER. WHERE DIRECTED ON THE PLANS OR BY THE CONSTRUCTION MANAGER, THE CONTRACTOR SHALL INSTALL SPARE CONDUITS WITH PULL TAPE AND TRACER WIRE FOR ROAD CROSSINGS.
- 8. ALL EXISTING CONDUIT AND CABLES ARE BASED ON RECORD DRAWINGS OR WERE ESTIMATED. CONTRACTOR SHALL VERIFY CONDUIT FILL CAPACITY IN EXISTING CONDUITS PRIOR TO BEGINNING CONSTRUCTION. THE CONTRACTOR SHALL NOTIFY ARLINGTON COUNTY IF CONDUIT CAPACITY IS NOT AVAILABLE IN EXISTING CONDUIT FOR NEW
- NEW CCTV CAMERAS SHALL BE INSTALLED IN ACCORDANCE WITH ARLINGTON COUNTY REQUIREMENTS. CONTRACTOR SHALL CONFIRM MOUNTING LOCATION OF CCTV CAMERA WITH COUNTY PRIOR TO INSTALLATION.
- 10. CONTRACTOR TO VERIFY THE CONDUIT AND % FILL. IF THERE IS NOT ENOUGH CAPACITY IN CONDUIT, THEN THE CONTRACTOR SHALL INSTALL NEW CONDUIT.
- 11. ALL PROPOSED CONDUIT SHALL HAVE #6 AWG (EGC) & TRACER WIRE FOR GROUNDING
- 12. REMOVE ALL EXISTING UNUSED RISERS, JUNCTION BOXES, AND CABLES.

- ALL MAST ARM SIGNS SHALL BE MOUNTED IN ACCORDANCE WITH ARLINGTON COUNTY STANDARDS. SIGNS SHALL BE FURNISHED AND INSTALLED BY THE CONTRACTOR UNLESS DIRECTED OTHERWISE.
- 2. STREET NAME SIGNS SHALL HAVE A WHITE LEGEND ON GREEN BACKGROUND. CONTRACTOR SHALL SUBMIT SIGN DETAILS TO COUNTY TO REVIEW. THE DIMENSIONS PROVIDED ON PLANS ARE ESTIMATED.
- G. DEMOLITION/SALVAGE
- ALL EXISTING SIGNAL EQUIPMENT IS TO BE REMOVED & RETURNED TO ARLINGTON COUNTY DEPARTMENT OF ENVIRONMENTAL SERVICES LOCATED AT 4300 29TH ST S... ARLINGTON, VA 22206.
- 2. ALL EXISTING SIGNAL POLE FOUNDATIONS SHALL BE DEMOLISHED IN ACCORDANCE WITH ARLINGTON COUNTY SPECIFICATIONS.
- COMMUNICATIONS
- 1. EXISTING COUNTY FIBER JUNCTION BOXES AND CONDUITS CONTAIN LIVE FIBER OPTIC CABLES. THE CONTRACTOR SHALL NOT CUT OR DAMAGE THE COUNTY'S EXISTING FIBER
- 2. ALL FIBER OPTIC CABLE INSTALLATION, REMOVAL, SPLICING, AND TESTING SHALL BE PERFORMED BY THE COUNTY AT THE CONTRACTOR'S EXPENSE. CONTRACTOR MAY CONTRACT DIRECTLY WITH THE COUNTY'S FIBER CONTRACTORS. UPON REQUEST 703-228-7726, THE COUNTY WILL PROVIDE THE CONTACT INFORMATION FOR CURRENT QUALIFIED COUNTY FIBER CONTRACTORS.
- 3. CONTACT ARLINGTON COUNTY DTS FOR FIBER OPTIC CABLE REMOVAL OR INSTALLATION AT LEAST 10 BUSINESS DAYS IN ADVANCE.
- 4. CONTRACTOR SHALL FURNISH FIBER PATCH PANEL FOR INSTALLATION BY THE COUNTY. FIBER PIGTAIL SHALL BE APPROPRIATE LENGTH TO ALLOW FOR 50 FEET OF SLACK IN EACH INTERMEDIATE JUNCTION BOX. CONTRACTOR SHALL SUBMIT A SHOP DRAWING OF THE PATCH PANEL (INDICATING THE TAIL LENGTH) FOR COUNTY REVIEW PRIOR TO ORDERING.
- 5. THE CONTRACTOR SHALL BE RESPONSIBLE FOR THE INSTALLATION OF PROPOSED JUNCTION BOXES AND CONDUITS INCLUDING ALL APPURTENANCES SUCH AS GROUND RODS, TRACER WIRE, PULL TAPE, ETC.
- ALL NEW CONDUITS SHALL HAVE PULL TAPE INSTALLED BETWEEN JUNCTION BOXES AND TRACER WIRE INSTALLED WITHIN OR BESIDE AT LEAST ONE OF THE CONDUITS. TRACER WIRE SHALL BE CONNECTED TO THE GROUND RODS INSTALLED IN THE ADJACENT
- DO NOT SPLICE TRACER WIRE.
- 1. THE CONTRACTOR SHALL CONTACT THE COUNTY CONSTRUCTION MANAGER FOR INSPECTIONS THROUGHOUT CONSTRUCTION AS REQUIRED BY THE CONSTRUCTION
- 2. THE COUNTY SHALL VERIFY POLE LOCATIONS PRIOR TO EXCAVATION. THE CONTRACTOR SHALL NOTIFY MR. SHAHID MOHIUDDIN, 703-228-7555 TO SCHEDULE INSPECTION PRIOR TO EXCAVATION, AND AGAIN PRIOR TO POURING CONCRETE. STAKEOUT IS THE RESPONSIBILITY OF THE CONTRACTOR UNLESS DIRECTED OTHERWISE.
- 3. THE CONTRACTOR SHALL CONTACT THE COUNTY CONSTRUCTION MANAGER WITHIN 7 BUSINESS DAYS OF SIGNAL ACTIVATION. ALL POWER AND COMMUNICATIONS SHALL BE IN OPERATION AT THE TIME OF ACTIVATION UNLESS APPROVED BY THE COUNTY CONSTRUCTION MANAGER.

# Table of Contents:

T-1. Cover She

T-3. Communications Plan

I CERTIFY THAT THIS PROJECT WAS BUILT IN SUBSTANTIAL CONFORMANCE WITH THIS PLAN,

UNLESS DULY NOTED IN THE ABOVE REVISION BLOCK.

PROJECT MANAGER

CONSTRUCTION MANAGER

				•	
eet					
gnal	Modificati	on Plan			

al Si

ARLINGTON

**DEPARTMENT OF** 

**ENVIRONMENTAL SERVICES** 

**Engineering & Capital Projects Division** Engineering Bureau 2100 Clarendon Boulevard, Suite 813

> Phone: 703.228.3629 Fax: 703.228.3606

Lic. No. 0402051415

QUALITY CONTROL ENGINEER

Kamal N. Taktak

Dennis M. Leach

TRANSPORTATION DIRECTOR

PROJECT MANAGER

Designed: AK Drawn: AK Checked: JEL Miss Utility Transmittal #:

Filename: TSD\_18th St. S. & S. Fern St.dwg Path: I:\PROJECTS\4019833\90\_CAD MODELS AND SHEETS\18 & FERN TSD Plotted: June 30, 2020 Plotted by: KharkwA

Scale: N.T.S.

Sheet

